

CERTIFICATE OF APPROPRIATENESS PLACARD

for Raleigh Historic Resources

207 E HARGETT STREET

Address

MOORE SQUARE

Historic District

Historic Property

049-18-MW

Certificate Number

04-16-2018

Date of Issue

04-16-2018

Expiration Date

This card must be kept pasted in a location within public view until all phases of the described project are complete. The work must conform with the code of the City of Raleigh and laws of the state of North Carolina. When your project is complete, you are required to ask for a final zoning inspection in a historic district area. Telephone the RHDC office at 832-7238 and commission staff will coordinate the inspection with the Inspection, your Certificate of Appropriateness is null and void.

Project Description:

- Removal of non-contributing brick wall;
- Construction of new ADA accessible ramp;
- Construction of new steps and guardrails;
- Landscaping

Signature, Collette R K

Raleigh Historic Development Commission

Pending the resolution of appeals, commencement of work is at your own risk.

Raleigh Historic Development Commission – Certificate of Appropriateness (COA) Application



Development Services Customer Service Center

One Exchange Plaza
1 Exchange Plaza, Suite 400
Raleigh, North Carolina 27601
Phone 919-996-2495
eFax 919-996-1831



 Minor Work (staff review) – 1 copy Major Work (COA Committee review) – 10 copies Additions Greater than 25% of Building Square Footage New Buildings Demo of Contributing Historic Resource All Other Post Approval Re-review of Conditions of Approval			For Office Use Only Transaction # 549927 File # 049-18-MW Fee 29.00 Amount Paid 29.00 Received Date 4/3/18 Received By 5#		
Property Street Address: 207 Eas	st Hargett Street				
Historic District Moore Square His	storic District	2			
Historic Property/Landmark nam	e (if applicable) N/A				
Owner's Name Wake County (Mar	bles Kids Museum)				
Lot size 1.09 Acres	(width in feet) See attached		(depth in feet) See attached		
	.e. both sides, in front (acro		provide addressed, stamped envelopes to owners, and behind the property) not including the width		
Property Ad	dress		Property Address		
			,		


I understand that all applications that require review by the commission's Certificate of Appropriateness Committee must be submitted by 4:00 p.m. on the application deadline; otherwise, consideration will be delayed until the following committee meeting. An incomplete application will not be accepted.

Type or print the following:				
Applicant Clearscapes / Andrew Rook				
Mailing Address 311-200 W. Martin Street				
City Raleigh	State NC	Zip Code 27601		
Date March 12, 2018	Daytime Phone 919) 821-2775			
Email Address arook@clearscapes.com				
Applicant Signature (Mh K) M				
		Office Hee Only		
Will you be applying for rehabilitation tax credits	for this project? Yes 🗵 No	Office Use Only Type of Work 59, 87, 35		
Did you consult with staff prior to filing the appli	cation? 🛛 Yes 🔲 No			

Des	sign Guidelines - Please cite the	e applicable sections of the design guidelines (www.rhdc.org).
Section/Page	Topic	Brief Description of Work (attach additional sheets as needed)
Section 1.3, pg. 23	Site Features & Plantings	
Applicable Items	1.3.1, 1.3.2, 1.3.6, 1.3.9	The Marbles Play Annex Courtyard project consists of site upgrades to an existing courtyard located in the middle of the Marbles Kids Museum and IMAX theater complex. The purpose of the project was to increase the visual and physical connection between the museum, the museum courtyard and the IMAX theater outdoor space. Grade differences between the main courtyard and the Play Annex Courtyard will be mitigated with a stepped landscape. All work is internal to the city block and will not be visible from
		the public right-of-way. Work consists of the following: Demolition of existing non-contributing brick site wall along east side of courtyard Partial demolition of non-contributing north site wall Construction of new ADA accessible concrete ramp that leads into courtyard Construction of new guardrail located where portion of brick wall is being demolished (adjacent to IMAX courtyard) Construction of new concrete seat walls Construction of new terraced landscape


Minor Work Approval (office use only)			
Upon being signed and dated below by the Planning Director or designee, this application becomes the Minor Work Certificate of Appropriateness. It is valid until $\frac{U/U/U}{U/U}$. Please post the enclosed placard form of the certificate as indicated at			
Appropriateness. It is valid until $\frac{ \mathcal{V} \mathcal{V} \mathcal{V} }{ \mathcal{V} \mathcal{V} }$. Please post the enclosed placard form of the certificate as indicated at the bottom of the card. Issuance of a Minor Work Certificate shall not relieve the applicant, contractor, tenant, or property owner from			
obtaining any other permit required by City Code or any law. Minor Works are subject to an appeals period of 30 days from the date			
of approval.			
Signature (City of Raleigh) Collette R K Date 04/16/2018			

TO BE COMPLETED BY APPLICANT				TO BE COMPLETED BY CITY STAFF		
	YES	N/A	YES	NO	N/A	
Attach 8-1/2" x 11" or 11" x 17" sheets with written descriptions and drawings, photographs, and other graphic information necessary to completely describe the project. Use the checklist below to be sure your application is complete.						
Minor Work (staff review) – 1 copy	Minor Work (staff review) – 1 copy					
Major Work (COA Committee review) – 10 copies N/A						
Written description. Describe clearly and in detail the nature of your project. Include exact dimensions for materials to be used (e.g. width of siding, window trim, etc.)						
Description of materials (Provide samples, if appropriate)						
3. Photographs of existing conditions are required. Minimum image size 4" x 6" as printed. Maximum 2 images per page.						
4. Paint Schedule (if applicable)						
5. Plot plan (if applicable). A plot plan showing relationship of buildings, additions, sidewalks, drives, trees, property lines, etc., must be provided if your project includes any addition, demolition, fences/walls, or other landscape work. Show accurate measurements. You may also use a copy of the survey you received when you bought your property. Revise the copy as needed to show existing conditions and your proposed work.						
Drawings showing existing and proposed work						
 □ Plan drawings □ Elevation drawings showing the façade(s) □ Dimensions shown on drawings and/or graphic scale (required) □ 11" x 17" or 8-1/2" x 11" reductions of full-size drawings. If reduced size is so small as to be illegible, make 11" x 17" or 8-1/2" x 11" snap shots of individual drawings from the big sheet. 						
 Stamped envelopes addressed to all property owners within 100 feet of property not counting the width of public streets and alleys (required for Major Work). Use the <u>Label Creator</u> to determine the addresses. 						
8. Fee (See Development Fee Schedule)						

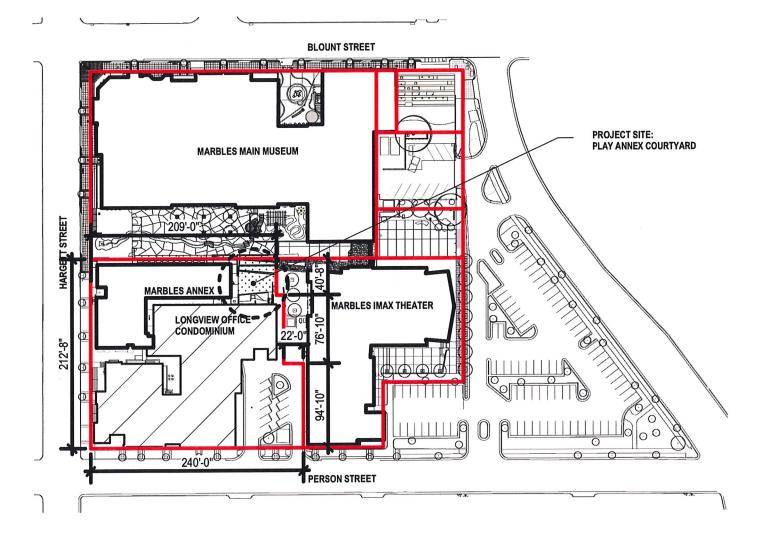

01 LOT DIMINSIONS Scale: 1"= 100 ft

 \bigcirc N

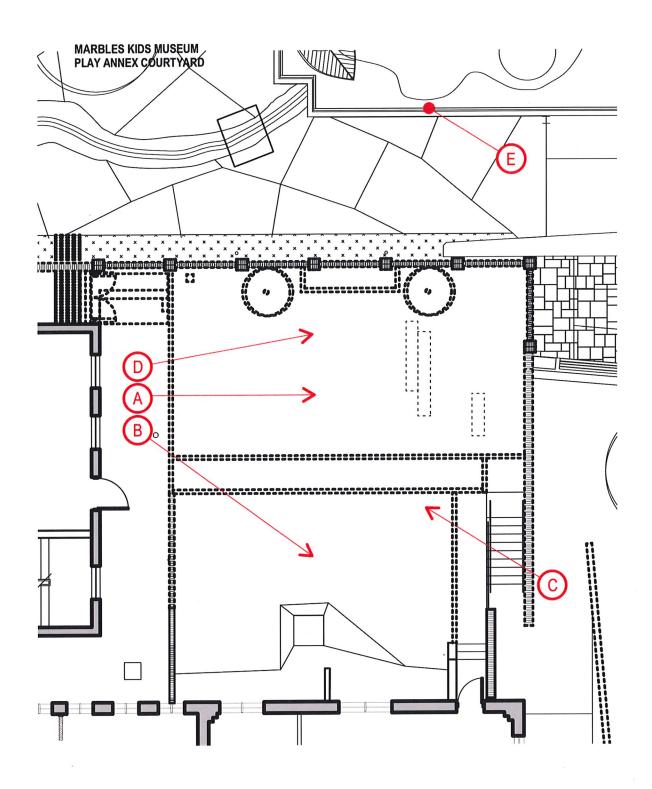

01 PHOTO KEY PLAN - EXISTING CONDITIONS

Scale: 3/32" = 1'-0"

MARBLES KIDS MUSEUM PLAY ANNEX COURTYARD



PORTION OF WALL TO BE
DEMOLISHED AND REPLACED WITH
PAINTED STEEL GUARDRAIL





BRICK WALL TO BE DEMOLISHED

BRICK SIDEWALK TO BE DEMOLISHED

©





NEW GUARDRAIL TO MATCH DETAILING AND COLOR OF EXISTING RAIL (NEW RAIL WILL BE 42" IN HEIGHT PER BUILDING CODE.)

MARBLES KIDS MUSEUM SITE IMPROVEMENTS / PLAY ANNEX COURTYARD: **PERMIT SET 03.02.2018**

MARBLES CAMPUS MAIN ADDRESS: 201 EAST HARGETT STREET, RALEIGH, NC 27601







SITE AND PROJECT LOCATION VICINITY MAP SHEET LIST GENERAL G000 COVER SHEET JONES STREET G001 G002 PROJECT DATA SHEET & BUILDING CODE SUMMARY BUILDING CODE SUMM G003 ARCHITECTURAL SITE PLAN ARCHITECTURAL A001 A002 DEMOLITION - SITE PLAN EDENTON STREET DEMOLITION - SITE SECTIONS/ ELEVATIONS OVERALL SITE PLAN A101 A102 ENLARGED PLAN PLAY ANNEX COURTYARD A201 A301 A302 NEW BERN AVENUE SECTION DETAILS SECTION DETAILS MORGAN STREET ELECTRICAL ELECTRICAL SYMBOLS E100 **ELECTRICAL DEMOLITION** ELECTRICAL NEW WORK ELECTRICAL RISER SITE HARGETT STREET

GENERAL NOTES

0-0. ALL WORK SHALL CONFORM TO:

O-0. ALL WORK SHALL CONFORM TO:

NORTH CAROLINA STATE BUILDING CODE, 2012 EDITION AND CURRENT AMENDMENTS.

RULES AND REGULATIONS OF THE CITY OF FALLEIGH, NORTH CAROLINA.

RULES AND REGULATIONS OF PUBLIC UTLITIES.

AMERICANS WITH DISABILITIES ACT, 26 JULY 1991, ANSI A117 AND CURRENT AMENDMENTS.

O-1. THE CODE COMPLIANCE SUMMARIES ARE GUIDES TO THE CONSTRUCTION CRITERIA DEVELOPED FOR THIS PROJECT. THEY ARE NOT INTENDED TO BE A COMPLETE LIST OF CODE REQUIREMENTS.

O-2. MAINITAIN INTEGRITY OF FIRE RESISTANCE RATING OF ALL RATED SHAFT ENCLOSURES AND RATED PARTITIONS BEHIND RECESSED WALL ACCESSORIES, INCLUDINS FIRE EXTINGUISHER CABINETS, TOILET ACCESSORIES, ELECTRICAL JUNCTION BOXES, AND OTHER ITEMS WHERE THEY OCCUR.

O-3. PENETRATIONS OF PIPES, CONDUITS, SWITCHES, OUTLETS, AND OTHER ITEMS AT RATED ASSEMBLIES SHALL BE FIRE-STOPPED, TYP.

GENERAL REQUIREMENTS

1-4. REFER TO THE PROJECT MANUAL FOR COMPLETE GENERAL REQUIREMENTS AND CONDITIONS OF THE CONTRACT. THE PROJECT MANUAL SHALL TAKE PRECEDENCE OVER THESE GENERAL NOTES IN THE EVENT OF A CONFLICT.

CONFLICT.

11. THE GENERAL CONTRACTOR MUST COORDINATE ARCHITECTURAL DRAWINGS WITH SPMEAFA DRAWINGS AND ALL OWNERS VENDORS INCLUDING, BUT NOT LIMITED TO, TELEPHONE, AUDIO/VISUAL. AND SECURITY SYSTEMS. NOTIFY ARCHITECT OF ANY CONFLICTS OR DISCREPENCIES PRIOR TO COMMENCEMENT OF WORK.

12. THE GENERAL CONTRACTOR AND ALL SUB-CONTRACTORS ARE RESPONSIBLE FOR REVIEWING AND COORDINATING THEIR WORK WITH ALL OF THE DRAWINGS PRIOR TO INSTALLATION. OMISSIONS OR CONFLICTS BETWEEN THE VARIOUS ELEMENTS OF THE DRAWINGS, PROJECT MANUAL, NOTES, AND DETAILS SHALL BE REPOUGHT TO THE ATTENTION OF THE ARCHITECT BY THE GENERAL CONTRACTOR AND SHALL BE RESOLVED WITH THE ARCHITECT BETTER CORRESPONSIBLE FOR EPICED WITH THE ARCHITECT BY THE GENERAL CONTRACTOR AND SHALL BE RESOLVED WITH THE ARCHITECT BETTER CORRESPONSIBLE FOR EPICE AND COORDINATION WITH CORPORATION OF THE ARCHITECT BY THE GENERAL CONTRACTOR TO INCLUDE ALL PERPIRE FEES AND COORDINATION WITH CORPORATION OF THE PROPERTY OF ALL PERPIRE FEES AND COORDINATION WITH ALL PROPERTY OF THE SEES AND COORDINATION WITH ALL POPUL THE SEES AND COORDINATION WITH ALL POPUL THE SEES AND COORDINATION WITH ALL POPUL THE SEES AND COORDINATION WITH ALL PROPERTY OF THE

THE ARCHITECT BEFORE PROCEEDING WITH THE WORK OR RELATED WORK.

13. THE GENERAL CONTRACTOR TO INCLUDE ALL PERMIT FEE'S AND COORDINATION WITH CITY OF RALEIGH INSPECTIONS DEPARTMENT, INCLUDING COORDINATION OF WORK IN CITY RIGHT OF WAY, TYPICAL.

14. BASE BID TO INCLUDE AN ALLOWANCE OF \$3,000 FOR PROCESS OF SECURING (2) PERMITS FROM THE CITY OF RALEIGH. PREMIT FOR EACH BUILDING WILL BE REQUIRED AND ASSUMED BY CONTRACTOR FOR THIS WORK.

EACH PERMIT IS ESTIMATED TO BE \$X,000 FOR MARBLES.

AS CONTRACTOR TO ASSUME A 2-STEP "NOTICE TO PROCESED" PROCESS. STEP #1-PERMITTING, SHOP DRAWINGS AND ORDER/SECURING OF MATERIALS/FIXTURES (9) DAYS). STEP #2-CONSTRUCTION (120 DAYS) (START DATE TO BE AGREED UPON BY ALL PARTIES AFTER MATERIALS HAVE BEEN SECURED)

16. THE CONTRACTOR WORK HOURS- CLEARSCAPES, MARBLES KIDS MUSEUM AND WAKE COUNTY GSA WILL WORK WITH SELECTED CONTRACTOR OROK HOURS- CLEARSCAPES, MARBLES KIDS MUSEUM AND WEKE COUNTY GSA WILL WORK WITH SELECTED CONTRACTOR TO ACCOMDOTE A COST EFFECTIVE SOLUTION FOR THE REPLACEMENT/INISTALLATION OF PROJECT THAT MAY INCLUDE NIGHT, EVENING AND WEKEKEND HOURS.

1-7. THE CONTRACTOR AND ALL SUB-CONTRACTORS ARE RESPONSIBLE TO COORDINATE AND PROVIDE ANY AND ALL REQUIRED CROWD CONTROL TOR AND ALL SEDED TO MAINTAIN EXIT EGGRESS AND SITE SAFETY FOR GENERAL PUBLIC AND MUSEUM PATRONS DURING BUSINESS HOURS. THIS ALSO INCLUDES SITE CONTROL OF CHILER COURT AREA

AND MUSEUM PATRONS DURING BUSINESS HOURS. THIS ALSO INCLUDES SITE CONTROL OF CHILLER COURT AREA AND MUSEUM SERVICE COURT.

AND MOSEUM SERVICE COURT.

1-8. DUE TO MUSEUM PATRONS, MARBLES KIDS MUSEUM CAMPUS IS A ZERO TOLERANCE SITE FOR USE OF DRUGS,
TOBACCO OR ALOCOHOL, INCLUDING USE OF VAPOR SMOKING DEVICES BY STAFF OR CONTRACTORS.

1-9. MARBLES KIDS MUSEUM HAS VERY LIMITED ONSITE STORAGE, THEREFORE CONTRACTOR IS RESPONSIBLE FOR PROVIDING THIER OWN STORAGE. MARBLES STAFF WILL WORK WITH GC TO COORDINATE OPTIONS ON A CASE BY CASE BASIS.

2-0. DIMENSIONS ARE NOTED OR CAN BE DETERMINED FROM OTHER INFORMATION INCLUDED IN THE DRAWINGS 2-01. DIMENSIONS ARE NOTED OR CAN BE DETERMINED FROM OTHER INFORMATION INCLUDED IN THE DRAWINGS.
VERIFY ALL DIMENSIONS BEFORE PROCEEDING WITH THE WORK. NOTIFY THE ARCHITECT IMMEDIATELY OF ANY
DISCREPANCIES OR OMISSIONS. DO NOT PROCEED WITH AFFECTED WORK OR RELATED WORK UNTIL THE
VARIATIONS OR OMISSIONS HAVE BEEN RESOLVED BY THE ARCHITECT. DO NOT SCALE DRAWINGS. DRAWING
SHEETS LESS THAN 24'x36" MAY HAVE BEEN REDUCED FROM THE ORIGINALS.
2-1. ALL DIMENSIONS ARE TO FINISHED FACE OF WALL UNLESS OTHERWISE NOTED.
2-2. WALLS SHOWN TO ALIGN ARE TO HAVE PRINSH FACES ALIGN UNLESS OTHERWISE NOTED.
2-3. IF PROVIDED, REFER TO ENLARGED PLANS AND PLAN DETAILS FOR ADDITIONAL INFORMATION AND
DIMENSIONS.

2-4. LOCATIONS OF ALL DEVICES AND FIXTURES DIMENSIONED, NOTED OR OTHERWISE DESCRIBED, ARE EXACT. 24. LOCATIONS OF ALL DEVICES AND TAT UNES DIMENSIONED, NOTED OR OTHERWISE DESCRIBED, ARE EARGT.
ALL NEW FRANING MUST ACCOMMODATE THESE LOCATIONS.
2-5. ANY DIMENSIONS OF OR TYING IN TO EXISTING BUILDING COMPONENTS ARE TO BE FIELD-VERIFIED PRIOR TO COMMENCEMENT OF WORK. VERIFY ANY DISCREPANCIES W/ ARCHITECT PRIOR TO COMMENCEMENT OF WORK.

3-1. TYPICAL DETAILS SHOWN ON THE DRAWINGS SHALL BE INCORPORATED AT ALL APPROPRIATE LOCATIONS WHETHER OR NOT SPECIFICALLY REFERENCED AT EACH LOCATION.
3-2. THE GENERAL CONTRACTOR IS RESPONSIBLE FOR ANY REQUIRED DEMOLITION, TEMPORARY SUPPORT OF,

3-2. THE GENERAL CONTRACTOR IS RESPONSIBLE FOR ANY REQUIRED DEMOLITION, TEMPORARY SUPPORT OF, ANDIOR DAMAGE TO NEW OR EXISTING FINISHES DURING CONSTRUCTION.

3-3. THE GENERAL CONTRACTOR IS TO COORDINATE, PROVIDE, AND INSTALL CONCEALED BLOCKING FOR ALL WALL-MOUNTED ITEMS INCLUDING, BUT NOT LIMITED TO, FIXTURES, EQUIPMENT, OWNER. ANDIOR VENDOR-PROVIDED ITEMS, ETC.

3-4. NO EXPOSED CONDUIT, WIRING, OR PIPING IS PERMITTED WITHOUT ARCHITECT APPROVAL UNLESS SPECIFICALLY NOTED OTHERWISE. ANY OPEN CEILING CONDITIONS AS PART OF THIS PROJECT, THE GENERAL CONTRACTOR WILL BE RESPONSIBLE FOR PROVIDING SYSTEMS COORDINATION BETWEEN THE TRADES. COORDINATION DRAWINGS SHALL BE PROVIDED FOR THE ARCHITECT'S REVIEW. ALL CONFLICTS ARE TO BE BROUGHT TO THE ATTENTION OF THE ARCHITECT PRIOR TO INSTALLATION.

3-5. ALL FRAMING, SOUND ATTENUATION, AND GYP BOARD FOR NON-RATED SOUND-ATTENUATED WALLS SHALL CONTINUET OF THE UNDESS PECIFICALLY NOTED OTHERWISE. GYP BOARD SHALL BE SEALED TO DECK AT EACH FACE WITH JOINT COMPOUND, SEALANT, ANDIOR EXPANDING FOAM ACCEPTABLE ONLY IN CONCEALED CONDITIONS, ANY REQUIRED PIPE DUCT OR WINNING PRIFATATIONS SHALL BE SEALED AS

CONCEALED CONDITIONS). ANY REQUIRED PIPE, DUCT, OR WIRING PENETRATIONS SHALL BE SEALED AS DESCRIBED ABOVE.

3-6. IN AREAS OF HARD CEILING, BUILDING SYSTEMS SHALL BE CONFIGURED TO MINIMIZE REQUIRED ABOVE-CEILING ACCESS. THE LOCATION OF ALL ACCESS DOORS MUST BE COORDINATED WITH AND APPROVED BY THE ARCHITECT PRIOR TO THE INSTALLATION OF ANY ABOVE-CEILING EQUIPMENT, DAMPERS, VALVES, JUNCTION BOXES, ETC. ACCESS DOORS SHALL BE PROVIDED AND INSTALLED FOR ANY WORK THAT REQUIRES ABOVE-CEILING ACCESS, ADDITIONALLY, ANY ACCESS DOORS OR PANELS REQUIRED IN WALLS MUST BE COORDINATED WITH AND APPROVED BY THE ARCHITECT PRIOR TO THE INSTALLATION OF ANY EQUIPMENT REQUIRING ACCESS.


ABBREVIATIONS

ABV	ABOVE	FEC	FIRE EXTINGUISHER CABINET
ACT	ACOUSTICAL CEILING TILE	FFE	FINISHED FLOOR ELEVATION
ADA	AMERICANS WITH DISABILITIES ACT	FH	FIRE HYDRANT
ADJ	ADJACENT	FLR	FLOOR
AFF	ABOVE FINISH FLOOR	FIN	FINISH
ALT	ALTERNATE	F.O.	FACE OF
ALUM	ALUMINUM	FOIC	FURNISHED BY OWNER/INSTA
во	BOTTOM OF	FOIC	CONTRACTOR
BTM	BOTTOM	FT	FOOT, FEET
C.I.P.	CAST IN PLACE	FTG	FOOTING
CJ	CONTROL JOINT	FURN	
CL	CENTER LINE	GA	FURNITURE
CLNG	CEILING	GALV	GAUGE
CLO	CLOSET		GALVANIZED
CLR	CLEAR	GC	GENERAL CONTRACTOR
CMU	CONCRETE MASONRY UNIT	GLAZ GWB	GLAZING
COL	COLUMN		GYPSUM BOARD
CONC	CONCRETE	GYP BD	GYPSUM BOARD
CONT	CONTINUOUS	HB	HOSE BIBB
CPT	CARPET	HC	HANDICAPPED
CSJ	CONSTRUCTION JOINT	HDWD	HARDWOOD
DIA	DIAMETER	HDWR	HARDWARE
DIM	DIMENSION	HM	HOLLOW METAL
DIST	DISTANCE	HORIZ	HORIZONTAL
ON	DOWN	HSS	HOLLOW STRUCTURAL SECTION
os	DOWNSPOUT	HVAC	HEATING, VENTILATING AND A
OSP	DRY STANDPIPE	INT	INTERIOR
OTL	DETAIL	LAM	LAMINATE
OWG	DRAWING	LAV	LAVATORY
A	EACH	LED	LIGHT EMITTING DIODE
.1	EXPANSION JOINT	MAX	AXIMUM
LEC	ELECTRICAL	MDF	MEDIUM DENSITY FIBERBOAR
LEV	ELEVATOR	MECH	MECHANICAL
Q	EQUAL/ EQUAL TO	MFR	MANUFACTURER
QUIP	EQUIPMENT	MIN	MINIMUM
WC	ELECTRIC WATER COOLER	MISC	MISCELLANEOUS
Α		MTL	METAL
DC	FIRE DEPARTMENT CONNECTION	N.I.C	NOT IN CONTRACT
E	CONNECTION	NTS	NOT TO SCALE

OC OD OH OPP PLAM PLY NGUISHER CABINET ON CENTER OUTSIDE DIAMETER OPPOSITE HAND OPPOSITE PLASTIC LAMINATE PLYWOOD ED BY OWNER/INSTALLED BY PREFIN PREFINISHED PRESSURE TREATED PTD PVC RCP RDL REF REQD RM R.O. S.C. SIM SPECS S.S. STL T.O. T.O.F. TRUCTURAL SECTION VENTILATING AND AIR COND. ENSITY FIBERBOARD

PAINTED
POLYVINYL CHLORIDE
REFLECTED CEILING PLAN
ROOF DRAIN LEADER REFERENCE REQUIRED ROOM ROUGH OPENING SOLID CORE STAINLESS STEEL TOP OF TOP OF FOOTING TYPICAL UNLESS NOTED OTHERWISE VERIFY IN FIELD WATER CLOSET

ANNOTATION LEGEND

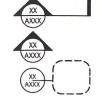

SECTION MARKER

FI EVATION MARKER DETAIL MARKER

STRUCTURAL COLUMN GRID



INTERIOR ELEVATION MARKER

ROOM NAME & NUMBER

ROOM NAME 1.0A

WALL CONSTRUCTION TYPE WINDOW MARKER

DXXX

DOOR NUMBER FINISHED FLOOR ELEVATION CLEARSCAPES

Lysaght & Associates 120 Saint Mary's Street Raleigh NC 27605

Sigma Engineered Solutions PC2100 Gateway Centre Blvd Suite 100 Morrisville, NC 27560 919.828.9346



PERMIT SET 03-02-2018

SITE **IMPROVEMENTS PLAY ANNEX** COURTYARD

Marbles Kids Museum 201 East Hargett Street Raleigh, NC 27601

NO. REVISION DATE

PROJECT NO: DRAWN: CHECKED:

COVER SHEET

BLOUNT STREET MARBLES MAIN MUSEUM PROJECT SITE: PLAY ANNEX COURTYARD MARBLES ANNEX MARBLES IMAX THEATER LONGVIEW OFFICE CONDOMINIUM PERSON STREET

CLEARSCAPES
ARCHITECTURE - ART
311-200 W. Marin Street | Raleigh, NC 27601
919.821.2775 | www.clearscapes.com

0004700

Lysaght & Associates 120 Saint Mary's Street Raleigh, NC 27605 919 833 0495

Sigma Engineered Solutions PC2100 Gateway Centre Blv Suite 100 Morrisville, NC 27560





PERMIT SET 03-02-2018

MART

SITE IMPROVEMENTS PLAY ANNEX COURTYARD


Marbles Kids Museum 201 East Hargett Street Raleigh, NC 27601

NO. REVISION DATE

PROJECT NO: DRAWN: CHECKED: DATE:

03.02.2018

ARCHITECTURAL SITE PLAN

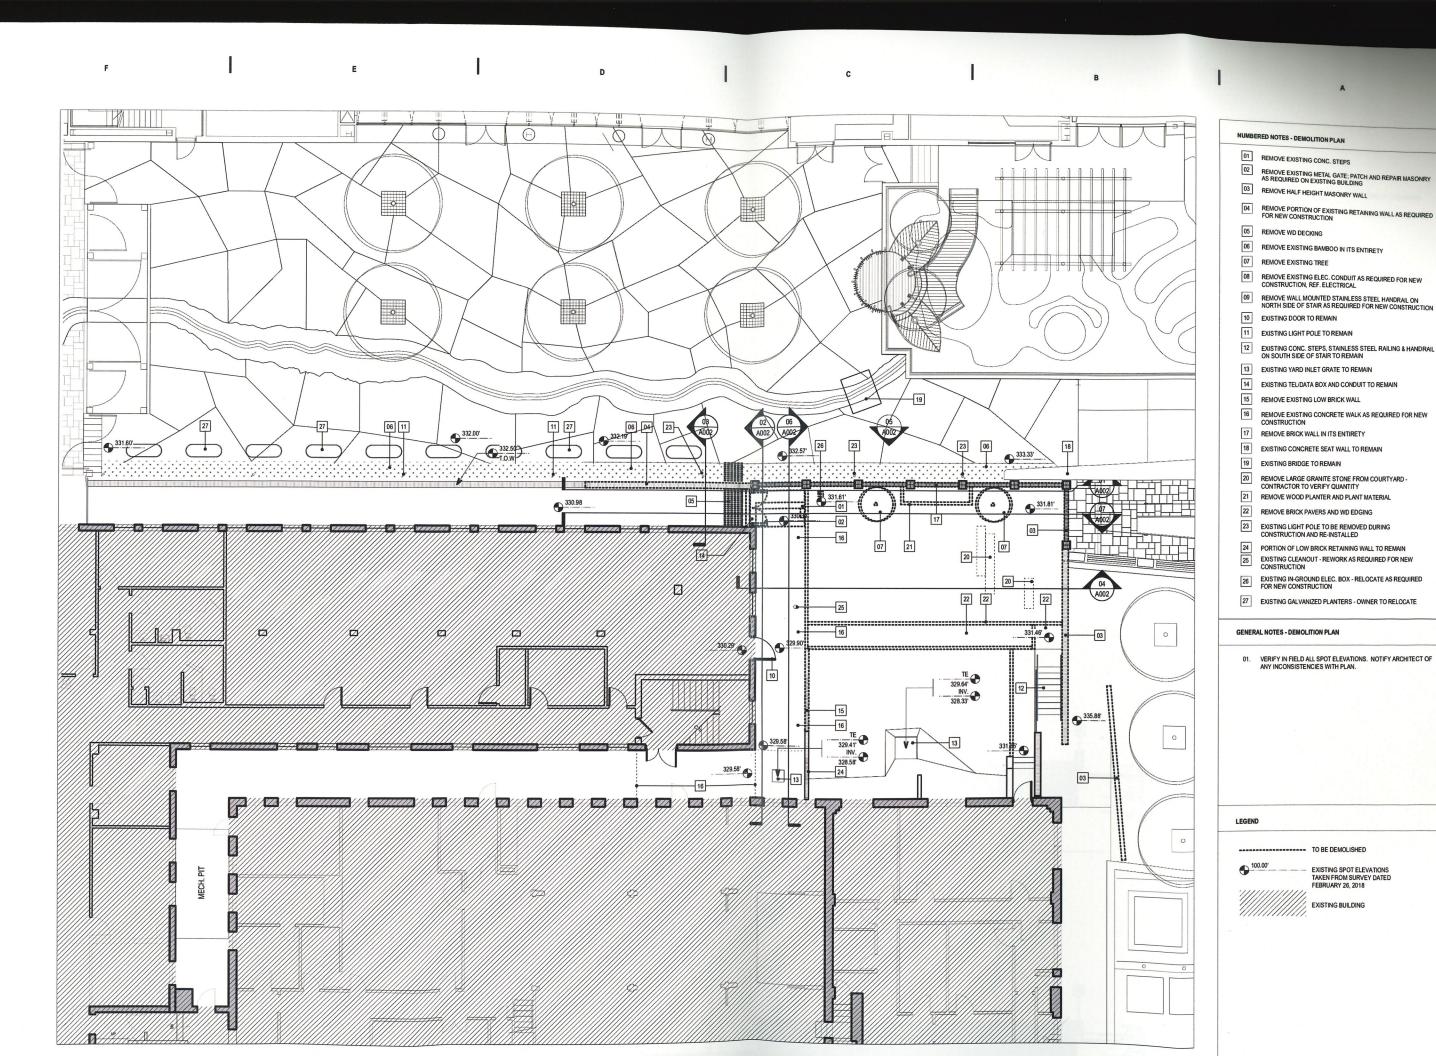

CLEARSCAPES

Lysaght & Associates 120 Saint Mary's Street Raleigh, NC 27605 919.833.0495

Sigma Engineered Solutions PC2100 Gateway Centre Blvd Suite 100 Morrisville, NC 27560 919.828.9346



PERMIT SET 03-02-2018

SITE **IMPROVEMENTS PLAY ANNEX** COURTYARD

Marbles Kids Museum 201 East Hargett Street Raleigh, NC 27601


- TO BE DEMOLISHED

EXISTING SPOT ELEVATIONS TAKEN FROM SURVEY DATED FEBRUARY 26, 2018 EXISTING BUILDING

PROJECT NO: DRAWN: CHECKED:

03.02.2018

DEMOLITION SITE PLAN

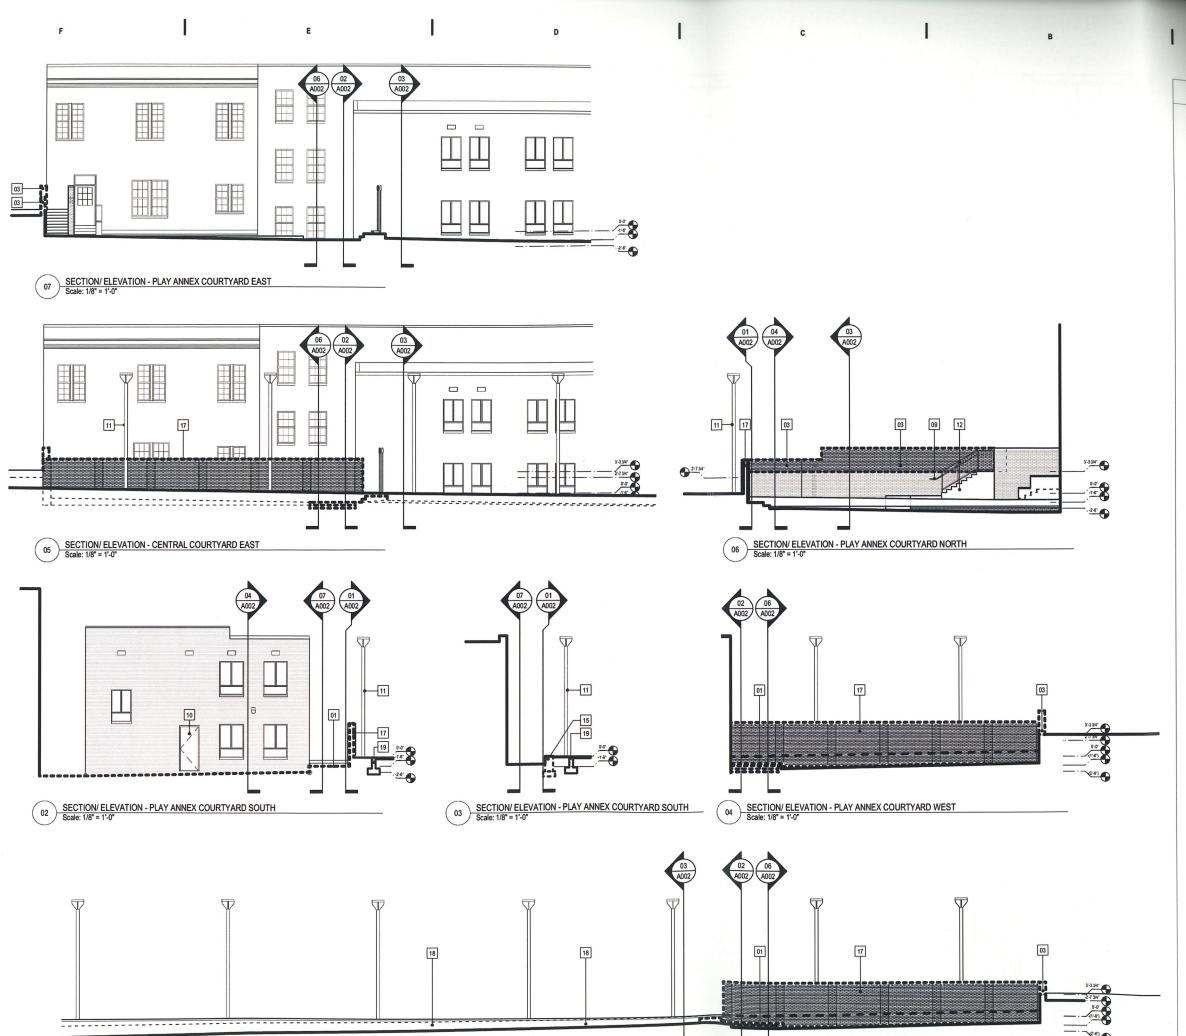

REMOVE EXISTING CONC. STEPS 02

REMOVE EXISTING METAL GATE; PATCH AND REPAIR MASONS

B3 REMOVE UPPER PORTION OF MASONRY WALL AS REQUIRED FOR NEW CONSTRUCTION

REMOVE PORTION OF EXISTING RETAINING WALL AS REQUIRE FOR NEW CONSTRUCTION

05 REMOVE WD DECKING

06 REMOVE BRICK PAVERS AND WD EDGING

06 REMOVE EXISTING BAMBOO IN ITS ENTIRETY 07 REMOVE EXISTING TREE

08 REMOVE EXISTING ELEC. CONDUIT AS REQUIRED FOR NEW CONSTRUCTION, REF. ELECTRICAL

09 REMOVE WALL MOUNTED STAINLESS STEEL HANDRAIL ON NORTH SIDE OF STAIR AS REQUIRED FOR NEW CONSTRUCTION 10 EXISTING DOOR TO REMAIN

11 EXISTING LIGHT POLE TO REMAIN

12 EXISTING CONC. STEPS, STAINLESS STEEL RAILING & HANDRAIL ON SOUTH SIDE OF STAIR TO REMAIN

13 EXISTING DRAIN GRATE TO REMAIN

14 EXISTING TEL/DATA BOX AND CONDUIT TO REMAIN

15 REMOVE EXISTING LOW BRICK RETAINING WALL

REMOVE EXISTING CONCRETE WALK AS REQUIRED FOR NEW CONSTRUCTION

17 REMOVE MASONRY WALL IN ITS ENTIRETY

18 EXPOSED ELECTRICAL CONDUIT AND FLOOD LIGHTS MOUNTED TO INSIDE FACE OF EXISTING RETAINING WALL-REF. ELECTRICAL DRAWINGS FOR EXTENT OF DEMOLITION

19 EXISTING SLAB & CONCRETE FOOTING TO REMAIN

CLEARSCAPES
A 1 C H 1 T C T U R V A R
311-200 W. Marin Street | Raleigh, NC 270
918.821.2775 | www.clearscapes.com





PERMIT SET 03-02-2018

SITE **IMPROVEMENTS PLAY ANNEX**


Marbles Kids Museum 201 East Hargett Street Raleigh, NC 27601

COURTYARD

PROJECT NO: DRAWN: CHECKED: DATE:

03 02 2018

DEMOLITION SITE SECTIONS/ ELEVATIONS

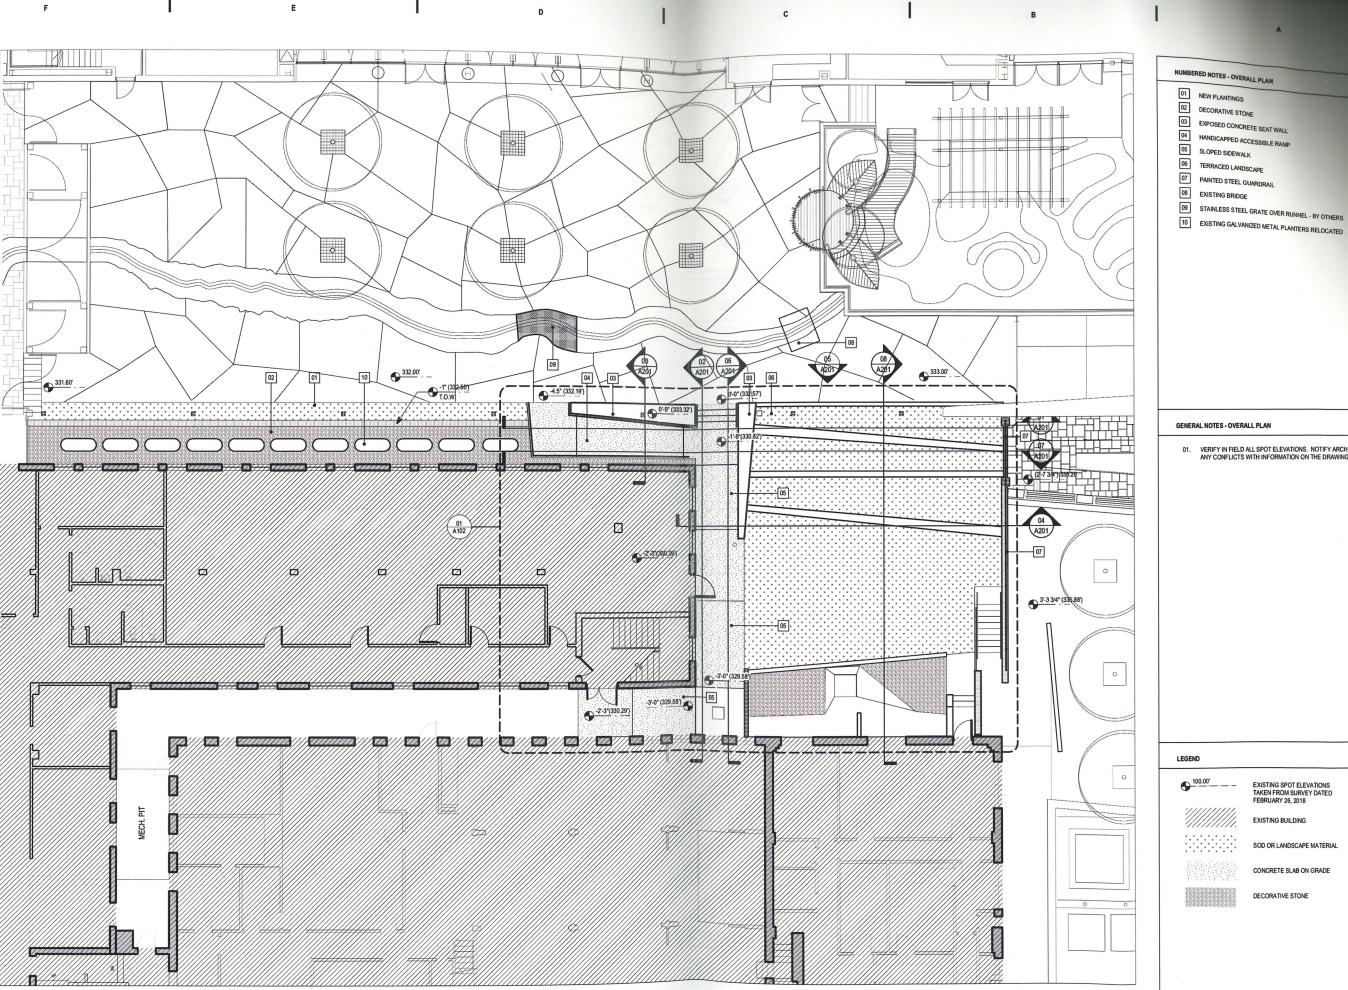

GENERAL NOTES - OVERALL PLAN

01. VERIFY IN FIELD ALL SPOT ELEVATIONS. NOTIFY ARCHITECT OF ANY CONFLICTS WITH INFORMATION ON THE DRAWINGS.

EXISTING SPOT ELEVATIONS TAKEN FROM SURVEY DATED FEBRUARY 26, 2018

SOD OR LANDSCAPE MATERIAL CONCRETE SLAB ON GRADE

EXISTING BUILDING

DECORATIVE STONE





PERMIT SET 03-02-2018

SITE **IMPROVEMENTS PLAY ANNEX** COURTYARD


Marbles Kids Museum 201 East Hargett Street Raleigh, NC 27601

1 10/31/2017 ADDENDUM #1

PROJECT NO: DRAWN: CHECKED: DATE:

03.02.2018

OVERALL PLAN

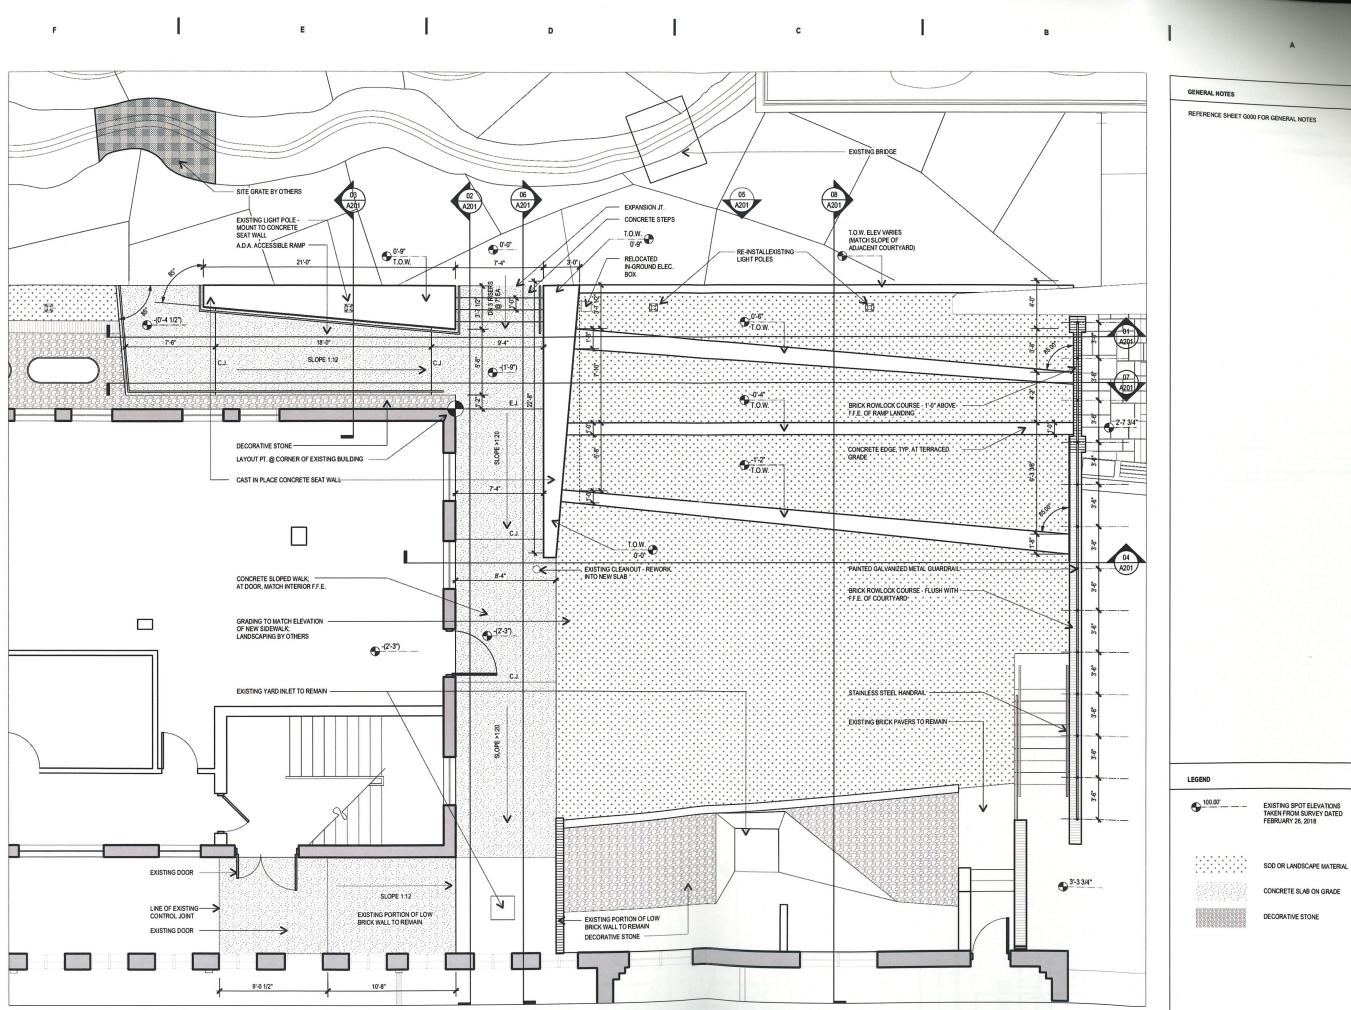

CLEARSCAPES
ARCHITICTURE - ART
311-200 W. Marin Street | Rabeth, NC 27801
919.8212775 | www.clearscapes.com

Sigma Engineered Solutions PC2100 Gateway Centre Blvd Suite 100 Morrisville, NC 27560 919.828.9346





PERMIT SET 03-02-2018

SITE **IMPROVEMENTS PLAY ANNEX** COURTYARD


Marbles Kids Museum 201 East Hargett Street Raleigh, NC 27601

10/31/2017 ADDENDUM#1


PROJECT NO:

CHECKED: DATE: 03.02.2018

ENLARGED PLAN

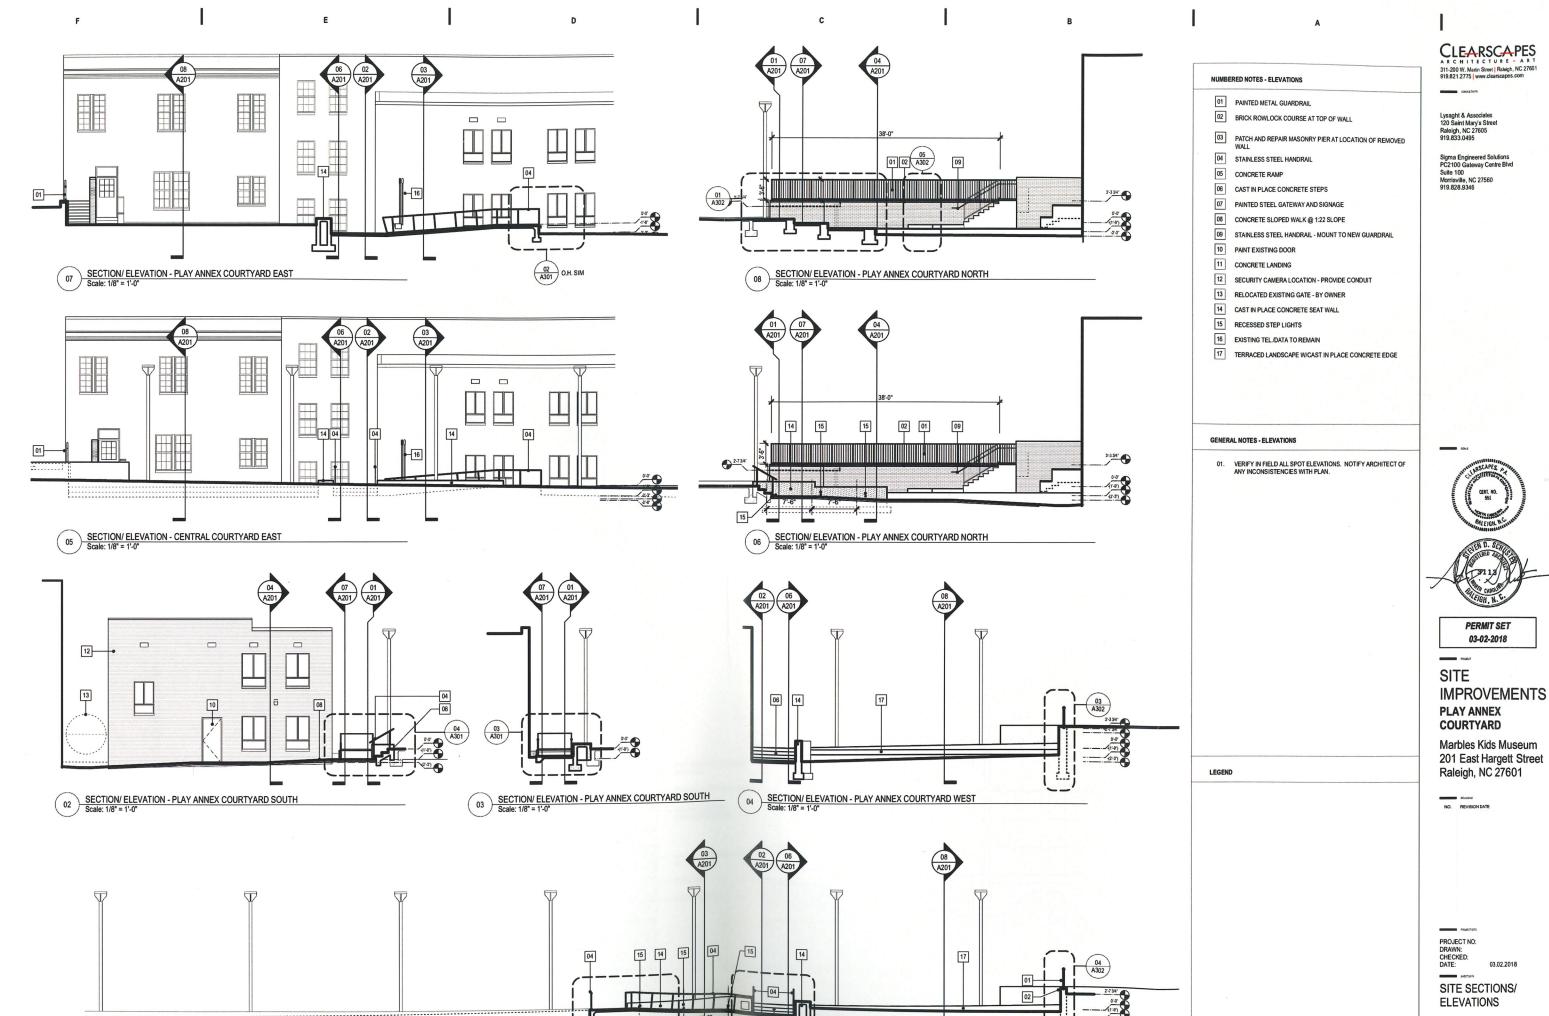

ELEVATIONS

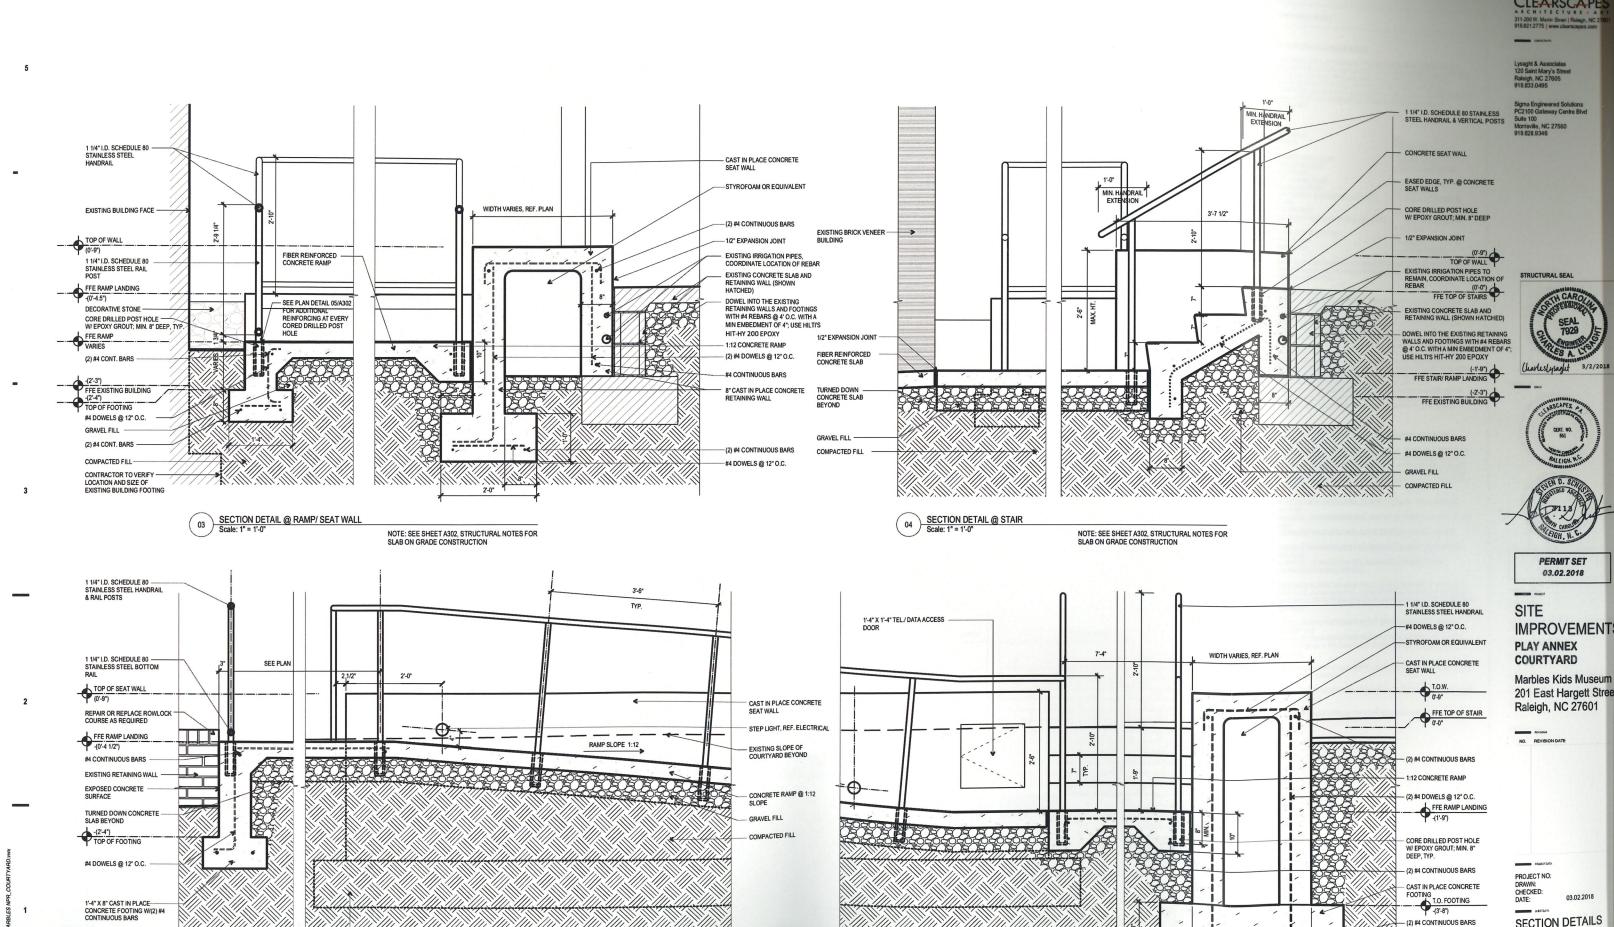

CONCRETE SEAT WALL FOOTING FOOTING BEYOND ARCHITECTURE A 311-200 W. Martin Street Raleigh, NC 270 919.821.2775 | www.clearscapes.com






IMPROVEMENT

201 East Hargett Street

SECTION DETAILS

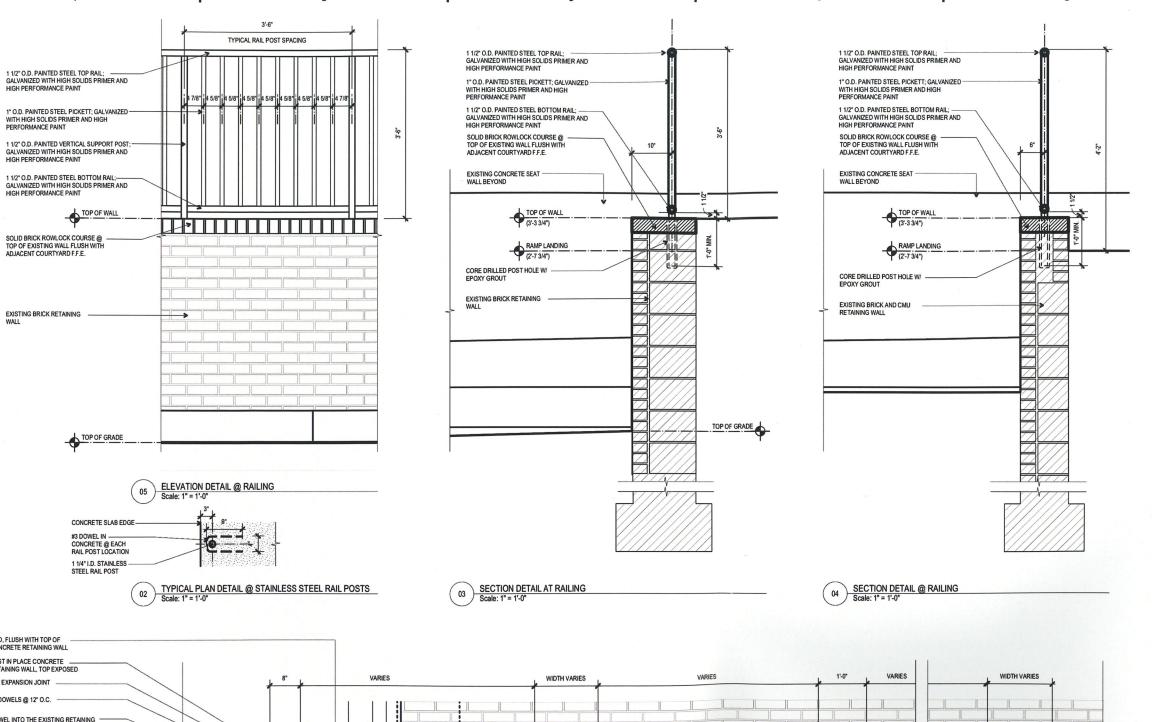

5

3

2

SOD, FLUSH WITH TOP OF CONCRETE RETAINING WALL CAST IN PLACE CONCRETE RETAINING WALL, TOP EXPOSED 1/2" EXPANSION JOINT #4 DOWELS @ 12" O.C. DOWEL INTO THE EXISTING RETAINING WALLS AND FOOTINGS WITH #4 REBARS @ 4' O.C. WITH A MIN EMBEDMENT OF 4": USE HILTI'S HIT-HY 200 EPOXY VARIES WITH ADJACENT COURTYARD F.F. (0'-0") TOP OF WALL PLANTING SOIL, MIN. 3" DEPTH -(0'-4") (2) #4 CONTINUOUS BARS 11 (2) #4 DOWELS @ 12" O.C. FINISHED GRADE EXISTING IRRIGATION PIPES GRAVEL FILL COORDINATE LOCATION OF REBAR " PERFORATED DRAIN. (2) #4 CONTINUOUS BARS TIE INTO EXISTING STORM LINE LOCATION OF DEMOLISHED WALL AND FOOTING SHOWN FOR (2) #4 CONTINUOUS BARS COMPACTED FILL

STRUCTURAL NOTES

SLAB-ON-GRADE CONSTRUCTION

CONCRETE SHALL BE DESIGNED TO MEET 4000 PSI COMPRESSIVE STRENGTH @ 28 DAYS AND EXHIBIT <0.04% SHRINKAGE @ 28 DAYS. THE MIX SHALL CONTAIN APPROXIMATELY 12 CUBIC FEET OF COARSE AGGREGATE (11/4" TOP SIZE), THE SPECIFIED WATER REDUCING ADMIXTURE (AND ACHIEVE A WICM RATIO OF 0.53 (MAX.). INTERIOR SLABS SHALL NOT BE AIR-ENTRAINED; EXTERIOR SLABS SHALL BE AIR ENTRAINED.

MATERIALS CEMENT COARSE AGGREGATE FINE AGGREGATE NECESSARY) TUF-STRAND FIBER WATER CONTENT AIR CONTENT (ENTRAPPED AIR ONLY)
SLABS AIR CONTENT
MID-RANGE WATER REDUCER (TYPE A/F)

7 CU FT +/- (ADJUST AS 3 LBS/ CU YD 250 – 300 LBS. 3.0% (MAX.) AT INTERIOR 4% - 6% AT EXTERIOR SLABS

MIX 517-560 LBS. ASH/SLAG PROHIBITED 12 CU FT +/- .50

INITIAL SLUMP (WATER) FINAL SLUMP

30Z.-100Z./100WT +/-0.53 (MAX.) 5.5" (MAX.) < 0.04% @ 28 DAYS

CALCIUM CHLORIDE OR ADMIXTURES CONTAINING MORE THAN 0.05% CHLORIDE IONS ARE NOT PERMITTED. FLYASH, SLAG, AND BOTTOM ASH

INTERIOR CURING
MOISTURE RETAINING COVER: ALL INTERIOR CONCRETE SLABS SHALL
BE PROTECTED FROM PREMATURE DRYING FOR A MINIMUM OF FIVE
DAYS, AS REQUIRED IN ACT 301, USING MOISTURE-RETAINING COVER.
FLOOD THE INTERIOR SLAB WITH SUFFICIENT WATER TO COVER THE SLAB, COVER CONCRETE SURFACES WITH MOISTURE-RETAINING COVER, PLACED IN WIDEST PRACTICAL WIDTH WITH SIDES AND ENDS LAPPED AT LEAST 3" AND SEALED BY WATERPROOF TAPE OR ADHESIVE.

MIMEDIATELY REPAIR ANY HOLES OR TEARS DURING CURING PERIOD

USING COVER MATERIAL AND WATERPROOF TAPE REMOVE ANY AIR

BUBBLES IN BETWEEN THE COVER AND THE INTERIOR SLAB. AFTER THE MINIMUM FIVE DAY CURING PERIOD, REMOVE MOISTURE-RETAINING COVER AND IMMEDIATELY SCRUB THE ENTIRE AREA WITH AUTO-SCRUBBER AND INTERIOR CONCRETE FLOOR CLEANER, AFTER INTERIOR CONCRETE SLAB IS THOROUGHLY CLEANED OF ALL SALTS, LAITANCE, DIRT AND DEBRIS, ALLOW DRYING FOR AT LEAST SIX (6) HOURS.

EXTERIOR CURING AND SEALING
ASTM C1315, TYPE I, CLASS B, (700G/L): LIQUID TYPE MEMBRANE
FORMING CURING

COMPOUND, CLEAR STYRENE ACRYLATE TYPE, COMPLYING WITH ASTM CONFOUND, CLEAS B, 20% SOLIDS CONTENT MINIMUM, MOISTURE
LOSS SHALL BE NOT MORE THAN 0.30 KGM2 WHEN APPLIED AT 300 SO.
FT/GALL MANUFACTURERS CERTIFICATION IS REQUIRED, ACCEPTIBALE
PRODUCTS: "SUPER REZ SEAL" BY EUCLID CHEMICAL OR "KUREN SEAL"

PLACE FLOOR SLAB ON A WELL COMPACTED BASE. THE SUBGRADE SHALL BE GRANULAR, NON-EXPANSIVE SOIL (THAT IS, WITHOUT CLAY), WHICH HAS

BEEN
COMPACTED TO AT LEAST 95% AND VERIFIED BY ON-SITE TESTING.

CONCRETE STRENGTH SHALL BE 4000 PSI AT 28 DAYS. USE A WATER REDUCING
ADMIXTURE TO REDUCE WATER, INCREASE WORKABILITY AND
DECREASE SHRINKAGE CRACKS.

THE CONTROL JOINT SPACING SHALL BE APPROXIMATELY 12 FOR A 4" THICK SLAB, PLACE CONTROL JOINTS TO AVOID REENTRANT CORNERS. MAKE SAWCUTS TO FORM WEAKEN PLANE CONTROL JOINTS AS SOON AS POSSIBLE.

LIGHTLY DAMPEN THE SUBGRADE BEFORE PLACING CONCRETE TO PREVENT THE

SUBGRADE FROM ABSORBING WATER FROM CONCRETE MIX. APPLY WATER AT NEARLY THE SAME RATE IT SOAKS INTO THE SUBGRADE SURFACE.

STEEL TROWEL THE CONCRETE TO A SHINY FINISH WHICH RESULTS IN A HARD, DENSE SURFACE.

DURING HOT WEATHER, USE A FOG SPRAY TO KEEP THE SURFACE DAMP

START CURING AS SOON AS THE FINISHERS ARE DONE.

CLEARSCAPES

Lysaght & Associates 120 Saint Mary's Street Raleigh, NC 27605 919.833.0495

Sigma Engineered Solutions PC2100 Gateway Centre Blvd Suite 100 Morrisville, NC 27560 919.828.9346

STRUCTURAL SEAL





PERMIT SET 03.02.2018

SITE **IMPROVEMENTS PLAY ANNEX** COURTYARD

Marbles Kids Museum 201 East Hargett Street Raleigh, NC 27601

PROJECT NO: DRAWN: CHECKED: DATE:

03.02.2018

SECTION DETAILS