

APPLICATION FOR A CERTIFICATE OF APPROPRIATENESS – STAFF REPORT

090-17-CA 605 N BLOUNT STREET

Applicant: MOBILITIE, LLC

Received: 5/10/2017 <u>Meeting Date(s)</u>:

<u>Submission date + 90 days</u>: 8/8/2017 1) 6/22/2017 2) 3)

INTRODUCTION TO THE APPLICATION

Historic District: BLOUNT STREET HISTORIC DISTRICT

Zoning: HOD-G

Nature of Project: Installation of small cell utility pole with antenna at overall height of 50 feet

APPLICABLE SECTIONS OF GUIDELINES and DESCRIPTION OF PROJECT

<u>Sections</u> <u>Topic</u> <u>Description of Work</u>

1.1 Public Rights-of- Installation of small cell utility pole with antenna at overall height

Way and Alleys of 50 feet

STAFF REPORT

Based on the information contained in the application and staff's evaluation:

- A. Installation of small cell utility pole is not incongruous in concept according to *Guidelines* 1.1.2, 1.1.2; however installation of a small cell utility pole with an antenna at an overall height of 50 feet **may be** incongruous according to *Guidelines* 1.1.10 and the following suggested facts:
- 1* The proposal is for a 47-foot tall wood pole with a 3-foot antenna on top bringing the total height to 50 feet. Equipment will be mounted at various heights on the pole starting at 6 feet above the ground.
- 2* The applicant states that the three wood poles nearest to the proposed pole are approximately 40ft with ancillary electrical equipment protruding approximately 2ft above pole height.
- 3* The pole is proposed to be located in the grass right-of-way near an unused entry drive off of Blount Street adjacent to a William Peace University parking lot. A photographic simulation of the proposal is included in the application.
- 4* The location of the proposed pole is incorrect on the location maps page of the application packet.

- 5* On the planning page (p. 18) of Public Rights-of-Way and Alleys section of the *Guidelines* it states that "Public right-of-way features such as trees, streetlights, benches, ground cover, sidewalk paving patterns, curbs, and gutters contribute to a district's character, as do necessary transportation and communication features, such as utility lines and poles, transformers, traffic signs, vending machines, transit stops, and parking booths.

 Consequently, maintaining the distinctive visual ambiance of a district requires attention to its streets and alleys and their features. Right-of-way characteristics vary from district to district; some vary within districts."
- 6* The commission recently approved a 37′ tall new wood pole with antenna and equipment at the southern end of the Blount Street (COA 073-17-CA) This pole was within 3 feet in height of the nearby poles.

Pending the committee's determination decision regarding the height of the pole with antenna, staff suggests that the committee approve the application with the following condition:

- 1. That the new pole and antenna be no more than 3' taller than wood poles within a half block of the proposed pole.
- 2. That the revised pole height and associated equipment be provided to and approved by staff prior to the issuance of the blue placard.

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Raleigh Historic Development Commission – Certificate of Appropriateness (COA) Application



Development Services
Customer Service Center
One Exchange Plaza
1 Exchange Plaza, Suite 400
Raleigh, North Carolina 27601
Phone 919-996-2495
eFax 919-996-1831



☐ Minor Work (staff rev ☐ Major Work (COA Co ☐ Additions Greate ☐ New Buildings ☐ Demo of Contrib ☐ All Other ☐ Post Approval Re-rev	mmittee review) – 1 er than 25% of Build outing Historic Reso	ling Square Footage urce	For Office Use Only Transaction # 090 - 17 - CA File # Amount Paid Amount Paid Received Date Received By Received By
Property Street Address 605	N. Blount St.		
Historic District Blount Stre	eet		
Historic Property/Landmark nam	e (if applicable)	N/A	
Owner's Name NCDOT	Public ROW of Blou	nt St.	
Lot size N/A	(width in feet)	N/A	(depth in feet)
	i.e. both sides, in fro		provide addressed, stamped envelopes to owners , and behind the property) not including the width
Property Ad	ldress		Property Address
15 E. Peace St Raleigh, NC	27604	549 N.	Blount St. Raleigh, NC 27604
6820 Greystone Dr. Raleig	h, NC 27615	540 N	. Blount St. Raleigh, NC 27604
549 N. Blount St. Raleigh,	NC 27604	612	N. Blount St. Raleigh, NC 27604
1123 Old Lystra Rd. Chapel	Hill, NC 27517		

I understand that all applications that require review by the commission's Certificate of Appropriateness Committee must be submitted by 4:00 p.m. on the application deadline; otherwise, consideration will be delayed until the following committee meeting. An incomplete application will not be accepted.

1000	
State GA	Zip Code 30305
Daytime Phone 919-604-2736	
s for this project? ☐ Yes ☐ XNo Tyl	Office Use Only pe of Work
ication? 🗹 Yes 🗌 No	
	Daytime Phone 919-604-2736 s for this project? Yes No Ty

Design	Guidelines - Please cite the	he applicable sections of the design guidelines (<u>www.rhdc.org</u>).
Section/Page	Topic	Brief Description of Work (attach additional sheets as needed)
		Construction of small cell utility pole with antenna at an overall held of 50ft.

Minor Work Approval <u>(office use only)</u>
Upon being signed and dated below by the Planning Director or designee, this application becomes the Minor Work Certificate of
Appropriateness. It is valid until Please post the enclosed placard form of the certificate as indicated at
the bottom of the card. Issuance of a Minor Work Certificate shall not relieve the applicant, contractor, tenant, or property owner from
obtaining any other permit required by City Code or any law. Minor Works are subject to an appeals period of 30 days from the date
of approval.
Signature (City of Raleigh) Date

TO BE COMPLETED BY APPLICANT			TO BE COMPLETED BY CITY STAFF			
		YES	N/A	YES	NO	N/A
and oth below to	3-1/2" x 11" or 11" x 17" sheets with written descriptions and drawings, photographs, or graphic information necessary to completely describe the project. Use the checklist to be sure your application is complete. Work (staff review) – 1 copy Work (COA Committee review) – 10 copies	х		X		
iviajor v	Written description. Describe clearly and in detail the nature of your project.					
	Include exact dimensions for materials to be used (e.g. width of siding, window trim, etc.)	X		X		
2.	Description of materials (Provide samples, if appropriate)	×		X		
3.	Photographs of existing conditions are required. Minimum image size 4" x 6" as printed. Maximum 2 images per page.	X		X		
4.	Paint Schedule (if applicable)		X			X
5.	<u>Plot plan</u> (if applicable). A plot plan showing relationship of buildings, additions, sidewalks, drives, trees, property lines, etc., must be provided if your project includes any addition, demolition, fences/walls, or other landscape work. Show accurate measurements. You may also use a copy of the survey you received when you bought your property. Revise the copy as needed to show existing conditions and your proposed work.	Ø		X		
6.	Drawings showing existing and proposed work					
	□ Plan drawings					
	☐ Elevation drawings showing the façade(s)			1		
	☐ Dimensions shown on drawings and/or graphic scale (required)	X		X		
	□ 11" x 17" or 8-1/2" x 11" reductions of full-size drawings. If reduced size is so small as to be illegible, make 11" x 17" or 8-1/2" x 11" snap shots of individual drawings from the big sheet.					
7.	Stamped envelopes addressed to all property owners within 100 feet of property not counting the width of public streets and alleys (required for Major Work). Use the <u>Label Creator</u> to determine the addresses.	X		4		
8.	Fee (See Development Fee Schedule)	Z		X		
				CONTROL SECURE	STREET, CHARLES	A STREET STREET, STREET



Mobilitie, LLC 3475 Piedmont Rd. NE. Suite 1000 Atlanta, GA 30305 Tel: 919-604-2736 www.mobilitie.com

May 9, 2017

Tania Georgiou Tully Planner II PO Box 590 Raleigh, NC 27602

RE: MOBILITIE, LLC'S SMALL CELL UTILITY POLE APPLICATION 605 N. BLOUNT ST. ROW

Dear Tania:

Thank you for your time at our previous meeting to discuss Mobilitie's plans within the NCDOT ROW of Blount St. and within the Blount St. Historic District.

Specifically, Mobilitie is deploying infrastructure to form a network that will provide high-speed, high-capacity bandwidth and mobile connectivity to service the residents, businesses and visitors of Raleigh.

SMALL CELLS SITES

Mobilitie's Small Cell Sites involves the installation of small, low-powered wireless facilities, consisting of a transmit-receive antenna that communicates with wireless devices, a wireless backhaul antenna that connects the facility to the carrier's core network, and compact radio equipment mounted on either new or existing utility or light poles. These Small Cells add coverage and capacity to the existing wireless networks, and are designed to blend with existing infrastructure. Enclosed are elevations detailing the specifics of the pole, antenna, and other ancillary equipment along with the Site Plan and Cover Sheet depicting the actual location of the candidate.

REQUEST FOR APPROVAL

Mobilitie respectfully requests that the Historic Review Board consider and approve a Certificate of Appropriateness (COA) for the enclosed application. The application consists of a 15-inch diameter, 47ft wooden pole with 3ft antenna totaling 50ft above ground level. Mobilitie values both the staff and board(s) input to the proposal, and will work closely throughout the permitting and construction process. Please do not hesitate to contact me at 919-604-2736 or mhicks@mobilitie.com if you may need any additional information. Thank you for your attention to this matter.

Respectfully submitted,

Michael Hicks Permitting Manager

Schedule of Enclosure:

Cover Sheet, Site Plan/Plot Plan, and Pole Elevations (10 copies)

COA Application

Stamped Self Addressed Envelopes within 100ft of parcel that proposed pole is fronting.

Copy of Receipt for Payment of Application Fee

Robb, Melissa

From:

Michael Hicks < MHicks@mobilitie.com>

Sent:

Monday, June 05, 2017 8:36 AM

To:

Tully, Tania; Robb, Melissa

Subject:

FW: Blount St. Rendering 090-17-CA (605 N Blount Street)

Attachments:

RA90XS096A_9NCB000849A_SIMs (1).jpg

Tania and Melissa,

Please see attached rendering in case you may need this for your files.

Also when you have a moment let me know if the application will proceed either under a major or minor encroachment.

Thanks,

Michael Hicks | NRE Permitting Manager | 919-604-2736 mobile

-----Original Message-----From: Michael Hicks

Sent: Thursday, June 01, 2017 3:40 PM To: Michael Hicks <MHicks@mobilitie.com>

Subject: Blount St. Rendering

Your message is ready to be sent with the following file or link attachments:

RA90XS096A 9NCB000849A SIMs (1)

Note: To protect against computer viruses, e-mail programs may prevent sending or receiving certain types of file attachments. Check your e-mail security settings to determine how attachments are handled.



Tully, Tania

From: Michael Hicks <MHicks@mobilitie.com>
Sent: Thursday, June 08, 2017 11:35 AM

To: Tully, Tania; Robb, Melissa

Cc: Tannyka Bent

Subject: RE: Blount St. Rendering 090-17-CA (605 N Blount Street)

Attachments: 2017-06-08 Small Cell Pole Example to Raleigh.pdf; Photo of Existing Nearby Utility

Pole.jpg

Tania,

Below are answers to your questions.

- 1. The are several poles (3) nearest to the proposed candidate which are approximately 40ft with ancillary electrical equipment protruding approximately 2ft above pole height. The material type is wooden for all nearby poles. Some of the nearby poles house just overhead electric lines while other poles contain a combination of overhead lines and street lights. Further away from the candidate location are other wooden poles that range in approximate heights from 30ft 40ft. The nearest pole, which is located directly across Blount St is shown on the attached photo. Again, the overall height with equipment is approximately 42ft.
- 2. Our pole is 46.8 (round up to 47) feet with a 3ft antenna on top. Thus, the overall antenna height of 50ft. The material type of the proposed pole is wood.
- 3. Best example to demonstrate what the antenna looks like can be seen on attached pdf document.
- 4. Best example to demonstrate what the equipment looks like can be seen on attached pdf document.

Michael Hicks | NRE Permitting Manager | 919-604-2736 mobile

----Original Message-----From: Michael Hicks

Sent: Tuesday, June 06, 2017 1:53 PM

To: 'Tully, Tania' < Tania. Tully@raleighnc.gov >; Robb, Melissa < Melissa. Robb@raleighnc.gov >

Cc: Tannyka Bent <tannyka.bent@mobilitie.com>

Subject: Blount St. Rendering 090-17-CA (605 N Blount Street)

Tania,

I will get you information back tomorrow to answer your below questions.

Michael Hicks | NRE Permitting Manager | 919-604-2736 mobile

----Original Message-----

From: Tully, Tania [mailto:Tania.Tully@raleighnc.gov]

Sent: Tuesday, June 06, 2017 1:30 PM

To: Michael Hicks < MHicks@mobilitie.com>; Robb, Melissa < Melissa.Robb@raleighnc.gov>

1

Subject: RE: Blount St. Rendering 090-17-CA (605 N Blount Street)

Hi Michael -

This item will remain on the agenda for the RHDC.



SITE ID-CANDIDATE LETTER/CASCADE ID-CANDIDATE LETTER: 9NCB000849A/RA90XS096A

LATITUDE/LONGITUDE: 35.788401/-78.636082

CROSS STREET:

N BLOUNT ST & PEACE STREET

CITY, STATE, ZIP: RALEIGH, NC 27604 (WAKE COUNTY)



IF YOU DIG IN ANY STATE
DIAL 811 FOR THE LOCAL
"ONE CALL CENTER" —
IT'S THE LAW

THE UTILITIES SHOWN HEREIN ARE FOR THE CONTRACTORS CONVENIENCE ONLY. THERE MAY BE OTHER UTILITIES NOT SHOWN ON THESE PLANS, THE ENGINEER/SURVEYOR ASSUMES NO RESPONSIBILITY FOR THE LOCATIONS SHOWN AND IT SHALL BE THE CONTRACTOR'S RESPONSIBILITY TO VERFY ALL THE UTILITIES WITHIN THE LUMBS OF THE WORK ALL DAMGE MADE TO THE (2) UTILITIES BY THE CONTRACTOR SHALL BE THE CONTRACTOR SHALL BE THE

GENERAL NOTES

THE FACILITY IS UNMANNED AND NOT FOR HUMAN HABITATION. A TECHNICIAN WILL VISIT THE SITE AS REQUIRED FOR ROUTINE MAINTENANCE, THE PROJECT WILL NOT RESULT IN ANY SIGNIFICANT DISTURBANCE OF EFFECT ON DRAINAGE; NO SANITARY SEWER SERVICE, POTABLE WATER OR TRASH DISPOSAL IS REQUIRED AND NO COMMERCIAL SIGNAGE IS PROPOSED.


SITE	INFORMATION
SITE ID:	9NCB000849A
CASCADE ID:	RA90XS096A
LATITUDE:	35.788401
LONGITUDE:	-78.636082
CROSS STREET:	N BLOUNT ST & PEACE STREET
CITY, STATE, ZIP:	RALEIGH, NC 27604
COUNTY:	WAKE COUNTY
JURISDICTION:	CITY OF RALEIGH
PROPERTY OWNER:	PUBLIC RIGHT-OF-WAY
APPLICANT:	MOBILITIE, LLC 3475 PIEDMONT ROAD NE; SUITE 1000 ATLANTA, GEORGIA 30305 PHONE: (312) 638-5400

ENGINEER

JACOBS ENGINEERING GROUP, INC. 5449 BELLS FERRY ROAD ACWORTH, GA 30102 CONTACT: KARL KRATINA PROJECT MANAGER TEL: (678) 460-1416 PROJECT: ER600201

DO NOT SCALE DRAWINGS

CONTRACTORS SHALL VERIFY ALL PLANS, (E) DIMENSIONS & FIELD CONDITIONS ON THE JOB SITE & SHALL IMMEDIATELY NOTIFY THE ARCHITECT/ENGINEER IN WRITING OF ANY DISCREPANCIES BEFORE PROCEEDING WITH THE WORK OR BE RESPONSIBLE FOR SAME.

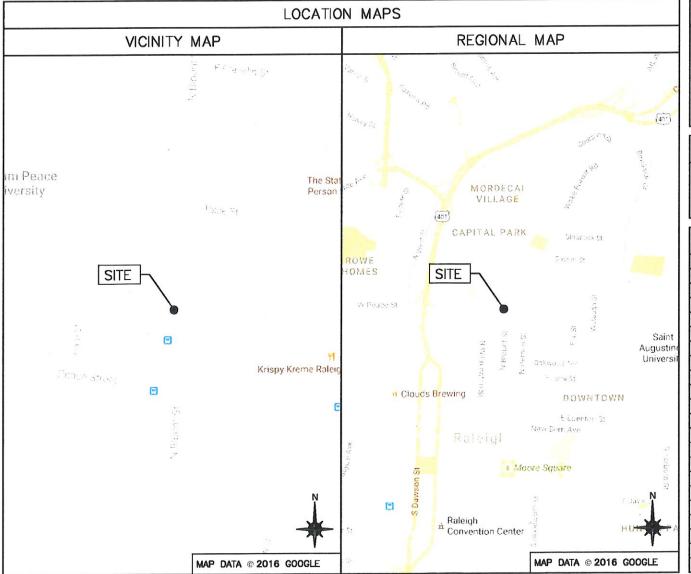

PROJECT DESCRIPTION

END USER PROPOSES TO INSTALL ANTENNA EQUIPMENT ON A NEW WOOD POLE WITHIN AN EXISTING RIGHT-OF-WAY.

THE SCOPE WILL CONSIST OF THE FOLLOWING:

- INSTALL A NEW WOOD UTILITY POLE WITH PROPOSED BACKHAUL TRANSPORT EQUIPMENT

CODES

2015 INTERNATIONAL BUILDING CODE 2014 NATIONAL ELECTRICAL CODE TIA/EIA-222-G-2 OR LATEST EDITION LOCAL BUILDING/PLANNING CODE

	DRAWING INDEX
SHEET NO:	SHEET TITLE
T-1	TITLE SHEET
SP-1	EXHIBIT PHOTO & SITE PLAN
EV-1	POLE ELEVATIONS
PL-1	PLUMBING & RISER DIAGRAM
EQ-1	EQUIPMENT DETAILS
EQ-2	EQUIPMENT DETAILS
EX−1	EXCAVATION DETAILS
E-1	ELECTRICAL DETAILS
G-1	GROUNDING DETAILS
S-1	POLE EMBEDMENT DETAILS
TC-1	VEHICULAR TRAFFIC CONTROL PLAN
TC-2	PEDESTRIAN SAFETY PLAN
GN-1	GENERAL NOTES
GN-2	GENERAL NOTES
GN-3	GENERAL NOTES




3475 PIEDMONT ROAD NE SUITE 1000 ATLANTA, GEORGIA 30305 PHONE: (312) 638-5400

PROJECT NO:	ER600201
DRAWN BY:	J. LAURETA
CHECKED BY:	B. POTESTA

PRELIM - NOT FOR CONSTRUCTION

_	-	
_		
D	04.26.17	INCLUDE SAS
С	04.19.17	UPDATE ANTENNA HEIGHT
В	11.15.18	JURISDICTIONAL REVISION
A	07.08.16	FOR REVIEW

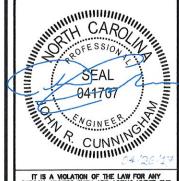

IT IS A VICLATION OF THE LAW FOR ANY ERSON, UNLESS THEY ARE ACTING UNDER THOMECTION OF A LICENSED PROFESSIONAL ENGINEER, TO ALTER THIS DOCUMENT

RA90XS096A 9NCB000849A N BLOUNT ST & PEACE STREET RALEIGH, NC 27604 UTILITY POLE

SHEET TITLE

TITLE SHEET

SHEET NUMBER


T-1




SITE SPECIFIC EXHIBIT PHOTO

SCALE: NOT TO SCALE

eace et

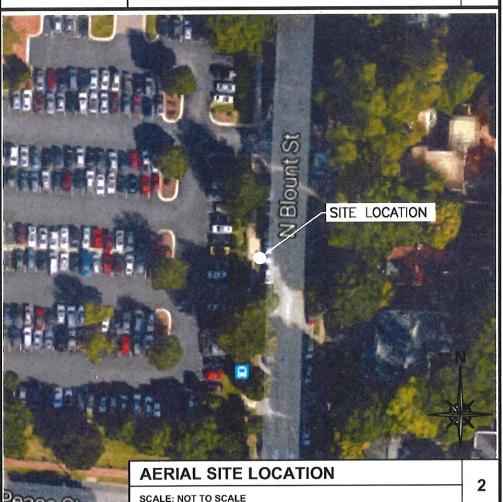

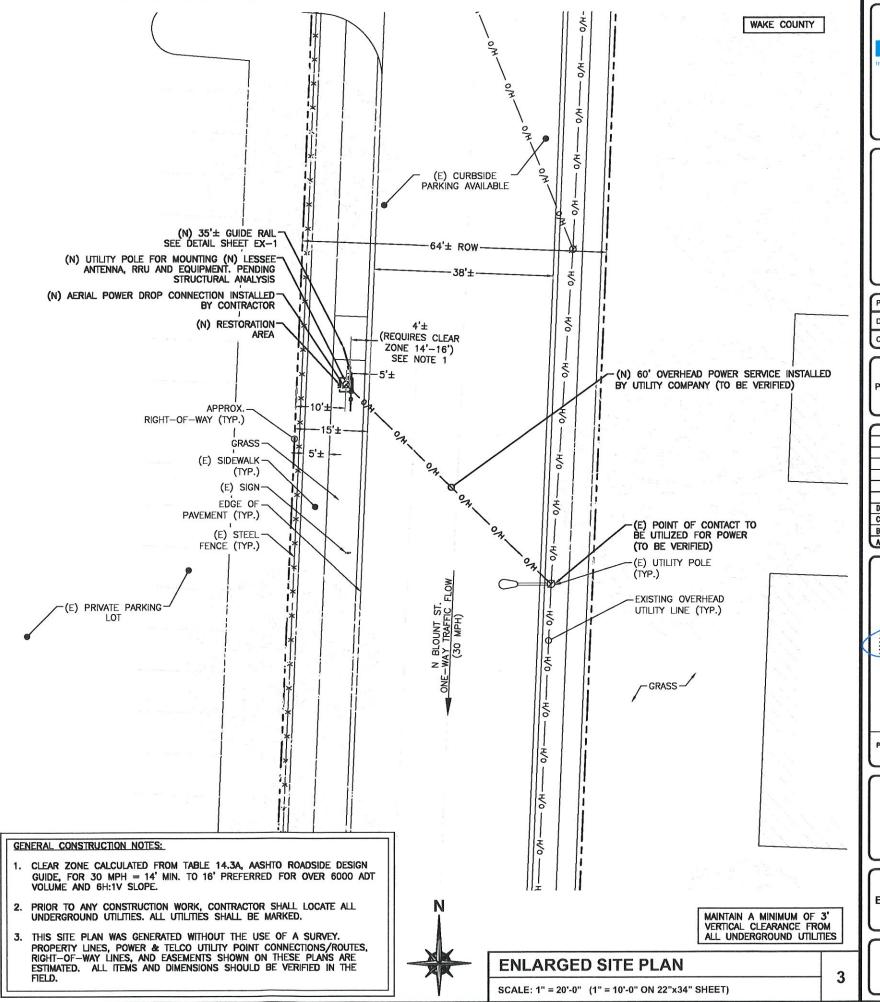



mobilitie

3475 PIEDMONT ROAD NE SUITE 1000 ATLANTA, GEORGIA 30305 PHONE: (312) 638-5400

PROJECT NO: ER600201 DRAWN BY: J. LAURETA CHECKED BY: B. POTESTA

PRELIM - NOT FOR CONSTRUCTION

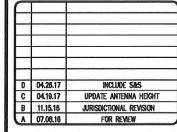

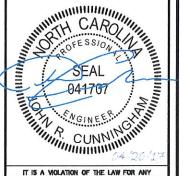

IT IS A WOLATION OF THE LAW FOR ANY PERSON, UNLESS THEY ARE ACTING UNDER THE DIRECTION OF A LICENSED PROFESSIONAL ENGINEER, TO ALTER THIS DOCUMENT


RA90XS096A 9NCB000849A N BLOUNT ST & PEACE STREET RALEIGH, NC 27604 UTILITY POLE

SHEET TITLE

EXHIBIT PHOTO & SITE PLAN

SHEET NUMBER

SP-1

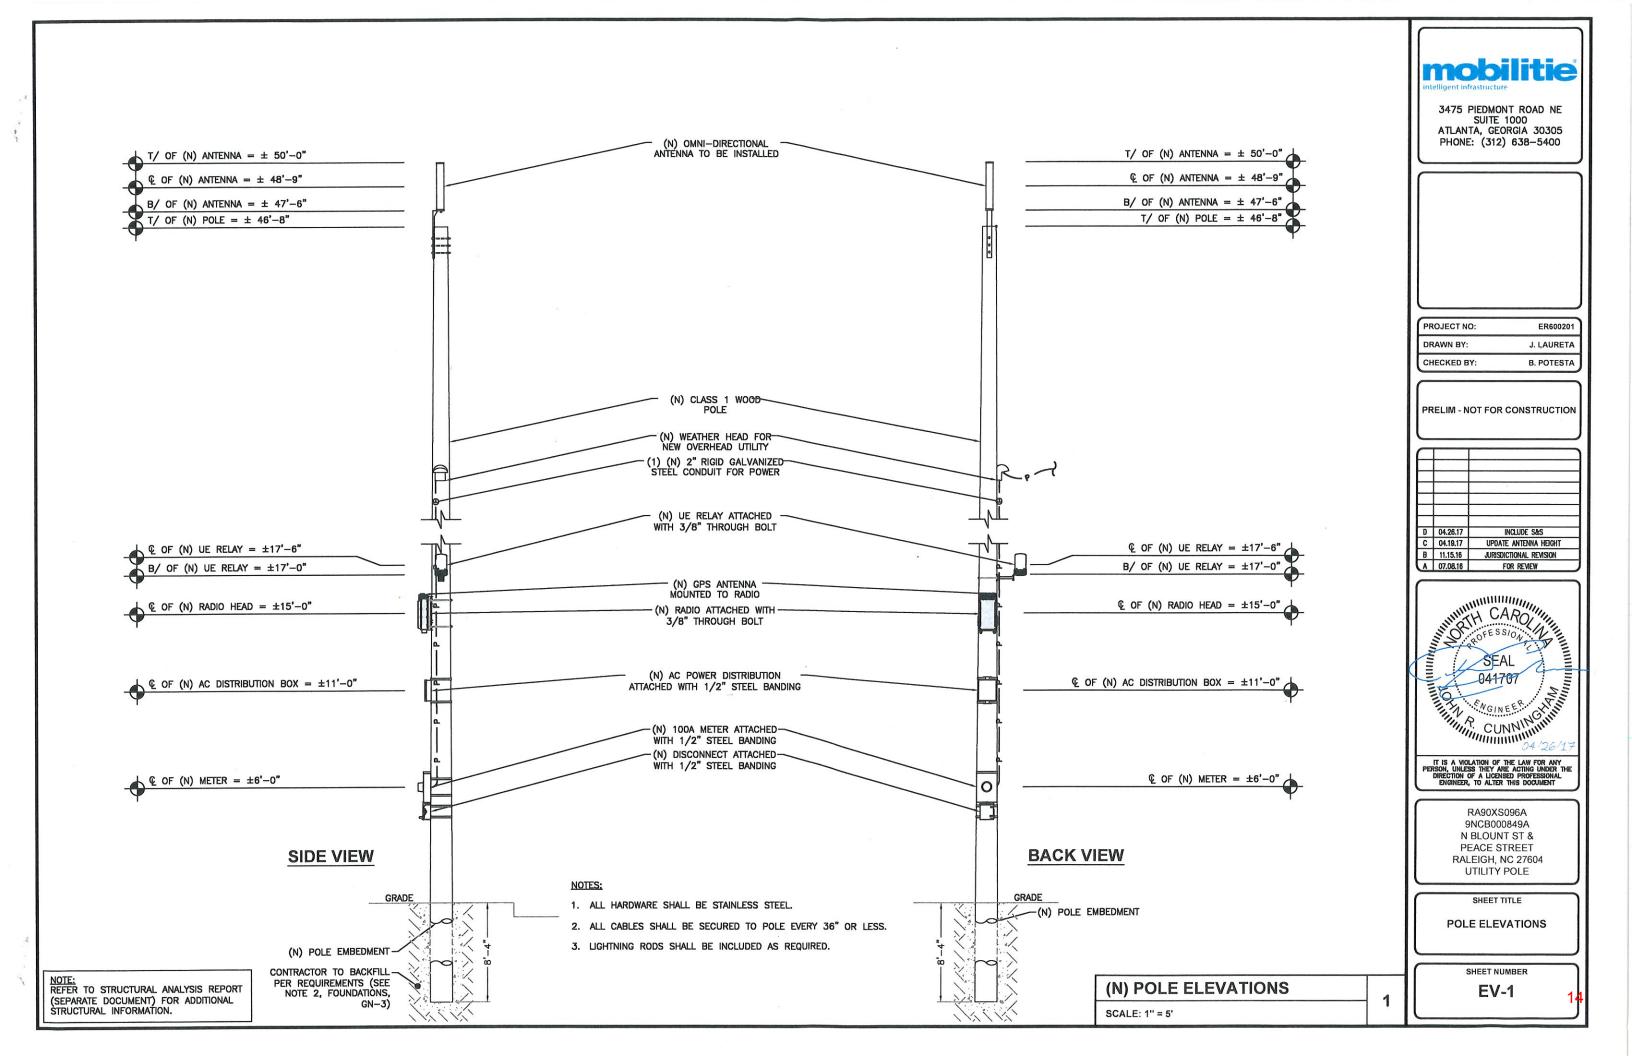

STANDALONE POLE: STANDARD

Standard Equipment



Design Highlights

- Site electronics placed directly on pole structure
- Weighs approx. 55 lbs. enabling the attachment to existing poles
- Components can be painted to match existing structures or to comply with JX color scheme
- Equipment designed for ambient air cooling and does not require fan-fed cooling.
- Sidearm mounted UE Relay provides better view 360° around pole allowing placement opposite the flow of traffic

Shown

- Omni antenna @ pole top and in alignment with pole axis minimizing visual impact
- UE Relay Unit & standoff @ 17'6" AGL
- GPS mounted on radio head @ 13'6"
- Radio head @ 13' AGL
- NEMA 4 Power Panel @ 11' AGL



Not Shown

- Utility Meter & Disconnect @ 6' AGL per code
- Cabling within the pole is the first option over placing outside the structure



PROPRIETARY & CONFIDENTIAL

15

S mall Cell Equipment

Wireless backhaul (UE Relay) Installed at 17.5 ft above ground

RF Antenna Installed designed elevation










PROPRIETARY & CONFIDENTIAL

S mall Cell Equipment

Radio Installed at 15 ft above ground

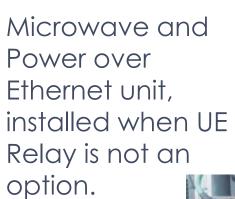





PROPRIETARY & CONFIDENTIAL