

Raleigh Historic Development Commission – Certificate of Appropriateness (COA) Application



Development Services
Customer Service Center
One Exchange Plaza
1 Exchange Plaza, Suite 400
Raleigh, North Carolina 27601
Phone 919-996-2495
eFax 919-996-1831



| Minor Work (staff review) – 1 copy Major Work (COA Committee review) – 10 copies ■ Additions Greater than 25% of Building Square New Buildings □ Demo of Contributing Historic Resource □ All Other □ Post Approval Re-review of Conditions of Approve | | are Footage | For Office Use Only Transaction # 525600 File # 139-17-CA Fee 147 Amount Paid 147 Received Date 8 1417 Received By 4417 | |
|--|-----------------------|-------------|---|--|
| Property Street Address 932 | N. Boylan Ave | | | |
| Historic District Glenwood | | | | |
| Historic Property/Landmark nam | e (if applicable) | | | |
| Owner's Name Michael Lon | nbardo | | | |
| Lot size .11 | (width in feet) 42.31 | | (depth in feet) 130.04 | |
| For applications that require review by the COA Committee (Major Work), provide addressed, stamped envelopes to owners of all properties within 100 feet (i.e. both sides, in front (across the street), and behind the property) not including the width of public streets or alleys (Label Creator). | | | | |
| Property Ad | dress | | Property Address | |
| Pressley 430 N. | . Boylan Ave | | | |
| Hotter 934 | N. Boylon Ax | > | | |
| | Wills Forest S | | | |
| Turner 623 | Wills Forest | 57 | | |
| PARKET 812 | Gaston Wo | 00 CT | | |
| | | | | |
| | | | | |
| | | | | |

I understand that all applications that require review by the commission's Certificate of Appropriateness Committee must be submitted by 4:00 p.m. on the application deadline; otherwise, consideration will be delayed until the following committee meeting. An incomplete application will not be accepted.

| Type or print the following: | | | | |
|--|--|----------------|--|--|
| Applicant Michael Lombardo | Applicant Michael Lombardo | | | |
| Mailing Address 932 N. Boylan Ave | | | | |
| city Raleigh | State NC | Zip Code 27605 | | |
| Date 08/12/17 | Daytime Phone 919-369-2742 | | | |
| Email Address luckylom@gmail.com | 1 | | | |
| Applicant Signature WI Signature | | | | |
| | a a constant of the constant o | | | |
| Will you be applying for rehabilitation tax credits for this project? | | | | |
| Design Guidelines - Please cite the applicable sections of the design guidelines (www.rhdc.org). | | | | |

| Section/Page | Topic | Brief Description of Work (attach additional sheets as needed) |
|--------------|--|--|
| | | Adding a dormer to rear side of house to accommodate a growing daughter. Other then making repairs to existing home, front elevations will not be touched. |
| | | |
| | | |
| | | |
| | | |
| | And the second s | |

Mike,

Thank you for sharing the drawings. It appears that you will need to submit a major work COA application for this project. As we discussed, the Glenwood-Brooklyn district is a streetside historic overlay district (HOD), so the only exterior changes to the house that need to be reviewed under a COA application are those that are within the first 50% of the building. You can see more about the ordinances for the streetside HOD at the City's website for the Unified Development Ordinance (UDO) in section 5.4.2.

Since your drawings did not provide any dimensions, we did a quick estimation that the first 50% of the house (not including the front porch) would be roughly through the refrigerator. So anything affecting the house exterior from that point forward will need a COA. You can find the application here.

Here is what you will need to submit with the application:

• Measured scaled drawings of the existing house and your proposed changes. This will be especially important for the elevations, and labeling them so that it's clear what is changing.

Measured scaled drawings are included in package.

It would also help to have a roof plan.

INCLUDED

A ground floor plan that shows where the first 50% of the house ends.

Included in package

Photographs from all sides of the house.

Front, Sides & Back pictures of 932 N Boylan Ave. included in package

| • A description of the materials that will be used. If it will be painted the same as the existing house color we do not need paint samples, but please state that is the case. |
|---|
| "Stick built" Frame |
| Hardi Siding will be used |
| Architectural asphalt roof shingles |
| Single hung windows to match the existing |
| Home will remain the same color |
| You'll find more information on the application. |
| The concept you are proposing is likely to meet the Design Guidelines, but since it falls within the COA review area you'll have to go through the process. Once you've got an approved COA you will be able to get the required building permits next. |
| The next COA application deadline is August 15 for the September 28 COA Committee meeting. |
| Best, |
| Melissa |
| |









GENERAL NOTES:

- 1. IT IS THE CONTRACTORS RESPONSIBILITY TO VERIFY THAT ALL DIMENSIONS, ROOF PITCHES, AND SQUARE FOOTAGE IS CORRECT PRIOR TO CONSTRUCTION. K&A HOME DESIGNS, INC. IS NOT RESPONSIBLE FOR ANY DIMENSIONING, ROOF PITCH, OR SQUARE FOOTAGE ERRORS ONCE CONSTRUCTION BEGINS.
- 2. ALL WALLS SHOWN ON THE FLOOR PLANS ARE DRAWN AT 4" UNLESS NOTED OTHERWISE.
- 3. ALL ANGLED WALL SHOWN ON THE PLANS ARE 45 DEGREES UNLESS NOTED OTHERWISE.
- 4. STUD WALL DESIGN SHALL CONFORM TO ALL NORTH CAROLINA STATE BUILDING CODE REQUIREMENTS.
- 5. DO NOT SCALE PLANS. DRAWING SCALE MAY BE DISTORTED DUE TO COPIER IMPERFECTIONS.
- 6. ALL CONSTRUCTION SHALL BE IN ACCORDANCE WITH NORTH CAROLINA STATE BUILDING CODE, 2012 EDITION.

SQUARE FOOTAGE

| HEATED SQUARE FO | OTAGE | UNHE | ATED SQUARE FO | O TA GI |
|------------------|-------|------|----------------|---------|
| FIRST FLOOR = | N/A | G | GA RA GE = | N/A |
| SECOND FLOOR= | 738 | F | RONT PORCH= | N/A |
| THIRD FLOOR= | N/A | S | CREEN PORCH= | N/A |
| BASEMENT= | N/A | D | DECK= | N/A |
| | | S | TORAGE= | N/A |
| | | | | |

 $TOTAL\ HEATED = 738$ $TOTAL\ UNHEATED = N/A$

CRAWL SPACE VENTILATION CALCULATIONS

-VENT LOCATIONS MAY VARY FROM THOSE SHOWN ON THE PLAN BUT SHOULD BE PLACED TO PROVIDE ADEQUATE VENTILATION AT ALL POINTS TO PREVENT DEAD AIR POCKETS.

-100% VAPOR BARRIER MUST BE PROVIDED WITH 12" MIN. LAP JOINTS.

-THE TOTAL AREA OF VENITLATION OPENINGS MAY BE REDUCED TO 1/1500 $\,$ $AS\ LONG\ AS\ REQUIRED\ OPENINGS\ ARE\ PLACED\ SO\ AS\ TO\ PROVIDE\ CROSS-$ VENTILATION OF THE SPACE. THE INSTALLATION OF OPERABLE LOUVERS SHALL NOT BE PROHIBITED. (COMPLY WITH NC CODE MIN. WITH REGARD TO VENT PLACEMENT FROM CORNERS)

N/ASQ. FT. OF CRAWL SPACE/1500

N/ASQ. FT. OF REQUIRED VENTILATION

VENTS AT 0.45 SQ. FT. NET FREE PROVIDED BY: N/A VENTILATION EACH= N/A SQ. FT. OF VENTILATION

**FOUNDATION DRAINAGE- WATERPROOFING PER SECTIONS 405 & 406.

ATTIC VENTILATION CALCULATIONS

- CALCULATIONS SHOWN BELOW ARE BASED ON VENTILATORS USED AT VENTIALTION PROVIDED BE EAVE VENTS.
- CATHEDRAL CEILINGS SHALL HAVE A MIN. 1" CLEARANCE BETWEEN THE BOTTOM OF THE ROOF DECK AND THE INSULATION.

847 SQ. FT. OF ATTIC/300= 2.82

EACH OF INLET AND OUTLET REQUIRED.

*WALL AND ROOF CLADDING DESIGN VALUES

- WALL CLADDING IS DESIGNED FOR A 24.1 SQ. FT. OR GREATER POSITIVE AND NEGATIVE PRESSURE.
- ROOF VALUES BOTH POSITVE AND NEGATIVE SHALL BE AS FOLLOWS:

45.5 LBS. PER SQ. FT. FOR ROOF PITCHES OF 0/12 TO 2.25/12

34.8 LBS. PER SQ. FT. FOR ROOF PITCHES OF 2.25/12 TO 7/12


21 LBS. PER SQ. FT. FOR ROOF PITCHES OF 7/12 TO 12/12

** MEAN ROOF HEIGHT 30' OR LESS




FRONT ELEVATION

1/4" = 1'-0"

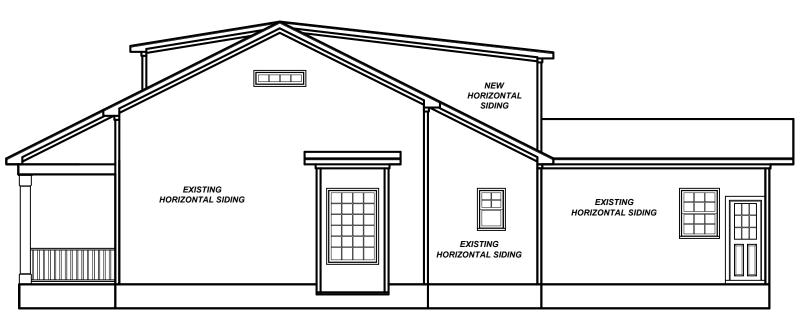


RIGHT ELEVATION

1/8" = 1'-0"

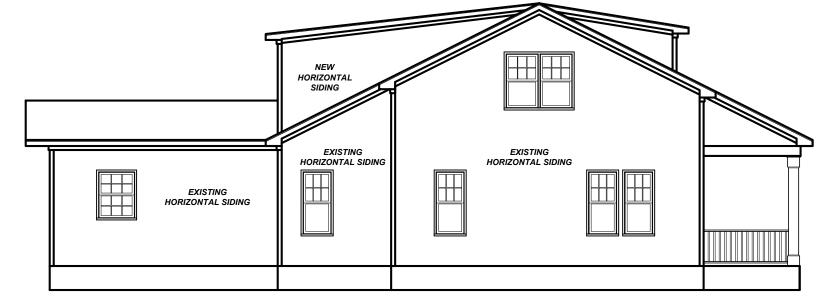

LEFT ELEVATION

1/8" = 1'-0"

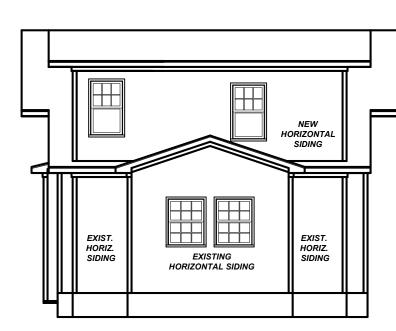

REAR ELEVATION

1/8" = 1'-0"

| Project #: | _ |
|------------------|-------------|
| 16KB-282 | |
| Date: | |
| 1-30-17 | |
| Drawn/Design By: | |
| KBB | |
| Scale: | |
| REFER TO ELEV | '. / |

| | RI | EVISIONS |
|-----|-------|----------|
| No. | Date: | Remarks |
| 1 | | |
| 2 | | |
| 3 | | |
| 4 | | |

9101 Te Raleigh, Office: (




ombardo Addition D

Mike Lombardo


ELEVATIONS

Sheet Number

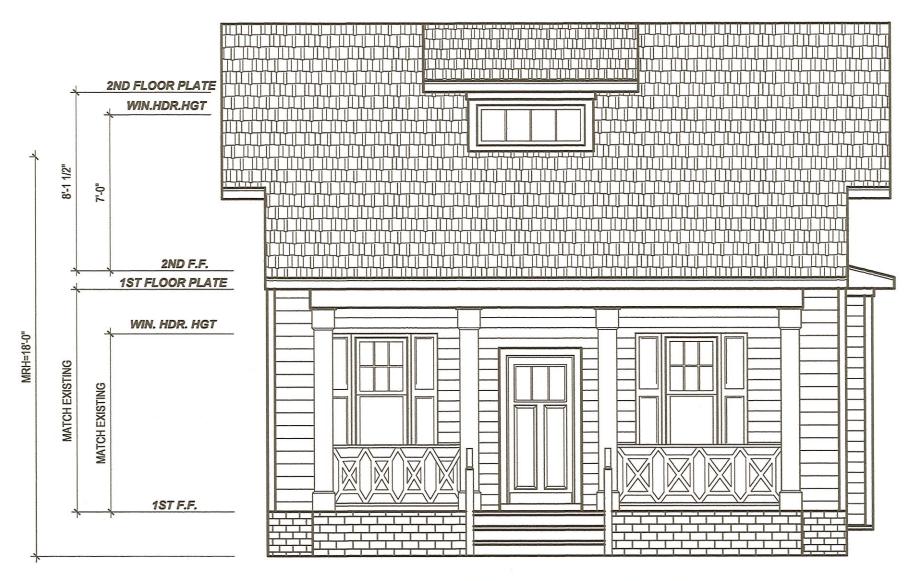

FRONT ELEVATION

1/4" = 1'-0"

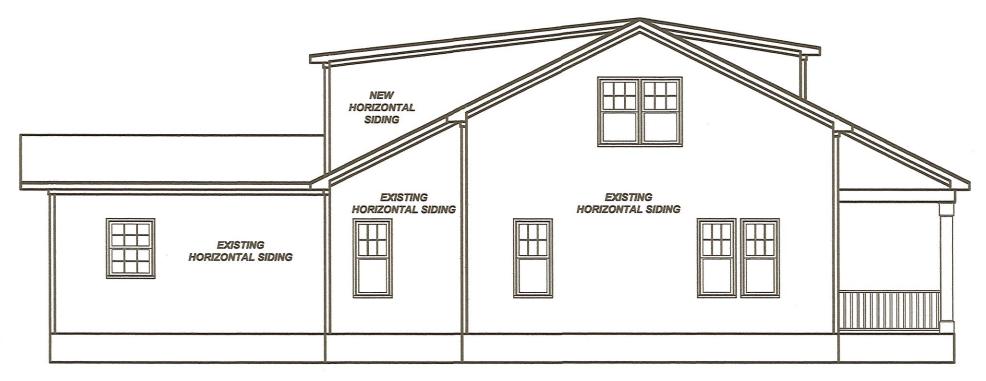


LEFT ELEVATION

1/8" = 1'-0"



REAR ELEVATION


1/8" = 1'-0"

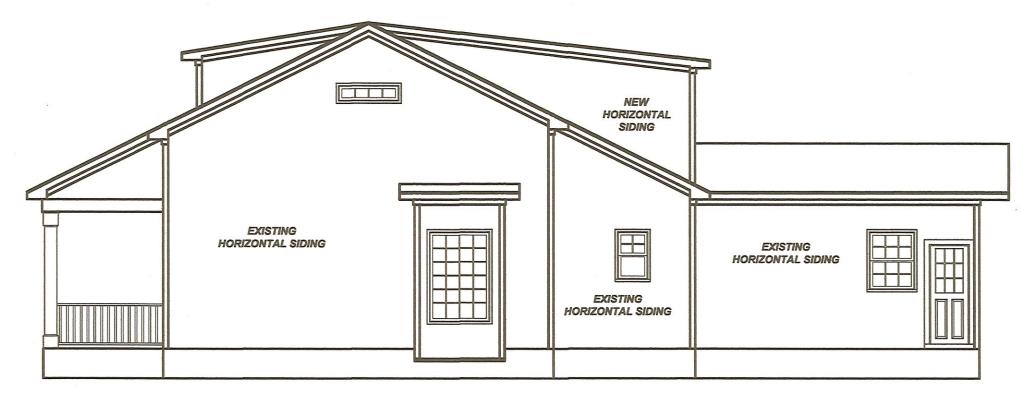


RIGHT ELEVATION

1/8" = 1'-0"

932 W. Baylan Ave RALEIGH N.C.

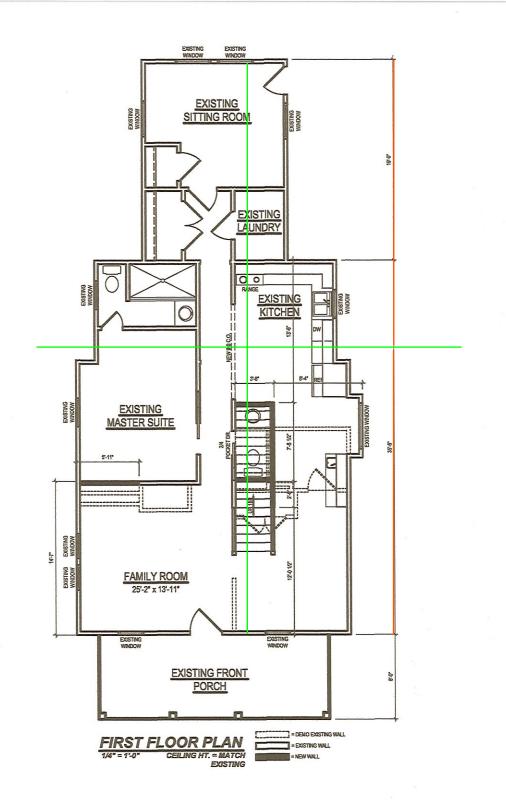

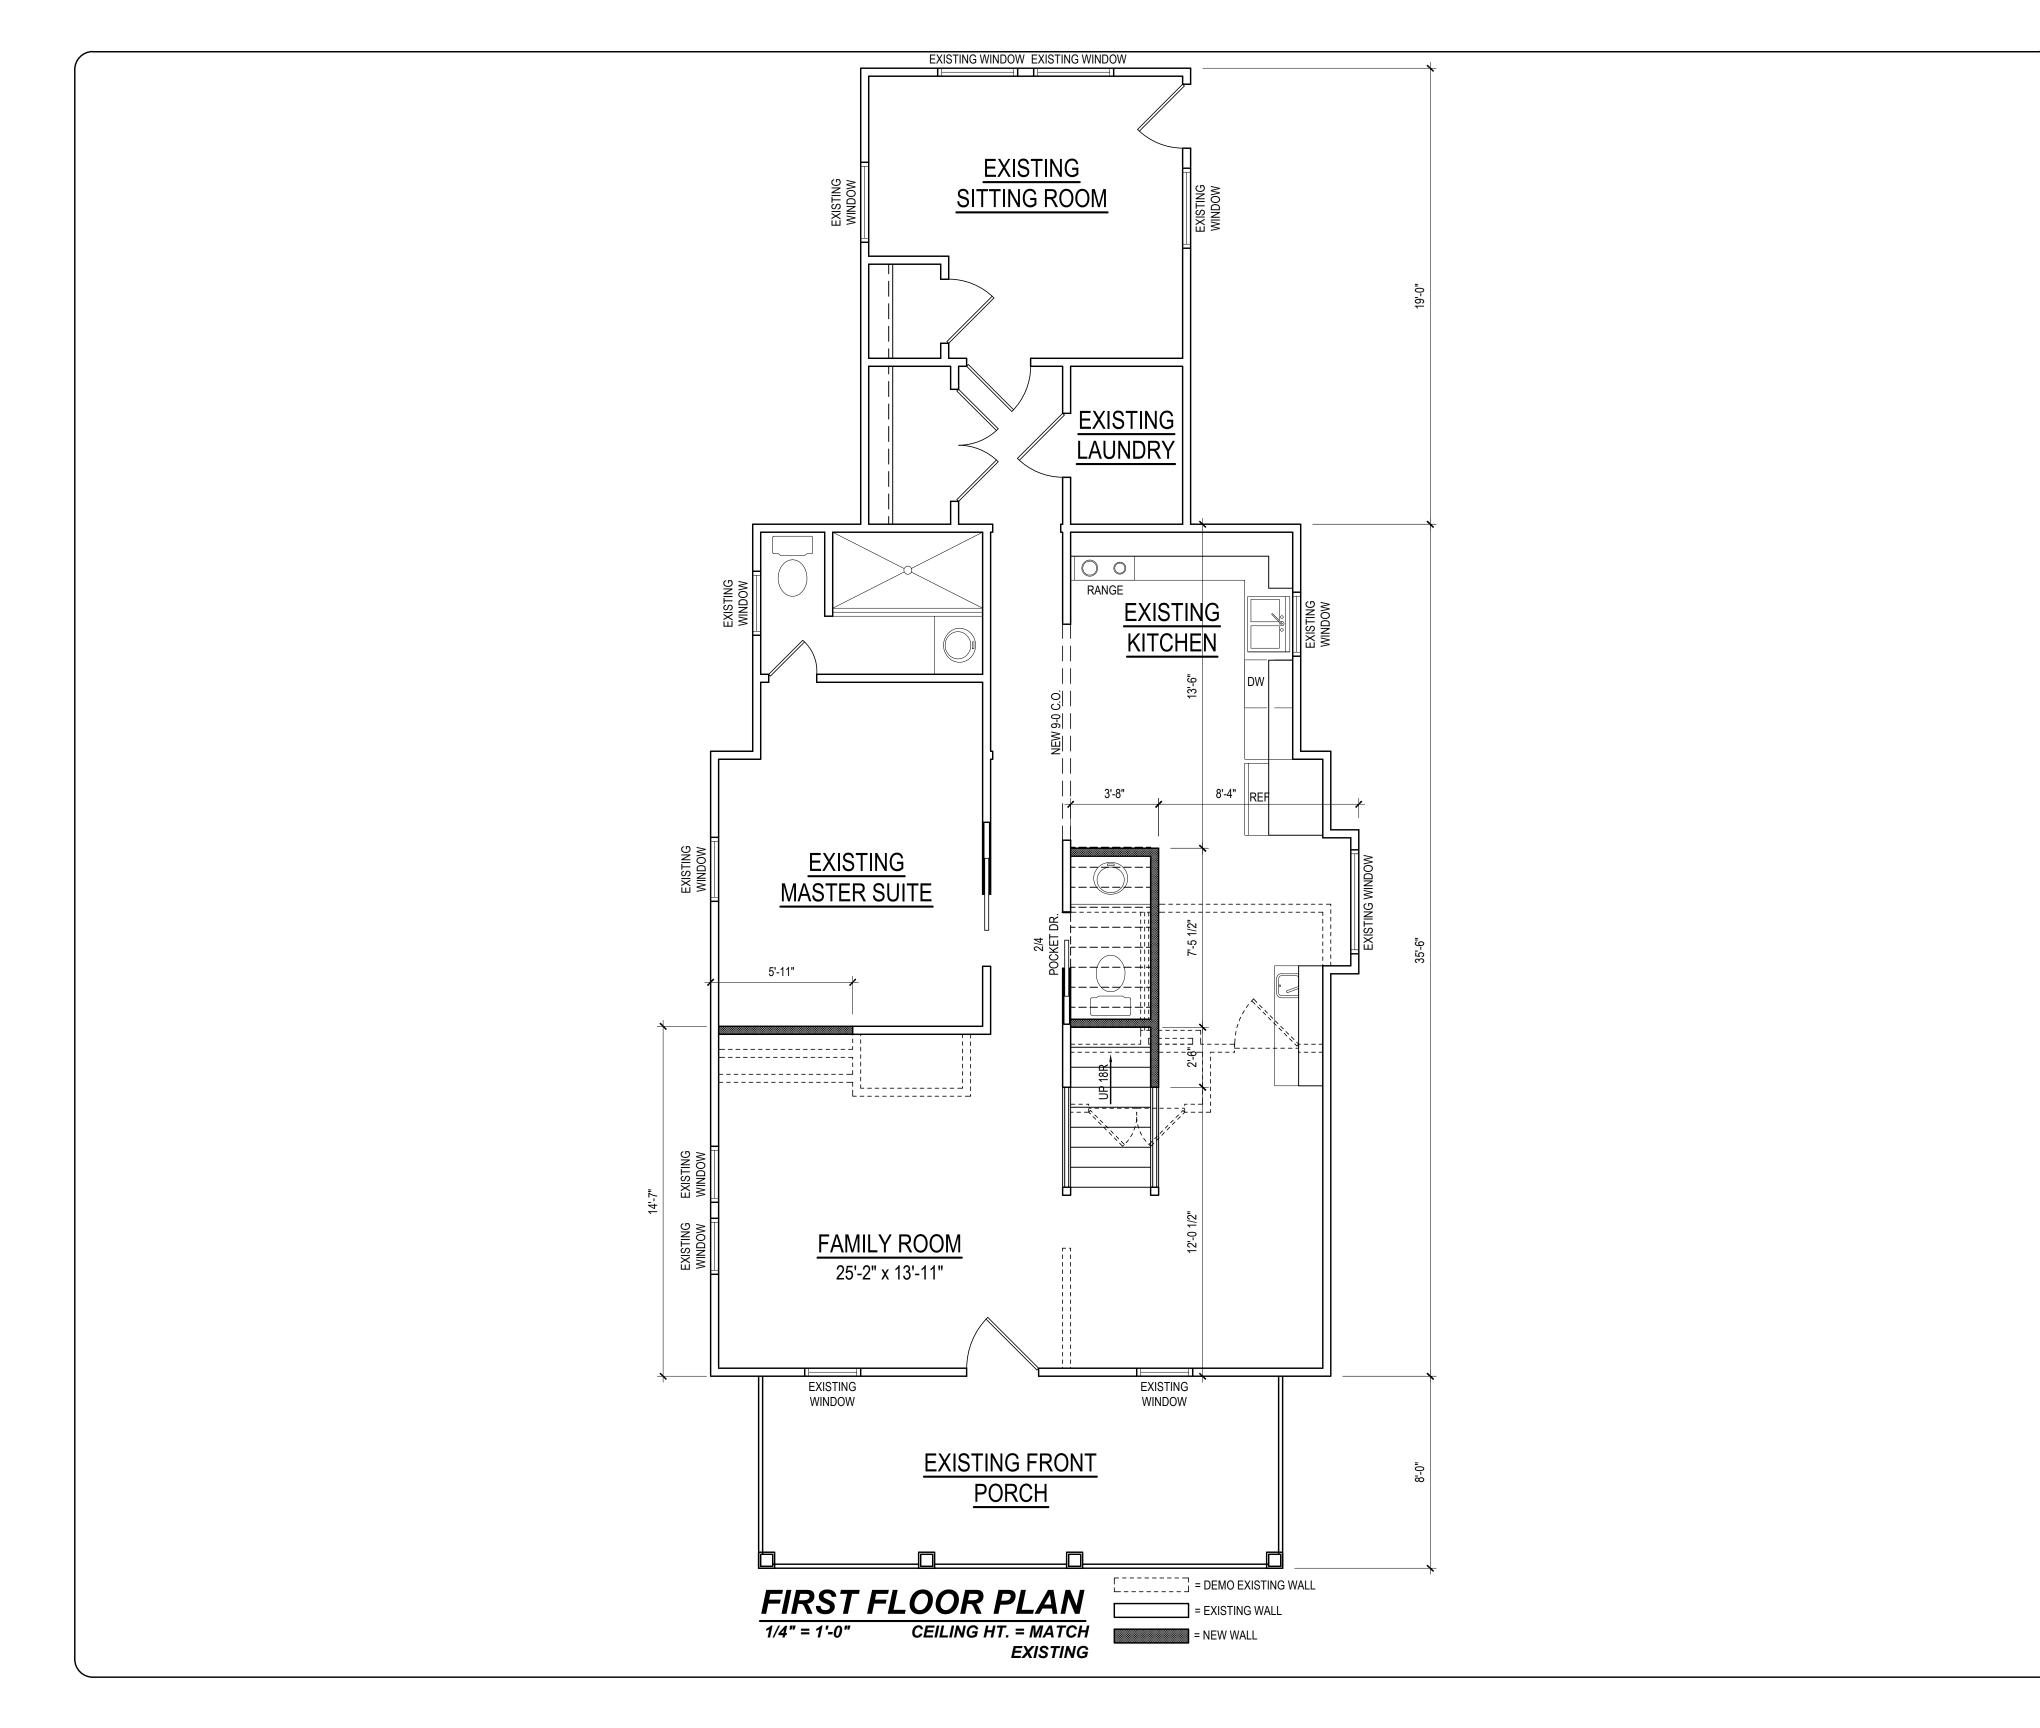

Project #: 16KB-282 <u>Date:</u> 1-30-17 Drawn/Design By:

| • | Scale: 1/4"=1 | -0" |
|-----------|------------------|----------|
| _ | DI | EVISIONS |
| <u>).</u> | Date: | Remarks |
| | | |
| | | |
| | | |


9101 Ten-Ten Rd. Raleigh, NC 27603 Office: (919) 302-0693

Website: www.KandAHomeDesigns.com


Email: Kent@KandAHomeDesigns.com

Lombardo Addition Mike Lombardo

FIRST FLOOR

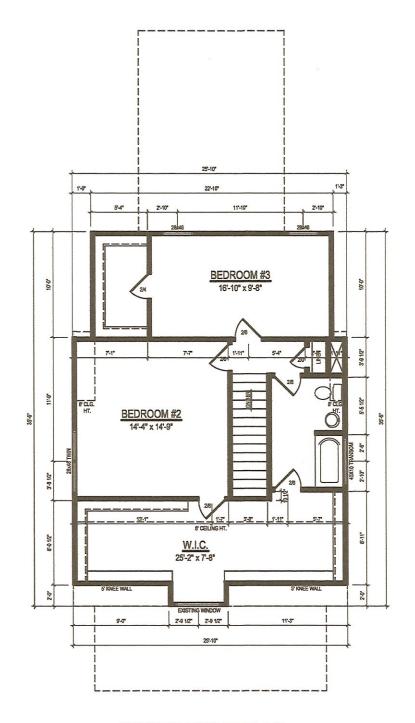



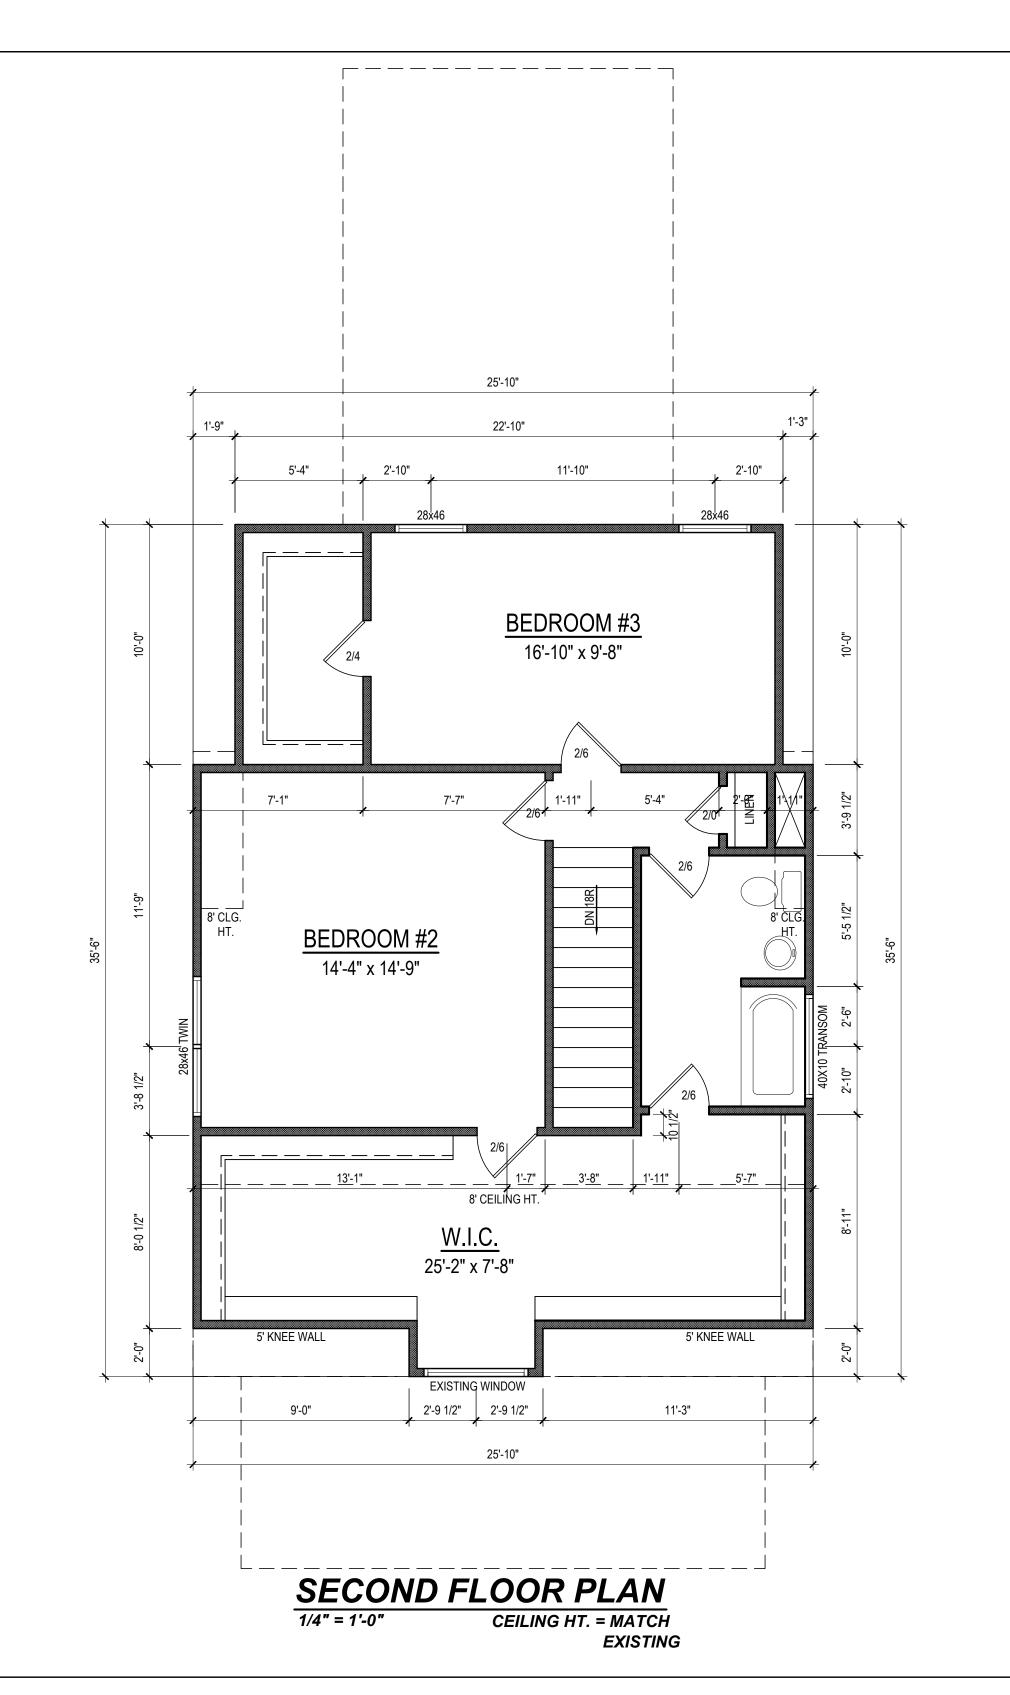

Project #: 16KB-282 Date: 1-30-17 Drawn/Design By: Scale: 1/4"=1'-0"

| 1/4 = 1 -0 | | | |
|------------|-------|----------|---|
| _ | | | |
| | RI | EVISIONS | 1 |
| | Date: | Remarks | |
| | | | |
| | | | |
| | | | |
| _ | | | |

Website: www.KandAHomeDesigns.com

Email: Kent@KandAHomeDesigns.com

| | RI | EVISIONS |
|-----|------------------|---|
| No. | Date: | Remarks |
| 1 | | |
| 2 | | |
| 3 | | |
| 4 | | |
| | 9101 Ten-Ten Rd. | Raleigh, NC 27603 Office: (919) 302-0693 |


D D

Lombardo Addition


Mike Lombardo

SECOND FLOOR & STRUCTURAL

Sheet Number

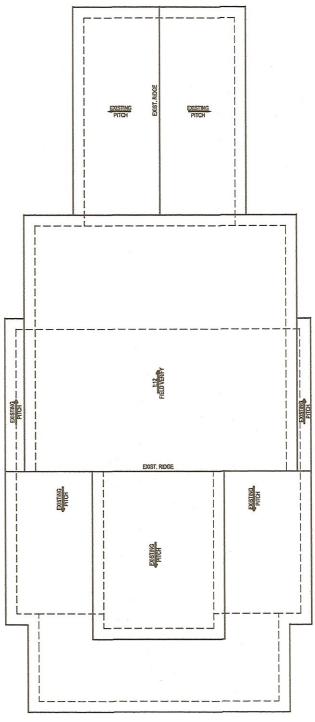

ROOF PLAN

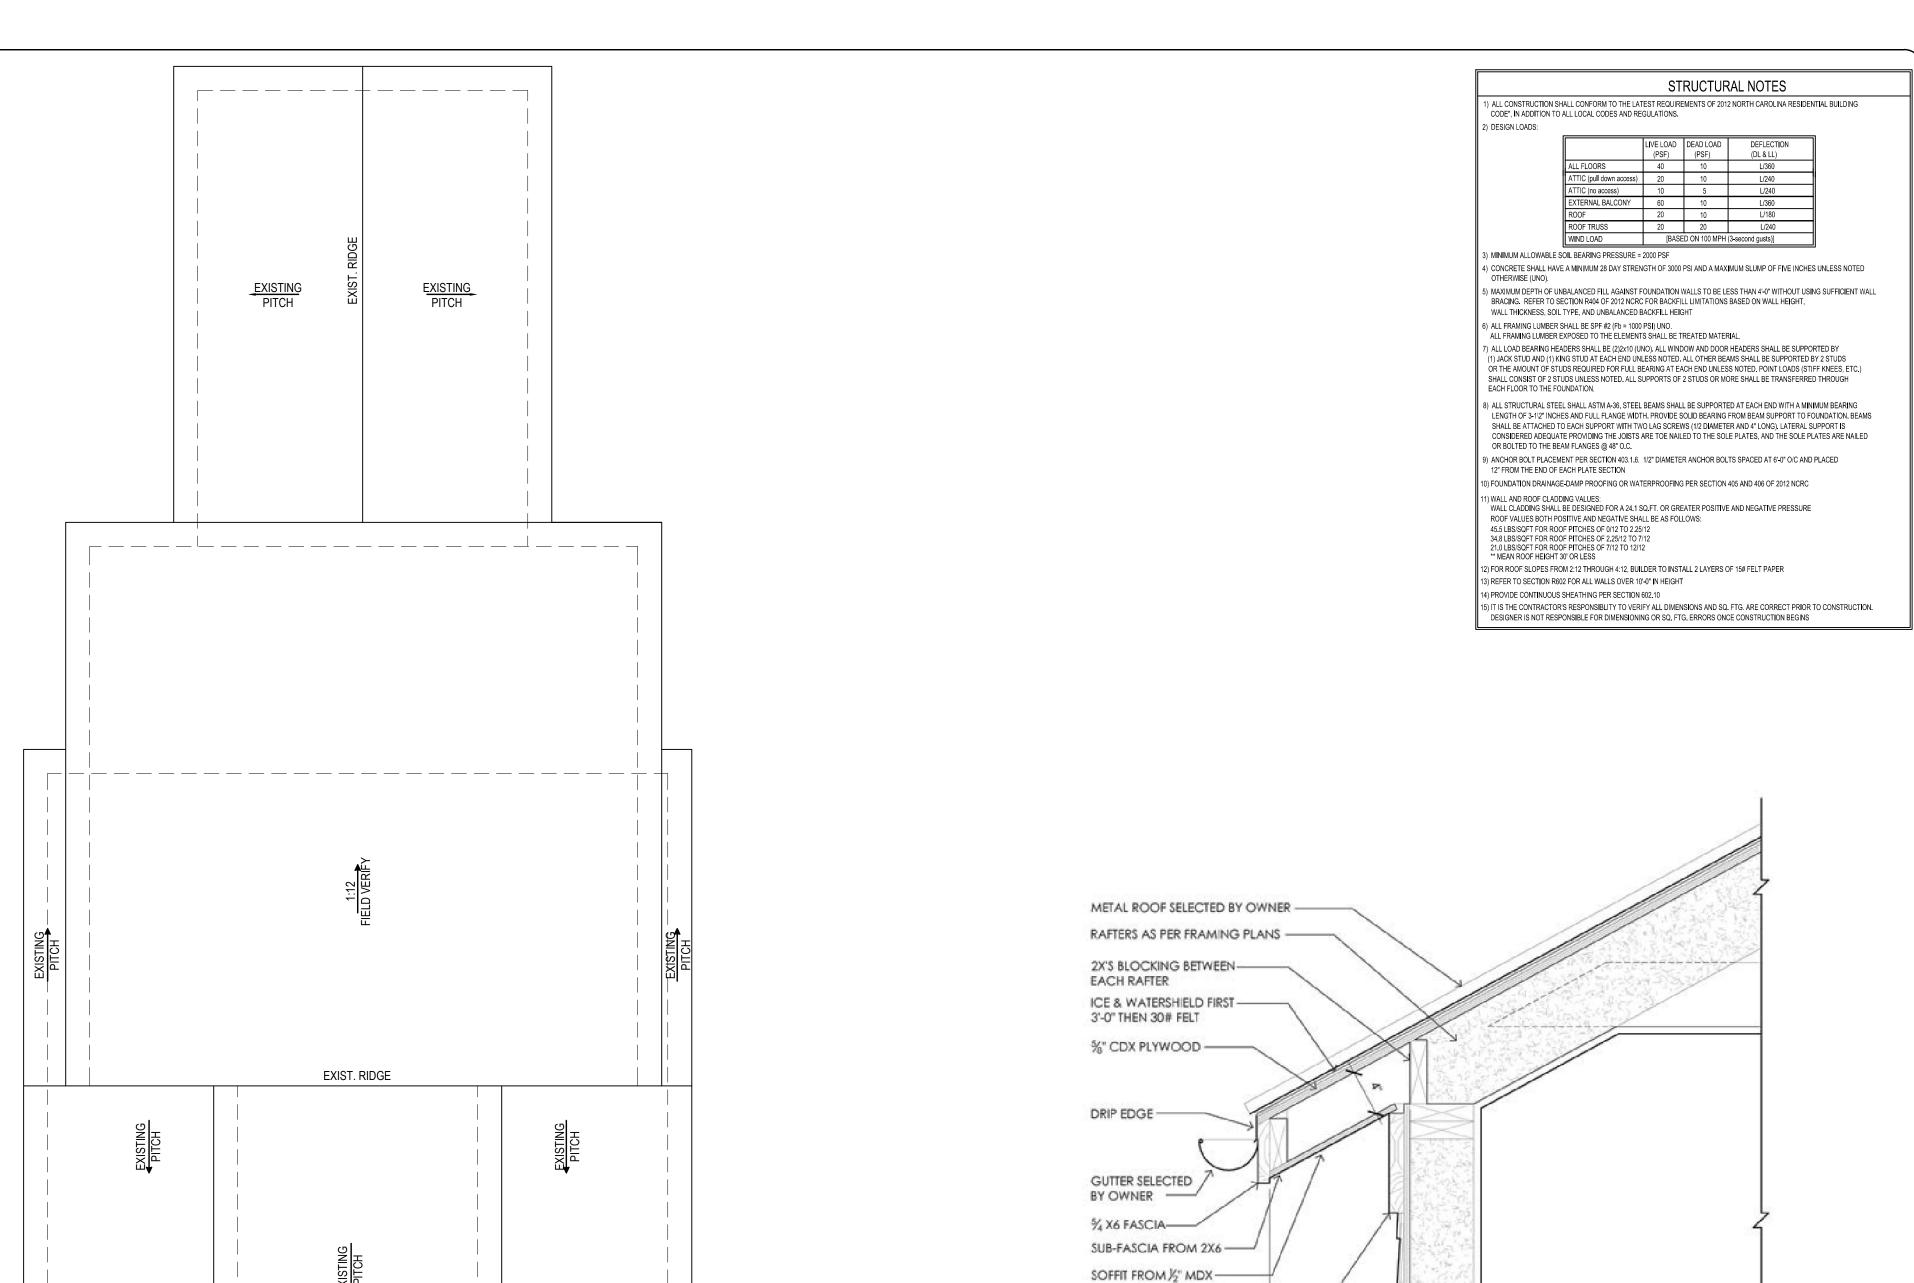

ROOF PLAN

1/4" = 1'-0"

TYPICAL EAVE DETAIL 1 1/2"=1'-0"

1'-0"

% FRIEZE BD. WIDTH AS — REQUIRED TO MEET % X 8 RAKE BD.

16KB-282 Date: 1-30-17 Drawn/Design By: KBB Scale: 1/4"=1'-0"

> REVISIONS Remarks

Ten-Ten Rd. igh, NC 27603 e: (919) 302-0693 9101 Ten-Ter Raleigh, NC 2 Office: (919) (

ombardo Addition

Mike Lombardo

ROOF LAYOUT & DETAILS

Sheet Number

Dear Neighbor,

I'm sure you have talked to either Colleen or myself about our desire to do a small addition to our house at 932 N Boylan Ave. We are working well within the limitation guidelines of the historic district, and will not be making any changes to the front of the house or landscape, only a rear dormer on the back to add a more spacious bedroom and playroom for our daughter, Gianna, now 6! We are looking to go to the City of Raleigh to get our Certificate of Appropriateness (COA), and with this certificate, we are required to inform our close neighbors of our application process. We are hopeful the City of Raleigh will approve this, and if so, we respect your space and privacy and promise to create as little disruption to everyone's lifestyle's as possible. We guarantee we will keep you all posted on any progress, and if you have any questions, please don't hesitate to call either of us. We just wanted to be respectful of our neighborhood and keep everyone in the loop.


Sincerely,

Mike Lombardo

919-369-2642

Colleen Johnson

919-909-4236

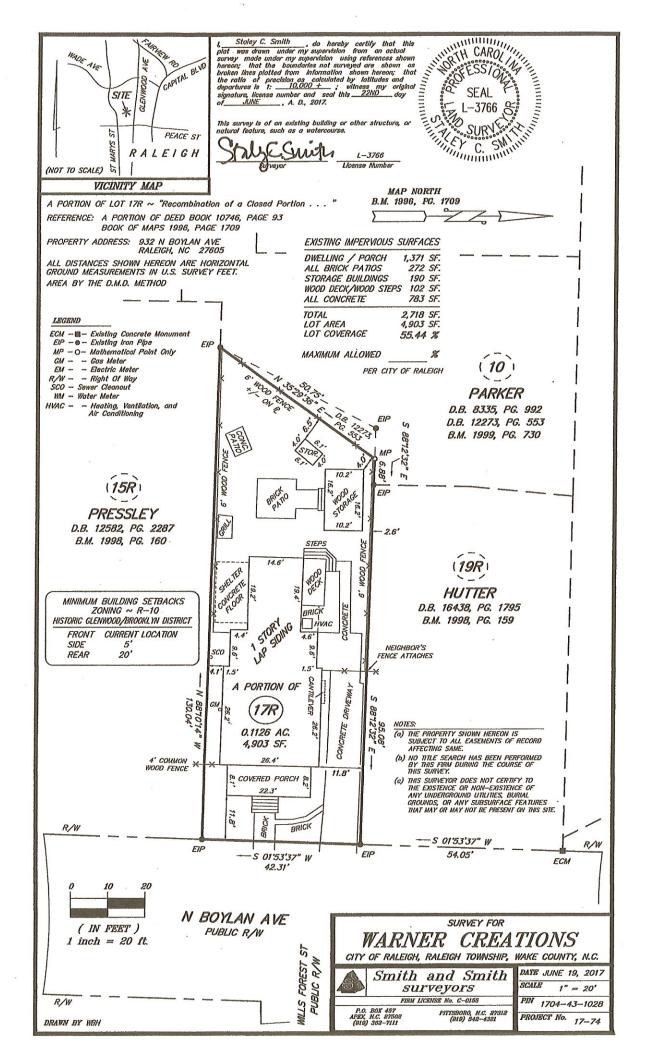

APPLICATION FOR A CERTIFICATE OF APPROPRIATENESS – STAFF REPORT

139-17-CA 932 N BOYLAN AVENUE Applicant: MICHAEL LOMBARDO

Received: 8/14/2017 <u>Meeting Date(s)</u>:

<u>Submission date + 90 days</u>: 11/12/2017 1) 9/28/2017 2) 3)

INTRODUCTION TO THE APPLICATION

Historic District: GLENWOOD-BROOKLYN HISTORIC DISTRICT

Zoning: Streetside HOD

Nature of Project: Addition of rear dormer

Staff Notes:

• The Glenwood-Brooklyn Historic District is a Streetside HOD. This means that this proposed addition is subject to COA review because the change is occurring in the first 50% of the house.

APPLICABLE SECTIONS OF GUIDELINES and DESCRIPTION OF PROJECT

Sections Topic Description of Work
3.2 Additions Addition of rear dormer

STAFF REPORT

Based on the information contained in the application and staff's evaluation:

- A. Addition of a rear dormer is not incongruous in concept according to *Guidelines* 3.2.4, 3.2.5, 3.2.6, 3.2.7, 3.2.8, 3.2.9, 3.2.10, and the following suggested facts:
- 1* According to the Glenwood-Brooklyn designation report the ca. 1917 house is a one-story frame Craftsman bungalow with weatherboard siding and an asphalt-shingled gable roof with a shed dormer.
- 2* A traditional way of adding onto a historic house is through new dormers.
- 3* The new dormer does not extend above the historic ridge of the historic house and is narrower than the historic roof.
- 4* A "typical" eave detail is provided, but it notes materials, such as a metal roof that are not proposed. It is unclear if this is the actual proposed eave detail.
- 5* The dormer addition is proposed to be sheathed in horizontal fiber cement siding, but does not specify a smooth finish.

6* New rear-facing windows are proposed to be single-hung to match the existing. Details and specifications were not provided.

Staff suggests that the committee approve the application, with the following conditions:

- 1. That details and specifications for the following be provided to and approved by staff prior to the issuance of the blue placard:
 - a. Eave construction;
 - b. Windows.
- 2. That the fiber-cement siding be installed with the smooth finish facing out.