

# Administrative Approval Action

Case File / Name: ASR-0014-2024 DSLC - GLENLAKE LOT 1 City of Raleigh
Development Services Department
One Exchange Plaza
Raleigh, NC 27602
(919) 996-2492
currentplanning@raleighnc.gov
www.raleighnc.gov

**LOCATION:** This 3.07 acre site zoned CX-7 CU (Z-77-21) is located on the northeast corner of

the intersection of Edwards Mill Road and Parklake Avenue at 4501 Edwards Mill

Road.

**REQUEST:** Construction of a one-story 8,152 square foot general building for a restaurant with

surface parking.

DA-8-2024 (Glenlake Lot 1) - (1) to allow the proposed service area to be located in front of the building in lieu of being located to the side or rear of building as required per UDO Section 7.2.5.C.1; (2) for relief from the requirement to protect the entire critical root zone of each existing tree per UDO Section 7.2.7.E.6 in order to preserve existing street trees; (3) for complete relief from the Avenue 2-lane Divided street cross section along Parklake Avenue required per UDO Section 8.5.5.B; and (4) for complete relief from the Avenue 2-lane Undivided street cross section along

Edwards Mill Road required per UDO Section 8.5.5.A.

DESIGN

ADJUSTMENT(S)/

ALTERNATES, ETC: N/A

FINDINGS: City Administration finds that this request, with the below conditions of

approval being met, conforms to the Unified Development Ordinance. This approval is based on a preliminary plan dated July 23, 2024 by

HIGHWOODS REALTY LP.

# **CONDITIONS OF APPROVAL and NEXT STEPS:**

This document must be applied to the second sheet of all future submittals except for final plats. This is a preliminary plan and as such no permits have been issued with this approval. To obtain permits and/or completion of the project, the following steps are required:

☑ <u>SITE PERMITTING REVIEW</u> - For land disturbance of 12,000 square feet or greater, public or private infrastructure, shared stormwater devices, etc. Site Permitting Review may be submitted upon receipt of this signed approval document.

The following items are required prior to approval of Site Permitting Review plans:

# General

1. For ease of reference please add the case number (DA-8-2024) and a detailed description of the approvals to the cover sheet.

# **Stormwater**

- 2. A surety equal to of the cost of clearing, grubbing and reseeding a site, shall be paid to the City (UDO 9.4.4).
- 3. A nitrogen offset payment must be made to a qualifying mitigation bank (UDO 9.2.2.B).

# **Urban Forestry**



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- 4. All tree protection fence must be inspected by Urban Forestry staff prior to the issuance of a grading permit or demolition permit, whichever comes first.
- 5. Submit a final tree conservation plan that includes metes and bounds descriptions of the tree conservation area and tree protection fencing as required (UDO 9.1.5).
- 6. Per DA-8-2024, applicant shall provide a tree care plan created and approved by an ISA certified arborist for the street trees prior to final approval of the site permit.
- 7. A tree impact permit must be obtained for the installation of tree protection fence around 10 existing street trees in the existing right-of-way to remain along Parklake Avenue and 3 existing street trees in the existing right-of-way to remain along Edwards Mill Road, and the removal of 1 existing street tree in the existing right-of-way along Parklake Avenue. Tree protection fence must be inspected by Urban Forestry staff prior to the issuance of a grading permit or demolition permit, whichever comes first.
- 8. Install tree protection fence around 2 existing trees within the future right-of-way to remain along Edwards Mill Road. Tree protection fence must be inspected by Urban Forestry staff prior to the issuance of a grading permit or demolition permit, whichever comes first.

☑ **LEGAL DOCUMENTS** - Email to legaldocumentreview@raleighnc.gov. Legal documents must be approved, executed, and recorded prior to or in conjunction with the recorded plat on which the associated easements are shown. Copies of recorded documents must be returned to the City within one business day of recording to avoid withholding of further permit issuance.

	Right of Way Deed of Easement Required
Ø	Sidewalk Deed of Easement Required

Utility Placement Deed of Easement
Required

☑ <u>RECORDED MAP(S)</u> - Submit plat to record new property lines, easements, tree conservation areas, etc.). Plats may be submitted for review when the Site Permitting Review plans, if required, have been deemed ready for mylar signature.

The following items must be approved prior to recording the plat:

# **Engineering**

1. A sidewalk deed of easement, in addition to a plat showing the location of the easement, shall be submitted to the Planning and Development Services Department for review, and if acceptable, approved for recordation. Approved plats must be recorded at the Wake County Register of Deeds Office on or before the 14th day following approval by the City. The 14-day expiration date shall be clearly indicated on the plat. By the end of the next business day following recordation of the plat, all required legal instruments (including deeds of easement) shall be recorded, and recorded copies of the plat and all legal instruments required by the City in association with development approval shall be provided to the City. (Reference: UDO 8.1.7.A; 10.2.5.F.4.d)



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- 2. A 5' utility placement easement deed of easement, in addition to a plat showing the location of the easement, shall be submitted to the Planning and Development Services Department for review, and if acceptable, approved for recordation. Approved plats must be recorded at the Wake County Register of Deeds Office on or before the 14th day following approval by the City. The 14-day expiration date shall be clearly indicated on the plat. By the end of the next business day following recordation of the plat, all required legal instruments (including deeds of easement) shall be recorded, and recorded copies of the plat and all legal instruments required by the City in association with development approval shall be provided to the City. (Reference: UDO 8.1.7.A; 10.2.5.F.4.d)
- 3. A public street right-of-way deed of easement, in addition to a plat showing the location of the easement, shall be submitted to the Planning and Development Services Department for review, and if acceptable, approved for recordation. Approved plats must be recorded at the Wake County Register of Deeds Office on or before the 14th day following approval by the City. The 14-day expiration date shall be clearly indicated on the plat. By the end of the next business day following recordation of the plat, all required legal instruments (including deeds of easement) shall be recorded, and recorded copies of the plat and all legal instruments required by the City in association with development approval shall be provided to the City. (Reference: UDO 8.1.7.A; 10.2.5.F.4.d)

☑ <u>BUILDING PERMITS</u> - For buildings and structures shown on the approved plans. Commercial building permit plans must include the signed, approved Site Permitting Review plans attached, if applicable. Permit sets may be reviewed prior to the recordation of required plats, but cannot be approved.

# The following items must be approved prior to the issuance of building permits:

# **Engineering**

- 1. A public infrastructure surety shall be provided to City of Raleigh Transportation Development Engineering Division (UDO 8.1.3) in the amount of 100% of the improvement cost for the NCDOT portion and 125% of the improvement cost for the City of Raleigh infrastructure.
- 2. A fee-in-lieu for shortage of MUP requirement from existing sidewalk long Parklake Avenue frontage shall be paid to the City of Raleigh (UDO 8.1.10).

# **Stormwater**

3. Impervious restrictions for each lot must be recorded on a plat prior to building permit issuance.

# **Urban Forestry**

- 4. A public infrastructure surety for 9 street trees shall be provided to City of Raleigh Transportation Development Engineering Division (UDO 8.1.3) in the amount of 125% of the improvement cost for the City of Raleigh infrastructure.
- A tree impact permit must be obtained for the approved streetscape tree installations in the rights-of-way. This development proposes 6 street trees along Edwards Mill Road and 3 street trees along Parklake Avenue.



# **Administrative Approval Action**

Case File / Name: ASR-0014-2024 **DSLC - GLENLAKE LOT 1** 

City of Raleigh **Development Services Department** One Exchange Plaza Raleigh, NC 27602 (919) 996-2492 currentplanning@raleighnc.gov www.raleighnc.gov

6. A tree conservation plat shall be recorded with metes and bounds showing the designated tree conservation areas (UDO 9.1). This development proposes 0.32 acres of tree conservation area.

The following are required prior to issuance of building occupancy permit:

# General

1. Final inspection of the tree conservation area and all right-of-way street trees by Urban Forestry Staff.

EXPIRATION DATES: The expiration provisions of UDO Section 10.2.8 E, including the ability to request extensions in the expiration date, apply to this site plan. If significant construction has not taken place on a project after administrative site review approval, that approval may expire and be declared void, requiring re-approval before permits may be issued. To avoid allowing this plan approval to expire the following must take place by the following dates:

3-Year Expiration Date: September 3, 2027

Obtain a valid building permit for the total area of the project, or a phase of the project.

# 4-Year Completion Date:

Within four years after issuance of the first building permit for the site plan, the construction of the entire site plan must be completed unless an applicant has been granted vested rights. Failure to complete construction within this specified time frame shall automatically void the approved site plan for which no building permits have been issued.

I hereby certify this administrative decision. Keegan McDonald Signed: \_ Date: 09/03/2024 Development Services Dir/Designee Staff Coordinator: Michael Walters

# ADMINISTRATIVE SITE REVIEW SUBMITTAL FOR:

# **GLENLAKE LOT 1**

4501 EDWARDS MILL ROAD RALEIGH, NORTH CAROLINA WAKE COUNTY



VICINITY MAP

# CREEDMOOR ROAD EDWARDS MILL ROAD EDWARDS MILL ROAD The state of the s LAKERIM AVENUE NORTH

ZONING CONDITION COMPLIANCE SUMMARY

3.) THE PROPOSED COMMERCIAL BUILDING WILL BE ONE STORY & WILL NOT EXCEED 36 FEET IN HEIGHT 4.) THE OPERATING HOURS FOR THE RESTAURANT WILL BE BETWEEN 6:00 AM TO 12 MIDNIGHT. 5.) THERE WILL NOT BE ANY DRIVE THRU SERVICES AT THIS ESTABLISHMENT.

A 75 FOOT UNDISTURBED BUFFER ADJACENT TO THE 4515 EDWARD MILLS ROAD PROPERTY WILL REMAIN UNDISTURBED.

8.) THE BUILDING ENTRANCE WILL BE WITHIN 100 FEET OF BOTH EDWARDS MILL RD & PARK LAKE AVENU 9.) THERE WILL BE A MAXIMUM OF TWO PARKING BAYS (ONE DRIVE AISLE) PROPOSED BETWEEN THE BUILDING AND PARK LAKE AVENUE.

ALL ON-SITE LIGHTING WILL CONFORM TO THE RALEGH UDO SECTION 7.4.7 VEHICULAR CANOPIES. THERE ARE NO PARSING STRUCTURES ONSITE. LIGHTING LEVELS SHALL NOT EXCEED 0.5 FOOT CANOLES AT THE PROPERTY LINES.

1.) RESTAURANT ESTABLISHMENT USE IS NOT PROHBITED.

2.) BUILDING WILL NOT INCLUDE ANY PERSONAL SERVICES USES

7.) THE PROPOSED BUILDING WILL BE A ONE STORY BUILDING.

10.) THERE WILL BE NO PARKING STRUCTURES ONSITE.

2. SITE ADDRESS: 4501 EDWARDS MILL ROAD RALEIGH, NORTH CAROLINA 3. WAKE COUNTY P.UN.: 5. LOT AREA: GROSS LOT AREA: PROPOSED RICHT OF WAY DEDICATION: NET LOT AREA: 3.07 ACRES 0.06 ACRES 3.01 ACRES CX-7-CU (2022) 351 ZC 836 7 BUILDING CROSS FLOOR AREA & USE-8 152 SF - RESTAURANT 8. BUILDING HEIGHT: MEAN BUILDING HEIGHT=25"-6" MAX BUILDING HEIGHT=34"-2" MAXIMUM: REST./BAR: 1/100 SF GROSS FLOOR AREA = 8,152/100 = 82 PROVIDED = 53 SPACES (INCLUDES 3 HC SPACES) TOTAL HANDICAPPED SPACES REQUIRED/PROVIDED: 3 SPACES REQUIRED/PROVDED (INCLUDES 1 VAN SPACE) 1 VAN SPACE REQUIRED/PROVDED SHORT TERM: REQUIRED: 1 SPACE/50,000 GSF= 8,152/50,000 = 1 (4 MIN) PROMDED: 4 SPACES LONG TERM: REQUIRED: 1 SPACE/25,000 GSF= 8,152/25,000 = 1 (4 MN) PROVIDED: 4 SPACES 11. TOTAL IMPERVIOUS SURFACE AREA: 0.0 ACRES +/- (EXIST.) 1.20 ACRES +/- (PROPOS 1.20 ACRES +/- (PROPOSED)

NOTE: MAXIMUM ALLOWABLE IMPERVIOUS SURFACE AREA
PER THE APPROVED SCM DESIGN = 1.58 AC 14. INSIDE FALLS LAKE OR SWIFT CREEK D 16. OUTDOOR AMENITY AREA: REQUIRED = 10% OF 3.01 AC = 0.31 AC PROVIDED = 0.37 AC TRANSPARENCY: GROUND FLOOR: BLANK WALL AREA (MAX): 33% REQUIRED 21. DEVELOPER: PIEDMONT LAND DESIGN, PLLC o/o Mike Schneder, PE 8522-204 SX FORKS ROM PALEGH, NORTH CAROLINA 27615 (919) 845-7600 (PHONE) (919) 845-7703 (RAX)

CITY OF RALEIGH SITE PLAN INFORMATION

# **GENERAL NOTES**

ALL MATERIALS AND METHODS OF CONSTRUCTION SHALL BE IN ACCORDANCE WITH THE CITY OF RALEIGH AND THE STATE OF NORTH CAROLINA STANDARDS AND SPECIFICATIONS.

0 60' 120'

- CONTRACTOR SHALL HAVE NORTH CAROLINA ONE CALL (1-800-632-4849) LOCATE ALL EXISTING UTILITIES PRIOR TO BEGINNING CONSTRUCTION.
- CONTRACTOR SHALL VERIFY THE LOCATION AND DEPTH OF ALL EXISTING UTILITIES AND NOTIFY THE ENGINEER OF ANY DISCREPANCIES OR CONFLICTS PRIOR TO BEGINNING CONSTRUCTION.

- ALL SITE LIGHTING SHALL BE IN ACCORDANCE WITH THE CITY OF RALEIGH ZONING ORDINANCE.
- 8. THIS DEVELOPMENT SHALL CONFORM TO ZONING CONDITIONS FOR Z-77-2021.

### STORMWATER NOTES:

- STORMMATER WILL BE TREATED BY THE DISTING SOM FOR GLDNAKE SUROWISON. THE DISTING SOM HAS BEEN DESIGNATED TO ACCOPT STORMMATER FROM THIS STEE. THIS THAT TO DOES NOT EXCEED THE FERE-DEVELOPMENT REMORF THAT FOR THE 2 AND TO YEAR STORM FOR THE GUILLANCE SURDIVISION. THIS POND HAS BEEN APPROVED AND ACCOPTION BY THE GYTY OF RALID THE GYTY OF ALLID THE GYTY OF RALID THE GYTY OF THE GYTY OF RALID THE GY FAIL THE GYTY OF RALID THE GY THE GYTY OF RALID THE GY OF
- THE MAXIMUM ALLOWABLE IMPERVIOUS SURFACE AREA FOR THIS LOT PER THE APPROVED SCM DESIGN IS 1.56 AC.
- 3. NUTRIENT BUTDOWN PAYMENT RECEIPT WILL BE REQUIRED PRIOR TO FINAL APPROVAL OF SPR. REVIEW.

### SOLID WASTE COMPLIANCE STATEMENT

NEW TRASH COMPACTOR WITH HEAVY DUTY CONCRETE PAD SHALL BE PROVIDED IN THE LOCATION SHOWN ON THE PLANS. THE OWNER WILL USE A PRIVATE HAULER TO REMOVE SOLID WASTE, CARDBOARD, AND OTHER RECYCLARD.

### DRAWING INDEX

- PA 1 COVER SHEET
  PA 2 EXISTING CONDITIONS PLAN
  PA 3 SITE PLAN
  PA 4 GRADING PLAN
  PA 6 THE CONSERVATION PLAN
  PA 7 SOLID WASTE ROUTE PLAN
  LAOD LANDSCAPE PLAN
  L9-10 LANDSCAPE DETAILS
  L9-11 LANDSCAPE DETAILS
  L9-11 LANDSCAPE DETAILS
  A201 SITE PLAN ELEVATIONS
  A201 SITE PLAN ELEVATIONS

# PUBLIC IMPROVEMENT

UANTITY SUMMARY					
IMBER OF LOTS	1				
T NUMBER BY PHASE	N/A				
MBER OF UNITS					
VABLE BUILDINGS					
PEN SPACE	NO.				
INBER OF OPEN SPACE LOTS	NO.				
JBLIC WATER (LF)	0 UF				
JBLIC SEMER (LF)	0.05				
JBLIC STREET (UF) - FULL	0.07				
JOLIC STREET (LF) - PARTIAL	0.0"				
JBLIC SIDEWALK (LF)	980 LF				
TREET SIGNS	0				
ATER SERVICE STUBS	1				



CASE # ASR-0014-2024

EDWARDS MILL ROAD EIGH, NORTH CAROLINA GLENLAKE LOT ISSUED: 22 FEB 2024 REVISIONS: A29 MAY 2024
PER CITY COMMENTS ₹23 JULY 2024 PER CITY COMMENTS


ZONING ORDINANCE SUMMARY

DWG. NO. PA 1

DRAWN BY: JET CHECKED BY: MLS

PROJECT: HWDPL1B

COVER

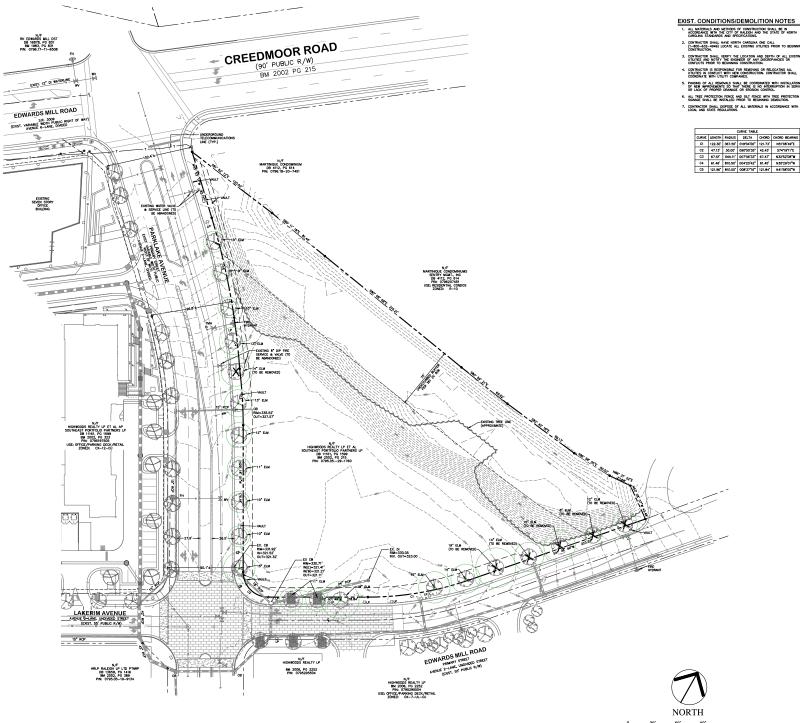



- ALL MATERIALS AND METHODS OF CONSTRUCTION SHALL BE IN ACCORDANCE WITH THE CITY OF RALEIGH AND THE STATE OF NORTH CARGUNA STANDARDS AND SPECIFICATIONS.
- CONTRACTOR SHALL HAVE NORTH CARGUNA ONE CALL (1-800-632-4949) LOCATE ALL EXISTING UTILITIES PRIOR TO BEGIN CONSTRUCTION.

			CURVE TABLE		
CURVE	LENGTH	RADIUS	DELTA	CHORD	CHORD BEARING
CI	122.30	367.50	019"04"00"	121.73	N51'08'49"E
C2	47.13	30.00	090'00'35"	42.43	S741911E
C3	67.51	544.11	007'06'33"	67.47	N32'52'06'W

SCALE IN FEET: 1" = 30

PHIMONILANDIESCNPIC



**GLENLAKE LOT 1** 

4501 EDWARDS MILL ROAD RALEIGH, NORTH CAROLINA


ISSUED: 22 FEB 2024

REVISIONS: ↑29 MAY 2024
PER CITY COMMENTS
↑23 JULY 2024
PER CITY COMMENTS

DRAWN BY: JET CHECKED BY: MLS PROJECT: HWDPL1B

> EXISTING CONDITIONS

CASE # ASR-0014-2024 DWG. NO. PA 2

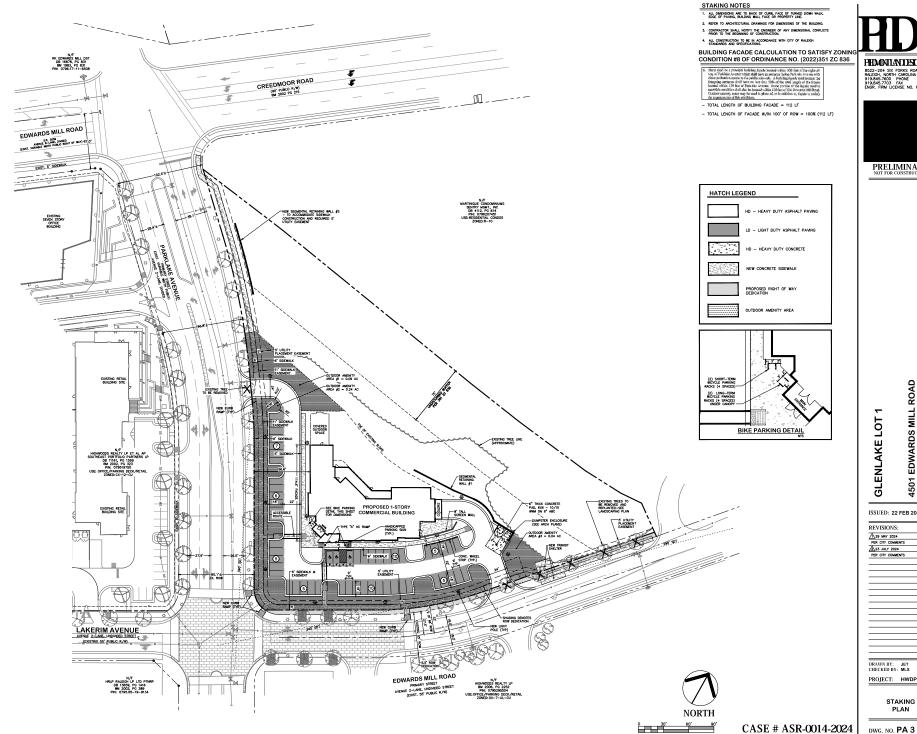

PHAONIANDESINATIC

PRELIMINARY NOT FOR CONSTRUCTION

**GLENLAKE LOT** 

4501 EDWARDS MILL ROAD RALEIGH, NORTH CAROLINA

ISSUED: 22 FEB 2024


REVISIONS: 29 MAY 2024
PER CITY COMMENTS
23 JULY 2024

PER CITY COMMENTS

DRAWN BY: JET CHECKED BY: MLS PROJECT: HWDPL1B

> STAKING PLAN

SCALE IN FEET: 1" = 30

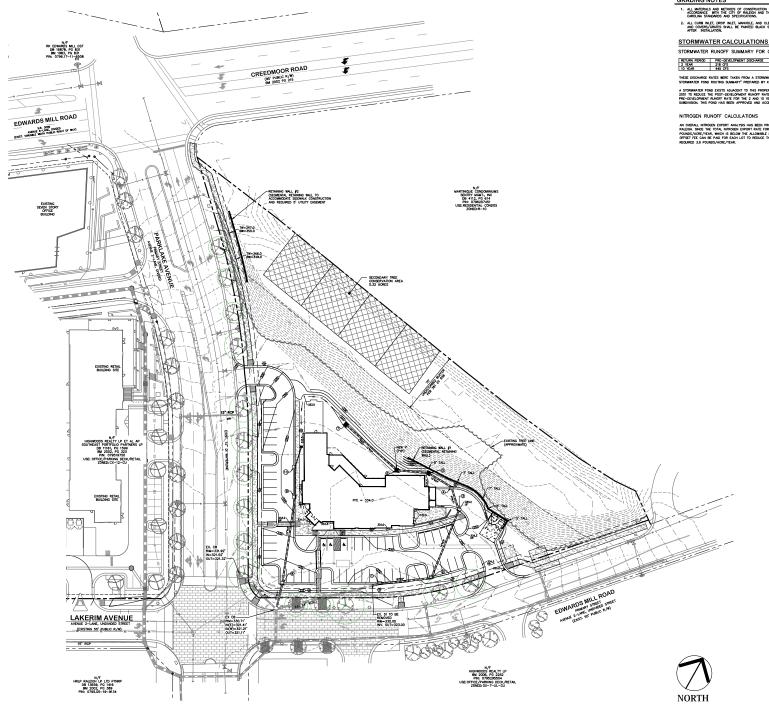

GRADING NOTES

- . ALL MATERIALS AND METHODS OF CONSTRUCTION SHALL BE IN ACCORDANCE WITH THE CITY OF RALEIGH AND THE STATE OF NORTH CAROLINA STANDARDS AND SPECIFICATIONS.

SCALE IN FEET: 1" = 30

PHAONITANDESCNPIC



PRELIMINARY NOT FOR CONSTRUCTION

4501 EDWARDS MILL ROAD RALEIGH, NORTH CAROLINA

ISSUED: 12 APR 2024

REVISIONS:

**GLENLAKE LOT 1** 


A 29 MAY 2024
PER CITY COMMENTS
23 JULY 2024
PER CITY COMMENTS

DRAWN BY: JET CHECKED BY: JDL

PROJECT: HWDPL1B

GRADING

CASE # ASR-0014-2024 DWG. NO. PA 4

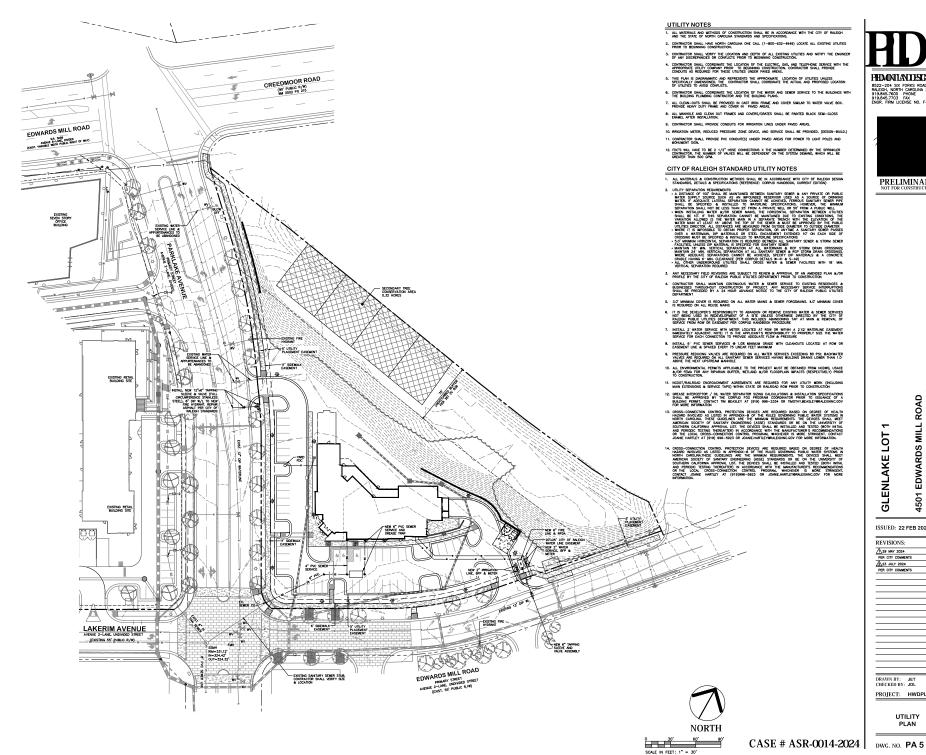

PHAONITANDESCNPIC

8522-204 SIX FORKS ROAD RALEIGH, NORTH CAROLINA 27615 919.845.7600 PHONE 919.845.7703 FAX ENGR. FIRM LICENSE NO. F-0843



**GLENLAKE LOT** 

4501 EDWARDS MILL ROAD RALEIGH, NORTH CAROLINA


ISSUED: 22 FEB 2024

REVISIONS: 29 MAY 2024 PER CITY COMMENTS

A23 JULY 2024 PER CITY COMMENTS

DRAWN BY: JET CHECKED BY: JDL PROJECT: HWDPL1B

UTILITY

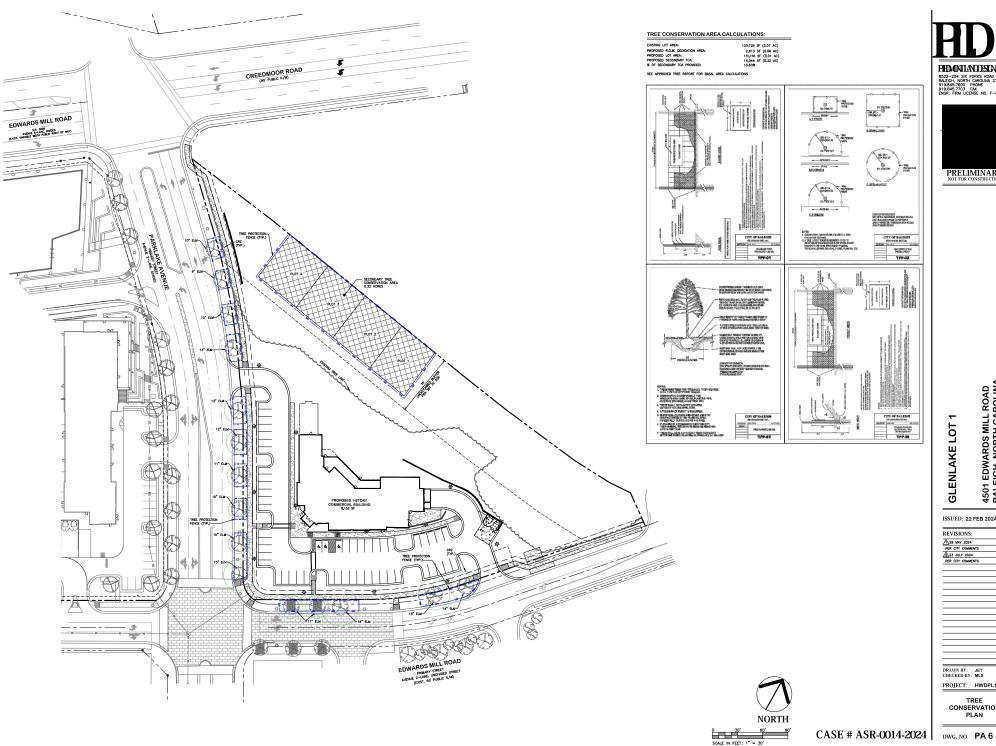



PRELIMINARY NOT FOR CONSTRUCTION

**GLENLAKE LOT 1** 

ISSUED: 22 FEB 2024

4501 EDWARDS MILL ROAD RALEIGH, NORTH CAROLINA

REVISIONS: A 29 MAY 2024
PER CITY COMMENTS
23 JULY 2024
PER CITY COMMENTS

DRAWN BY: JET CHECKED BY: MLS PROJECT: HWDPL1B

TREE CONSERVATION PLAN



PHANNIANDESNHIC 8522-204 SIX FORKS ROAD RALEIGH, NORTH CARGUNA 27615 919.845.7703 FAX ENGR. FIRM LICENSE NO. F-0843

**GLENLAKE LOT 1** 

4501 EDWARDS MILL ROAD RALEIGH, NORTH CAROLINA

ISSUED: 28 MAY 2024

REVISIONS:


A 29 MAY 2024
PER CITY COMMENTS
23 JULY 2024
PER CITY COMMENTS

DRAWN BY: JET CHECKED BY: MLS PROJECT: HWDPL1B

SOLID WASTE ROUTE PLAN

CASE # ASR-0014-2024 DWG. NO. PA 7

SCALE IN FEET: 1" = 30"

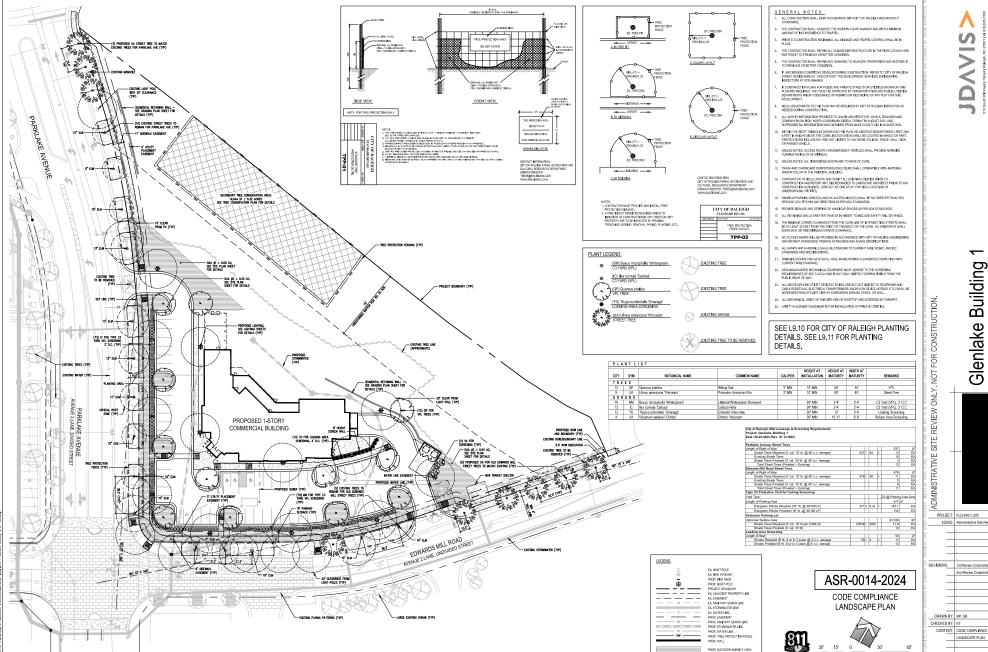

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Glenlake Building 1 4501 Edwards Mill Road Raleigh, North Carolina 27612

PROJECT: PLD-24011.200

ISSUE: Administrative Site Review 02:22:2024 REVISIONS: 1st Review Comments 05:29:2024 2nd Review Comments 07.12.20244

Call before you dig. SCALE: 1" = 30"

PROP, TREE CONSERVATION AREA

L4.00

### CHAPTER 2 TREE PLANTING AND MAINTENANCE

THIS CHAPTER OUTLINES THE STANDARDS FOR PLANTING AND MAINTAINING TREES ON PROPERTY OWNED OR CONTROLLED BY THE CITY OF PALEIGH.

THE PARKS, RECREATION AND CULTURAL RESOURCES DEPARTMENT IS RESPONSIBLE FOR PLAN REVIEW, INSPECTION, MONITORING AND ENTORCEMENT ASSOCIATED WITH TREE PLANTING AND MAINTENANCE ON PROPERTY OWNED OR CONTROLLED BY THE CITY.

- DEVELOPMENT, PRIVATE CITIZEN OR CONTRACT PLANTING ON CITY OWNED OR CONTROLLED PROPERTY BY ANY INCUIDANL OR COGNINGATION OF THE THAN THE CITY. THESE PROJECTS ARE AT THE EXPENSE OF THE ROCLESTOR AND REQUIRE A TIME IMPACT PERM
- PARTNERSHIP PLANTING UNDERTAKEN BY NON-PROFIT ORGANIZATIONS, PUBLIC-PRIVATE PARTNERSHIPS, AND CINC GROUPS. UNLESS WORK IS DONE UNDER STREET GUIDANCE AND OVERSIGHT BY THE URBAN FORESTER. THESE PROJECTS ARE AT THE EXPONSE OF THE ROQUESTOR AND PROJECTE AT THE IMPACT PERMIT.
- REQUESTS FOR TREE PLANTING AND TREE IMPACT PERMITS ARE EVALUATED IN THE ORDER IN WHICH THEY ARE RECEIVED.
- TREE PLANTING IS CONTINGENT ON THE PLANTING SEASON, AVAILABILITY OF PLANT MATERIAL, SITE SUITABILITY, STAFFING, AND FUNCING.
- THE URBAN FORESTER OR DESIGNEE WILL PRIORITIZE TREE PLANTING REQUESTS ACCORDING TO THE FOLLOWING CRITERIA:
- A. NEEDS BASED: AREAS DENTIFIED WITH THE GREATEST TREE CANOPY DEFICITS
- ON DEWAND: CITY DEPARTMENTS, VOLUNTEER GROUPS, NEIGHBORHOODS, CITIZENS, AND DEVELOPMENT

### D. TREE QUALITY STANDARDS

- COMPARE, PRIMERSH MUSERIY-CROWN PLANTS TRUE TO GENUS, SPECIES, WARETY, CLLTILARS, STEM FORM, SHEARING, AND OTHER FEATURES INDUSTED ON CRANINGS AND COMPLYING WITH AND SOLI, WITH FEATURY SHEARING, AND OTHER FEATURES INDUSTED ON CRANINGS AND COMPLYING WITH AND SOLI, WITH FEATURY WELL-SHIPED, PULLY SHAWMER, PLANTY, MOORNUS STOCK PRIZE OF DEFACE INSICTS, EGGS, LARINE, AND DEFECTS SHOULD AND STATE SHAW CANDERS, SHRAWMER, AND DEPRESENDENCE.
- TREES WITH MULTIPLE LEADERS, LINLESS SPECIFIED, WILL BE RELECTED. TREES WITH DAMAGED OR CROOKED LEADERS, BOYK ARRANGES, SURSCALD, DISTRIBUTING MOOTS, MERCT DAMAGE, OR CUTS ON LINIS OFFER TO IN NOLWETER THAT ARE NOT COMPLETELY CLOSED, OR ROOT FLARE MORE THAN 2" BELOW SURFACE OF ROOT BALL MILL BE RESCIETCE. 3. SPECIES SELECTION

  - B. EXOTIC INVASIVE SPECIES ARE NOT PERMITTED.
  - C. TREES TO BE INSTALLED UNDER OVERHEAD POWERLINES SHALL HAVE A MATURE HEIGHT OF NO GREATER THAN 30FT.
  - D. ALL SPECIES SELECTIONS SHALL BE REVIEWED BY THE URBAN FORESTER OR DESIGNEE
  - E. SPECIES DIVERSITY IS ENCOURAGED TO IMPROVE OVERALL URBAN FOREST HEALTH.
  - ALL PLANT WATERIAL AND INSTALLATION WORK SHALL CONFORM TO THE STANDARDS DETAILED IN THIS MANABI, THE MIRBICAN NATIONAL STRADARDS FOR TIBE CARE OPERATIONS, ANSI A330 AND NINSERY STOCK, ANSI ISSUE AND PPROVIDE OIL STANDARD DETAILS.
- ALL PLANT MATERIAL SHALL BE FREE OF ALL PESTS, DISEASES, AND CANKERS, IN HEALTHY CONDITION, AND FREE OF MECHANICAL DAMAGE AT THE TIME OF PLANTING AS DETERMINED BY URBAN FORESTRY STAFF.
- PROVIDE PLANTS OF SIZES, GRADES, AND BALL OR CONTAINER SIZES COMPLYING WITH ANS 200.1 FOR TYPES
  AND FORM OF PLANTS REQUIRED, PLANTS OF LANGER SIZE MAY BE USED IF ACCEPTABLE TO URBAN FORESTER
  MITH A PROPORTIONATE INCREASE IN SIZE OF ROOTS OR BALL BLUED.
- LABEL EACH PLANT OF EACH WARETY AND CALPER WITH A SECURELY ATTACHED, WATERPROOF TAG BEARING LEGIBLE DESIGNATION OF BOTANICAL AND COMMON NAME, INCLIDE NOVENCLATURE FOR HYBRID, WARETY, OR CULTIVIAR, IF APPLICABLE.

- MEASURE ACCORDING TO ANSIZED, WITH BRANCHES AND TRUNKS OR CANES IN THEIR NORMAL POSITION, DO NOT PRUNE TO OBTAIN REQUIRED SIZES.
- B. INSTALLATION SIZE FOR RIGHT OF WAY TREES.
- UNDERSTORY TREES SHALL BE A MINIMUM OF 1.5" CALIPER FOR SINGLE STEM AND 6" TALL FOR BOTH SINGLE AND MULTI-STEMMED TREES.
- A. TREES DESIGNATED BBB SHALL BE PROPERLY DUG WITH FIRM NATURAL BALLS OF SOL, WITH BALL SIZE NOT LESS THAN CLAMETER AND DEPTH BROOMEDINED BY MASI ZOL FOR THE AND SIZE OF TREE. RETAINING A WARM FERDIOLS, DROTS AS POSSEUR. BUSINES SHALL BE FRANCY WARMED WITH BLOOGRADABLE BURLAP AND SECURED WITH NAULS AS RECOMMEDICED BY WAST ZOO.
- B. THE ROOT FLARE SHALL BE APPARENT AT THE SURPACE OF THE ROOT BALL, OR THE CONTRACTION WILL BE RESPONDED FOR REMOVING EXCESS SILL FROM THE TOP OF THE ROOT BALL IN ORDER ESTABLES THE CORRECT GRACE. THESE SHALL BE REFECTED THE ROOT THAT AND HAS SEED IN SUL LONG ENOUGH FOR THE STEM TO SPRICE FACION THOSE ROOTS, RESS WITH LOOSE, BROWNEY PROCESSED, OR AMPLIFICATIONS OFOR BALL WILL HOT BE ROCEPTED.
- PROCESSED, IX WINNEY, LICENS SHALL BE HAVE YEARDOUGH WILL ADOTTE CHTEGOR READS GROWN
  CONTRIVENCE OF THE CONTRIVENCE OF THE CONTRIVENCE OF THE CONTRIVENCE
  MANIFARM A TRIMBALL WERE RESPONDED FROM CORFARE. THE SCOTT FACE SHALL BE PROVIDED
  AND SHALL BE REPORTED. FOR REMOVED FROM CORFARE.

  THE STATE OF THE REMOVED FROM CORFARE. THE SCOTT FACE SHALL BE PROVIDED
  BY REMOVED FOR THE STATE OF THE CONTRIVENCE OF THE REMOVED FROM REMOVED FOR STATE
  HAD BY ROOM TO HAD BALL SHAPE AND PROTECT FOOT MAS DEATH SHAPE WITH SOURCE
  AND SHAPE AND THE STATE OF THE STATE
- BASE ROOT MATERIAL SHALL BE GROWN IN THE GROUND IN THE NURSERY WITHOUT ARTHE MY.
  RESTSCHOOL DEVICES, SUCH AS CONTAINERS OF FARRY BASIS, MICRE RAYORABLE GROWNING
  CONCITIONS AND WHICH HAVE RESERVED THE PROPER LOLD LIBEAL TREATMENT TO DEVELOP A
  WILL BRANCHED ROOT SYSTEM, AFTER HARVEST, THE SOLLS REMOVED FROM THE ROOTS.

# 10. DELIVERY, STORAGE AND HANDLING

- A DO NOT PRUME TREES AND SHRUBS BEFORE DELIVERY, PROTECT BURK, SPANCHES, AND POOT SYSTEMS FROM SIX DCALD, DRYING, SWEATING, WHEPPING, AND OTHER HANDLING AND TYME DAMMAGE, DOWN BEBOO CREMOTE, THESE OR SHAUGHS BUSHOW AND STATE TO DESTROYT HER MATURIAL, SHAVE, PROVIDE PROTECTIVE COMERNIO OF EXTENDER PLANTS DURING DELIVERY, CO NOT DRYP EXTENDER PLANTS QUEING CLEIDEY.
- B. HANDLE PLANTING STOCK BY ROOT BALL HEAVIER MATERIAL SHALL BE HANDLED WITH STRAPS ON THE ROOT BALL AND APPROPRIATE EQUIPMENT SUCH AS A SMALL SKID STEER LONDER.
- DELIVER BARE-ROOT STOCK PLANTS FRESHLY DUG. IMMEDIATELY AFTER DIGGING UP BARE-ROOT STOCK, PACK ROOT SYSTEM IN WET STRAW, HAY, OR OTHER SUITABLE MATERIAL TO KEEP ROOT SYSTEM MOIST LIVITLE PLANTING.
- SET BALLED STOCK ON GROUND AND COVER BALL WITH SOL, PEAT MOSS, SAWDUST, OR OTHER ACCEPTABLE MATERIAL.
- . DO NOT REMOVE CONTAINER-GROWN STOCK FROM CONTAINERS BEFORE TIME OF PLANTING
- WATER ROOT SYSTEMS OF EXTERIOR PLANTS STORED ON-SITE WITH A PINE-MET SPRAY, WATER AS OFTEN AS NECESSARY TO MAINTAIN ROOT SYSTEMS IN A MOST, BUT NOT OVER LYMET CONDITION.

- A PLANTS SHALL BE GROWN WITHIN ONE COLD HARDINESS ZONE OF THE PROJECT SITE
- PROVIDE DIGITAL PHOTOS FROM THE NURSERY WITH HEIGHT DENTIFED FOR REVIEW BY THE URBAN FORESTER OR DESIGNEE PHOR TO CHIGONO OR SHIPPING, ALL TREES SHALL ALSO BE REVIEWED AND APPROVIDE PRICE TO INSTALLATION EFFICER AT PLACE OF PURCHASE, NURSERY, HOLDING YARD OR WINDY KITS OF THE LIBBAIL PROPROTED OR DEVIAME.

A. URBAN FORESTER OR DERICKEE MAY OBSERVE TREES AT PLACE OF PURCHASE, MIRISERY HOLDING MY OR AT SITE SECTOR "A WINNES FOR COMPLICE" MY HIS OR REMOVED FOR SIGNAS, SECTOR S

### 13. SUBSTITUTIONS

- B. IF FOR ANY REASON TREES CANNOT BE INSTALLED ACCORDING TO THE PLANS A REQUEST SHALL BE MADE TO THE URBAN FORESTER IN MISTING. THE CONTRACTOR SHALL IMPORT THE CITY AND ALTERNATE FLANTING LOCATIONS SHALL BE SELECTED FOR A PROVIAL BY THE URBAN FORESTER.

### PLEASE REFER TO CITY OF RALEIGH STANDARD DETAILS LOCATED AT RALEIGHNG GOV

- A. TREES WILL BE PLANTED IN ACCORDANCE WITH SPACING REQUIREMENTS DETAILED IN THE UNIFIED DEVELOPMENT ORDINANCE UNLESS OTHERWISE DIRECTED BY THE URBAIN FORESTER OR DESIGNEE
- B. TREES TO BE INSTALLED UNDER OVERHEAD UTILITY LINES SHALL HAVE A MATURE HEIGHT OF NO GREATER THAN 30FT

### C GROUPED PLANTINGS

### 3. EXECUTION

### A. TREE AND SHRUB EXCAVATION

- PLANTING HOLE: DICAWATE CROULAR PITS WITH SIDES SLOPED NOWNO, TRIM BASE LEWING CENTER AREA RABED SLIGHTLY TO SUPPORT ROOT BALL AND ASSIST IN DRAINAGE, DO NOT FURTHER CISTURS BASE. SCARPY SIDES OF PLANT RT SMEARED OR SMOOTHED DURING EXXXAUTION.
- EXCAVATE APPROXIMATELY THREE TIMES AS WIDE AS BALL DIAMETER FOR ALL PLANT MATERIAL.
- SCIL REMOVED FROM EXCAVATIONS MAY BE USED AS BACKFILL PROVIDED IT MEETS THE SPECIFIED PLANTING SOL, MIX REQUIREMENTS.
- CRAINAGE: PLANTING HOLES NOT ASSOCIATED WITH A CRAIN SYSTEM SHALL DRAIN FULL WITHIN A 12-HOURPERIOD. NOTIFY URBAN FORESTER IF SUBSOLL CONCITIONS EVIDENCE UNEXPECTED WATER SEEPAGE OR RETENTION IN TIRE OR SHRUB PITS.

### R TREE AND SHRUB PLANTING BALL AND BURLAP

- SET BALLED AND BURLAPPED STOCK PLUMB AND IN CENTER OF HTT OR TRENCH ROOT FLARE AT GRADE. A MADIMUM OF 2 INCHES ABONE ADJACENT RINGH GRAD AND NEVER BELOW GRADE. DO NOT MANEUVER BY TRUNK, MADICE BY ROOT B. ONLY.
- REMOVE BURLAP AND WINE BASKETS FROM THE TOP % OF ROOT BALL, CUT OFF AND DESCARD FROM HOLE, BUT DO NOT REMOVE PROMUNDER ROOT BALLS. REMOVE PALLETS, F. MY, BEFORE SETTING, ON DOT USE PLANTING STOCK FROOT BALL IS CRACKED OR BROKEN BEFORE OR DURING PLANTING OPERATION.
- CHARLES LA SENDANT SERVICE OR DUTTED FROM THE OPENITION.

  PLACE PLANTING SIGN. MY ARROWN FOR STALL PLANTERS, TAMPHIS GENTLY TO SETTL

  MX AND ELIMINATE VIDES AND ARPOCRETS, WENNETT IS REPRODUNKTELY CORE-HALF

  BLOCKFLLED, WATER THOCKOUGHY SERVED PLANTING SOUR MYSTER AGAIN AFTER

  REPEAT WHITENING UNIT, NO MORE WATER IS ABSCRIBED, WATER AGAIN AFTER

  PLANTING AND TAMPED FRUIL, LAFFE OF PLANTING SOUR. MYSTER AGAIN AFTER

  ALTERNA AND TAMPED FRUIL, LAFFE OF PLANTING SOUR. MYSTER AGAIN AFTER

  MYSTER AND THE SERVICE OF T

- SET CONTAINER GROWN STOCK PLUMB AND IN CENTER OF PIT OR TRENCH WITH ROOF PLANE AT GRADE, A MADIBUM OF ZINCHES ABOVE ADJACENT FINISH GRADES, AND NEVER BELOW GRADE, DO NOT MANEUVER BY TRUNK. HANDLE BY ROOT BALL ONLY. CAREFULLY REMOVE ROOT BALL FROM CONTAINER WITHOUT DAWAGING ROOT BALL OR PLAYT, GENTLY LOOSEN THE ROOTS AND CUT ANY CIRCL NO ROOTS IN AT LEAST TWO PLACES.
- PUMCE PLANTING SCIL MIX AROUND ROOT BALL IN LAYERS, TAMPING TO SETTLE MIX AND ELIMANTE VIDES AND AR POCKETS. WHEN IT IS APPROXIMATELY CRE-HULF BOXFOLLED, WATER THOROUGH PURCHERS FOR EACH PURCH BOXFOLLED, WATER ASSOCIATION, WATER AGAIN AFTER PLANTING SCIL MORE WATER ASSOCIATION. WATER AGAIN AFTER PLANTING SCIL MORPHOR THAIL LYTS OF PLANTING SCIL. MORE WATER AGAIN AFTER PLANTING SCIL MORPHOR THAIL LYTS OF PLANTING SCIL.

### TREES IN SIDEWALKS, PITS, GRATES AND TREE LAWINS

- b. TREE GRATES SHALL HAVE A PROVISION FOR TRUNK EXPANSION OF THE TREE, SUCH AS POP OUT CONCENTRIC RINGS IN THE GRATE AROUND THE TRUNK.
- c. NO UTLITIES OR ELECTRICAL CONDUITS ARE PERMITTED WITHIN THE TREE PT OR GRATE. UTLITIES MAY RUN BELOW AND THROUGH THE SUBSURFACE ROOT EXPANSION INFRASTRUCTURE.
- TREES SHALL BE CENTERED IN THE PIT
- TREE PITS SHALL ACCOMMODATE A DEPTH OF 3' OF PLANTING SOIL.
- . HIGH QUALITY PLANTING SOIL SHALL BE USED IN THE PIT DIRECTLY BELOW THE GRATE
- DRAINAGE SHALL BE PROVIDED.

## MINIMUM 6 FEET WIDE TREE LAWN.

- TREE CENTERED IN AREA.

### E. REQUIRED SUBSURFACE ROOT EXPANSION

- HIGH-QUALITY PLANTING SOIL OR STRUCTURAL SOIL SHALL BE USED TO ACCOMPLISH THE SOIL VOLUME REQUIREMENT. 800 CUBIC FEET OF SUBSURFACE ROOT EXPANSION AREA REQUIRED PER TREE.
- b. SUBSURFACE SOIL CONTAINMENT STRUCTURE

- MAY ONLY BE USED IN COMENATION WITH OTHER OFFICIAS OR IN CASES WHERE CONNECTIONS TO AVAILABLE SOL SPACE AMPLIES THE 600 CURE FEET RECORDING TO AVAILABLE SOL SPACE AMPRICES THE 600 CURE SECTION AND AVAILABLE SOL SPACE AMPLIES TO ADJACENT ROOT PATHS WITH POSSIBLE.
- C.3. WHEN ROOT EXPANSION PATHS EXTEND UNDER THE SIDEWALK ENSURE MINIMAN DENSITY REQUIREMENTS ARE MET.

- APPLY 3 NOH AVERAGE THICKNESS OF ORGANIC MULCH EXTENDING 12 INCHES BEYOND EDGE OF PLANTING PTI OR TRENCH, DO NOT PLACE MULCH WITHIN 3 NOHES OF TRUNKS OR STEMS. ROOT FLARE SHALL BE VIBLE AT BASE OF ALL PLANT MATERIA.
- MULCH SHALL BE THE RESPONSIBILITY OF THE ADJACENT PROPERTY OWNER TO REFRESH AS NEEDED AND KEEP FREE OF DEBRIS AND TRASH.
- G. SOIL
  - BACKFLL DRECTLY IN TREE PIT OR PLANTING AREA SHALL BE HIGH-QUALITY PLANTING SOLL SUTTABLE FOR SUCCESSFUL GROWTH.

# THE URBAN FORESTER OR DESIGNEE MAY REJECT UNSUITABLE SOIL.

- H. GUYING AND STAKING
  - REMOVE ALL STAKING MATERIAL AFTER 1 YEAR.
- LEAVE SLIGHT SLACK IN TIE TO PROMOTE TRUNK TAPER. UPDIENT STANDA AND THIS: YIMEN KOOLINED DIES ANMANIANTS STANDA. SET YESTOLI.
  STANDA AND SPACE TO NIND PRIEIT PARTIES FROM THALES ON FROM THESES. SUPPORT TREES
  CONTACT POWER WITH THE TRANS. ALLOW REDUCH SLACK TO ANDD BRIDE RESTANDAT OF
  TREE. SPACE STANDA COLUMN THE SAND ATTACH FLAGS TO EACH QUY WHIE FOR
  YESEL BY.

### F. WAINTENANCE AND WARRANTY STANDARDS

A TREE IMPACT PERMIT IS REQUIRED FOR MAINTENANCE ACTIVITIES.

IT IS THE ADJACENT PROPERTY OWNER'S RESPONSIBILITY TO MAINTAIN THE MULCH RING OR TREE GRATE AROUND TREES IN THE RIGHT OF WAY AND PREVENT STRING TRIVMER OR MOWER DAMAGE.

- A. MANTANIA AKTHASS BY PRINNING, CULTIVATING, WATERING, WEEDING, FERTIL LENG, MALCHING, RESTORNO RANTING SALCERS, ADLASTING AND RESAMEND TREEST STAFFLICKTION CREVIES. RESERTING TO PROPER GRADES OF VEHICLAL POSITION, AND PERFORMAND OFFER OPERATIONS AS REQUERED TO ESTABLES HEALTHY, WARLE PLANTINGS, SPRAY OR TREAT AS REQUIRED TO KEEP PLANTIS REFOR OR RESCITE AND DESCRIPTIONS.
- FILL IN AS NECESSARY SOL SUBSIDENCE THAT MAY OCCUR BECAUSE OF SETTLING, RUTTING OR DAMAGE BY EQUIPMENT OR OTHER PROCESSES, REPLACE MULCH MATERIALS DAMAGED OR LOST IN AREAS OF SUBSIDENCE.
- APPLY TREATMENTS AS REQUIRED TO KEEP PLANT WATERNUS, PLANTED AREAS AND SOLLS PREE OF PESTS AND PATH-CORNES ON LEBEGRE, USE INTEGRATED PEST WANGEMENT PRACTICES WHEREVER POSSIBLE TO NUMBER TO LIGHT OF THE THE STATE OF THE THE THE THE THE THE THE PROPERTY OF THE THE THE THE PHYSICAL CONTROLS SUCH AS THOM OF FOLINGE, MECHANICAL CONTROLS SUCH AS TRAPS, AND SOLICIDED, CONTROLS SUCH AS THOM OF FOLINGE, MECHANICAL CONTROLS SUCH AS TRAPS, AND SOLICIDED, CONTROL ASSETS.
- A PROVIDE AND MAINTAIN TEMPORARY RIFING, HOSES, AND WATERING EQUIPMENT TO CONVEY WATER
- B. SCHEDULE WATERING TO COMPLY WITH THE CITY OF RALEIGH WATER CONSERVATION ORDINANCE
- WATERING VOLUMES SHOULD BE BASED UPON DELIVERY OF INCH OF MOISTURE PER WEEK TO THE PLANT IF PRECIPITATION DOES NOT MEET THAT AMOUNT DURING THE ACTIVE GROWING SEASON DEFINED AS A PRILL THROUGH NOVEMBER 1. SUPPLEMENTAL WATER SHALL BE APPLIED DURING THE ESTABLISHMENT PERIOD AS PREQUENTLY AS 3. TIMES PER WEBLAND DURING PERIODS OF DROUGHT OR EXCESSIVE HEAT.
- E. USE A SLOW FLOW HOSE END DENIE AND WATER EACH THEE AT THE BASE FOR SEVERAL INNUTES.
  COMMERCIALLY ANNUARE WATER BAGS ARE ACCEPTABLE. AT EACH WIST MAYE SARE THE BAGS IS
  BARYT, THOROUGH Y SOAN, THE ROTO DILL, THE MESTAL THE BAG OFFICIAN THE EMITTERS ALVOY
  PREFE CON OF WATER TO BESURE THE BAG WATER, DAVIE, ALL INSTERS BAGS SHALL BE REMOVED.
  PROSI THESE SHAPE THO REMOVEMENT USEL THAT PLAY IS TO COLOMBY DEVIA.

- B. MULCH TO THE DRIP LINE OF MATURE TREES.
- C. DO NOT PLACE MULCH WITHIN 3 INCHES OF TRUNKS OR STEMS, ROOT PLARE SHALL BE VISIBLE AT BASE OF ALL PLANT MATERIAL.
- D. KEEP MULCH FREE OF WEEDS, TRASH AND DEBRIS

- A TREE GRATE MAINTENANCE IS THE RESPONSIBILITY OF THE ADJACENT PROPERTY OWNER. MAINTAIN GRATES FREE OF WEEDS, TRASH AND DEBRIS.
- REPLENISH GRAVEL AS NEEDED TO MAINTAIN AN EVEN SURFACE. GRAVEL SHALL MATCH EXISTING MATERIAL, TYPICALLY GRAY PEA GRAVEL #67 WASHED STONE GRAVEL.
- C. NOTIFY URBAN FORESTER IF THE TREE GRATE IS GROUNG TREE OR CAUSING DAMAGE TO TREE.
- A PREVIOUS TRANSPORT AND THE CHEMICALS AND BILLODIAL CONTROL AGAINS IN ACCORDANCE WITH BEOLOGISHMAN OF AUTHORITIES HAVING A BISSICITION AND MAURICAL DRESS WITH THE BEOLOGISHMAN OF CHEMICAL STATEMENT AND THE CHEMICAL STATEMENT AND THE CHEMICAL ACCORDANCE WITH TO THE VICK. ACRITY URBAN PORESTER REFORE EACH APPLICATION IS PREPORTED AND OTHERS IN PRODUITY IN PERMIT.
- PRE-EMERGENT HERRICIDE: APPLY TO TREE, SHRUB AND GROUND-COVER AREAS IN ACCORDANCE WITH MANUFACTURERS WRITTEN RECOMMENDATIONS, DO NOT APPLY TO SEEDED AREAS.
- C. POST-ENERGENT HERBICIDE: APPLY ONLY AS NECESSARY TO TREAT ALREADY GERMINATED WEEDS AND IN ACCORDANCE WITH WANLFACTURER'S WRITTEN RECOMMENDATIONS.
- A. ALL TREE PRUNING SHALL BE DONE BY OR UNDER THE SUPERVISION OF ANISA CERTIFIED ARBORIST


# 7 ROOT PRI MING

- A. AREA FOR ROOT PRUNING MUST BE APPROVED BY AN IBA CERTIFIED ARBORIST TO PREVENT A HAZARDOUS TREE CONDITION (CHAPTER N.
- ACCEPTABLE METHODS OF CUTTING ARE BY SHARP HAND PRUNERS, LOPPERS, HAND SAW OR HYDRAULIC TOOLS, IMPLEMENT MUST LEAVE A CLEAN CUT.
- C. IF EXCAVATION CAUSES PRUMED ROOTS OVER 1.5" IN CHAMPTER TO REMAIN EXPOSED FOR MORE THAN 24 HOURS, ROOTS ON TREE SIDE SHALL BE KEPT MOST. BACKFUL WITH TOPSOL, MOST MUICH, OR DRAFE WITH WET BURLEY.
- D. WHERE CONCRETE IS POURED ADJACENT TO PRUNED ROOTS HEAVY DUTY PLASTIC SHALL BE INSTALLED AGAINST THE TREE SIDE OF THE PRUNED ROOTS TO PREVENT UPTAKE (TOUC TO TREE) 8. TREE REPLACEMENT OF WARRANTIED TREES
- A. TREES SHALL SE REPLACED IN THE NEXT PLANTING SEASON IF THEY ARE MORE THAN 25% DEAD. IN RAPID DECLINE, ARE INVESTED BY NESTED OF DESAUE, HAVE LOST THE NATURAL SHAPE DUE TO DEAD BRANCHES, EXCESSIVE PRUNKS INCLUDING WARDALISM, MADEQUATE OR IMPROPER MAINTENANCE, OR ARE FALING DUE TO OTHER CAUSES.
- REPLACEMENT TREES INSTALLED AFTER THE 1ST YEAR OF A 2-YEAR WARRANTYMAINTENANCE PERIOD SHALL GET A FULL 1 YEAR OF WARRANTYMAINTENANCE FROM THE TIME OF PLANTING.

A TREE PROTECTION PLAN IS REQUIRED FOR ANY ACTIVITY IMPACTING CITY TREES INTENDED TO REMAIN

### 1. TREE PROTECTION PLAN

- A. SUBMIT PROJECT PLANS SHOWING TREE PROTECTION WITH THE TREE IMPACT PERMIT REQUEST.
- B. TREE SPOTECTION BLAN SHALL BACKLING ALL THAT ADDLY
- EXISTING TREES ON SITE.
- TREE PROTECTION FENCING DELINEATION AND SPECIFICATION.
- OTHER PRODUCTS FOR PROTECTION IN LICHIMATTING/ETC.) REMEDIATION
- TREE PROTECTION FENCING SHALL BE INSTALLED AT A MINIMUM RADIUS OF THE CRITICAL ROOT ZONE (CRZ) (TREE) (CRZ DEFINED AS RADIUS 1,25 FEET PER CAUPER NOH AT DRH FROM TRUNK OF TREE).
- TREE PROTECTION SIGNAGE REQUIRED EVERY 50 FEET. IF CONSTRUCTION OCCURS WITHIN THE CRZ AT LEAST 12" OF MULCH SHALL BE PLACED AND/OR LOCKING M WHERE MACHINERY MANELYERS TO REDUCE SOIL COMPACTION IN THIS ZONE AND IDENTIFY ON PLAN.
- THE TREE PROTECTION FENCING SHALL NOT SE WOLATED FOR THE DURATION OF THE PROJECT WITHOUT APPROVAL FROM URBAN FORESTRY STAFF. THERE WILL BE ZERO TOLERANCE FOR STORING OR PARKING VEHICLES, SUPPLIES, OR EQUIPMENT UNDER PROTECTED TRUES.

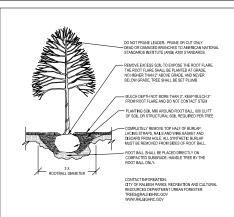

- NOTES:

  1. TREES MUST MEET THE TREE QUALITY STANDARDS IN CH. 2 OF THE CITY TREE MANUAL.

  2. CONTRACTOR IS RESPONSIBLE FOR ADEQUATE DRAINAGE OF ALL PLANTING PITS. (POSITIVE DRAINAGE AWAY FROM PIT)
- 4 A TREE IMPACT PERMIT IS REQUIRED. 5. ELECTRICAL OUTLETS AND OTHER UTILITIES ARE PROHIBITED IN THE PLANTING AREA IMMEDIATELY SURROUNDING THE TREE

TREES SHALL BE PLANTED BETWEEN OCTOBER 1ST AND APRIL 30TH.

 IF STAKING IN ACCORDANCE WITH THE CITY TREE MANUAL, THE STAKING MUST BE REMOVED WITHIN ONE YEAR. 7. TREES WILL HAVE A MINIMUM 1 YEAR WARRANTY AFTER THE INITIAL PLANTING IS APPROVED BY THE CITY CITY OF RALEIGH TREE PLANTING DETAIL TPP-03

NOTE: DETAIL TPP-03 IS FOR STREET TREE PLANTINGS, SEE DETAIL # 5 SHEET L9.11 FOR ALL OTHER TREES ON SITE

Inlake Building 1 Edwards Mill Road 3h, North Carolina 27612 4501 E Raleigh, I en 즁

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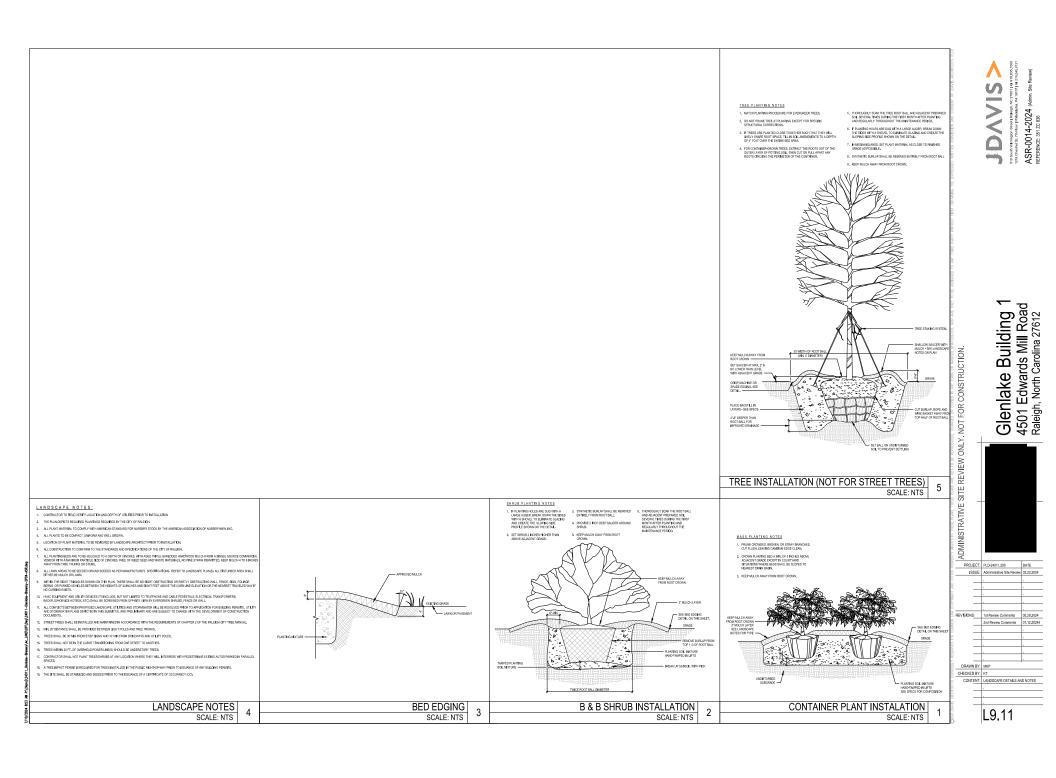
2010 South Wilmington Street | Refergh. NC 1218 Chestrual St. The Root | Prolaboscheia, P. ASR-0014-2024 (Add REFERENCE: 351 ZC 836


ONLY. NOT FOR CONSTRUCTION. **REVIEW** SITE PROJECT: PLD-24011-200


ISSUE: Administrative Site Review 02.22.2024 REVISIONS: 1st Review Comments 05.29.2024 2nd Review Comments 07.12.20244 DRAWN BY: MP, SB

CONTENT: CITY OF RALEIGH STANDARD L9.10

CHECKED BY: KT



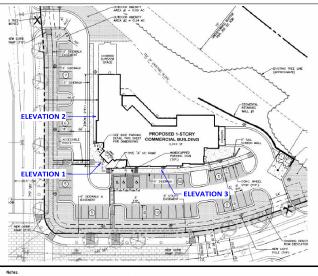


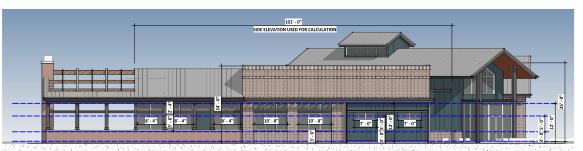

Parklake - West

07/22/24

POST-DEVELOPMENT GRADE					BUILD	ING: FFE 334.0'	Building Type: 0	ype: General Building CX-7-U [ VDO 3.2.5 ]		
	Elevation	Post Development	Post Development		Average Post Development		UDO 1.5.7	Building Height [ CX ]		
	cievation	Grade to Low Roof	Grade to High Roof		Grade to High Roof		UDO 3.2.5	Maximum [ CX ]	Provided [ CX ]	
	Side Elevation - West	ELEV: 333.3'	ELEV: 333.3'		THE HIGH PO	NT OF ROOF IS LOCATED		34'-2"	1 stories - 34'	
2	Side Elevation - West	24'-0" ABOVE GRADE	25'-0' ABOVE GRADE	25'-0" ABO		25'-0" ABOVE THE AVERAGE GRADE OF 333.3"		Transparency [ CX ]		
							Ground Floor	33% [0'-12']; 50% of req'd [	3'-8'), see elevations	
							UDO 3.2.5.F	Blank Wall [ CX ] Maximu	m = 20'	
TRAN	ISPARENCY							no elevation has more than 20' of blank wall		
Over	rerall Facade Area [0'-12'] = 1212 sf Required		Required	Р	ovided As per UDO 1.5.9-8.4: Glass shall be considered transparent where it has		UDO 7.2.5.D	Screening: Mechanical Equipment.  Roof Mounted Equipment with Screens		
Required Transparency = 33% of the total area from 0' to 12'		33%: 1212 x 33% = 400 sf	435 sf		a transparency higher than 80% and an external reflectance of less		Roor Pounted Equipment With Screens		4	
Requ	ired Transparency between 3'	3. 8' = 50% of the req'd area	50%: 400 x 50% = 200sf	226 sf than 15%, Glass on upper stories may have any level of transparency and external reflectance.						

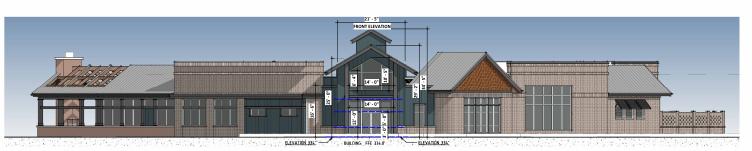

Entry Elevation.

1/8" = 1'-0"

Notes:	POST-DEVELOPMENT GRADE				BU	JILDING: FFE 334.0'	Building Type:	General Building CX-7-U [	[ UDO 3.2.5 ]
		Elevation	Post Development Grade to Low Roof	Post Development Grade to High Roof		Average Post Development Grade to High Roof	UDO 1.5.7 UDO 3.2.5	Building Height [ CX ]  Maximum [ CX ]	Provided [ CX ]
	1 Entr	itry Elevation - Corner	ELEV: 334" 16"-6" ABOVE GRADE	ELEV: 334 25'-0" ABOVE GRADE		IGH POINT OF ROOF IS LOCATED ABOVE THE AVERAGE GRADE OF 334	UDO 15.9	34'-2" Transparency [ CX ]	1 stories - 34'
	$\vdash$				$\neg$		Ground Floor		eq'd [3'-8'], see elevations
	TRANSPARI	RENCY					UDO 3.2.5.F	Blank Wall [ CX ] Ma no elevation has more	aximum = 20" than 20" of blank wall
	Overall Facade Area [0'-12'] = 237 sf  Required Transparency = 33% of the total area from 0' to 12'		Required P 33%: 237 x 33% 168 sf = 79 sf		Provided As per UDO 1.5.9-B.4: Glass shall be considered transparent where it has		Screening: Mechanical Equipment.  Roof Mounted Equipment with Screens		
					a transparency higher than 80% and an external reflectance of less		KOOT MOUNTED EQUIPMEN	nr with Screens	
	Required Transparency between 3' & 8' = 50% of the req'd area		50%: 79 x 50% = 39.5 sf	70 sf	than 15%. Glass on upper stories may have any level of transparency and external reflectance.				
						and external reflectance.			

919 829 4969

115 1/2 E. Hargett Street Suite 300 Raleigh, NC 27601

4501 Edwards Mill Road Highwoods


Raleigh. NC 27612

Issued For: Review

Exterior Elevations for Site Plan Review

Project Number	23045				
Date	07/22/24				
Drawn By	MM				
Checked By	MM				
A-200					

As indicated

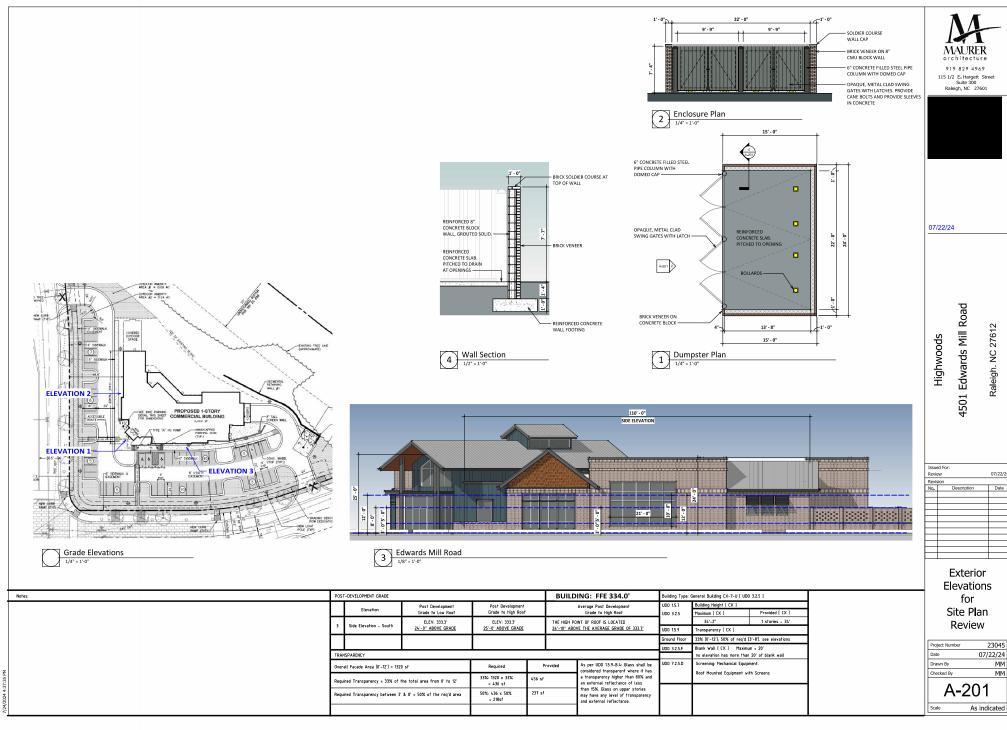



07/22/24 Date

A-201					
Checked By	MM				
Drawn By	MM				
Date	07/22/24				
Project Number	23045				



115 1/2 E. Hargett St Suite 300 Raleigh, NC 27601 maurerarchitecture.com



SEALS

# PHOTOMETRIC PLAN FOR. GLENLAKE LOT

DATE	07/10/2024
DR.	CML
CH.	MK/CHKBY
PROJ. #	-
REVISIONS	DATE

PHOTOMETRIC PLAN

1 OF 1