Administrative Site Review Application

Office Use Only: Case #:



Planning and Development Customer Service Center • One Exchange Plaza, Suite 400 | Raleigh, NC 27601 | 919-996-2500

This form is required when submitting site plans as referenced in Unified Development Ordinance (UDO) Section 10.2.8. Please check the appropriate building types and include the plan checklist document when submitting.

Planner (print):

Please review UDO Section 10.2.8. to determine the site plan tier. If assistance determining a Site Plan Tier is needed				
	ı request can be submitted online	e via the Permit and Development Portal. (Note: There is a		
Site Plan Tier: Tier Two	o Site Plan Tier Three	e Site Plan		
Building and	Development Type	Site Transaction History		
(Check	all that apply)			
Detached	General	Subdivision case #:		
Attached	Mixed use	Scoping/sketch plan case #:		
Townhouse	Civic	Certificate of Appropriateness #:		
Apartment	Cottage Court	Board of Adjustment #:		
Tiny house	Frequent Transit	Zoning Case #: Design Alternate #:		
Open lot	Development Option	Design Alternate #.		
opon lot				
	GENERAL II	NFORMATION		
Development name:				
Inside City limits? Ye	s No			
Property address(es):				
Site P.I.N.(s):				
Please describe the scope	e of work. Include any additions,	expansions, and uses (UDO 6.1.4).		
	•	ildings, a pool/clubhouse, and the necessary		
parking and site infras	tructure.			
Current Property Owner	(s):			
Company: Mitchell Mill I	• •	Title:		
Address:				
Phone #:	Email:			
Applicant Name (If differ	rent from owner. See "who can	apply" in instructions):		
	Lessee or contract purchaser	Owner's authorized agent Easement holder		
•	· 			
Company: Advanced C	'ivil Design Address:			

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Phone #:	Email:		
NOTE: please attach purchase agreemen	t or contract,	lease or easement when submitting this form.	
Developer Contact:			
Company: Title:			
Address:			
Phone #:	Email:		
Applicant Name:			
Company:	Address:		
Phone #:	Email:		

DEVELOPMENT TYPE + SITE DATE TABLE (Applicable to all developments) SITE DATA **BUILDING DATA** Existing gross floor area (not to be demolished): Zoning district(s) (please provide the acreage of each): Gross site acreage: Existing gross floor area to be demolished: # of parking spaces proposed: New gross floor area: Max # parking permitted (7.1.2.C): Total sf gross (to remain and new): Overlay District (if applicable): Proposed # of buildings: Existing use (UDO 6.1.4): Proposed # of stories for each: Proposed use (UDO 6.1.4): Proposed # of basement levels (UDO 1.5.7.A.6)

STORMWATER INFORMATION			
Imperious Area on Parcel(s):	Impervious Area for Compliance (includes ROW):		
Existing (sf) Proposed total (sf)	Existing (sf) Proposed total (sf)		

RESIDENTIAL & OVERNIGHT LODGING DEVELOPMENTS						
Total # of dwelling units: Total # of hotel bedrooms:						
# of bedroom units: 1br 84	2br <u>108</u>	3br <u>24</u>	4br or more			
# of lots:			Is your project a cottage court?	Yes	No	
			A frequent transit development?	Yes	No	

Continue to Applicant Signature Block on Page Three.

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APPLICANT SIGNATURE BLOCK

Pursuant to state law (N.C. Gen. Stat. § 160D-403(a)), applications for development approvals may be made by the landowner, a lessee or person holding an option or contract to purchase or lease land, or an authorized agent of the landowner. An easement holder may also apply for development approval for such development as is authorized by the easement.

By submitting this application, the undersigned applicant acknowledges that they are either the property owner or one of the persons authorized by state law (N.C.G.S. 160D-403(a)) to make this application, as specified in the application. The undersigned also acknowledges that the information and statements made in the application are correct and the undersigned understands that developments approvals are subject to revocation for false statements or misrepresentations made in securing the development approval, pursuant to N.C. Gen. Stat. § 160D-403(f).

The undersigned indicates that the property owner(s) is aware of this application and that the proposed project described in this application will be maintained in all respects in accordance with the plans and specifications submitted herewith, and in accordance with the provisions and regulations of the City of Raleigh Unified Development Ordinance.

The undersigned hereby acknowledges that, pursuant to state law (N.C.G.S. 143-755(b1), if this permit application is placed on hold at the request of the applicant for a period of six consecutive months or more, or if the applicant fails to respond to comments or provide additional information requested by the City for a period of six consecutive months or more, then the application review is discontinued and a new application is required to proceed and the development regulations in effect at the time permit processing is resumed shall apply to the new application.

	1	
Signature: 🙏	L Duns	Date:
Printed Name:		

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PROPERTY INFORMATION:

1747379686

ADDRESS: 3805 MITCHELL MILL RD. TOTAL SITE AREA: 10.462/455,731 ACRES/SF

ZONING INFORMATION: EXISTING ZONING:

RX-3-PL-CU

(RESIDENTIAL MIXED USE-3 STORIES-CONDITIONAL USE)

Z-82-2022 CUD CASE NUMBER:

DEVELOPMENT INFORMATION: FRONTAGE TYPE:

PARKING LIMITED

BUFFER TYPE: ZONE A PROTECTIVE YARD - TYPE 1 ZONE A PROTECTIVE YARD - TYPE 2

VACANT EXISTING USE: APARTMENT PROPOSED USE:

EXISTING BUILDING AREA:

290,688 SF TOTAL AREA: 290,688 SF

BUILDING DIMENSIONAL STANDARDS:

BUILDING HEIGHT: APARTMENT BUILDINGS

BLDG. TYPE II - 46' 0" BLDG. TYPE II - 46'0"

216

UNIT BREAKDOWN: 1-BR UNITS: 2-BR UNITS: 3-BR UNITS: TOTAL UNITS:

GROUND FLOOR HEIGHT MINIMUM: 3 STORY PR. BUILDING HEIGHT:

GROUND STORY TRANSPARENCY: 20% MINIMUM ACCESSORY STRUCTURE: 26' MAX PR. ACCESSORY STRUCTURE: N/A

PRIMARY STREET: MITCHELL MILL ROAD **BUILDING SETBACKS:** PRIMARY STREET- 5 SIDE STREET-SIDE LOT LINE- 0' OR 6'

PARKING DIMENSIONAL STANDARDS:

PARKING SETBACKS:

SIDE LOT LINE-REAR LOT LINE-

REAR LOT LINE- 0' OR 6'

IMPERVIOUS AREA CALCULATIONS:

EX. IMPERVIOUS AREA: 0.0/0 ACRES/SF 5.713/248,857 ACRES/SF PR. IMPERVIOUS AREA: SITE COVERAGE: 5.713/10.462 = 54.6%

FLOOD HAZARD AREA: NO, FEMA MAP PANEL #3720174700K REQUIRED AMENITY AREA: 8.973 AC * 10% = 0.897 (39,087 SF)

(10% OF SITE AREA) PROVIDED AMENITY AREA: .934 AC (40,703 SF)

PARKING CALCULATIONS:

MAX PARKING ALLOWED 1.5(1BR) + 2.25(2BR) + 3(3BR)1.5(84) + 2.25(108) + 3(24) = 441 SPACES MAX

TOTAL PROPOSED PARKING 306 SPACES

ACCESSIBLE PARKING:

REQUIRED ACCESSIBLE PARKING: 301 TO 400 = 8 TOTAL (2 VAN)TOTAL PROVIDED ACCESSIBLE PARKING: PROVIDED STANDARD ACCESSIBLE SPACES: 9 SPACES

BICYCLE CALCULATIONS:

PROVIDED VAN PARKING SPACES:

SHORT TERM BICYCLE PARKING 1 PER 20 UNITS 216 UNITS/20 = 10.8 = 11 SPACES

LONG TERM BICYCLE PARKING 1 PER 7 BR 372 BR /7 = 53.1 = 54 SPACES

11 SPACES

ZONING CONDITIONS (Z-82-22):


Z-82-22 - 3805 Mitchell Mill Road, located on its north side approximately 1,000 feet west of Forestville Road, being Wake County PIN 1747379686. Approximately 10.41 acres rezoned to Residential Mixed Use-3 Stories-Parking Limited-Conditional

CONDITIONS DATED: MARCH 10, 2023

- The following Principal Uses as listed in UDO Section 6.1.4. that are permitted, limited, or special uses in the RX-District shall be prohibited: (i) cemetery.
- There shall be no more than twenty—four (24) residential units within any singlebuilding that is located within five hundred (500) feet of the northern boundary of the property. There shall be no more than thirty—six (36) residential units within any single building that is located on all other portions of the property.
- between the Mitchell Mill Road right-ofway and the building facade located closest and most parallel to the Mitchell Mill Road right-of-way.
- For those buildings fronting along Caliber Woods Drive, there shall be no private,on—site vehicular parking areas located between the Caliber Woods Drive right—ofway and the building façade located closest and most parallel to the Caliber Woods Drive right-of-way. However, this condition shall not prohibit vehicular parking areas located closer to the Caliber Woods Drive right—of—way than the closest and most parallel building facade so long as the vehicular parking areas are located to the sides of each building's facade located closest and most parallel to the Caliber Woods Drive right-of-way.
- The property owner shall pay to the City a total of \$20,000.00 to be placed in the fund designated for the City's Affordable Housing Program. The \$20,000.00 amount may be payable in four annual installments of \$5,000.00, with the first payment being due prior to the issuance of the first certificate of occupancy and with each other annual installment due on or before the same day of the successive years, although the property owner has a right to prepay any amounts due. Prior to the issuance of any building permit, this payment obligation shall be evidenced by a promissory note to the City. If a sale of the project or the property (or a portion thereof), including a sale of controlling interests of an ownership entity within the project, occurs subsequent to the issuance of the first building permit and prior to the payment in full of the sum described within this condition, any outstanding amount shall be paid prior to the change of ownership

ADMINISTRATIVE SITE REVIEW MITCHELL MILL APARTMENTS

CITY OF RALEIGH, WAKE COUNTY, NORTH CAROLINA

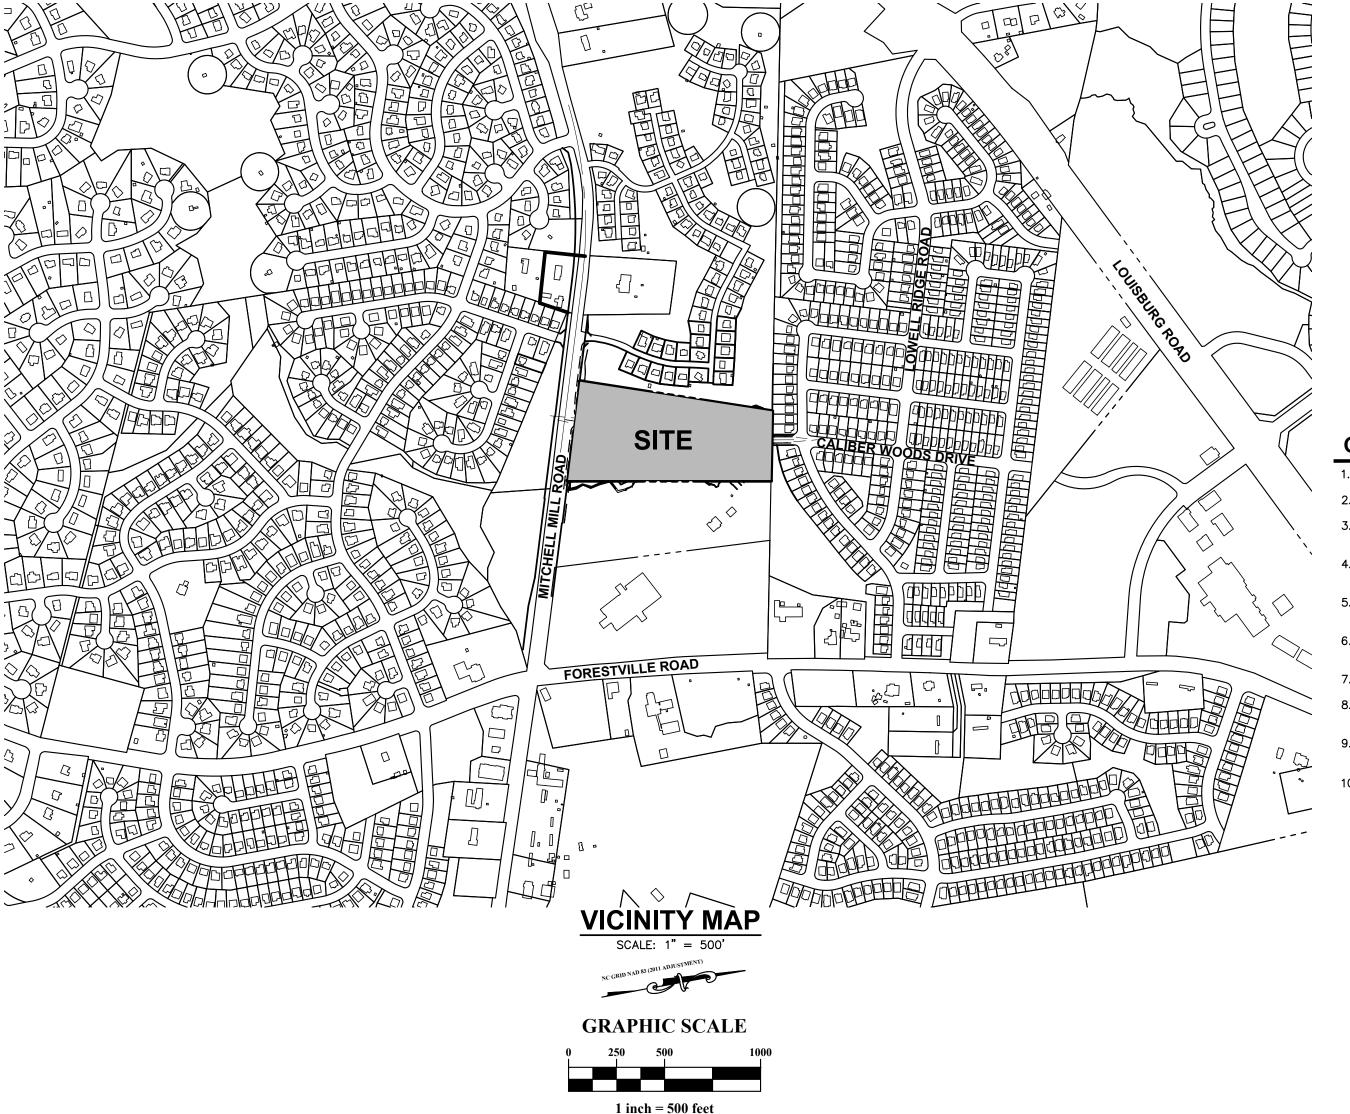

INDEX OF DRAWINGS

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SCM PLAN - UNDERGROUND DETENTION	_C.4.1
PRE-DEVELOPED STORMWATER PLAN	C.5.0
POST-DEVELOPED STORMWATER PLAN	_C.6.0
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FIRE DEPARTMENT ACCESS PLAN	_C.8.0
STANDARD DETAILS	_C.9.0-C.9.
SITE LIGHTING PLAN	-SL1.0
TREE CONSERVATION PLAN	-L1.20
LANDSCAPE PLAN	-L4.00
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EXTERIOR ELEVATIONS - BUILDING TYPE II	B2-EL
EXTERIOR ELEVATIONS - BUILDING TYPE III	-B3-EL
TRASH COMPACTOR PLANS	-TC-PLT

GENERAL NOTES


- 1. ALL CONSTRUCTION SHALL BE IN ACCORDANCE WITH ALL CITY OF RALEIGH AND/OR NCDOT STANDARDS AND SPECIFICATIONS. 2. CONTACT NC 811 FOR FIELD LOCATION OF UNDERGROUND UTILITIES.
- THE CONTRACTOR SHALL LOCATE ALL EXISTING UTILITIES TO VERIFY LOCATIONS, DEPTHS, AND ELEVATIONS PRIOR TO STARTING ANY CONSTRUCTION ACTIVITIES. ANY DIFFERENCES SHALL BE REPORTED TO THE OWNER, ENGINEER, AND ARCHITECT.
- NO INFRASTRUCTURE TO BE CONSTRUCTED PRIOR TO CONSTRUCTION PLAN APPROVAL AND UTILITY PERMIT ISSUANCE BY THE CITY
- LOCATIONS AND SIZES SHOWN FOR STORMWATER DEVICES ARE PRELIMINARY AND SUBJECT TO CHANGE PENDING FINAL LAYOUT AND
- LOCATIONS AND SIZES SHOWN FOR WATER AND SEWER DEVISES ARE PRELIMINARY AND SUBJECT TO CHANGE PENDING FINAL
- PROPOSED GRADES SHOWN ARE PRELIMINARY AND SUBJECT TO CHANGE PENDING FINAL LAYOUT AND FINAL DESIGN.
- THESE PLANS AND ALL CALCULATIONS HEREIN ARE PRELIMINARY AND SUBJECT TO CHANGE PENDING FINAL CONSTRUCTION PLAN
- HANDICAP ACCESS RAMPS WILL BE PROVIDED IN ACCORDANCE WITH CURRENT RALEIGH ENGINEERING STANDARD DRAWING STANDARD
- NO TEMPORARY OR PERMANENT ENCROACHMENTS (INCLUDING BUT NOT LIMITED TO CLEARING, GRADING, FENCING, AND THE INSTALLATION OF RETAINING WALLS OR OTHER STRUCTURES) ARE PERMITTED WITHIN THE GREENWAY EASEMENT AREA WITHOUT PRIOR APPROVAL BY THE CITY OF RALEIGH.

Existing Site Data Table		
Owner: Mitchell Mill, LLC		
Address:	3805 MITCHELL MILL RD	
PIN #:	1747-37-9686	
Tract Data:	D.B. 12985 Pg. 56	
Map Data:	B.M. 1981, Pg. 452 (Lot 6)	
Lot Area (square feet):	455,731	
Lot Area (acres):	10.462	

Proposed Site Data Table			
Acres Square Feet			
New Lot 1 Area:	3.625	157,910	
New Lot 2 Area:	5.348	232,941	
New R/W Area:	1.489	64,880	
Total Area:	10.462	455,731	



SITE ADMINISTRATIVE MILL FOR ITT CA

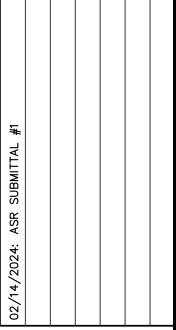

Date: 02/14/2024 **Scale:** 1" = 500'

Drawn By: Checked By **Project Number:** 18-0004-742

Drawing Number:

C.0.0 ASR-XXXX-2024

Use (RX3-PL-CU). For those buildings fronting along Mitchell Mill Road, there shall be no private, on—site vehicular parking areas located

OWNER MITCHELL MILL, LLC 3301 BENSON DRIVE, SUITE 304 RALEIGH, NORTH CAROLINA 27619

DEVELOPER DEWITT CAROLINAS, INC. 3301 BENSON DRIVE, SUITE 103 RALEIGH, NORTH CAROLINA 27609 PHONE: 919-863-1000 CONTACT: NEIL KING EMAIL: NEIL.KING@DEWITTCAROLINAS.CO

CIVIL ENGINEER ADVANCED CIVIL DESIGN, INC.

51 KILMAYNE DRIVE, SUITE 102 CARY, NORTH CAROLINA 27511 PHONE: 919-481-6290 CONTACT: JAKE BUZZELL BUZZELL@ADVANCEDCIVILDESIGN.COM

ADVANCED

CIVIL DESIGN

1 SIX FORKS ROAD, SUITE 100 RALEIGH, NORTH CAROLINA 27609 PHONE: 919-424-1946 CONTACT: TATE HOLT THOLT@PLANWORX.COM

ARCHITECT

PLANWORX ARCHITECTURE PA

JDAVIS 510 SOUTH WILMINGTON STREET RALEIGH, NORTH CAROLINA 27601 PHONE: 919-835-1500 CONTACT: SAWAKO BUSH SAWAKOB@JDAVISARCHITECTS.COM

LANDSCAPE

ARCHITECT

Administrative Site Review Application

Planning and Development Customer Service Center • One Exchange Plaza, Suite 400 | Raleigh, NC 27601 | 919-996-250



REVISION 1.23.23

raleighnc.gov

	Flamming and Development Customer Service Center	• One Exchange Flaza, Suite 400 Ra	leigh, NC 27601 919-996-25

This form is required when submitting site plans as referenced in Unified Development Ordinance (UDO) Section 10.2.8. Please check the appropriate building types and include the plan checklist document when submitting.

Site Plan Tier: Tier Two Site Plan	Tier Three	e Site Plan 🗸	
Building and Developm (Check all that app		Site Transaction History	
□ Detached □ General □ Attached □ Mixed use □ Townhouse □ Civic ☑ Apartment □ Cottage Court □ Tiny house □ Frequent Transit □ Open lot □ Development Option		Subdivision case #: Scoping/sketch plan case #: Certificate of Appropriateness #: Board of Adjustment #: Zoning Case #: Z-82-2022 Design Alternate #:	
	GENERAL IN	IFORMATION	
Development name: Mitchell Mill Apartments Inside City limits? Yes V No Property address(es): 3805 Mitchell Mill Road Site P.I.N.(s): 1747-37-9686 Please describe the scope of work. Include any additions, expansions, and uses (UDO 6.1.4). Proposed improvements consist of 8 apartment buildings, a pool/clubhouse, and the necessary parking and site infrastructure.			
Current Property Owner(s): Mitche	ell Mill LLC	I	
Company: Mitchell Mill LLC Address: 3301 Benson Dr, Suite 304 Raleigh			
Address 3301 Renson Dr. Suite			
	Fmail: neil k	ing@dewittcarolinas.com	
Phone #: 919-533-5341	l .	ing@dewittcarolinas.com	
Phone #: 919-533-5341 Applicant Name (If different from o	wner. See "who can		

Phone #: 919-460-2024	Email: jbuz	zell@advancedcivildesign.com	
NOTE: please attach purchase ag	reement or contract,	lease or easement when submitting this form.	
Developer Contact:			
Company:	Company: Title:		
Address:			
Phone #:	Email:	Email:	
Applicant Name:	·		
Company:	Address:		
Phone #:	Email:		

DEVELOPMENT TYPE + SITE DATE TABLE (Applicable to all developments)			
SITE DATA	BUILDING DATA		
Zoning district(s) (please provide the acreage of each): RX-3-PL-CU (10.462 Ac)	Existing gross floor area (not to be demolished): n/a		
Gross site acreage: 10.462	Existing gross floor area to be demolished: n/a		
# of parking spaces proposed: 260	New gross floor area: 290,688 sf		
Max # parking permitted (7.1.2.C):	Total sf gross (to remain and new): 290,688 sf		
Overlay District (if applicable):	Proposed # of buildings: 10		
Existing use (UDO 6.1.4): Vacant	Proposed # of stories for each: 3		
Proposed use (UDO 6.1.4): Apartment	Proposed # of basement levels (UDO 1.5.7.A.6) n/a		

STO	RMWATER	INFORMATION	
Imperious Area on Parcel(s):		Impervious Area for	r Compliance
		(includes ROW):	
Existing (sf) $\frac{0}{2}$ Proposed total (sf) $\frac{2}{2}$	48,857		
		Existing (sf) 0	Proposed total (sf) 248,857
DESIDENTIAL & O	VEDNICHT	LODGING DEVELO	PMENTS
INLOIDENTIAL & O	VEIXIVIGITI		
Total # of dwelling units: 216	VERNIGITI	Total # of hotel bed	rooms:
Total # of dwelling units: 216	3br <u>24</u>	Total # of hotel bed 4br or more	rooms:
Total # of dwelling units: 216			

Continue to Applicant Signature Block on Page Three.

Page 2 of 3 REVISION 1.23.23

APPLICANT SIGNATURE BLOCK

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Signature: July Juny	Date: 2/14/2024
Printed Name: Jake Buzzell	

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ADVANCED

CIVIL DESIGN

ENGINEERS

Suite 102

Cary, North Carolina 27511

ph 919.481.6290

fax 919.336.5127

VIEW INTS

| Issue Dates:
| O2/14/2024: ASR SUBMITTAL #1
| O2/14/2024: ASR SUBMITTAL RECOUNTY, NORTH CAROLIN
| O2/14/2024: ASR SUBMITTAL RECOUNTY, NORTH CAROLIN
| O2/14/2024: ASR SUBMITTAL RECOUNTY, NORTH CAROLIN
| O2/14/2024: ASR SUBMITTAL BROWN CAROLI

Checked By


Project Number:

18-0004-742

Drawing Number:

C.0.1

Page **1** of **3**

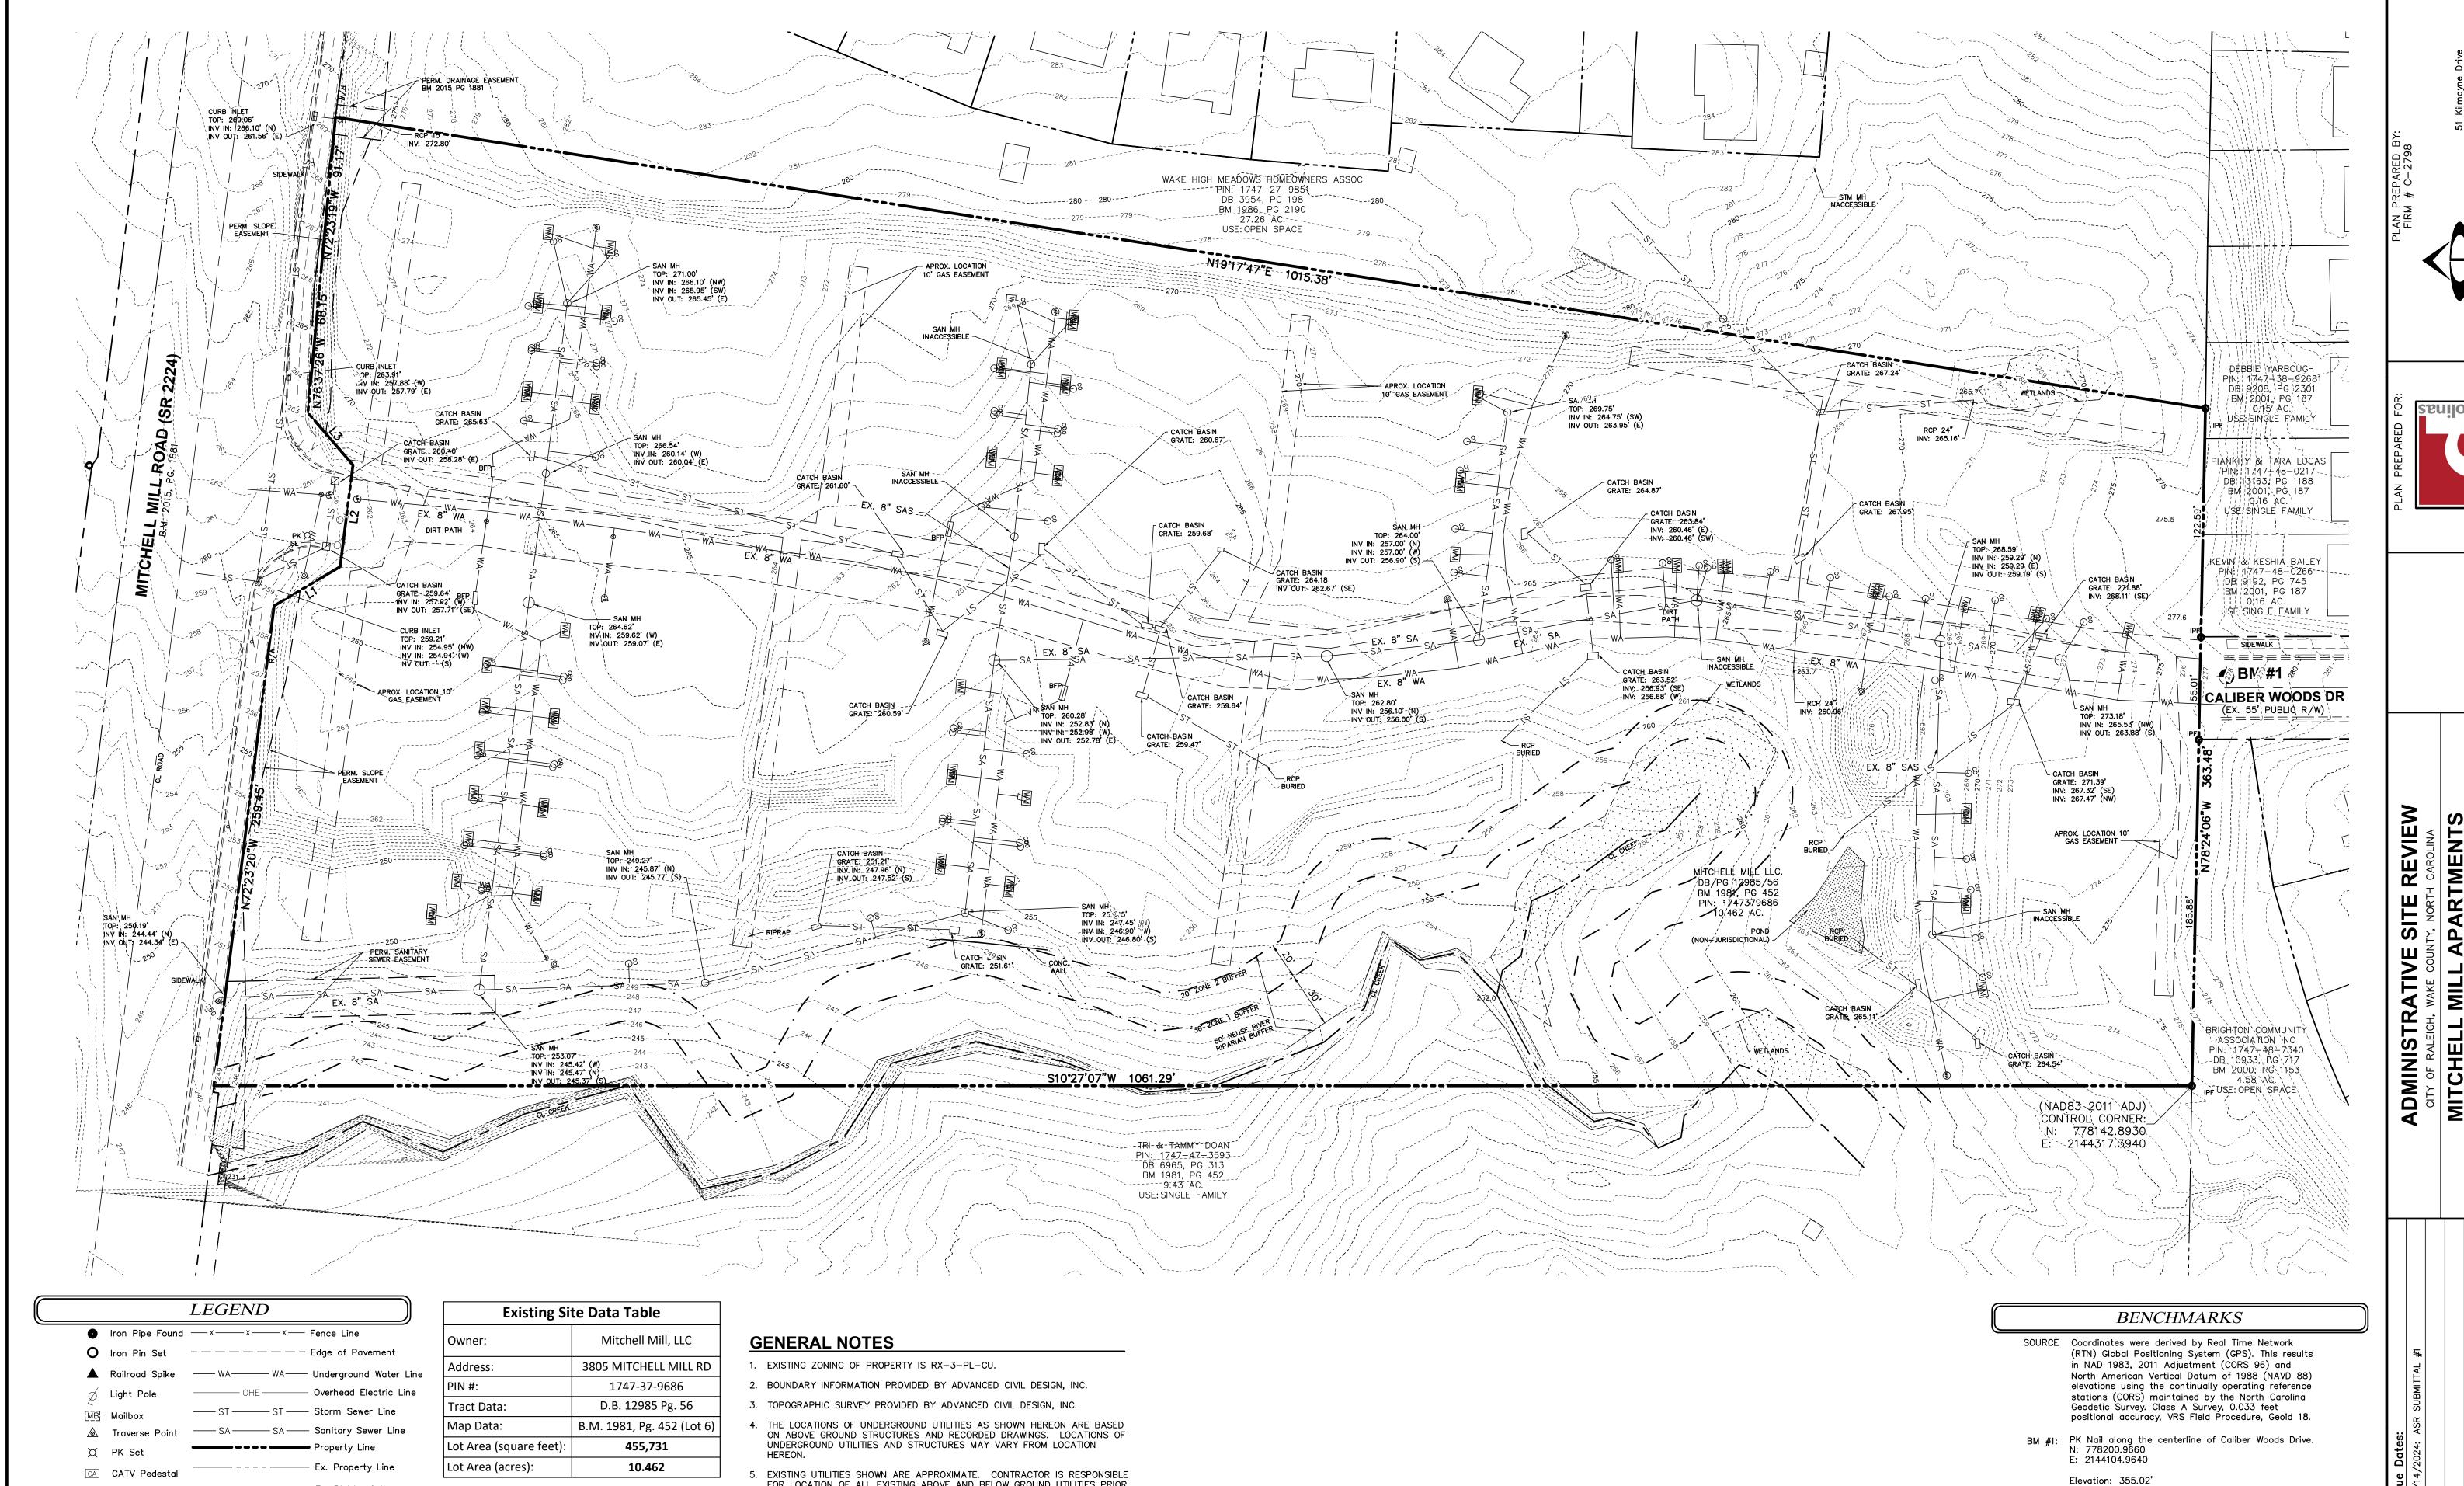

— — Ex. Right-of-Way — — Ex. Easement Line Pole Elec --- Ex. Major Contour(s) Pole Elec -- Ex. Minor Contour(s) □ Catch Basin ----- G ------ Underground Gas Curb Inlet -----FO ----- Underground Fiber Optic WM Water Meter —— E — Underground Electric OHE Overhead Electric M Air Release Manhole ⊕ Water Valve Sanitary Cleanout

Sanitary Manhole


Existing Site Data Table				
Owner:	Mitchell Mill, LLC			
Address:	3805 MITCHELL MILL RD			
PIN #:	1747-37-9686			
Tract Data:	D.B. 12985 Pg. 56			
Map Data:	B.M. 1981, Pg. 452 (Lot 6)			
Lot Area (square feet):	455,731			
Lot Area (acres):	10.462			

LINE TABLE					
LINE	DISTANCE	BEARING			
L1	41.17'	N20°10'59"W			
L2	55.00'	N72°23'19"W			
L3	37.03'	S59°39'01"W			
	L1 L2	LINE DISTANCE L1 41.17' L2 55.00'			

- FOR LOCATION OF ALL EXISTING ABOVE AND BELOW GROUND UTILITIES PRIOR TO ANY CONSTRUCTION.
- EXISTING VEGETATION AND NATURAL AREAS WILL BE PROTECTED TO THE GREATEST EXTENT POSSIBLE AND MINIMUM CLEARING OF LAND SHALL BE UNDERTAKEN DURING DEVELOPMENT.

FLOOD NOTE

BY GRAPHIC PLOTTING ONLY THIS PROPERTY IS NOT LOCATED IN SPECIAL FLOOD HAZARD ZONE BY THE FEDERAL EMERGENCY MANAGEMENT AGENCY ON FLOOD INSURANCE RATE MAP, COMMUNITY PANEL NO. 3720174700K WITH AN EFFECTIVE DATE OF JULY 19, 2022, IN WAKE COUNTY NORTH CAROLINA. NO FIELD SURVEYING WAS PERFORMED TO DETERMINE THIS ZONE.

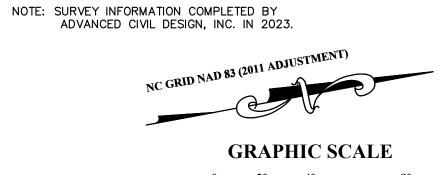


1 inch = 40 feet


Date: 02/14/2024 **Scale:** 1" = 40'


Drawn By: Checked By **Project Number:**


18-0004-742


Drawing Number:

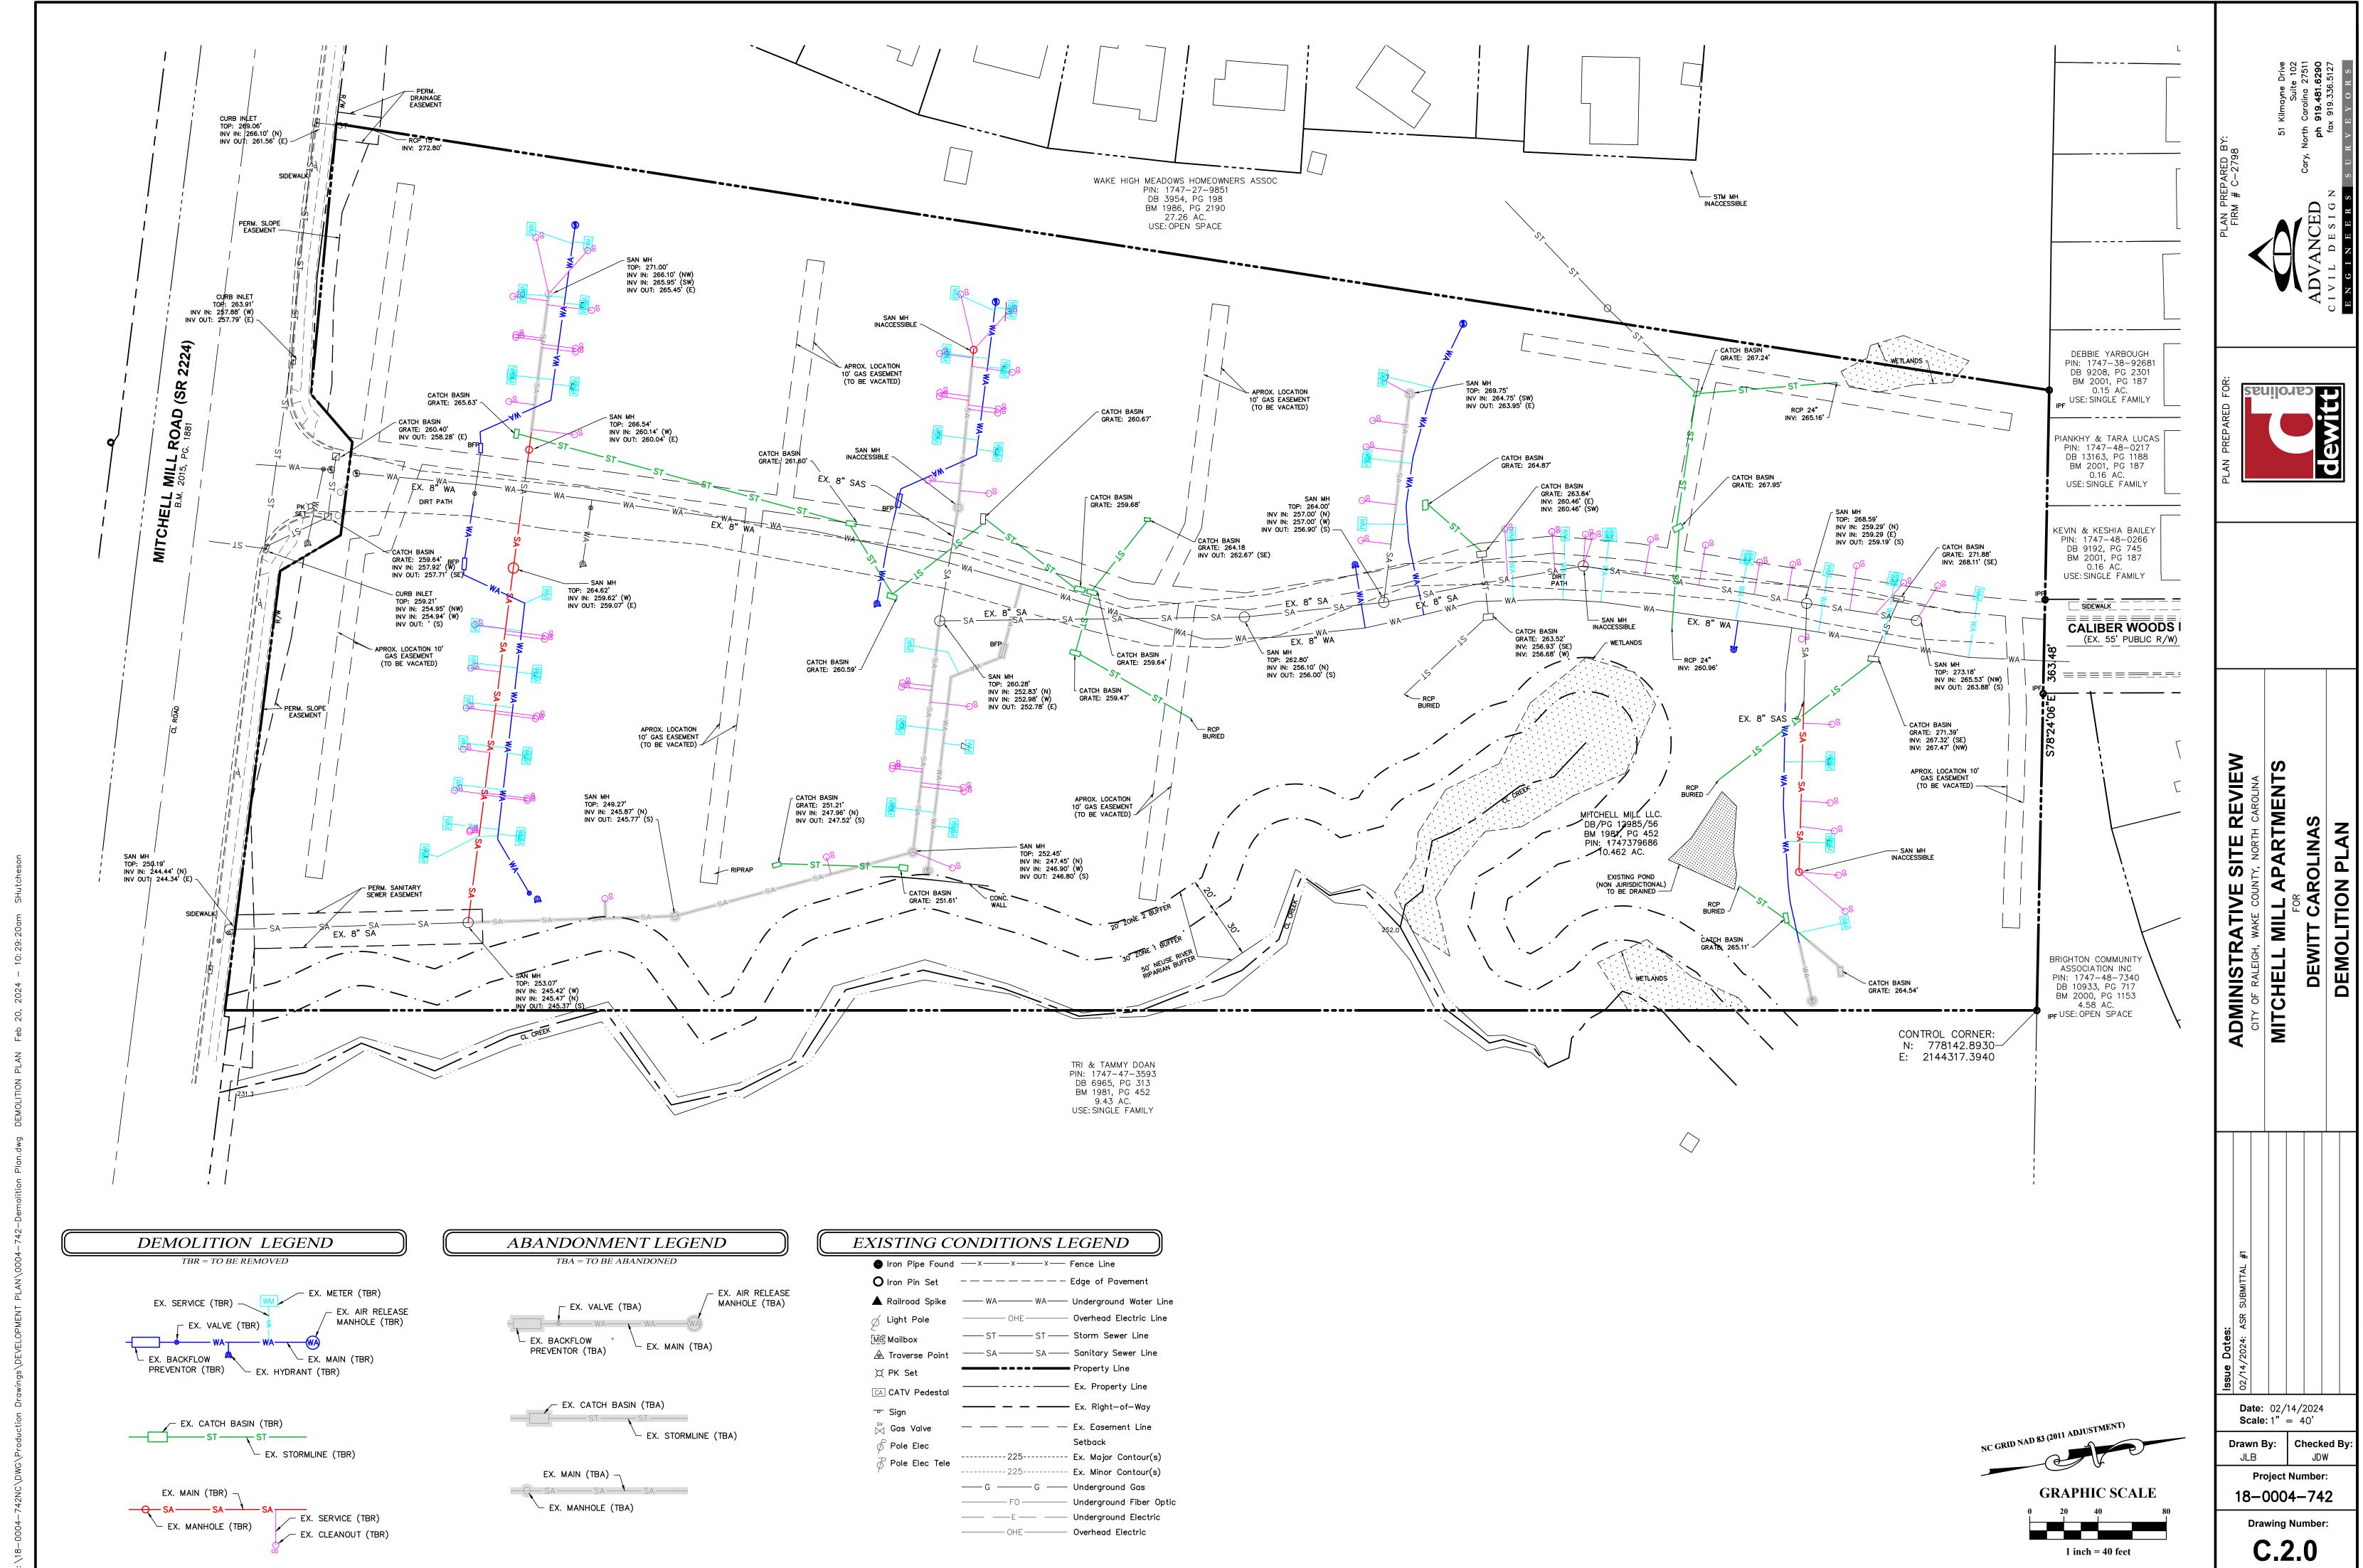

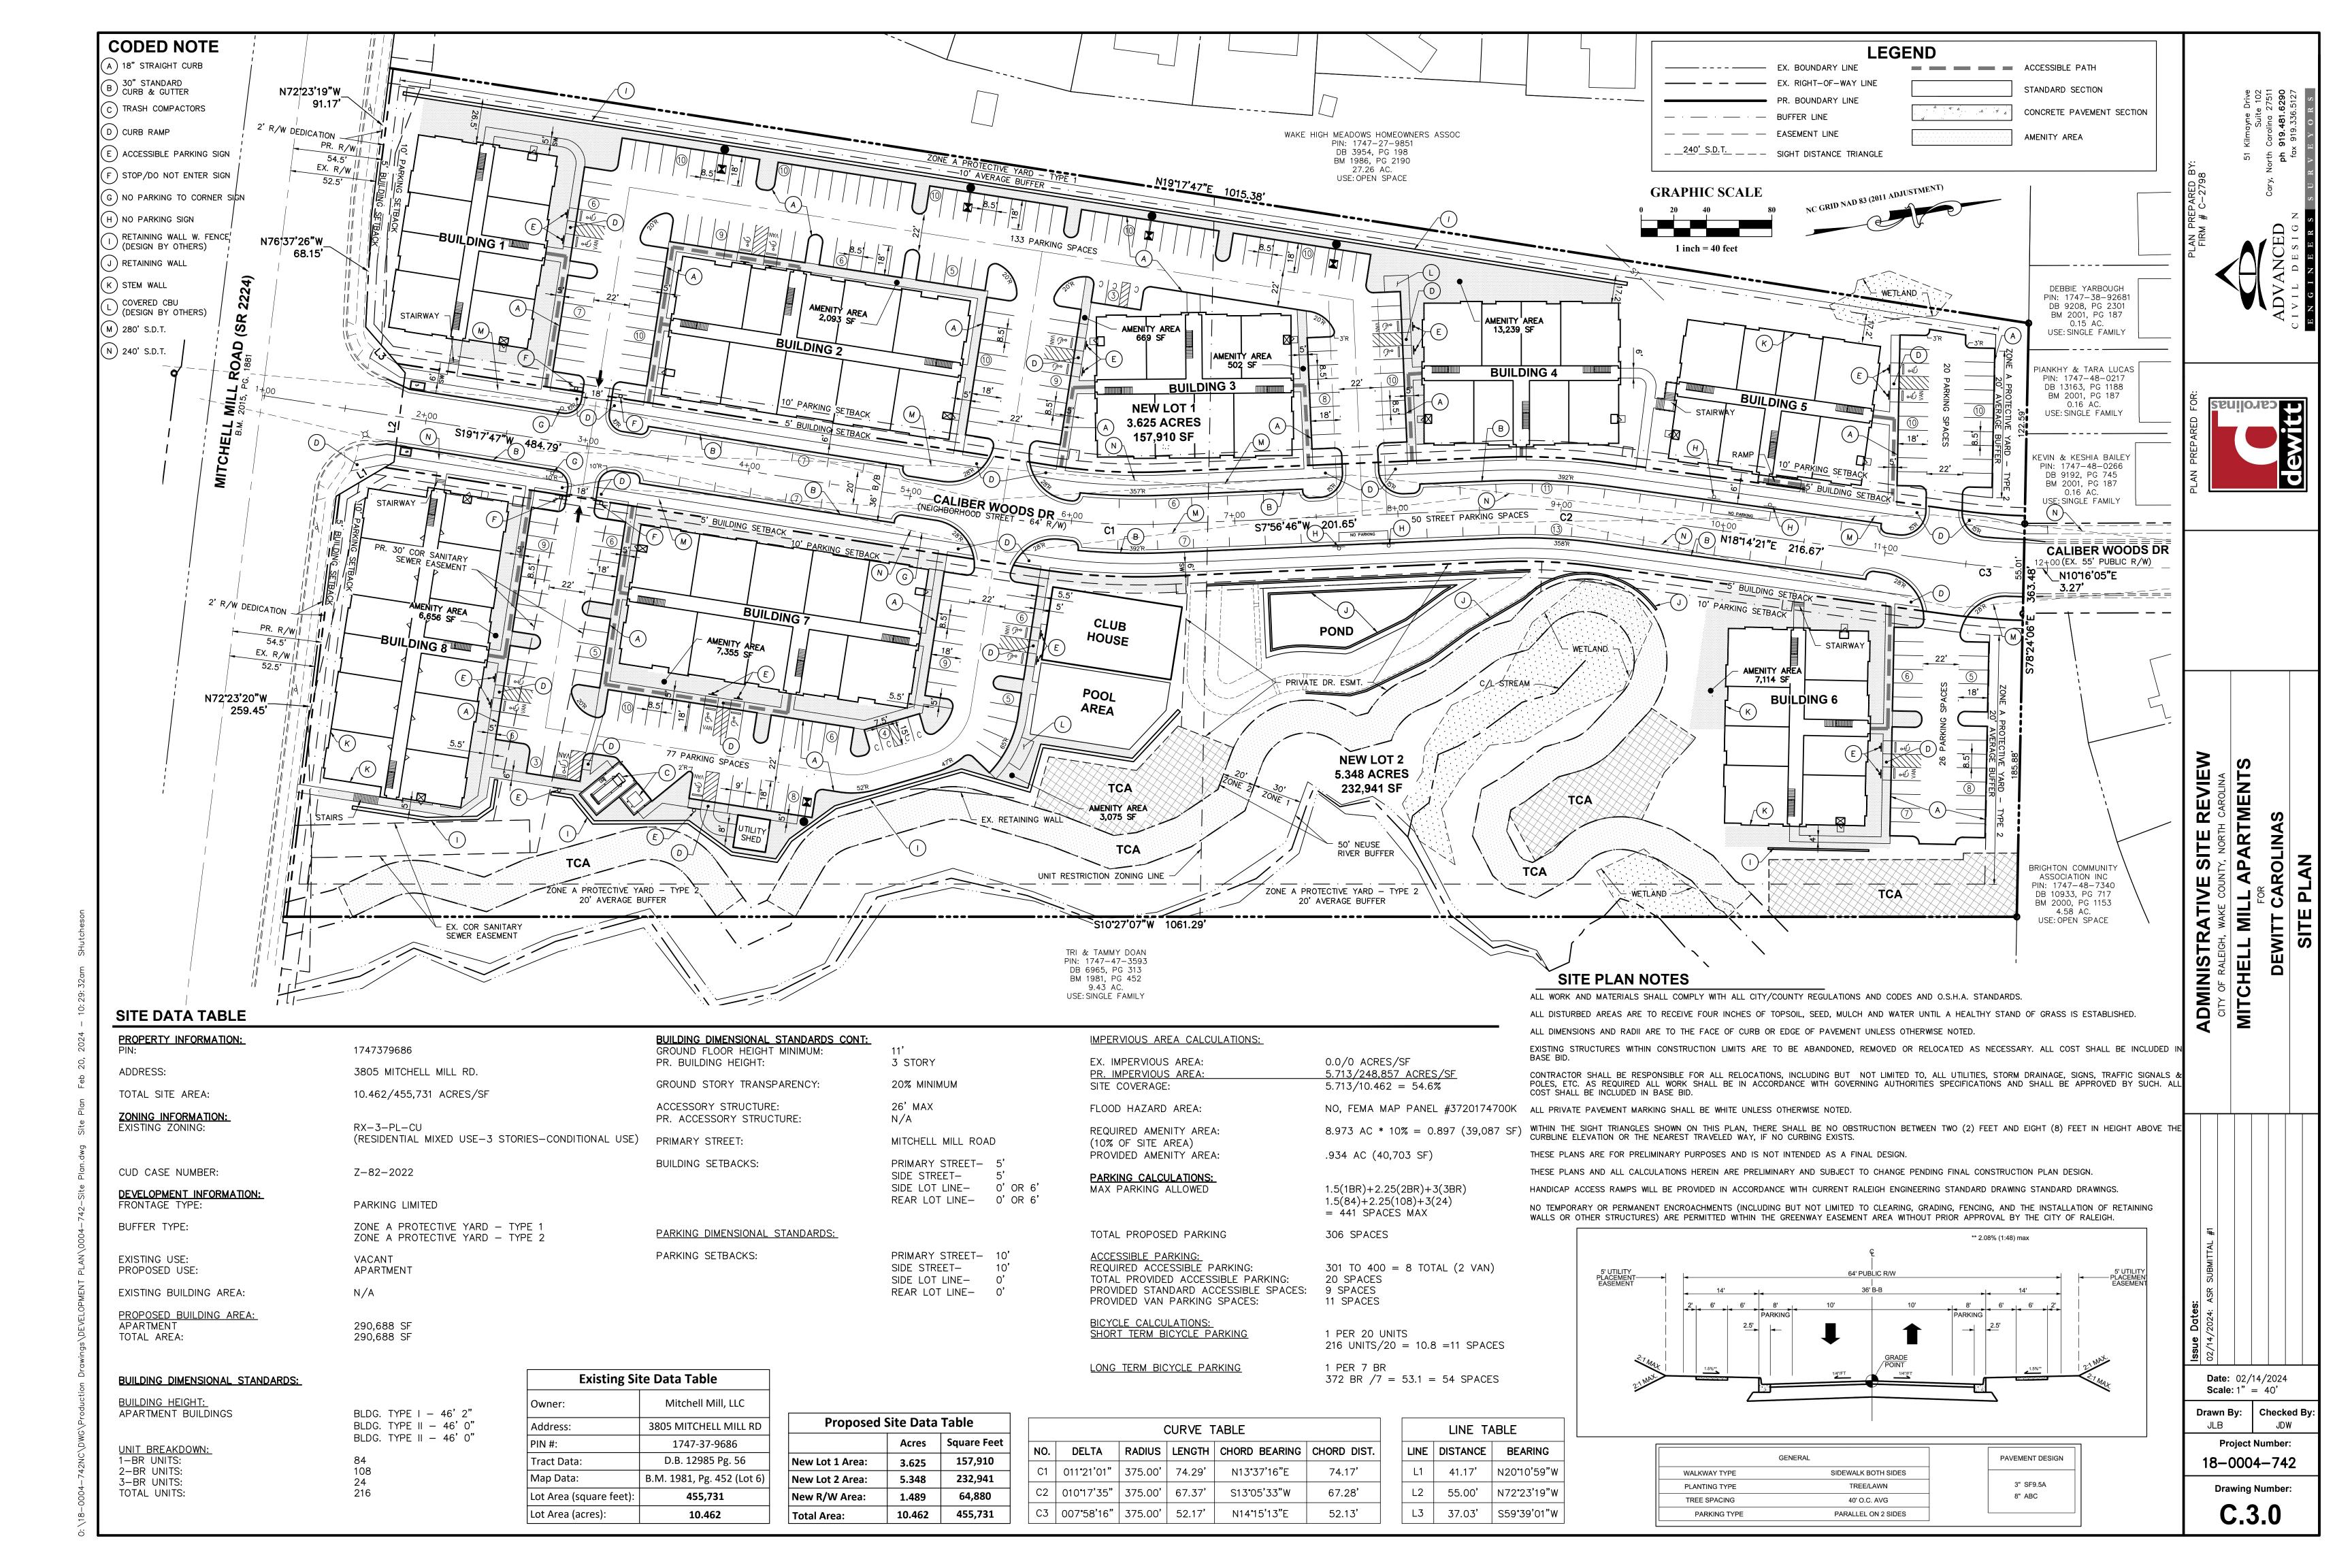

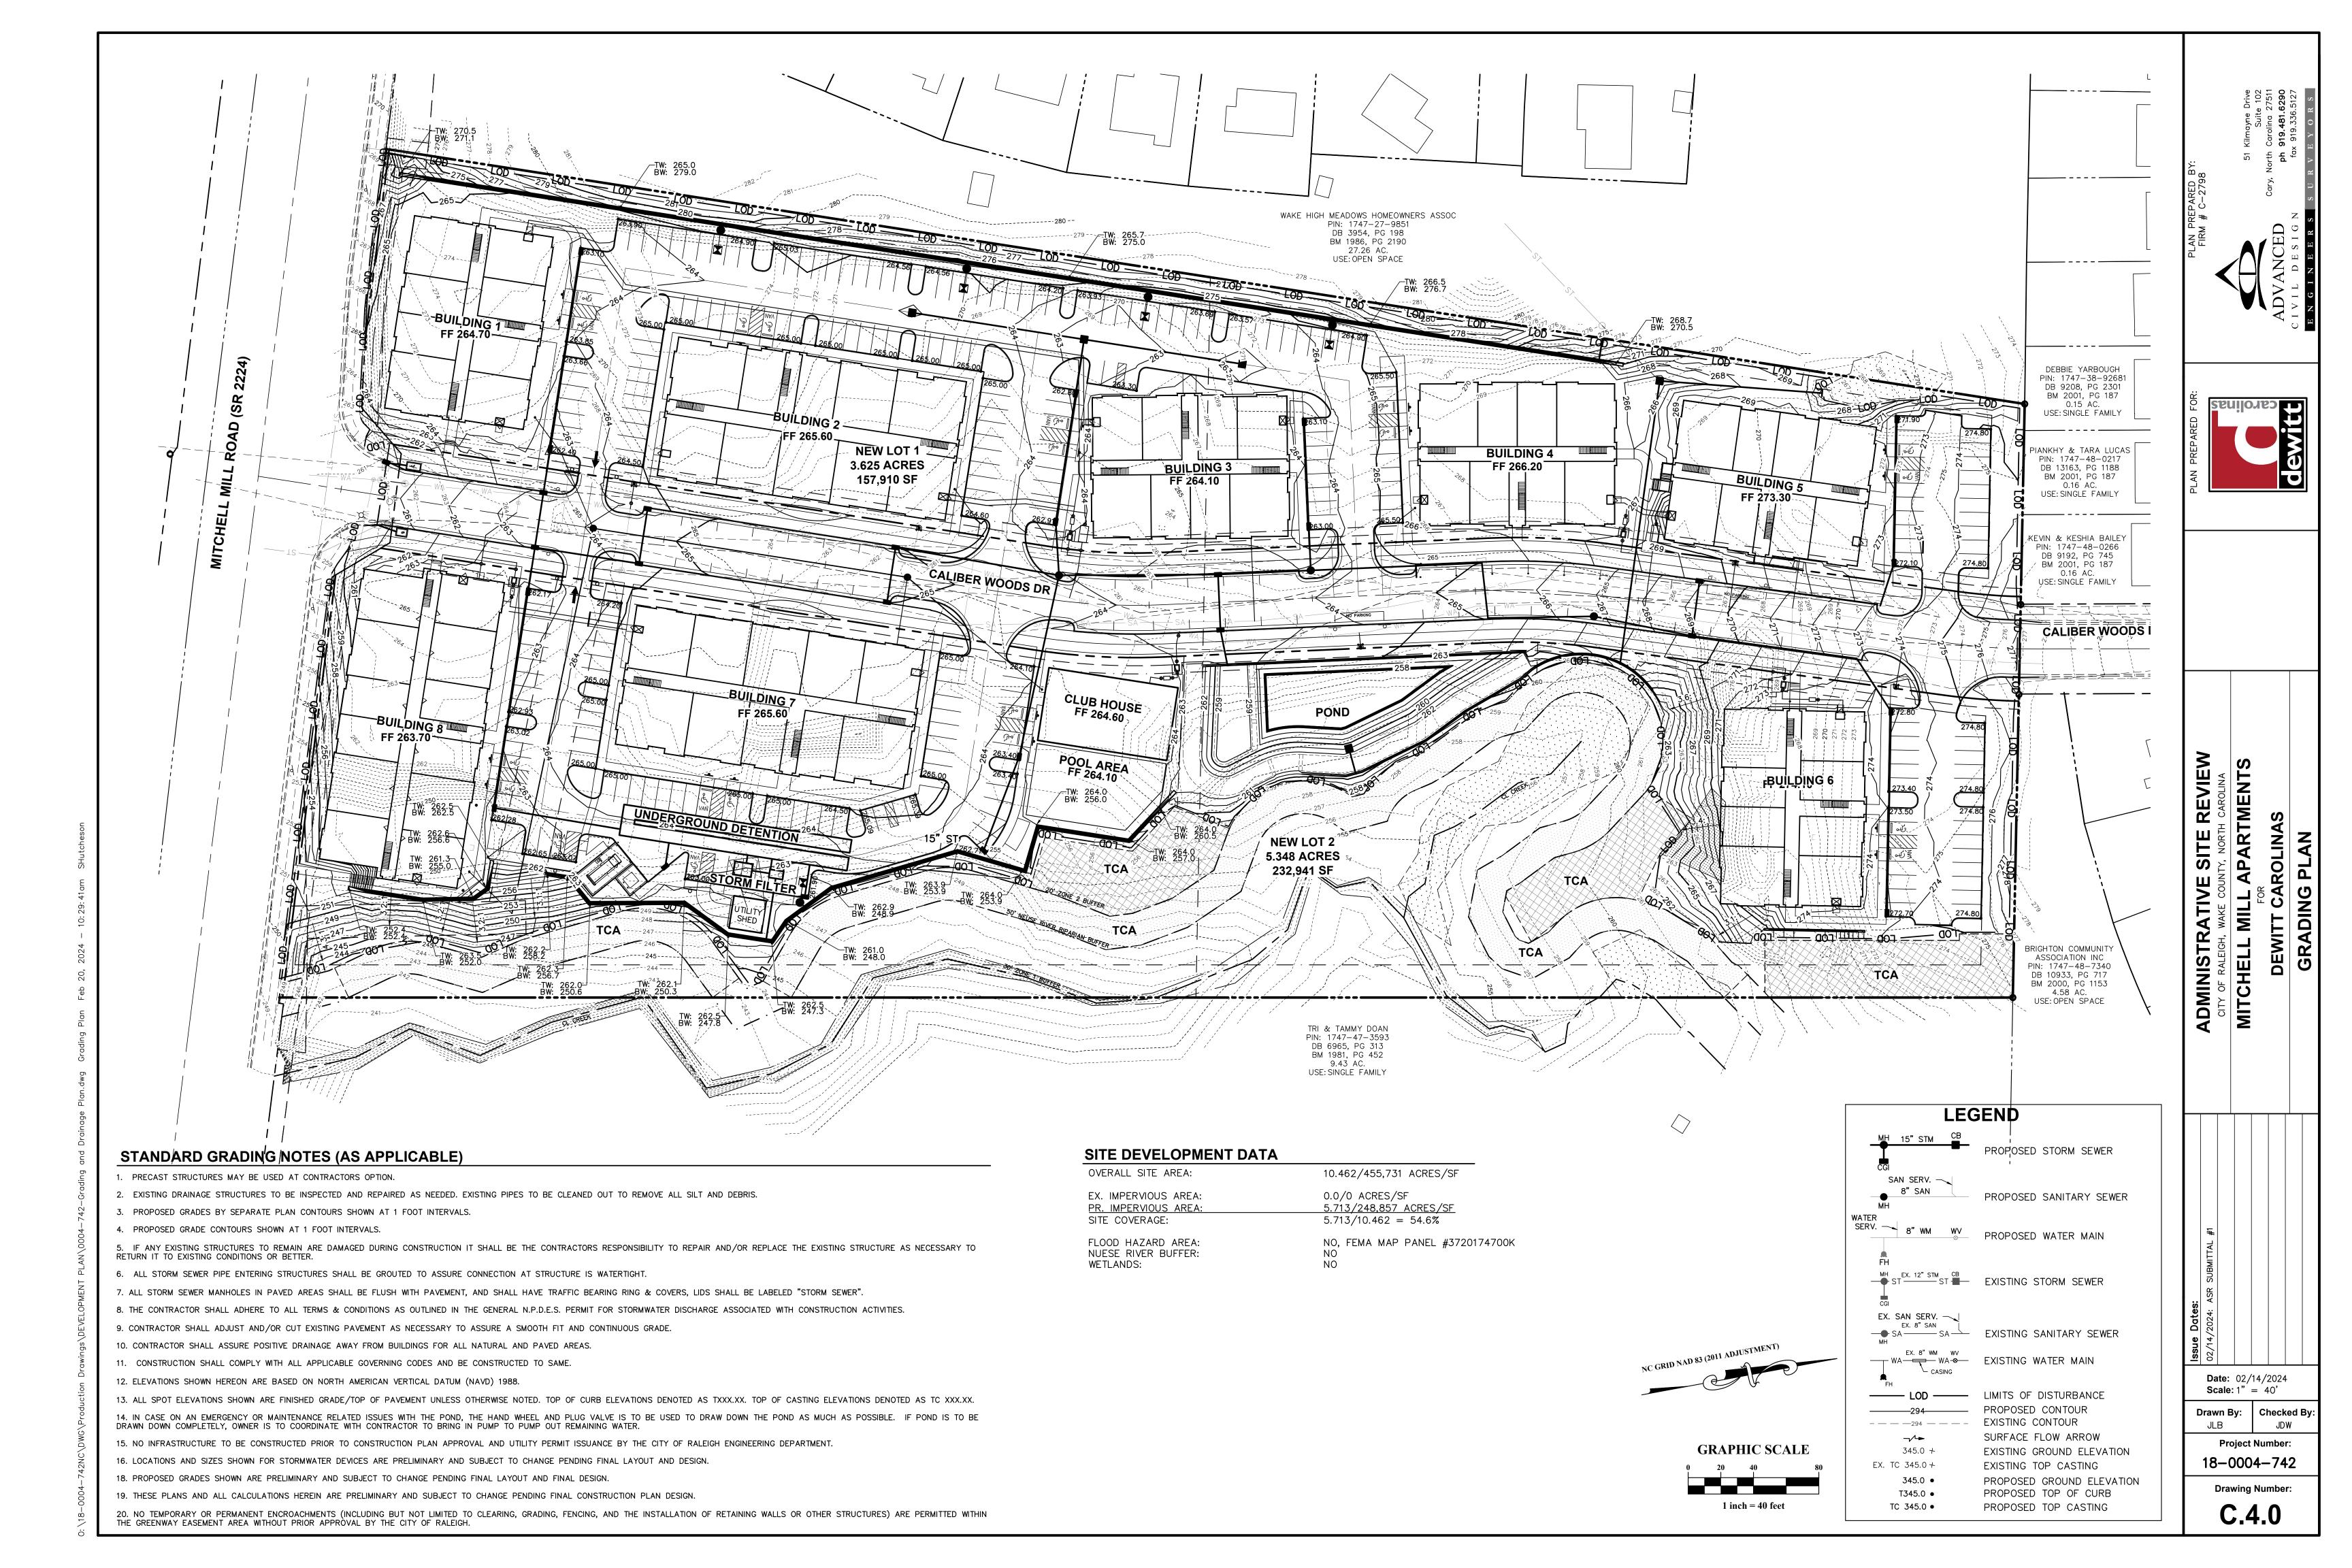

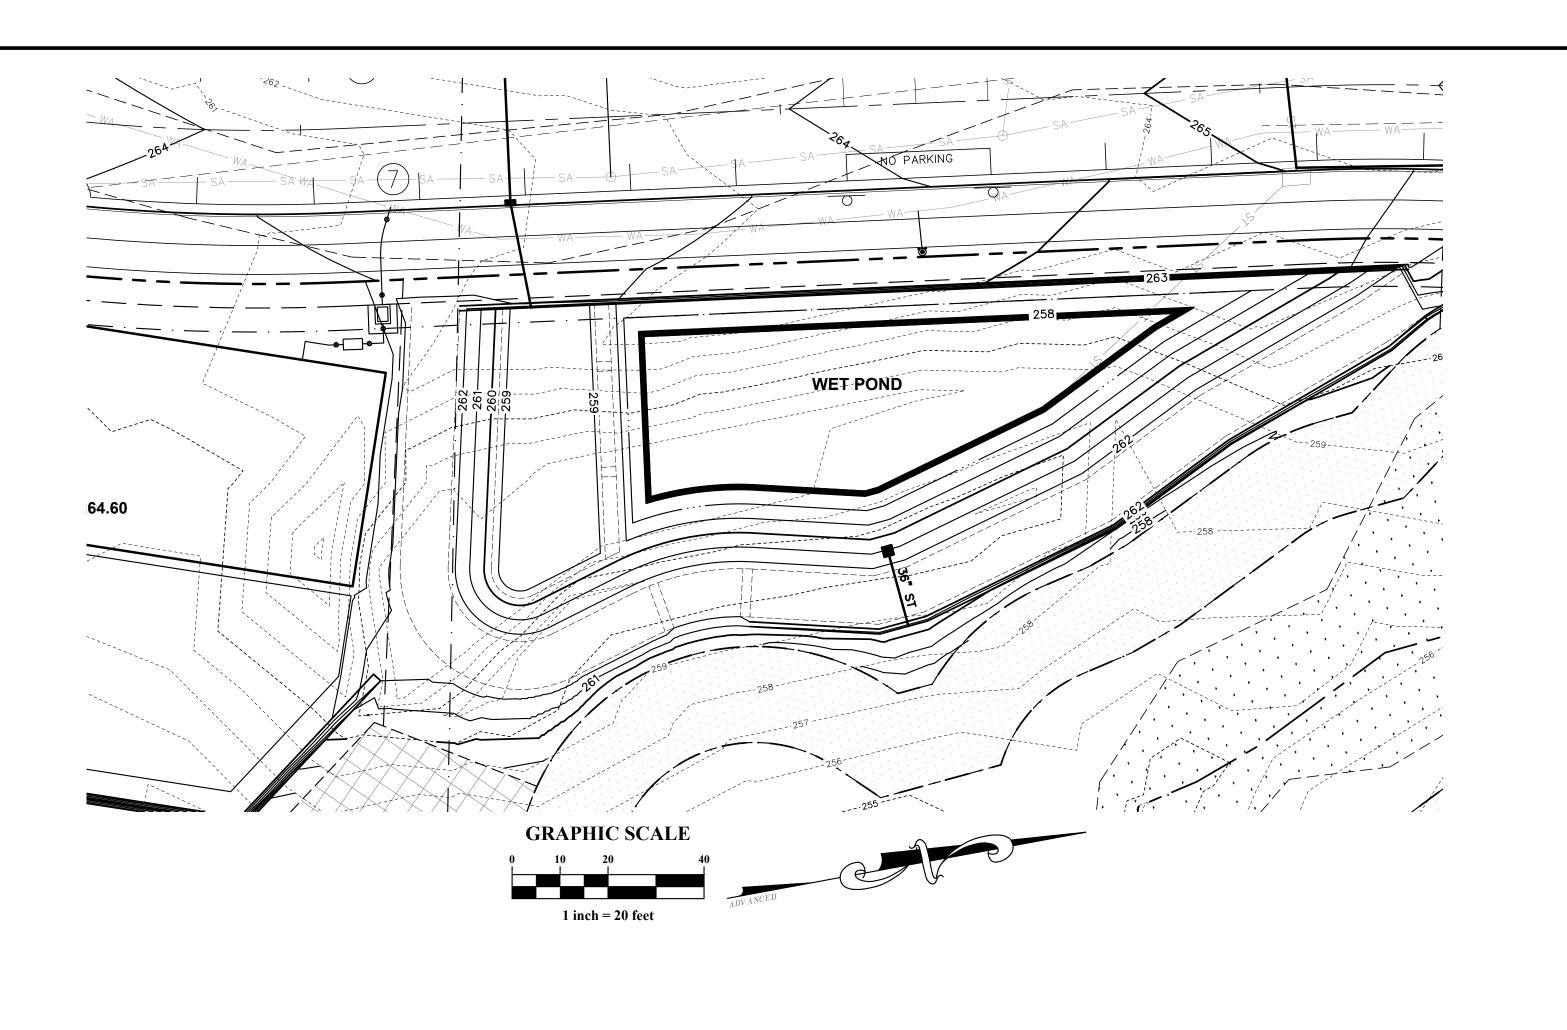

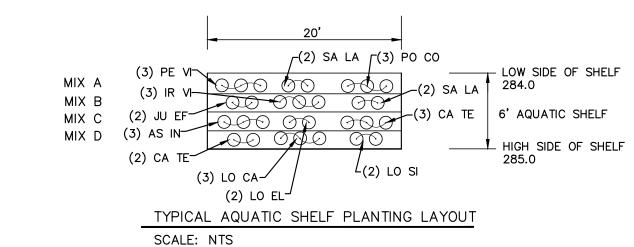

SIZE COND SPACING

REVIEW

SITE

ADMINISTRATIVE

Date: 02/14/2024

Project Number:

18-0004-742

Drawing Number:

C.5.0

Checked By

Scale: 1" = 20'

Drawn By:

CODE | QTY. | BOT. NAME / COMMON NAME

	MIX A	EMERGENT DEEP (6"-3" BELOW WAT	ER LEVEL)		
PE VI	84	Peltandra virginica	18"	plug	24" o.c.
		Arrow Arum			Field Locat
SA LA	56	Sagittaria latifolia	9"	plug	24" o.c.
		Broad—Leaf Arrowhead			Field Locat
PO CO	84	Pontederia cordata	9"	plug	24" o.c.
		Pickerel Weed			Field Locat
	MIX B	EMERGENT SHALLOW (3"-0" BELOW	WATER LEVE	:L)	
IR VI	84	Iris virginica	18"	plug	24" o.c.
		Blue Flag Iris			Field Locat
JU EF	56	Juncus effusus	9"	plug	24" o.c.
		Common Rush			Field Locat
SA LA	56	Sagittaria latifolia	9"	plug	24" o.c.
		Broad—Leaf Arrowhead			Field Locat
	MIX C	EDGE (0"-3" ABOVE WATER LEVEL)			
AS IN	84	Asclepias incarnata	24"	plug	24" o.c.
		Swamp Milkweed			Field Loca
CA TE	56	Carex Tenera	18"	plug	24" o.c.
		Quill Sedge			Field Loca
LO EL	56	Lobelia Elongata	18"	plug	24" o.c.
		Longleaf Lobelia			Field Loca
	MIX D	SATURATED (3"-6" ABOVE WATER LE	 EVEL)		
CA TE	56	Carex Tenera	18"	plug	24" o.c.
		Quill Sedge			Field Locate
LO CA	84	Lobelia cardinalis	18"	plug	24" o.c.
		Cardinal Flower			Field Locate
LO SI	56	Lobelia siphilitica	24"	plug	24" o.c.
		Great Blue Lobelia			Field Locate

GRASS AND HATCHING LEGEND


PROPOSED SOD AREAS

PROPOSED RCA AREA

AQUATIC SHELF

STEEP SLOPE STABILIZATION

1. SIZE INDICATED AT TIME OF PLANTING.

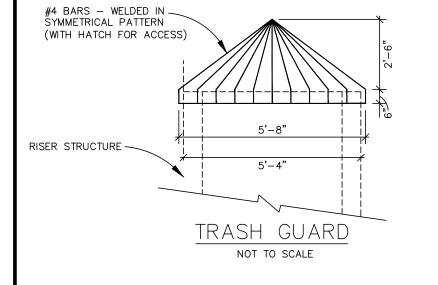

STORMWATER MANAGEMENT SUMMARY - OUTLET POINT						
RETURN EVENT (YR)	PRE-DEV. RELEASE RATE (CFS)	POST-DEV. RELEASE RATE (CFS)				
2	19.30	18.73				
10	41.93	36.53				
100	72 56	56.69				

WET DETENTION POND: BASIN SIZING, CALCULATIONS, AND REQUIREMENTS

REQUIRED SURFACE AREA FOR PERMANENT POOL

TOTAL DRAINAGE AREA TO BASIN: 5.104 AC IMPERVIOUS AREA DRAINING TO BASIN: 3.884 AC PERCENT OF IMPERVIOUS FOR DRAINAGE AREA: 76.1% PERMANENT POOL AVERAGE DEPTH: 6 FT. SURFACE AREA/DRAINAGE AREA RATIO (SA/DA): 1.56 REQUIRED SURFACE AREA: SA = (1.56/100)*(5.104 AC)*(43,560 SF/AC)= 3,468 SF

PROVIDED SURFACE AREA: SA = 4,208 SF

SURFACE AREA PROVIDED > SURFACE AREA REQUIRED

REQUIRED VOLUME TO CONTROL THE 1" STORM

RUNOFF COEFFICIENT (RV): STORM RUNOFF (IN) / STORM RAINFALL (IN) PERCENT IMPERVIOUS (I): DRAINAGE AREA (AC) / IMPERVIOUS PORTION OF DA (AC.)

RV = 0.05 + .009 * (I)= 0.05 + .009 * (76.1)= 0.735 IN/IN

4,208 SF > 3,468 SF


- REQ. VOL. FROM 1" OF RUNOFF= (DESIGN RAINFALL) * (RV) * (DRAINAGE AREA) = (1")*(0.735 IN/IN)*(5.104 AC)*(43,560 SF/AC)*(1FT/12IN) = 13,615 CF
- * VOLUME FROM 1-INCH PROVIDED BETWEEN ELEVATIONS 260.4 AND 260.5

PROVIDED VOLUME FROM 1" OF RUNOFF = 59,614 CF

VOLUME PROVIDED > VOLUME REQUIRED 13,928 CF > 13,615 CF


CITY OF RALEIGH SCM REQUIREMENTS

REQUIREMENT: THE POST-DEVELOPMENT PEAK RUNOFF RATE SHALL BE LIMITED TO THE PRE-DEVELOPMENT PEAK RUNOFF RATE FOR THE 1-YEAR, 24-HOUR AND THE 10-YEAR, 24-HOUR STORMS. SCMS SHALL STORE RUNOFF FROM A ONE-(1) INCH RAINFALL FROM THE SITE ABOVE THE PERMANENT POOL. THE DISCHARGE RATE FROM THE SCM SYSTEM FOLLOWING THE ONE- (1) INCH RAINFALL DESIGN STORM SHALL BE SUCH THAT THE RUNOFF DOES NOT DRAW DOWN TO THE PERMANENT POOL LEVEL IN LESS THAN TWO (2) DAYS AND THAT THE POND IS DRAWN DOWN TO THE PERMANENT POOL LEVEL WITHIN AT LEAST FIVE (5) DAYS.

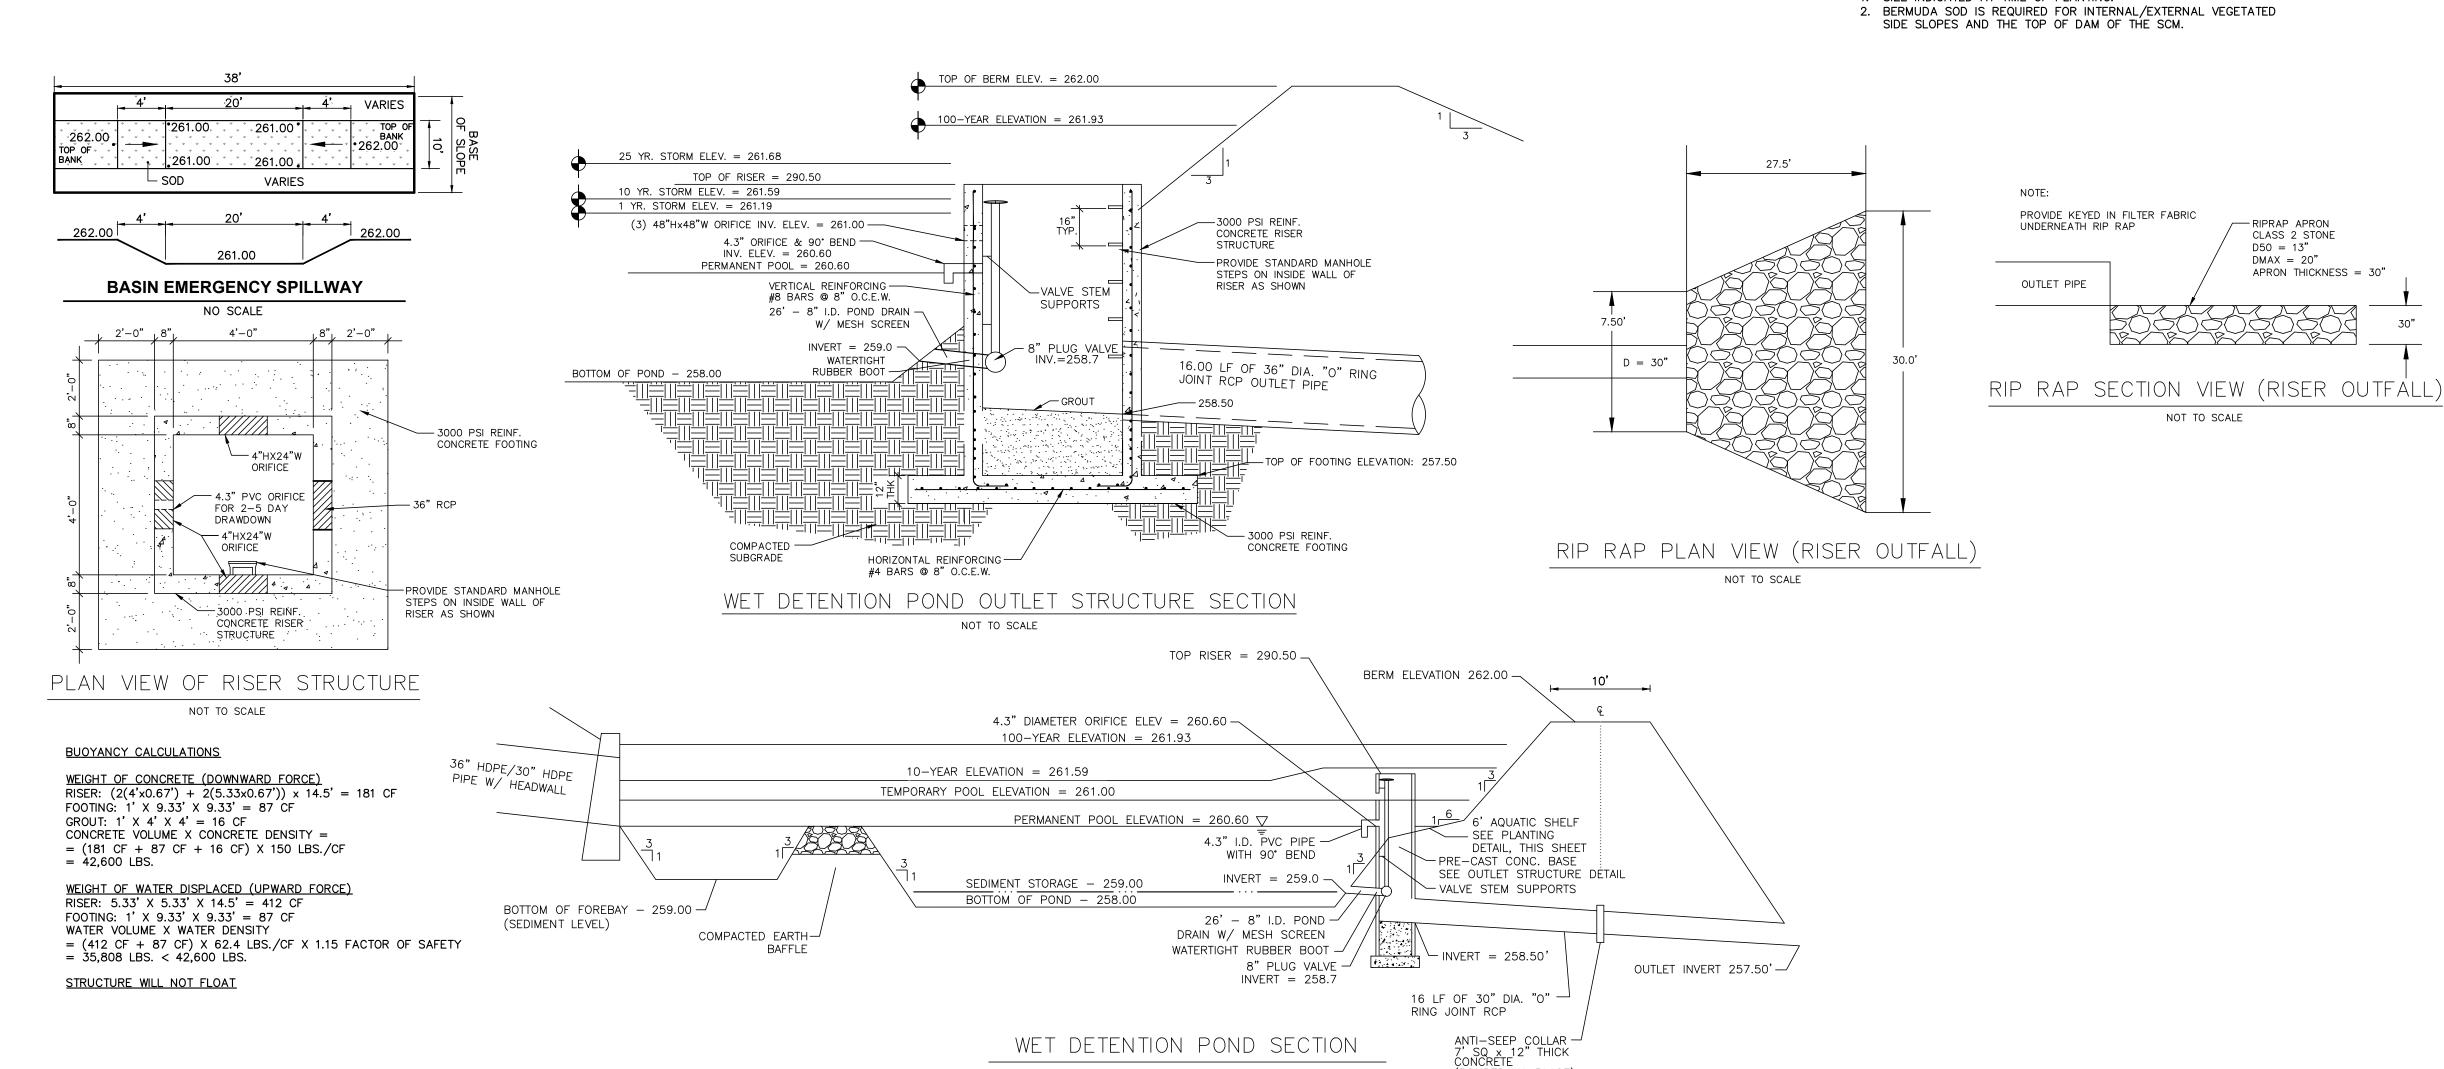

NOT TO SCALE

(POURED-IN-PLACE)

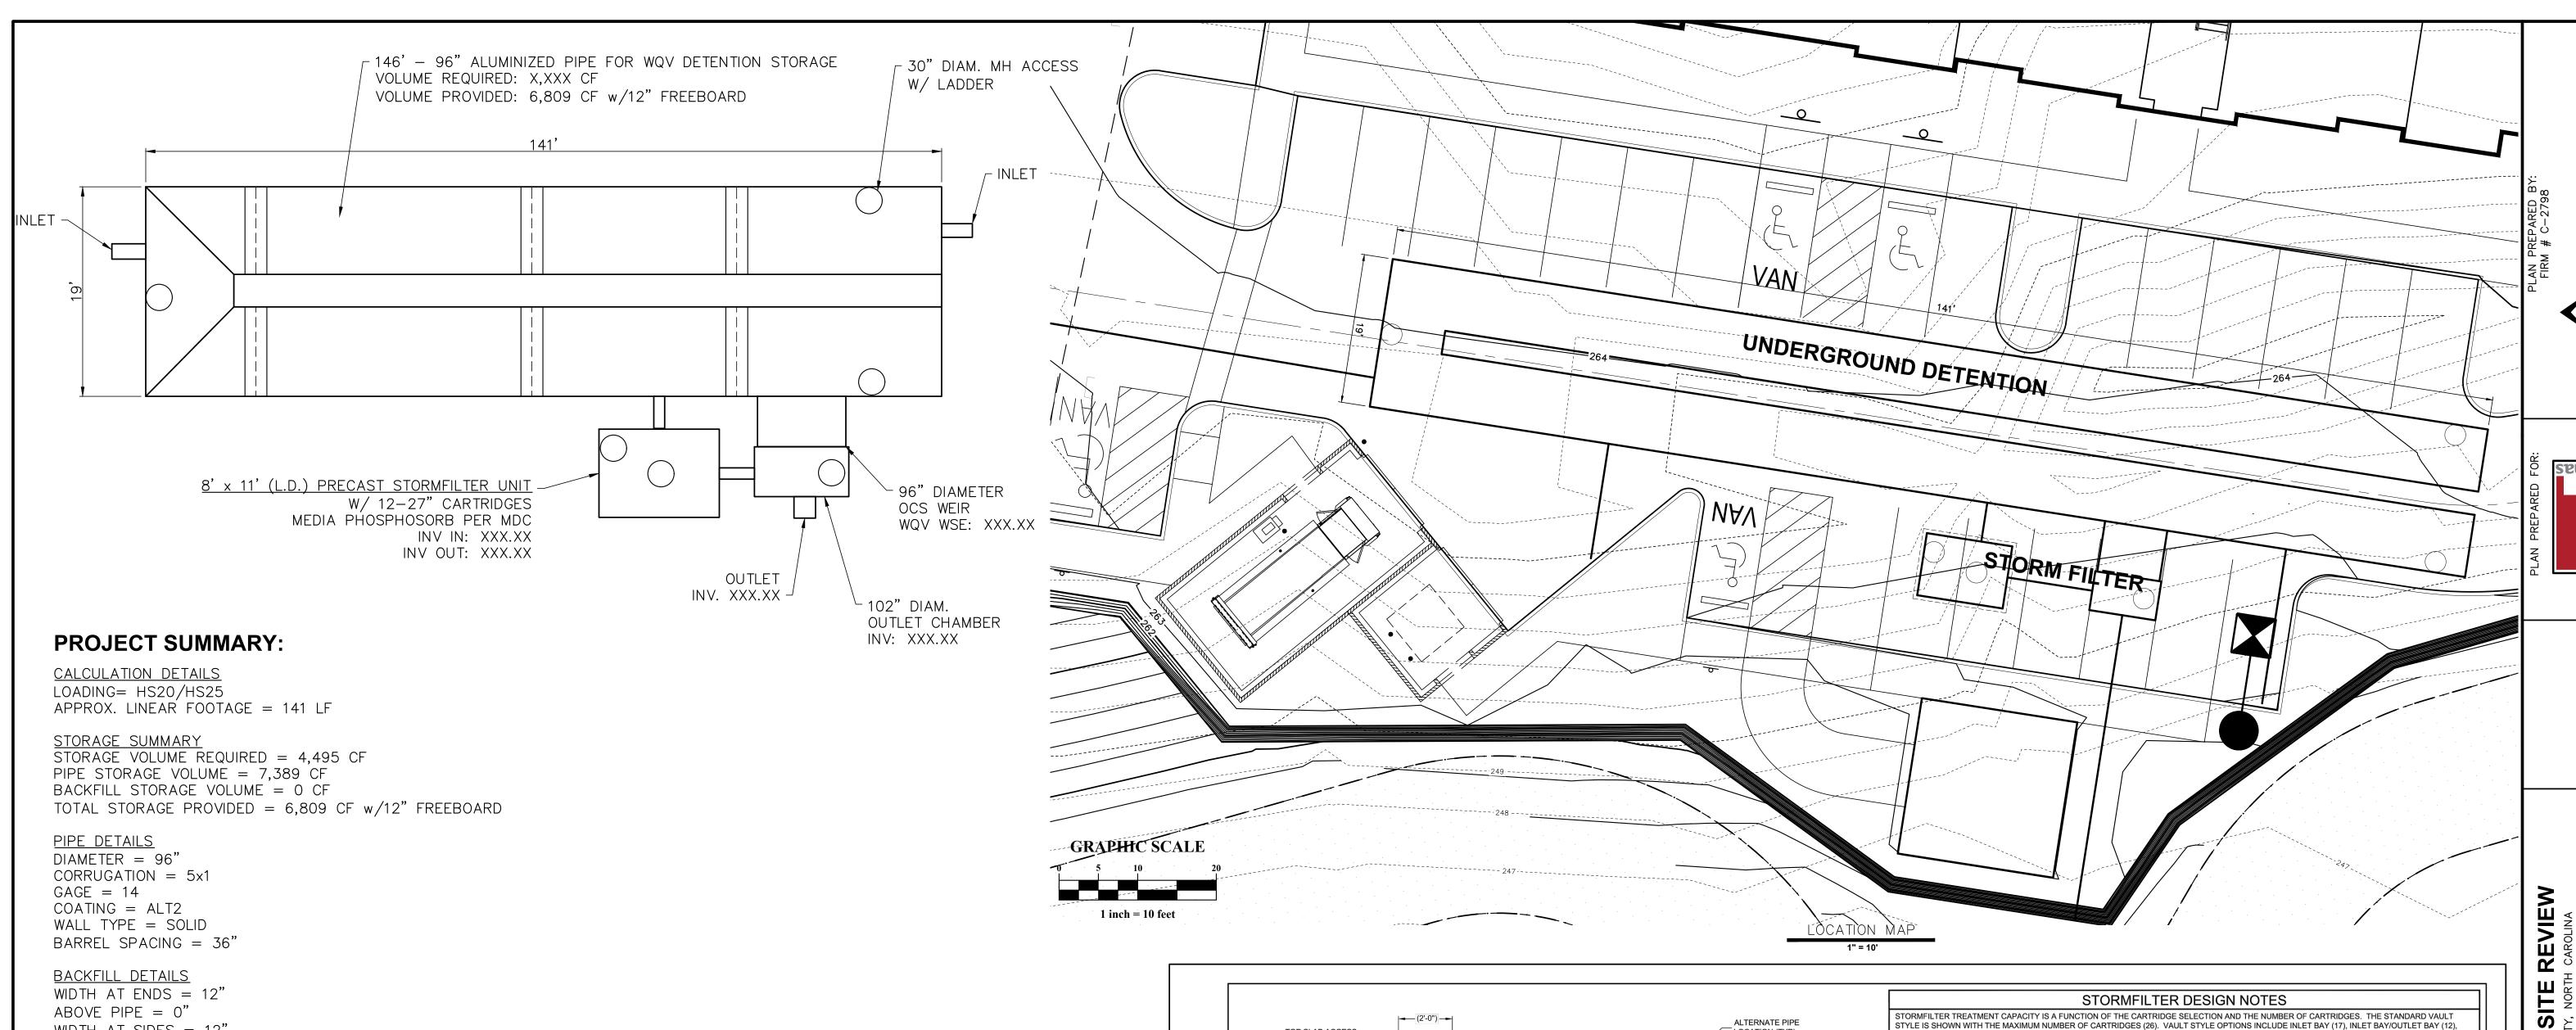

NOTES:

WIDTH AT SIDES = 12"

BELOW PIPE = 0"

1. ALL RISER AND STUB DIMENSIONS ARE TO CENTERLINE. ALL ELEVATIONS, DIMENSIONS, AND LOCATIONS OF RISERS AND INLETS, SHALL BE VERIFIED BY THE ENGINEER OF RECORD PRIOR TO RELEASING FOR FABRICATION.

2. ALL FITTINGS AND REINFORCEMENT COMPLY WITH ASTM A998.

3. ALL RISERS AND STUBS ARE $2-2/3" \times 1/2"$ CORRUGATION AND 16 GAGE UNLESS OTHERWISE NOTED.


4. RISERS TO BE FIELD TRIMMED TO GRADE.


5. QUANTITY OF PIPE SHOWN DOES NOT PROVIDE EXTRA PIPE FOR CONNECTING THE SYSTEM TO EXISTING PIPE OR DRAINAGE STRUCTURES. OUR SYSTEM AS DETAILED PROVIDES NOMINAL INLET AND/OR OUTLET PIPE STUB FOR CONNECTION TO EXISTING DRAINAGE FACILITIES. IF ADDITIONAL PIPE IS NEEDED IT IS THE RESPONSIBILITY OF THE CONTRACTOR.

6. BAND TYPE TO BE DETERMINED UPON FINAL DESIGN.

7. THE PROJECT SUMMARY IS REFLECTIVE OF THE DYODS DESIGN, QUANTITIES ARE APPROX. AND SHOULD BE VERIFIED UPON FINAL DESIGN AND APPROVAL. FOR EXAMPLE, TOTAL EXCAVATION DOES NOT CONSIDER ALL VARIABLES SUCH AS SHORING AND ONLY ACCOUNTS FOR MATERIAL WITHIN THE ESTIMATED EXCAVATION FOOTPRINT.

8. THESE DRAWINGS ARE FOR CONCEPTUAL PURPOSES AND DO NOT REFLECT ANY LOCAL PREFERENCES OR REGULATIONS. PLEASE CONTACT YOUR LOCAL CONTECH REP FOR MODIFICATIONS.

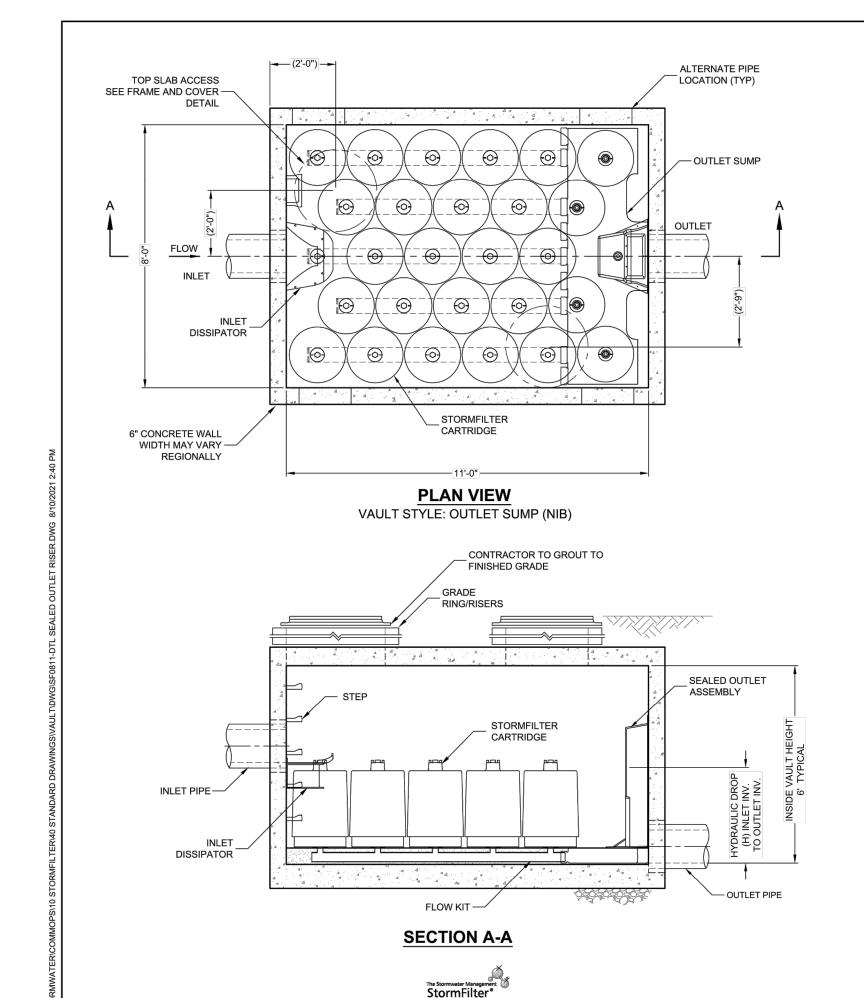

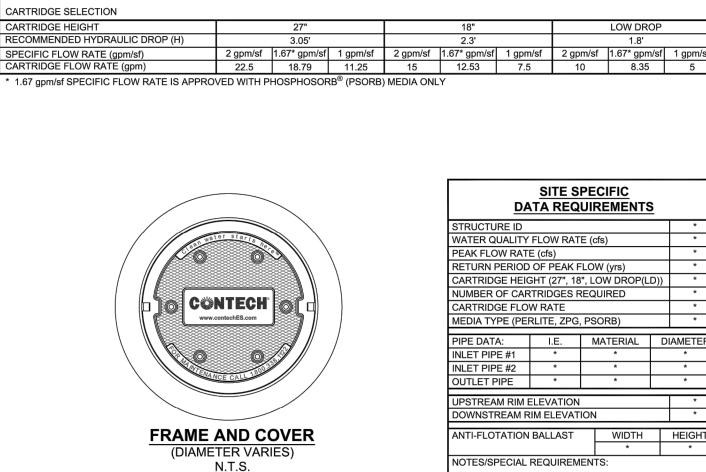

OUTLET BAY (21), FULL HEIGHT BAFFLE WALL (17). STORMFILTER 8X11 PEAK HYDRAULIC CAPACITY IS 1.8 CFS. IF THE SITE CONDITIONS EXCEED 1.8

GENERAL NOTES

1. CONTECH TO PROVIDE ALL MATERIALS UNLESS NOTED OTHERWISE. 2. DIMENSIONS MARKED WITH () ARE REFERENCE DIMENSIONS. ACTUAL DIMENSIONS MAY VARY. 3. FOR SITE SPECIFIC DRAWINGS WITH DETAILED VAULT DIMENSIONS AND WEIGHTS, PLEASE CONTACT YOUR CONTECH ENGINEERED SOLUTIONS LLC REPRESENTATIVE. www.ContechES.com

4. STORMFILTER WATER QUALITY STRUCTURE SHALL BE IN ACCORDANCE WITH ALL DESIGN DATA AND INFORMATION CONTAINED IN THIS 5. STRUCTURE SHALL MEET AASHTO HS20 LOAD RATING, ASSUMING EARTH COVER OF 0' - 5' AND GROUNDWATER ELEVATION AT, OR BELOW, THE OUTLET PIPE INVERT ELEVATION. ENGINEER OF RECORD TO CONFIRM ACTUAL GROUNDWATER ELEVATION. CASTINGS SHALL MEET AASHTO

M306 AND BE CAST WITH THE CONTECH LOGO. 6. FILTER CARTRIDGES SHALL BE MEDIA-FILLED, PASSIVE, SIPHON ACTUATED, RADIAL FLOW, AND SELF CLEANING. RADIAL MEDIA DEPTH SHALL BE 7-INCHES. FILTER MEDIA CONTACT TIME SHALL BE AT LEAST 38 SECONDS. 7. SPECIFIC FLOW RATE IS EQUAL TO THE FILTER TREATMENT CAPACITY (gpm) DIVIDED BY THE FILTER CONTACT SURFACE AREA (sq ft).

8. STORMFILTER STRUCTURE SHALL BE PRECAST CONFORMING TO ASTM C-857 AND AASHTO LOAD FACTOR DESIGN METHOD.

INSTALLATION NOTES

A. ANY SUB-BASE, BACKFILL DEPTH, AND/OR ANTI-FLOTATION PROVISIONS ARE SITE-SPECIFIC DESIGN CONSIDERATIONS AND SHALL BE SPECIFIED BY ENGINEER OF RECORD. B. CONTRACTOR TO PROVIDE EQUIPMENT WITH SUFFICIENT LIFTING AND REACH CAPACITY TO LIFT AND SET THE STORMFILTER VAULT (LIFTING

CLUTCHES PROVIDED). C. CONTRACTOR TO INSTALL JOINT SEALANT BETWEEN ALL VAULT SECTIONS AND ASSEMBLE VAULT. D. CONTRACTOR TO PROVIDE, INSTALL, AND GROUT PIPES. MATCH OUTLET PIPE INVERT WITH OUTLET BAY FLOOR. E. CONTRACTOR TO TAKE APPROPRIATE MEASURES TO PROTECT CARTRIDGES FROM CONSTRUCTION-RELATED EROSION RUNOFF.

CNTECH ENGINEERED SOLUTIONS LLC

CFS AN UPSTREAM BYPASS STRUCTURE IS RÈQUIRED.

SF0811 STORMFILTER STANDARD DETAIL

* PER ENGINEER OF RECORD

SITE **ADMINISTR**

Date: 02/14/2024

Scale: AS NOTED

Project Number:


18-0004-742


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Checked By

Drawn By:

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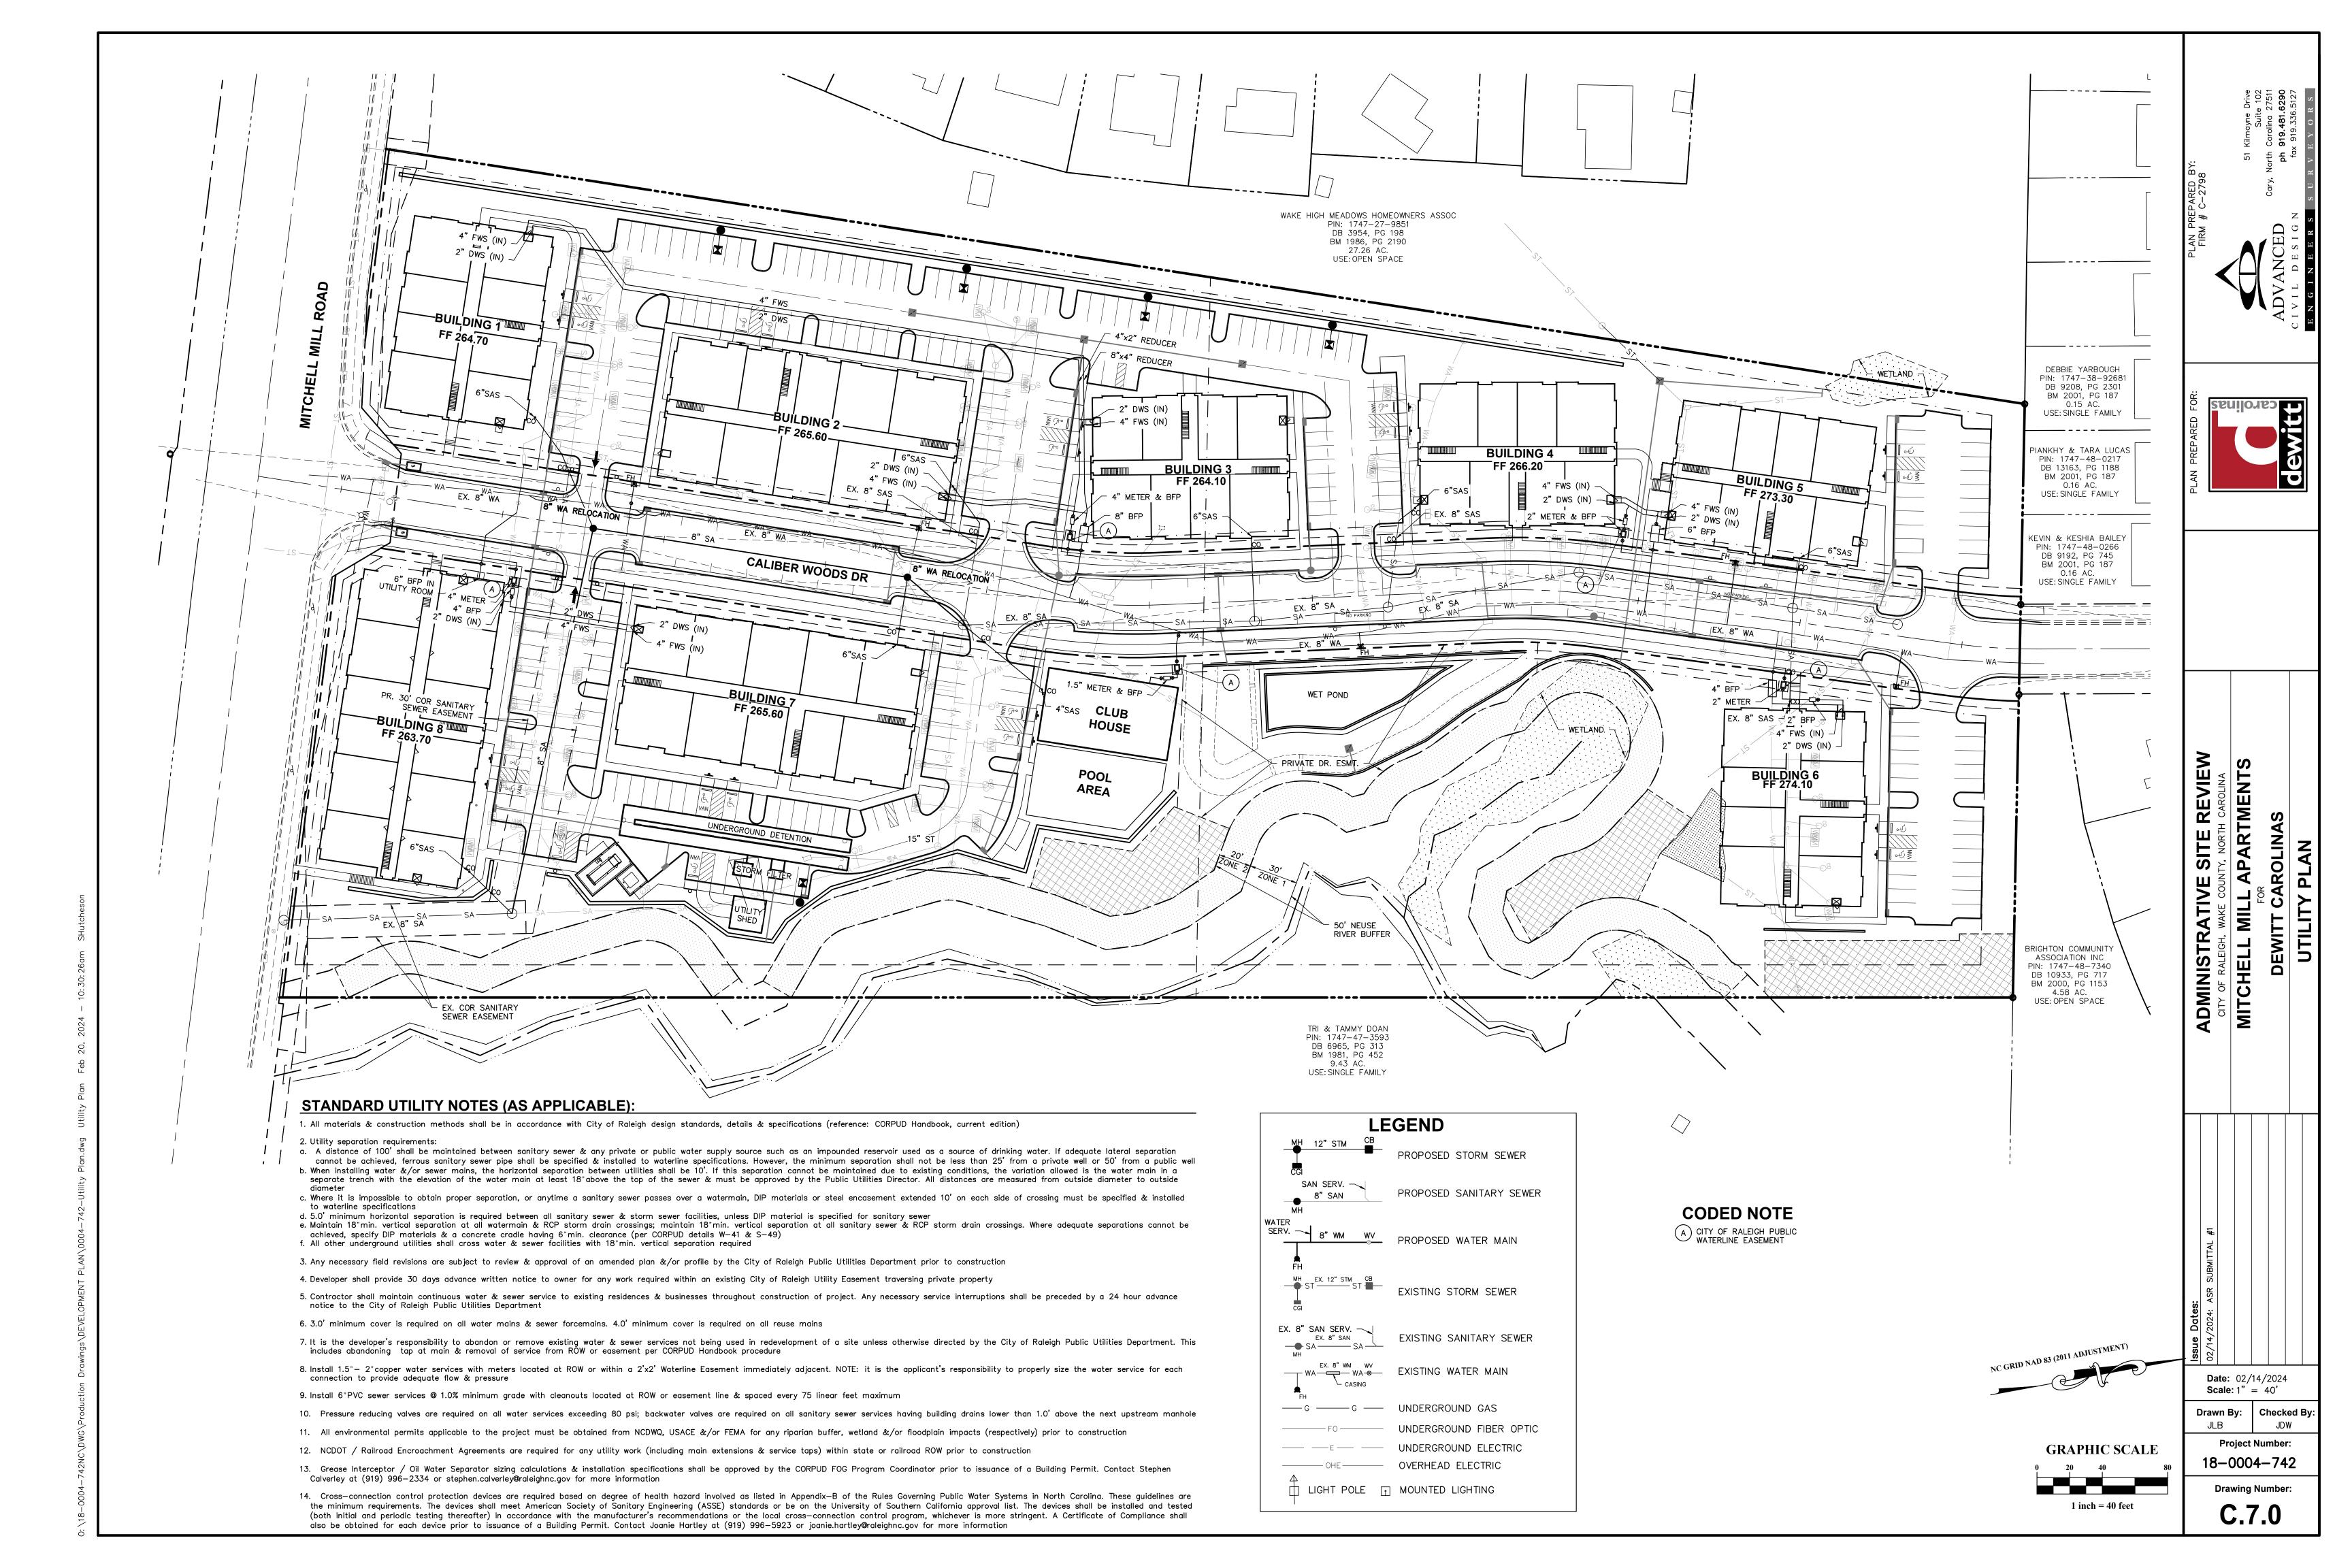



20. NO TEMPORARY OR PERMANENT ENCROACHMENTS (INCLUDING BUT NOT LIMITED TO CLEARING, GRADING, FENCING, AND THE INSTALLATION OF RETAINING WALLS OR OTHER STRUCTURES) ARE PERMITTED WITHIN THE GREENWAY EASEMENT AREA WITHOUT PRIOR

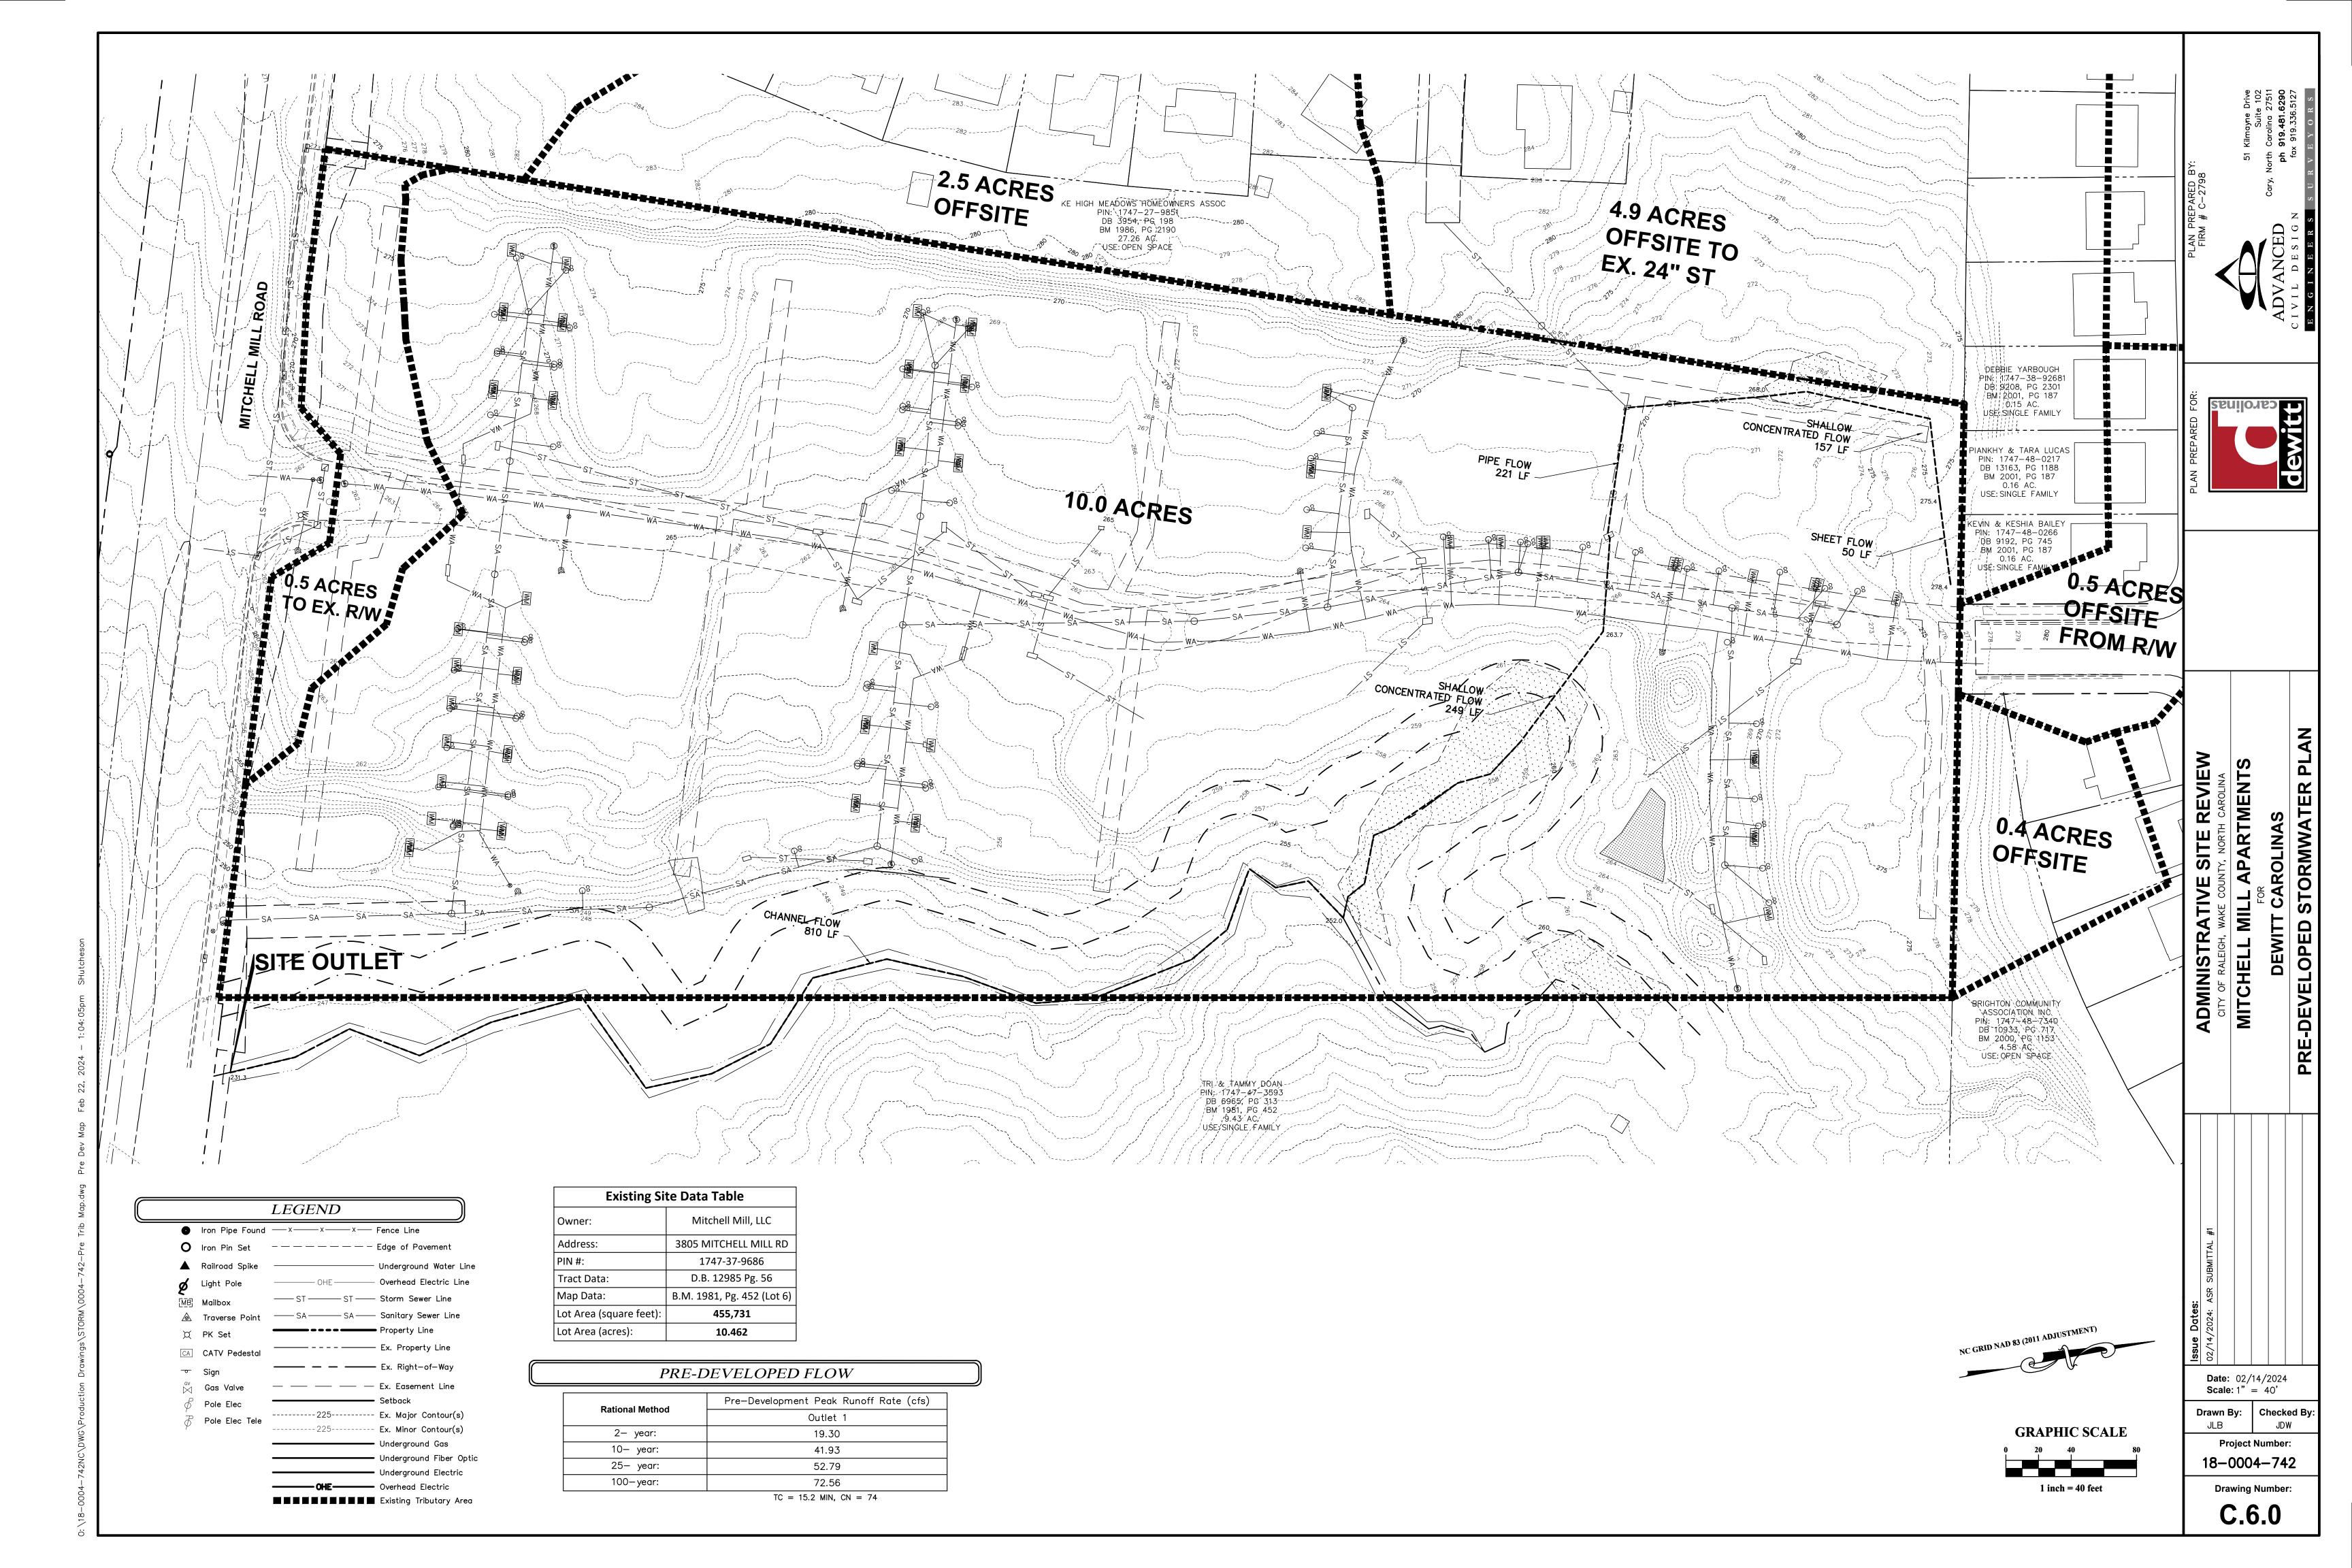
APPROVAL BY THE CITY OF RALEIGH.

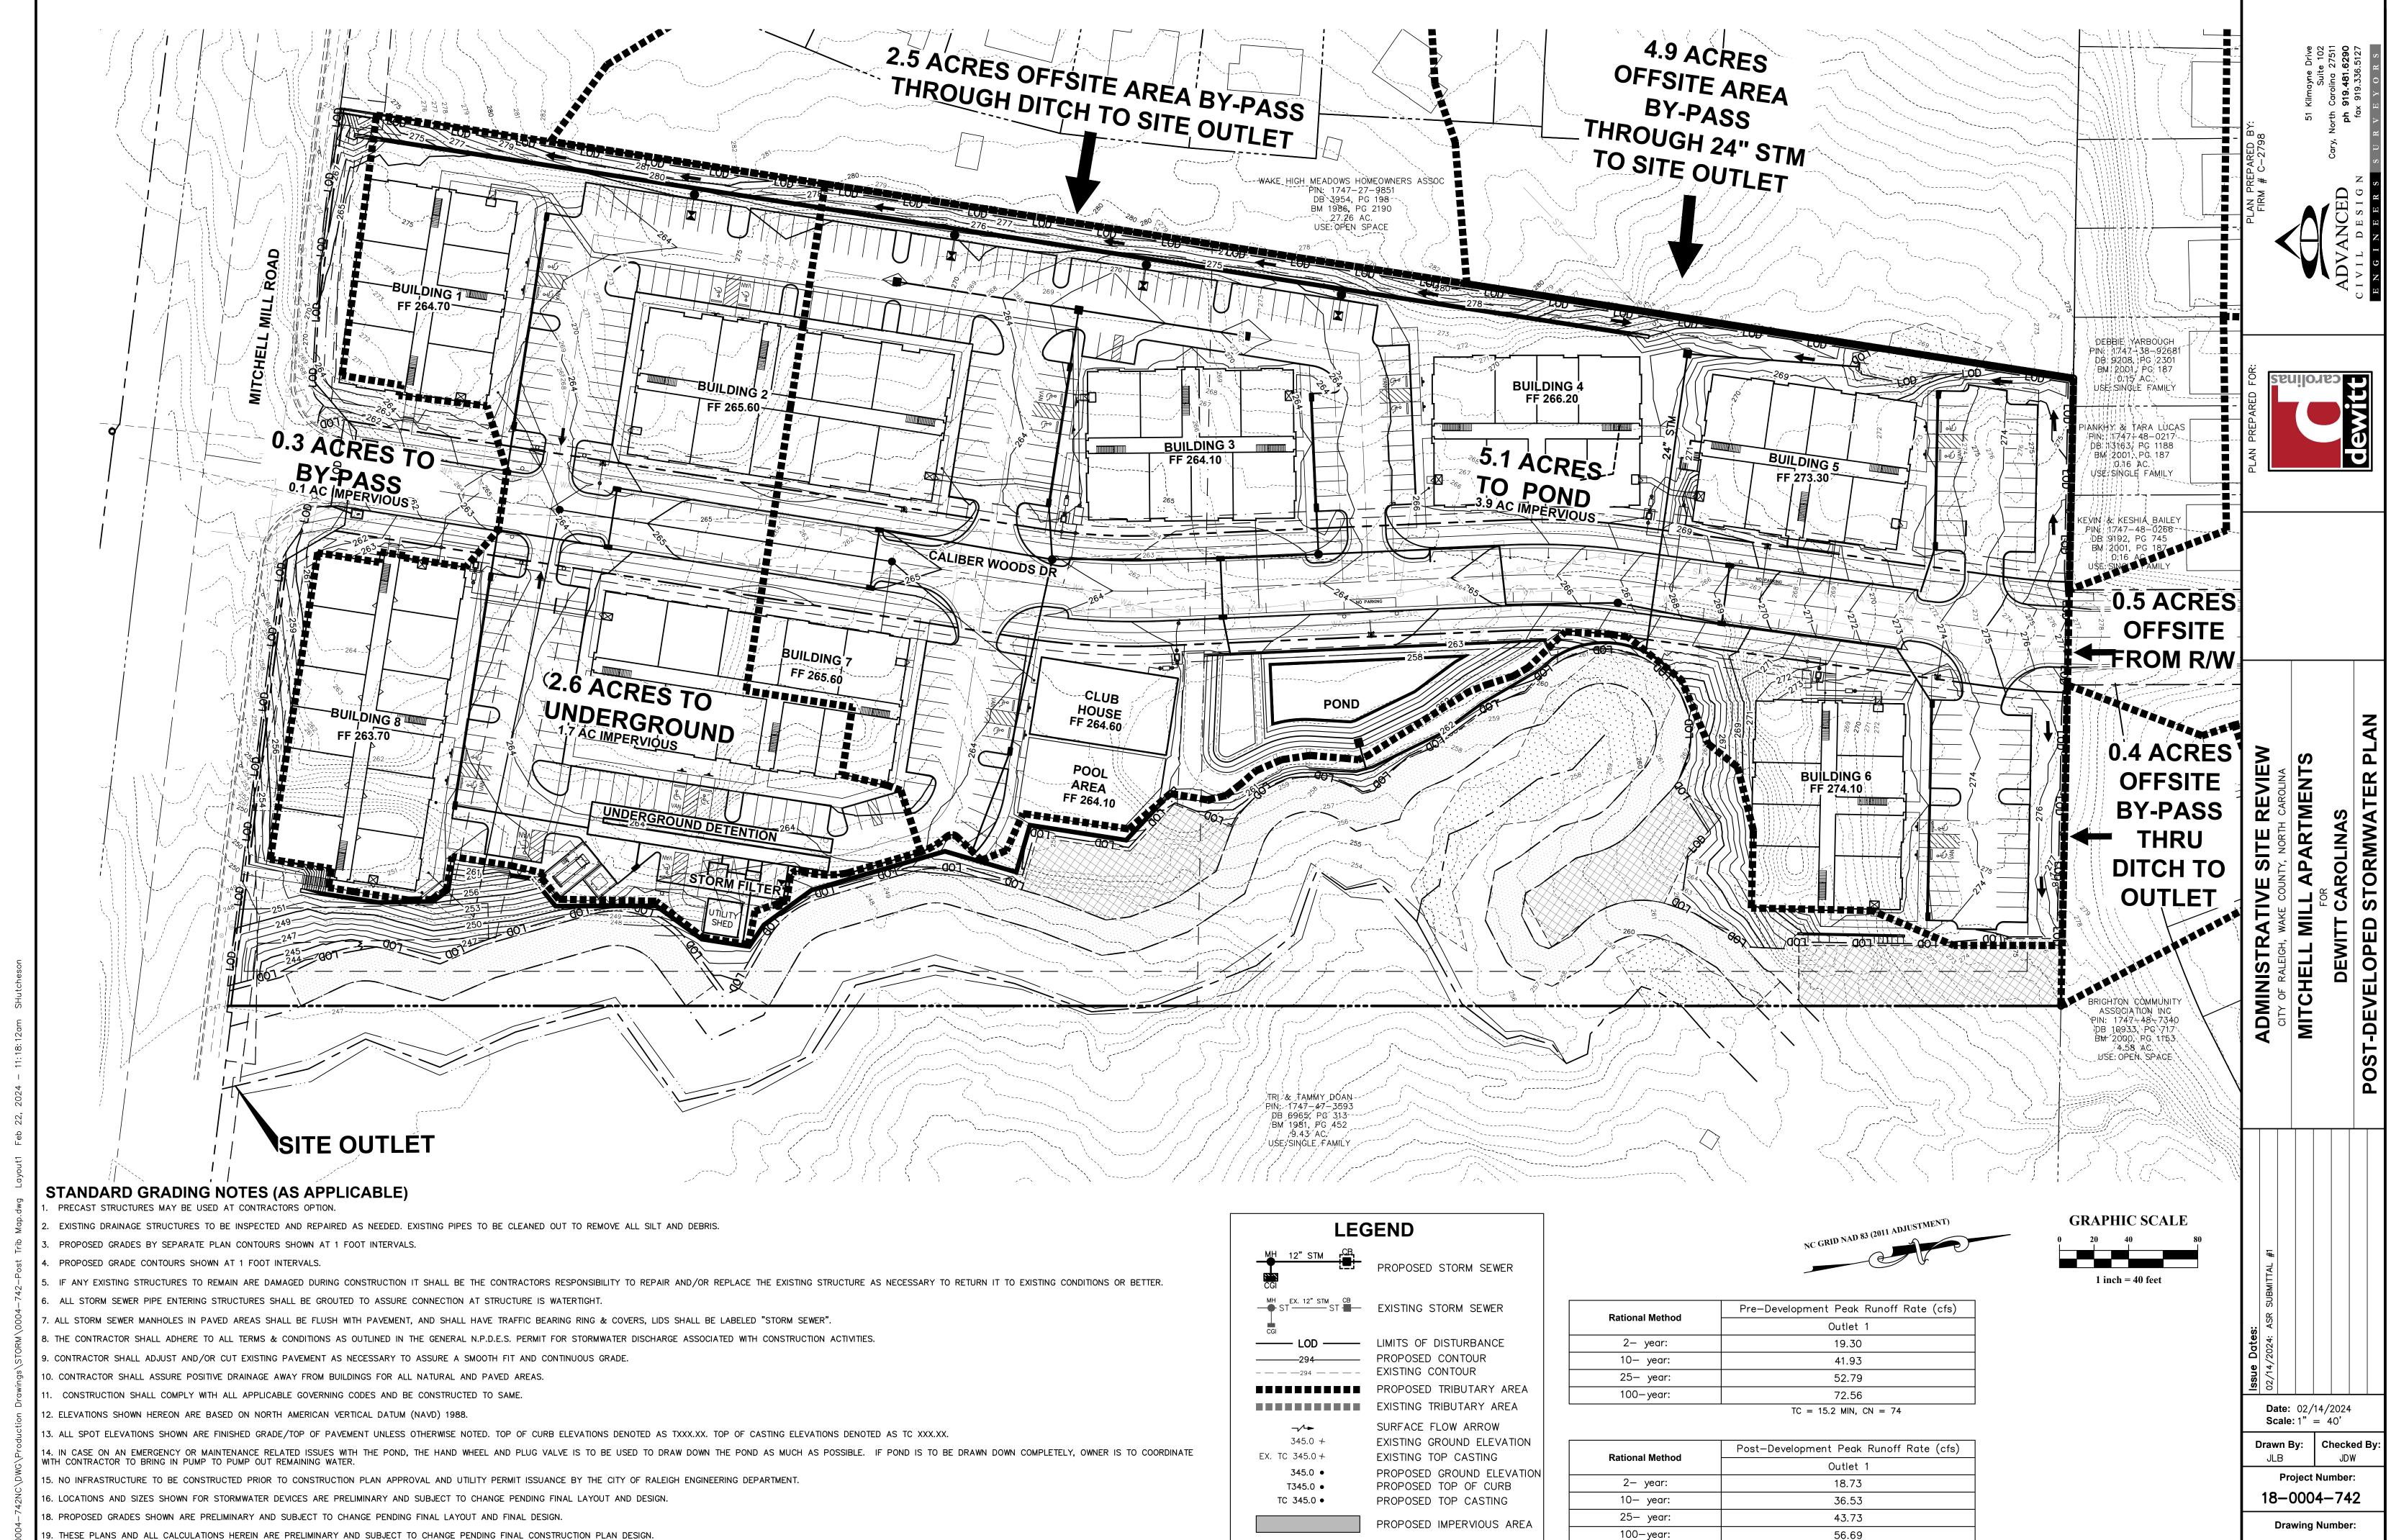
C.6.1


TC = 15.0 MIN, CN = 72



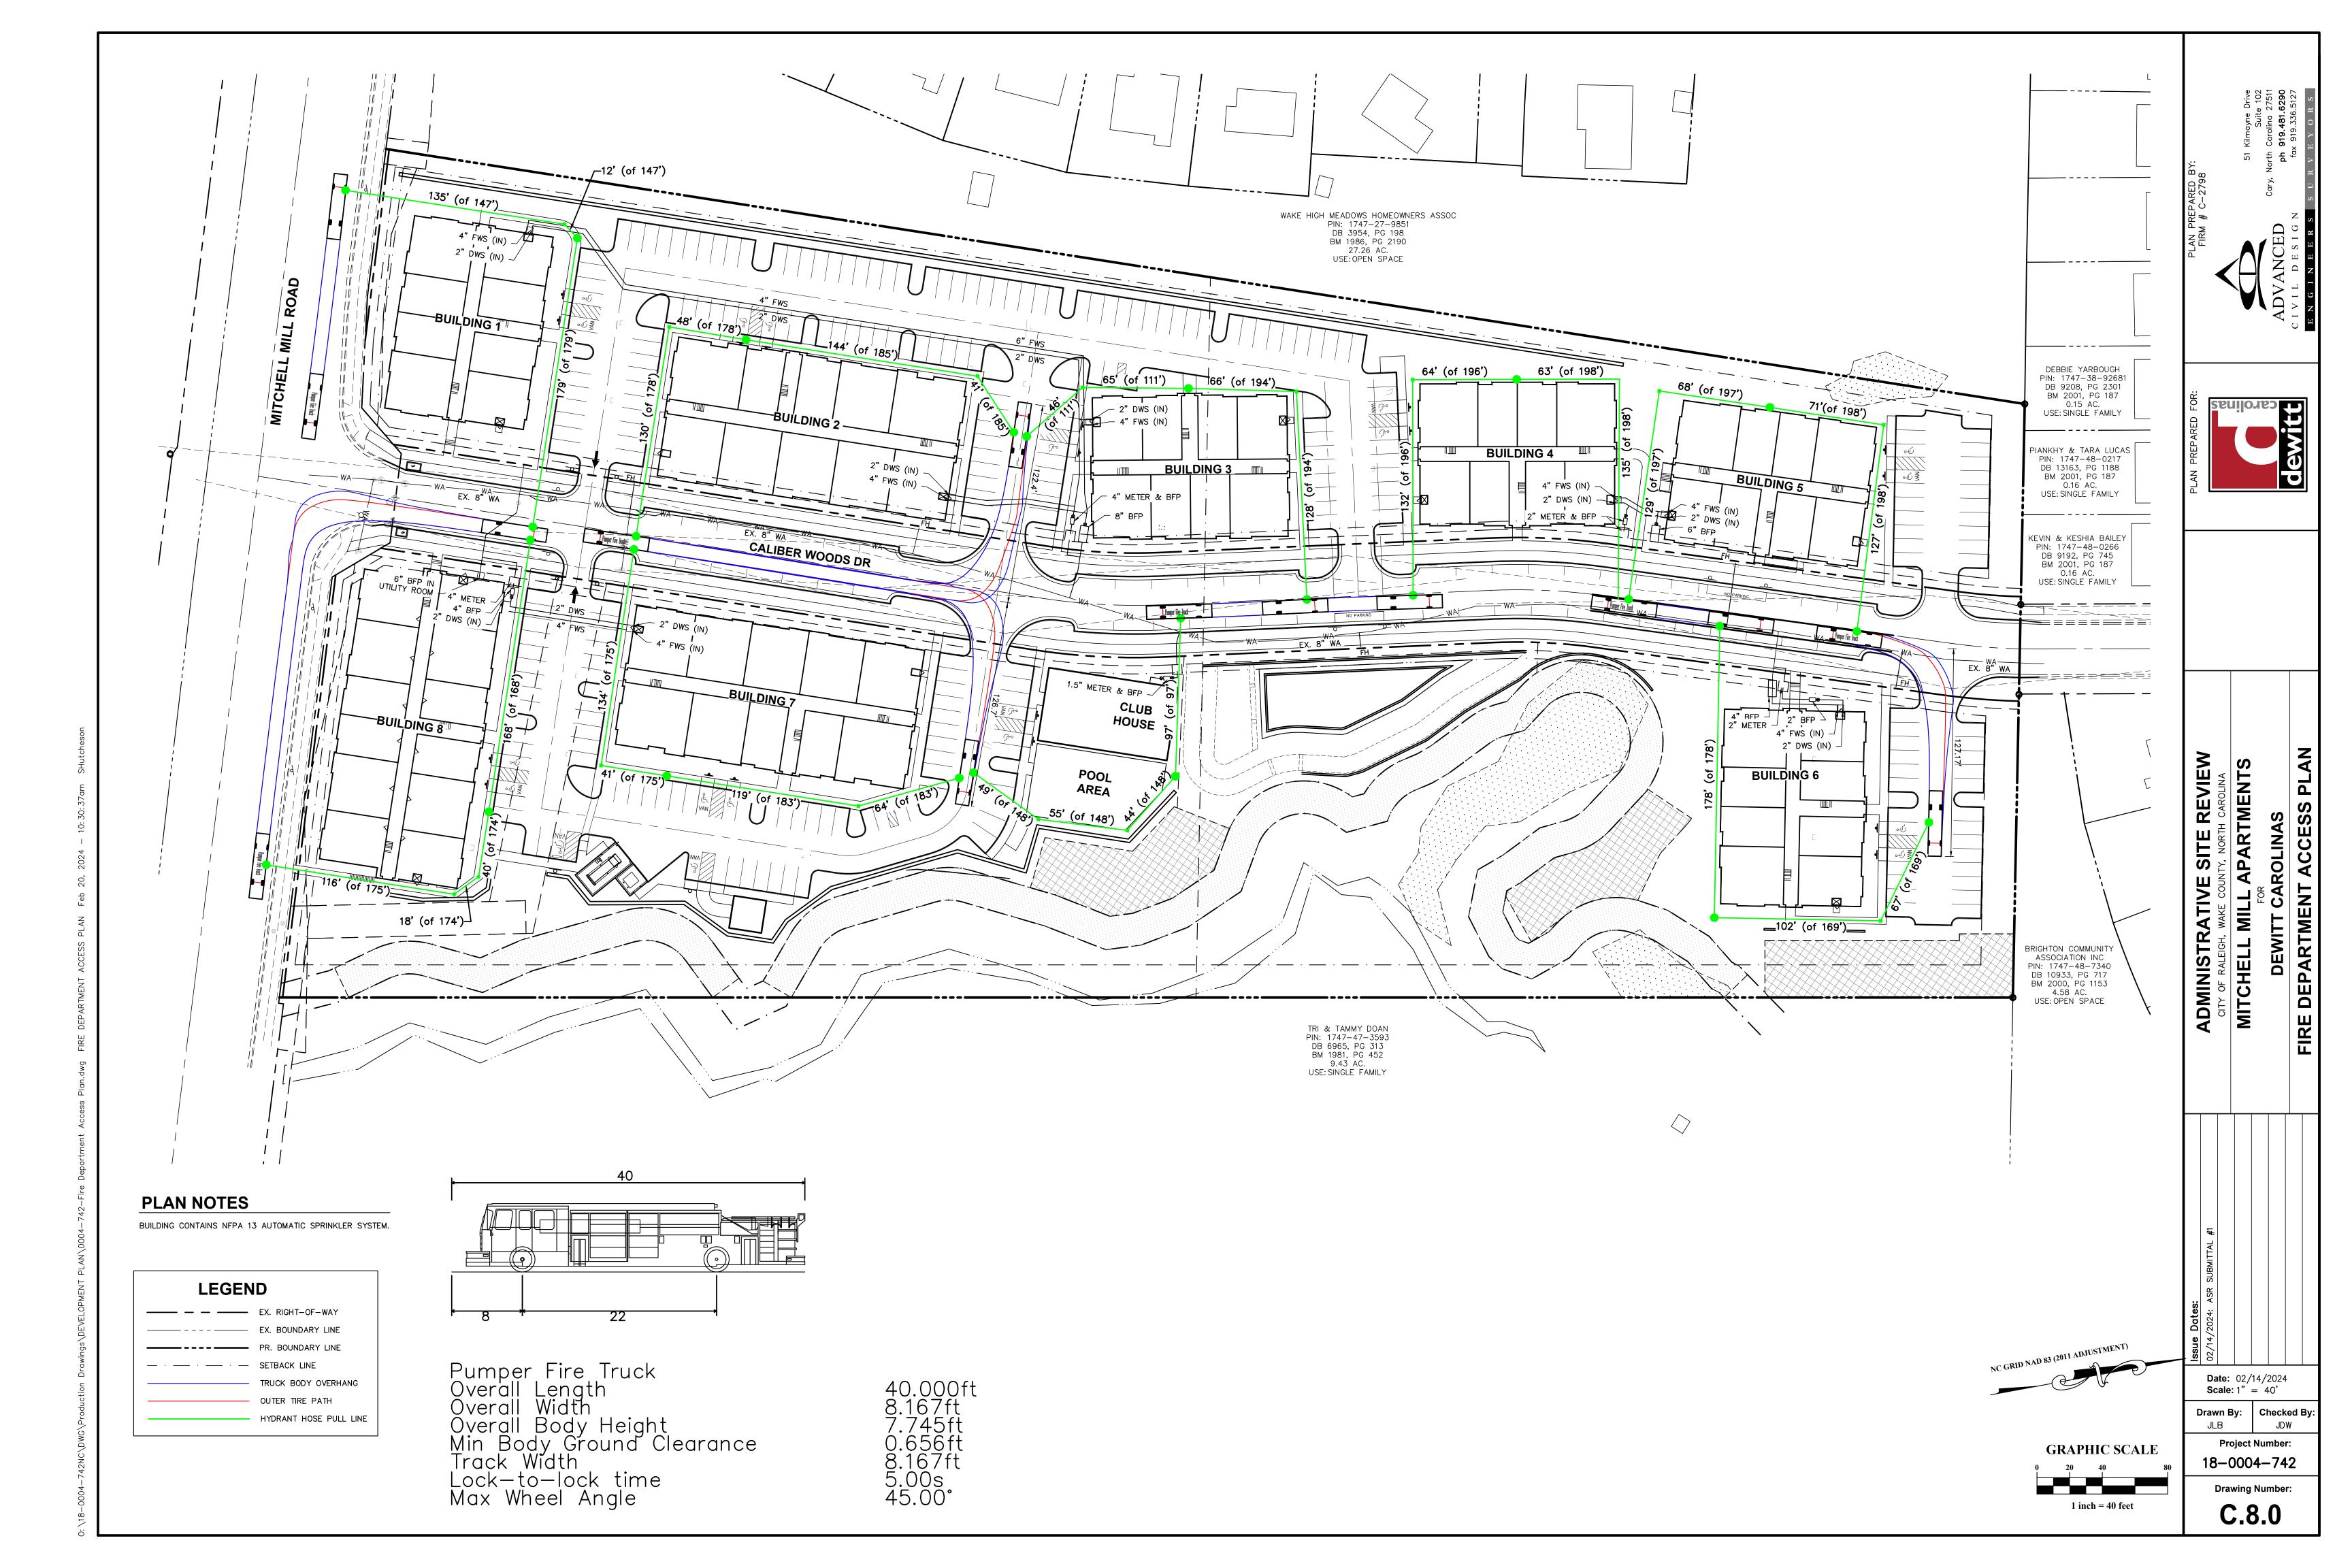

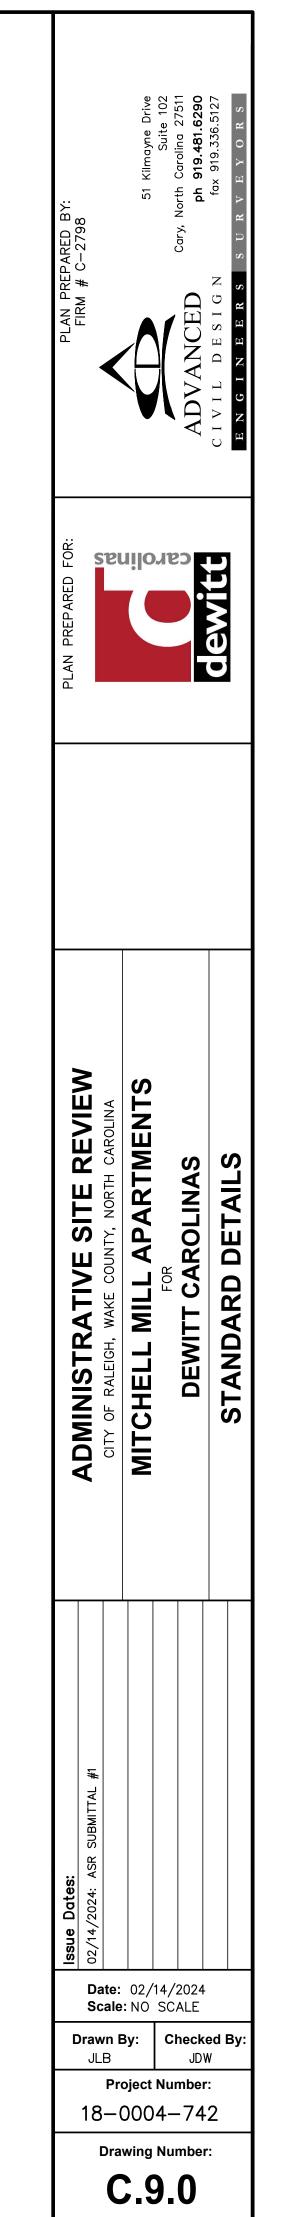

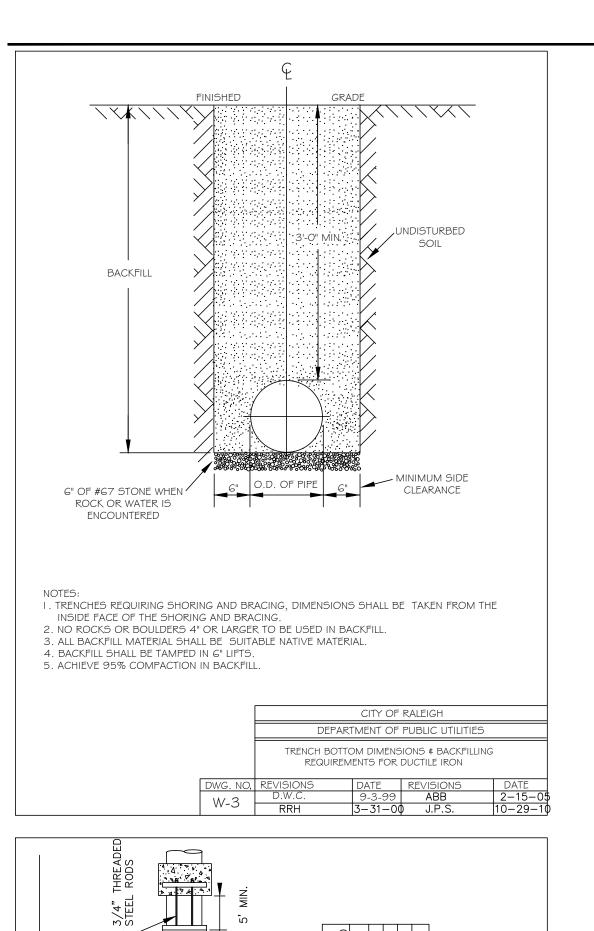

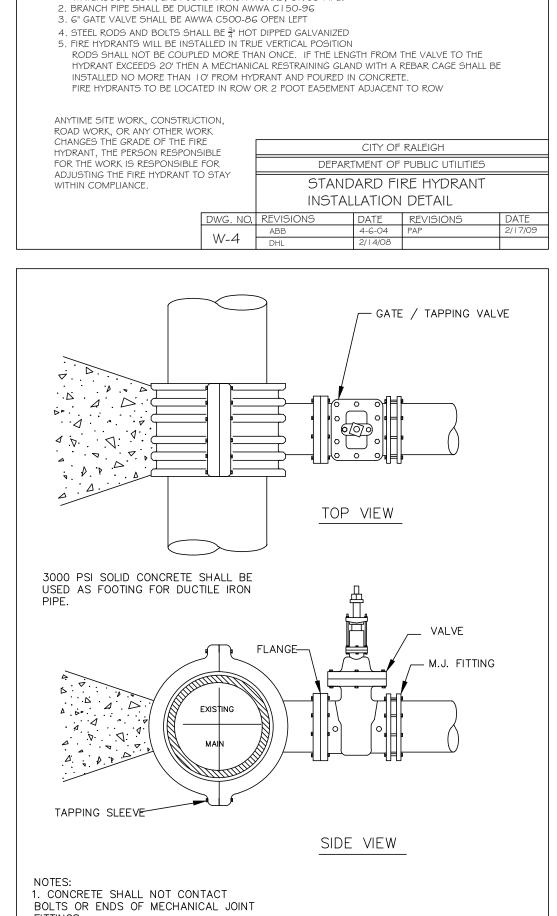

, MINIMUM 36" HORIZONTAL CLEARANCE

TOWARDS FIRE TRUCK ACCESS.

TRAFFIC FLANGE BETWEEN 2" - 6"

FIRE HYDRANT, PUMPER NOZZLE TO BE POINTED

COMPACTED BACKFILL (TAMPED IN 6" LIFTS)

I. FIRE HYDRANT SHALL BE AS MANUFACTURED: MUELLER, AMERICAN DARLING, KENNEDY, M&H,

RESTRAINING GLANDS

WATEROUS, CLOW, EAST JORDAN IRON WORKS, OR US PIPE.

1'-3"x 1'-3"x 4" THICK

7 CU. FT. CRUSHED

STONE MIN.

-62 m 4 m 1

CITY OF RALEIGH

DEPARTMENT OF PUBLIC UTILITIES

STANDARD VERTICAL BEND

2. SEE STANDARD REACTION BLOCK TABLES, W-10 AND W-11 FOR AREA CONCRETE REQUIRED.

PAVEMENT

RESTRAINING _

CITY OF RALEIGH
DEPARTMENT OF PUBLIC UTILITIES


4" - 24" STANDARD TAPPING

SLEEVE AND VALVE ASSEMBLY


-UNDISTURBED EARTH.


FROM ANY OBJECT.


, ABOVE GRADE

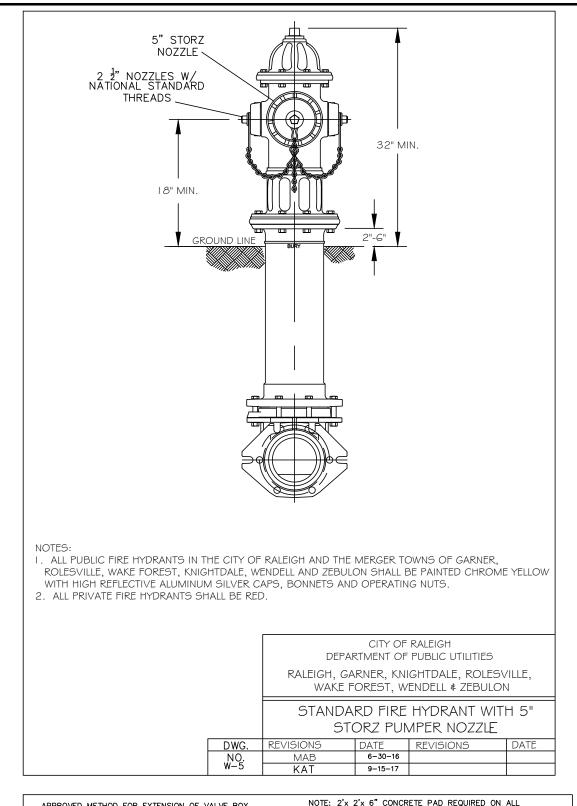



WATER

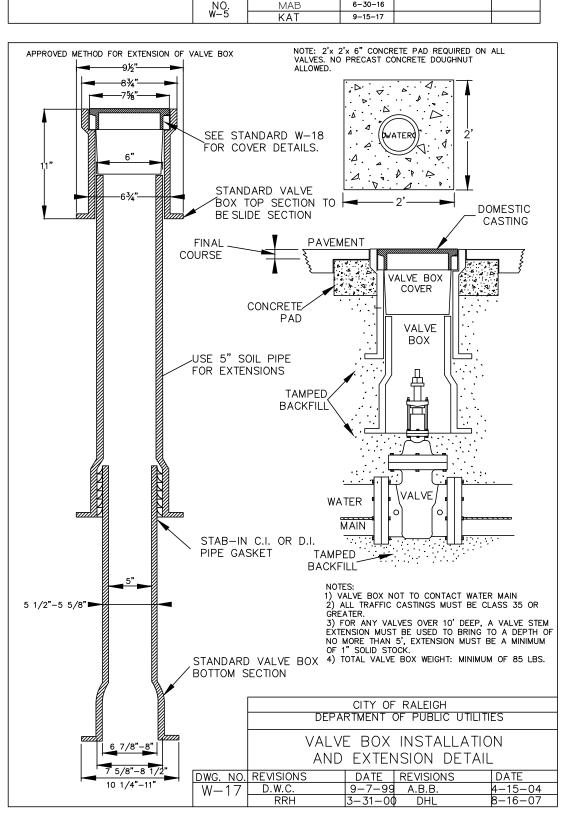


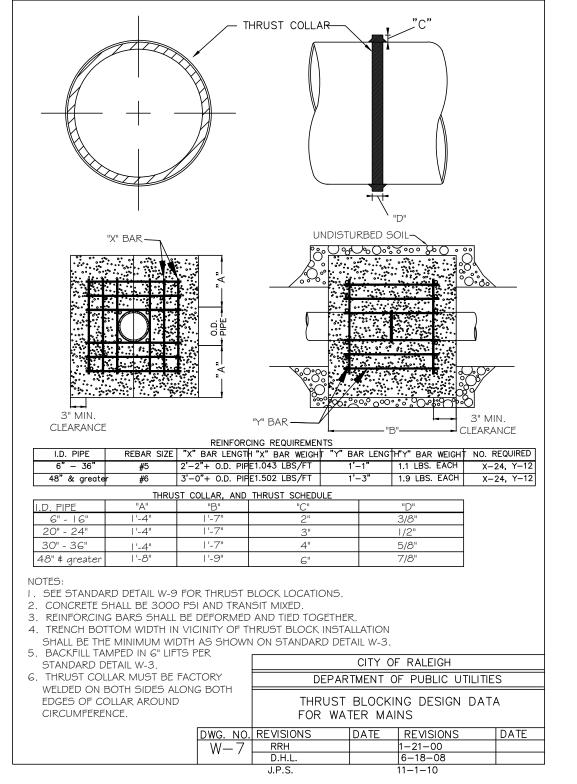

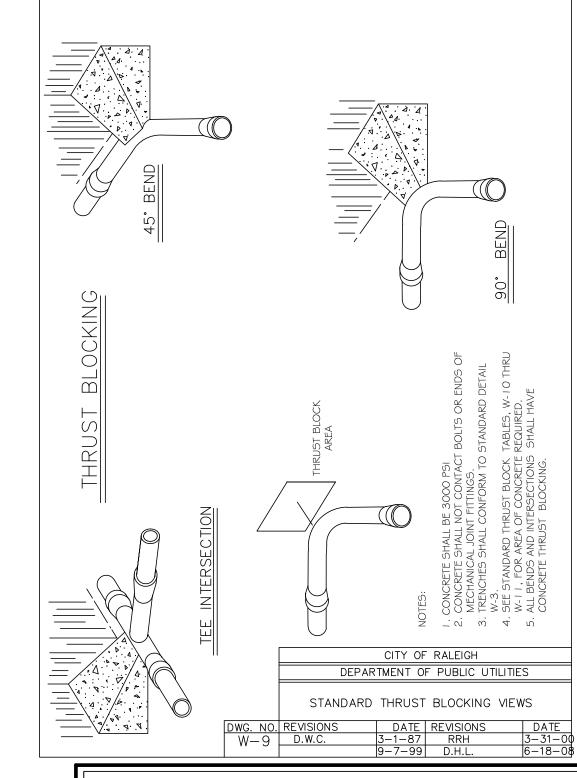


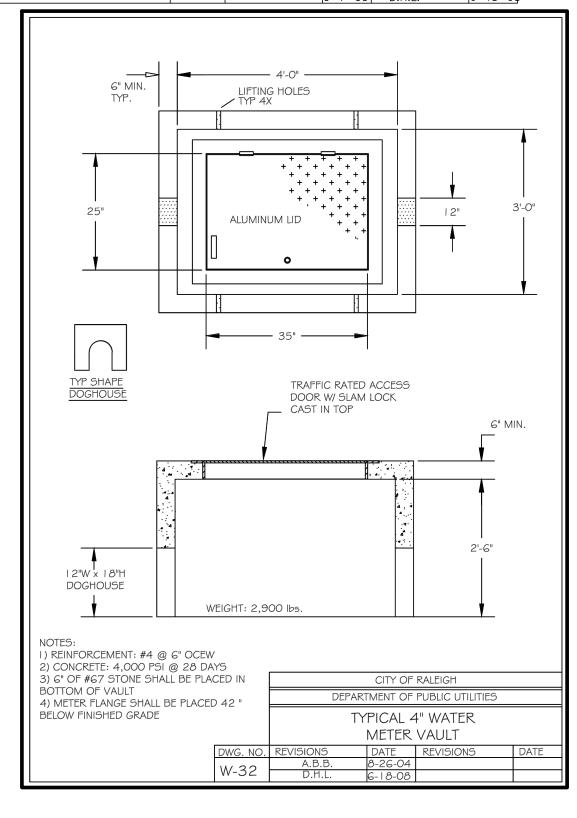

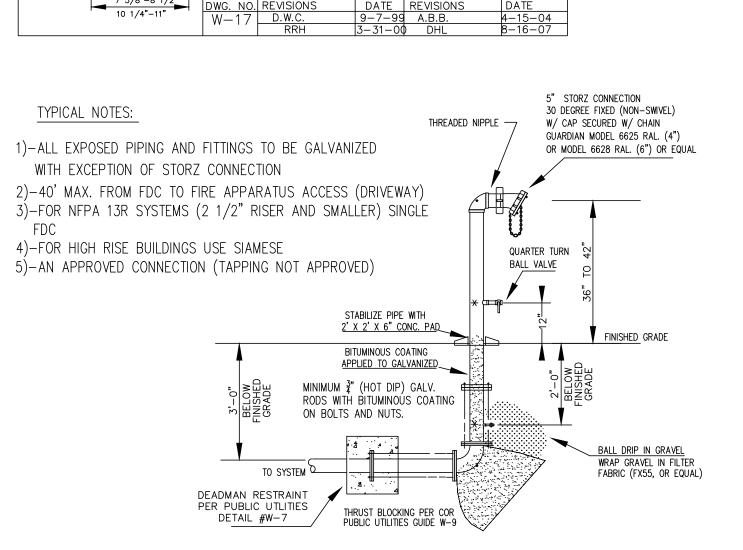

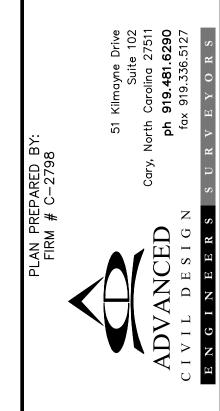



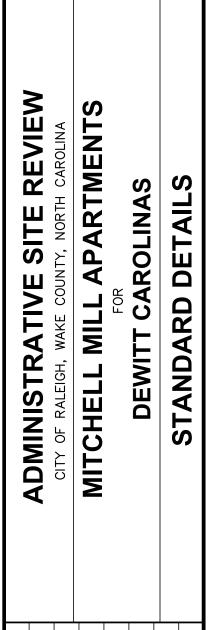


Issue Dates:	02/14/2024: ASR SUBMITTAL #1						
Date: 02/14/2024 Scale: NO SCALE							

Drawn By: Checked By Project Number: 18-0004-742

Drawing Number:


C.9.1

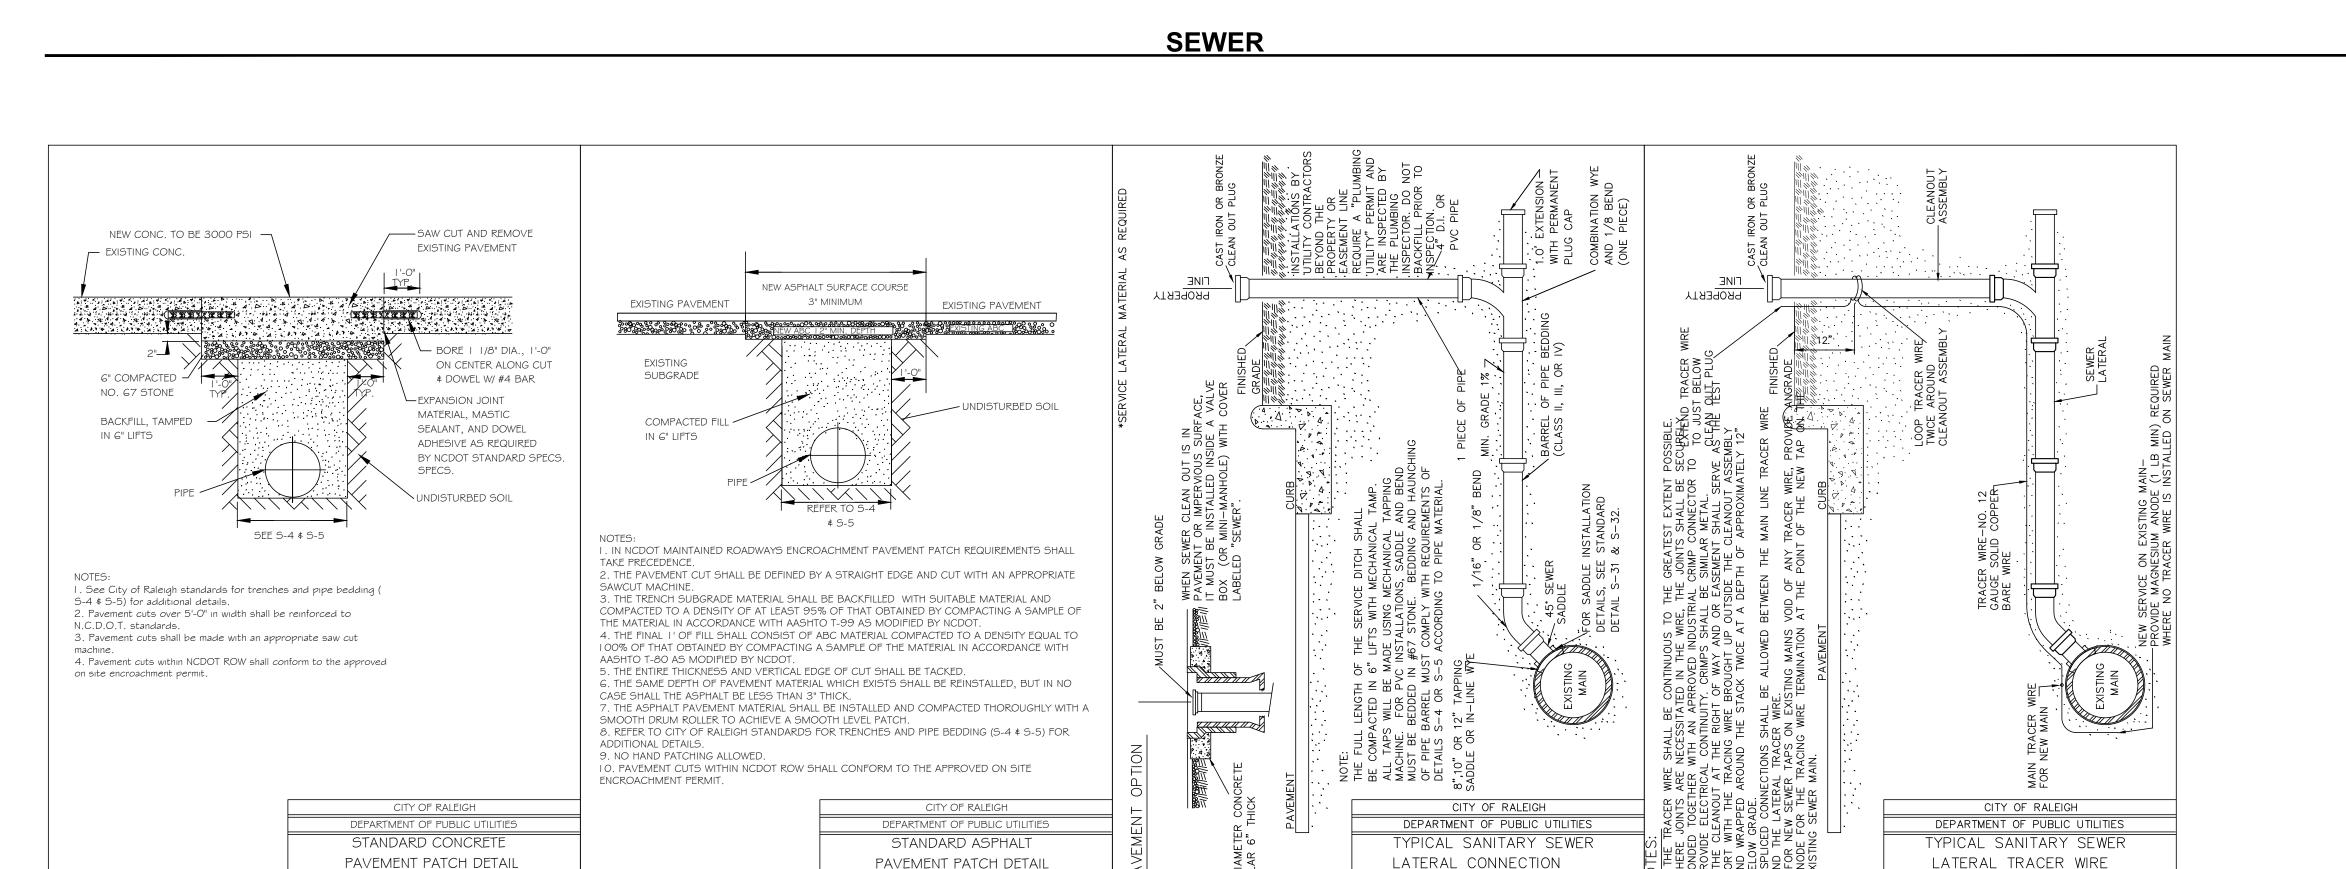


S-3 -


TRANSPORTATION TREE PROTECTION

9 × 4

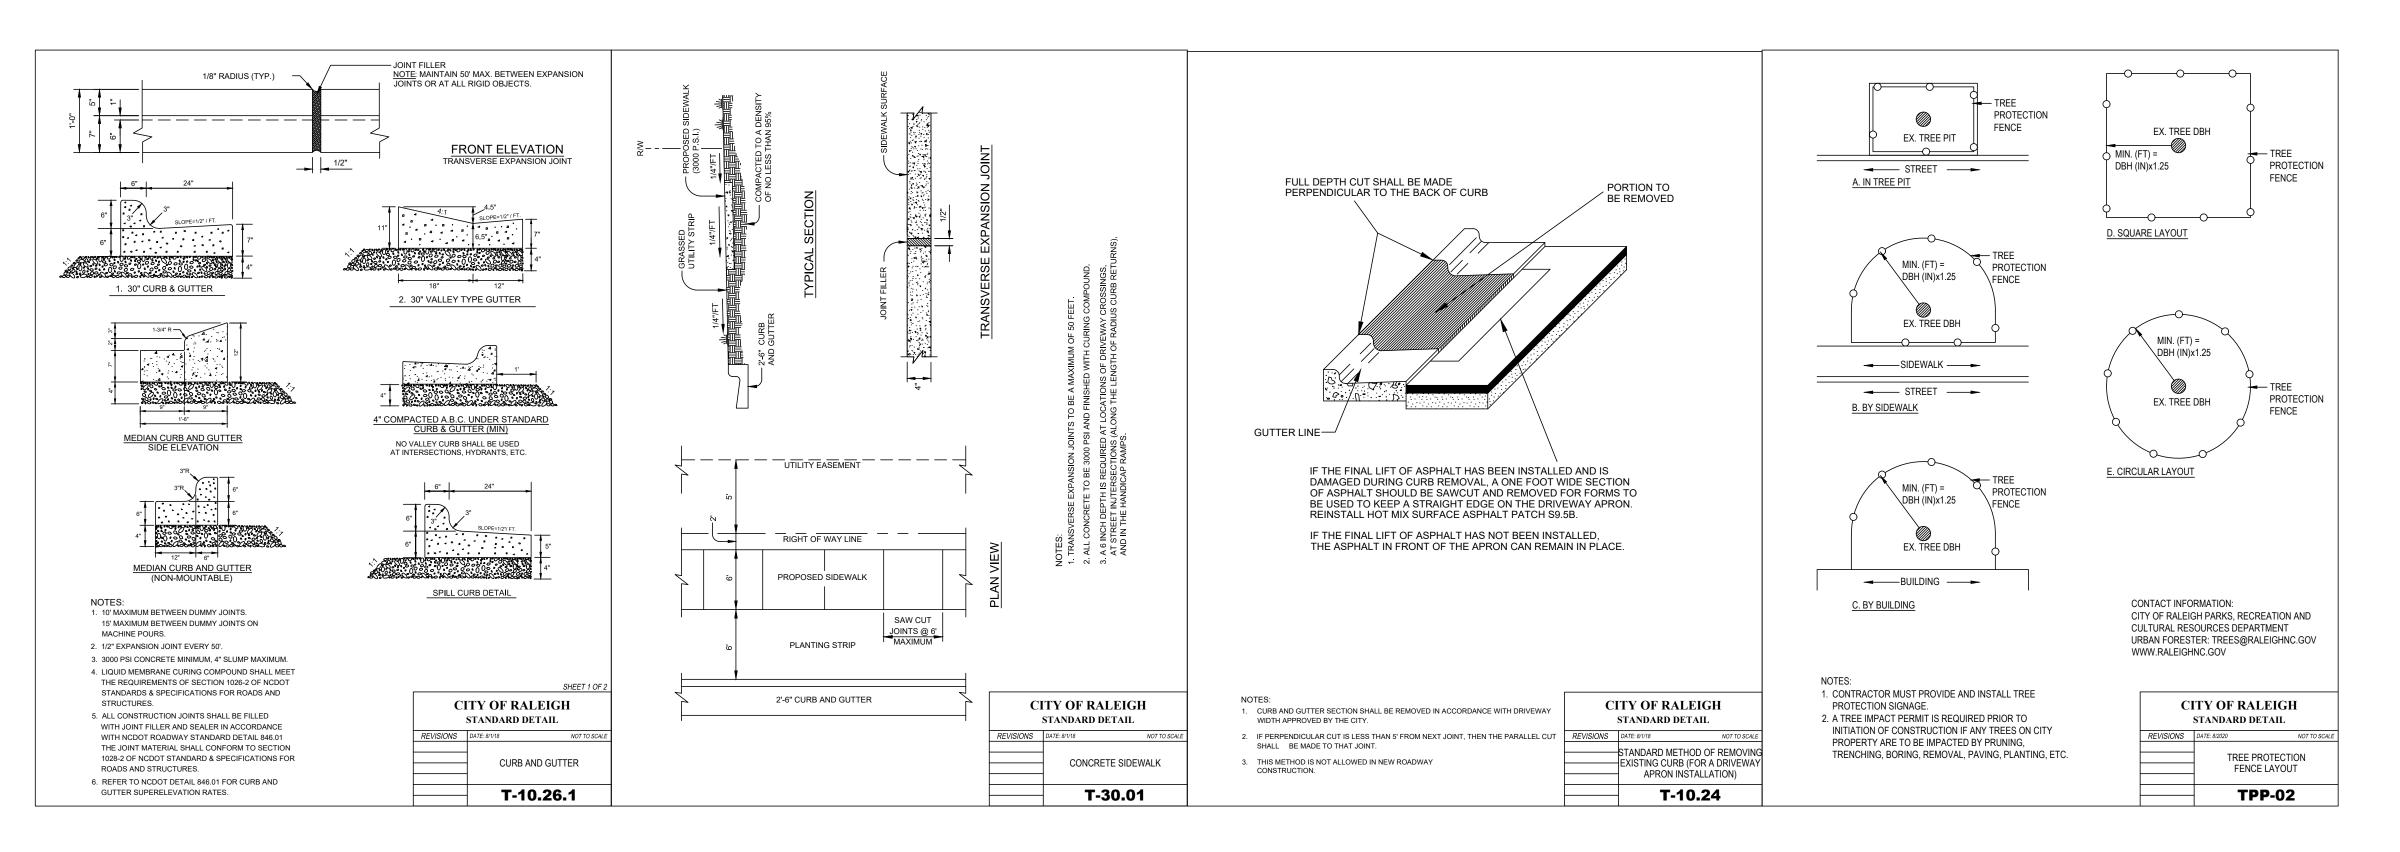


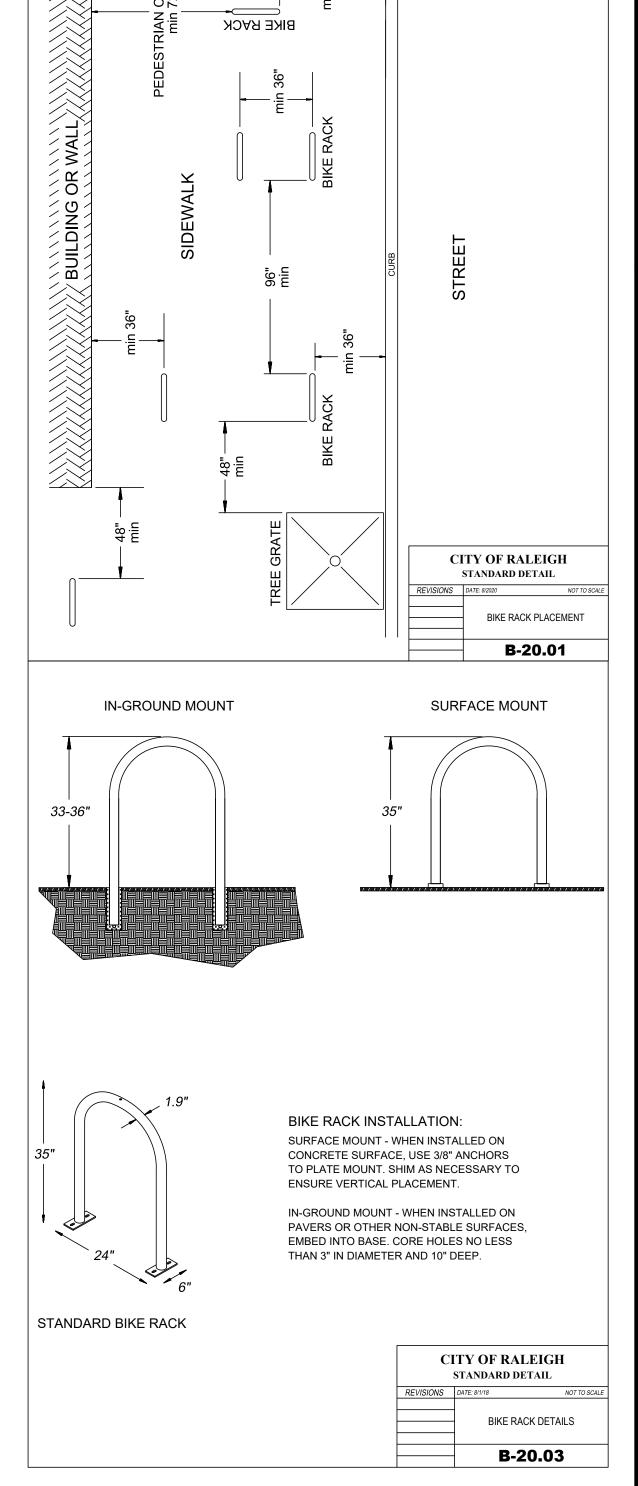

BICYCLE FACILITIES

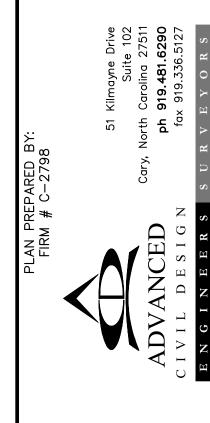



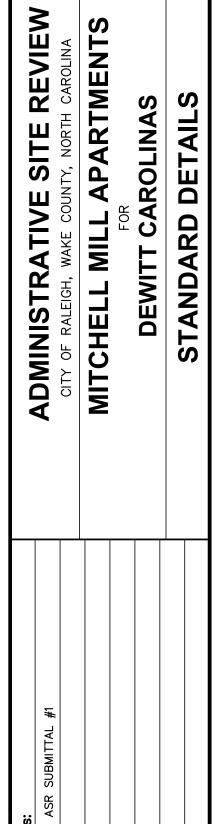

Date: 02/14/2024 **Scale:** NO SCALE

Drawn By: Checked By

Project Number:

18-0004-742


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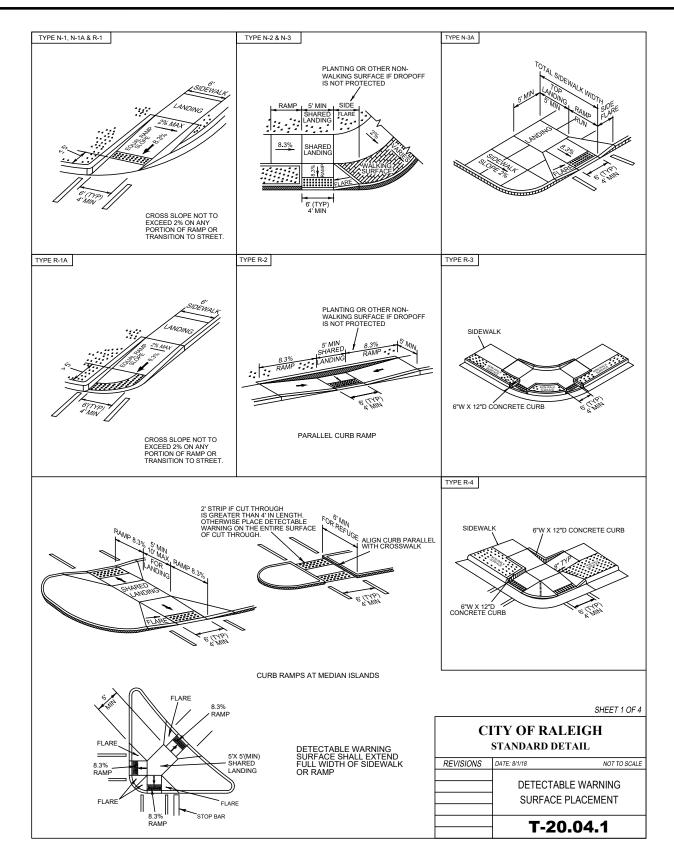
C.9.2


JDW


JLB


TRANSPORTATION



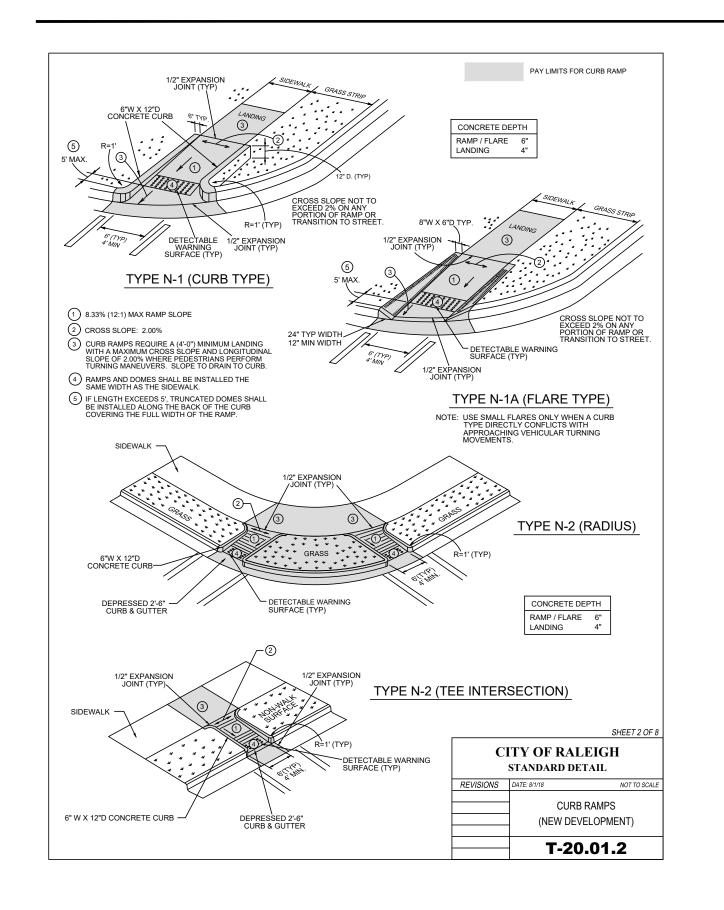

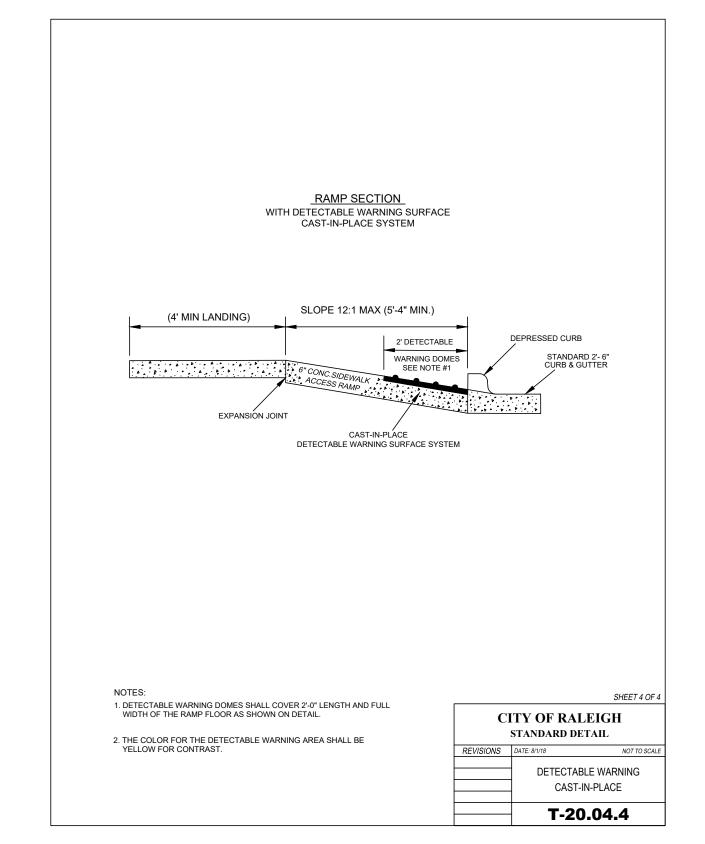


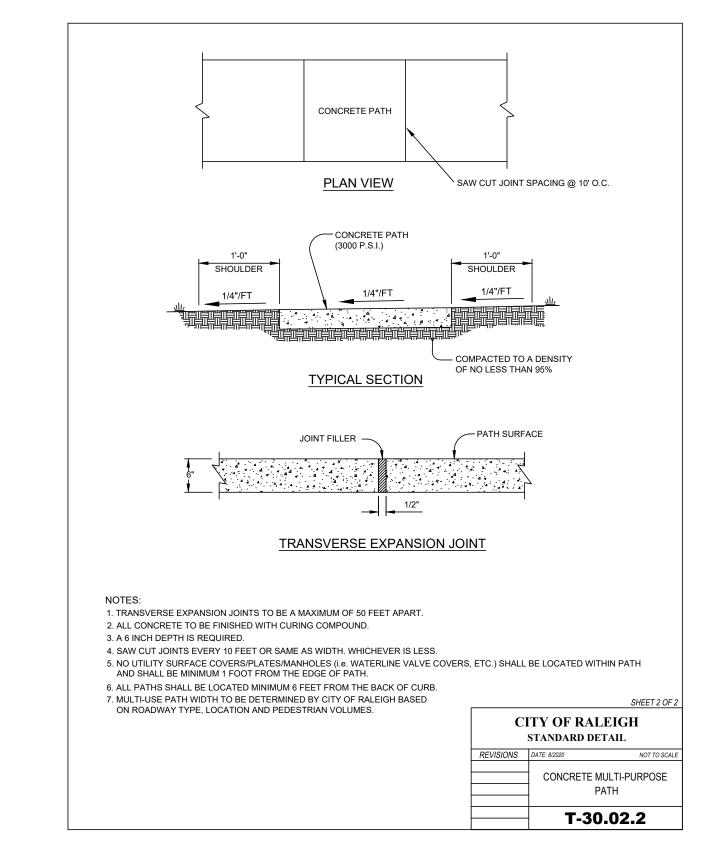


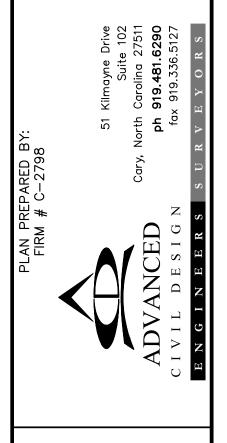



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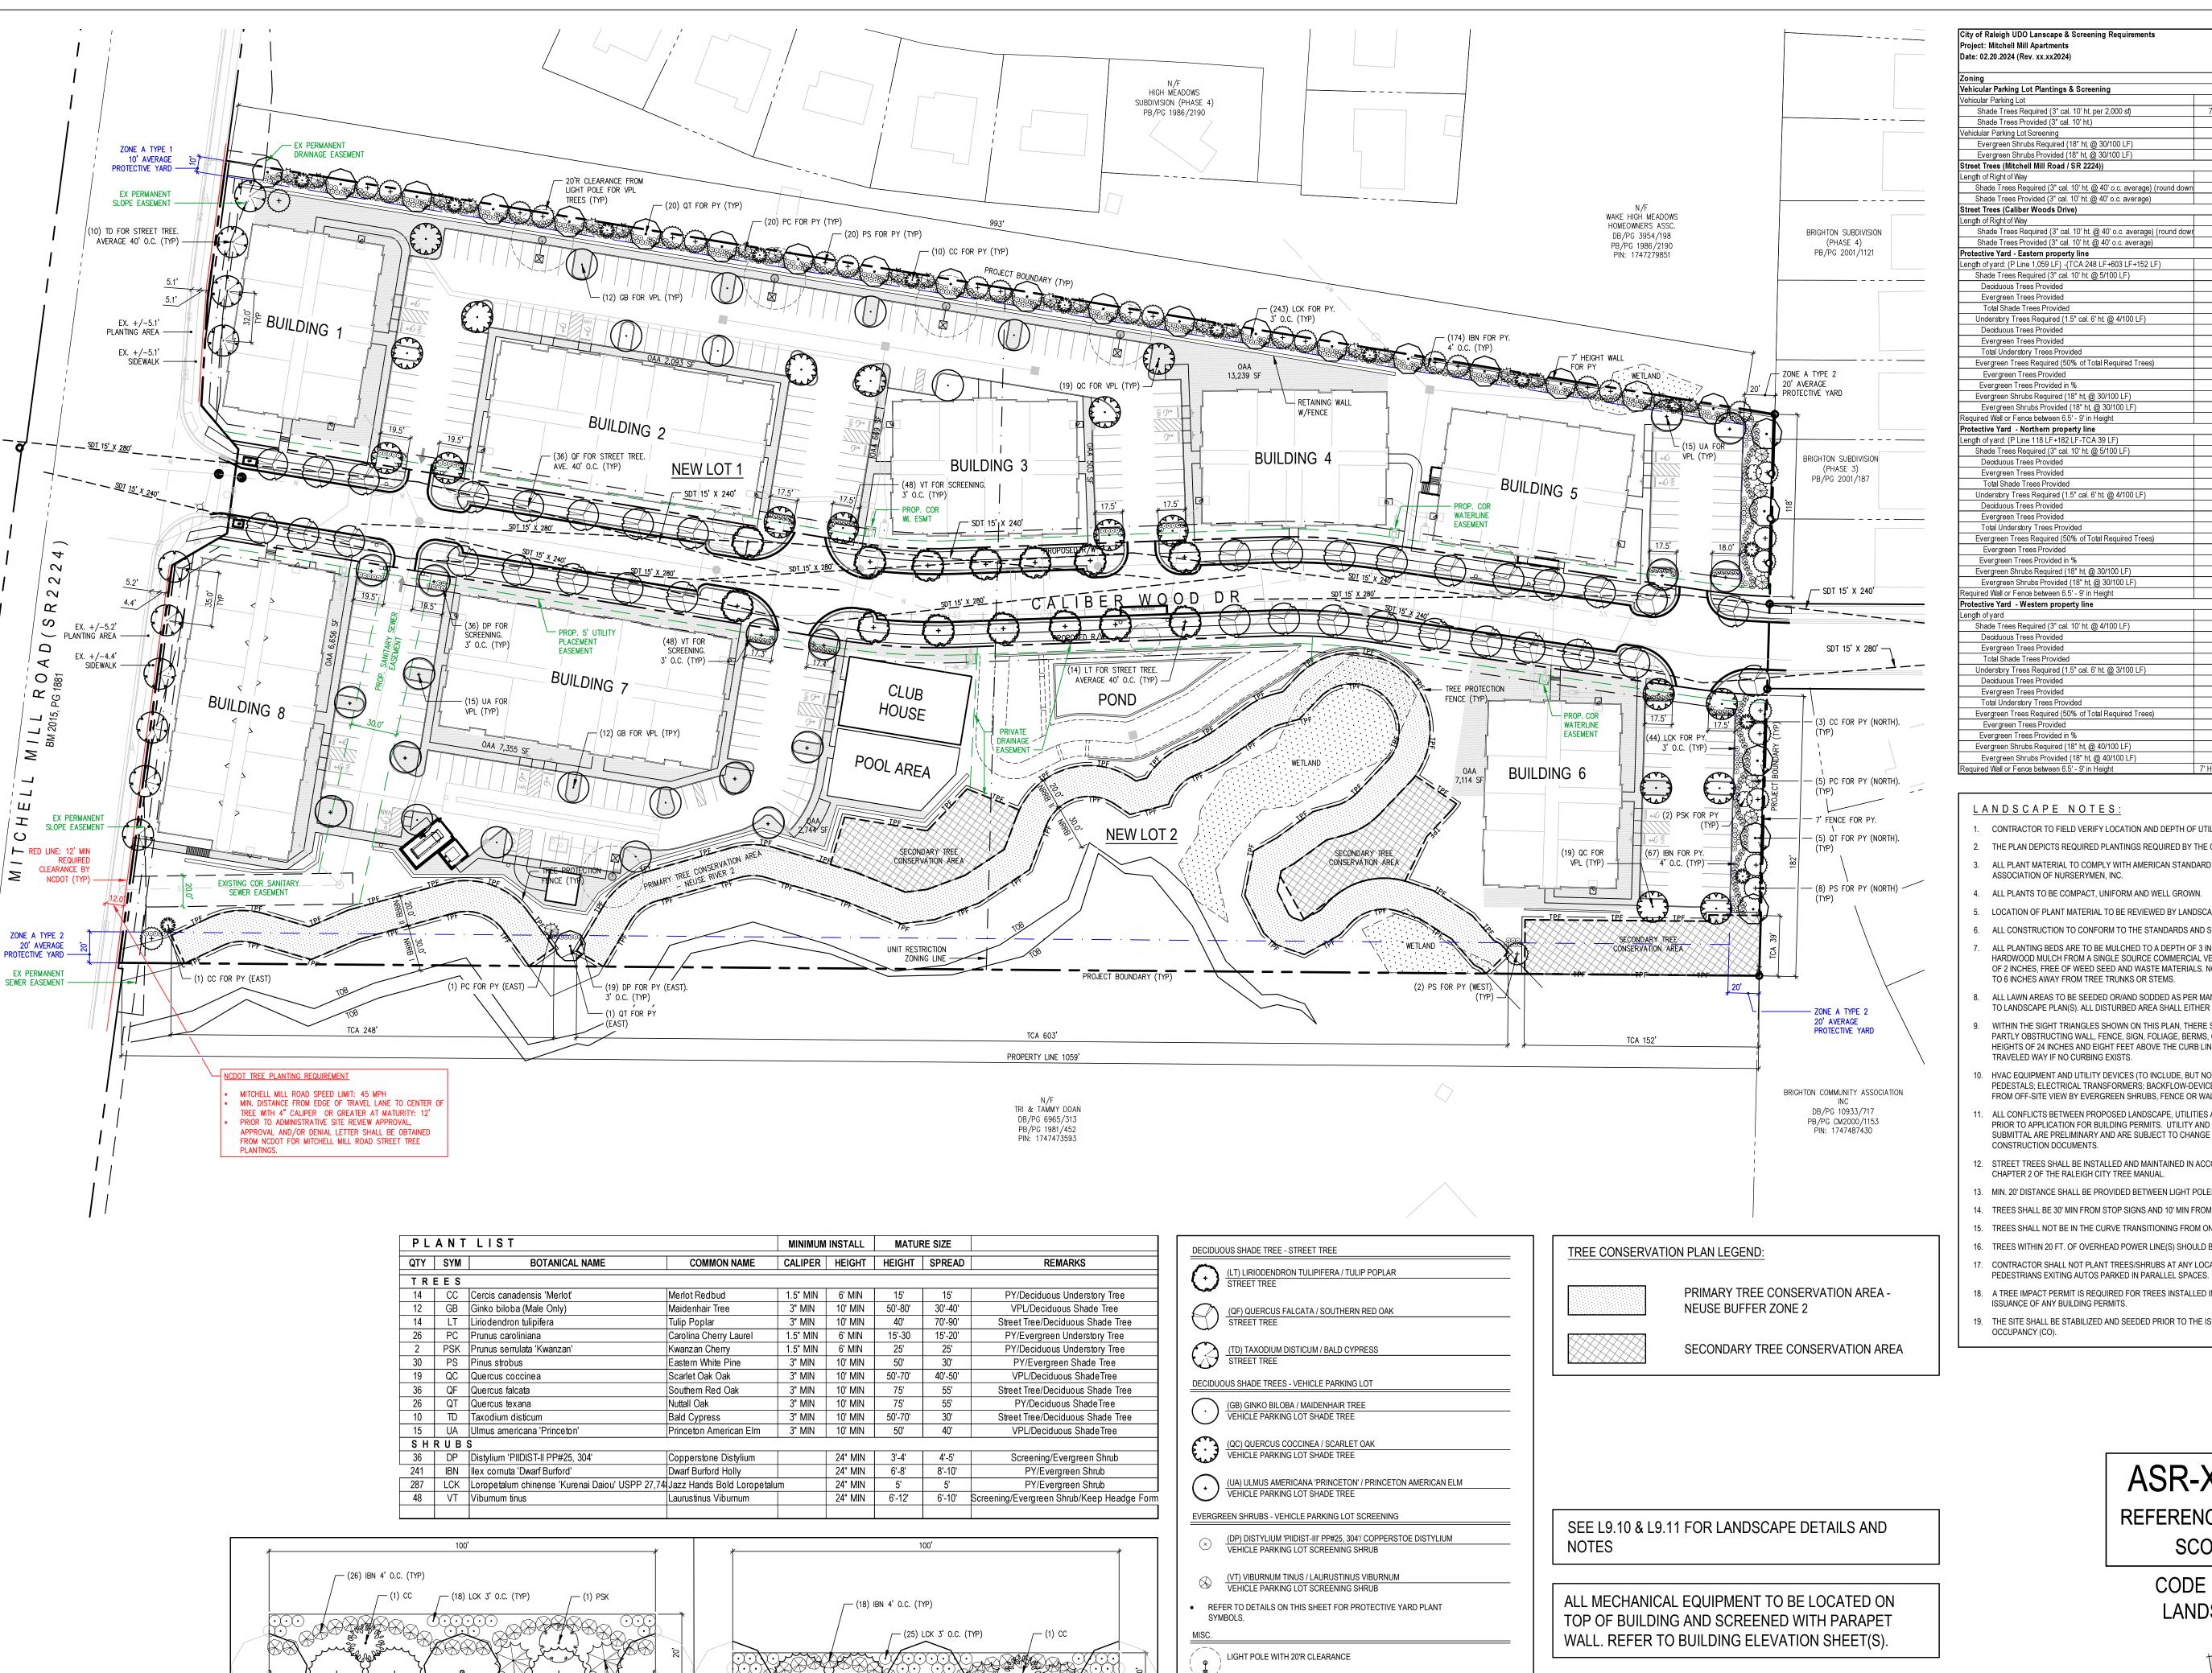


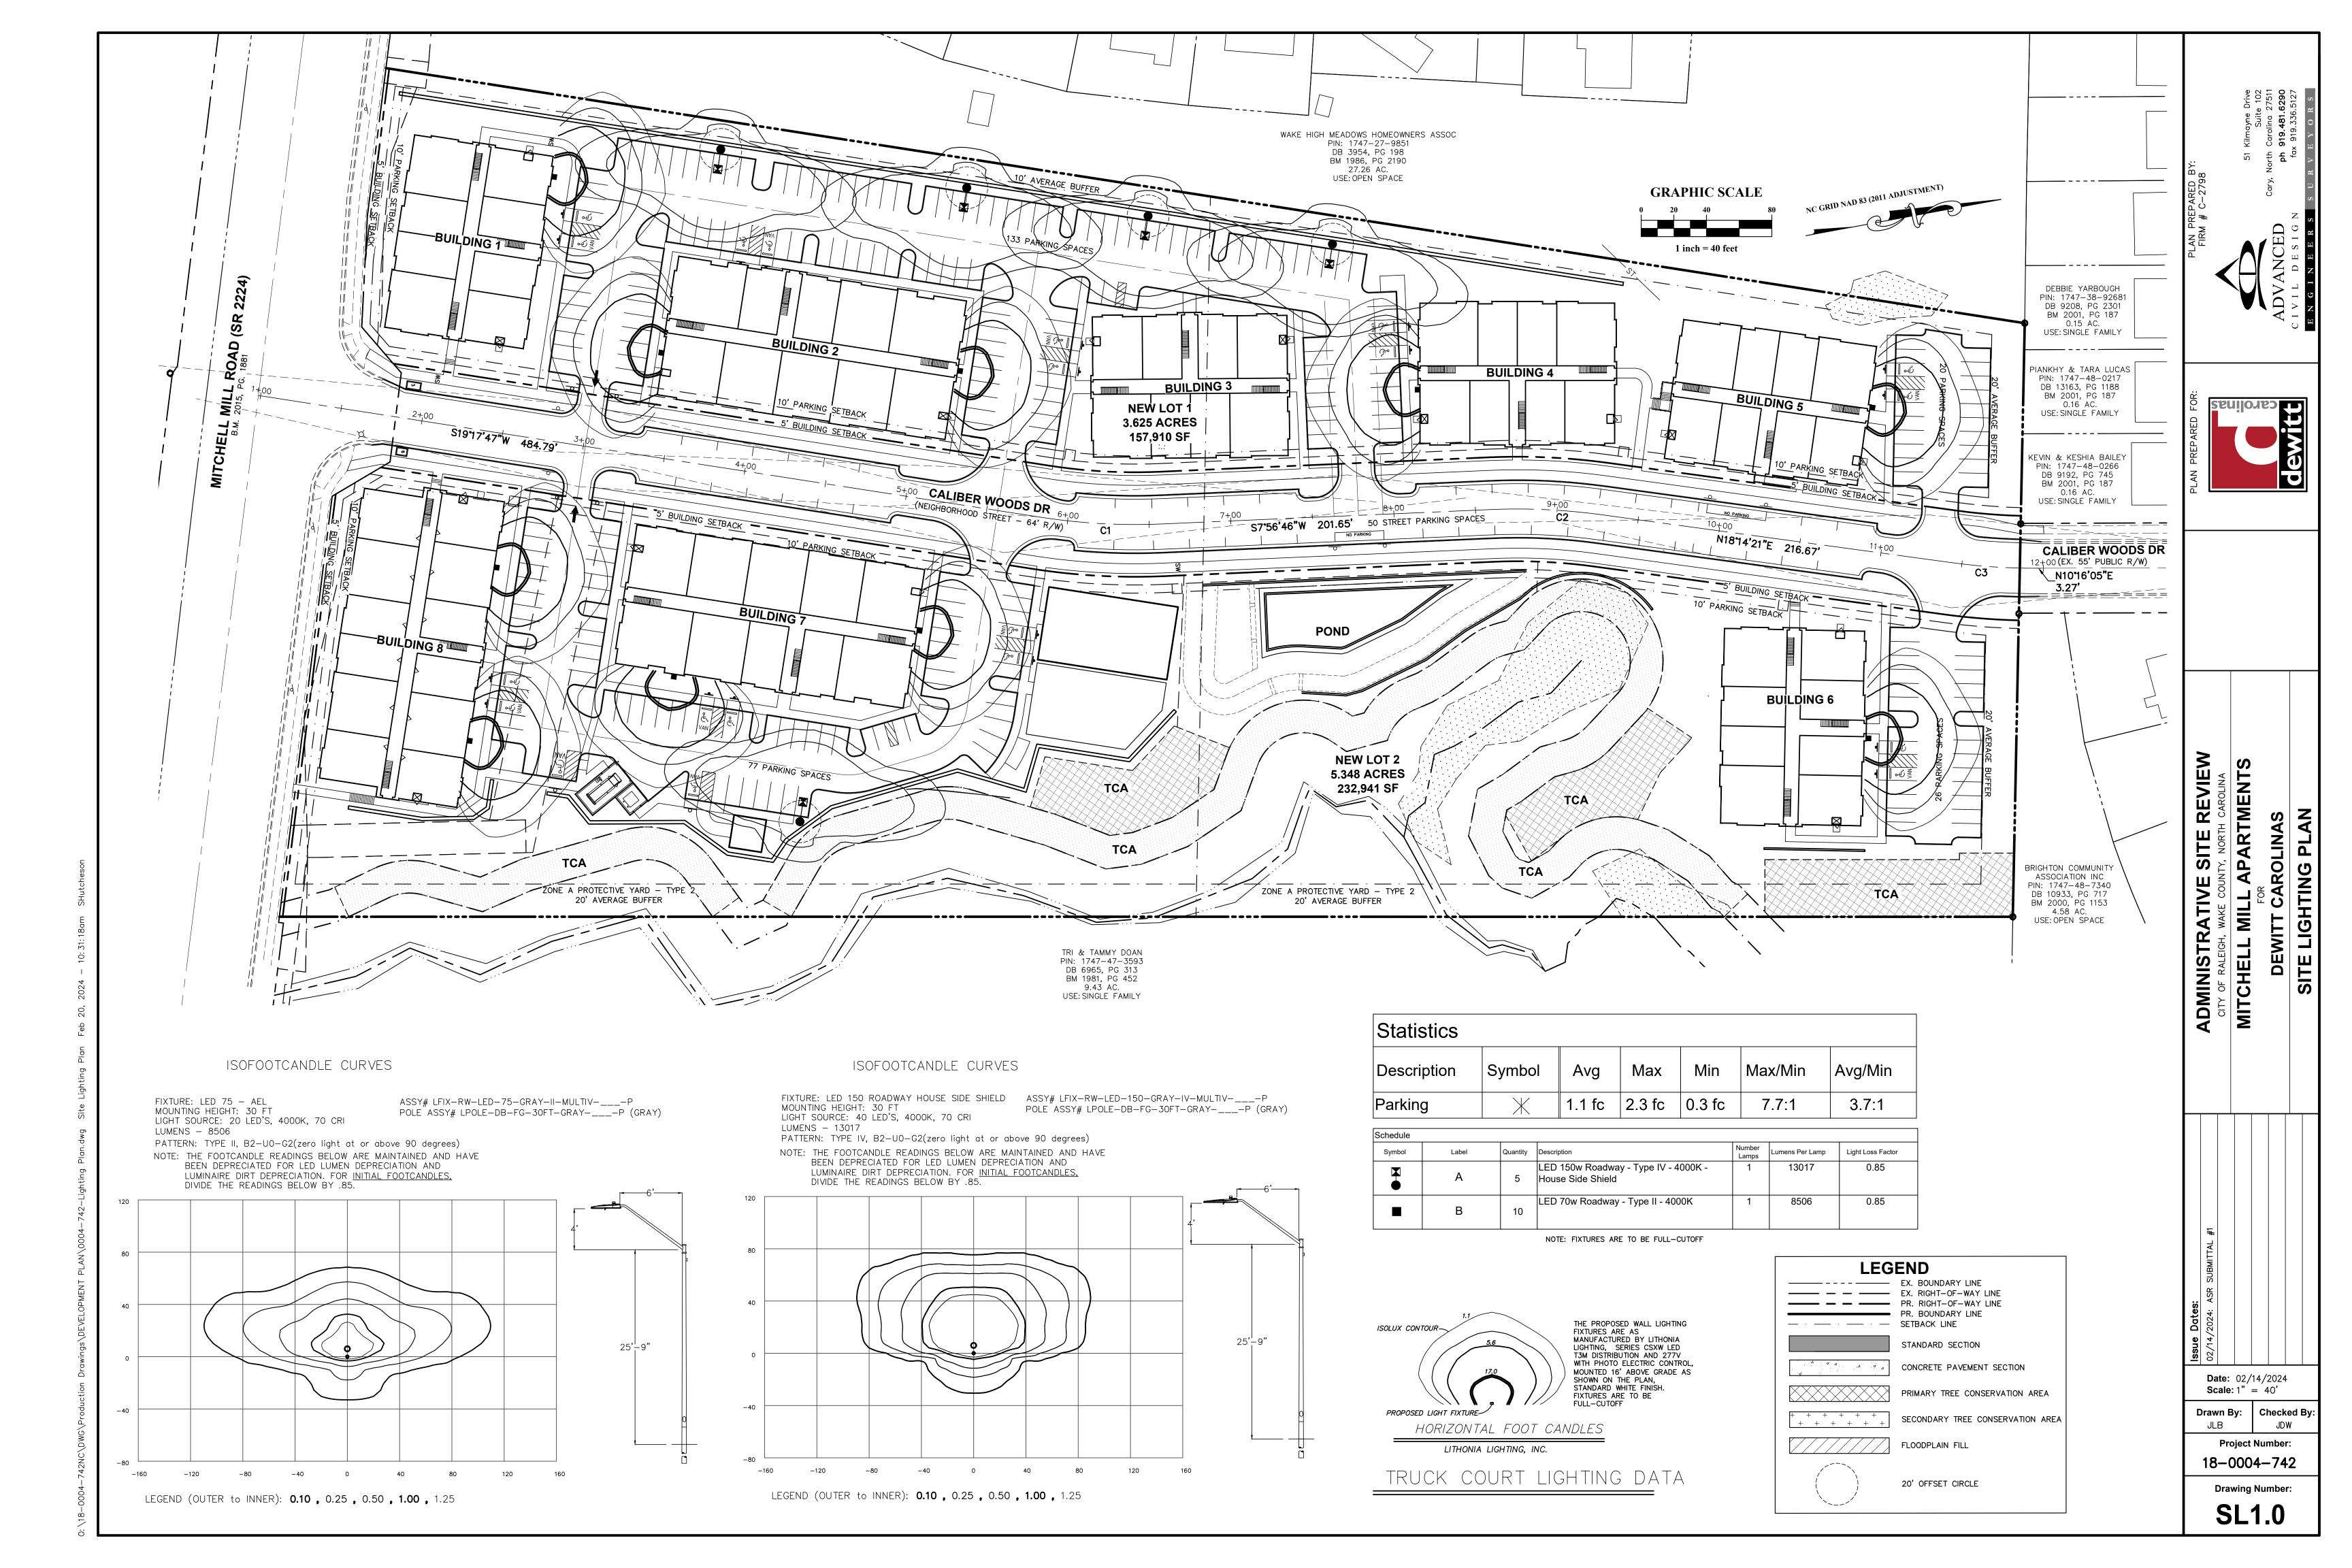partments **Road** 27616 Carolina <u>Ф</u> 3805 **№** Raleigh, l Mitch

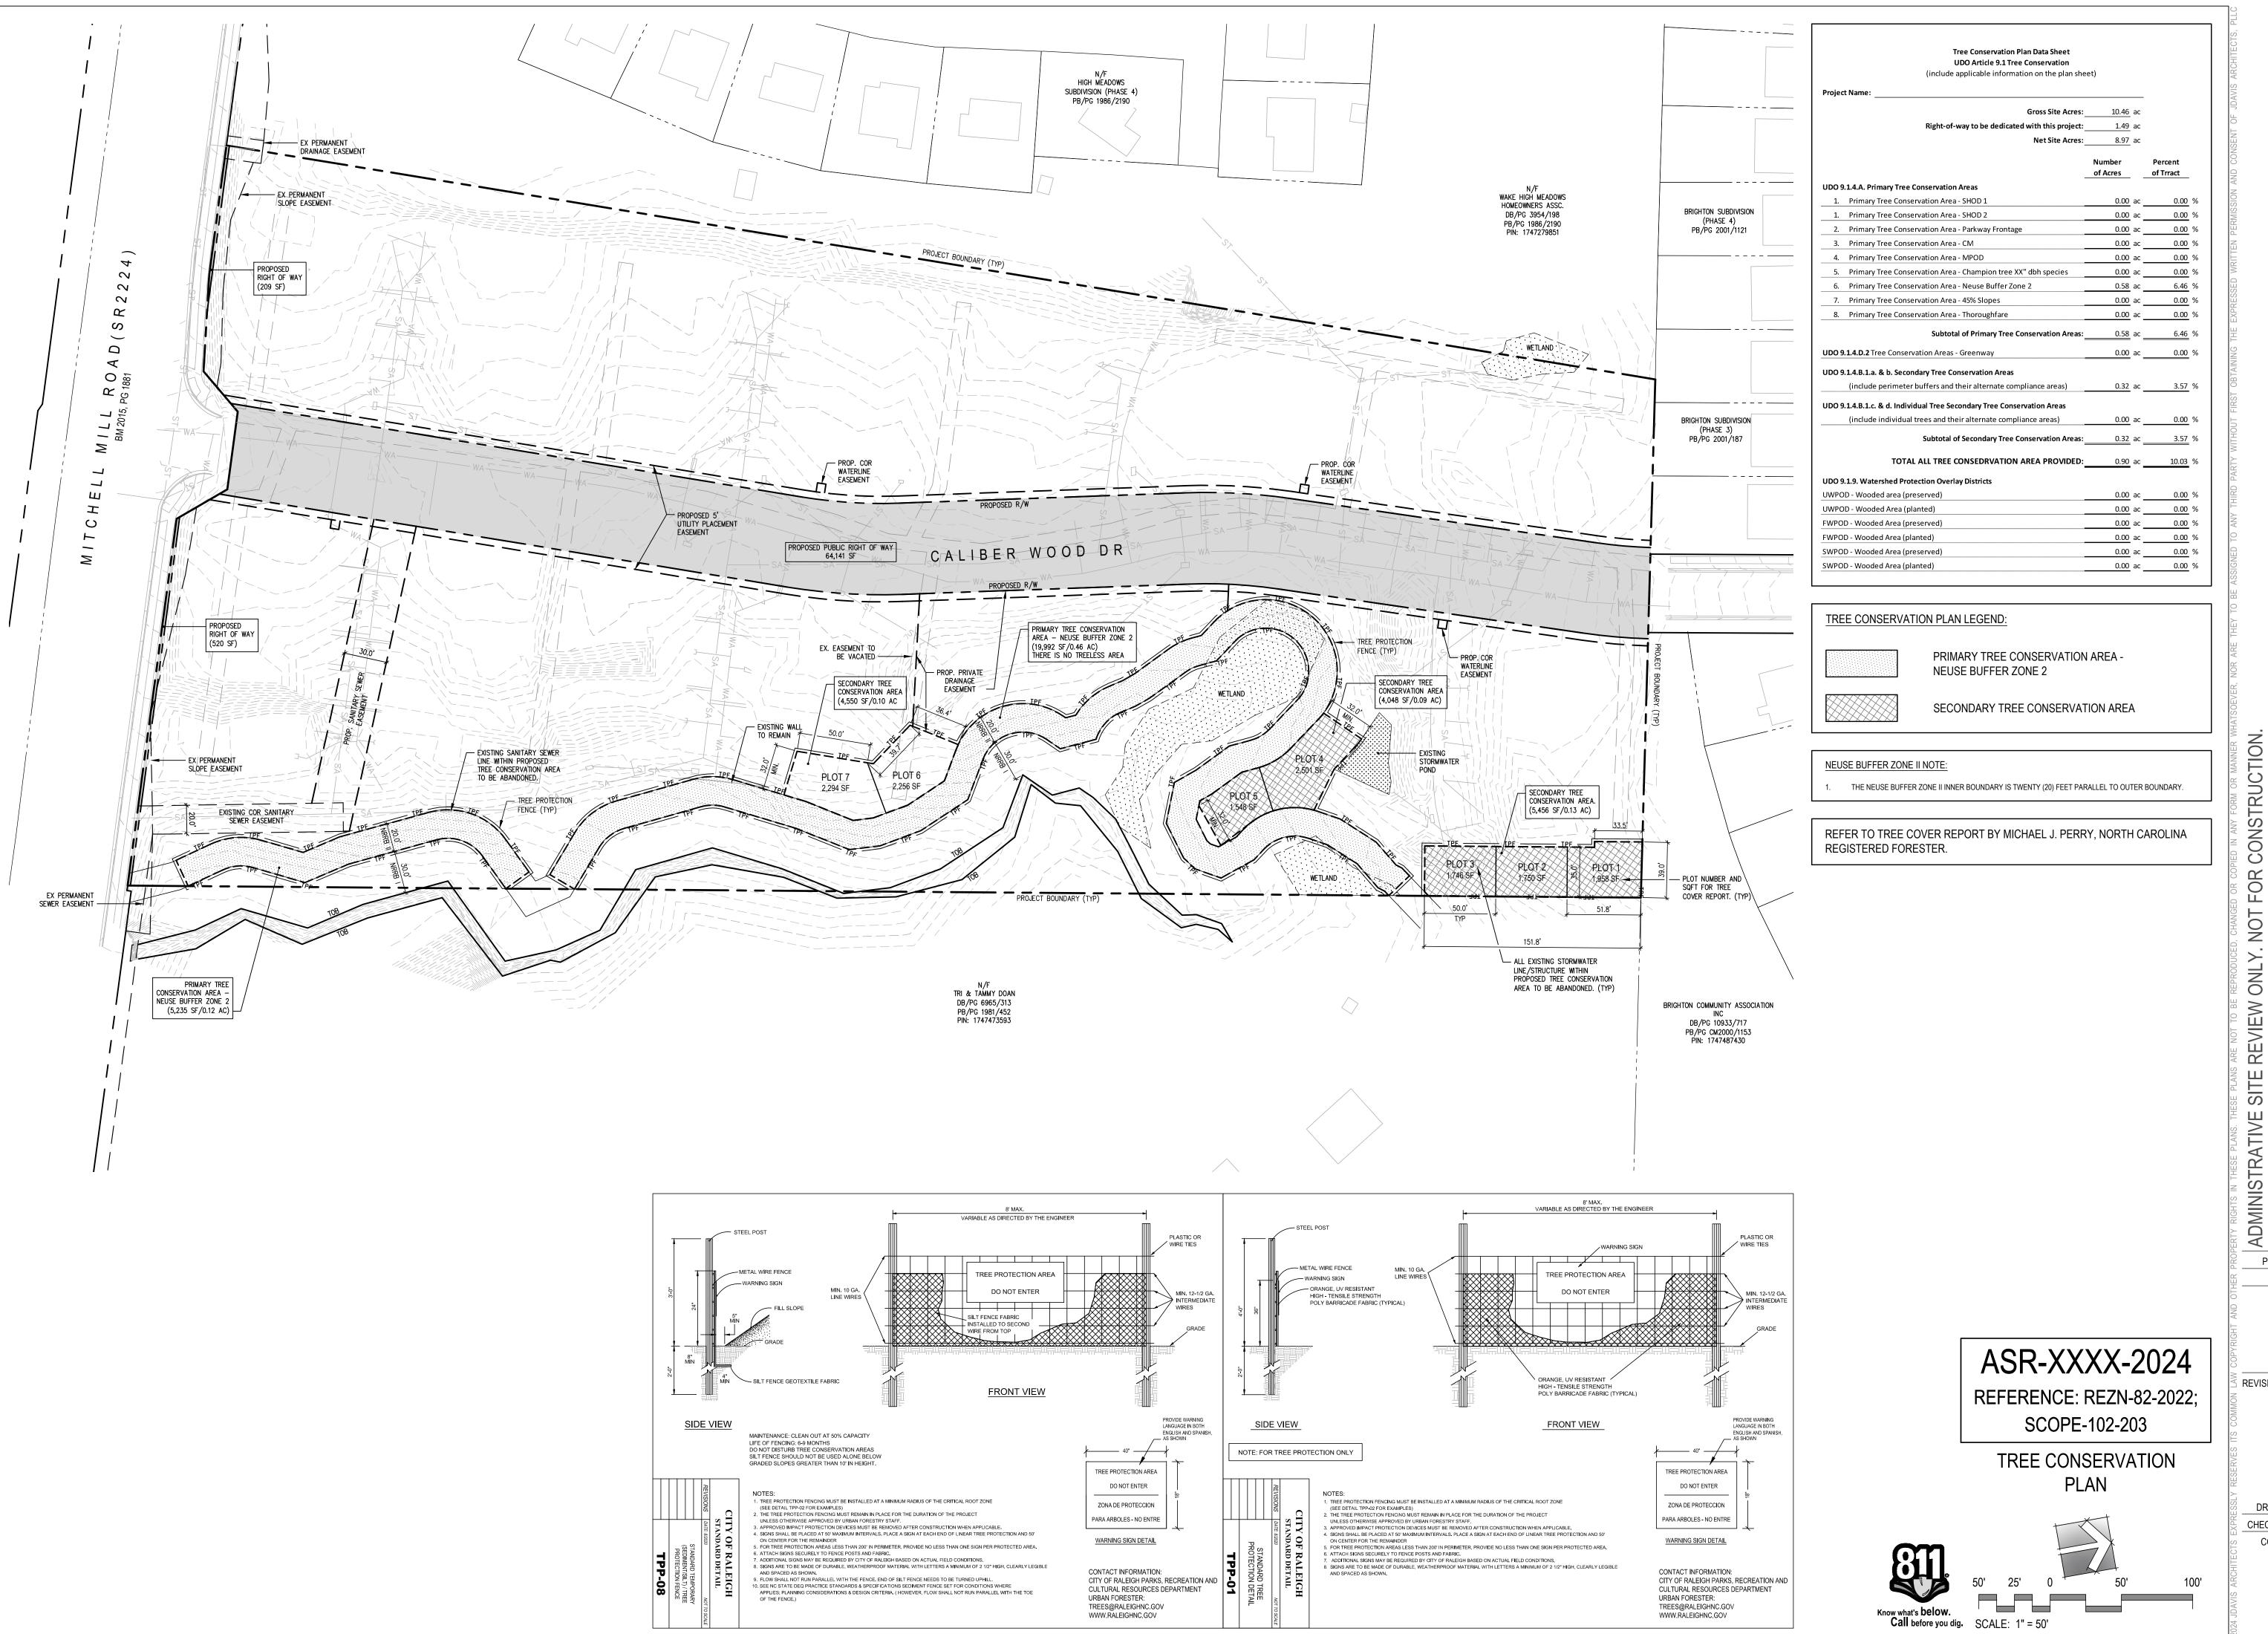PROJECT: DEWITT-23023

ISSUE: Administrative Site Review 02.21.2024 **REVISIONS**: DRAWN BY: SB CHECKED BY: KT CONTENT: TREE CONSERVATION PLAN

_1.20



(2) PC (TYP)

TYPICAL ZONE A TYPE 2 20' PROTECTIVE YARD

FIRE HYDRANT WITH 10'R CLEARANCE

- (2) PC (TYP)


SCALE: 1" = 20'

TYPICAL ZONE A TYPE 1 10' PROTECTIVE YARD

——— ——— EXISTING AND PROPOSED EASEMENT

NCDOT CLEAR ZONE FROM LARGE STREET TREE

PROPOSED PROTECTIVE YARD

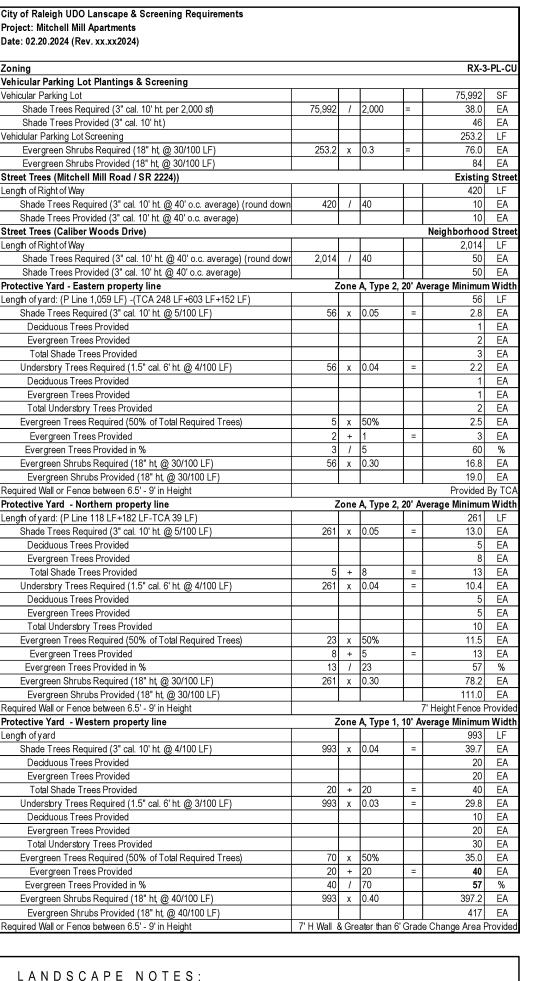



LANDSCAPE NOTES:

- CONTRACTOR TO FIFLD VERIFY LOCATION AND DEPTH OF UTILITIES PRIOR TO INSTALLATION
- THE PLAN DEPICTS REQUIRED PLANTINGS REQUIRED BY THE CITY OF RALEIGH.
- ALL PLANT MATERIAL TO COMPLY WITH AMERICAN STANDARD FOR NURSERY STOCK BY THE AMERICAN ASSOCIATION OF NURSERYMEN, INC.
- 4. ALL PLANTS TO BE COMPACT, UNIFORM AND WELL GROWN.
- 5. LOCATION OF PLANT MATERIAL TO BE REVIEWED BY LANDSCAPE ARCHITECT PRIOR TO INSTALLATION.
- ALL PLANTING BEDS ARE TO BE MULCHED TO A DEPTH OF 3 INCHES, WITH AGED TRIPLE SHREDDED HARDWOOD MULCH FROM A SINGLE SOURCE COMMERCIAL VENDOR WITH A MAXIMUM PARTICLE SIZE OF 2 INCHES, FREE OF WEED SEED AND WASTE MATERIALS. NO PINE STRAW PERMITTED. KEEP MULCH 4
- ALL LAWN AREAS TO BE SEEDED OR/AND SODDED AS PER MANUFACTURE'S SPECIFICATIONS. REFER TO LANDSCAPE PLAN(S). ALL DISTURBED AREA SHALL EITHER BE MULCH OR LAWN.
- WITHIN THE SIGHT TRIANGLES SHOWN ON THIS PLAN, THERE SHALL BE NO SIGHT OBSTRUCTING OR PARTLY OBSTRUCTING WALL, FENCE, SIGN, FOLIAGE, BERMS, OR PARKED VEHICLES BETWEEN THE HEIGHTS OF 24 INCHES AND EIGHT FEET ABOVE THE CURB LINE ELEVATION OR THE NEAREST TRAVELED WAY IF NO CURBING EXISTS.
- HVAC EQUIPMENT AND UTILITY DEVICES (TO INCLUDE, BUT NOT LIMITED TO TELEPHONE AND CABLE PEDESTALS; ELECTRICAL TRANSFORMERS; BACKFLOW-DEVICE HOTBOX; ETC) SHALL BE SCREENED FROM OFF-SITE VIEW BY EVERGREEN SHRUBS, FENCE OR WALL.
- ALL CONFLICTS BETWEEN PROPOSED LANDSCAPE, UTILITIES AND STORMWATER WILL BE RESOLVED PRIOR TO APPLICATION FOR BUILDING PERMITS. UTILITY AND STORMWATER PLANS DEPICTED IN THIS SUBMITTAL ARE PRELIMINARY AND ARE SUBJECT TO CHANGE WITH THE DEVELOPMENT OF
- STREET TREES SHALL BE INSTALLED AND MAINTAINED IN ACCORDANCE WITH THE REQUIREMENTS OF
- 13. MIN. 20' DISTANCE SHALL BE PROVIDED BETWEEN LIGHT POLES AND TREE TRUNKS.
- 14. TREES SHALL BE 30' MIN FROM STOP SIGNS AND 10' MIN FROM DRIVEWAYS AND UTILITY POLES.
- 15. TREES SHALL NOT BE IN THE CURVE TRANSITIONING FROM ONE STREET TO ANOTHER.
- 16. TREES WITHIN 20 FT. OF OVERHEAD POWER LINE(S) SHOULD BE UNDERSTORY TREES. 17. CONTRACTOR SHALL NOT PLANT TREES/SHRUBS AT ANY LOCATION WHERE THEY WILL INTERFERE WITH
- 18. A TREE IMPACT PERMIT IS REQUIRED FOR TREES INSTALLED IN THE PUBLIC RIGHT-OF-WAY PRIOR TO
- ISSUANCE OF ANY BUILDING PERMITS.
- 19. THE SITE SHALL BE STABILIZED AND SEEDED PRIOR TO THE ISSUANCE OF A CERTIFICATE OF

ASR-XXXX-2024 REFERENCE: REZN-82-2022; SCOPE-102-203

> CODE COMPLIANCE LANDSCAPE PLAN

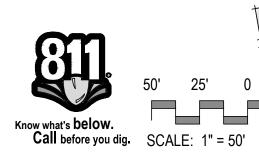

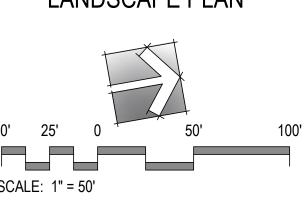

partmen **Road** 27616 Carolina North **/iitcl** Φ Dewitt C. Mitch 3805 **№** Raleigh,

FOR

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REVIEW

SITE

DMINISTRATIVE PROJECT: DEWITT-23023 DATE ISSUE: | Administrative Site Review | 02.21.2024 REVISIONS: DRAWN BY: SB CHECKED BY: KT CONTENT: CODE COMPLIANCE LANDSCAPE PLAN

THIS CHAPTER OUTLINES THE STANDARDS FOR PLANTING AND MAINTAINING TREES ON PROPERTY OWNED OR

CONTROLLED BY THE CITY OF RALEIGH.

THE PARKS, RECREATION AND CULTURAL RESOURCES DEPARTMENT IS RESPONSIBLE FOR PLAN REVIEW, INSPECTION, MONITORING AND ENFORCEMENT ASSOCIATED WITH TREE PLANTING AND MAINTENANCE ON PROPERTY OWNED OR

- CONTROLLED BY THE CITY 1. DEVELOPMENT, PRIVATE CITIZEN OR CONTRACT PLANTING ON CITY OWNED OR CONTROLLED PROPERTY BY
- ANY INDIVIDUAL OR ORGANIZATION OTHER THAN THE CITY. THESE PROJECTS ARE AT THE EXPENSE OF THE REQUESTOR AND REQUIRE A TREE IMPACT PERMIT.

THESE PROJECTS ARE AT THE EXPENSE OF THE REQUESTOR AND REQUIRE A TREE IMPACT PERMIT.

PARTNERSHIP PLANTING UNDERTAKEN BY NON-PROFIT ORGANIZATIONS, PUBLIC-PRIVATE PARTNERSHIPS, AND CIVIC GROUPS. UNLESS WORK IS DONE UNDER STRICT GUIDANCE AND OVERSIGHT BY THE URBAN FORESTER.

C. REQUESTS FOR TREE PLANTING

B. TREE PLANTING ON CITY PROPERTY

1. REQUESTS FOR TREE PLANTING AND TREE IMPACT PERMITS ARE EVALUATED IN THE ORDER IN WHICH THEY ARE

- 2. TREE PLANTING IS CONTINGENT ON THE PLANTING SEASON, AVAILABILITY OF PLANT MATERIAL, SITE
- SUITABILITY, STAFFING, AND FUNDING 3. THE URBAN FORESTER OR DESIGNEE WILL PRIORITIZE TREE PLANTING REQUESTS ACCORDING TO THE
- FOLLOWING CRITERIA:
- A. NEEDS BASED: AREAS IDENTIFIED WITH THE GREATEST TREE CANOPY DEFICITS B. PRE-IDENTIFIED LOCATIONS: AREAS EARMARKED FOR BEAUTIFICATION IMPROVEMENTS
- C. ON DEMAND: CITY DEPARTMENTS, VOLUNTEER GROUPS, NEIGHBORHOODS, CITIZENS, AND

D. TREE QUALITY STANDARDS

- 1. GENERAL: FURNISH NURSERY-GROWN PLANTS TRUE TO GENUS, SPECIES, VARIETY, CULTIVAR, STEM FORM, SHEARING, AND OTHER FEATURES INDICATED ON DRAWINGS AND COMPLYING WITH ANSI Z60.1, WITH HEALTHY ROOT SYSTEMS DEVELOPED BY TRANSPLANTING OR ROOT PRUNING AND A VISIBLE ROOT FLARE. PROVIDE WELL-SHAPED, FULLY BRANCHED, HEALTHY, VIGOROUS STOCK FREE OF DISEASE, INSECTS, EGGS, LARVAE, AND
- DEFECTS SUCH AS KNOTS, SUN SCALD, INJURIES, ABRASIONS, AND DISFIGUREMENT TREES WITH MULTIPLE LEADERS, UNLESS SPECIFIED, WILL BE REJECTED. TREES WITH DAMAGED OR CROOKED LEADERS, BARK ABRASIONS, SUNSCALD, DISFIGURING KNOTS, INSECT DAMAGE, OR CUTS ON LIMBS OVER 1/2 IN. IN DIAMETER THAT ARE NOT COMPLETELY CLOSED, OR ROOT FLARE MORE THAN 2" BELOW SURFACE OF ROOT

BALL WILL BE REJECTED

CONDITIONS.

- SPECIES SELECTION A. SELECTED TREE SPECIES SHALL BE OF A CULTIVAR THAT IS SUPERIOR IN FORM AND DISEASE RESISTANCE. PREFERENCE WILL BE GIVEN TO STREET TREES GROWN SPECIFICALLY FOR URBAN
 - B. EXOTIC INVASIVE SPECIES ARE NOT PERMITTED.
 - C. TREES TO BE INSTALLED UNDER OVERHEAD POWERLINES SHALL HAVE A MATURE HEIGHT OF NO
 - D. ALL SPECIES SELECTIONS SHALL BE REVIEWED BY THE URBAN FORESTER OR DESIGNEE.
 - E. SPECIES DIVERSITY IS ENCOURAGED TO IMPROVE OVERALL URBAN FOREST HEALTH.
 - F. ALL PLANT MATERIAL AND INSTALLATION WORK SHALL CONFORM TO THE STANDARDS DETAILED IN THIS MANUAL, THE AMERICAN NATIONAL STANDARDS FOR TREE CARE OPERATIONS, ANSI A300 AND NURSERY STOCK, ANSI Z60.1 AND APPROVED CITY STANDARD DETAILS.
- 4. ALL PLANT MATERIAL SHALL BE FREE OF ALL PESTS, DISEASES, AND CANKERS, IN HEALTHY CONDITION, AND FREE OF MECHANICAL DAMAGE AT THE TIME OF PLANTING AS DETERMINED BY URBAN FORESTRY STAFF.
- PROVIDE PLANTS OF SIZES, GRADES, AND BALL OR CONTAINER SIZES COMPLYING WITH ANSI Z60.1 FOR TYPES AND FORM OF PLANTS REQUIRED. PLANTS OF LARGER SIZE MAY BE USED IF ACCEPTABLE TO URBAN FORESTER, WITH A PROPORTIONATE INCREASE IN SIZE OF ROOTS OR BALLS.
- 6. LABEL EACH PLANT OF EACH VARIETY AND CALIPER WITH A SECURELY ATTACHED, WATERPROOF TAG BEARING LEGIBLE DESIGNATION OF BOTANICAL AND COMMON NAME. INCLUDE NOMENCLATURE FOR HYBRID, VARIETY, OR
- WHEN MORE THAN ONE PLANT OF ANY SPECIES IS PLANTED, ALL PLANT MATERIAL SHALL BE UNIFORM IN SIZE AND SHAPE WHEN POSSIBLE, ALL PLANT MATERIAL SHALL HAVE FULL FORM WITH EVEN-SPACED BRANCHING. ONE-SIDED PLANTS OR TIGHT ROW PLANTS ARE NOT ACCEPTABLE IF THE GROWTH HABIT IS ADVERSELY

8. TREE AND SHRUB MEASUREMENTS

- A. MEASURE ACCORDING TO ANSI Z60.1 WITH BRANCHES AND TRUNKS OR CANES IN THEIR NORMAL POSITION. DO NOT PRUNE TO OBTAIN REQUIRED SIZES.
- B. INSTALLATION SIZE FOR RIGHT OF WAY TREES.
- SHADE TREES SHALL BE A MINIMUM OF 3" CALIPER AND 10' TALL.
- UNDERSTORY TREES SHALL BE A MINIMUM OF 1.5" CALIPER FOR SINGLE STEM AND 6' TALL FOR BOTH SINGLE AND MULTI-STEMMED TREES.

9. BALLED AND BURLAP (B&B). CONTAINER AND BARE ROOT PLANT MATERIALS

- A. TREES DESIGNATED B&B SHALL BE PROPERLY DUG WITH FIRM, NATURAL BALLS OF SOIL WITH BALL SIZE NOT LESS THAN DIAMETER AND DEPTH RECOMMENDED BY ANSI Z60.1 FOR TYPE AND SIZE OF TREE, RETAINING AS MANY FIBROUS ROOTS AS POSSIBLE. BALLS SHALL BE FIRMLY WRAPPED WITH BIODEGRADABLE BURLAP AND SECURED WITH NAILS AS RECOMMENDED BY ANSI Z60.1.
- B. THE ROOT FLARE SHALL BE APPARENT AT THE SURFACE OF THE ROOT BALL. OR THE CONTRACTOR WILL BE RESPONSIBLE FOR REMOVING EXCESS SOIL FROM THE TOP OF THE ROOT BALL IN ORDER TO ESTABLISH THE CORRECT GRADE. TREES SHALL BE REJECTED IF THE ROOT FLARE HAS BEEN BURIED LONG ENOUGH FOR THE STEM TO SPROUT ADVENTITIOUS ROOTS. TREES WITH LOOSE, BROKEN, PROCESSED, OR MANUFACTURED ROOT BALLS WILL NOT BE ACCEPTED.
- C. CONTAINER-GROWN STOCK SHALL BE HEALTHY, VIGOROUS, WELL-ROOTED EXTERIOR PLANTS GROWN IN A CONTAINER WITH WELL-ESTABLISHED ROOT SYSTEM REACHING SIDES OF CONTAINER AND MAINTAINING A FIRM BALL WHEN REMOVED FROM CONTAINER. THE ROOT FLARE SHALL BE APPARENT AT SURFACE OF BALL. OR THE CONTRACTOR WILL BE RESPONSIBLE FOR REMOVING EXCESS SOIL FROM THE TOP OF THE ROOT BALL IN ORDER TO ESTABLISH THE CORRECT GRADE. CONTAINER SHALL BE RIGID ENOUGH TO HOLD BALL SHAPE AND PROTECT ROOT MASS DURING SHIPPING AND BE SIZED ACCORDING TO ANSI Z60.1 FOR KIND, TYPE, AND SIZE OF EXTERIOR PLANT REQUIRED.
- D. BARE ROOT MATERIAL SHALL BE GROWN IN THE GROUND IN THE NURSERY WITHOUT ARTIFICIAL ROOT RESTRICTION DEVICES, SUCH AS CONTAINERS OR FABRIC BAGS, UNDER FAVORABLE GROWING CONDITIONS AND WHICH HAVE RECEIVED THE PROPER CULTURAL TREATMENT TO DEVELOP A WELL-BRANCHED ROOT SYSTEM. AFTER HARVEST, THE SOIL IS REMOVED FROM THE ROOTS.

10. DELIVERY, STORAGE AND HANDLING

- A. DO NOT PRUNE TREES AND SHRUBS BEFORE DELIVERY. PROTECT BARK. BRANCHES. AND ROOT SYSTEMS FROM SUN SCALD. DRYING. SWEATING. WHIPPING. AND OTHER HANDLING AND TYING DAMAGE. DO NOT BEND OR BIND-TIE TREES OR SHRUBS IN SUCH A MANNER AS TO DESTROY THEIR NATURAL SHAPE. PROVIDE PROTECTIVE COVERING OF EXTERIOR PLANTS DURING DELIVERY. DO NOT DROP EXTERIOR PLANTS DURING DELIVERY.
- B. HANDLE PLANTING STOCK BY ROOT BALL. HEAVIER MATERIAL SHALL BE HANDLED WITH STRAPS ON THE ROOT BALL AND APPROPRIATE EQUIPMENT SUCH AS A SMALL SKID STEER LOADER.
- C. DELIVER BARE-ROOT STOCK PLANTS FRESHLY DUG. IMMEDIATELY AFTER DIGGING UP BARE-ROOT STOCK, PACK ROOT SYSTEM IN WET STRAW, HAY, OR OTHER SUITABLE MATERIAL TO KEEP ROOT SYSTEM MOIST UNTIL PLANTING.

D. DELIVER EXTERIOR PLANTS AFTER PREPARATIONS FOR PLANTING HAVE BEEN COMPLETED AND

- INSTALL IMMEDIATELY. IF PLANTING IS DELAYED MORE THAN SIX HOURS AFTER DELIVERY, SET EXTERIOR PLANTS IN THEIR APPROPRIATE ASPECT (SUN, FILTERED SUN, OR SHADE), PROTECT FROM WEATHER AND MECHANICAL DAMAGE, AND KEEP ROOTS MOIST.
- SET BALLED STOCK ON GROUND AND COVER BALL WITH SOIL, PEAT MOSS, SAWDUST, OR OTHER ACCEPTABLE MATERIAL.
- WATER ROOT SYSTEMS OF EXTERIOR PLANTS STORED ON-SITE WITH A FINE-MIST SPRAY.
- WATER AS OFTEN AS NECESSARY TO MAINTAIN ROOT SYSTEMS IN A MOIST, BUT NOT OVERLY-WET CONDITION

HEEL-IN BARE-ROOT STOCK. SOAK ROOTS THAT ARE IN DRY CONDITION IN WATER FOR TWO

DO NOT REMOVE CONTAINER-GROWN STOCK FROM CONTAINERS BEFORE TIME OF PLANTING.

HOURS. REJECT DRIED-OUT PLANTS

NURSERY

- A. PLANTS SHALL BE GROWN WITHIN ONE COLD HARDINESS ZONE OF THE PROJECT SITE.
- B. PROVIDE DIGITAL PHOTOS FROM THE NURSERY WITH HEIGHT IDENTIFIED FOR REVIEW BY THE URBAN FORESTER OR DESIGNEE PRIOR TO DIGGING OR SHIPPING. ALL TREES SHALL ALSO BE REVIEWED AND APPROVED PRIOR TO INSTALLATION EITHER AT PLACE OF PURCHASE, NURSERY, HOLDING YARD OR WORK SITE BY THE URBAN FORESTER OR DESIGNEE.

12. OBSERVATION AND REJECTION

A. URBAN FORESTER OR DESIGNEE MAY OBSERVE TREES AT PLACE OF PURCHASE, NURSERY HOLDING YARD, OR AT SITE BEFORE PLANTING FOR COMPLIANCE WITH REQUIREMENTS FOR GENUS, SPECIES, VARIETY, SIZE, AND QUALITY. URBAN FORESTER RETAINS RIGHT TO OBSERVE TREES FURTHER FOR SIZE AND CONDITION OF BALLS AND ROOT SYSTEMS, INSECTS, INJURIES, AND LATENT DEFECTS AND TO REJECT UNSATISFACTORY OR DEFECTIVE MATERIAL AT ANY TIME DURING PROGRESS OF WORK. REMOVE REJECTED TREES IMMEDIATELY FROM PROJECT SITE.

- A. REQUESTS FOR SUBSTITUTION FOR THE LISTED PLANT MATERIAL MUST BE MADE TO THE URBAN FORESTER IN WRITING. THE REQUEST SHALL INCLUDE A MINIMUM OF 5 NURSERIES ATTEMPTED FOR LOCATION AND CONTACT INFORMATION. SUBSTITUTIONS WILL BE CONSIDERED IF THE LISTED MATERIAL CANNOT BE LOCATED OR CONFIRMED BY KNOWN SUPPLIERS. PLANT SUPPLIERS MUST BE RESEARCHED AND LOCATED PRIOR TO SUBMITTAL. IF PLANT MATERIAL SUBSTITUTIONS ARE TO BE MADE AFTER AWARD OF THE CONTRACT OR PERMIT, THE SUBSTITUTION MUST BE OF SIMILAR GROWTH HABIT, FORM, AND CHARACTERISTICS; SIMILAR IN SPECIFIED SIZE; AND EQUAL IN PRICE AND SUBJECT TO APPROVAL OR REJECTION BY THE URBAN FORESTER.
- B. IF FOR ANY REASON TREES CANNOT BE INSTALLED ACCORDING TO THE PLANS A REQUEST SHALL BE MADE TO THE URBAN FORESTER IN WRITING. THE CONTRACTOR SHALL INFORM THE CITY AND ALTERNATE PLANTING LOCATIONS SHALL BE SELECTED FOR APPROVAL BY THE URBAN FORESTER.

- 1. PLEASE REFER TO CITY OF RALEIGH STANDARD DETAILS LOCATED AT RALEIGHNC.GOV
- 2. LINEAR SPACING AND LOCATION
 - A. TREES WILL BE PLANTED IN ACCORDANCE WITH SPACING REQUIREMENTS DETAILED IN THE UNIFIED DEVELOPMENT ORDINANCE UNLESS OTHERWISE DIRECTED BY THE URBAN FORESTER OR DESIGNEE
 - B. TREES TO BE INSTALLED UNDER OVERHEAD UTILITY LINES SHALL HAVE A MATURE HEIGHT OF NO GREATER THAN 30FT.

C. GROUPED PLANTINGS

 GROUPING TREES WHEREVER POSSIBLE AND DESIGNING TREE PITS OR MULCH AREAS THAT ALLOW SHARED ROOT SPACE PROVIDES A NUMBER OF BENEFITS TO THE HEALTH AND LONGEVITY OF URBAN TREES. DESIGNS THAT GROUP TREES ARE FAVORED OVER INDIVIDUAL PLANTINGS

A. TREE AND SHRUB EXCAVATION

- PLANTING HOLE: EXCAVATE CIRCULAR PITS WITH SIDES SLOPED INWARD. TRIM BASE LEAVING CENTER AREA RAISED SLIGHTLY TO SUPPORT ROOT BALL AND ASSIST IN DRAINAGE. DO NOT FURTHER DISTURB BASE. SCARIFY SIDES OF PLANT PIT SMEARED OR SMOOTHED DURING
- EXCAVATE APPROXIMATELY THREE TIMES AS WIDE AS BALL DIAMETER FOR ALL PLANT
- PLANTING HOLES SHALL BE NO DEEPER THAN THE ROOT FLARE OF THE TREE OR PLANT WHICH SHALL BE INSTALLED AT GRADE, A MAXIMUM OF 2 INCHES ABOVE GRADE, AND NEVER BELOW
- SOIL REMOVED FROM EXCAVATIONS MAY BE USED AS BACKFILL PROVIDED IT MEETS THE SPECIFIED PLANTING SOIL MIX REQUIREMENTS.
- OBSTRUCTIONS: NOTIFY URBAN FORESTER IF UNEXPECTED ROCK OR OBSTRUCTIONS DETRIMENTAL TO TREES OR SHRUBS ARE ENCOUNTERED IN EXCAVATIONS.
- DRAINAGE: PLANTING HOLES NOT ASSOCIATED WITH A DRAIN SYSTEM SHALL DRAIN FULLY WITHIN A 12-HOURPERIOD. NOTIFY URBAN FORESTER IF SUBSOIL CONDITIONS EVIDENCE UNEXPECTED WATER SEEPAGE OR RETENTION IN TREE OR SHRUB PITS.

B. TREE AND SHRUB PLANTING

- a. SET BALLED AND BURLAPPED STOCK PLUMB AND IN CENTER OF PIT OR TRENCH WITH ROOT FLARE AT GRADE. A MAXIMUM OF 2 INCHES ABOVE ADJACENT FINISH GRADES. AND NEVER BELOW GRADE. DO NOT MANEUVER BY TRUNK. HANDLE BY ROOT BALL
- b. REMOVE BURLAP AND WIRE BASKETS FROM THE TOP ½ OF ROOT BALL, CUT OFF AND DISCARD FROM HOLE, BUT DO NOT REMOVE FROM UNDER ROOT BALLS. REMOVE PALLETS, IF ANY, BEFORE SETTING. DO NOT USE PLANTING STOCK IF ROOT BALL IS CRACKED OR BROKEN BEFORE OR DURING PLANTING OPERATION
- c. PLACE PLANTING SOIL MIX AROUND ROOT BALL IN LAYERS, TAMPING GENTLY TO SETTLE MIX AND ELIMINATE VOIDS AND AIR POCKETS. WHEN PIT IS APPROXIMATELY ONE-HALF BACKFILLED, WATER THOROUGHLY BEFORE PLACING REMAINDER OF BACKFILL. PLACING AND TAMPING FINAL LAYER OF PLANTING SOIL MIX.

CONTAINER

- a. SET CONTAINER-GROWN STOCK PLUMB AND IN CENTER OF PIT OR TRENCH WITH ROOT FLARE AT GRADE, A MAXIMUM OF 2 INCHES ABOVE ADJACENT FINISH GRADES, AND NEVER BELOW GRADE. DO NOT MANEUVER BY TRUNK. HANDLE BY ROOT BALL ONLY.
- b. CAREFULLY REMOVE ROOT BALL FROM CONTAINER WITHOUT DAMAGING ROOT BALL OR PLANT. GENTLY LOOSEN THE ROOTS AND CUT ANY GIRDLING ROOTS IN AT LEAST TWO
- c. PLACE PLANTING SOIL MIX AROUND ROOT BALL IN LAYERS, TAMPING TO SETTLE MIX AND ELIMINATE VOIDS AND AIR POCKETS. WHEN PIT IS APPROXIMATELY ONE-HALF BACKFILLED, WATER THOROUGHLY BEFORE PLACING REMAINDER OF BACKFILL. REPEAT WATERING UNTIL NO MORE WATER IS ABSORBED. WATER AGAIN AFTER PLACING AND TAMPING FINAL LAYER OF PLANTING SOIL MIX.

BARE ROOT

a. FOLLOW THE METHOD FOR CONTAINER PLANTING. STAKING REQUIRED.

C. TREES IN SIDEWALKS, PITS, GRATES AND TREE LAWNS

- TREE GRATES
- a. 4' X 6' GRAY IRON, ADA COMPLIANT
- b. TREE GRATES SHALL HAVE A PROVISION FOR TRUNK EXPANSION OF THE TREE. SUCH AS POP OUT CONCENTRIC RINGS IN THE GRATE AROUND THE TRUNK.
- c. NO UTILITIES OR ELECTRICAL CONDUITS ARE PERMITTED WITHIN THE TREE PIT OR GRATE. UTILITIES MAY RUN BELOW AND THROUGH THE SUBSURFACE ROOT EXPANSION
- TREES SHALL BE CENTERED IN THE PIT
- TREE PITS SHALL ACCOMMODATE A DEPTH OF 3' OF PLANTING SOIL.
- HIGH QUALITY PLANTING SOIL SHALL BE USED IN THE PIT DIRECTLY BELOW THE GRATE
- DRAINAGE SHALL BE PROVIDED.
- D. TREE LAWN MINIMUM 6 FEET WIDE TREE LAWN.
 - TREE CENTERED IN AREA.
 - 600 CUBIC FEET OF HIGH-QUALITY PLANTING SOIL IN THE IMMEDIATE AREA WHERE TREE IS TO BE PLACED.

E. REQUIRED SUBSURFACE ROOT EXPANSION

- HIGH-QUALITY PLANTING SOIL OR STRUCTURAL SOIL SHALL BE USED TO ACCOMPLISH THE
- 600 CUBIC FEET OF SUBSURFACE ROOT EXPANSION AREA REQUIRED PER TREE.
- a. STRUCTURAL SOIL
- b. SUBSURFACE SOIL CONTAINMENT STRUCTURE
- c. ROOT PATHWAYS
- MAY ONLY BE USED IN COMBINATION WITH OTHER OPTIONS OR IN CASES WHERE CONNECTIONS TO AVAILABLE SOIL SPACE ACHIEVES THE 600 CUBIC FEET REQUIREMENT
- 20-FOOT MINIMUM EXTENSION FOR EACH PATH. CONNECT TO ADJACENT ROOT PATHS WHEN POSSIBLE. WHEN ROOT EXPANSION PATHS EXTEND UNDER THE SIDEWALK ENSURE
- MINIMUM DENSITY REQUIREMENTS ARE MET.
- d. SUSPENDED PAVEMENT

e. EXCEPTIONS AND DESIGN ALTERNATIVES ARE ENCOURAGED TO ACHIEVE SOIL VOLUME: G. TREE PROTECTION URBAN FORESTER REVIEW REQUIRED.DESIGNS THAT GROUP TREES AND CONNECT ROOT SPACES WILL BE FAVORED AS WELL AS THE INTRODUCTION OF LID MATERIALS

AND TECHNOLOGY.

- APPLY 3 INCH AVERAGE THICKNESS OF ORGANIC MULCH EXTENDING 12 INCHES BEYOND EDGE OF PLANTING PIT OR TRENCH. DO NOT PLACE MULCH WITHIN 3 INCHES OF TRUNKS OR STEMS. ROOT FLARE SHALL BE VISIBLE AT BASE OF ALL PLANT MATERIAL.
- MULCH SHALL BE THE RESPONSIBILITY OF THE ADJACENT PROPERTY OWNER TO REFRESH AS NEEDED AND KEEP FREE OF DEBRIS AND TRASH.

- BACKFILL DIRECTLY IN TREE PIT OR PLANTING AREA SHALL BE HIGH-QUALITY PLANTING SOIL SUITABLE FOR SUCCESSFUL GROWTH.
- IF SOIL ON SITE IS SUITABLE IT MAY BE MIXED AT A RATE OF 50% WITH HIGH-QUALITY PLANTING
- SOIL MUST BE FREE OF SUBSOIL, HARD CLODS, STONE, RESIDUES OR UNDESIRABLE MATERIALS, STICKS, WEED SEED AND UNIFORM IN QUALITY.
- THE URBAN FORESTER OR DESIGNEE MAY REJECT UNSUITABLE SOIL.

H. GUYING AND STAKING

- DO NOT STAKE UNLESS THE TREE BECOMES UNSTABLE OR IT IS A HIGH WIND AREA.
- REMOVE ALL STAKING MATERIAL AFTER 1 YEAR.
- LEAVE SLIGHT SLACK IN TIE TO PROMOTE TRUNK TAPER.
- UPRIGHT STAKING AND TYING: WHEN REQUIRED USE A MINIMUM OF 3 STAKES. SET VERTICAL STAKES AND SPACE TO AVOID PENETRATING ROOT BALLS OR ROOT MASSES. SUPPORT TREES WITH TWO STRANDS OF TIE WIRE ENCASED IN HOSE SECTIONS OR ARBORIST TAPE AT CONTACT POINTS WITH TREE TRUNK. ALLOW ENOUGH SLACK TO AVOID RIGID RESTRAINT OF TREE. SPACE STAKES EQUALLY AROUND TREES AND ATTACH FLAGS TO EACH GUY WIRE FOR

F. MAINTENANCE AND WARRANTY STANDARDS

A TREE IMPACT PERMIT IS REQUIRED FOR MAINTENANCE ACTIVITIES

IT IS THE ADJACENT PROPERTY OWNER'S RESPONSIBILITY TO MAINTAIN THE MULCH RING OR TREE GRATE AROUND TREES IN THE RIGHT OF WAY AND PREVENT STRING TRIMMER OR MOWER DAMAGE.

A 2-YEAR WARRANTY AND MAINTENANCE PERIOD IS REQUIRED AFTER THE FINAL INSPECTION OF PERMITTED PLANTING.

TREE AND PLANT MAINTENANCE A. MAINTAIN PLANTINGS BY PRUNING, CULTIVATING, WATERING, WEEDING, FERTILIZING, MULCHING, RESTORING PLANTING SAUCERS, ADJUSTING AND REPAIRING TREE-STABILIZATION DEVICES, RESETTING TO PROPER GRADES OR VERTICAL POSITION, AND PERFORMING OTHER OPERATIONS AS REQUIRED TO ESTABLISH HEALTHY, VIABLE PLANTINGS. SPRAY OR TREAT AS REQUIRED TO KEEP PLANTS FREE OF INSECTS AND DISEASE.

- B. FILL IN AS NECESSARY SOIL SUBSIDENCE THAT MAY OCCUR BECAUSE OF SETTLING, RUTTING OR DAMAGE BY EQUIPMENT OR OTHER PROCESSES. REPLACE MULCH MATERIALS DAMAGED OR LOST IN
- APPLY TREATMENTS AS REQUIRED TO KEEP PLANT MATERIALS, PLANTED AREAS AND SOILS FREE OF PESTS AND PATHOGENS OR DISEASE. USE INTEGRATED PEST MANAGEMENT PRACTICES WHENEVER POSSIBLE TO MINIMIZE THE USE OF PESTICIDES AND REDUCE HAZARDS. TREATMENTS INCLUDE PHYSICAL CONTROLS SUCH AS HOSING OFF FOLIAGE, MECHANICAL CONTROLS SUCH AS TRAPS, AND BIOLOGICAL CONTROL AGENTS.

2. WATERING INSTRUCTIONS

- A. PROVIDE AND MAINTAIN TEMPORARY PIPING, HOSES, AND WATERING EQUIPMENT TO CONVEY WATER
- B. SCHEDULE WATERING TO COMPLY WITH THE CITY OF RALEIGH WATER CONSERVATION ORDINANCE. WATERING VOLUMES SHOULD BE BASED UPON DELIVERY OF INCH OF MOISTURE PER WEEK TO THE PLANT IF PRECIPITATION DOES NOT MEET THAT AMOUNT DURING THE ACTIVE GROWING SEASON
- DEFINED AS APRIL 1 THROUGH NOVEMBER 1 D. SUPPLEMENTAL WATER SHALL BE APPLIED DURING THE ESTABLISHMENT PERIOD AS FREQUENTLY AS 3 TIMES PER WEEK AND DURING PERIODS OF DROUGHT OR EXCESSIVE HEAT.
- E. USE A SLOW FLOW HOSE END DEVICE AND WATER EACH TREE AT THE BASE FOR SEVERAL MINUTES. COMMERCIALLY AVAILABLE WATER BAGS ARE ACCEPTABLE. AT EACH VISIT MAKE SURE THE BAG IS EMPTY, THOROUGHLY SOAK THE ROOT BALL, THEN REFILL THE BAG CHECKING THE EMITTERS ALLOW FREE FLOW OF WATER TO ENSURE THE BAG WILL DRAIN. ALL WATERING BAGS SHALL BE REMOVED

FROM TREES STARTING NOVEMBER 1 UNTIL APRIL 1 OF FOLLOWING YEAR.

- MAINTAIN A 3-INCH AVERAGE THICKNESS OF ORGANIC MULCH EXTENDING 12 INCHES BEYOND EDGE OF PLANTING PIT OR TRENCH. TYPICAL MATERIAL IS SHREDDED HARDWOOD, PINE BARK, WOOD CHIPS OR PINE STRAW (NOT PERMITTED WITHIN 10' OF STRUCTURES).
- B. MULCH TO THE DRIP LINE OF MATURE TREES.
- C. DO NOT PLACE MULCH WITHIN 3 INCHES OF TRUNKS OR STEMS. ROOT FLARE SHALL BE VISIBLE AT BASE OF ALL PLANT MATERIAL. D. KEEP MULCH FREE OF WEEDS, TRASH AND DEBRIS

IMPROVES SOIL QUALITY, MOISTURE AND TEMPERATURE EXCHANGE, AESTHETICS AND OVERALL HEALTH AND LONGEVITY OF THE URBAN TREE

PESTICIDE AND HERBICIDE APPLICATION

A. TREE GRATE MAINTENANCE IS THE RESPONSIBILITY OF THE ADJACENT PROPERTY OWNER. MAINTAIN

THE MULCH RING PREVENTS STRING TRIMMER, MOWER AND OTHER MECHANICAL DAMAGE. IT ALSO

- GRATES FREE OF WEEDS TRASH AND DEBRIS B. REPLENISH GRAVEL AS NEEDED TO MAINTAIN AN EVEN SURFACE. GRAVEL SHALL MATCH EXISTING MATERIAL; TYPICALLY GRAY PEA GRAVEL/#67 WASHED STONE GRAVEL.
- C. NOTIFY URBAN FORESTER IF THE TREE GRATE IS GIRDLING TREE OR CAUSING DAMAGE TO TREE.

- APPLY PESTICIDES AND OTHER CHEMICALS AND BIOLOGICAL CONTROL AGENTS IN ACCORDANCE WITH REQUIREMENTS OF AUTHORITIES HAVING JURISDICTION AND MANUFACTURER'S WRITTEN RECOMMENDATIONS. COORDINATE APPLICATIONS WITH CITY OPERATIONS AND OTHERS IN PROXIMITY TO THE WORK, NOTIFY URBAN FORESTER BEFORE EACH APPLICATION IS PERFORMED OR AS SPECIFIED
- B. PRE-EMERGENT HERBICIDE: APPLY TO TREE, SHRUB AND GROUND-COVER AREAS IN ACCORDANCE
- WITH MANUFACTURER'S WRITTEN RECOMMENDATIONS. DO NOT APPLY TO SEEDED AREAS. POST-EMERGENT HERBICIDE: APPLY ONLY AS NECESSARY TO TREAT ALREADY-GERMINATED WEEDS AND IN ACCORDANCE WITH MANUFACTURER'S WRITTEN RECOMMENDATIONS.

- A. ALL TREE PRUNING SHALL BE DONE BY OR UNDER THE SUPERVISION OF AN ISA CERTIFIED ARBORIST
- B. ANSI A-300 PRUNING STANDARDS SHALL APPLY (CHAPTER 6)

DRAPE WITH WET BURLAP

8. TREE REPLACEMENT OF WARRANTIED TREES

DESIGNEE

- A. AREA FOR ROOT PRUNING MUST BE APPROVED BY AN ISA CERTIFIED ARBORIST TO PREVENT A
- HAZARDOUS TREE CONDITION (CHAPTER 6) B. ACCEPTABLE METHODS OF CUTTING ARE BY SHARP HAND PRUNERS, LOPPERS, HAND SAW OR
- HYDRAULIC TOOLS. IMPLEMENT MUST LEAVE A CLEAN CUT. C. IF EXCAVATION CAUSES PRUNED ROOTS OVER 1.5" IN DIAMETER TO REMAIN EXPOSED FOR MORE THAN 24 HOURS, ROOTS ON TREE SIDE SHALL BE KEPT MOIST. BACKFILL WITH TOPSOIL, MOIST MULCH, OR
- D. WHERE CONCRETE IS POURED ADJACENT TO PRUNED ROOTS HEAVY DUTY PLASTIC SHALL BE INSTALLED AGAINST THE TREE SIDE OF THE PRUNED ROOTS TO PREVENT UPTAKE (TOXIC TO TREE)

RAPID DECLINE, ARE INFESTED BY INSECTS OR DISEASE, HAVE LOST THE NATURAL SHAPE DUE TO DEAD BRANCHES. EXCESSIVE PRUNING INCLUDING VANDALISM. INADEQUATE OR IMPROPER MAINTENANCE, OR ARE FAILING DUE TO OTHER CAUSES.

B. REPLACEMENT TREES INSTALLED AFTER THE 1ST YEAR OF A 2-YEAR WARRANTY/MAINTENANCE PERIOD

A. TREES SHALL BE REPLACED IN THE NEXT PLANTING SEASON IF THEY ARE MORE THAN 25% DEAD, IN

SHALL GET A FULL 1 YEAR OF WARRANTY/MAINTENANCE FROM THE TIME OF PLANTING C. DEAD, DYING, DISEASED OR VANDALIZED TREES THAT ARE DESTROYED SHALL BE REMOVED WITHIN 15

D. REPLACEMENT TREE SPECIES MAY BE CHANGED WITH APPROVAL FROM URBAN FORESTER OR


A TREE PROTECTION PLAN IS REQUIRED FOR ANY ACTIVITY IMPACTING CITY TREES INTENDED TO REMAIN.

TREE PROTECTION PLAN

- A. SUBMIT PROJECT PLANS SHOWING TREE PROTECTION WITH THE TREE IMPACT PERMIT REQUEST.
- B. TREE PROTECTION PLAN SHALL INCLUDE ALL THAT APPLY
- EXISTING TREES ON SITE
- CRITICAL ROOT ZONES OF PROTECTED TREES
- TREE PROTECTION FENCING DELINEATION AND SPECIFICATION
- OTHER PRODUCTS FOR PROTECTION (MULCH/MATTING/ETC.)
- REMEDIATION 2. TREE PROTECTION FENCING SHALL BE INSTALLED AT A MINIMUM RADIUS OF THE CRITICAL ROOT ZONE (CRZ) OF
- TREES (CRZ DEFINED AS RADIUS 1.25' FEET PER CALIPER INCH AT DBH FROM TRUNK OF TREE).
- 3. TREE PROTECTION SIGNAGE REQUIRED EVERY 50 FEET.
- 4. IF CONSTRUCTION OCCURS WITHIN THE CRZ AT LEAST 12" OF MULCH SHALL BE PLACED AND/OR LOGGING MATS WHERE MACHINERY MANEUVERS TO REDUCE SOIL COMPACTION IN THIS ZONE AND IDENTIFY ON PLAN.
- 5. THE TREE PROTECTION FENCING SHALL NOT BE VIOLATED FOR THE DURATION OF THE PROJECT WITHOUT APPROVAL FROM URBAN FORESTRY STAFF.
- 7. REMEDIATION INCLUDES BUT IS NOT LIMITED TO REPLACEMENT, PRUNING, SUPPLEMENTAL WATER, MULCH NUTRITION (FERTILIZER, ORGANIC MATTER, ETC.), INSECT/DISEASE CONTROL, STAKING AND COMPACTION

6. THERE WILL BE ZERO TOLERANCE FOR STORING OR PARKING VEHICLES, SUPPLIES, OR EQUIPMENT UNDER

8. AFTER CONSTRUCTION OR IMPACT PROTECTION DEVICES SHALL BE REMOVED. MULCH OR OTHER MATERIALS USED FOR A ROOT BUFFER SHALL BE REMOVED BY HAND WITHIN THE CRITICAL ROOT ZONE. IT MAY BE REMOVED MECHANICALLY BEYOND THIS ZONE. THERE SHALL BE 3" OF MULCH LEFT ON SITE AS DESCRIBED IN SECTION F.3 OF THIS CHAPTER.

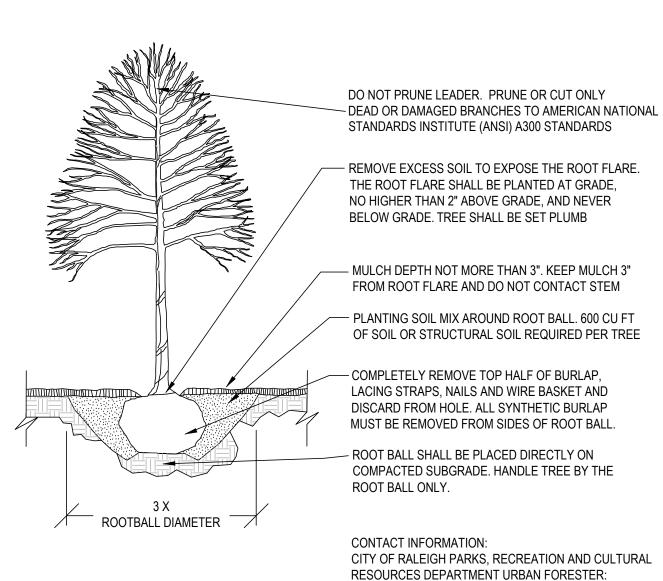

TREES@RALEIGHNC.GOV WWW.RALEIGHNC.GOV

- TREES MUST MEET THE TREE QUALITY STANDARDS IN CH. 2 OF THE CITY TREE MANUAL.
- 2. CONTRACTOR IS RESPONSIBLE FOR ADEQUATE DRAINAGE OF ALL PLANTING PITS. (POSITIVE DRAINAGE AWAY FROM PIT)
- 3. TREES SHALL BE PLANTED BETWEEN OCTOBER 1ST AND APRIL 30TH.

5. ELECTRICAL OUTLETS AND OTHER UTILITIES

4. A TREE IMPACT PERMIT IS REQUIRED.

ARE PROHIBITED IN THE PLANTING AREA IMMEDIATELY SURROUNDING THE TREE. 6. IF STAKING IN ACCORDANCE WITH THE CITY

TREE MANUAL, THE STAKING MUST BE REMOVED

WITHIN ONE YEAR. 7. TREES WILL HAVE A MINIMUM 1 YEAR WARRANTY

AFTER THE INITIAL PLANTING IS APPROVED BY THE CITY.


CITY OF RALEIGH STANDARD DETAIL REVISIONS DATE: 8/2020 NOT TO SCALE 10/2019 TREE PLANTING DETAIL TPP-03

NOTE: DETAIL TPP-03 IS FOR STREET TREE PLANTINGS. SEE DETAIL # 5 SHEET L9.11 FOR ALL OTHER TREES ON SITE

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PROJECT: DEWITT-23023 DATE ISSUE: | Administrative Site Review | 02.21.2024 REVISIONS: DRAWN BY: SB CHECKED BY: KT CONTENT: CITY OF RALEIGH STANDARD


CITY OF RALEIGH STANDARD DETAILS AND NOTES FOR CITY TREES



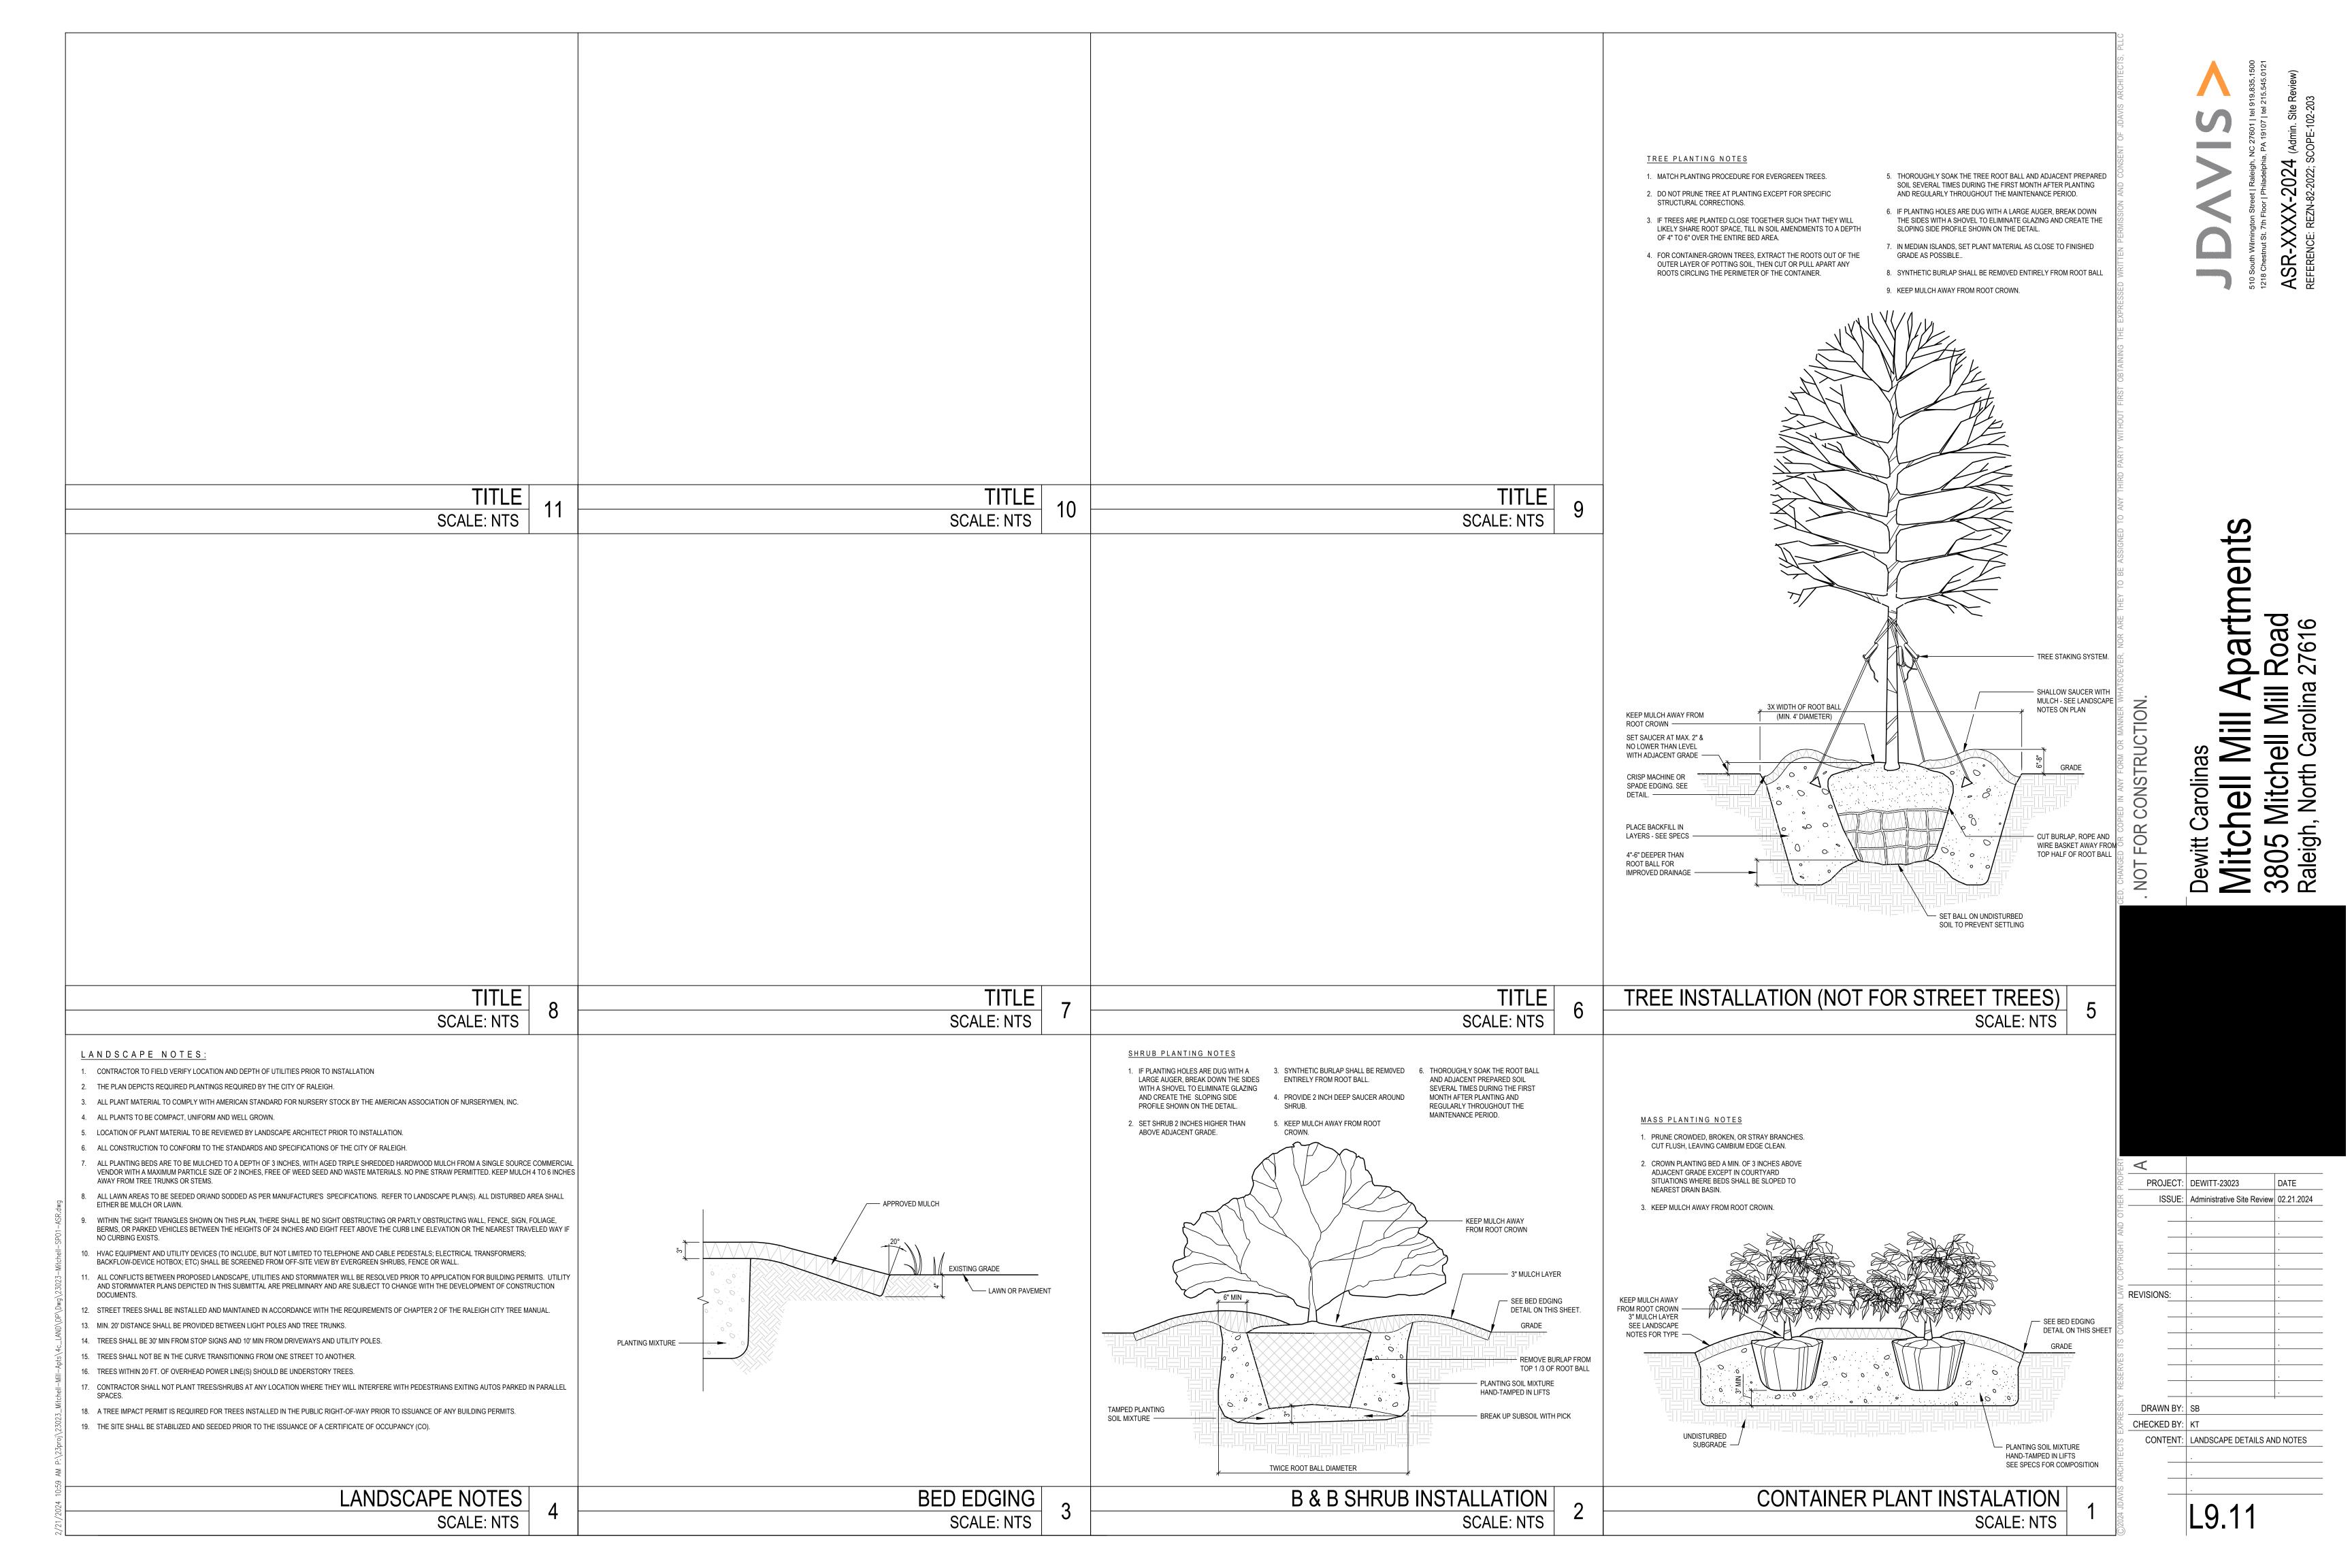

FRONT ELEVATION



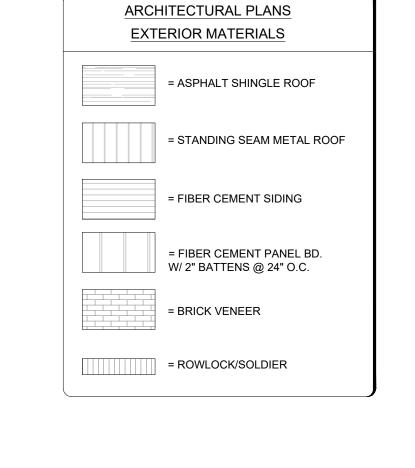

SIDE ELEVATION





BUILDING TYPE 1

Scale: 1/8" = 1'-0"








FRONT ELEVATION



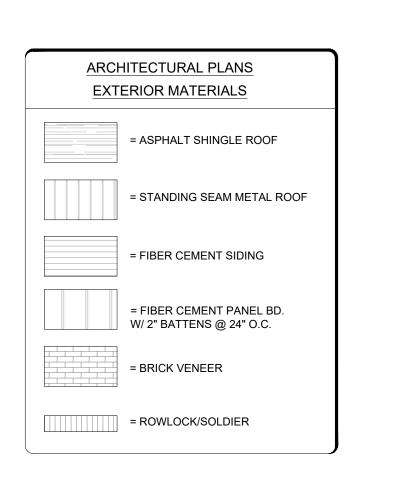





BUILDING TYPE 2

Scale: 1/8" = 1'-0"







FRONT ELEVATION










BUILDING TYPE 3

Scale: 1/8" = 1'-0"






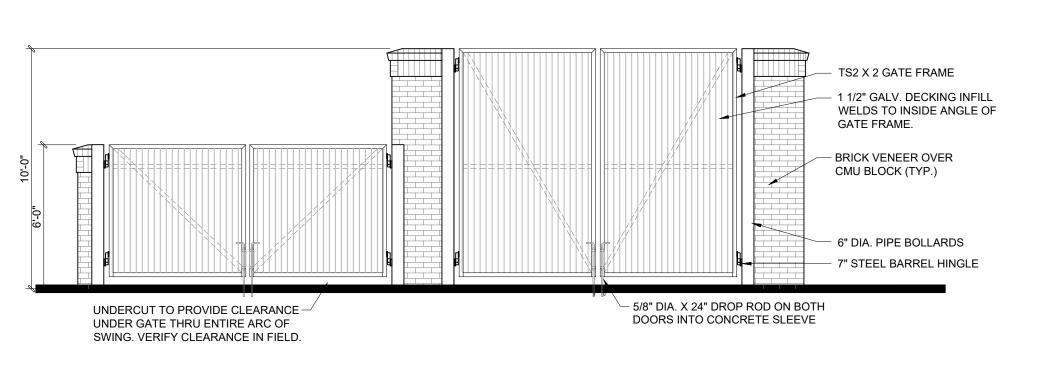


ARCHITECTURAL PLANS **EXTERIOR MATERIALS** = ASPHALT SHINGLE ROOF = STANDING SEAM METAL ROOF = FIBER CEMENT SIDING = FIBER CEMENT PANEL BD. W/ 2" BATTENS @ 24" O.C. = BRICK VENEER = ROWLOCK/SOLDIER


FRONT ELEVATION

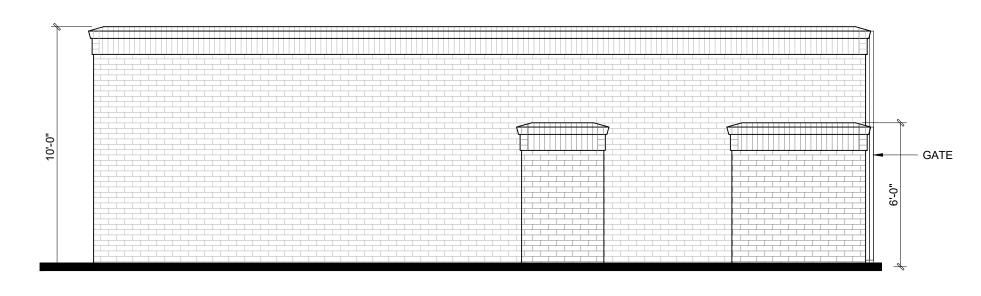


LEFT ELEVATION

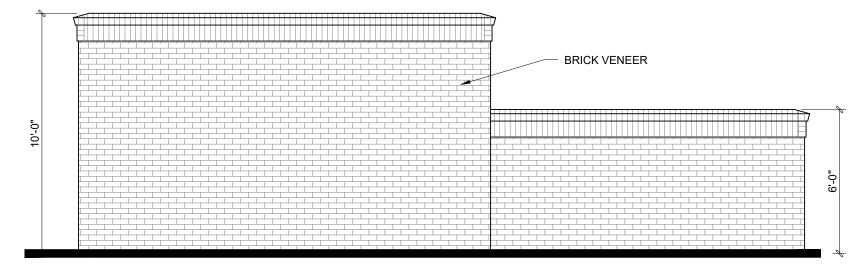

REAR ELEVATION

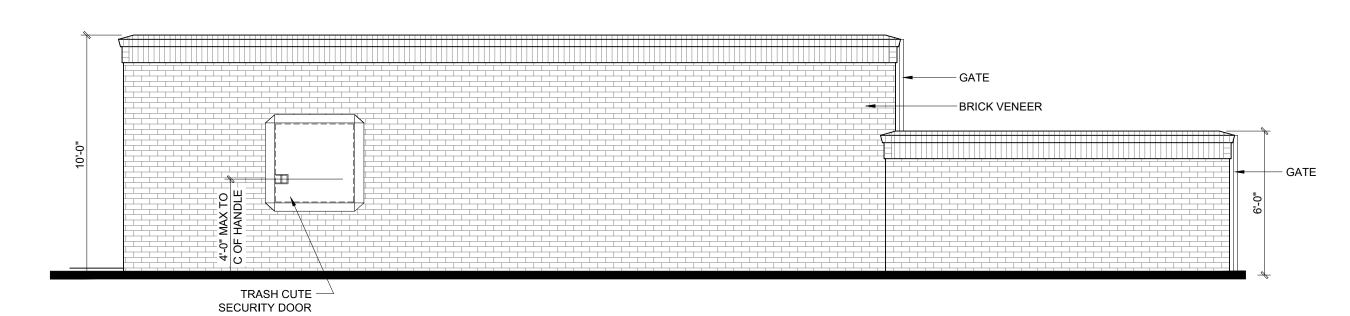

RIGHT ELEVATION

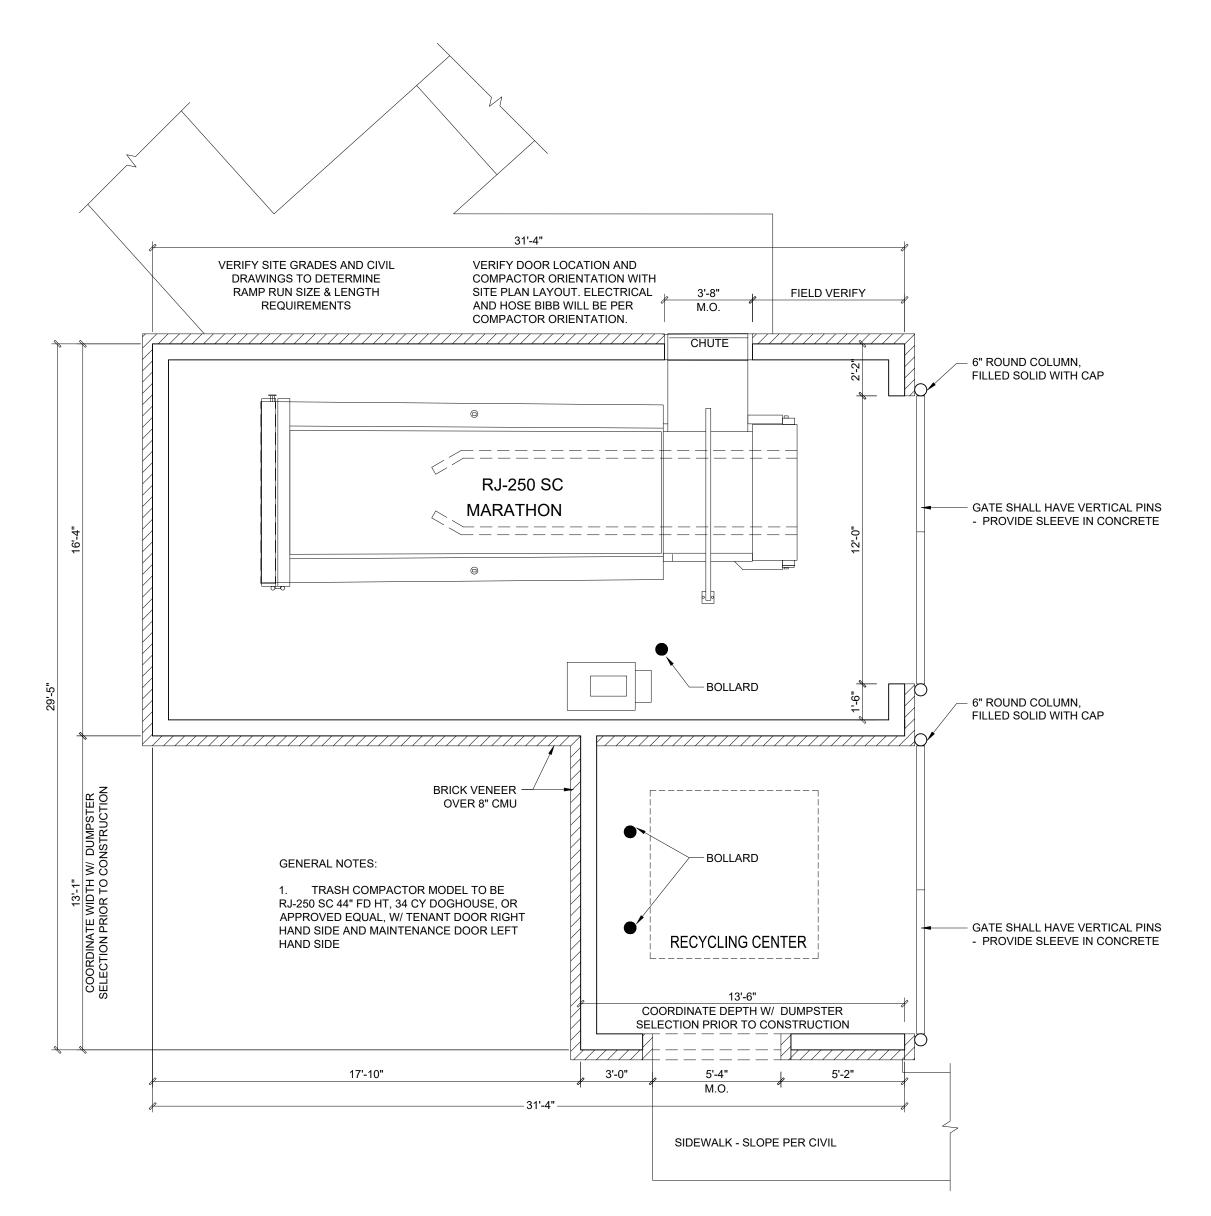

FLOOR PLAN



