



Administrative Approval Action

Case File / Name: ASR-0024-2023

DSLCL - PLEASANT VALLEY PROMENADE MULTIFAMILY

City of Raleigh
Development Services Department
One Exchange Plaza
Raleigh, NC 27602
(919) 996-2492
currentplanning@raleighnc.gov
www.raleighnc.gov

LOCATION: This site is located on the east side of Glenwood Avenue, south of Pleasant Valley Road at 3917 & 4001 Pleasant Valley Rd and 6204 & 6250 Glenwood Avenue.

REQUEST: Development of an existing Tract 4, 4.56 ac site (Lot 4), and a recombined area of 81,345 sf totaling 6.43 acres of lot area from existing lots 1-3. An area of 0.1ac of right-of-way will be dedicated, leaving a new net area of 6.33 acre for new Tract 4 for construction.

Tract 4 is zoned CX-5-PL CU and is being developed into a proposed 5-story multi-unit apartment, multiple-module building, and a proposed, 166,200 GFA, 5-story parking deck. The proposed overall building gross floor area totals 443,594 sf, with 3 building modules for an average grade for each module. Proposed Module #1 is 199,243 sf; Module #2 is 149,639 sf, and Module #3 is 94,712 sf. A total of 351 multi-unit apartment units (205 1-bedrooms; 133 2-bedrooms and 13 3-bedrooms) are proposed in the building. The overall redevelopment includes recombined land area or land area portions from the Pleasant Valley Shopping Center tracts 1, 2 & 3, in addition to Tract 4, as part of the site development and recombination. Tract 3 will remain vacant, while Tracts 1 & 2 will contain the shopping center.

Z=20-22 - Rezoning to CX-5-PL CU. Prohibited uses and TIA peak hours trip generations. Effective May 10, 2022.

**DESIGN
ADJUSTMENT(S)/
ALTERNATES, ETC:** N/A

FINDINGS: City Administration finds that this request, with the below conditions of approval being met, conforms to the Unified Development Ordinance. This approval is based on a preliminary plan dated September 22, 2023 by Kimley-Horn.

CONDITIONS OF APPROVAL and NEXT STEPS:

This document must be applied to the second sheet of all future submittals except for final plats. This is a preliminary plan and as such no permits have been issued with this approval. To obtain permits and/or completion of the project, the following steps are required:

☒ **SITE PERMITTING REVIEW** - For land disturbance of 12,000 square feet or greater, public or private infrastructure, shared stormwater devices, etc. Site Permitting Review may be submitted upon receipt of this signed approval document.

The following items are required prior to approval of Site Permitting Review plans:

General



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1. Demonstrate & show building foundation wall landscaping and screening design compliance, per UDO Sec.7.2.8.E.4.a, by revising the shrub installation information & planting schedule for the proposed min. shrub heights as shown on sheet L2 to meet min. 36" standard requirements as listed.
2. The transparency data calculation table for the non-residential portion(s) of building module #3, as shown on sheet A201, are revised as shown and demonstrate compliance with UDO Sec.1.5.9.B.
3. The building data information as shown on the preliminary ASR coversheet and that listed on sheet C3, site data information table, is revised and re-calculated per the existing, new gross floor and demolishing information listed on the application form.
4. A set of proposed design elevation grade sheets are inserted into the Site Permit Review plans for all new retaining walls.
5. All proposed lighting fixtures comply with UDO chapter Sec.7.4 & Sec.7.4.11., including any wall packs. A light-level illumination count for the parking structure, level 6, and vehicular parking surface areas is inserted and provided with the Site Permit Review plans.
6. ADA accessibility paths to proposed amenity areas are noted on the civil Site Permit Review plans set site plan sheet.
7. Update and revise subtitle blocks for the floor plan sheets (G003-G004, A101-A108), or provide the floor & story labels for the proposed garage, as shown with the building floor plan stories as shown.
8. Update sheets G003-G004 and A106-A108, by providing clarity with a legend for the hatched areas being shown on all sheets, and identifying the structure being shown on sheet A107. Lastly, amend the labeling on sheet A108 for the garage deck level per the rooftop plan shown.
9. Identify the parking level and or remove sheet A001, for the parking deck outline shown.

Engineering

10. Detailed review of the pedestrian connections to the rights of way to and from the main entrance and through the site for overall pedestrian connectivity.
11. A Traffic Control and Pedestrian (TCPED) Plan must be approved and a right-of-way occupancy permit must be obtained from Right-of-way Services for any construction activities within the right-of-way.

Public Utilities

12. A deed shall be recorded prior to concurrent approval for all necessary offsite City of Raleigh Sanitary Sewer Easements to accommodate future sewer line construction.

Stormwater

13. A surety equal to of the cost of clearing, grubbing and reseeding a site, shall be paid to the City (UDO 9.4.4).



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14. A nitrogen offset payment must be made to a qualifying mitigation bank (UDO 9.2.2.B).
15. A stormwater control plan with a stormwater operations and maintenance manual and budget shall be approved (UDO 9.2).

Urban Forestry

16. Tree protection fence must be inspected by Urban Forestry staff prior to the issuance of a grading permit or demolition permit, whichever comes first.
17. Submit a final tree conservation plan that includes metes and bounds descriptions of the tree conservation area and tree protection fencing as required (UDO 9.1.5).

☒ **LEGAL DOCUMENTS** - Email to legaldocumentreview@raleighnc.gov. Legal documents must be approved, executed, and recorded prior to or in conjunction with the recorded plat on which the associated easements are shown. Copies of recorded documents must be returned to the City within one business day of recording to avoid withholding of further permit issuance.

<input checked="" type="checkbox"/>	Cross Access Agreements Required
<input checked="" type="checkbox"/>	Right of Way Deed of Easement Required
<input checked="" type="checkbox"/>	Sidewalk Deed of Easement Required

<input checked="" type="checkbox"/>	Utility Placement Deed of Easement Required
<input checked="" type="checkbox"/>	Slope Easement Deed of Easement Required

☒ **RECORDED MAP(S)** - Submit plat to record new property lines, easements, tree conservation areas, etc.). Plats may be submitted for review when the Site Permitting Review plans, if required, have been deemed ready for mylar signature.

The following items must be approved prior to recording the plat:

General

1. A demolition permit shall be issued and this building permit number shown on all maps for recording.

Engineering

2. A sidewalk deed of easement, in addition to a plat showing the location of the easement, shall be submitted to the Planning and Development Services Department for review, and if acceptable, approved for recordation. Approved plats must be recorded at the Wake County Register of Deeds Office on or before the 14th day following approval by the City. The 14-day expiration date shall be clearly indicated on the plat. By the end of the next business day following recordation of the plat, all required legal instruments (including deeds of easement) shall be recorded, and recorded copies of the plat and all legal instruments required by the City in association with development approval shall be provided to the City. (Reference: UDO 8.1.7.A; 10.2.5.F.4.d)



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3. A slope easement deed of easement, in addition to a plat showing the location of the easement, shall be submitted to the Planning and Development Services Department for review, and if acceptable, approved for recordation. Approved plats must be recorded at the Wake County Register of Deeds Office on or before the 14th day following approval by the City. The 14-day expiration date shall be clearly indicated on the plat. By the end of the next business day following recordation of the plat, all required legal instruments (including deeds of easement) shall be recorded, and recorded copies of the plat and all legal instruments required by the City in association with development approval shall be provided to the City. (Reference: UDO 8.1.7.A; 10.2.5.F.4.d)
4. A 5' utility placement easement deed of easement, in addition to a plat showing the location of the easement, shall be submitted to the Planning and Development Services Department for review, and if acceptable, approved for recordation. Approved plats must be recorded at the Wake County Register of Deeds Office on or before the 14th day following approval by the City. The 14-day expiration date shall be clearly indicated on the plat. By the end of the next business day following recordation of the plat, all required legal instruments (including deeds of easement) shall be recorded, and recorded copies of the plat and all legal instruments required by the City in association with development approval shall be provided to the City. (Reference: UDO 8.1.7.A; 10.2.5.F.4.d)
5. A public street right-of-way deed of easement, in addition to a plat showing the location of the easement, shall be submitted to the Planning and Development Services Department for review, and if acceptable, approved for recordation. Approved plats must be recorded at the Wake County Register of Deeds Office on or before the 14th day following approval by the City. The 14-day expiration date shall be clearly indicated on the plat. By the end of the next business day following recordation of the plat, all required legal instruments (including deeds of easement) shall be recorded, and recorded copies of the plat and all legal instruments required by the City in association with development approval shall be provided to the City. (Reference: UDO 8.1.7.A; 10.2.5.F.4.d)
6. A cross access agreement shall be approved by the Development Services Department for recording in the Wake County Registry, and a copy of the recorded offer of cross access easement shall be returned to the Development Services Department within one day of plat recordation. If a recorded copy of the document is not provided within this time, further recordings and building permit issuance will be withheld.

Public Utilities

7. Infrastructure Construction Plans (concurrent submittal) must be approved by the City of Raleigh Public Utilities Department for all public water, public sewer and/or private sewer extensions.

Urban Forestry

8. A tree conservation plat shall be recorded with metes and bounds showing the designated tree conservation areas (UDO 9.1). This development proposes 0.389 acres of tree conservation area.

☒ **BUILDING PERMITS** - For buildings and structures shown on the approved plans. Commercial building permit plans must include the signed, approved Site Permitting Review plans attached, if applicable. Permit sets may be reviewed prior to the recordation of required plats, but cannot be approved.



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The following items must be approved prior to the issuance of building permits:

General

1. A recombination map shall be recorded prior to or in conjunction with the recording of lots, recombining the existing tracts into the proposed site and land configurations, per the development plan, for Lots 1-4.
2. Comply with all conditions of Z-20-22.
3. A demolition permit shall be obtained.
4. An offsite and onsite retaining wall easement is recorded for those retaining walls and easements proposed and being shown between Lots 1 & 4.

Engineering

5. A public infrastructure surety shall be provided to City of Raleigh Transportation – Development Engineering Division (UDO 8.1.3) in the amount of 100% of the improvement cost for the NCDOT portion and 125% of the improvement cost for the City of Raleigh infrastructure.

Public Utilities

6. A plat must be recorded at the Wake County Register of Deeds office for all utility easement dedications.
7. Initiation of the easement exchange process is required (via dedication of new easement on record plat, ending with abandonment of old easement on subsequent deed).
8. Utility re-alignment construction shall be substantially complete (to eliminate conflict with new building).

Stormwater

9. A surety equal to 125% of the cost of the construction of a stormwater device shall be paid to the Engineering Services Department (UDO 9.2.2.D.1.d).
10. All stormwater control measures and means of transporting stormwater runoff to and from any nitrogen and stormwater runoff control measures shall be shown on all plats for recording as private drainage easements (UDO 9.2).

Urban Forestry

11. A tree impact permit must be obtained for the approved streetscape tree installation in the right of way. This development proposes 39 street trees along Pleasant Valley Road.
12. A tree conservation plat shall be recorded with metes and bounds showing the designated tree conservation areas (UDO 9.1).



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13. A public infrastructure surety for 39 street trees shall be provided to City of Raleigh Transportation – Development Engineering Division (UDO 8.1.3) in the amount of 125% of the improvement cost for the City of Raleigh infrastructure.

The following are required prior to issuance of building occupancy permit:

General

1. All Water, Sanitary Sewer and Reuse facilities shall be installed, inspected, tested and accepted by the City of Raleigh Public Utilities Department for operations and maintenance.
2. Final inspection of all tree conservation areas and right of way street trees by Urban Forestry Staff
3. All street lights and street signs required as part of the development approval are installed.
4. Required public right-of-way infrastructure improvements shall be, at a minimum, sufficiently completed to provide the necessary, safe emergency and vehicular access.
5. All proposed lighting fixtures, including the parking deck fixtures, demonstrate and show design compliance with UDO Sec.7.4.10 & UDO Sec.7.4.11.

Stormwater

6. As-built drawings and associated forms for all Stormwater devices are accepted by the Engineering Services Department (UDO 9.2.2.D.3).
7. As-built impervious survey is accepted by the Engineering Services Department (UDO 9.2).

EXPIRATION DATES: The expiration provisions of UDO Section 10.2.8 E, including the ability to request extensions in the expiration date, apply to this site plan. If significant construction has not taken place on a project after administrative site review approval, that approval may expire and be declared void, requiring re-approval before permits may be issued. To avoid allowing this plan approval to expire the following must take place by the following dates:

3-Year Expiration Date: October 4, 2026

Obtain a valid building permit for the total area of the project, or a phase of the project.

4-Year Completion Date:

Within four years after issuance of the first building permit for the site plan, the construction of the entire site plan must be completed unless an applicant has been granted vested rights. Failure to complete construction within this specified time frame shall automatically void the approved site plan for which no building permits have been issued.



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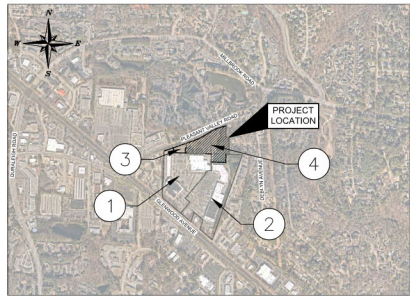
I hereby certify this administrative decision.

Signed: *Daniel L. Stegall* Date: 10/04/2023
Development Services Dir/Designee
Staff Coordinator: Jermont Purifoy

ADMINISTRATIVE SITE REVIEW FOR: PLEASANT VALLEY PROMENADE MULTIFAMILY - PHASE 1

ASR-0024-2023

6250 GLENWOOD AVENUE (PIN#0786779662);
6204 GLENWOOD AVENUE (PIN#0786874371);
4001 PLEASANT VALLEY ROAD (PIN#0786881039);
3917 PLEASANT VALLEY ROAD (PIN#0786885116);
RALEIGH, NORTH CAROLINA 27612



VICINITY MAP SCALE: 1" = 1000'

CROSS ACCESS EXEMPTION

CROSS ACCESS REQUIREMENT SHALL NOT APPLY WHEN THE ADJUTING PROPERTY IS IN A RESIDENTIAL ZONING DISTRICT.

BLOCK PERIMETER EXEMPTION

NEW STREET RIGHT-OF-WAY WOULD CONSUME MORE THAN 10% OF THE PROPERTY TO BE DEVELOPED AND THEREFORE THIS PROPERTY IS EXEMPT FROM BLOCK PERIMETER REQUIREMENTS.

THE CREATION OF ANY NEW STREET WOULD BE OBSTRUCTED BY EXISTING IMPROVEMENTS WHERE THE VALUE OF SUCH IMPROVEMENTS IS MORE THAN THE LAND VALUE OF THE PARCEL ON WHICH THE IMPROVEMENTS ARE LOCATED AND THEREFORE THIS PROPERTY IS EXEMPT FROM BLOCK PERIMETER REQUIREMENTS.

RECOMMENDATION NOTE:
A RECOMMENDATION PLAN WILL BE REQUIRED AS A CONDITION OF THIS DEVELOPMENT APPROVAL.

STORMWATER MAINTENANCE NOTE:
STORMWATER CONTROL MEASURES, INCLUDING SAND FILTER AND INLET PIPE, TO BE MAINTAINED PER CITY OF RALEIGH STORMWATER SPECIFICATIONS.

WASTE DISPOSAL NOTE:
WASTE DISPOSAL SERVICES WILL BE PROVIDED BY PRIVATE HAULER. DEVELOPERS HAVE REVIEWED AND ARE IN COMPLIANCE WITH THE REQUIREMENTS SET FORTH IN THE SOLID WASTE DESIGN MANUAL.

- TRAFFIC CONTROL AND PEDESTRIAN PLAN (TOPED) NOTES:**
- PRIOR TO ANY WORK THAT IMPACTS THE RIGHT-OF-WAY, CLOSING OR DETOURING OF ANY STREET, LANE, OR SIDEWALK, THE CONTRACTOR MUST APPLY FOR A PERMIT WITH RIGHT-OF-WAY SERVICES. PLEASE DIRECT ANY QUESTIONS TO RIGHTOFWAYSERVICES@RALEIGHNC.GOV.
 - THE STREET, LANE, SIDEWALK, CLOSURE PERMIT IS REQUIRED FOR ANY CLOSURE ON CITY STREETS AND ALL NC DOT STREETS WITHIN RALEIGH'S JURISDICTION.
 - A PERMIT REQUEST WITH A TOPED PLAN SHALL BE SUBMITTED TO RIGHT-OF-WAY SERVICES THROUGH THE CITY OF RALEIGH PERMIT AND DEVELOPMENT PORTAL.
 - PRIOR TO THE START OF WORK, THE CLIENT SHALL SCHEDULE A PRE-CONSTRUCTION MEETING WITH THE ENGINEERING INSPECTIONS COORDINATOR TO REVIEW THE SPECIFIC COMPONENTS OF THE APPROVED PLAN, AND ENSURE ALL PERMITS ARE ISSUED.
 - ALL TOPED PLANS SHALL COMPLY WITH ALL LOCAL, STATE, AND FEDERAL REQUIREMENTS AND STANDARDS, INCLUDING BUT NOT LIMITED TO:
 - MANUAL ON UNIFORM TRAFFIC CONTROL (MUTCD);
 - PUBLIC RIGHTS-OF-WAY ACCESSIBILITY GUIDELINES (PROWAG);
 - AMERICAN DISABILITY ACT (ADA) REQUIREMENTS;
 - RALEIGH STREET DESIGN MANUAL (RSDM).
 - ALL PUBLIC SIDEWALKS MUST BE ACCESSIBLE TO PEDESTRIANS WHO ARE VISUALLY IMPAIRED AND/OR PEOPLE WITH MOBILITY CONCERNS. EXISTING AND ALTERNATIVE PEDESTRIAN ROUTES DURING CONSTRUCTION SHALL BE REQUIRED TO BE COMPLIANT WITH THE PUBLIC RIGHTS OF WAY ACCESSIBILITY GUIDELINES (PROWAG). THE ADA STANDARDS FOR ACCESSIBLE DESIGN AND THE MANUAL ON UNIFORM TRAFFIC CONTROL DEVICES (MUTCD).
 - ALL PERMITS MUST BE AVAILABLE AND VISIBLE ON SITE DURING THE OPERATION.

Administrative Site Review Application

Planning and Development Customer Service Center - One Exchange Plaza, Suite 400 | Raleigh, NC 27601 | 919-996-2000



This form is required when submitting site plans as referenced in Unified Development Ordinance (UDO) Section 10.2.8. Please check the appropriate building types and include the plan checklist document when submitting.

Office Use Only: Case #: _____ Planner (print): _____

Please review UDO Section 10.2.8 to determine the site plan tier. If assistance determining a Site Plan Tier is needed a Site Plan Tier Verification request can be submitted online via the [Permit and Development Portal](#). (Note: There is a fee for this verification service.)

Site Plan Tier: Tier Two Site Plan ☐ Tier Three Site Plan ☒

Building and Development Type (Check all that apply)	Site Transaction History
<input type="checkbox"/> Detached <input type="checkbox"/> Attached <input type="checkbox"/> Townhouse <input checked="" type="checkbox"/> Apartment <input type="checkbox"/> Tiny house <input type="checkbox"/> Open lot	<input type="checkbox"/> General <input type="checkbox"/> Mixed use <input type="checkbox"/> Civic <input type="checkbox"/> Cottage Court <input type="checkbox"/> Frequent Transit Development Option
Subdivision case #: _____ Scoping/sketch plan case #: SCOPE-0187-2022 Certificates of Appropriateness #: _____ Board of Adjustment #: _____ Zoning Case #: Z-20-22 Design Alternate #: _____	

GENERAL INFORMATION

Development name: Pleasant Valley Promenade Multifamily

Inside City limits? Yes ☒ No ☐

Property address(es): 4001 Pleasant Valley Road, 3917 Pleasant Valley Road, 6204 Glenwood Avenue, 6250 Glenwood Avenue

Site P.I.N.(s): 0786881039, 0786885116, 0786874371, 0786779662

Please describe the scope of work. Include any additions, expansions, and uses (UDO 6.1.4).

Demolition of existing Van Gogh Exhibition building (formerly Fitness Connection) in north east corner of subject property to allow for construction of a new apartment building.

Current Property Owner(s): Kimco Raleigh LP (OWNS PARCELS 0786881039, 0786885116, 0786874371, 0786779662)

Company: Kimco Raleigh LP Title: _____

Address: 3333 New Hyde Park Road, New Hyde Park, NY 11042

Phone #: (704) 362-6149 Email: tjohnson@kimcorealty.com

Applicant Name (if different from owner. See "who can apply" in instructions): _____

Relationship to owner: ☐ Lessee or contract purchaser ☒ Owner's authorized agent ☐ Easement holder

Company: Kimley-Horn Address: 421 Fayetteville Street, Raleigh, NC 27601

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REVISION 1.23.23

raleighnc.gov

RESIDENTIAL & OVERNIGHT LODGING DEVELOPMENTS			
Total # of dwelling units: 351	Total # of hotel bedrooms: _____		
# of bedroom units: 1br 205 2br 133 3br 13 4br or more _____	Is your project a cottage court? <input type="radio"/> Yes <input checked="" type="radio"/> No		
# of lots: 1	A frequent transit development? <input type="radio"/> Yes <input checked="" type="radio"/> No		

Continue to Applicant Signature Block on Page Three.

Sheet List Table	
Sheet Number	Sheet Title
C0.0	COVER SHEET
C0.1	GENERAL NOTES
C0.2	APPROVAL LETTERS
C1.0	PLAT
C1.1	TOPOGRAPHIC SURVEY
C1.2	TOPOGRAPHIC SURVEY
C2.0	DEMOLITION PLAN
C2.1	PROPERTY LINE ADJUSTMENT PLAN
C3.0	SITE PLAN
C3.1	BUILD-TO PLAN
C3.2	FIRE APPARATUS AND HOSE LAY PLAN
C3.3	SIGHT DISTANCE PLAN
C3.4	SIGHT DISTANCE PLAN
C4.0	GRADING AND DRAINAGE PLAN
C5.0	UTILITY PLAN
C6.0	UNDERGROUND DETENTION & SAND FILTER DETAILS
C7.0	SITE DETAILS
C7.1	SITE DETAILS
LT.0	LIGHTING PLAN
TC.0	TREE CONSERVATION PLAN
L1.0	LANDSCAPE PLAN
L2.0	LANDSCAPE DETAILS
G003	FIRE AREA PLANS & CODE SUMMARY
G004	FIRE AREA PLANS & CODE SUMMARY
A001	ARCHITECTURAL SITE PLAN
A101	GROUND LEVEL FLOOR PLAN
A102	LOWER LEVEL FLOOR PLAN
A103	LEVEL 1 FLOOR PLAN
A104	LEVEL 2 FLOOR PLAN
A105	LEVEL 3 FLOOR PLAN
A106	LEVEL 4 FLOOR PLAN
A107	LEVEL 5 FLOOR PLAN
A108	ROOF PLAN
A201	EXTERIOR ELEVATIONS - N-S
A202	EXTERIOR ELEVATIONS - E-W

REZONING CONDITIONS

Z-20-22 - 6204 (PARTIAL), 6250 (PARTIAL), GLENWOOD AVENUE, 3917, 4001 PLEASANT VALLEY ROAD, LOCATED APPROXIMATELY 800 FEET EAST OF THE INTERSECTION OF GLENWOOD AVENUE AND PLEASANT VALLEY ROAD, BEING WAKE COUNTY FINE SUBDIVISION 0786779662, 078688116, 0786881039, APPROXIMATELY 18.35 ACRES REZONED TO COMMERCIAL MIXED USE-5 STORES-PARKING LIMITED-CONDITIONAL USE (C-MX-P5, CUL).

CONDITIONS DATED MAY 10, 2022 Z-20-22

1. THE FOLLOWING PRINCIPAL USES AS LISTED IN UDO SECTION 6.1.4 THAT ARE PERMITTED LIMITED OR SPECIAL USES IN THE C-MX DISTRICT SHALL BE PROHIBITED:
 - (a) ADULT ESTABLISHMENT AND ENTERTAINMENT CENTER, USE, PRESENT OR FUTURE
2. FOR THE PURPOSE OF OBTAINING BUILDING PERMITS, THE TOTAL ALL PEAK HOUR AND TOTAL PM PEAK HOUR TRIPS GENERATED ON THE PROJECT SHALL BE NO MORE AS FOLLOWS, AS DETERMINED BY THE ITE TRIP GENERATION MANUAL, 11TH EDITION:
 - AM PEAK HOUR: 760 TOTAL TRIPS
 - PM PEAK HOUR: 816 TOTAL TRIPS

OWNER

KIMCO RALEIGH LP
840 PARK ROAD
CHARLOTTE, NC 28210
CONTACT: LEE JOHNSON
PHONE: (704) 362-6149
EMAIL: LJOHNSON@KIMCOREALTY.COM

CIVIL ENGINEER

KIMLEY HORN AND ASSOCIATES, INC.
421 FAYETTEVILLE ST., STE 600
RALEIGH, NC 27601
CONTACT: CORY HORNELL, P.E.
PHONE: (919) 678-4195
EMAIL: CORY.HORNELL@KIMLEY-HORN.COM

SURVEYOR

GSC SURVEYING, INC.
4072 BARRETT DRIVE
RALEIGH, NC 27609
CONTACT: CHUCK SMITH
PHONE: (919) 243-1058
EMAIL: CHUCK.SMITH@GSCSURVEYING.COM

DEVELOPER

KIMLEY HORN AND ASSOCIATES, INC.
300 HILLSBOROUGH STREET
RALEIGH, NC 27603
CONTACT: JASON GABLE
PHONE: (919) 686-6991
EMAIL: JGABLE@KIMLEY-HORN.COM

ARCHITECT

KIMLEY HORN AND ASSOCIATES, INC.
421 FAYETTEVILLE STREET, STE 600
RALEIGH, NC 27601
CONTACT: AUSTIN ROLAND
PHONE: (919) 686-6991
EMAIL: AUSTIN.ROLAND@KIMLEY-HORN.COM

LANDSCAPE ARCHITECT

KIMLEY HORN AND ASSOCIATES, INC.
421 FAYETTEVILLE STREET, STE 600
RALEIGH, NC 27601
CONTACT: AUSTIN ROLAND
PHONE: (919) 686-6991
EMAIL: AUSTIN.ROLAND@KIMLEY-HORN.COM

FOR REVIEW ONLY

NOT FOR CONSTRUCTION

Digitally signed by
Jermont Purifoy@raleighnc.gov
Date: 2023.09.28 10:20:37 -0400


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Know what's below.
Call before you dig.

PARCEL AREA TABLE							
SHOPPING CENTER PARCELS	PIN	PARCEL ID/REID	EXISTING AREA	AREA LOST	AREA GAINED	RIGHT-OF-WAY DEDICATION	NET AREA
(1) 6250 GLENWOOD AVENUE	#0786779662	#0453609	14.15 AC / 616,166 SF	0.10 AC / 4,399 SF (TO LOT 4)	N/A	0.02 AC / 961 SF	13.40 AC / 583,924 SF
(2) 6204 GLENWOOD AVENUE	#0786874371	#0453610	16.27 AC / 708,546 SF	0.79 AC / 34,370 SF (TO LOT 3)	N/A	0 AC / 0 SF	15.48 AC / 674,176 SF
MULTIFAMILY PARCELS	PIN	PARCEL ID/REID	EXISTING AREA	AREA LOST	AREA GAINED	RIGHT-OF-WAY DEDICATION	NET AREA
(3) 4001 PLEASANT VALLEY ROAD	#0786881039	#0023667	.98 AC / 42,576 SF	0.98 AC / 42,576 SF (TO LOT 4)	0.62 AC / 26,881 SF (FROM LOT 1)	0.04 AC / 1,549 SF	0.58 AC / 25,336 SF
(4) 3917 PLEASANT VALLEY ROAD	#0786885116	#0453611	4.56 AC / 198,741 SF	N/A	0.10 AC / 4,399 SF (FROM LOT 1) 0.79 AC / 34,370 SF (FROM LOT 2) 0.98 AC / 42,576 SF (FROM LOT 3)	0.10 AC / 4,549 SF	6.33 AC / 275,538 SF

BUILD-TO TABLE					
STREET TYPE	FRONTAGE (LF)	% REQUIRED WITH BUILDING	LF REQUIRED WITH BUILDING	% PROVIDED WITH BUILDING	LF PROVIDED WITH BUILDING
PRIMARY STREET (PLEASANT VALLEY ROAD)	758.40	50%	379.20	66.57%	504.90
SIDE STREET (N/A)	N/A	25%	N/A	N/A	N/A

PUBLIC IMPROVEMENTS	
PHASE NUMBER	1
NUMBER OF LOTS	1
LOT NUMBERS BY PHASE	N/A
NUMBER OF UNITS	351
LIVABLE BUILDINGS	1
AMENITY SPACE	0.638 AC
PUBLIC WATER (LF)	91 LF
PUBLIC SEWER (LF)	781 LF
PUBLIC STREET (LF) - FULL	0
PUBLIC STREET (LF) - PARTIAL	0
PUBLIC SIDEWALK (LF)	0 LF
STREET SIGNS	0
WATER SERVICE STUBS	2
SEWER SERVICE STUBS	2

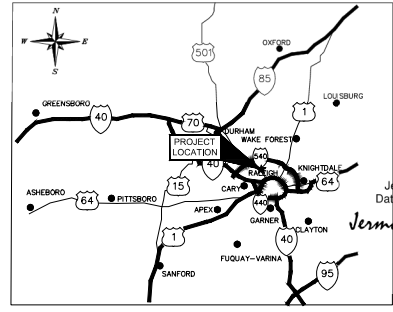

Kimley»Horn

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PHONE: 919-686-6991 FAX: 919-677-2050
WWW.KIMLEY-HORN.COM
#F-002

COVER SHEET

PLEASANT VALLEY PROMENADE
MULTIFAMILY - PHASE 1
PREPARED FOR
KIMCO RALEIGH LIMITED
PARTNERSHIP
RALEIGH

SHEET NUMBER

C0.0

DATE

6/7/2023

REVISIONS

No.	REVISIONS	DATE
4	REVISED PER CITY ASR COMMENTS	9/23/2023
3	REVISED PER CITY ASR COMMENTS	9/1/2023
2	REVISED PER CITY ASR COMMENTS	7/28/2023
1	REVISED PER CITY ASR COMMENTS	6/7/2023

EROSION CONTROL NOTES:

1. ALL WORK AND MATERIALS SHALL COMPLY WITH ALL CITY OF RALEIGH AND NORTH CAROLINA DEPARTMENT OF TRANSPORTATION REGULATIONS AND CODES AND U.S.A. STANDARDS.
2. ALL CONTIGUOUS AND SPOT ELEVATIONS REFLECT FINISHED GRADES. SPOT ELEVATIONS AT CURB AND GUTTER CORNERS ARE TO THE GUTTER LINE UNLESS OTHERWISE NOTED.
3. ALL ELEVATIONS ARE IN REFERENCE TO THE BENCHMARK, AND THIS SHALL BE VERIFIED BY THE GENERAL CONTRACTOR PRIOR TO BEGINNING GRADE.
4. THE CONTRACTOR SHALL BE RESPONSIBLE TO CARRY ANY DISCREPANCIES FOUND BETWEEN ACTUAL FIELD CONDITIONS AND CONSTRUCTION DOCUMENTS AND SHALL WAIT FOR INSTRUCTION PRIOR TO PROCEEDING.
5. THE CONTRACTOR SHALL BE RESPONSIBLE FOR LOCATING AND PROTECTING EXISTING UTILITIES, AND SHALL REPAIR ALL DAMAGE TO EXISTING UTILITIES THAT OCCUR DURING CONSTRUCTION.
6. CONTRACTOR SHALL BE REQUIRED NEW EARTHWORK MOVEMENTS TO TRANSITION BACK TO EXISTING GRADE.
7. CONTRACTOR SHALL DEVELOP THE RECOMMENDATIONS OF A GEOTECHNICAL ENGINEER LICENSED IN THE STATE OF NORTH CAROLINA.
8. LIMITS OF CLEARING SHOWN ON GRADING PLANS ARE BASED UPON THE APPROXIMATE CUT AND FILL SLOPE LIMITS, OR OTHER GRADING REQUIREMENTS.
9. EXISTING TOPOGRAPHY SHOWN ON DRAINAGE AND PARKING LOTS AND SIDEWALKS ARE FINISHED ELEVATIONS INCLUDING ASPHALT. REFER TO PAVEMENT CROSS SECTION DATA TO ESTABLISH CORRECT SUBBASE OR ADEQUATE BASE COURSE ELEVATIONS TO BE COMPLETED UNDER THIS CONTRACT.
10. CONTRACTOR SHALL ENSURE PROPER DRAINAGE OF ALL AREAS OF THE SITE BY GRADITY FLOW ACROSS ANY PAVEMENT AREAS TO NEW OR EXISTING DRAINAGE INLETS OR SHOWN OVERLAND.
11. ANY GRADING, BEYOND THE LIMITS OF DRAINAGE AS SHOWN ON THE GRADING PLAN IS CONSIDERED A VIOLATION OF THE GRADING PERMIT AND SUBJECT TO A FINE.
12. EXISTING TOPOGRAPHIC INFORMATION TAKEN FROM A SURVEY REFERENCED IN THIS PLAN SET.
13. THE CONTRACTOR SHALL OBTAIN AT LEAST A CONVEYANCE AS OUTLINED IN THE GENERAL U.P.E.S. PERMIT FOR STORMWATER DISCHARGE AGREEMENTS WITH CONSTRUCTION ACTIVITIES AND ALL TERMS AND CONDITIONS IN THE STATE OR MUNICIPAL GRADING AND EROSION CONTROL PERMIT ISSUED FOR THIS PROJECT.
14. ALL AREAS DISTURBED BY CONSTRUCTION SHALL RECEIVE 8 INCHES OF TOPSOIL AND 6 INCHES OF GROUNDCOVER AS APPROPRIATE. REFER TO EROSION CONTROL NOTE 12 FOR ADDITIONAL DATA.
15. CONTRACTOR SHALL STABILIZE AND WATER DISTURBED AREAS UNTIL A HEALTHY STAND OF GRASS IS OBTAINED.
16. THE CONTRACTOR IS RESPONSIBLE FOR THE DESIGN AND IMPLEMENTATION OF ALL SHEETING, SHORING, BRACING, AND PROTECTIVE MEASURES TO BE USED TO MAINTAIN THE EXISTING STATE ROAD REGULATORY EASEMENT PURSUANT TO THE INSTALLATION OF THE WORK INDICATED ON THESE DRAWINGS. THE DESIGN ENGINEER ACCEPTS NO RESPONSIBILITY FOR THE DECISIONS TO INSTALL SUD ITEMS.
17. THE CONTRACTOR SHALL INCLUDE IN ALL BIDDING A CONVEYANCE AS OUTLINED IN THE GENERAL U.P.E.S. PERMIT FOR STORMWATER DISCHARGE AGREEMENTS WITH CONSTRUCTION ACTIVITIES AND ALL TERMS AND CONDITIONS IN THE PROCESSES SHOWN ON THE DRAWINGS IN AN ALTERNATE ALLOWANCE.
18. CONTRACTOR TO BE RESPONSIBLE FOR DETERMINING AS NECESSARY TO CONSTRUCT THE PROJECT AS SHOWN ON THE PLANS.
19. CONTRACTOR SHALL REFER TO THE ARCHITECTURAL PLANS FOR EXACT BUILDING DIMENSIONS, DOOR LOCATIONS, AND EXACT UTILITY DRAINING LOCATIONS AND ELEVATIONS.
20. ALL FILL MATERIALS, EXISTING BUILDING FOUNDATIONS, PAVEMENT AND UTILITY STRUCTURES, TOPSOIL, AND ANY OTHER DELICATE MATERIALS SHALL BE COMPLETELY REMOVED FROM WITHIN THE BEARING ZONE, BELOW THE STRUCTURE.
21. ALL FOUNDATION AND UTILITY EXCAVATION SHALL BE INSPECTED BY A QUALIFIED GEOTECHNICAL REPRESENTATIVE TO DETERMINE WHETHER RECONSTRUCTION MATERIAL SHALL BE REMOVED OR NOT. ALL REMOVED MATERIAL SHALL BE REMOVED, BACKFILLED AND COMPACTED WITH SUITABLE MATERIAL AS REQUIRED BY THE GEOTECHNICAL REPRESENTATIVE AT CONTRACTOR'S EXPENSE.
22. GRADES, ELEVATIONS AND LOCATIONS SHOWN ARE APPROXIMATE, AS DICTATED BY THE ENGINEER, THEY MAY BE SUBJECT TO CHANGE TO ACCOMMODATE ANY CHANGES TO THE EXISTING DRAINAGE OR TO THE CENTER OF DRAINAGE LINES, MANHOLES AND JUNCTION BOXES, AND THE IMPROVED OF THE GUTTER FLOW LINE OR CENTER OF DRAINAGE LINES.
23. CONTRACTOR SHALL ADJUST AND/OR CUT EXISTING PAVEMENT AS NECESSARY TO ASSURE A SMOOTH FIT AND CONTINUOUS GRADE.
24. EXISTING AND PROPOSED GRADE CONTOUR INTERVALS SHOWN AT 1' FOOT.
25. CONTRACTOR IS RESPONSIBLE FOR REMEDIATION OF EXISTING STRUCTURES INCLUDING REMOVAL OF ANY EXISTING UTILITY STRUCTURES REMOVED DURING CONSTRUCTION. ANY REMOVED TO THE RIGHT-OF-WAY OR ABANDONED AT MAN AS FULFILLED IN THE PLANS.
26. ALL CUT OR FILL SLOPES SHALL BE 3:1 OR FLATTER UNLESS OTHERWISE NOTED.
27. ALL AREAS WITH 2:1 SLOPE OR ERODIBLE SLOPES SHALL BE COVERED WITH EROSION MATTING OR APPROVED EROSION CONTROL MEASURES.
28. THE CONTRACTOR IS SPECIFICALLY CAUTIONED THAT THE LOCATION AND/OR ELEVATION OF EXISTING UTILITIES AS SHOWN ON THESE PLANS IS BASED ON RECORDS OF THE VARIOUS UTILITY COMPANIES, AND WHERE POSSIBLE, THE CONTRACTOR SHALL BE REQUIRED TO VERIFY THE LOCATION AND/OR ELEVATION OF EXISTING UTILITIES. THE CONTRACTOR MUST CALL THE APPROPRIATE UTILITY COMPANIES AT LEAST 48 HOURS BEFORE ANY EXCAVATION OR OTHER WORK THAT MAY DISTURB EXISTING UTILITIES.

21. ALL UTILITIES SHALL COORDINATE WITH ALL UTILITY COMPANIES FOR INSTALLATION REQUIREMENTS AND ANY SPECIFICATIONS.
 22. ALL WATER MAIN LENGTHS SHOWN ARE APPROXIMATE.
 23. ALL EXISTING UTILITIES PROPOSED TO BE RELOCATED ON THESE PLANS SHALL BE PLACED UNDERGROUND.
 24. ALL SANITARY SEWER AND WATER DISTRIBUTION SYSTEM WORK TO BE INSTALLED BY A LICENSED UTILITY CONTRACTOR.
 25. THE CONTRACTOR SHALL COORDINATE AS REQUIRED WITH UTILITY PROVIDERS FOR INSTALLATION OF PRIMARY ELECTRIC SERVICE AND TELEPHONE SERVICE TO THE PROPOSED BUILDINGS.
 26. WHEN A WATER MAIN CROSSES OVER A SEWER MAIN, THERE MUST BE EIGHTEEN INCHES OF VERTICAL SEPARATION. WHEN A WATER MAIN CROSSES UNDER A SEWER MAIN, BOTH LINES MUST BE MADE OF DUCTILE IRON FOR A MINIMUM OF TEN FEET ON EITHER SIDE OF THE CROSSING WITH A TWELVE INCH VERTICAL SEPARATION. THE CROSSING OF SEWER MAINS OVER WATER MAINS SHALL BE MADE OF DUCTILE IRON FOR A MINIMUM OF TEN FEET. ALL DISTANCES ARE MEASURED FROM OUTSIDE DIAMETER TO OUTSIDE DIAMETER.
 27. WHEN A WATER LINE PASSES OVER OR UNDER A STORM SEWER, VERTICAL SEPARATION OF ALL DISTANCES SHALL BE MAINTAINED. WHEN A WATER LINE PASSES OVER A STORM SEWER, THE CROSSING SHALL BE MADE OF DUCTILE IRON FOR A MINIMUM OF TEN FEET. ALL DISTANCES ARE MEASURED FROM OUTSIDE DIAMETER TO OUTSIDE DIAMETER.
 28. A FIRE INSPECTOR SHALL INSPECT THE UNDERGROUND FIRE LINE PIPING FROM THE PIV TO THE BUILDING. FORTY-FOUR INCH FIRE DEPARTMENT CONNECTIONS (FDCs), THE UNDERGROUND FDC PIPING MUST BE INSPECTED BEFORE IT IS COVERED.
- DRAINAGE

24. THE CONTRA ELECTRIC SEX

26. WHEN A WATER MAIN CROSSES OVER A SEWER MAIN, THERE MUST BE EIGHTEEN INCHES OF VERTICAL SEPARATION. THE SEWER MAIN SHALL BE COVERED UNDER THE SEWER MAIN. BOTH LINES MUST BE ENCASED IN CONCRETE FOR A MINIMUM OF TEN FEET ON EITHER SIDE OF THE CROSSING WITH A TWELVE INCH VERTICAL SEPARATION. THE CROSSING OF THE SEWER MAIN OVER THE WATER MAIN SHALL BE MEASURED FROM THE TOP OF THE SEWER MAIN TO THE BOTTOM OF THE WATER MAIN. ALL DISTANCES ARE MEASURED FROM OUTSIDE DIAMETER TO OUTSIDE DIAMETER.
 27. WHEN A WATER LINE PASSES OVER OR UNDER A STORM SEWER, VERTICAL SEPARATION OF 18 INCHES SHALL BE MAINTAINED THROUGHOUT THE ENTIRE LENGTH OF THE CROSSING. IF THE WATER LINE IS ENCASED IN CONCRETE, A MINIMUM 4" THICK CONCREDE CRACKLE SHALL BE POURED BETWEEN THE TWO. DISTANCES ARE MEASURED FROM OUTSIDE DIAMETER TO OUTSIDE DIAMETER.
 - 27.A. A PIPE INSPECTOR SHALL INSPECT THE UNDERGROUND FIVE FOOT PIPING FROM THE PIV TO THE BUILDING FLOOR YARD FIRE DEPARTMENT CONNECTIONS (FDC'S). THE UNDERGROUND FDC PIPING MUST BE INSPECTED BEFORE IT IS COVERED BY ANY FINISH MATERIAL.
- DRAINAGE:
1. STORM PIPE SHALL BE AS FOLLOWS UNLESS OTHERWISE NOTED:
 - 1ST" DIAMETER AND LARGER: RCP, CLASS III PER ASTM C-76, WITH FLEXIBLE PLASTIC BUTTEND GAUGETS AT JOINTS.
 - MORE THAN 1ST" DIAMETER: PVC SCHEDULE 40 DR HOPE - ANNUAL DESIGN LOAD KILLED TIME 5, M294 TYP 15' AND MPY-87 TYPE 5, SMOOTH INTERIOR/ANGULAR EXTERIOR, ONLY PERMITTED WHEN SPECIFICALLY INDICATED ON THE CONTRACTOR DRAWINGS. PIPE SHALL BE INSTALLED IN ACCORDANCE WITH PIPE MANUFACTURER'S INSTALLATION GUIDELINES OR NDOT SPECIFICATION.
 - IF THE DRAINAGE IS MORE STRINGENT, PIPE JOINTS AND FITTINGS SHALL CONFORM TO AASHTO M292 AND M294.
 - ALL STORM DRAINAGE WITHIN THE PUBLIC RIGHT-OF-WAY SHALL BE CLASS III REINFORCED CONCRETE PIPE UNLESS OTHERWISE SPECIFIED AS CLASS IV.
 - PIPE LENGTHS AND SLOPES ARE APPROXIMATE.
 - ALL PIPES SHALL BE LAID ON STRAIGHT ALIGNMENTS AND EVEN GRADES USING A PIPE LASER OR OTHER ACCURATE METHOD.
 4. ADDITIONAL SUBSURFACE DRAINAGE MAY BE REQUIRED IN THE STREET RIGHT-OF-WAY IF DEEMED NECESSARY BY THE ENGINEER.
 5. UNDERGROUND UTILITY LINES SHALL BE INSTALLED IN ACCORDANCE WITH THE FOLLOWING STANDARDS IN ADDITION TO THEIR APPLICABLE CITIES:
 - NO. 1. NO MORE THAN 500 LF OF TRENCH MAY BE OPENED AT ONE TIME.
 2. EXCAVATED MATERIAL SHALL BE PLACED ON THE UPHILL SIDE OF TRENCHES.
 3. EFFLUENT FROM DRAINING OPERATIONS SHALL BE FILTERED OR PASSED THROUGH AN APPROVED SEDIMENT TRAPPING DEVICE PRIOR TO DISCHARGE IN A MANNER THAT DOES NOT ADVERSELY AFFECT SURROUNDING STREAMS OR OFF-SITE PROPERTY.
 4. MATERIAL USED FOR BACK-FILLING TRENCHES SHALL BE PROPERLY COMPACTED IN ORDER TO MINIMIZE SETTLEMENT.
 5. DESTABILIZATION SHALL BE ACCOMPLISHED IN ACCORDANCE WITH THE EROSION AND SEDIMENT CONTROL PLAN.
 6. APPLICABLE SAFETY REGULATIONS SHALL BE COMPLIED WITH.
 7. IF ANY EXISTING STRUCTURES TO REMAIN ARE DAMAGED DURING CONSTRUCTION, IT SHALL BE THE CONTRACTORS RESPONSIBILITY TO REPAIR AND/OR REPLACE THE EXISTING STRUCTURE AS NECESSARY TO RETURN IT TO EXISTING CONDITION.
 8. STORM PIPE ENTERING STRUCTURES SHALL BE GROUTED TO ASSURE CONNECTION AT STRUCTURE END WATERTIGHT.
 9. ALL STORM STRUCTURES SHALL HAVE A SMOOTH UNIFORM POURED MORTAR INVERT FROM INVERT TO INVERT.
 10. PRECAST STRUCTURES MAY BE USED AT CONTRACTORS OPTION, CATCH BASINS, MANHOLES, FRAMES, GRATES, ETC. SHALL MEET THE REQUIREMENTS OF THE LATEST EDITION OF THE NORTH CAROLINA DEPARTMENT OF TRANSPORT STANDARD DETAILS.
 11. THIS PLAN DETAILS PIPES UP TO 3FT FROM THE BUILDING FACE. REFER TO DRAWINGS BY OTHERS FOR CONCRETE FOUNDATIONS, CONTRACTOR SHALL SUPPLY AND INSTALL PIPE ADAPTERS AS NECESSARY.

11. ALL STORM
HAVE TRAFFIC

12. STRUCTURE RIM ELEVATIONS SHOWN HERE IN ARE APPROXIMATE. CONTRACTOR SHALL ADJUST AS NECESSARY.
13. RIM ELEVATIONS AS SHOWN ON THE CONSTRUCTION DRAWINGS REFLECT FINISHED GRADES. RIM ELEVATIONS REFER TO THE CENTER OF DROP INLETS, MANHOLES, AND JUNCTION BOXES, AND THE GUTTER FLOW LINE FOR CURB INLETS, UNLESS OTHERWISE NOTED.

- RETAINING WALL NOTES:

1. STRUCTURAL AND SUBSURFACE DRAINAGE DESIGN FOR RETAINING WALLS ARE NOT ADDRESSED IN CULVANS BY KIRBY-HORN AND ASSOCIATES, REFER TO RETAINING WALL SHEETS IN THIS PLAN SET.
2. BOTTOM OF WALL ("BW") GRADINGS SHOWN ON THESE PLANS REPRESENT FINISHED GROUND ADJACENT TO LOW SIDE OF WALL. ELEVATION ("TW") ELEVATIONS SHOWN ON THESE PLANS REPRESENT FINISHED GROUND TO HIGH SIDE OF WALL TO GRADING PLANS IN THIS PLAN SET FOR ALL TW AND BW ELEVATIONS.
3. RETAINING WALLS WITH ELEVATION DROP EXCEEDING 2'-6" IN HEIGHT SHALL HAVE GUARDRAILS OR FENCING FOR FALL PROTECTION
- BACKFLOW PREVENTION NOTES:**
- 1. THERE SHALL BE NO TAPS, PIPING BRANCHES, UNAPPROVED BYPASS PIPES, HYDRANTS, FIRE DEPARTMENT CONNECTION POINTS OR OTHER PIPING/USE APPURTENANCES CONNECTED TO THE SUPPLY LINE BETWEEN ANY PROPERTY LINE AND AS SHOWN IN THE LOCATION OF THE UTILITY PLAN.
 - 2. ALL REQUIRED BACKFLOW PREVENTER ASSEMBLIES BE REQUIRED TO BE TESTED BY AN APPROVED CERTIFIED TECHNICIAN PRIOR TO PLACING THE WATER SYSTEM INTO SERVICE.
 - 3. THE DOMESTIC BACKFLOW PREVENTER SHALL BE INSTALLED PER THE CITY OF RALEIGH REGULATIONS AT THE PROPERTY LINE AND AS SHOWN IN THE LOCATION OF THE UTILITY PLAN.
 - 4. THE FIRE BACKFLOW PREVENTER SHALL BE INSTALLED PER THE CITY OF RALEIGH REGULATIONS AT THE PROPERTY LINE AND AS SHOWN IN THE LOCATION OF THE UTILITY PLAN.
 - 5. THE IRRIGATION BACKFLOW PREVENTER SHALL BE INSTALLED PER THE CITY OF RALEIGH REGULATIONS AT THE PROPERTY LINE AND AS SHOWN IN THE LOCATION OF THE UTILITY PLAN.

- ATTENTION CONTRACTORS**
- The Construction Contractor responsible for the extension of sewer, and/or reuse, as approved in these plans, is responsible for contacting the Public Works Department at (919) 936-2889 or Public Utilities Department at (919) 936-6340 at least twenty-four hours prior to beginning any of their construction.

The Construction Contractor responsible for the extension, sewer, and/or reuse, as approved in these plans, is responsible for contacting the Public Works Department at (919) 996-2489, Public Utilities Department at (919) 996-4540 at least twenty-four hours prior to beginning any of their construction.

811
Now what's below

Know what's below. **Call** before you dig.

2. CONTRACTOR IS RESPONSIBLE FOR PROPERLY DISPOSING OF EXCESS MATERIAL OFF-SITE.
3. CONTRACTOR SHALL INSTALL AND MAINTAIN THROUGHTOUT THE CONSTRUCTION PROJECT ALL EROSION CONTROL MEASURES AS SPECIFIED IN THE CONTRACT. IN ACCORDANCE WITH APPLICABLE STANDARDS FROM THE U.S. ARMY CORPS OF ENGINEERS, QUALITY SEDIMENT CONTROL REGULATIONS.
4. GROUND COVER SHALL BE ESTABLISHED PER "SEEDING PREPARATION NOTES" PROVIDED IN THE CONTRACT DETAILS.
5. THE CONTRACTOR SHALL PROVIDE GROUND COVER ON DESIGNATED AREAS AND SLOPES GREATER THAN 3:1 UNTIL THE FOLLOWING COMPLETION OF A PHASE OF GRADING. CONTRACTOR SHALL PROVIDE GROUND COVER IN 14 DAYS ON ALL OTHER AREAS FOLLOWING COMPLETION OF A PHASE OF GRADING. GROUND COVER SHALL BE MAINTAINED THROUGHOUT THE CONSTRUCTION PERIOD, INCLUDING DURING 90 CALENDAR DAYS (WHICHEVER IS SHORTER) FOLLOWING COMPLETION OF CONSTRUCTION.
6. DURING CONSTRUCTION OF THE PROJECT, SOIL STOCKPILES AND BORROW AREAS SHALL BE STABILIZED OR COVERED WITH EROSION CONTROL MEASURES TO PREVENT EROSION AND TO PREVENT SEDIMENTATION AND PERMANENT STABILIZATION OF ALL SOIL STOCKPILES ON SITE AS WELL AS BORROW AREAS. EROSION CONTROL MEASURES SHALL BE MAINTAINED THROUGHOUT THE CONSTRUCTION PERIOD.
7. SEDIMENT BASINS AND TRAPS, PERMITTEE DICES, SEDIMENT BARRIERS, AND OTHER MEASURES INTENDED TO PREVENT SEDIMENT SHALL BE CONSTRUCTED AS A FIRST STEP IN ANY LAND-DISTURBING ACTIVITY AND CONSTRUCTION OF THESE MEASURES SHALL BE COMPLETED PRIOR TO ANY OTHER ACTIVITY.
8. WHERE CONSTRUCTION VEHICLE ACCESS ROUTES INTERSECT PAVED OR PUBLIC ROADS, PROVISIONS SHALL BE MADE TO MINIMIZE THE TRANSPORT OF SEDIMENT BY VEHICULAR TRAFFIC ONTO THE PAVED SURFACE. SEDIMENT TRAPS SHALL BE INSTALLED AT ALL SUCH INTERSECTIONS. TRAPS SHALL BE MAINTAINED AND CLEANED THROUGHTOUT THE END OF EACH DAY. SEDIMENT SHALL BE REMOVED FROM THE TRAPS AND DISPOSED OFF-SITE. SWEEPING SHALL BE PERFORMED DAILY. SEDIMENT TRAPS SHALL BE MAINTAINED AND STREET WASHING SHALL BE ALLOWED ONLY AFTER SEDIMENT IS REMOVED IN THIS MANNER.
9. ALL TEMPORARY EROSION AND SEDIMENT CONTROL MEASURE SHALL BE REMOVED WITHIN 30 DAYS AFTER COMPLETION OF THE CONSTRUCTION OF THE PROJECT. PERMANENT EROSION CONTROL MEASURES SHALL HAVE BEEN OBTAINED FROM THE CITY OF RALEIGH INSPECTIONS DEPARTMENT, TRAPPED SEDIMENT SHALL BE REMOVED AND DISPOSED OFF-SITE. EROSION CONTROL MEASURES SHALL BE PERMANENTLY STABILIZED TO PREVENT FURTHER EROSION AND SEDIMENTATION.
10. ALL EROSION CONTROL MEASURES SHALL BE CONSTRUCTED IN ACCORDANCE WITH THE NORTH CAROLINA CONSTRUCTION EROSION CONTROL MEASURES ACT, CHAPTER 113, AND THE U.S. ARMY CORPS OF ENGINEERS, U.S. SOIL CONSERVATION SERVICE, AND CITY OF RALEIGH REQUIREMENTS.
11. THE CONTRACTOR SHALL DULIGENTLY AND CONTINUOUSLY MAINTAIN ALL EROSION CONTROL DEVICES AND MEASURES THROUGHOUT THE CONSTRUCTION PERIOD. THE CONTRACTOR SHALL BE RESPONSIBLE FOR THE CONTRACT INSPECTOR SO THAT PERIODIC INSPECTIONS CAN BE PERFORMED AT APPROPRIATE STAGES OF CONSTRUCTION.
12. A COPY OF THE APPROVED EROSION AND SEDIMENT CONTROL PLAN AND PERMIT SHALL BE MAINTAINED ON THE SITE AT ALL TIMES.
13. STABILIZATION IS THE BEST FORM OF EROSION CONTROL. ALL DISTURBED AREAS WHICH ARE NOT OTHERWISE PROTECTED BY EROSION CONTROL MEASURES SHALL BE STABILIZED BY SEEDING OR PERMANENTLY COVERED WITH EROSION CONTROL MEASURES. THE CONTRACTOR SHALL MAINTAIN ALL EROSION CONTROL MEASURES IN ACCORDANCE WITH THE CITY OF RALEIGH SEDIMENT CONTROL REGULATIONS, PERMANENT SEEDING AND COVERING SHALL BE MAINTAINED THROUGHOUT THE CONSTRUCTION PERIOD.
14. CONTRACTOR TO INSURE THAT SEDIMENT LADEN RUNOFF DOES NOT LEAVE SITE, BUT IS ENTER PROTECTED AREAS. ANY SEDIMENT DEPOSITED BEYOND DISTURBED AREA WITHIN SITE LIMITS SHALL BE REMOVED.
15. WHEN A CRUSHED STONE CONSTRUCTION ENTRANCE HAS BEEN COVERED WITH SOIL OR HAS BEEN PUSHED INTO THE SOIL BY CONSTRUCTION TRAFFIC, IT SHALL BE REPLACED WITH A DEPTH OF STONE EQUAL TO THE ORIGINAL DEPTH.
16. ALL DRAINAGE INLETS SHALL BE PROTECTED FROM SILTATION. EFFECTIVE PROTECTION DEVICES SHALL BE IMMEDIATELY REPLACED AND THE INLET CLEANED. FLUSHING IS NOT AN ACCEPTABLE METHOD OF PROTECTION.
17. DURING DRAINATING OPERATIONS, WATER SHALL BE PUMPED INTO AN APPROVED DRAINING DEVICE PRIOR TO STABILIZATION TO RECEIVING OUTLET.
18. DISCHARGE MEASURES SHALL BE APPLIED TO STRUCTURES SUCH AS DAMS, DIKES AND OVERSILLS TO PREVENT EROSION.

DEMOLITION NOTES

1. THE CONTRACTOR SHALL COORDINATE ALL REMOVAL EFFORTS WITH THE OWNER. COORDINATION ITEMS ARE TO BE MAINTAINED FOR THE PROJECT, INCLUDING RECORDS, MAINTENANCE OF ACCESS AND UTILITIES FOR EXISTING BUILDINGS TO REMAIN, AND EROSION CONTROL.
2. ALL FEATURES MARKED TO BE ABANDONED IN PLACE SHALL REMAIN IN EXISTING CONDITION UNLESS REMOVED THROUGH EFFORTS FOR OTHER FEATURES.
3. ALL FEATURES MARKED TO BE REMOVED SHALL BE MAINTAINED AS MUCH AS POSSIBLE UNTIL THE FINAL REMOVAL. IN THE EVENT OF AN IMPACT TO SUCH FEATURES, THE CONTRACTOR SHALL PERFORM REPAIR AND/OR RESTORATION TO ORIGINAL CONDITION AS OF START OF WORK.
4. WHERE PAVEMENT REMOVAL AHEAD ADJUT OTHER PAVEMENT AREAS TO REMAIN, THE EXISTING PAVEMENT SHALL BE CUT TO PROVIDE A ROUNDABOUT WHICH IS STRAIGHT AND CLEAN IN APPEARANCE.
5. ALL SANITARY SEWER MAIN FEATURES WILL GENERALLY BE PROTECTED IN PLACE UNLESS SPECIFICALLY MARKED FOR REMOVAL.
6. THE CONTRACTOR SHALL PROPERLY AND LEGALLY DISPOSE OF ALL DEMOLITION DEBRIS OFF OF THE CONSTRUCTION SITE.

TREE PROTECTION NOTES:

- THE CONTRACTOR SHALL PROTECT ALL TREES AND SHRUBS OUTSIDE OF CUT/FILL LINES, IN ADDITION TO THOSE THAT RECEIVE TREE/SHRUB PROTECTION BARRIERS. THE CONTRACTOR IS ALSO REQUESTED TO SAVE TREES AND SHRUBS THAT ARE NOT IN THE CUT/FILL AREAS.
- WHEN ROOT PRUNING IS NECESSARY, USE A TENCHER TO CUT AREA WHERE APPROPRIATE ROOT HANDLING SHOULD BE PERFORMED; TO PRUNE ROOTS LARGER THAN THE CAPABILITY OF A TENCHER, USE HAND SAWING TO CLEAR THE AREA. REMOVE AND DISPOSE OF ALL ROOTS AND BRANCHES. REMOVE PLYWOOD FORMS WHEN TREE ROOTS ARE ADJACENT TO PROPOSED CURB AND GUTTER.
3. NO SOIL DISTURBANCE OR COMPACTION, CONSTRUCTION MATERIALS, TRAFFIC, BURNING, PILES, TENDING OR OTHER ACTS THAT COULD DAMAGE OR DESTROY TREES AND SHRUBS SHALL BE ALLOWED. TREES AND SHRUBS SHALL BE INSTALLED BEFORE ANY DEMOLITION, GRADING, OR CONSTRUCTION BEGINS, AND NOT REMOVED UNTIL FINAL GRADING IS COMPLETE.
4. NO GRUBBING WITH TREE PROTECTION ZONE, LEAVE SOIL AND LEAF LITTER UNDISTURBED, SUPPLEMENT WITH 1-2 INCHES OF MULCH. RE-SEED WITH GRASS ONLY IN DISTURBED/GRADING AREAS.
5. TREE BARRICADES MUST BE INSTALLED BEFORE ANY DEMOLITION, GRADING, GROUND, AND IS NOT TO BE REMOVED UNTIL THE PROJECT IS COMPLETE.

ALL CONSTRUCTION TO BE IN ACCORDANCE WITH ALL CITY OF RALEIGH, WAKE COUNTY, AND NCDOT STANDARDS AND SPECIFICATIONS; MORE STRINGENT SHALL GOVERN.

SURVEY NOTE:
ALL EXISTING TOPOGRAPHICAL, BOUNDARY,
SUBSURFACE UTILITY INFORMATION WAS PROVIDED
WITHIN A TOPOGRAPHIC SURVEY OF PLEASANT
VALLEY SHOPPING CENTER PREPARED BY GSC
SURVEYING, INC., 4072 BARRETT DRIVE, RALEIGH, NC
27609, (919) 787-5805, DATED 10/10/2018 AND
REVISED 03/10/2023.

Kimley»»Horn
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21 FAYETTEVILLE STREET, SUITE 600, RALEIGH, NC 27601
PHONE: 919-677-2000 FAX: 919-677-2050
WWW.KIMLEY-HORN.COM

11

1

KHA PROJECT	DATE	SCALE	DESIGNED BY	DRAWN BY
017377022	03/31/2023	AS SHOWN	JAC	SET

TES

GENERAL NO

GENERAL


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1	

KEY PROMET
Y - PHASE
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[illegible]

1. CHARLES M. SMITH CERTIFY THAT THIS PROJECT WAS COMPLETED UNDER MY DIRECT AND RESPONSIBLE CHARGE FROM AN ACTUAL SURVEY MADE UNDER MY SUPERVISION; THAT THIS AIRBORNE/GROUND SURVEY WAS PERFORMED AT THE 80 PERCENT CONFORMANCE LEVEL TO MEET FEDERAL GOVERNMENT AND STATE REQUIREMENTS FOR AERIAL PHOTOGRAPHY; THAT THIS SURVEY WAS PERFORMED TO MEET THE REQUIREMENTS FOR A TOPOGRAPHIC/PLANNING SURVEY TO THE ACCURACY OF CLASS A AND VERTICAL ACCURACY WITHIN 1/30 OF THE HORIZONTAL ACCURACY; THAT THE SURVEY DATA WAS OBTAINED ON 5/7/78 THROUGH 5/23/78; THAT THE SURVEY WAS COMPLETED ON MARCH 9, 2003; THAT CONTIGUOUS BROWN AIR SOLID LINES MAY NOT MEET THE STATE STANDARD; AND ALL COORDINATES AND HEIGHTS ARE BASED ON NAD 83. MISSOURI STATE ROAD 65 (2011) AND ALL ELEVATIONS ARE BASED ON NAD 86.

CHIEF W. BETH MC BRIDE 5/9/95
DATE

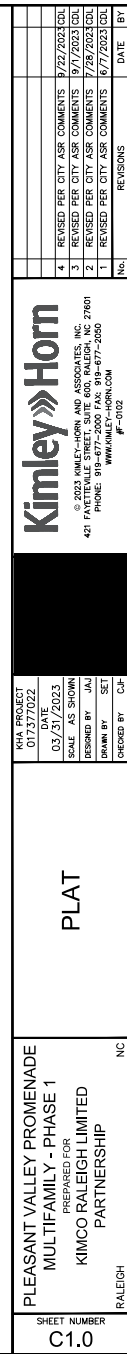

GSC SURVEYING

SSG PROJECT: 22041
AN UPDATED TOPOGRAPHIC SURVEY OF
PLEASANT VALLEY

DATE: MAR. 5, 2023	SCALE: 1" = 20'	SHEET: 1 OF 2
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TOPOGRAPHIC
SURVEY


PLEASANT VALLEY PROMENADE
MULTIFAMILY - PHASE 1
PREPARED FOR
KIMCO RALEIGH LIMITED
PARTNERSHIP

SHEET NUMBER
C1.1

Kimlev» Horn

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421 FAYETTEVILLE STREET, SUITE 600, RALEIGH, NC 27601
PHONE: 919-677-2000 FAX: 919-677-2050
WWW.KIMLEY-HORN.COM

No.	REVISIONS	DATE	BY
4	REVISED PER CITY ASR COMMENTS	9/22/2023	COL
3	REVISED PER CITY ASR COMMENTS	9/1/2023	COL
2	REVISED PER CITY ASR COMMENTS	7/28/2023	COL
1	REVISED PER CITY ASR COMMENTS	6/7/2023	COL

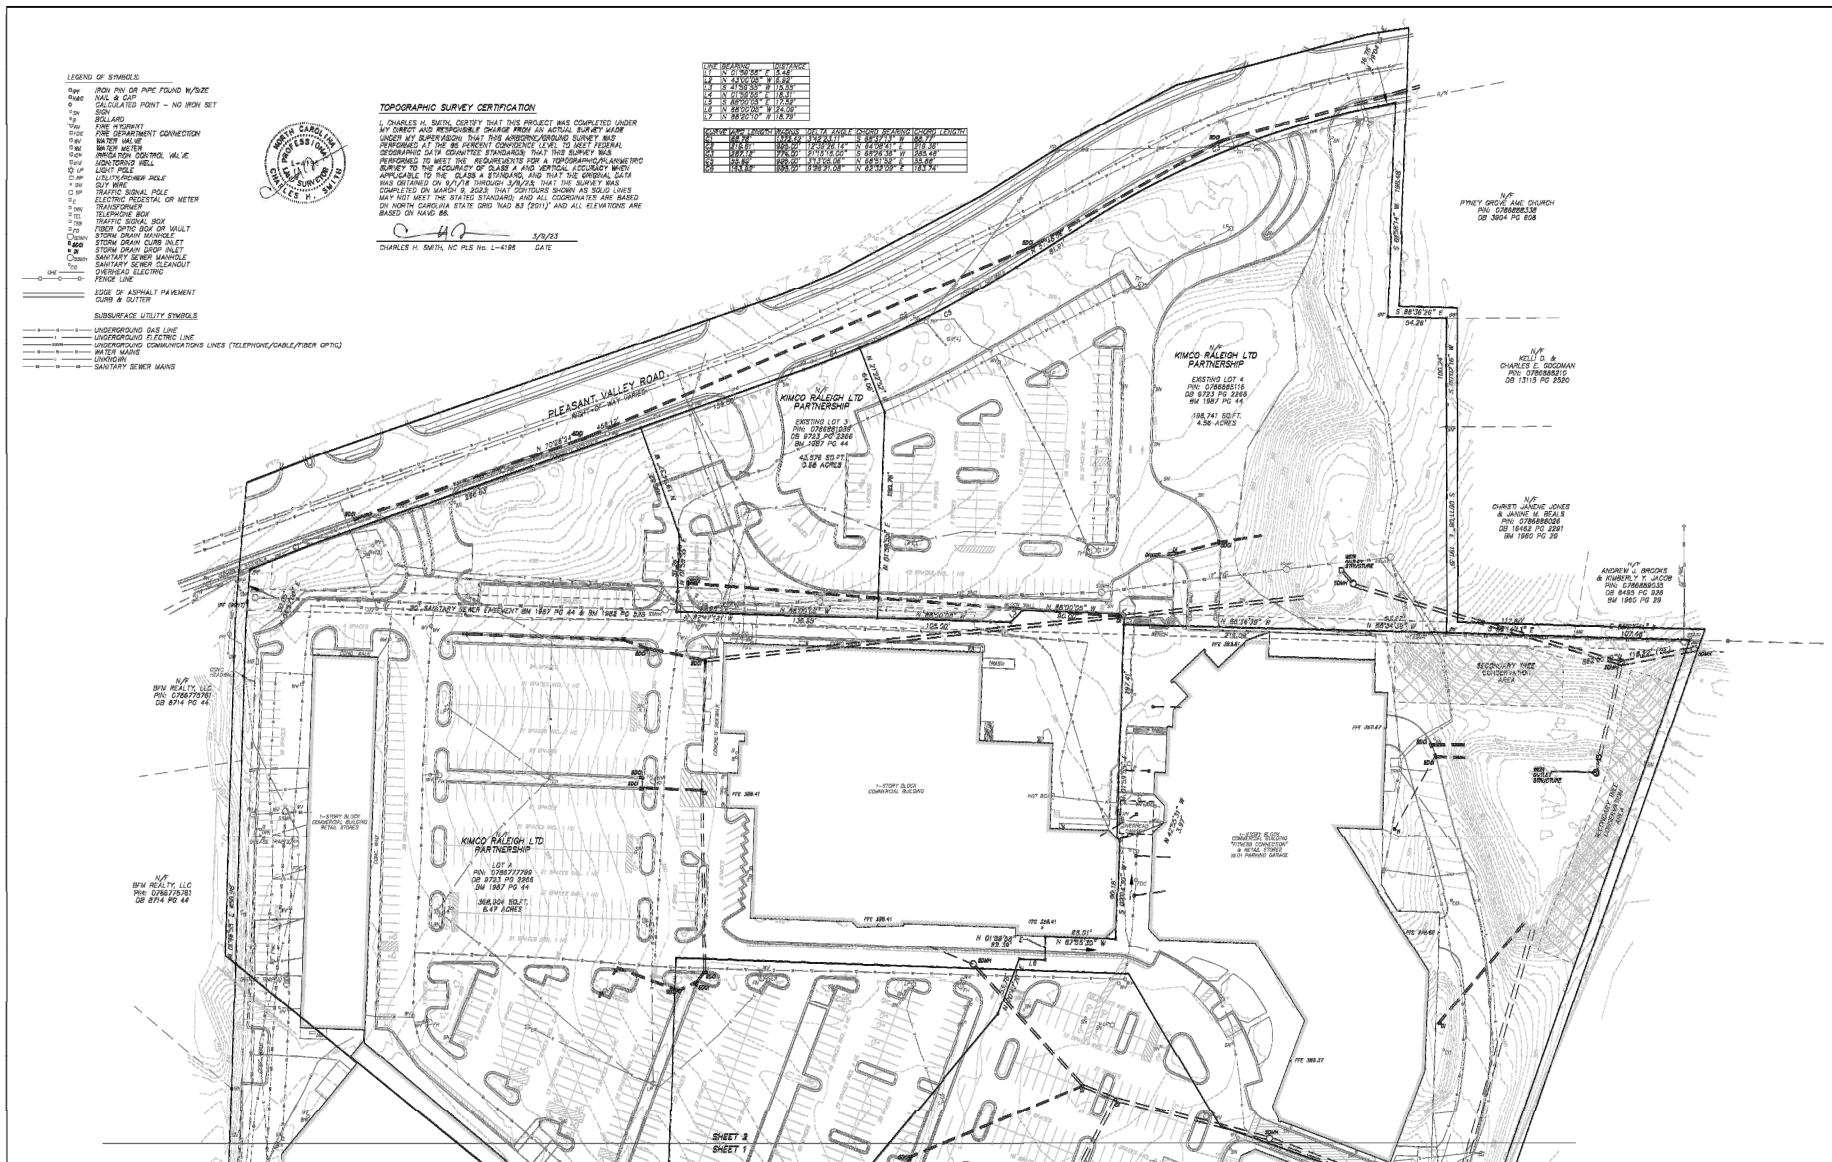

GSC SURVEYING
4078 BARRETT DRIVE
RALEIGH, NC 27608
PHONE (919) 767-8803
FAX (919) 767-8804

SSG PROJECT: 22041
A PARTIAL TOPOGRAPHIC SURVEY OF
PLEASANT VALLEY
SHOPPING CENTER AND
PLEASANT VALLEY ROAD
CITY OF RALEIGH, WAKE COUNTY, NC


PLEASANT VALLEY PROMENADE
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TOPOGRAPHIC
SURVEY


KHA PROJECT	DATE	SCALE	AS SHOW	DESIGNED BY	JA	DRAWN BY	SE
017377022	03/31/2023						

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No.	Revisions	Date	By
4	REVISED PER CITY ASR COMMENTS	9/22/2023	COL
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PROPERTY ADJUSTMENT LEGEND	
	EXISTING PROPERTY LINES
	PROPOSED PROPERTY LINES
	ACCESS EASEMENT
	UTILITY EASEMENT
	SLOPE EASEMENT
	DRAINAGE EASEMENT
	RIGHT-OF-WAY DEDICATION
	PROPOSED TREE CONSERVATION AREA



PARCEL AREA TABLE

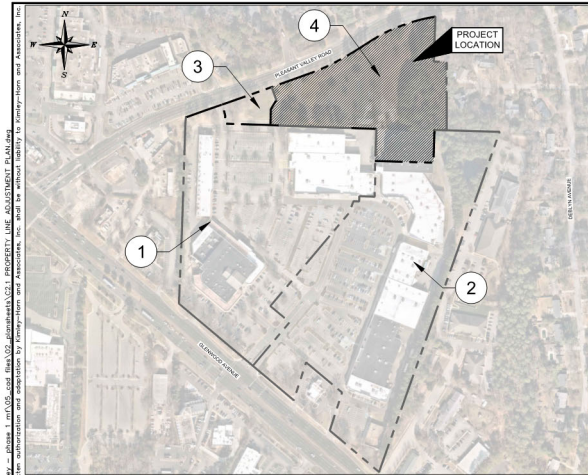SHOPPING CENTER PARCELS	PIN	PARCEL ID#	EXISTING AREA	AREA LOST	AREA GAINED	RIGHT-OF-WAY DEDICATION	NET AREA
(1) 6250 GLENWOOD AVENUE	#0786779662	#0453609	14.15 AC / 616,166 SF	0.10 AC / 4,399 SF (TO LOT 4) 0.62 AC / 26,881 SF (TO LOT 3)	N/A	0.02 AC / 961 SF	13.40 AC / 583,924 SF
(2) 6204 GLENWOOD AVENUE	#0786874371	#0453610	16.27 AC / 708,546 SF	0.79 AC / 34,370 SF (TO LOT 4)	N/A	0 AC / 0 SF	15.48 AC / 674,176 SF
MULTIFAMILY PARCELS	PIN	PARCEL ID#	EXISTING AREA	AREA LOST	AREA GAINED	RIGHT-OF-WAY DEDICATION	NET AREA
(3) 4001 PLEASANT VALLEY ROAD	#0786881039	#0023667	98 AC / 42,576 SF	0.98 AC / 42,576 SF (TO LOT 4)	0.62 AC / 26,881 SF (FROM LOT 1)	0.04 AC / 1,545 SF	0.58 AC / 25,336 SF
(4) 3917 PLEASANT VALLEY ROAD	#0786881116	#0453611	4.56 AC / 198,741 SF	N/A	0.10 AC / 4,399 SF (FROM LOT 1) 0.79 AC / 34,370 SF (FROM LOT 2) 0.98 AC / 42,576 SF (FROM LOT 3)	0.10 AC / 4,549 SF	6.33 AC / 275,538 SF

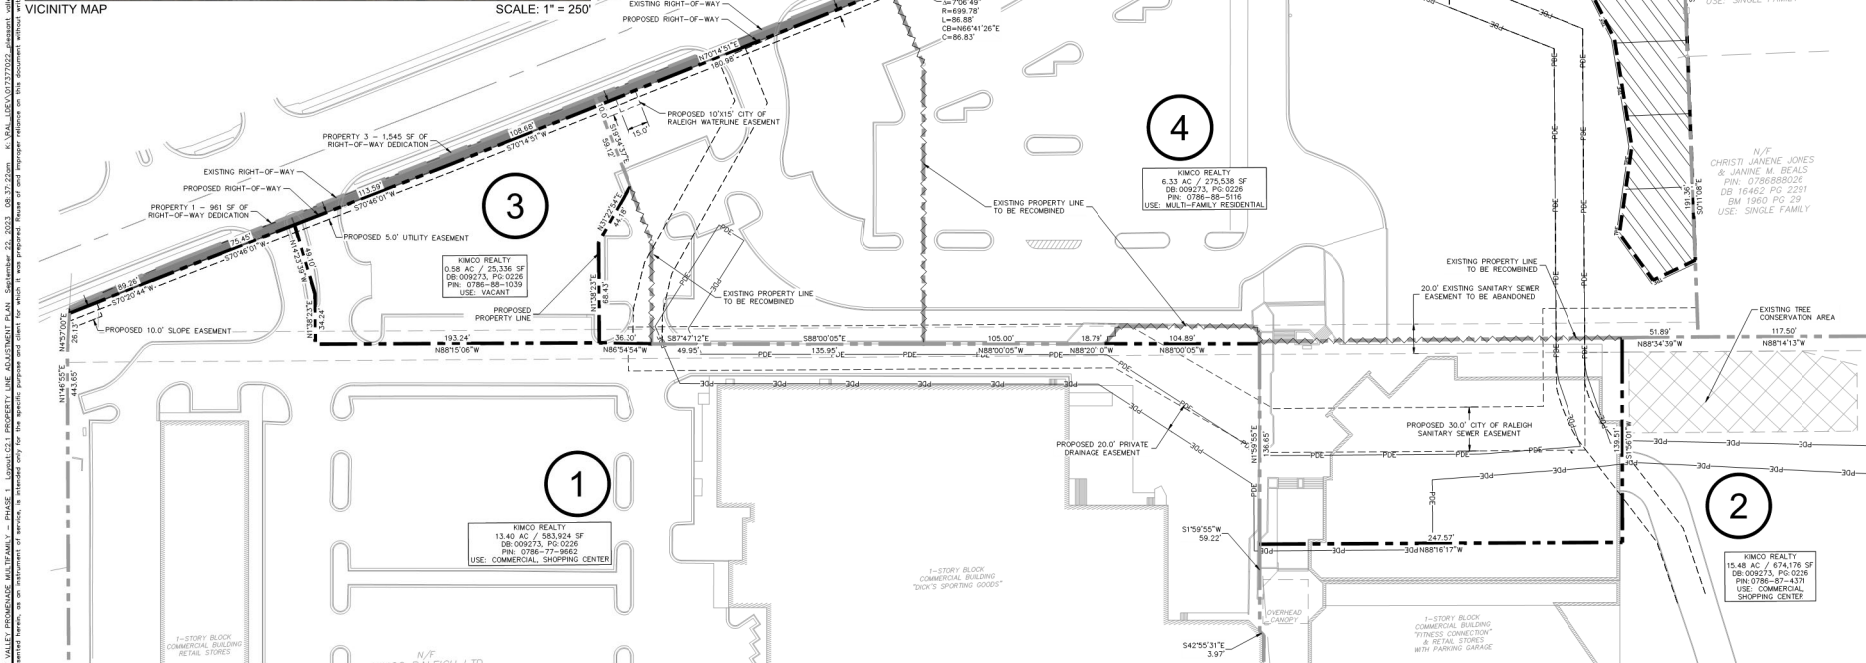

Know what's below.
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FOR REVIEW ONLY
NOT FOR CONSTRUCTION

ALL CONSTRUCTION TO BE IN ACCORDANCE WITH ALL CITY OF RALEIGH, WAKE COUNTY, AND NCDDOT STANDARDS AND SPECIFICATIONS, MORE STRINGENT SHALL GOVERN.

SURVEY NOTE:
ALL EXISTING TOPOGRAPHICAL, BOUNDARY, SUBSURFACE UTILITY INFORMATION WAS PROVIDED WITHIN A TOPOGRAPHIC SURVEY OF PLEASANT VALLEY SHOPPING CENTER PREPARED BY GSC SURVEYING, INC. 4072 BARRETT DRIVE, RALEIGH, NC 27609, (919) 787-5805, DATED 10/16/2018 AND REVISED 03/10/2023.

PROPERTY LINE
ADJUSTMENT PLAN

PLEASANT VALLEY PROMENADE
MULTIFAMILY - PHASE 1
PREPARED FOR
KIMCO RALEIGH LIMITED
PARTNERSHIP

SHEET NUMBER
C2.1


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NO.	REVISIONS	DATE	BY
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1	REVISED PER CITY ASR COMMENTS	6/7/2023	COL

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SITE LEGEND

- PROPOSED PROPERTY LINE
- EXISTING PROPERTY LINE
- BUILDING SETBACK
- FENCE
- RETAINING WALL
- HANDRAILS
- STANDARD CURB AND GUTTER
- PARKING SPACE COUNT
- SID (SEE PLAN)
- LIGHT POLE
- WHEEL STOP
- ACCESSIBLE PARKING MARKING (V INDICATES VAN ACCESSIBLE)
- DIRECTIONAL PAVEMENT ARROWS
- ACCESSIBLE RAMP
- DEPRESSED CURB RAMP
- LIGHT DUTY ASPHALT
- HEAVY DUTY ASPHALT
- STANDARD DUTY CONCRETE
- HEAVY DUTY CONCRETE
- BUILDING - MODULE 1
- BUILDING - MODULE 2
- BUILDING - MODULE 3
- PARKING DECK



KIMCO REALTY
0.58 AC / 25,336 SF
DB: 000273, PG: 0228
PIN: 0786-88-1039
USE: VACANT

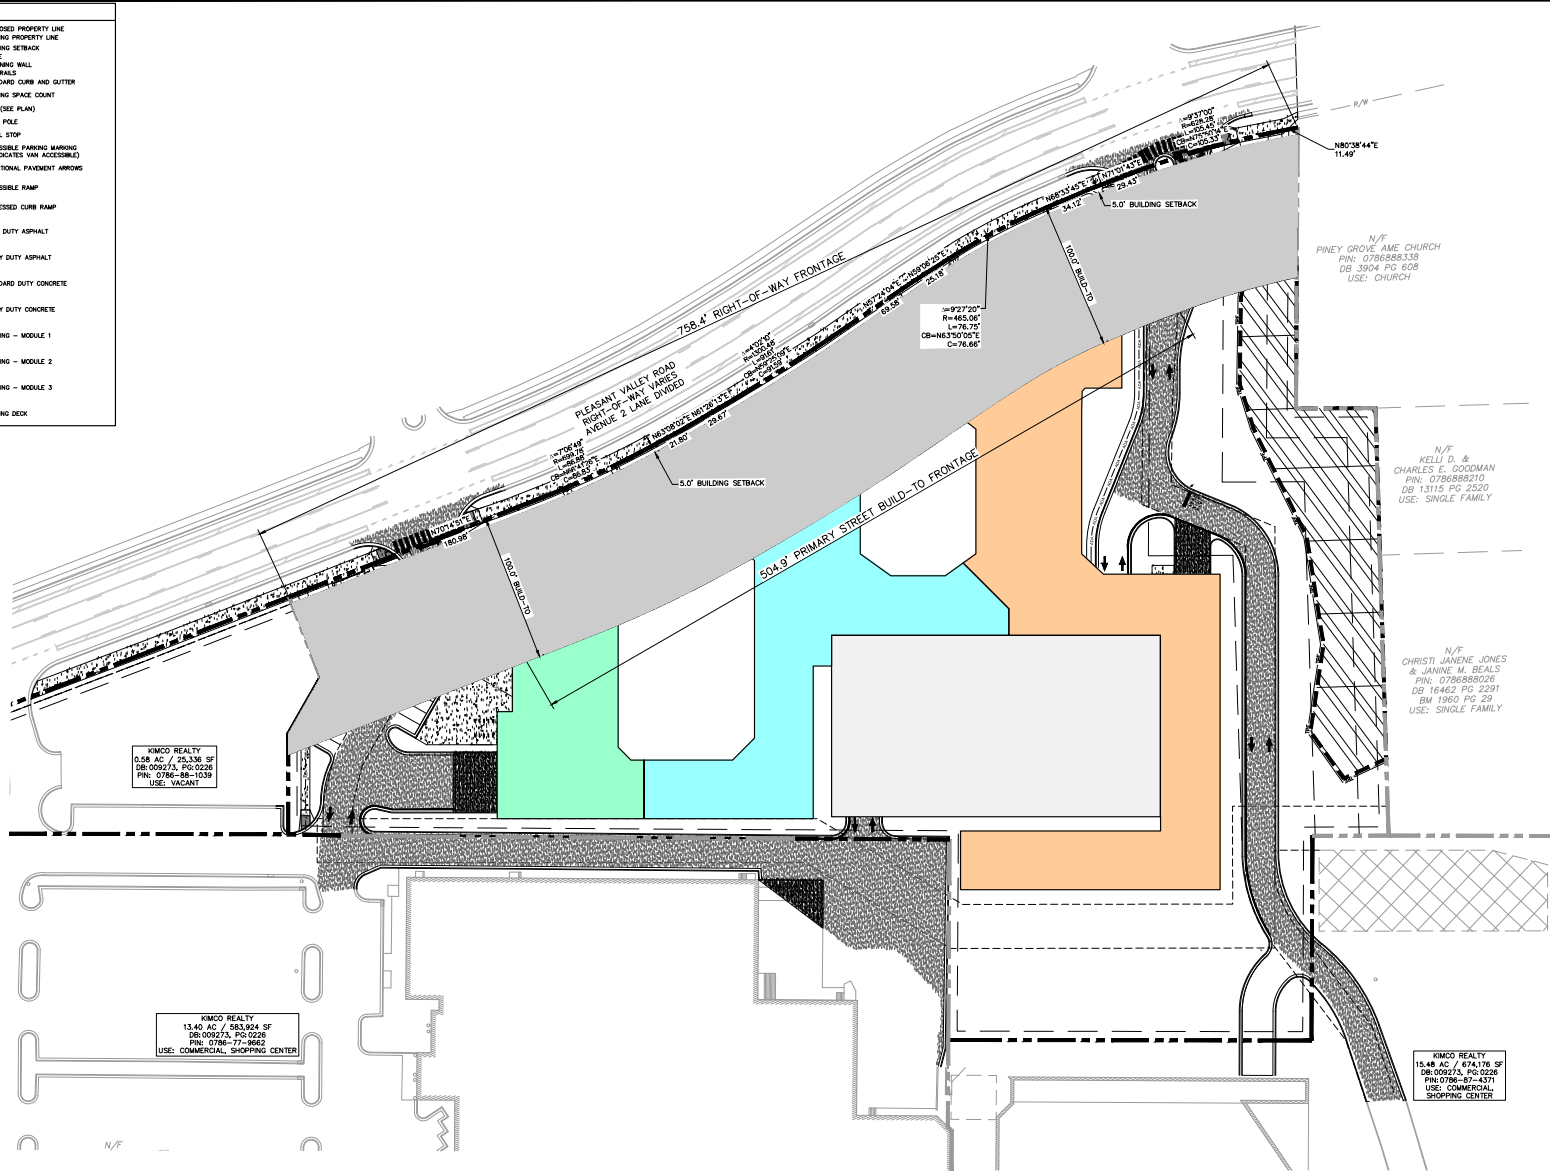KIMCO REALTY
13.40 AC / 583,824 SF
DB: 000273, PG: 0228
PIN: 0786-77-8662
USE: COMMERCIAL SHOPPING CENTER

KIMCO REALTY
15.48 AC / 674,176 SF
DB: 000273, PG: 0228
PIN: 0786-87-4371
USE: COMMERCIAL SHOPPING CENTER

BUILD-TO TABLE					
STREET TYPE	FRONTAGE (LF)	% REQUIRED WITH BUILDING	LF REQUIRED WITH BUILDING	% PROVIDED WITH BUILDING	LF PROVIDED WITH BUILDING
PRIMARY STREET (PLEASANT VALLEY ROAD)	758.40	50%	379.20	66.57%	504.90
SIDE STREET (N/A)	N/A	25%	N/A	N/A	N/A

SURVEY NOTE:
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ALL CONSTRUCTION TO BE IN ACCORDANCE WITH ALL CITY OF RALEIGH, N/A COUNTY, AND NCDDY STANDARDS AND SPECIFICATIONS. MORE STRINGENT SHALL GOVERN.



GRAPHIC SCALE IN FEET
0 20 40 80

FOR REVIEW ONLY
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BUILD-TO PLAN

PLEASANT VALLEY PROMENADE
MULTIFAMILY - PHASE 1
PREPARED FOR
KIMCO RALEIGH LIMITED
PARTNERSHIP

RALEIGH NC


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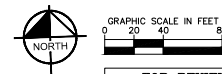
811
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REVISIONS

No.	REVISIONS	DATE	BY
1	REVISED PER CITY ASR COMMENTS	6/7/2023	DL
2	REVISED PER CITY ASR COMMENTS	7/28/2023	DL
3	REVISED PER CITY ASR COMMENTS	9/1/2023	DL
4	REVISED PER CITY ASR COMMENTS	9/22/2023	DL



40.000ft
8.333ft
11.000ft
1.393ft
8.333ft
6.00s
45.00°

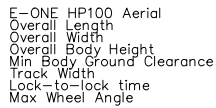

ALL CONSTRUCTION TO BE IN ACCORDANCE WITH ALL CITY OF RALEIGH, WAKE COUNTY, AND NCDOT STANDARDS AND SPECIFICATIONS; MORE STRINGENT SHALL GOVERN.

SURVEY NOTE:
ALL EXISTING TOPOGRAPHICAL, BOUNDARY,
SUBSURFACE UTILITY INFORMATION WAS PROVIDED
WITHIN A TOPOGRAPHIC SURVEY OF PLEASANT
VALLEY SHOPPING CENTER PREPARED BY GSC
SURVEYING, INC., 4072 BARRETT DRIVE, RALEIGH, NC
27609, (919) 787-5805, DATED 10/10/2018 AND
REVISED 03/10/2023.



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No.	Revisions	Date	By
4	REVISED PER CITY ASR COMMENTS	9/22/2023	GDL
3	REVISED PER CITY ASR COMMENTS	9/1/2023	GDL
2	REVISED PER CITY ASR COMMENTS	7/28/2023	GDL
1	REVISED PER CITY ASR COMMENTS	6/7/2023	GDL

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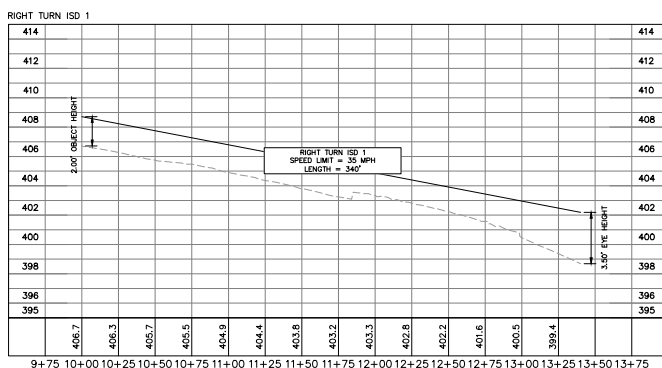
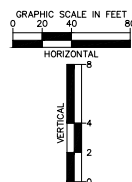
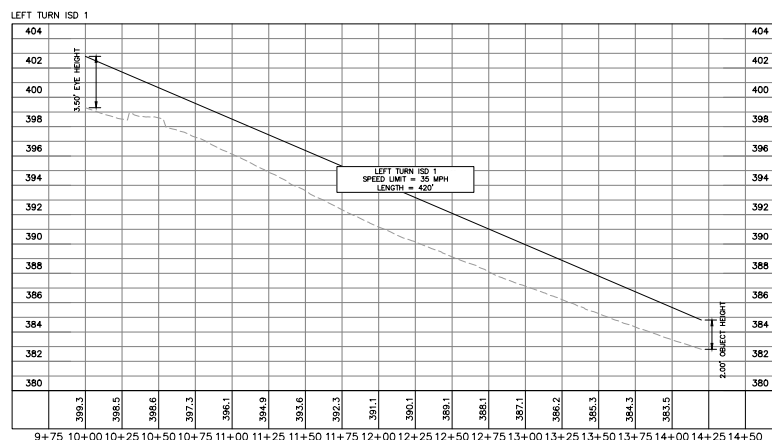
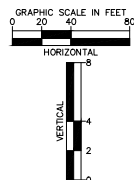
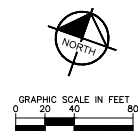
KHA PROJECT	DATE	SCALE	AS SHOWN	DESIGNED BY	JA.	SET	CJH
017377022	03/31/2023						

FIRE APPARATUS AND HOSE LAY PLAN

PLEASANT VALLEY PROMENADE
MULTIFAMILY - PHASE 1
PREPARED FOR
KIMCO RALEIGH LIMITED
PARTNERSHIP

SHEET NUMBER
C3.2

[illegible]



ALL CONSTRUCTION TO BE IN ACCORDANCE WITH THE
ALL CITY OF RALEIGH, WAKE COUNTY, AND N.C. DEPARTMENT OF
STANDARDS AND SPECIFICATIONS; MORE STRINGENT STANDARDS
SHALL GOVERN.

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SURVEY NOTE:
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SUBSURFACE UTILITY INFORMATION WAS PROVIDED
WITHIN A TOPOGRAPHIC SURVEY OF PLEASANT
VALLEY SHOPPING CENTER PREPARED BY GSC
SURVEYING, INC., 4072 BARRETT DRIVE, RALEIGH, NC
27609, (919) 787-5805, DATED 10/10/2018 AND
REVISED 03/10/2023.

PLEASANT VALLEY PROMENADE
MULTIFAMILY - PHASE 1
PREPARED FOR
KIMCO RALEIGH LIMITED
PARTNERSHIP

SHEET NUMBER
C3.3

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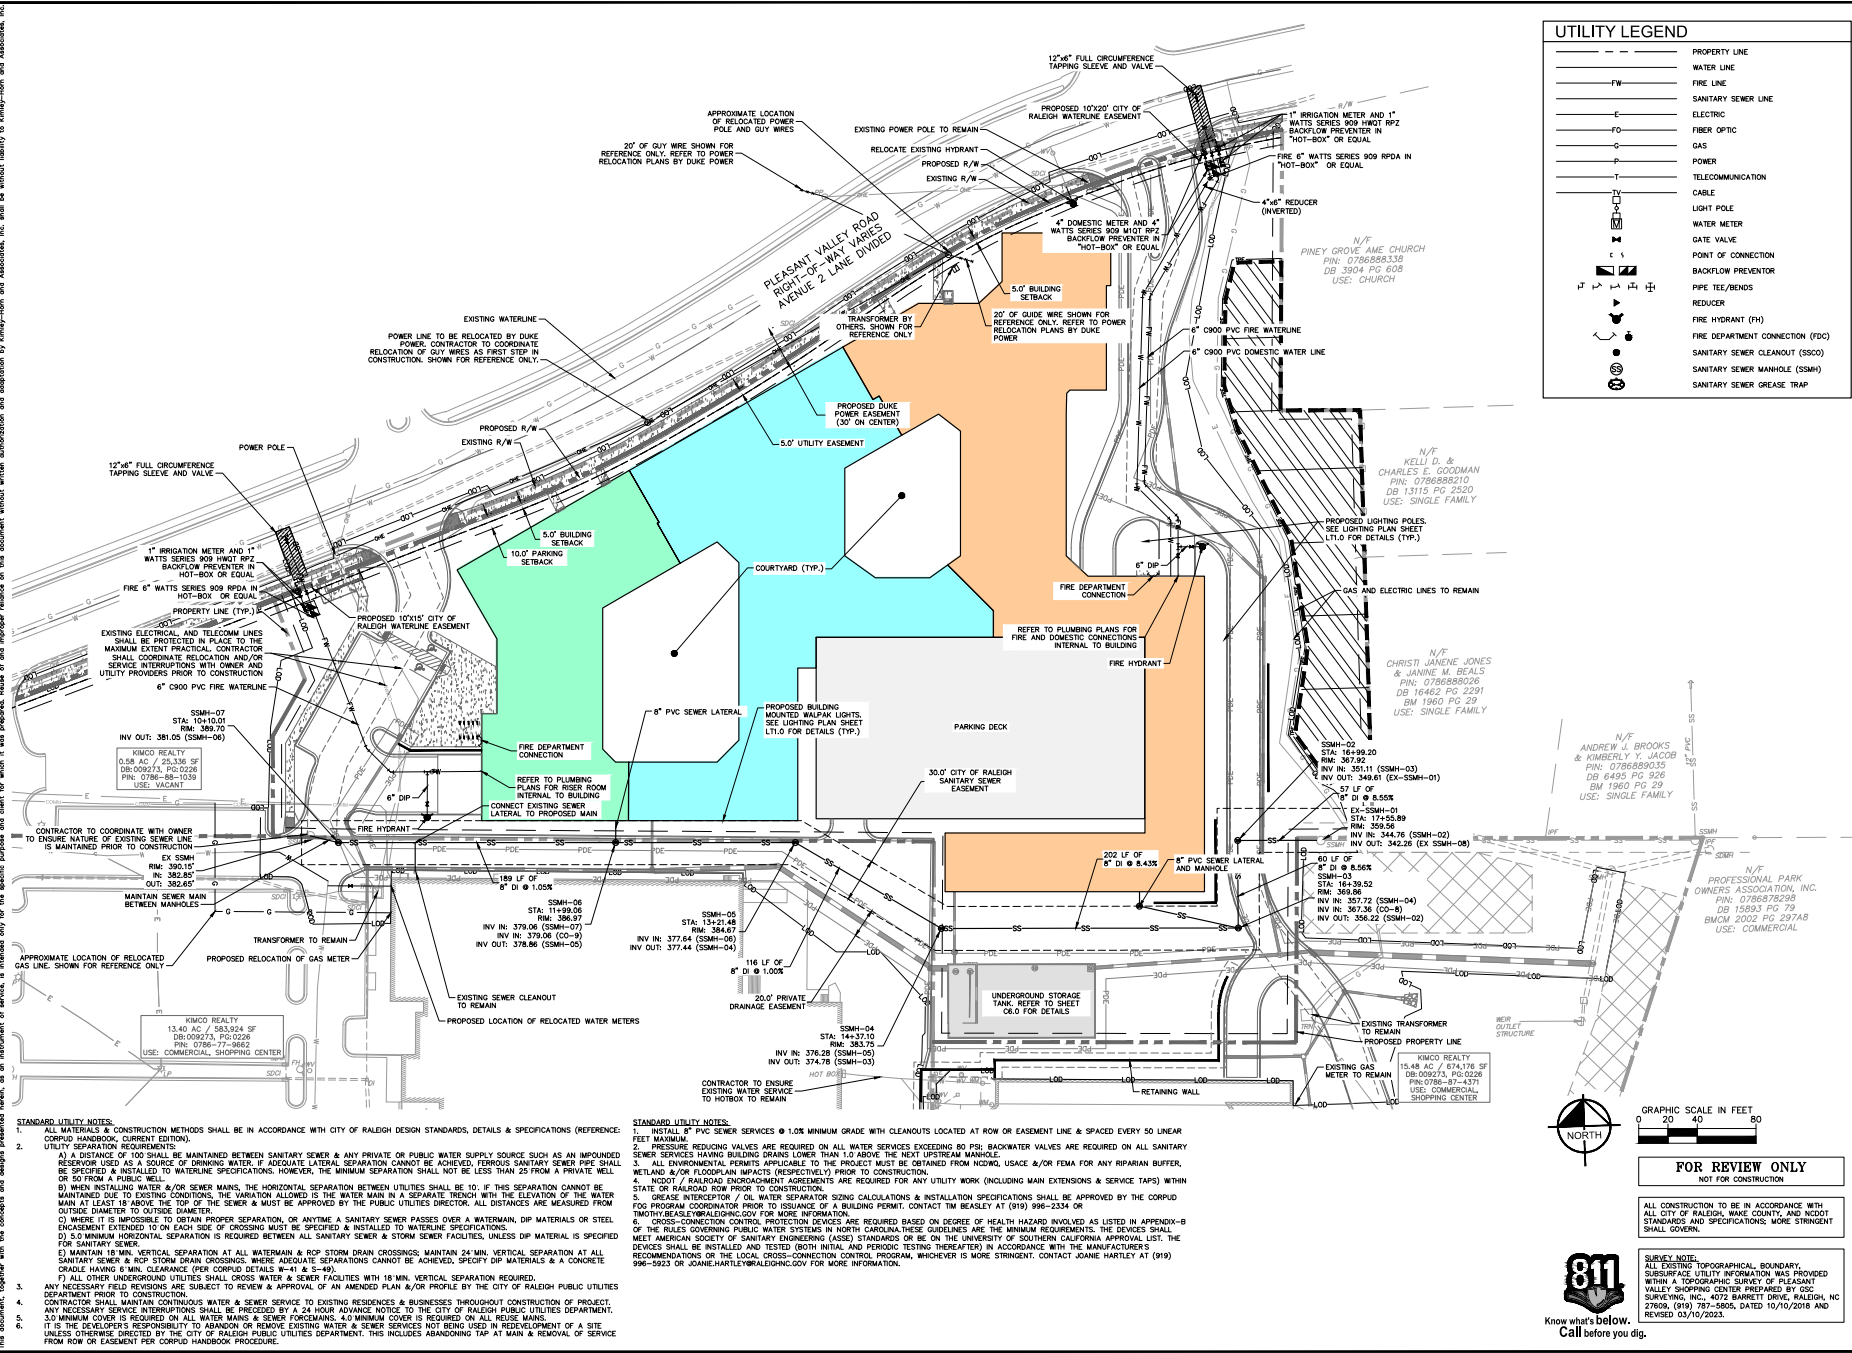
KHA PROJECT	DATE	DESIGNED BY	JAN
017377022	03/31/2023	DRAWN BY	SET
		CHECKED BY	CJH

No.	REVISED PER CITY ASR COMMENTS	DATE	BY
4	REVISED PER CITY ASR COMMENTS	9/22/2023	COL
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2	REVISED PER CITY ASR COMMENTS	7/28/2023	COL
1	REVISED PER CITY ASR COMMENTS	6/7/2023	COL



PLEASANT VALLEY PROMENADE MULTIFAMILY - PHASE 1 PREPARED FOR KIMCO RALEIGH LIMITED PARTNERSHIP RALEIGH	SIGHT DISTANCE PLAN	NC	KHA PROJECT DATE	03/31/2023
			SCALE AS SHOWN	DESIGNED BY JAU
			DRAWN BY SET	CHECKED BY CJ-
			SHEET NUMBER C3.4	
			KIMLEY»HORN © 2023 KIMLEY-HORN AND ASSOCIATES, INC. 421 FAYTTEVILLE STREET, SUITE 600, RALPH, NC 27801 PHONE: 919-487-4000 FAX: 919-487-0500 WWW.KIMLEY-HORN.COM #--002	
4 REVISED PER CITY ASR COMMENTS	9/27/2023 CDL			
3 REVISED PER CITY ASR COMMENTS	9/1/2023 CDL			
2 REVISED PER CITY ASR COMMENTS	7/28/2023 CDL			
1 REVISED PER CITY ASR COMMENTS	6/7/2023 CDL			
No.	REVISIONS	DATE	BY	

DATE: 07/27/2023 11:45 AM PROJECT: PLEASANT VALLEY ROAD MULTIFAMILY - PHASE 1 UTILITY PLAN SHEET: 01 OF 02 DRAWN BY: JACOB L. HORN, P.E. CHECKED BY: JACOB L. HORN, P.E. SCALE: AS SHOWN



Kimley»Horn

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UTILITY PLAN

PLEASANT VALLEY PROMENADE
MULTIFAMILY - PHASE 1
PREPARED FOR
KIMCO RALEIGH LIMITED
PARTNERSHIP

REVISIONS

NO.	REVISIONS	DATE
1	REVISED PER CITY ASR COMMENTS 6/7/2023 DCL	
2	REVISED PER CITY ASR COMMENTS 7/28/2023 DCL	
3	REVISED PER CITY ASR COMMENTS 9/1/2023 DCL	
4	REVISED PER CITY ASR COMMENTS 9/22/2023 DCL	

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4	REVISED PER CITY ASR COMMENTS 9/22/2023 DCL	

PROJECT INFORMATION

NO.	REVISIONS	DATE
1	REVISED PER CITY ASR COMMENTS 6/7/2023 DCL	
2	REVISED PER CITY ASR COMMENTS 7/28/2023 DCL	
3	REVISED PER CITY ASR COMMENTS 9/1/2023 DCL	
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PROJECT INFORMATION




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PROJECT INFORMATION

NOTES:


1. SAND FILTER TO BE DESIGNED FOR H-20 LOADING.
2. CONTRACTOR SHALL SUBMIT SAND FILTER SHOP DRAWINGS FOR REVIEW.
3. SAND FILTER AND UNDERGROUND STORAGE CHAMBER TO BE WRAPPED IN 30 MM WATERPROOF LINING.
4. ALL JOINTS TO BE WATERTIGHT.

KEYNOTES

SEDIMENT CHAMBER AREA	
FILTER CHAMBER AREA	
OUTFALL STRUCTURE AREA	



GRAPHIC SCALE IN FEET



A horizontal scale bar with markings at 0, 10, 20, and 40 feet. The bar is divided into segments: 0 to 10 is white, 10 to 20 is black, 20 to 30 is white, and 30 to 40 is black.

1-STORY BLOCK
COMMERCIAL BUILDING
"FITNESS CONNECTION"
& RETAIL STORES
WITH PARKING GARAGE

CONTRACTOR TO PROVIDE SHOP DRAWINGS TO
ENGINEERING FOR VERIFICATION PRIOR TO ORDERING PARTS


MANHOLE RIM = 383.00
APPROXIMATELY 8% GRADE
MANHOLE RIM = 382.00
MANHOLE RIM = 378.5
MANHOLE RING AND COVER (TYP.)
FINISHED GRADE
MANHOLE RIM = 375.5
COMPACTED SUBGRADE

12" RCP IN. INV 368.17'
PERMANENT POOL ELEVATION = 368.17'
368.17'
1.50'
WCE = 370.67' 0"
SAND FILTER MEDIA
6" PERFORATED PVC UNDERDRAIN PIPE IN 100% STAINLESS STEEL STRAPS 4" ON CENTER.
ASSUMED SHWT ELEVATION = 367.67'
4" AGGREGATE BASE
368.00'


4" PVC ELBOW AND TURNDOWN
SEE FLOW DISTRIBUTION PIPING
DETAIL THIS SHEET
6" PERFORATED UNDER DRAIN THROUGH STRUCTURE INTO UNDERGROUND STORAGE
100 - YR STORM EVENT ELEVATION = 364.83'
10 - YR STORM EVENT ELEVATION = 363.03'
363.00' TOP OF STRUCTURE
ACCESS STEPS (TYP.)
5'
2 - YR STORM EVENT ELEVATION = 361.19'
367.00' BOTTOM OF STRUCTURE
36" RCP OUT

SEDIMENT CHAMBER
FILTER CHAMBER
DETENTION CHAMBER
WATER QUALITY ELEVATION = 361.20'
STEEL REINFORCEMENT BY PRECAST MANUFACTURER
42" RCP IN DIRECT TO UNDERGROUND STORAGE BYPASS SEDIMENT CHAMBER AND TIE IN AT 357.00'
357.00'


SECTION A-A
NOT TO SCALE

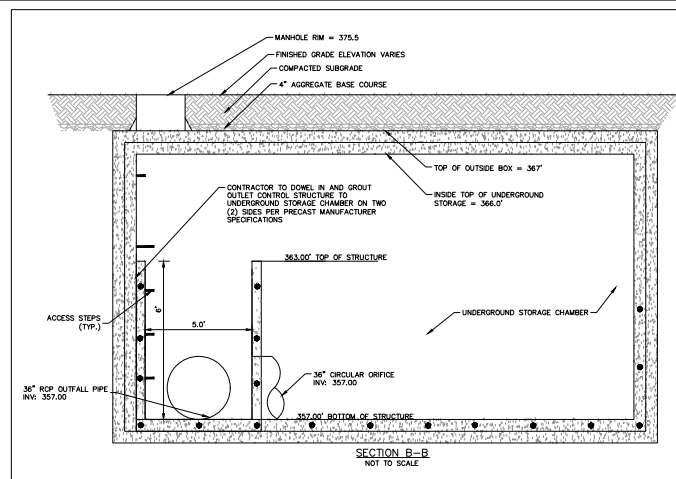

SECTION B-B
NOT TO SCALE

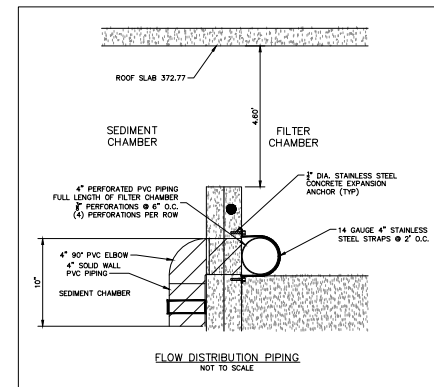

FLOW DISTRIBUTION PIPING
NOT TO SCALE

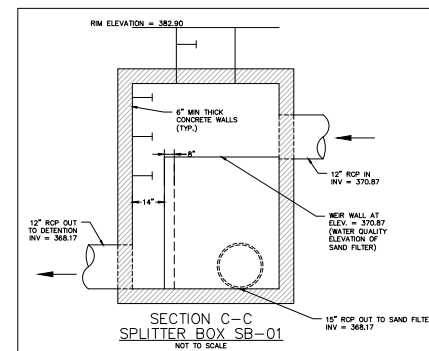

SECTION C-C
SPLITTER BOX SB-01


FOR REVIEW ONLY
NOT FOR CONSTRUCTION







ALL CONSTRUCTION TO BE IN ACCORDANCE WITH ALL CITY OF RALEIGH, WAKE COUNTY, AND NCDOT STANDARDS AND SPECIFICATIONS; MORE STRINGENT SHALL GOVERN.

SURVEY NOTE:
ALL EXISTING TOPOGRAPHICAL BOUNDARY,
SUBSURFACE UTILITY INFORMATION WAS PROVIDED
WITHIN A TOPOGRAPHIC SURVEY OF PLEASANT
VALLEY SHOPPING CENTER PREPARED BY GSC
SURVEYING, INC., 4072 BARRETT DRIVE, RALEIGH, NC
27609, (919) 787-5805, DATED 10/10/2018 AND
REVISED 03/10/2023.



Know what's below.
Call before you dig.

SHEET NUMBER		C6.0	
PLEASANT VALLEY PROMENADE MULTIFAMILY - PHASE 1		UNDERGROUND DETENTION & SAND FILTER DETAILS	
PREPARED FOR KIMCO RALEIGH LIMITED PARTNERSHIP		RMA PROJECT 01/2022 DATE 03/31/2023 SCALE AS SHOWN DESIGNED BY JAH DRAWN BY SET CHECKED BY C-B	
RALEIGH	NC	 <p>© 2023 KIMLEY-HORN AND ASSOCIATES, NC, 27601 421 PATTERVALE STREET, SUITE 600, RALEIGH, NC 27601 PHONE: 919-876-4772 WWW.KIMLEY-HORN.COM #-0102</p>	
		1 REVISED PER CITY ASR COMMENTS 9/22/2023 CGL 2 REVISED PER CITY ASR COMMENTS 9/1/2023 CGL 3 REVISED PER CITY ASR COMMENTS 7/28/2023 CGL 4 REVISED PER CITY ASR COMMENTS 6/7/2023 CGL	
		No. REVISIONS DATE BY	

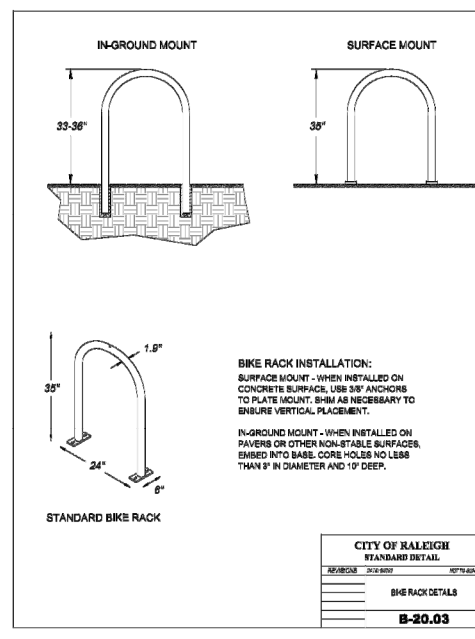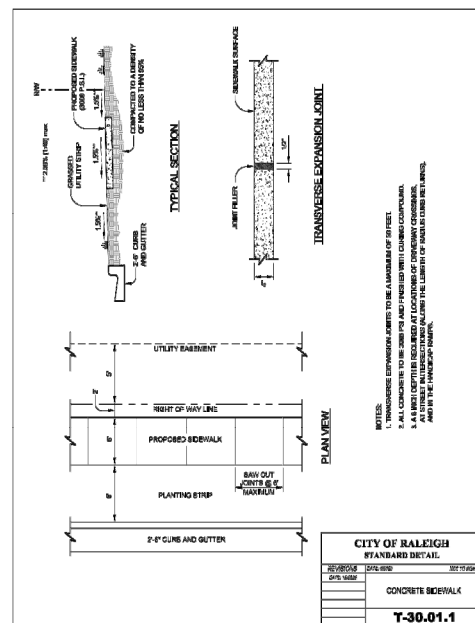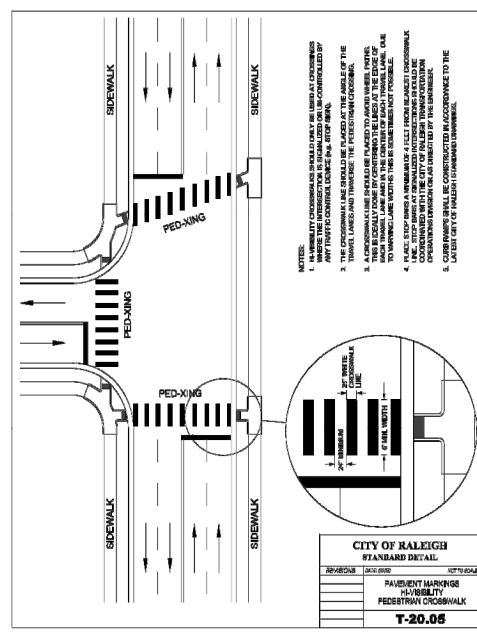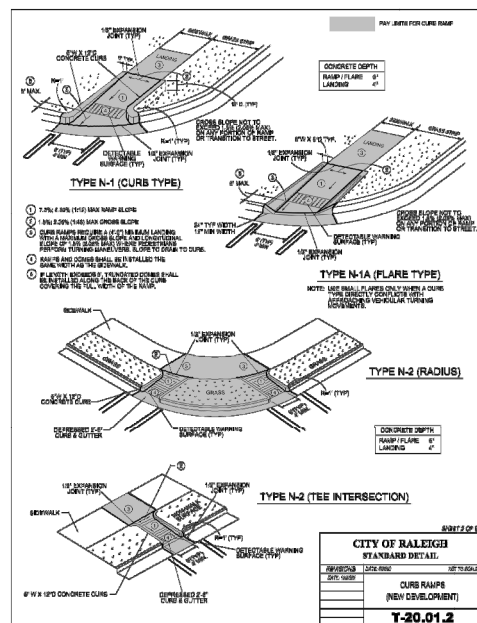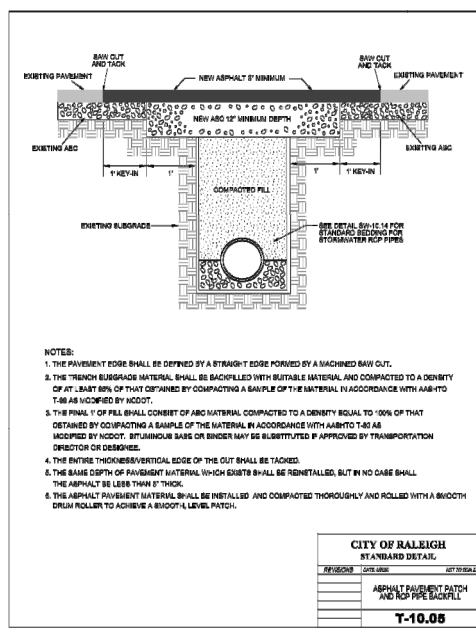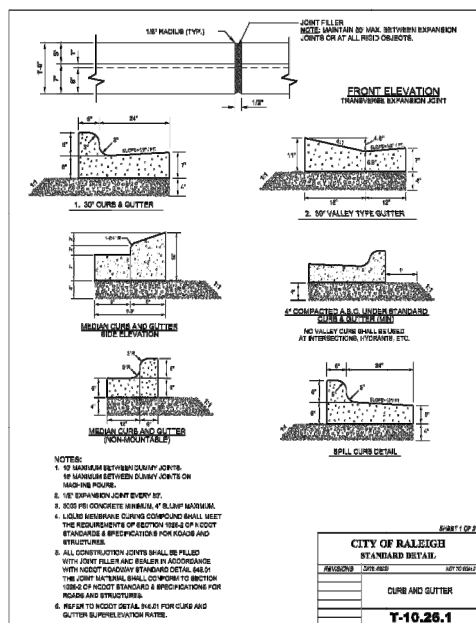

Know what's below.
Call before you dig.

<p align="center">FOR REVIEW ONLY</p> <p align="center">NOT FOR CONSTRUCTION</p>
<p>ALL CONSTRUCTION TO BE IN ACCORDANCE WITH ALL CITY OF RALEIGH, WAKE COUNTY, AND NCDOT STANDARDS AND SPECIFICATIONS; MORE STRINGENT SHALL GOVERN.</p>
<p>SURVEY NOTE:</p> <p>ALL EXISTING TOPOGRAPHICAL, BOUNDARY, SUBSURFACE UTILITY INFORMATION WAS PROVIDED WITHIN A TOPOGRAPHIC SURVEY OF PLEASANT VALLEY SHOPPING CENTER PREPARED BY GSC SURVEYING, INC., 4072 BARRETT DRIVE, RALEIGH, NC 27609, (919) 787-5805, DATED 10/10/2018 AND REVISED 03/10/2023.</p>

SURVEY NOTE:
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SUBSURFACE UTILITY INFORMATION WAS PROVIDED
WITHIN A TOPOGRAPHIC SURVEY OF PLEASANT
VALLEY SHOPPING CENTER PREPARED BY GSC
SURVEYING, INC., 4072 BARRETT DRIVE, RALEIGH, NC
27609, (919) 787-5805, DATED 10/10/2018 AND
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SURVEYING, INC., 4072 BARRETT DRIVE, RALEIGH, NC
27609, (919) 787-5805, DATED 10/10/2018 AND
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SITE DETAILS

PLEASANT VALLEY PROMENADE
MULTIFAMILY - PHASE 1
PREPARED FOR
KIMCO RALEIGH LIMITED
PARTNERSHIP



SHEET NUMBER
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No.	REVISIONS	DATE	BY
4	REVISED PER CITY ASR COMMENTS	9/22/2023	GDL
3	REVISED PER CITY ASR COMMENTS	9/1/2023	GDL
2	REVISED PER CITY ASR COMMENTS	7/28/2023	GDL
1	REVISED PER CITY ASR COMMENTS	6/7/2023	GDL

Kimley»»Horn
© 2021 KIMLEY-HORN AND ASSOCIATES, INC.
421 FAYETTEVILLE STREET, SUITE 600, RALEIGH, NC 27601
PHONE: 919-677-2000 FAX: 919-677-2050
WWW.KIMLEY-HORN.COM
#F-0102




KHA PROJECT	017377022
DATE	03/31/2023
SCALE	AS SHOWN
DESIGNED BY	JAJ
DRAWN BY	SET
CHECKED BY	CJH

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


PIEASANT VILLAGE LIGHTING SCHEDULE							
MARK	MODEL	QUANTITY	NO. OF JUNCTIONS / TYPE	LIGHTING TYPE	VOLTAGE	WATTS	DESCRIPTION
LT-010A	DSXL LED P-140K 7000K T77W-10M	2	3 SINGLE BY WALL MOUNT	LED	MDVOLT	51	TYPE FOUR - FORWARD THROW
LT-010B	DSXL LED P-140K 7000K T77W-10M	3	6 SINGLE BY WALL MOUNT	LED	MDVOLT	51	TYPE FOUR - FORWARD THROW
LT-010A	DSXL LED P-140K 7000K T77W-10M	1	3 SINGLE BY WALL MOUNT	LED	MDVOLT	51	TYPE TWO
LT-010B	DSXL LED P-140K 7000K T77W-10M	4	6 SINGLE BY WALL MOUNT	LED	MDVOLT	51	TYPE TWO W/ HOUSIE SIDE SHEILD
LT-010A	DSXL LED P-140K 7000K T77W-10M	3	3 SINGLE BY WALL MOUNT	LED	MDVOLT	51	TYPE FIVE

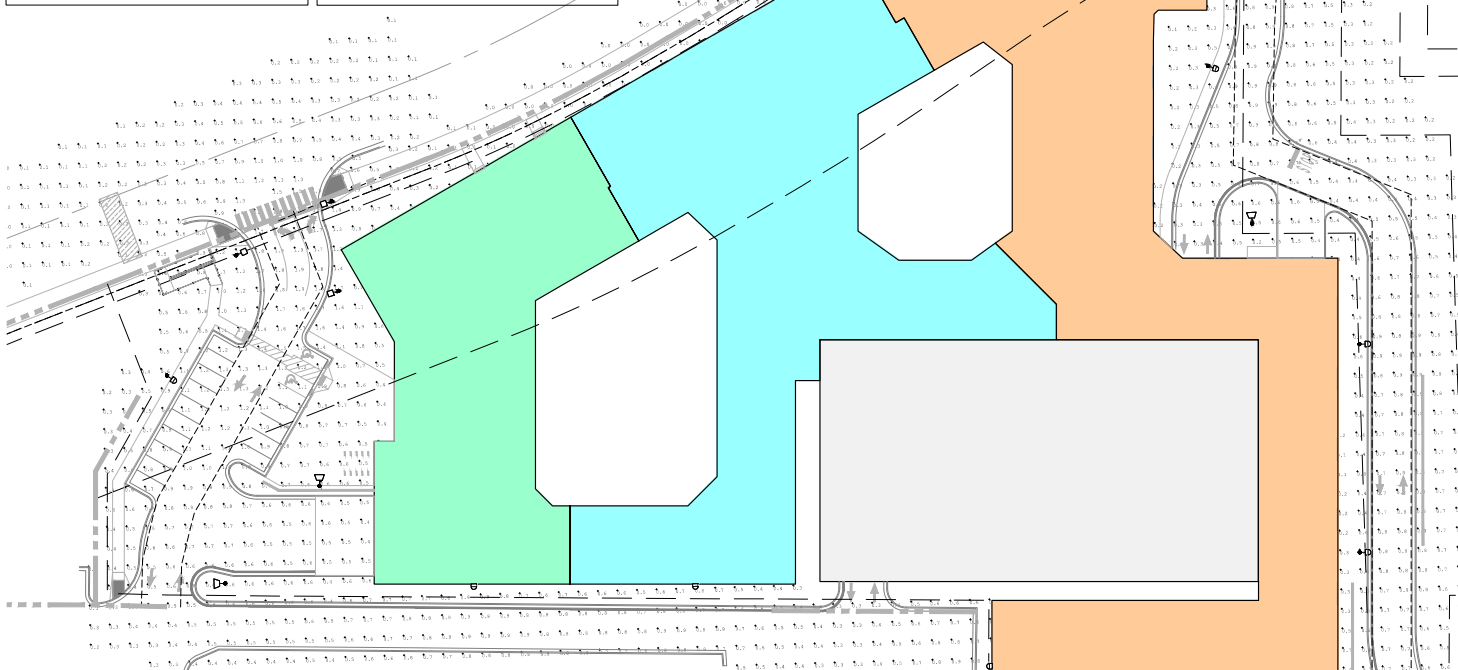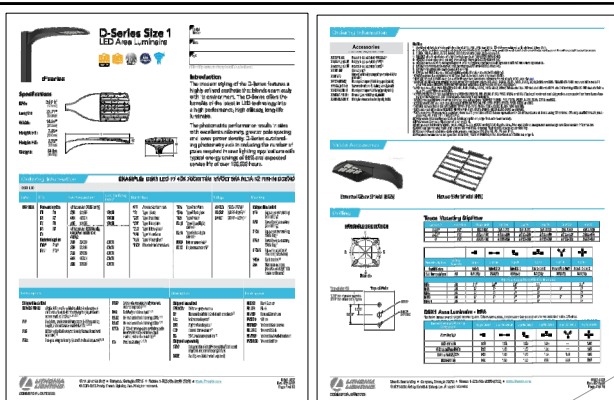CALCULATION SUMMARY						
AREA LABEL	CALC TYPE	UNITS	AVG	MAX	MIN	AVG/MIN
INTERSECTIONS	ILLUMINANCE	FC	1.38	1.47	1.20	1.36
ROADS	ILLUMINANCE	FC	0.80	1.60	0.25	5.34
SIDEWALKS	ILLUMINANCE	FC	0.65	1.30	0.40	1.64

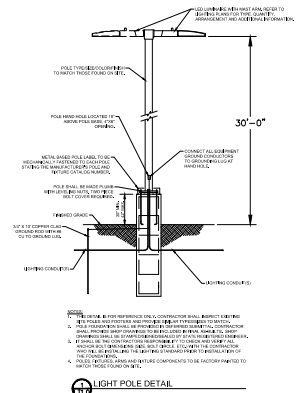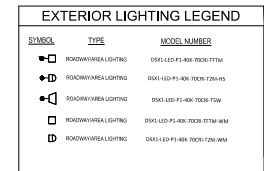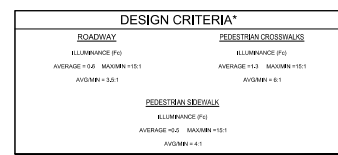

GRAPHIC SCALE IN FEET



A horizontal line with vertical tick marks at 0, 15, 30, and 60 feet. The segment between 15 and 30 feet is shaded black.

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NOT FOR CONSTRUCTION


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SURVEY NOTE:
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WITHIN A TOPOGRAPHIC SURVEY OF PLEASANT
VALLEY SHOPPING CENTER PREPARED BY GSC
SURVEYING, INC., 4072 BARRETT DRIVE, RALEIGH,
27609, (919) 787-5805, DATED 10/10/2018 AND
REVISED 03/10/2023.

Know what's below.
Call before you dig.

Printed By:Tindoli, Sarah (Reidsp) Sheet: SHELLEANS VALLEY PROMENADE MULTIFAMILY - PHASE 1 Layout:TC 10, September 23, 2023 08:41:52am K:\PLAN_ID\0173770222_plansheet_v03wy - phase 1.mxd Open File\02_eplansheet\TC10_TREE CONSERVATION PLAN.dwg



1. TREE CONSERVATION NOTES.
2. A TREE CONSERVATION PERMIT IS REQUIRED TO ESTABLISH TREE CONSERVATION AREAS IN THE FIELD.
3. A TREE CONSERVATION PERMIT IS REQUIRED PRIOR TO ISSUANCE OF A GRADING PERMIT.
4. PROJECTIONS OF THE TREE CONSERVATION AREAS FOLLOWING WILL BE RECORDED WITH THE WAKE COUNTY REGISTER OF DEEDS.
5. THE TREE CONSERVATION AREAS MUST BE RECORDED PRIOR TO OBTAINING A GRADING PERMIT FROM THE WAKE COUNTY.
6. NEW PLANTINGS SHALL NOT BE INSTALLED WITHIN THE CRITICAL ROOTZONE OF ANY EXISTING TREE LOCATED WITHIN A TREE CONSERVATION AREA.
7. TREE PROTECTION FENCE IS SHOWN OFF FORTY FEET FROM THE CRITICAL ROOTZONE TO A TREE BOUNDARY.
8. THE CRITICAL ROOTZONE SHALL BE:
9. TREES OVER 10 INCHES DBH WITH 30% OR MORE OF THEIR CRZ IMPACTED BY DEVELOPMENT OR CONSTRUCTION SHALL BE PROTECTED.
10. TREES WITH CRITICAL ROOTZONES THAT WILL NOT BE COUNTED TOWARDS BASAL AREA CALCULATIONS.
11. TREES ON THE CITY OF RALEIGH INVASIVE SPECIES LIST WILL NOT BE COUNTED TOWARDS BASAL AREA CALCULATIONS.
12. SEE THE ATTACHED REPORT FOR BASAL AREA CALCULATIONS.
13. THE INFORMATION ON THIS PLAN HAVE BEEN TAKEN FROM A TREE SURVEY PERFORMED BY KIMLEY-HORN & ASSOCIATES DATED DECEMBER 21, 2001.
14. ALL DISTANCES SHOWN ARE HORIZONTAL, GROUND DISTANCES IN U.S. SURVEY FEET UNLESS OTHERWISE NOTED.
15. ALL BEARINGS ARE BASED ON THE NORTH CAROLINA STATE PLANE SYSTEM (NAD 1983/2011).

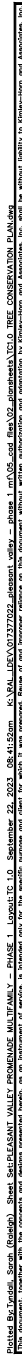TREE SURVEY LEGEND	
Tree Label	Tree Name
T1	American beech
T2	American holly
T3	Black cherry
T4	Chimaphila
T5	Crape myrtle
T6	Eastern reed cedar
T7	Loblolly pine
T8	Periwinkle
T9	Post oak
T10	Red maple
T11	Scarlet oak
T12	Shortleaf pine
T13	Southern red oak
T14	Sweetgum
T15	Tulip poplar
T16	White oak
T17	White oak
T18	White oak

*Chimaphila is considered an invasive species and shall not be counted towards basal area calculations.

GRAPHIC SCALE IN FEET
0 20 40 80

ALL CONSTRUCTION TO BE IN ACCORDANCE WITH ALL CITY OF RALEIGH, WAKE COUNTY, AND NCDOT STANDARDS AND SPECIFICATIONS- MORE STRINGENT

SURVEY NOTE:
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SURVEYING, INC., 4072 BARRETT DRIVE, RALEIGH, NC
27609, (919) 787-5805, DATED 10/10/2018 AND
REVISED 03/10/2023.



u dig.

Kimley»»Horn

TREE
CONSERVATION PLAN



RALEIGH
MULTIFAMILY - PHASE 1
PREPARED FOR
KIMCO RALEIGH LIMITED
PARTNERSHIP
NC

SHEET NUMBER
TC1.0




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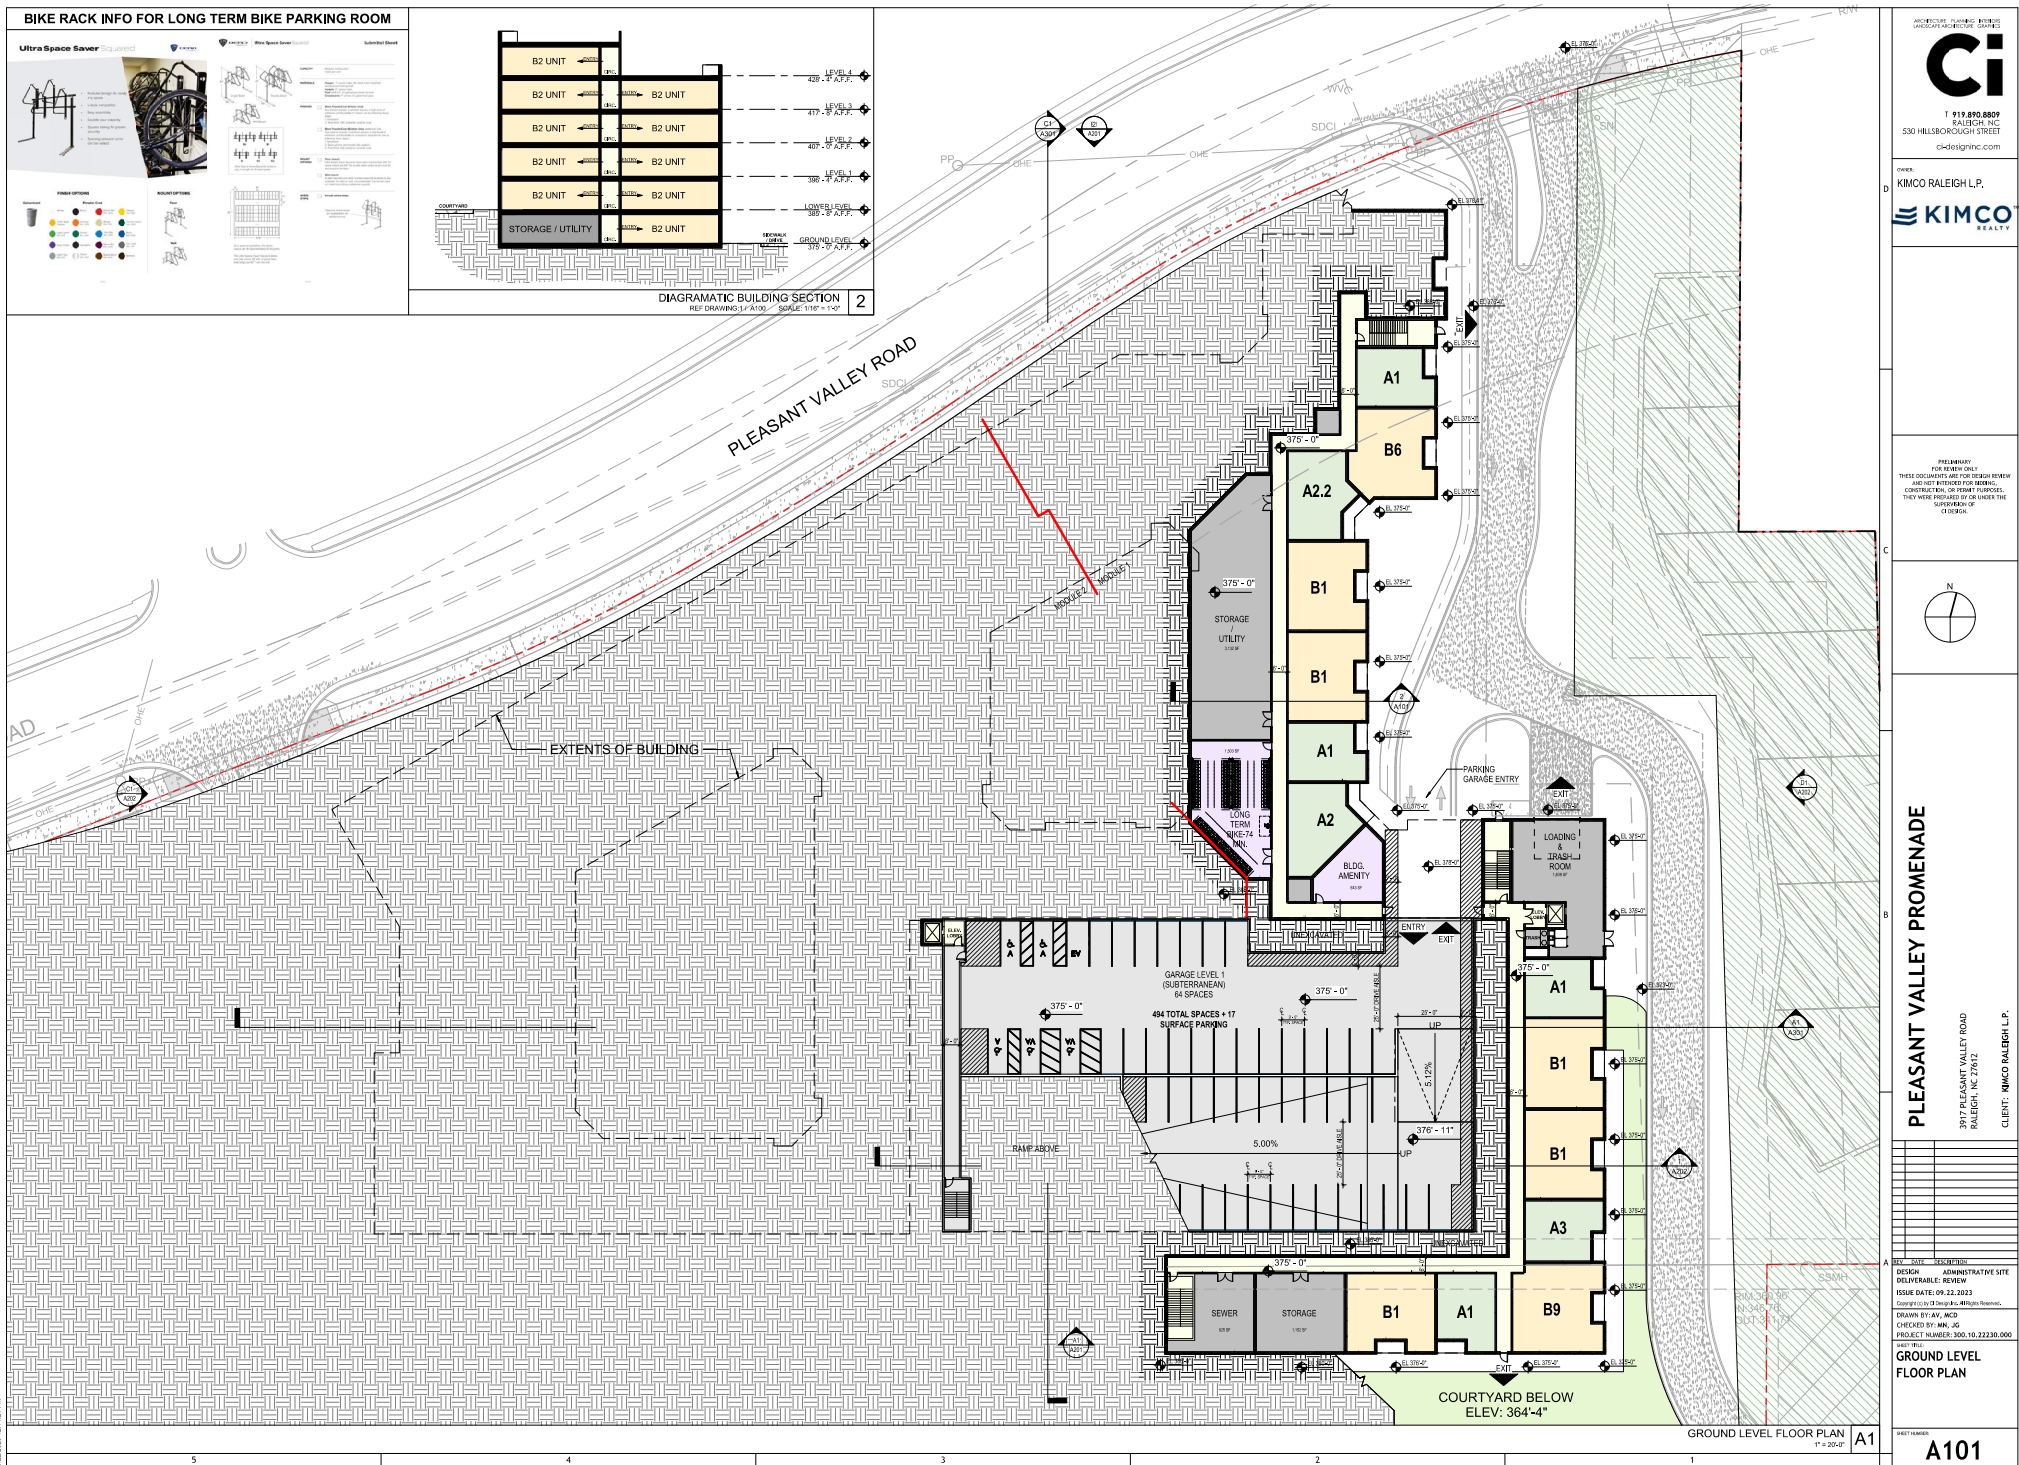
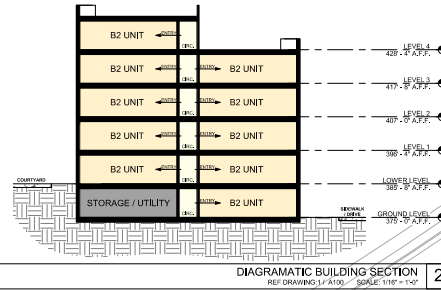
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LINE	BEARING	DISTANCE
L1	N 01°59'55" E	5.49'
L2	N 43°00'00" W	6.92'
L3	S 41°59'55" W	15.50'
L4	N 01°59'55" E	18.31'
L5	S 88°00'00" E	17.52'
L6	N 88°00'00" W	34.00'
L7	N 88°20'10" W	18.79'

CURVE	ARC LENGTH	RADIUS	DELTA ANGLE	CHORD BEARING	CHORD LENGTH
C1	88.78'	1372.42'	1°42'23.11"	S 88°37'13" W	88.77'
C2	219.81'	995.00'	12°32'26.14"	N 64°19'41" E	219.36'
C3	287.12'	774.00'	2°11'51.00"	S 68°26'30" W	285.48'
C4	55.89'	995.00'	1°13'05.00"	N 68°41'52" E	55.88'
C5	153.92'	995.00'	8°28'21.38"	N 92°32'09" E	153.74'

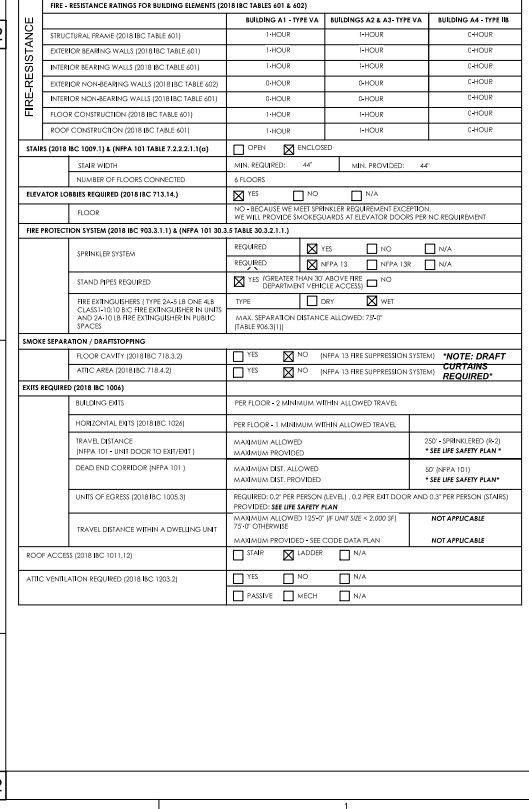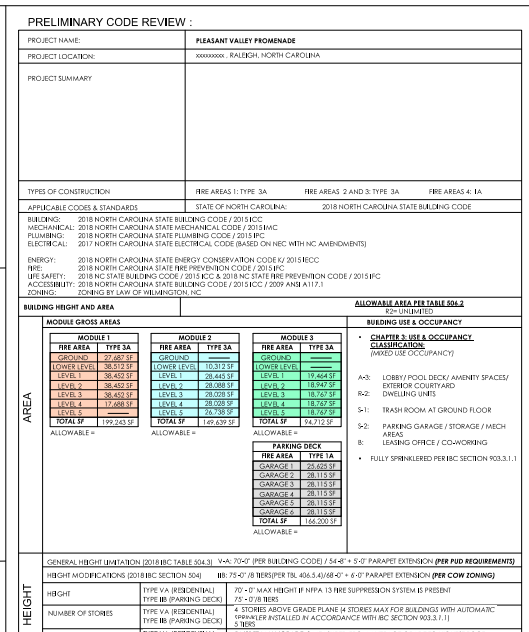

[illegible]



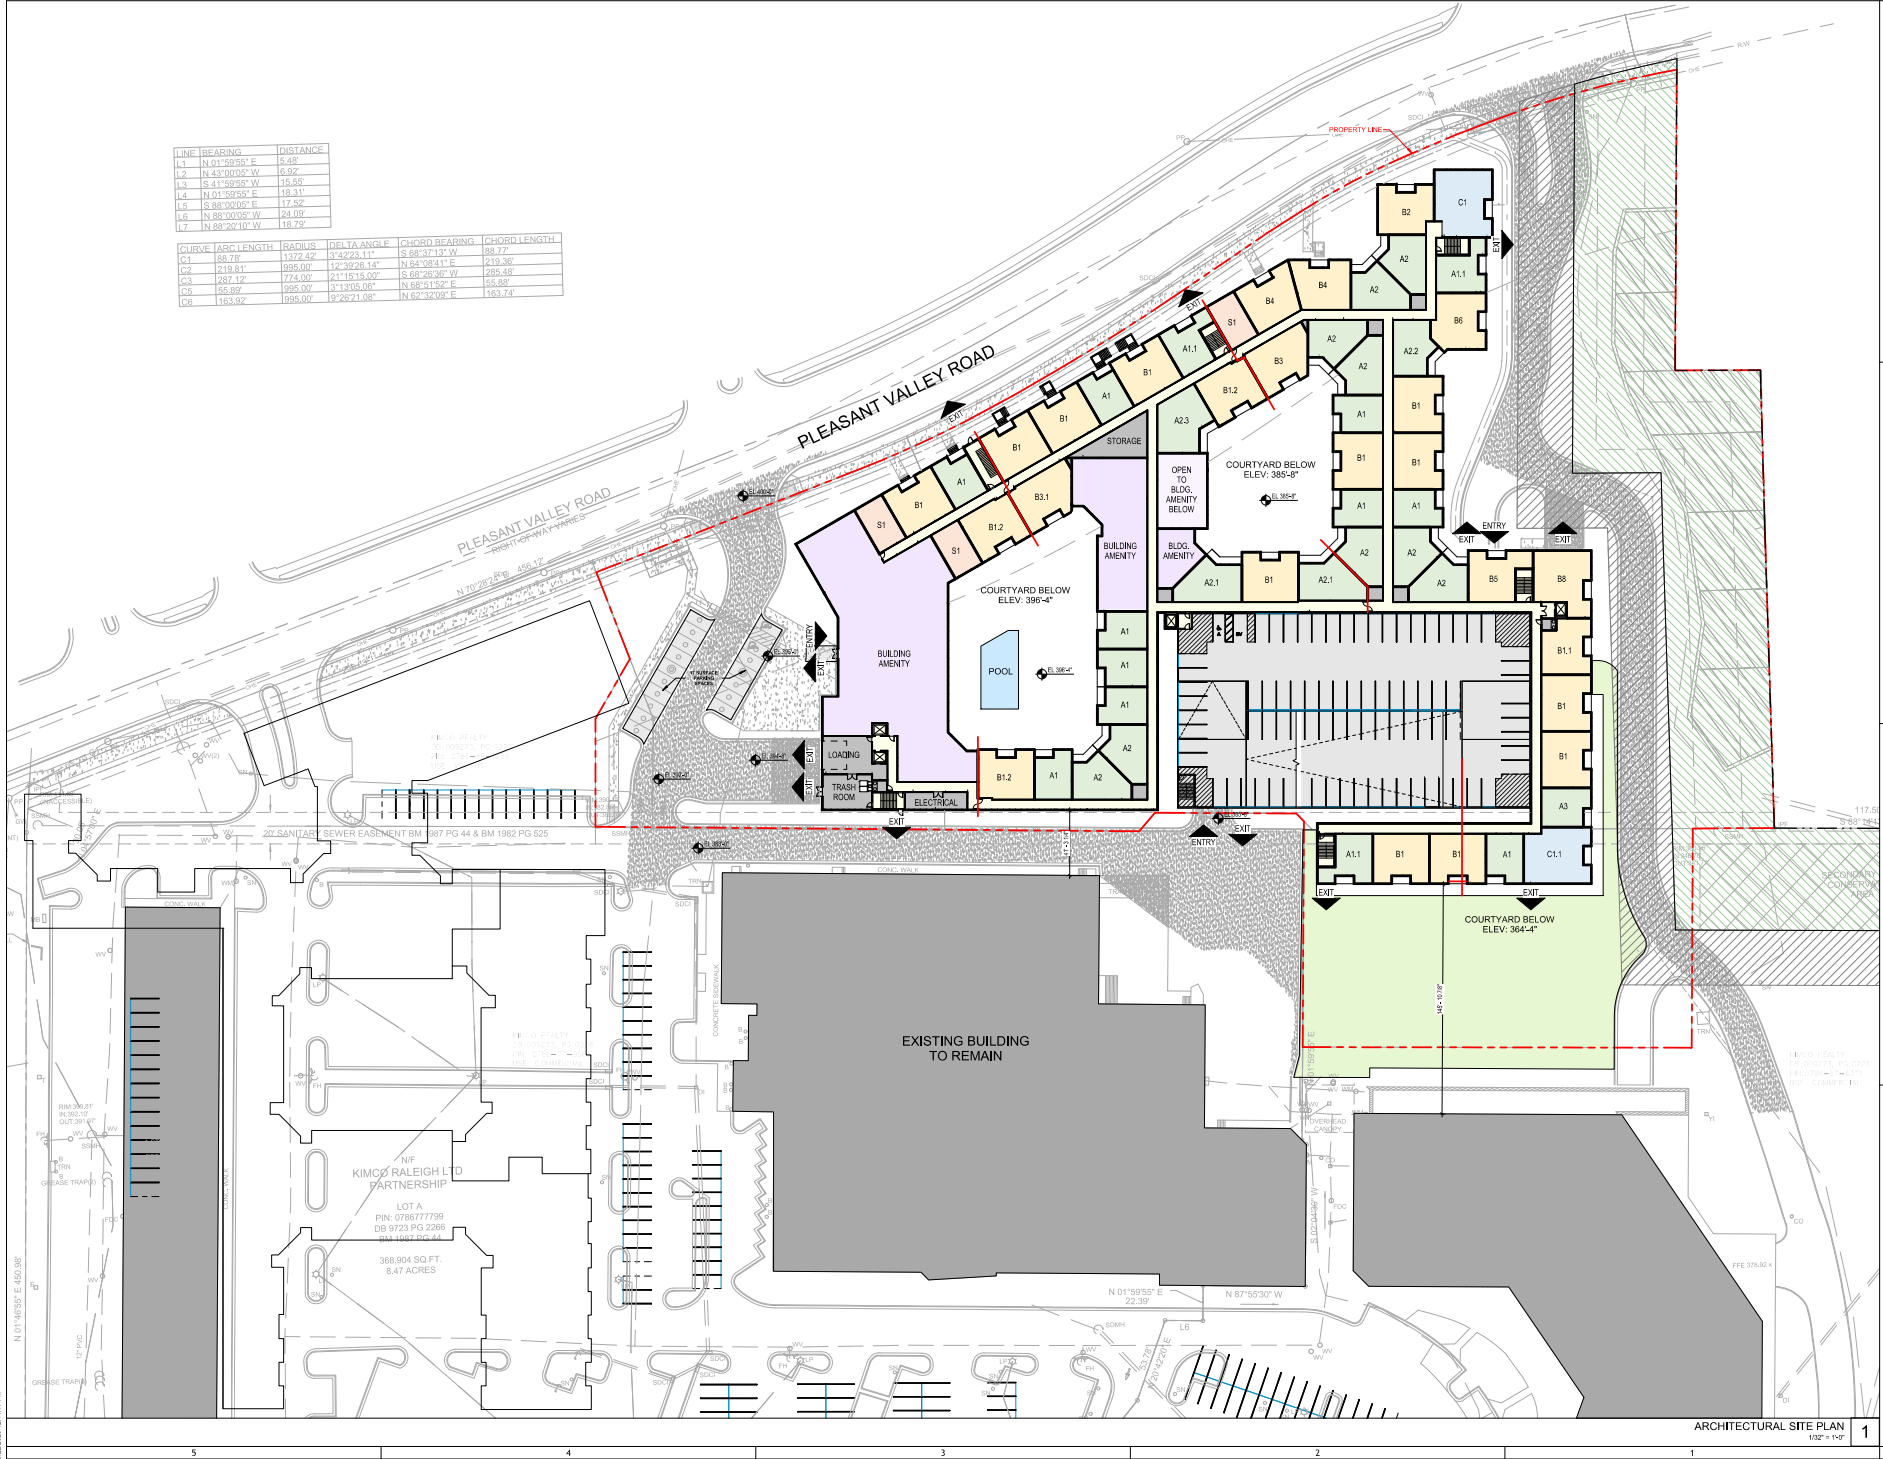




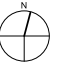


1 919.890.8809
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530 HILLSBOROUGH STREET
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OWNER:
KIMCO RALEIGH L.P.



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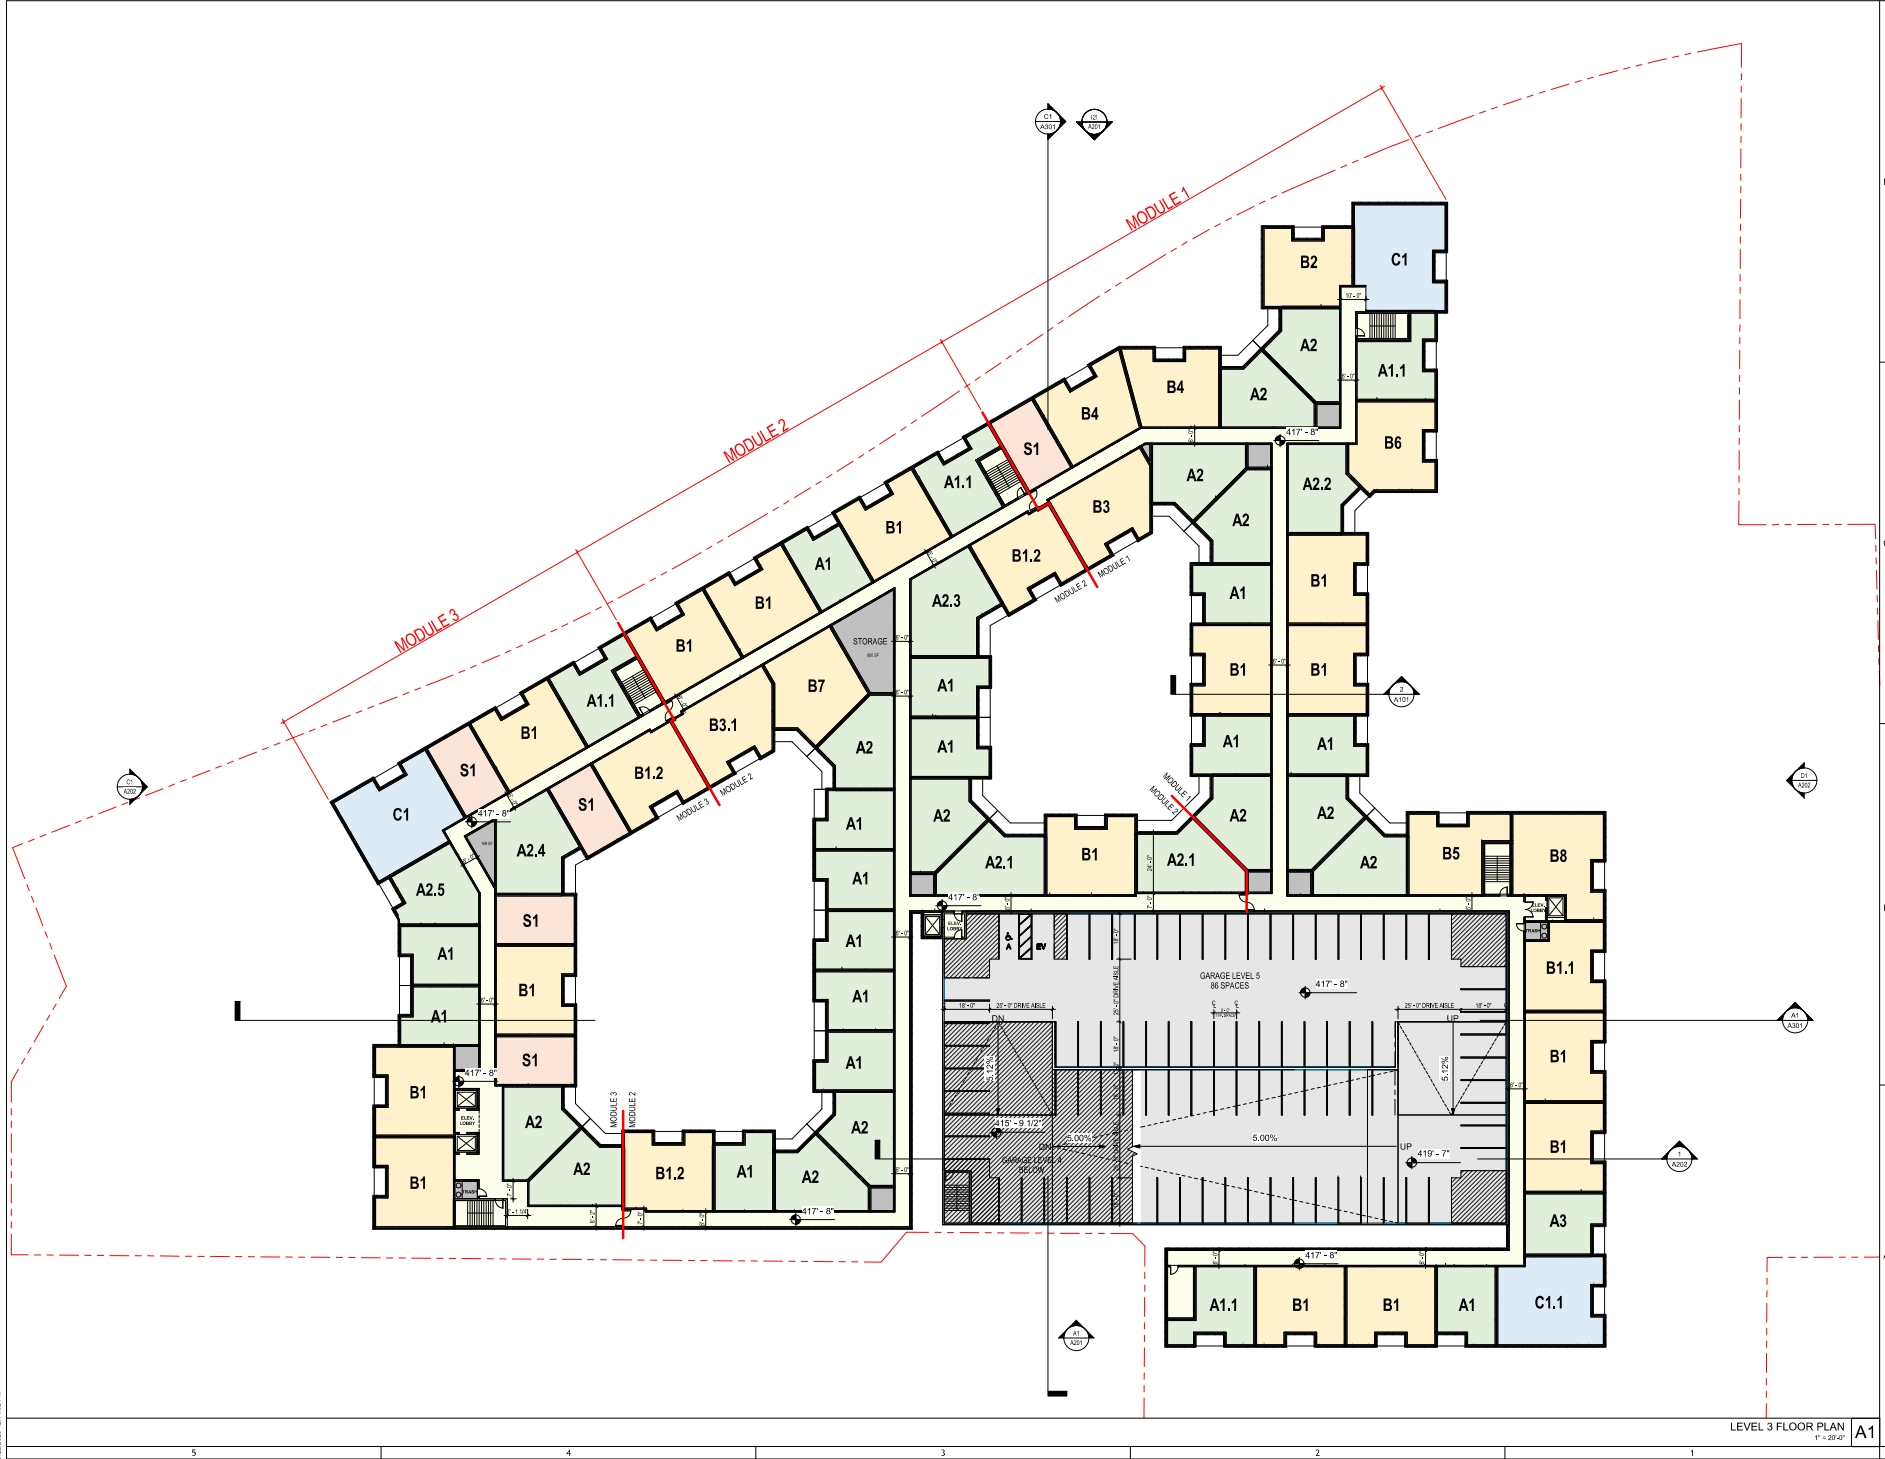
NO.	DATE	DESCRIPTION
1	09-22-2023	ISSUE DATE

DESIGN: ADVISORY SITE
PRELIMINARY REVIEW
ISSUE DATE: 09-22-2023
DRAWN BY: AV, MCD
CHECKED BY: MCD, JG
PROJECT NUMBER: 300.10.22230.000

LEVEL 2 FLOOR PLAN

LEVEL 2 FLOOR PLAN
1" = 20'-0"

A104



LEVEL 3 FLOOR PLAN
1" = 20'-0"

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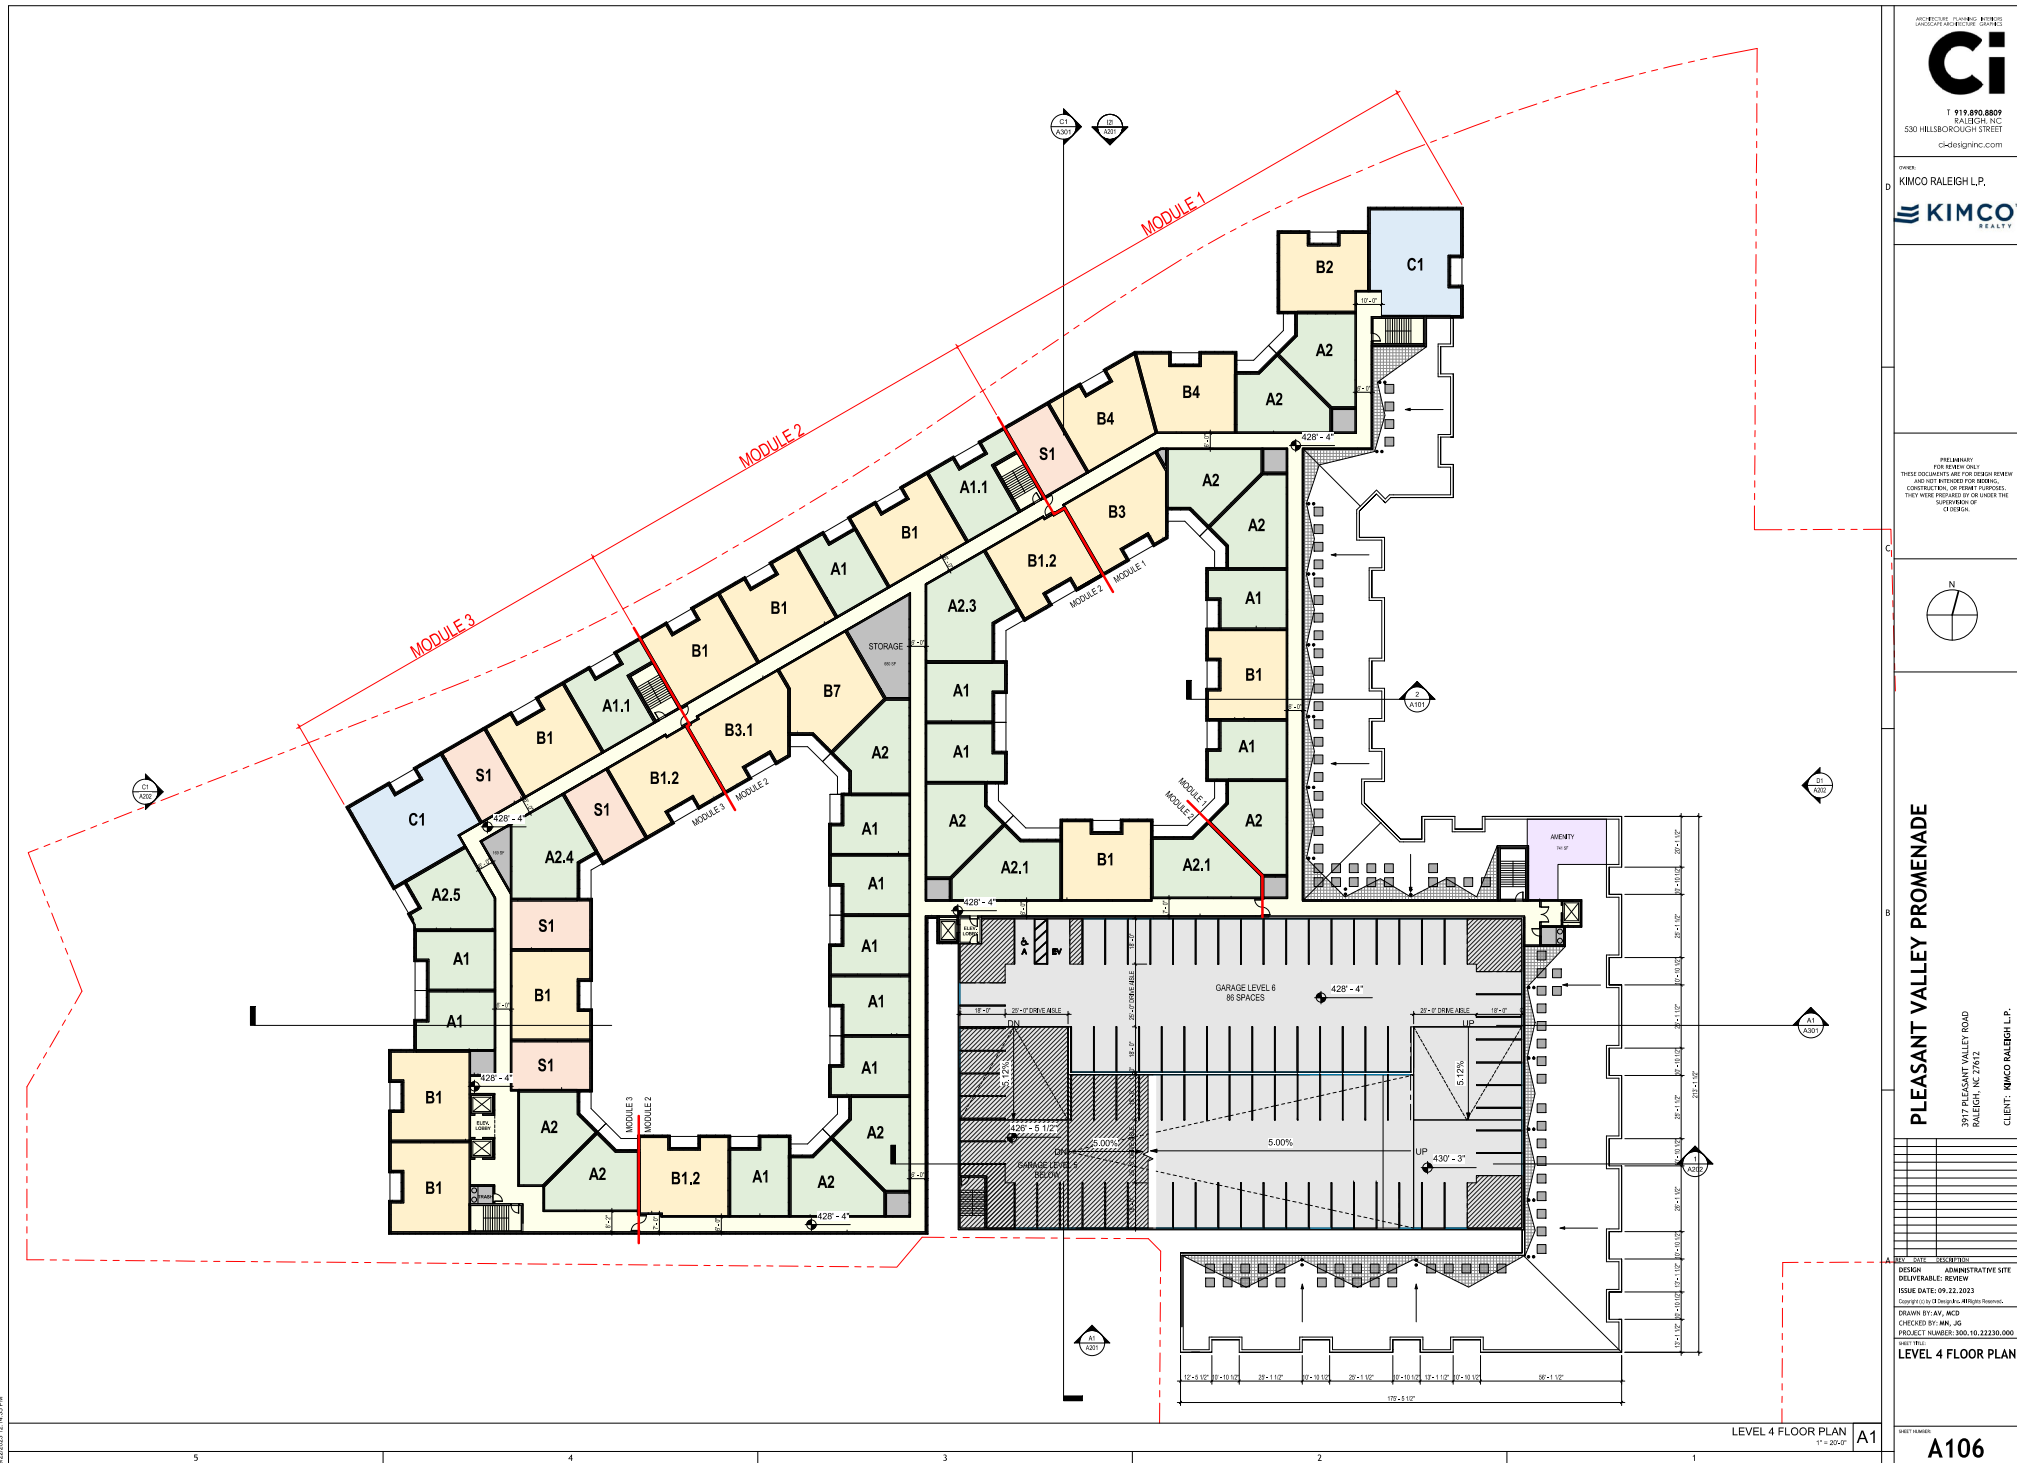
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PLEASANT VALLEY PROMENADE
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RALEIGH, NC 27612
CLIENT: KIMCO RALEIGH L.P.

REV	DATE	DESCRIPTION
1	09/22/2023	ADMINISTRATIVE SITE PRELIMINARY REVIEW
2	09/22/2023	ISSUE DATE: 09/22/2023
3	09/22/2023	DESIGNED BY: AV, MCD CHECKED BY: MCD, JG PROJECT NUMBER: 300.10.22230.000

LEVEL 3 FLOOR PLAN

A105





PLEASANT VALLEY PROMENADE

917 PLEASANT VALLEY ROAD


CLIENT: KIMCO RAILFIGHT P

[illegible]

DESIGN ADMINISTRATIVE SHEET
 DELIVERABLE: REVIEW
 ISSUE DATE: 09.22.2023
 Copyright (c) by C Design Inc. All Rights Reserved.
 DRAWN BY: AV, MKD
 CHECKED BY: MN, JG
 PROJECT NUMBER: 300.10.22230.1
 SHEET TITLE:
FLOOR 5 FLOOR PLAN


LEVEL 5 FLOOR PLAN

SHEET NUMBER:
A107

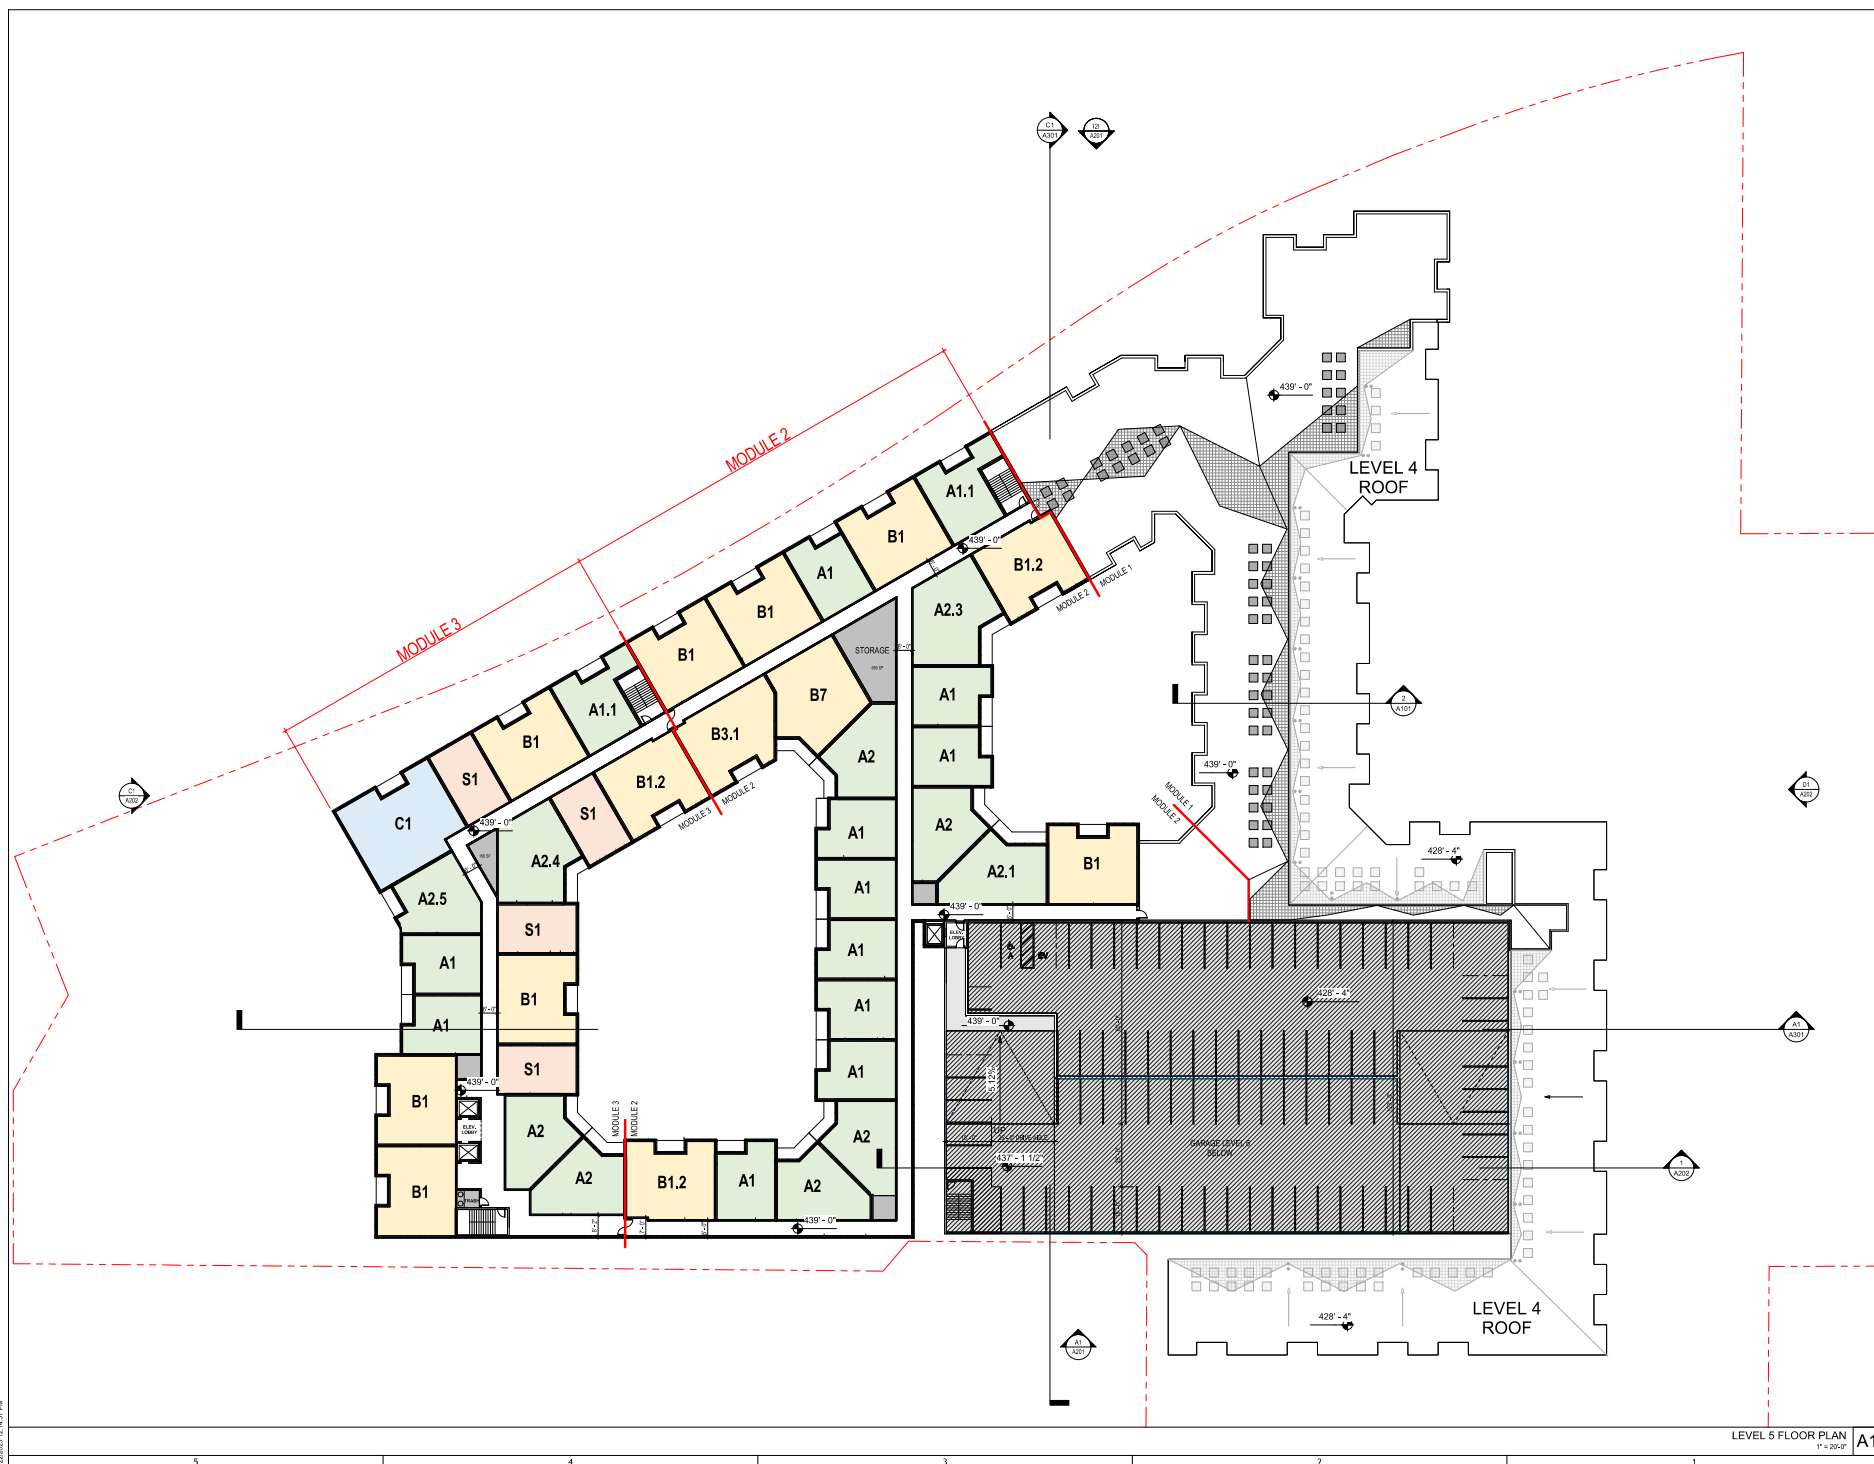

Site & Area

Geacolor EcoForm Gen-2 combines economy with performance in an LED area luminaire. Capable of delivering up to 27,500 lumens or more in a compact, low profile LED luminaire, EcoForm offers a new level of customer value. EcoForm features an innovative retrofit arm kit, simplifying the conversions to LED by eliminating the need to drill additional holes in most existing poles. Integral control systems available for further energy savings. Includes Service Tag, our innovative way to provide assistance throughout the life of the product.

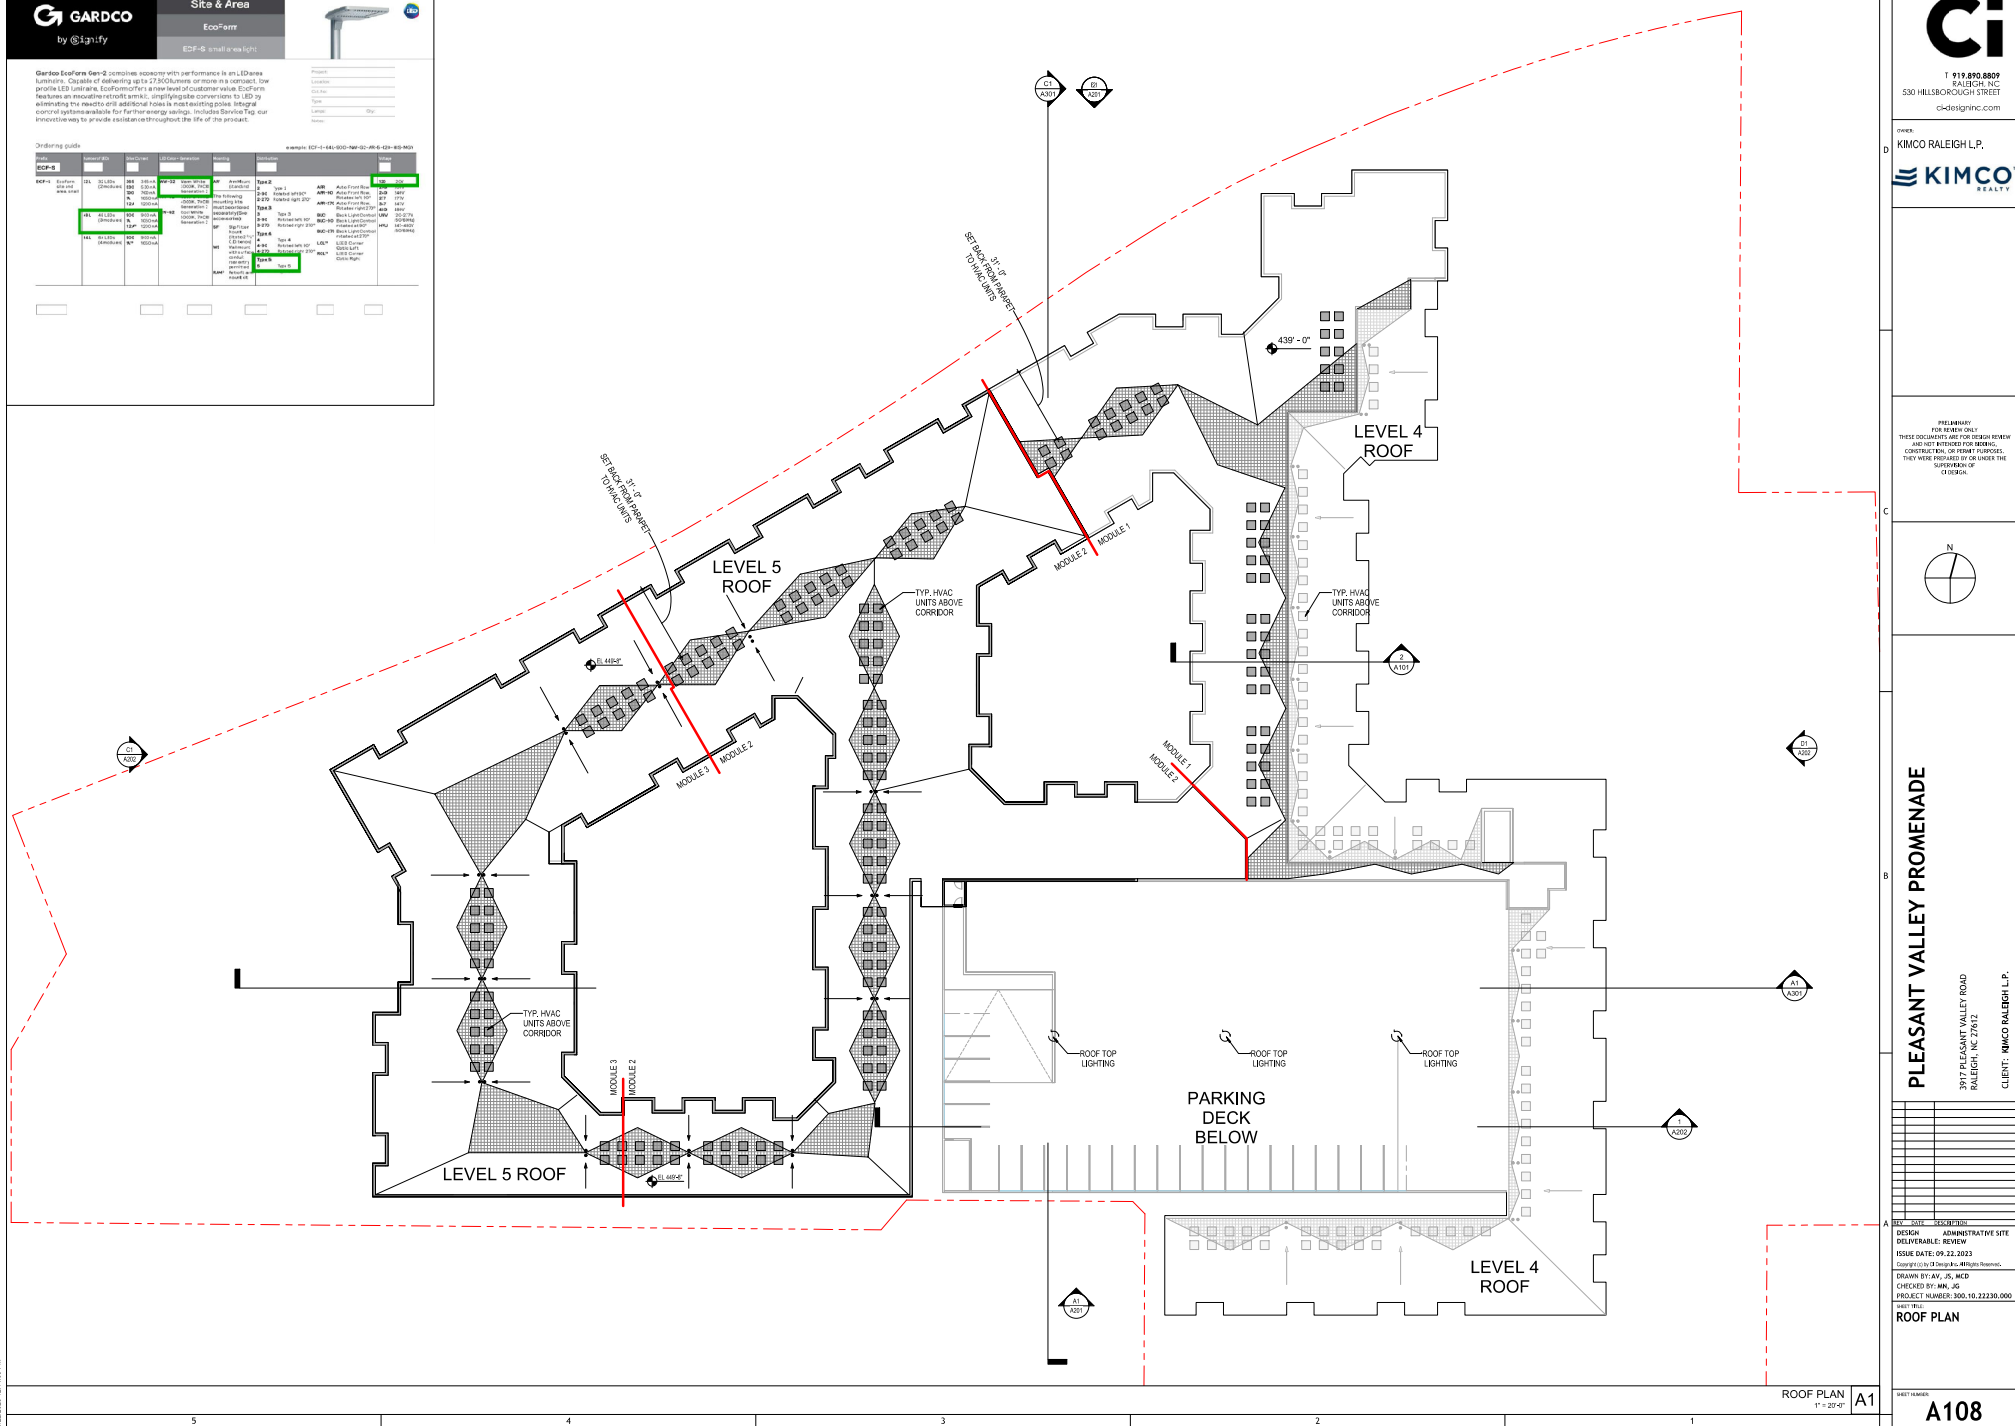[illegible]

USE SPECIFICATIONS FOR DETAILED INFORMATION.

1. SEE ADDENDUM FOR GENERAL CONDITIONS OF THE CONTRACT FOR CONSTRUCTION.

2. SEE SHEET TWO FOR TYPICAL NOTES, SYMBOLS, ACCESSIBILITY MINIMUM STANDARDS, AND UNIVERSAL DESIGN. TWO FOR TYPICAL NOTES, SYMBOLS, ACCESSIBILITY MINIMUM STANDARDS, AND UNIVERSAL DESIGN.

3. CONTRACTOR TO COORDINATE CONNECTION WITH TRACES PRIOR TO COMMENCEMENT OF WORK.

4. CONTRACTOR SHALL BE RESPONSIBLE FOR REPAIRING, PATCHING, AND REPLACING ANY DAMAGE DUE TO CONSTRUCTION OR INSTALLATION OF TRACES, REPAIR PATCH AND FINISH OF EXISTING CONDITIONS SHALL BE THE RESPONSIBILITY OF THE CONTRACTOR.

5. EXTERIOR DIMENSIONS ARE TAKEN FROM FACE OF SMOOTHING OR MASONRY UNLESS NOTED. SEE WALLS SECTIONS AND DETAILS FOR MORE INFORMATION.

6. CONTRACTOR TO REPLY TO ALL REQUESTS FOR CONNECTION PRIOR TO COMMENCEMENT OF NEW CONSTRUCTION IN CASE OF THE CONTRACTOR SHALL NOTIFY THE ARCHITECT PRIOR TO ANY CONNECTION.

7. ALL PIPES TO BE SUPPLIED AND INSTALLED BY CONTRACTOR UNLESS SPECIFICALLY NOTED AS "N.C." OR OTHERWISE.

8. COORDINATION OF WORK TO PROTECT ADJACENT SPACES FROM CONSTRUCTION. ZONE, PROVIDE BARREER DIVISIONS AS REQUIRED AND DIRECTED BY GENERAL CONTRACTOR AND OWNER, AND PROVIDE PROTECTION TO ALL ADJACENT AREAS.

9. PENETRATIONS SHALL BE FIRE STOPPED AND SEALED IN ACCORDANCE TO APPLICABLE UL, ADOPTED NATIONAL, AND TO STRUCTURAL AND MECHANICAL DRAWINGS AND SPECIFICATIONS FOR MORE INFORMATION.

THE PROPOSED PROJECT CONSISTS OF 361 UNITS, AND A PARKING STRUCTURE FOR UP TO 521 CARS.

THE MULTIFAMILY BUILDING WILL BE FULLY SPRINKLERED PER NFPA 13, THERE ARE 7 LEVELS DUE TO THE TOPOGRAPHICAL ELEVATION OF THE SITE BUT NEVER MORE THAN 3 TOTAL LEVELS AT ANY GIVEN POINT OF VERTICAL RISE. TYPE 1A CONSTRUCTION, ANCHOR SPACES SERVING THE RESIDENTS WILL BE LOCATED ON THE BASEMENT, FIRST AND SECOND FLOOR LEVELS.

THE PARKING STRUCTURE WILL BE 6/STORIES OF TYPE 1A CONSTRUCTION FINISHED WITH LIKE MATERIAL OF THE MULTIFAMILY BUILDING.

LOCATION:	WALL SQ/FT	TRANS SQ/FT	% OF 3'-8"	% OF 12"
GROUND	543 SQ/FT	404 SQ/FT		55%

GROUND	67 SQ/FT	401 SQ/FT	-	65%
GROUND	255 SQ/FT	183 SQ/FT	71%	--

LOCATION:	WALL SQ/FT	TRANS SQ/FT	% OF TRANS	REQ'
GROUND	5,450 SQ/FT	2,007 SQ/FT	36%	20%

UPPER	21,545 SQ/FT	7,283 SQ/FT	33%	15%
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OVERALL BUILDING TRANSPARENCY DIAGRAM
REF DRAWING: 1 / A100 SCALE: 1/32" = 1'-0"

NORTH ELEVATION - TRANSPARENCY DIAGRAM




CROSS HATCH INDICATES LOCATION OF FOUNDATION WALLS. (SEE L1 SHEETS FOR FOUNDATION PLANTINGS.) PER SEC 7.2.8.E.A.

-CROSS HATCH INDICATES LOCATION OF FOUNDATION WALLS. (SEE L1 SHEETS FOR FOUNDATION PLANTINGS.) PER SEC 7.2 & E.A

MODULE 3 = 53' - 5" HT

NORTH ELEVATION 1/16" = 1'-0"	B1
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SOUTH ELEVATION
1/16" = 1'-0" **A1**

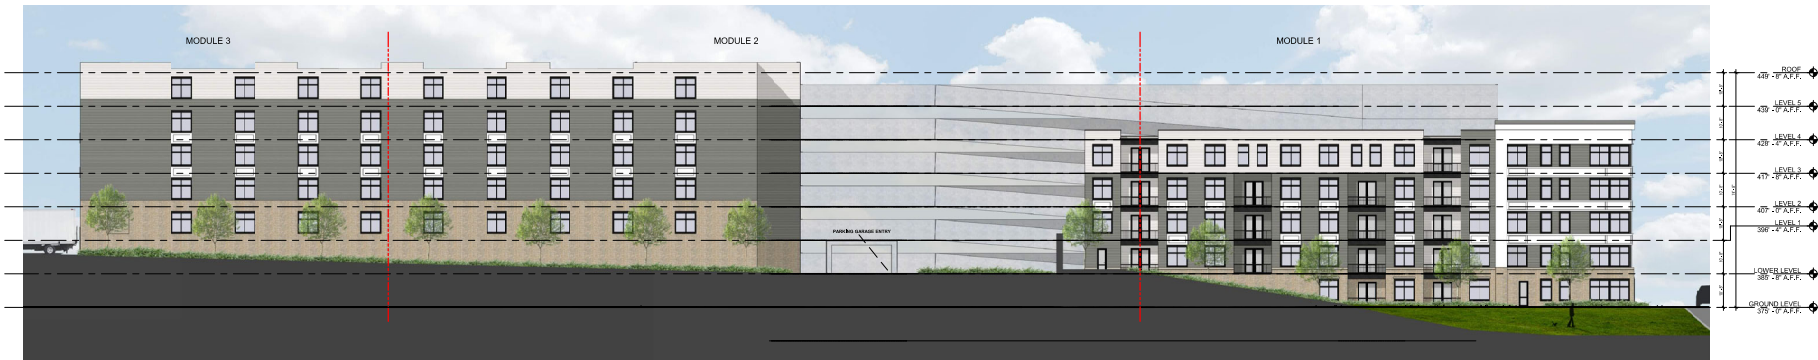ELEVATION GENERAL NOTES



1. SEE SPECIFICATIONS FOR DETAILED INFORMATION.
2. SEE ADD-2017 FOR GENERAL CONDITIONS OF THE CONTRACT FOR CONSTRUCTION.
3. SEE SHEET 101 FOR TYPICAL NOTES, SYMBOLS, ACCESSIBILITY WORKING STANDARDS, AND ABBREVIATIONS. USE SHEET 102 FOR CODE SUMMARY INFORMATION.
4. CONTRACTOR TO COORDINATE CONSTRUCTION WITH ALL TRADES PRIOR TO COMMENCEMENT OF WORK.
5. CONTRACTOR SHALL BE RESPONSIBLE FOR REPAIRING, PATCHING, AND REPLACING ANY DAMAGE DUE TO CONSTRUCTION OR INSTALLATION OF TRAVEL, REPAIR, PATCH, AND FINISH OF EXISTING CONDITIONS DAMAGED BY NEW WORK SHALL MATCH ADJACENT WORK.
6. ELEVATION DIMENSIONS ARE TAKEN FROM FACE OF SHEATHING OR MASONRY UNITS. SEE WALL SECTIONS AND DETAILS FOR MORE INFORMATION.
7. CONTRACTOR TO RE-VERIFY DIMENSIONS AND CONNECTIONS PRIOR TO COMMENCEMENT OF NEW CONSTRUCTION. IN CASE OF CONFLICT, THE CONTRACTOR SHALL NOTIFY THE ARCHITECT PRIOR TO PROCEEDING WITH WORK.
8. ALL ITEMS TO BE SUBMITTED AND INSTALLED BY CONTRACTOR UNLESS SPECIFICALLY LISTED AS "N.C." OR "BY OTHER".
9. CONCRETE SEQUENCE OF WORK TO PROTECT ADJACENT SPACES FROM CONSTRUCTION ZONE, PROVIDE BARRIER SEPARATION AS REQUIRED AND DIRECTED BY GENERAL CONTRACTOR AND OWNER, ALL WORKMANSHIP RATING OF CONSTRUCTION WHERE ANY ITEMS ARE SUB. INTO CONSTRUCTION, ALL FINE TRADES SHALL BE THE STOPPED AND SEALED IN ACCORDANCE TO APPLICABLE U.L. ASSEMBLY DETAIL.
10. REFER TO STRUCTURAL AND MECHANICAL DRAWINGS AND SPECIFICATIONS FOR MORE INFORMATION.

GENERAL BUILDING INFORMATION

THE PROPOSED PROJECT CONSISTS OF 301 UNITS, AND A PARKING STRUCTURE FOR UP TO 521 CARS.

THE MULTIFAMILY BUILDING WILL BE FULLY SPRINKLERED PER NFPA 13. THERE ARE 7 LEVELS DUE TO THE TOPOGRAPHICAL ELEVATION OF THE SITE BUT NEVER MORE THAN 5 TOTAL LEVELS AT ANY ONE POINT OF RISE FROM THE TYPE 4A CONSTRUCTION LIMITS. SPACES BELOW THE REBENTERS WILL BE LOCATED ON THE BASEMENT, FIRST AND SECOND FLOOR LEVELS.

THE PARKING STRUCTURE WILL BE 5-5 STORY OF TYPE 4A CONSTRUCTION FINISHED WITH LIKELIHOOD MATERIAL OF THE MULTIFAMILY BUILDING.

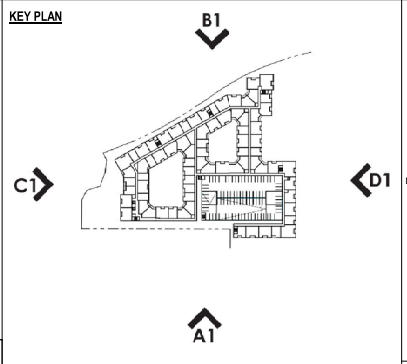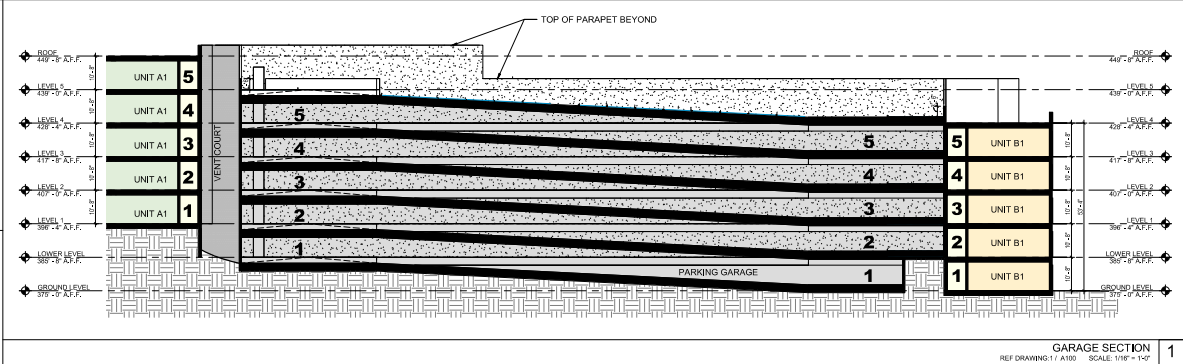


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OWNER
KIMCO RALEIGH L.P.

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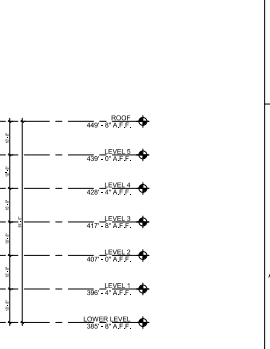


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PLEASANT VALLEY PROMENADE

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RALEIGH, NC 27612

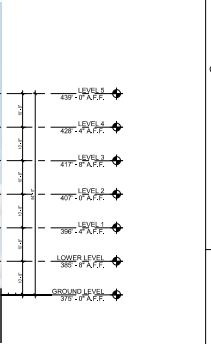CLIENT: KIMCO RALEIGH L.P.



WEST ELEVATION
1/16" = 1'-0"

A202