Administrative Site Review Application

Office Use Only: Case #:



Planning and Development Customer Service Center • One Exchange Plaza, Suite 400 | Raleigh, NC 27601 | 919-996-2500

This form is required when submitting site plans as referenced in Unified Development Ordinance (UDO) Section 10.2.8. Please check the appropriate building types and include the plan checklist document when submitting.

Planner (print): _

Please review UDO Section 10.2.8. to determine the site plan tier. If assistance determining a Site Plan Tier is needed a Site Plan Tier Verification request can be submitted online via the <u>Permit and Development Portal</u> . (Note: There is a fee for this verification service.)						
Site Plan Tier: Tier Two Site Plan ☐ Tier Three			e Site Plan □			
	Building Type		Site Transaction History			
	☐ Detached ☐	Cottage Court	Subdivision case #:			
[□ Attached	☐ General	Scoping/sketch plan case #: Certificate of Appropriateness #:			
	Apartment	☐ Mixed use	Board of Adjustment #:			
	Townhouse	☐ Open lot	Zoning Case #: Design Alternate #:			
	Tiny house	☐ Civic				
		GENERAL IN	IFORMATION			
Development na	me:					
Inside City limits	Inside City limits? Yes No					
Property address	s(es):					
Site P.I.N.(s):						
Please describe the scope of work. Include any additions, expansions, and uses (UDO 6.1.4).						
Current Property Owner(s):						
Company:			Title:			
Address:		1				
Phone #:	Phone #: Email:					
Applicant Name (If different from owner. See "who can apply" in instructions):						
Relationship to owner: Lessee or contract purchaser Owner's authorized agent Easement holder						
Company:	Company: Address:					

Page 1 of 3 REVISION 10.25.22

Email:				
NOTE: please attach purchase agreement or contract, lease or easement when submitting this form.				
	Title:			
Email:				
Applicant Name:				
Address:				
Email:				
	t or contract, Email: Address:			

DEVELOPMENT TYPE + SITE DATE TABLE (Applicable to all developments)				
SITE DATA	BUILDING DATA			
Zoning district(s) (please provide the acreage of each):	Existing gross floor area (not to be demolished):			
Gross site acreage:	Existing gross floor area to be demolished:			
# of parking spaces proposed:	New gross floor area:			
Max # parking permitted (7.1.2.C):	Total sf gross (to remain and new):			
Overlay District (if applicable):	Proposed # of buildings:			
Existing use (UDO 6.1.4):	Proposed # of stories for each:			
Proposed use (UDO 6.1.4):	Proposed # of basement levels (UDO 1.5.7.A.6)			

STORMWATER INFORMATION				
Imperious Area on Parcel(s):	Impervious Area for Compliance (includes ROW):			
Existing (sf) Proposed total (sf)	Existing (sf) Proposed total (sf)			

RESIDENTIAL & OVERNIGHT LODGING DEVELOPMENTS						
Total # of dwelling units: Total # of hotel bedrooms:						
# of bedroom units: 1br 2br 3br 4br or more						
# of lots:		Is your project a cottage court?	Yes	No		
		A frequent transit development?	Yes	No		

Continue to Applicant Signature Block on Page Three.

Page 2 of 3 REVISION 10.25.22

APPLICANT SIGNATURE BLOCK

Pursuant to state law (N.C. Gen. Stat. § 160D-403(a)), applications for development approvals may be made by the landowner, a lessee or person holding an option or contract to purchase or lease land, or an authorized agent of the landowner. An easement holder may also apply for development approval for such development as is authorized by the easement.

By submitting this application, the undersigned applicant acknowledges that they are either the property owner or one of the persons authorized by state law (N.C.G.S. 160D-403(a)) to make this application, as specified in the application. The undersigned also acknowledges that the information and statements made in the application are correct and the undersigned understands that developments approvals are subject to revocation for false statements or misrepresentations made in securing the development approval, pursuant to N.C. Gen. Stat. § 160D-403(f).

The undersigned indicates that the property owner(s) is aware of this application and that the proposed project described in this application will be maintained in all respects in accordance with the plans and specifications submitted herewith, and in accordance with the provisions and regulations of the City of Raleigh Unified Development Ordinance.

The undersigned hereby acknowledges that, pursuant to state law (N.C.G.S. 143-755(b1), if this permit application is placed on hold at the request of the applicant for a period of six consecutive months or more, or if the applicant fails to respond to comments or provide additional information requested by the City for a period of six consecutive months or more, then the application review is discontinued and a new application is required to proceed and the development regulations in effect at the time permit processing is resumed shall apply to the new application.

Signature:	Scuttleri	Date: 4 20 23			
Printed Name:	Scott Dixon				



(NOT TO SCALE)

DENSITY CALCULATION - LOT 10

TOTAL ACREAGE: 45,349 S.F. (1.0411 AC.)

MAXIMUM DENSITY: 18.14 UNITS (1DU / 2,500SF) PROPOSED DENSITY: 18 UNITS (1DU / 2,519SF)

VEHICLE PARKING SUMMARY

September 12, 2022

Beacon Street

2607 Oberlin Rd

Raleigh, NC 27608

Attn: Justin Hime

Sincerely,

Tara Zents Account Manager

(M) 919-427-2399

GFL Environmental – Raleigh

Budleigh located off St. Mary's, Oberlin and Fairview.

commercial waste and recycling services for this property.

This is a letter of support for trash and recycling services for your new project being planned for

We have reviewed the plans and have found that GFL Environmental will be able to safely perform all

If the project design changes, this letter is void and a new letter must be issued. Additionally, this letter

Current design plans include residential carts for the perimeter buildings and mini mac containers for

the center condo building. Valet service is anticipated by GFL. Frequency of service is to be determined

We want to visit the site during the initial phases of construction to ensure that the site will continue to

Should you have any questions or need more information, please contact me at tara.zents@gflenv.com

be safe to service and the trash enclosure will be large enough to accommodate the volume of trash

We look forward to providing waste and recycling services at your new property once it has been

PROPOSED 10 2-BR UNITS 2.25 SP PER UNIT MAX = 22.5 SPACES

PROPOSED 8 3-BR UNITS 3 SP PER UNIT MAX = 24 SPACES

MAXIMUM ALLOWED PARKING = 47 SPACES

TOTAL PARKING PROVIDED FOR 18 UNITS. 39 SPACES . 1 ADA SPACE (VAN)

SHARED PARKING PROVIDED FOR SUB-0062-2022. . 16 SPACES

BICYCLE PARKING SUMMARY

SHORT-TERM (MIN) 1 PER 20 UNITS MIN 4 = 4 SPACES (18 UNITS) LONG-TERM (MIN) 1 PER 7 BR = 5 SPACES (36 BEDROOMS)

TOTAL BICYCLE PARKING PROVIDED (ALL IN GARAGE) SHORT-TERM - 4 SPACES

LONG-TERM - 6 SPACES

AMENITY AREA CALCULATION - LOT 10

GROSS AREA	45,349 S.F. (1.0411 AC.)
NET AREA	45,349 S.F. (1.0411 AC.)
REQUIRED AREA (10%)	4,535 S.F. (0.1041 AC.)
REQUIRED ADA ACCESSIBLE (50% OF REQ'D)	2,268 S.F. (0.0521 AC.)
PROVIDED AREA (10.4%)	4,880 S.F. (0.1120 AC.)
PROVIDED ADA ACCESSIBLE AREA	2,380 S.F. (0.0546 AC.)

LOT 10 BUDLEIGH EAST

ADMINISTRATIVE SITE REVIEW - TIER 3

ASR-_____-2023

SUB-0062-2022(REV)

RALEIGH, NORTH CAROLINA

APRIL 2023



OWNER/DEVELOPER:

PO Box 6474 Raleigh, N.C. 27628 919-785-1445

CIVIL ENGINEER:

JAECO JOHN A. EDWARDS & COMPANY

Consulting Engineers NC License F-0289 333 Wade Ave., Raleigh, NC 27605 Phone: (919) 828-4428 Fax: (919) 828-4711 E-mail: info@jaeco.com

BEACON STREET BUDLEIGH LLC

sdixon@beacon-street.com

DEVELOPERS HAVE REVIEWED AND ARE IN COMPLIANCE WITH THE REQUIREMENTS SET FORTH IN THE SOLID WASTE DESIGN MANUAL PRIVATE SERVICE TO BE PROVIDED.

SOLID WASTE SERVICES

INDEX

COVER SHEET

CE-1 **OVERALL SUBDIVISION PLAN**

CE-2 **EXISTING CONDITIONS**

CE-3 SITE PLAN

CE-4 **SITE PLAN - PARKING LEVEL**

CE-5 **UTILITY PLAN**

CE-6 **GRADING / STORMWATER MANAGEMENT PLAN**

CE-7 FIRE DEPARTMENT PLAN

LANDSCAPE PLAN L-1

LANDSCAPE DETAILS **L-2** A100 **GARAGE FLOOR PLAN**

A104 **ROOF DECK**

A201 **EXTERIOR ELEVATIONS**

A202 EXTERIOR ELEVATIONS

SITE DATA

OWNER:

BEACON STREET BUDLEIGH LLC PO BOX 6474

RALEIGH, NC 27628-6474

ADDRESS: 2550 OBERLIN RD

RALEIGH, NC 27608

PIN# (PARENT PARCEL) 1704-29-3852

AREA: PROPOSED LOT 10 (SUB-0062-2022)

45,349 S.F. (1.0411 AC.)

ZONING: R-10

CURRENT USE: VACANT

REFERENCES: DB 18959, PG 2149 BM 2022, PG 386

WAKE COUNTY REGISTRY

ALL CONSTRUCTION SHALL BE IN ACCORDANCE WITH CITY OF RALEIGH AND / OR NCDOT STANDARDS AND SPECIFICATIONS.

HORIZONTAL DATUM: VERTICAL DATUM:

Administrative Site Review Application

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Please review UDO Section 10.2.8. to determine the site plan tier. If assistance determining a Site Plan Tier is needed a Site Plan Tier Verification request can be submitted online via the Permit and Development Portal. (Note: There is a

Site Plan Tier: Tier Two Site Plan Tier Three Site Plan ✓ Cottage Court Subdivision case #: SUB-0062-2022 Scoping/sketch plan case #: SCOPE-0092-2022 ☐ Attached Mixed use | Board of Adjustment #: ☐ Open lot Design Alternate #:

☐ Tiny house **GENERAL INFORMATION** Development name: Lot 10 Budleigh East Inside City limits? Yes No

2550 Oberlin Road Site P.I.N.(s): 1704-29-3852 Please describe the scope of work. Include any additions, expansions, and uses (UDO 6.1.4).

Current Property Owner(s): Beacon Street Budleigh LLC

Property address(es):

Phone #: (919) 785-1445

Existing use (UDO 6.1.4): vacant

Proposed use (UDO 6.1.4): multi-family condo

Address: PO Box 6474, Raleigh NC 27628

18 Condominium units in a single building over structured parking

Email: sdixon@beacon-street.com Applicant Name (If different from owner. See "who can apply" in instructions): Beacon Street Budleigh LLC

Relationship to owner: Lessee or contract purchaser Owner's authorized agent Easement holder

Address: PO Box 6474, Raleigh NC 27628

REVISION 10.25.22

NOTE: please attach purchase agreement or contract, lease or easement when submitting this form. Company: Beacon Street Budleigh LLC Title: Vice President Address: PO Box 6474, Raleigh NC 27628 Phone #: (919) 785-1445 Email: sdixon@beacon-street.com Applicant Name: Beacon Street Budleigh LLC Address: PO Box 6474, Raleigh NC 27628

Email: sdixon@beacon-street.com

Proposed # of basement levels (UDO 1.5.7.A.6) 1

A frequent transit development? (


DEVELOPMENT TYPE + SITE DATE TABLE SITE DATA Zoning district(s) (please provide the acreage of each): | Existing gross floor area (not to be demolished): Existing gross floor area to be demolished: 1.0411 Acres # of parking spaces proposed: 39 + 16 shared New gross floor area: 51,567 sf Max # parking permitted (7.1.2.C): 47 for condo use | Total sf gross (to remain and new): 51,567 sf Overlay District (if applicable) Proposed # of buildings:


Imperious Area on Parcel(s): Impervious Area for Compliance Existing (sf) 14,280 Proposed total (sf) 37,130 Existing (sf) 16,169 Proposed total (sf) 53,299 Total # of dwelling units: 18 Total # of hotel bedrooms 4br or more # of bedroom units: 1br Is your project a cottage court? Yes No

Pursuant to state law (N.C. Gen. Stat. § 160D-403(a)), applications for development approvals may be made by the landowner, a lessee or person holding an option or contract to purchase or lease land, or an authorized agent of the landowner. An easement holder may also apply for development approval for such development as is authorized by the easement. By submitting this application, the undersigned applicant acknowledges that they are either the property owner or one of the persons authorized by state law (N.C.G.S. 160D-403(a)) to make this application, as specified in the application. The undersigned also acknowledges that the information and statements made in the application are correct and the undersigned understands that developments approvals are subject to revocation for false statements or misrepresentations made in securing the development approval, pursuant to N.C. Gen. Stat. § The undersigned indicates that the property owner(s) is aware of this application and that the proposed project described in this application will be maintained in all respects in accordance with the plans and specifications submitted herewith, and in accordance with the provisions and regulations of the City of Raleigh Unified The undersigned hereby acknowledges that, pursuant to state law (N.C.G.S. 143-755(b1), if this permit application is placed on hold at the request of the applicant for a period of six consecutive months or more, or if the applicant fails to respond to comments or provide additional information requested by the City for a period of six consecutive months or more, then the application review is discontinued and a new application is required to proceed and the

development regulations in effect at the time permit processing is resumed shall apply to the new application.

Signature: Scutton Date: 4 | 20 | 23 Printed Name: Scott Dixos

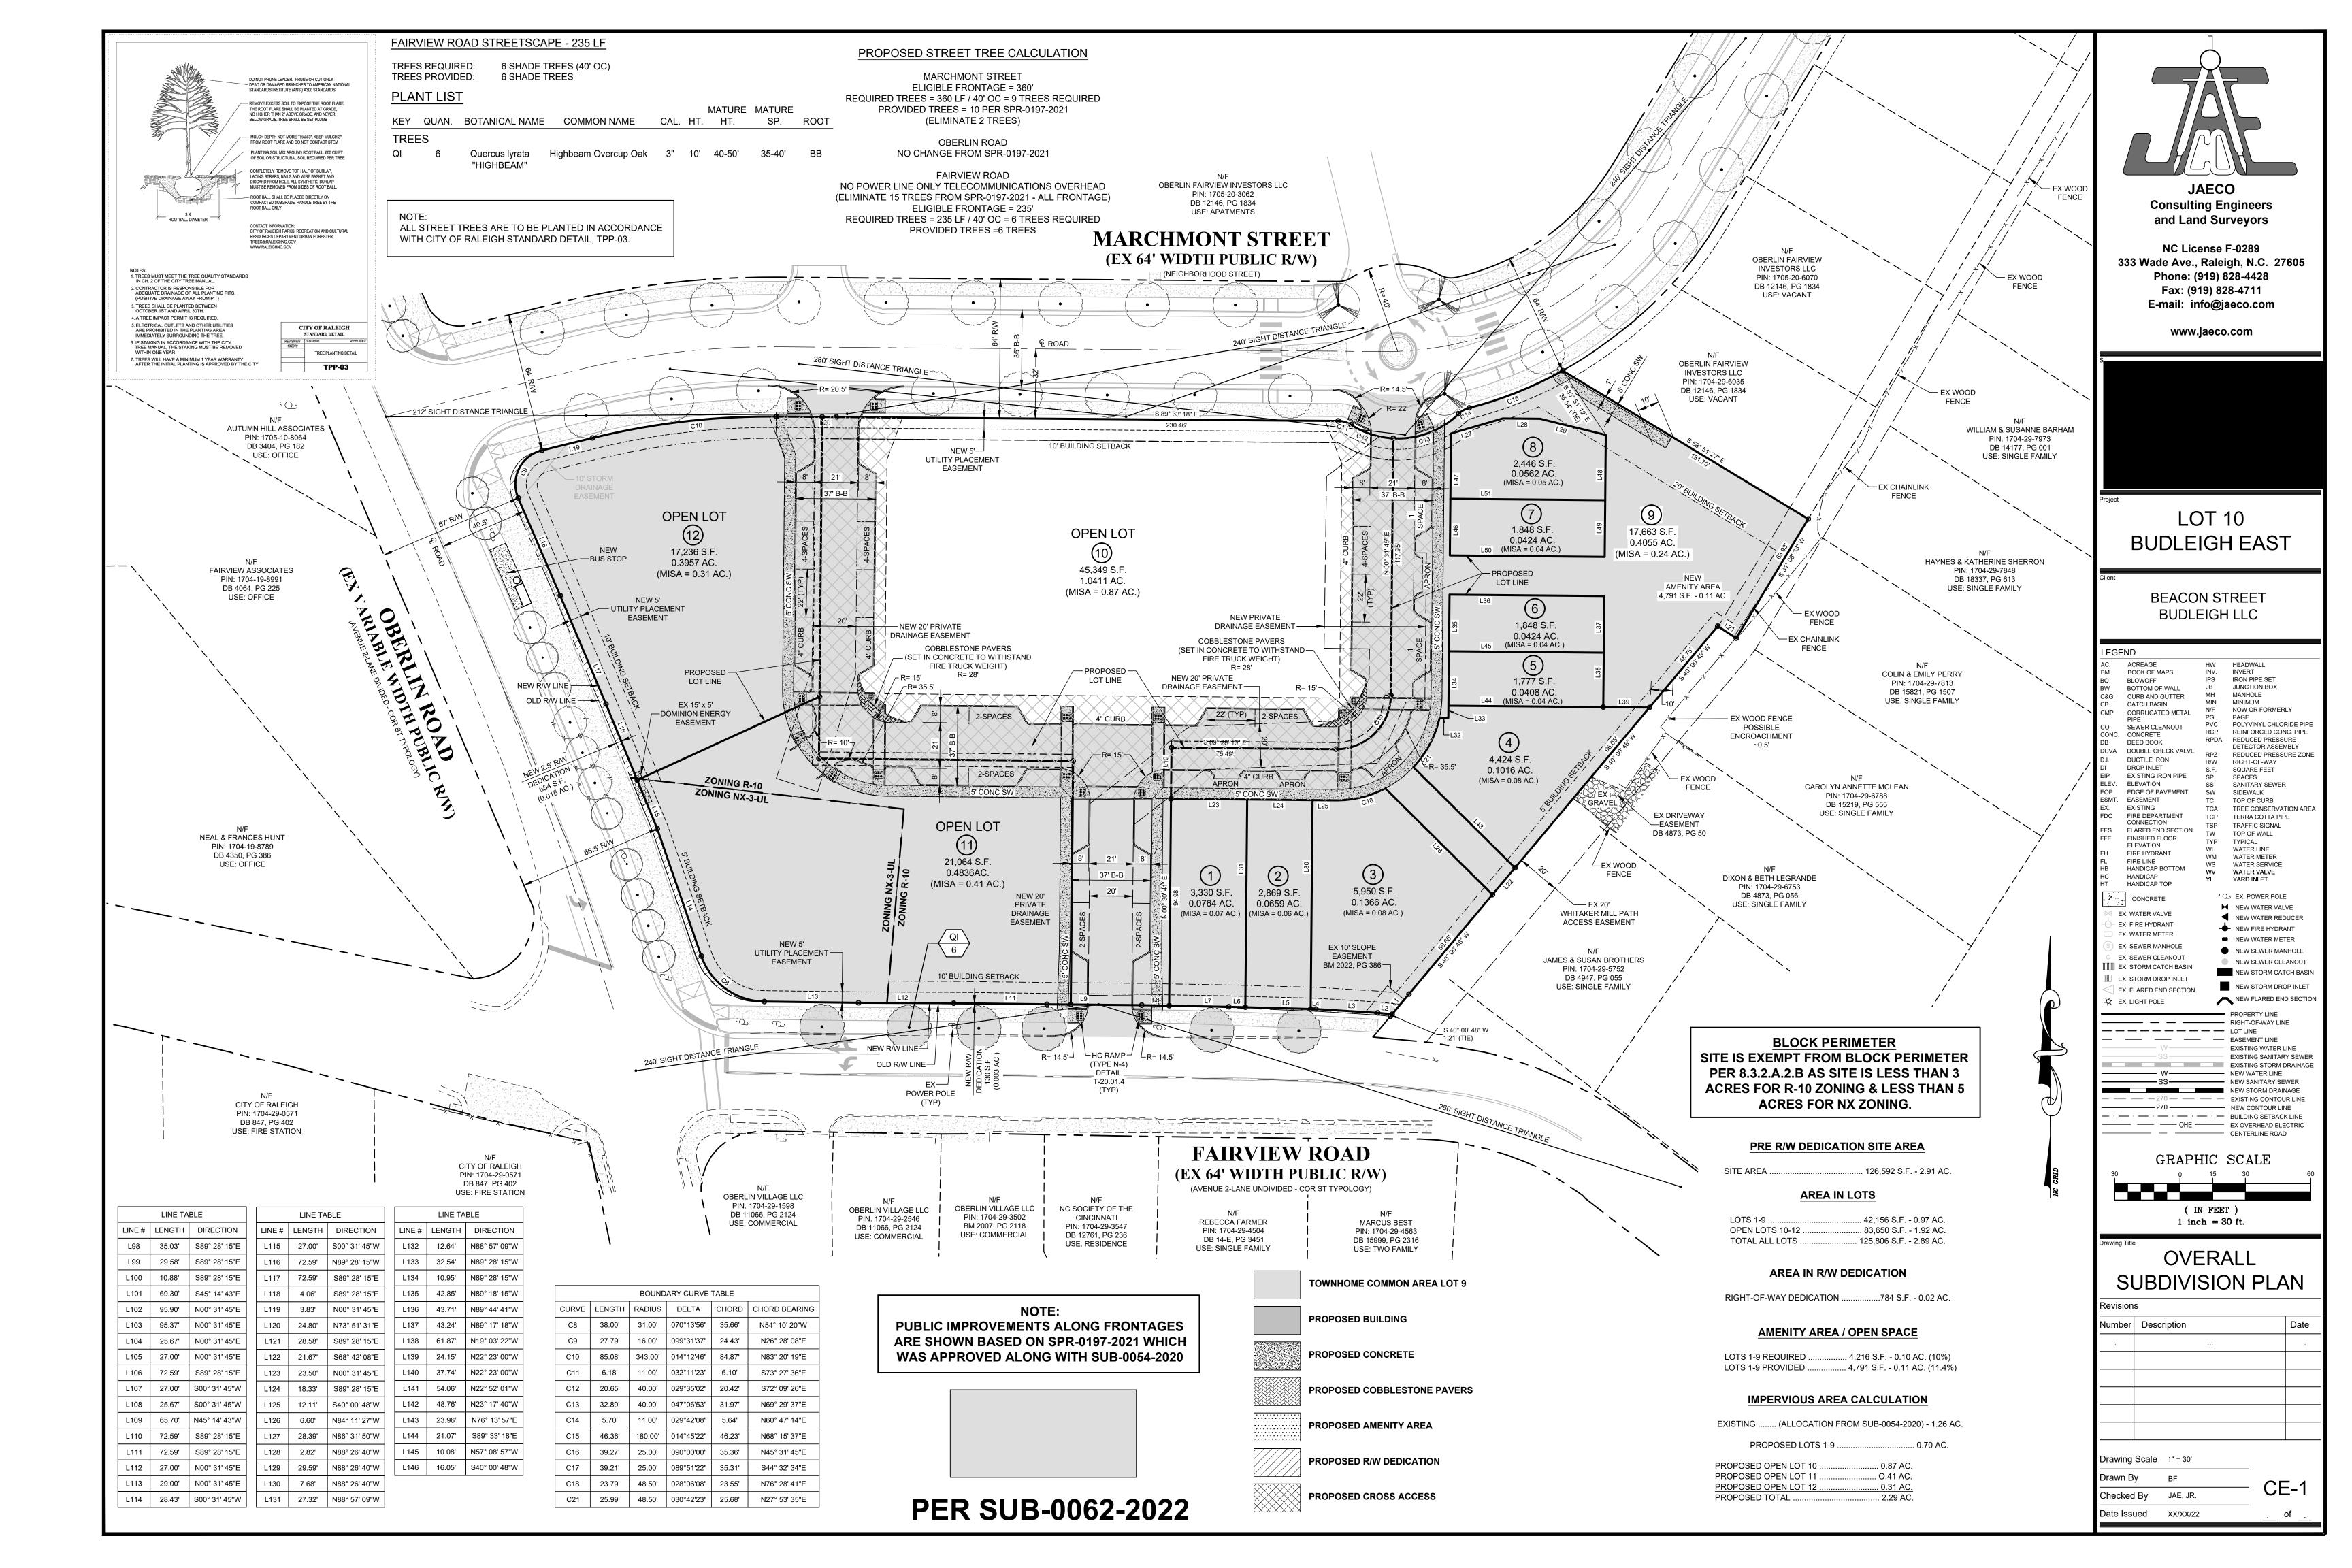

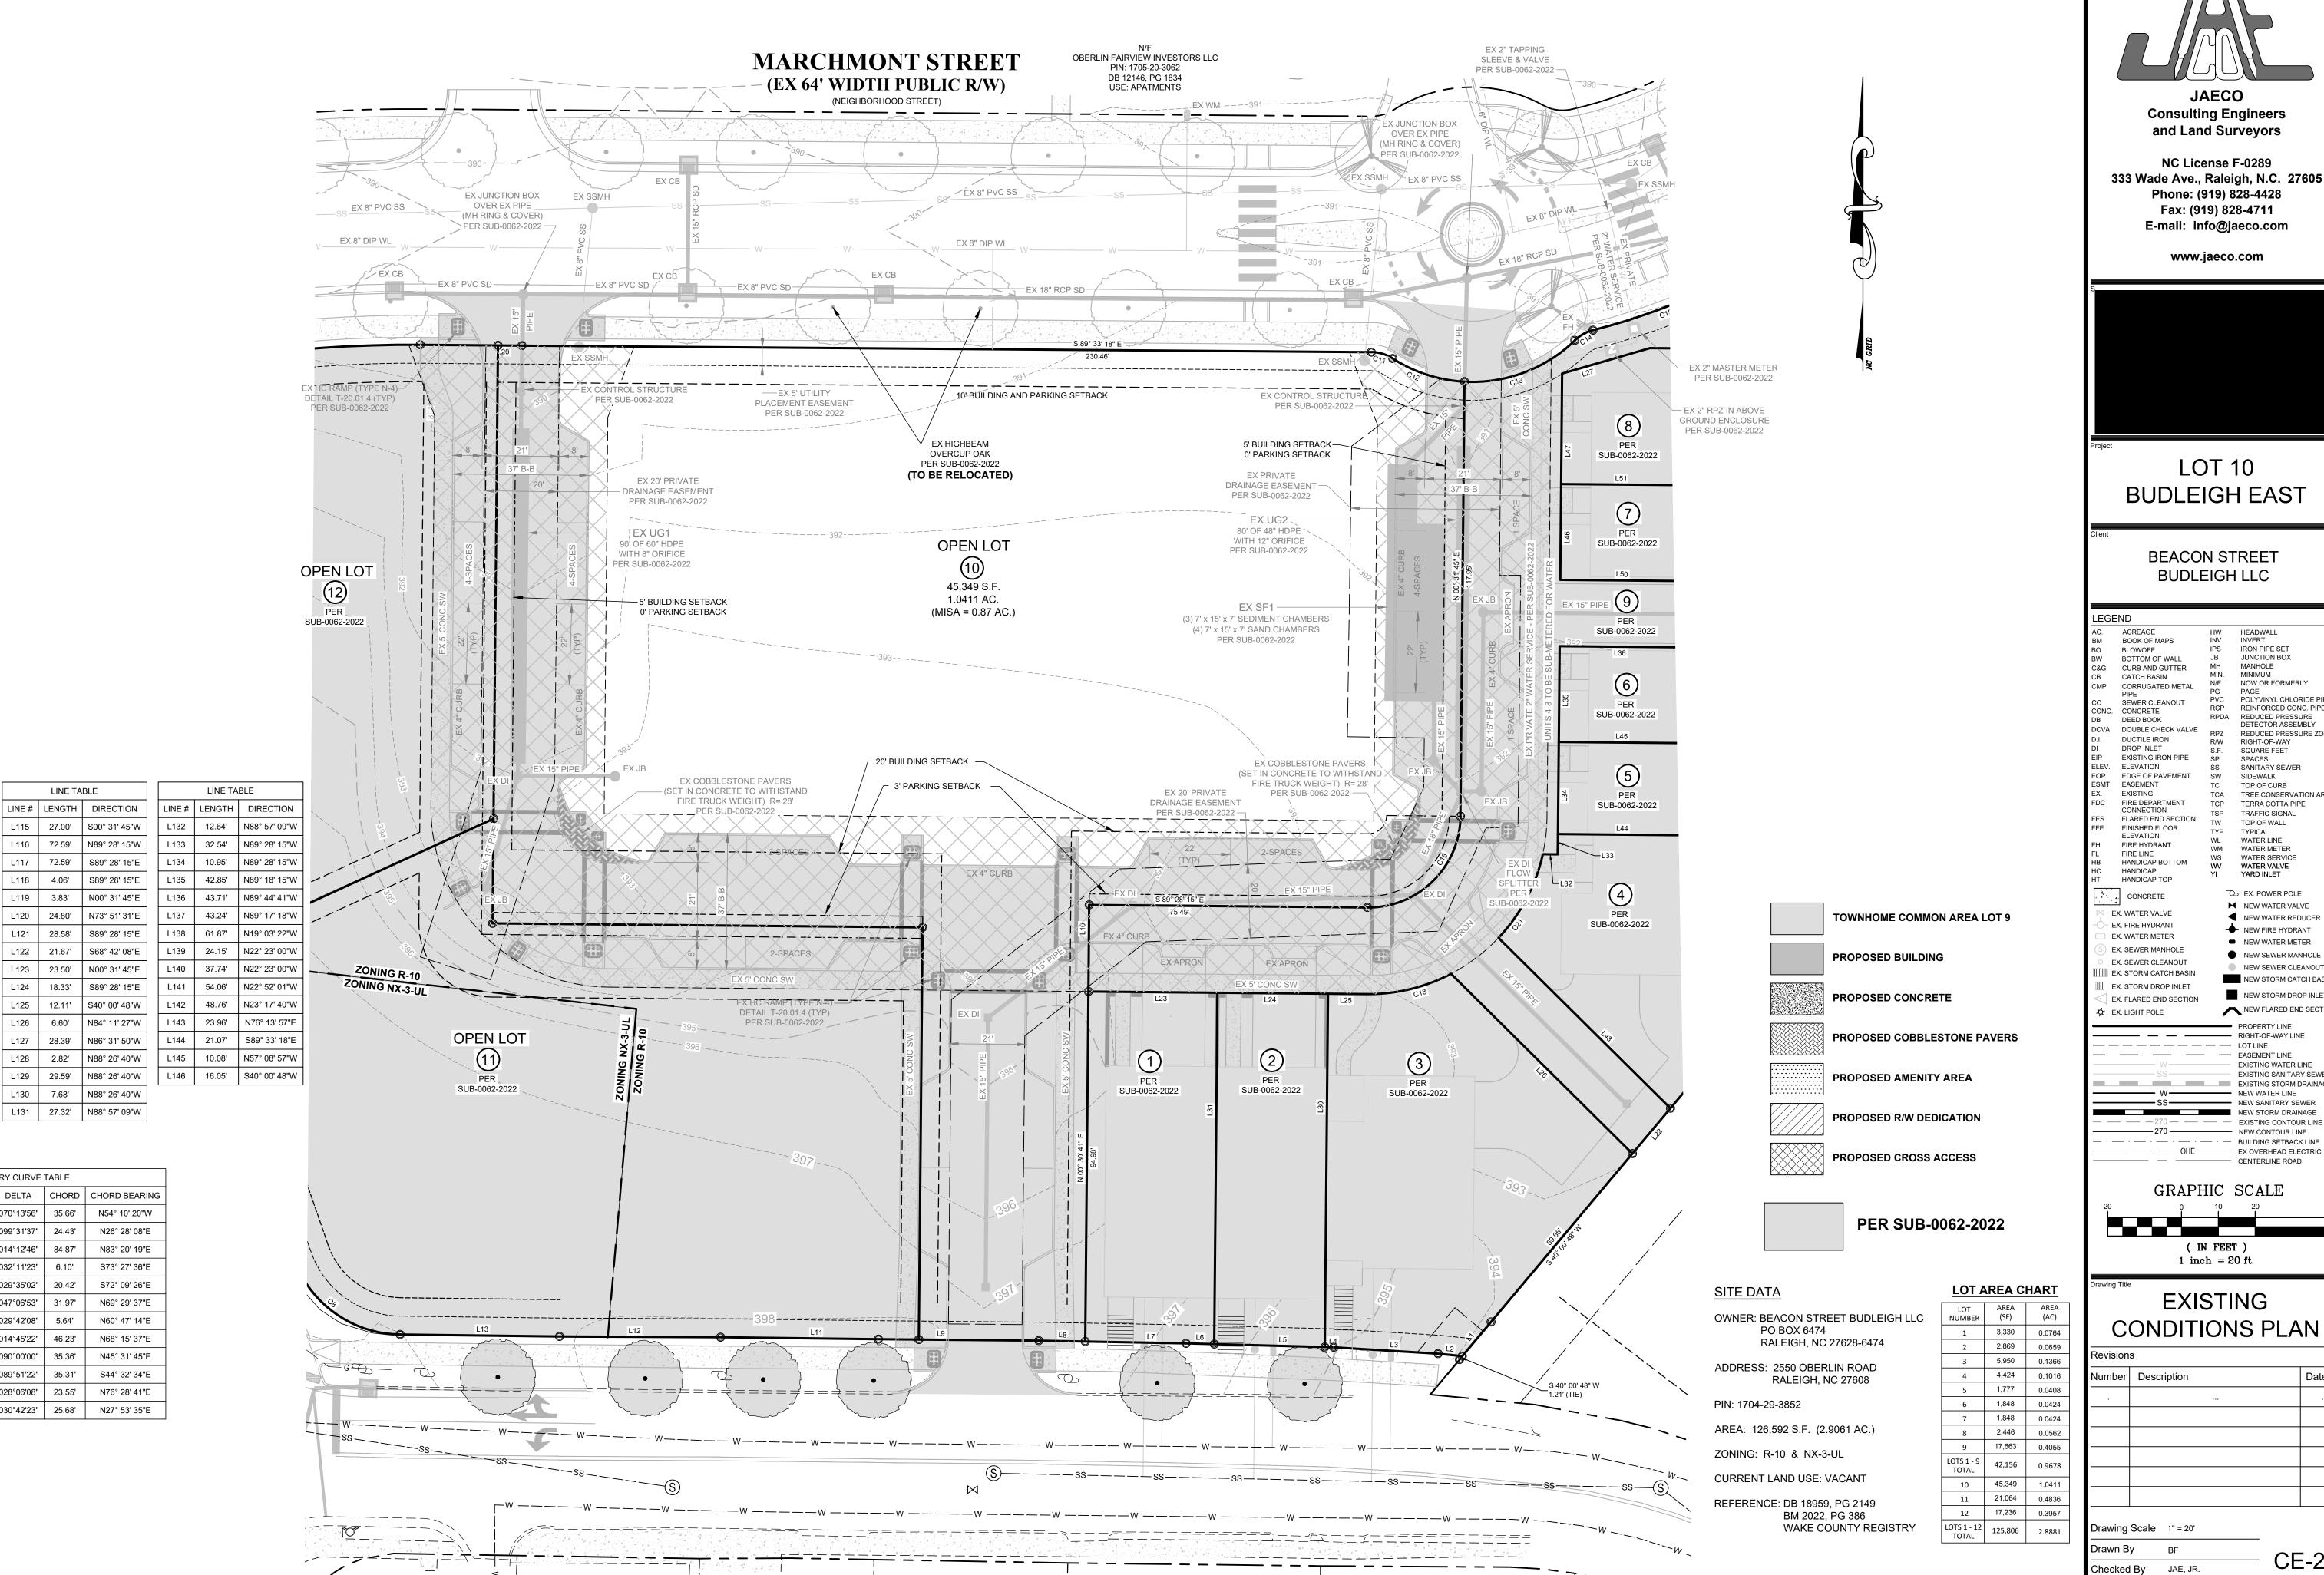

LINE TABLE

LINE # | LENGTH | DIRECTION

L99 | 29.58' | S89° 28' 15"E

L101 | 69.30' | S45° 14' 43"E

L102 95.90' N00° 31' 45"E

L103 | 95.37' | N00° 31' 45"E

L104 25.67' N00° 31' 45"E

L108 | 25.67' | S00° 31' 45"W

L109 | 65.70' | N45° 14' 43"W |

L110 72.59' S89° 28' 15"E L111 72.59' S89° 28' 15"E

L113 29.00' N00° 31' 45"E

L114 28.43' S00° 31' 45"W L131 27.32' N88° 57' 09"W

BOUNDARY CURVE TABLE CURVE | LENGTH | RADIUS | DELTA | CHORD | CHORD BEARING C8 | 38.00' | 31.00' | 070°13'56" | 35.66' | N54° 10' 20"W

C9 | 27.79' | 16.00' | 099°31'37" | 24.43' | N26° 28' 08"E

C10 85.08' 343.00' 014°12'46" 84.87' N83° 20' 19"E

C11 6.18' 11.00' 032°11'23" 6.10' \$73° 27' 36"E C12 | 20.65' | 40.00' | 029°35'02" | 20.42' | \$72° 09' 26"E

C13 | 32.89' | 40.00' | 047°06'53" | 31.97' | N69° 29' 37"E

C15 | 46.36' | 180.00' | 014°45'22" | 46.23' | N68° 15' 37"E

C16 | 39.27' | 25.00' | 090°00'00" | 35.36' | N45° 31' 45"E

C17 | 39.21' | 25.00' | 089°51'22" | 35.31' | S44° 32' 34"E

C18 | 23.79' | 48.50' | 028°06'08" | 23.55' | N76° 28' 41"E

C21 25.99' 48.50' 030°42'23" 25.68' N27° 53' 35"E

5.70' | 11.00' | 029°42'08" | 5.64' | N60° 47' 14"E

35.03' S89° 28' 15"E

LINE TABLE

L115 | 27.00' | S00° 31' 45"W |

L120 | 24.80' | N73° 51' 31"E


L121 28.58' S89° 28' 15"E

L122 21.67' S68° 42' 08"E

L125 | 12.11' | S40° 00' 48"W |

L130 7.68' N88° 26' 40"W


LINE TABLE

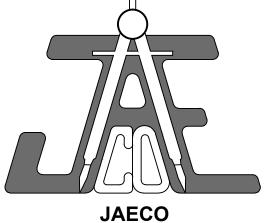

Consulting Engineers and Land Surveyors

NC License F-0289 333 Wade Ave., Raleigh, N.C. 27605 Phone: (919) 828-4428 Fax: (919) 828-4711 E-mail: info@jaeco.com

www.jaeco.com

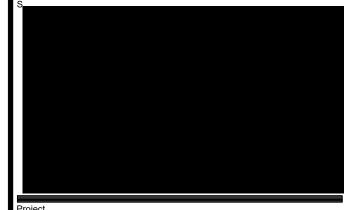

LOT 10 **BUDLEIGH EAST**

BEACON STREET BUDLEIGH LLC


LLOL			
AC.	ACREAGE	HW	HEADWALL
BM	BOOK OF MAPS	INV.	INVERT
ВО	BLOWOFF	IPS	IRON PIPE SET
BW	BOTTOM OF WALL	JB	JUNCTION BOX
C&G	CURB AND GUTTER	MH	MANHOLE
СВ	CATCH BASIN	MIN.	MINIMUM
CMP	CORRUGATED METAL	N/F	NOW OR FORMERLY
Olvii	PIPE	PG	PAGE
CO	SEWER CLEANOUT	PVC	POLYVINYL CHLORIDE PIF
CONC.	CONCRETE	RCP	REINFORCED CONC. PIPE
DB	DEED BOOK	RPDA	REDUCED PRESSURE
DCVA	DOUBLE CHECK VALVE		DETECTOR ASSEMBLY
D.I.	DUCTILE IRON	RPZ	REDUCED PRESSURE ZO
DI	DROP INLET	R/W S.F.	RIGHT-OF-WAY
EIP	EXISTING IRON PIPE	S.F.	SQUARE FEET SPACES
ELEV.	ELEVATION	SS	SANITARY SEWER
EOP	EDGE OF PAVEMENT	SW	SIDEWALK
ESMT.	EASEMENT	TC	TOP OF CURB
EX.	EXISTING	TCA	TREE CONSERVATION AR
FDC	FIRE DEPARTMENT	TCP	TERRA COTTA PIPE
	CONNECTION	TSP	TRAFFIC SIGNAL
FES	FLARED END SECTION	TW	TOP OF WALL
FFE	FINISHED FLOOR	TYP	TYPICAL
	ELEVATION	WL	WATER LINE
FH	FIRE HYDRANT	WM	WATER METER
FL	FIRE LINE	WS	WATER SERVICE
HB	HANDICAP BOTTOM	WV	WATER VALVE
HC	HANDICAP	Υl	YARD INLET
HT	HANDICAP TOP		
4	CONCRETE	\mathcal{L}	と EX. POWER POLE
11.2		×	NEW WATER VALVE
Ņ E	X. WATER VALVE	•	NEW WATER REDUCER
-Ó- E	X. FIRE HYDRANT	-4	► NEW FIRE HYDRANT
○ E	X. WATER METER		
(S) E	X. SEWER MANHOLE	_	
0 E	X. SEWER CLEANOUT	•	•
	X. STORM CATCH BASIN		NEW SEWER CLEANOUT
mm	X. STORM DROP INLET		NEW STORM CATCH BAS
	X. FLARED END SECTION		NEW STORM DROP INLE
7	X. LIGHT POLE		NEW FLARED END SECT
<u>~</u> -		—	PROPERTY LIVE
			PROPERTY LINE
			RIGHT-OF-WAY LINE
			LOT LINE
		-	EASEMENT LINE
	W SS		EXISTING WATER LINE
			EXISTING SANITARY SEWE
			EXISTING STORM DRAINA
	w		NEW WATER LINE
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			NEW STORM DRAINAGE
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	270 —		NEW CONTOUR LINE
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	GRAPE		
20	0	10	20


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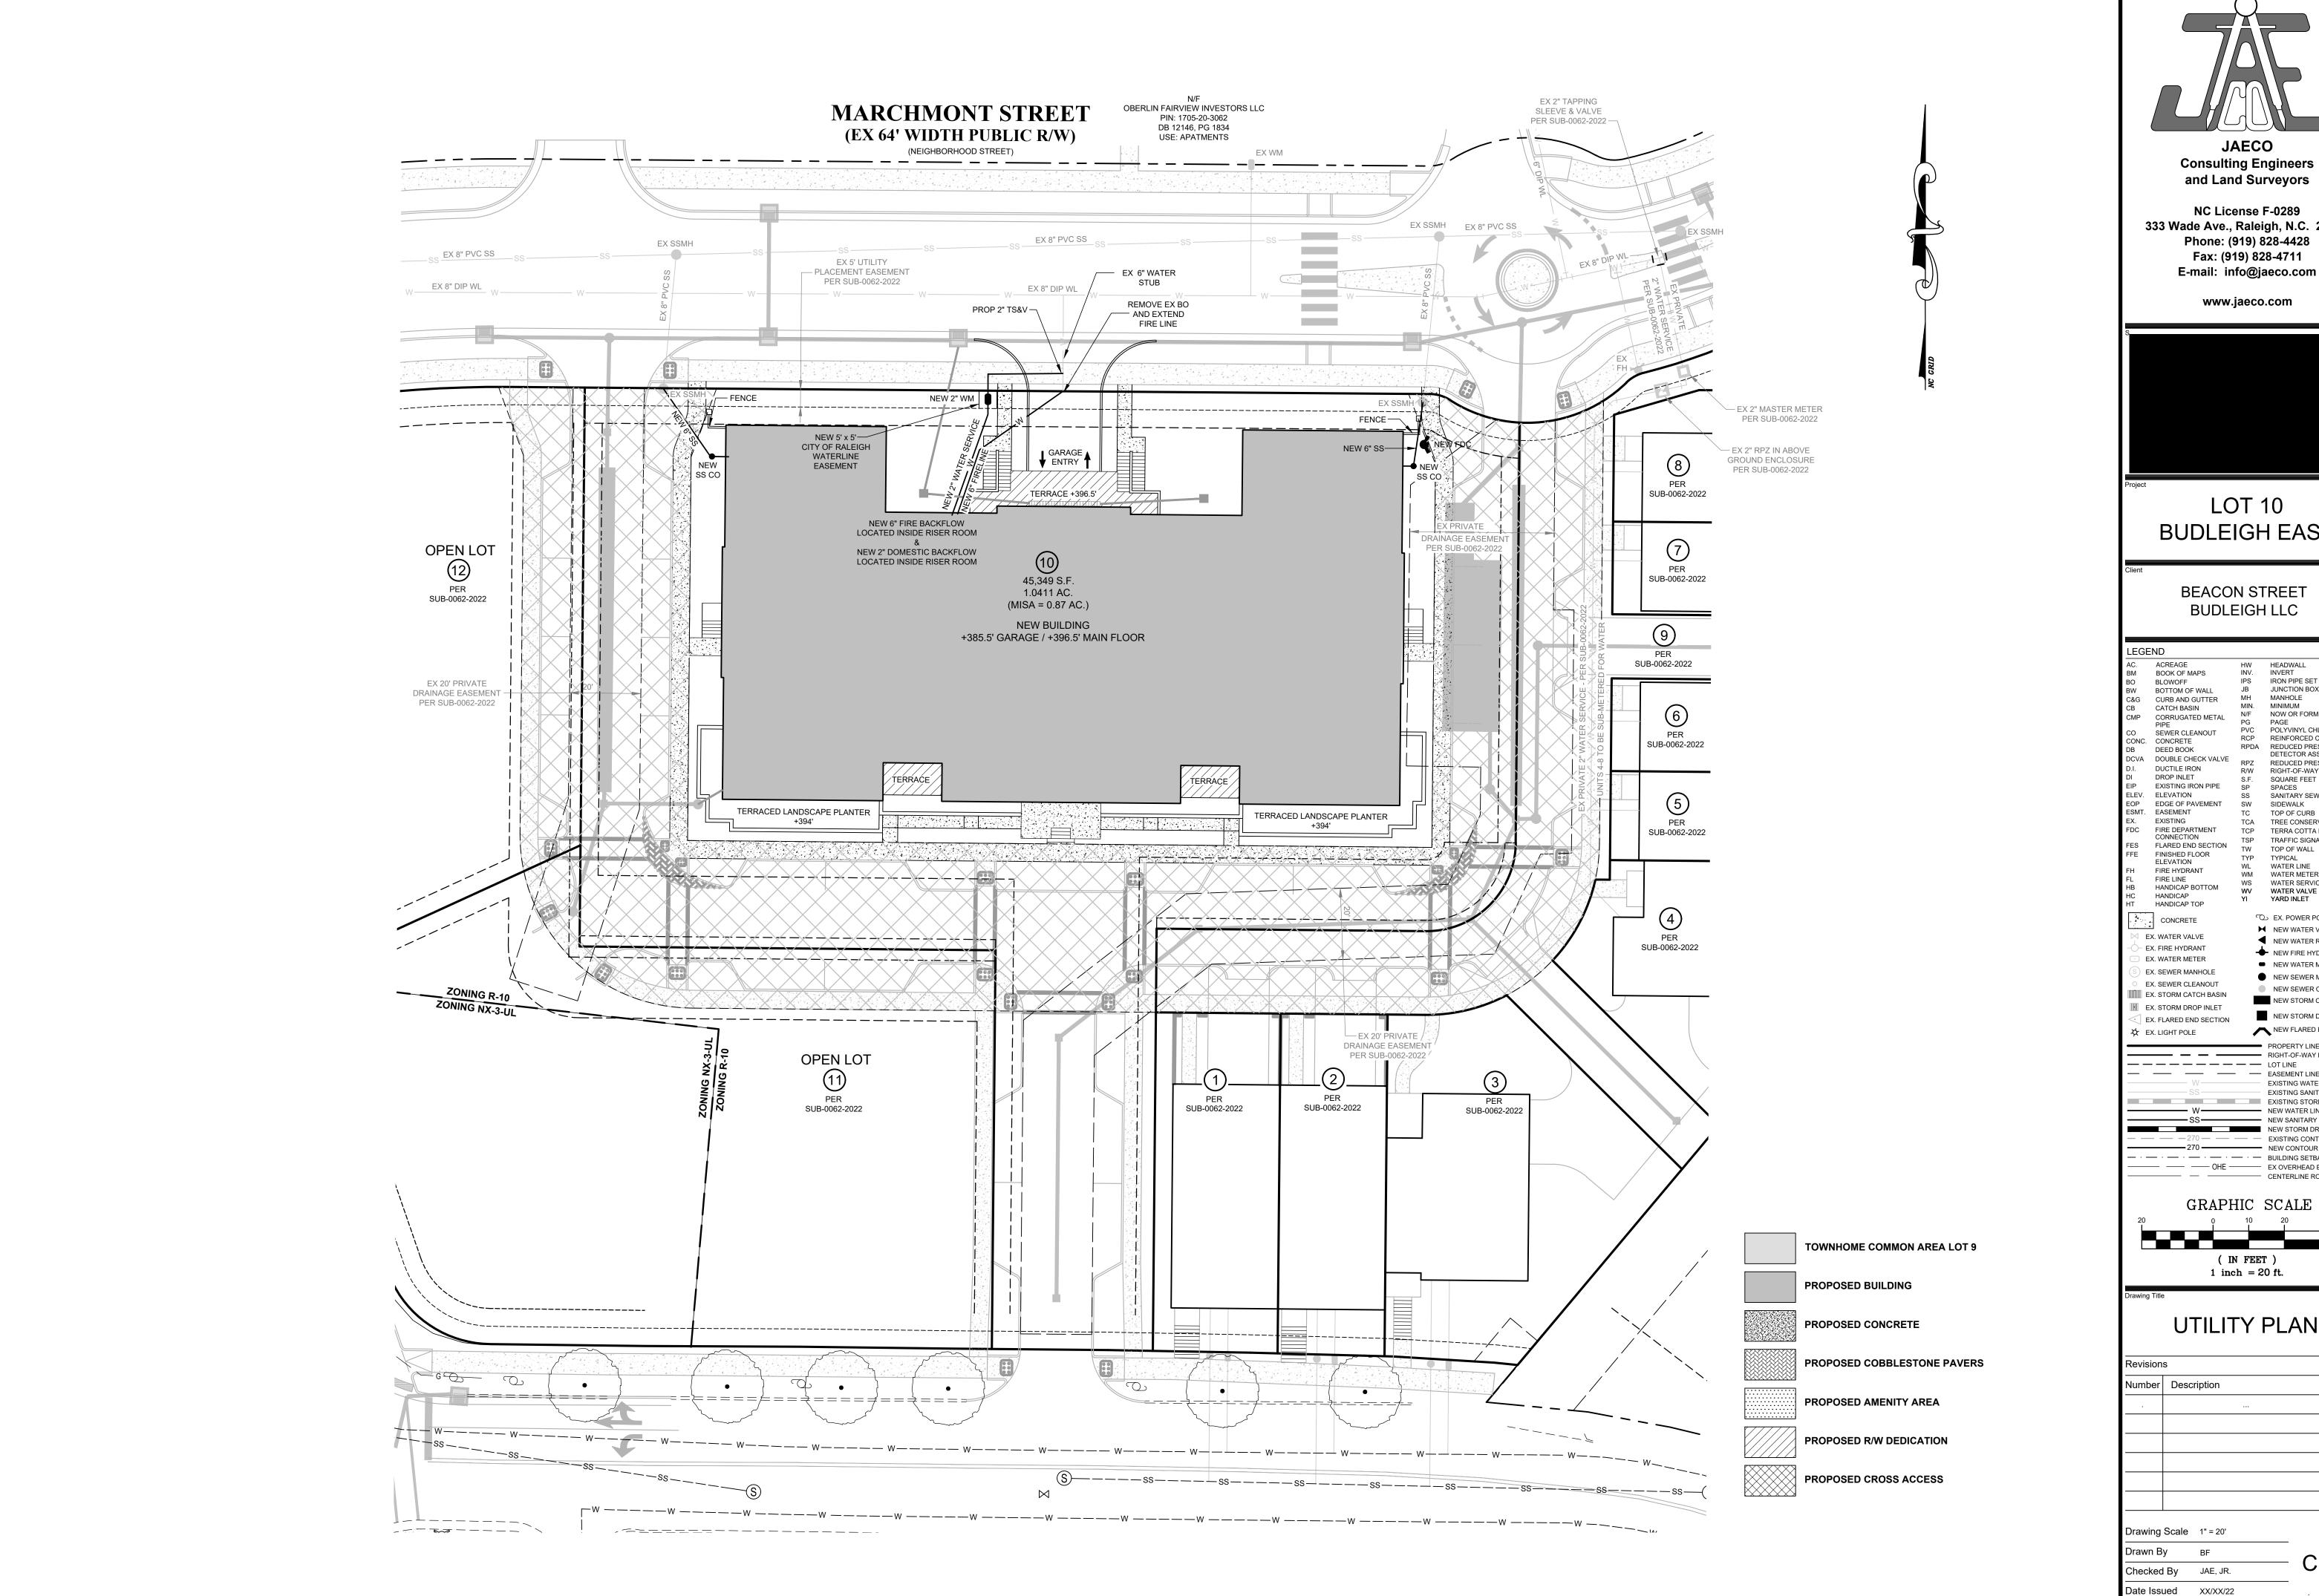
1 inch = 20 ft.


Date Issued XX/XX/22

CE-2



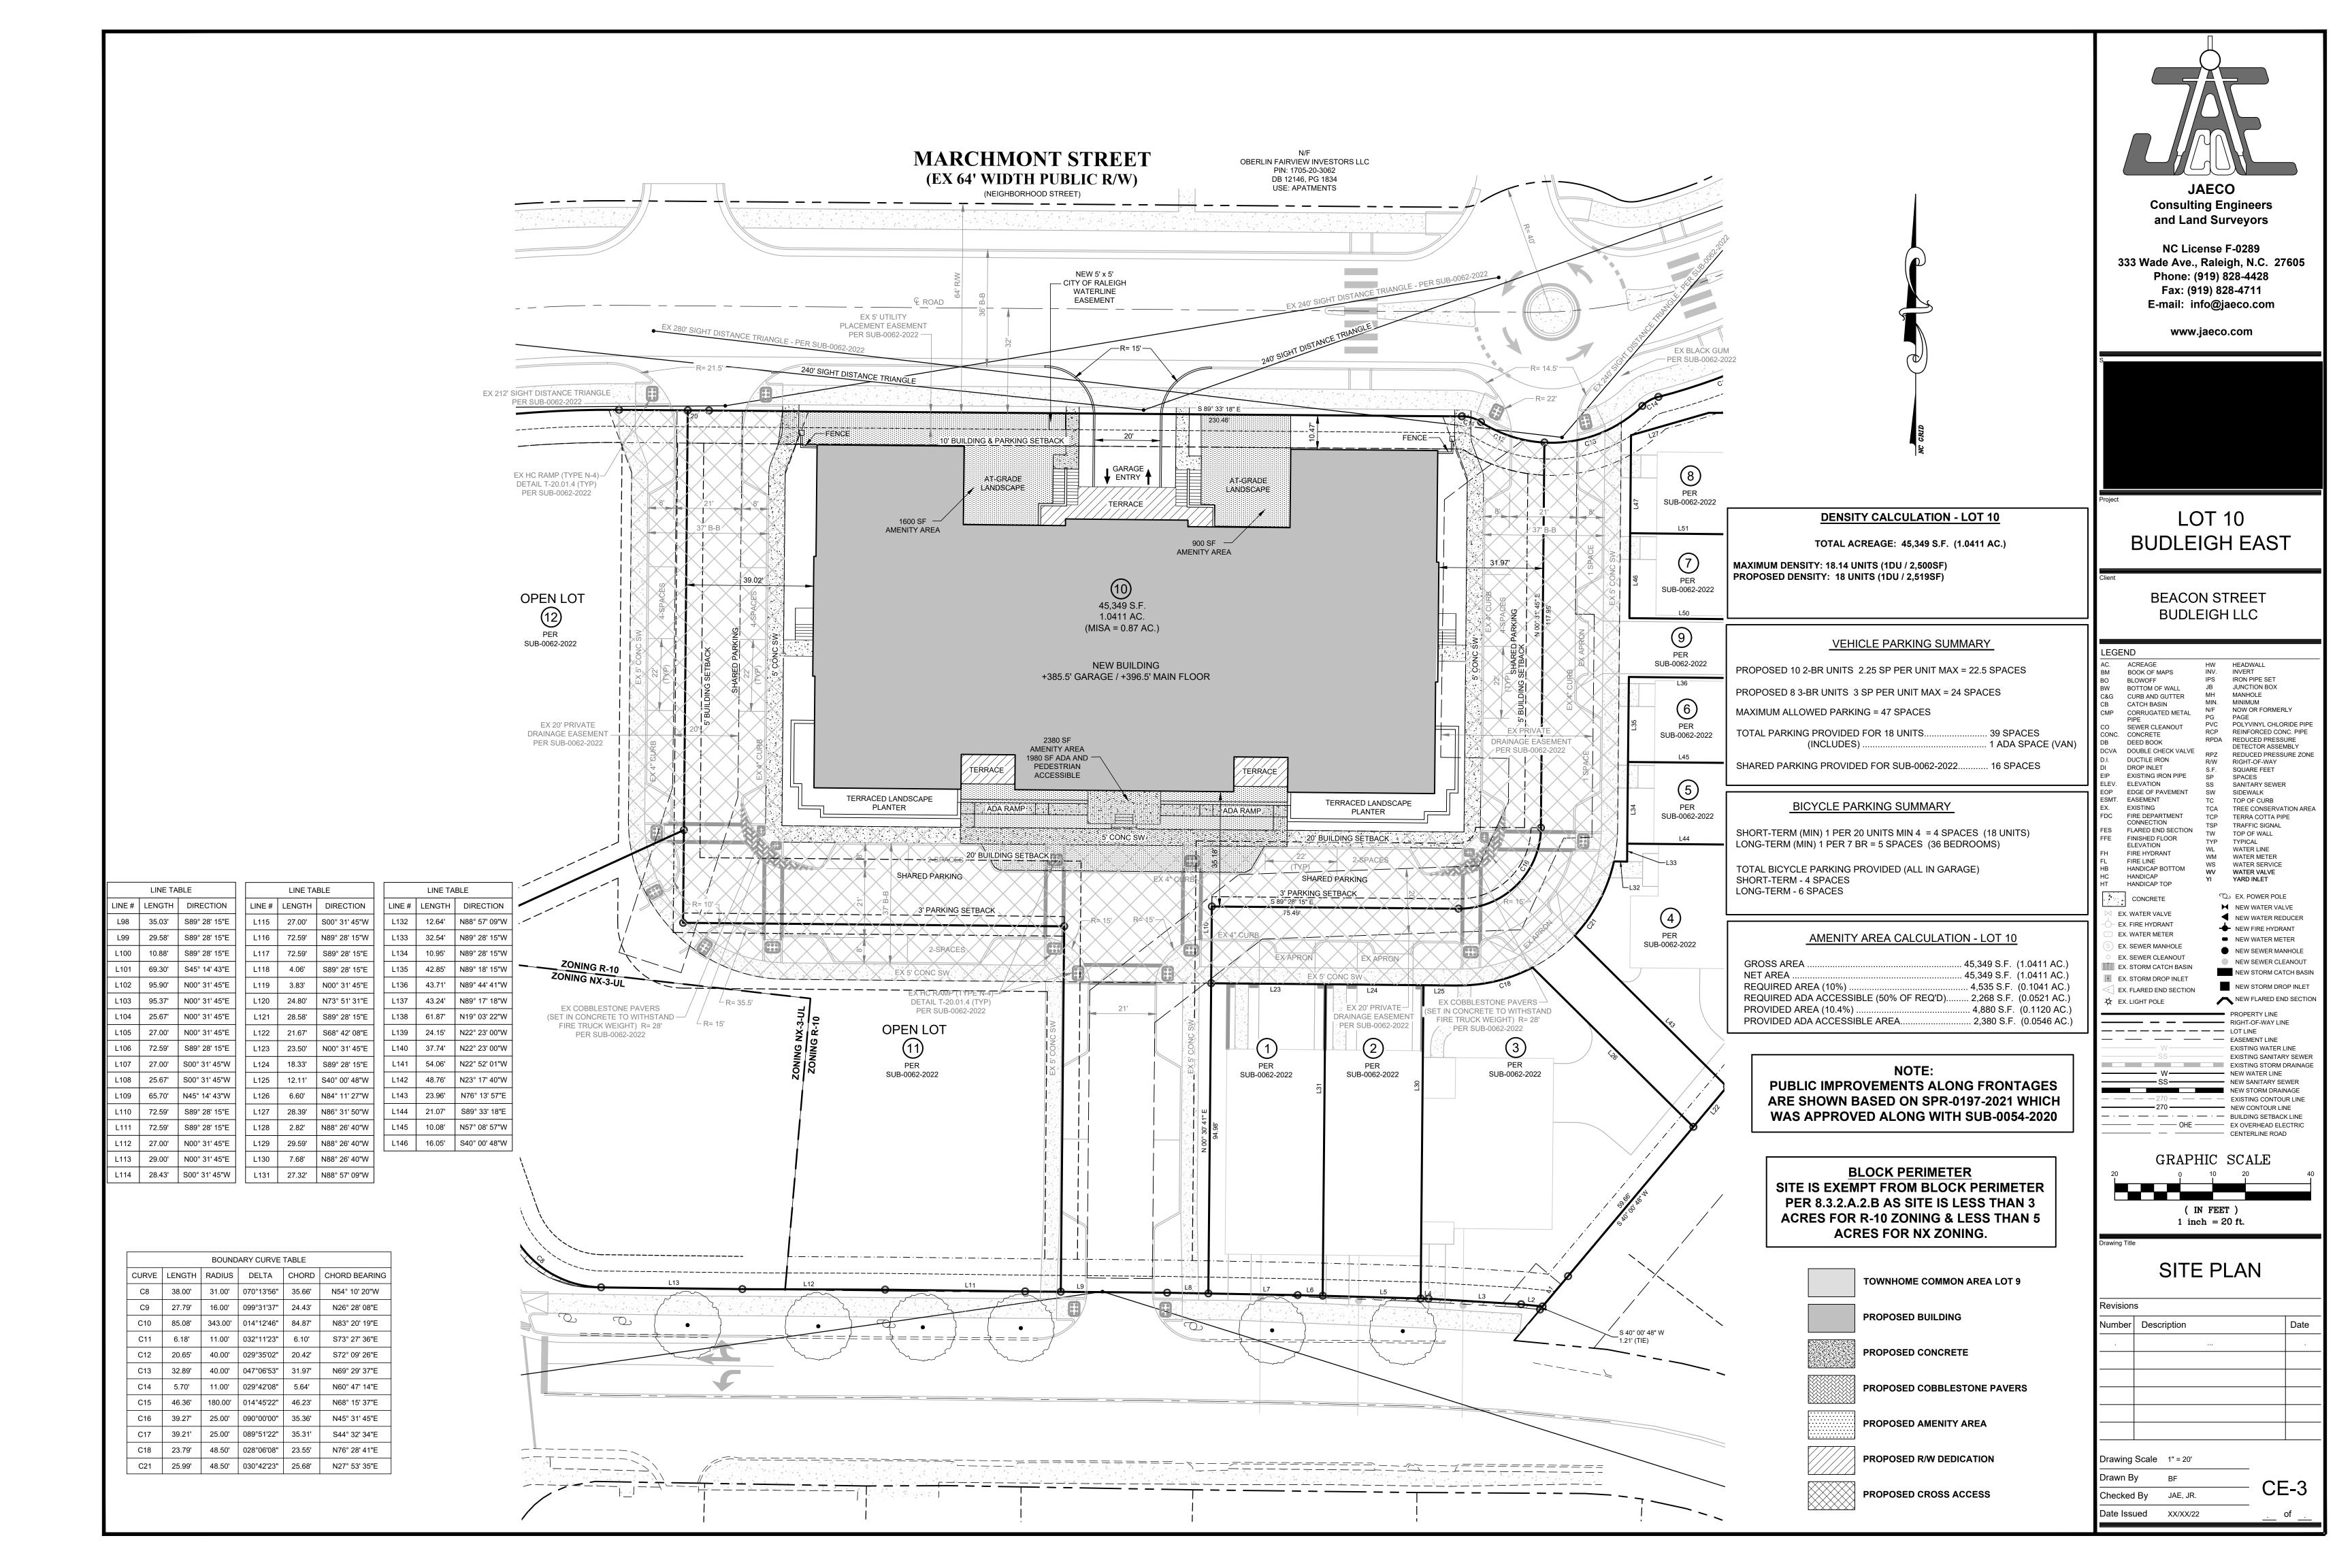

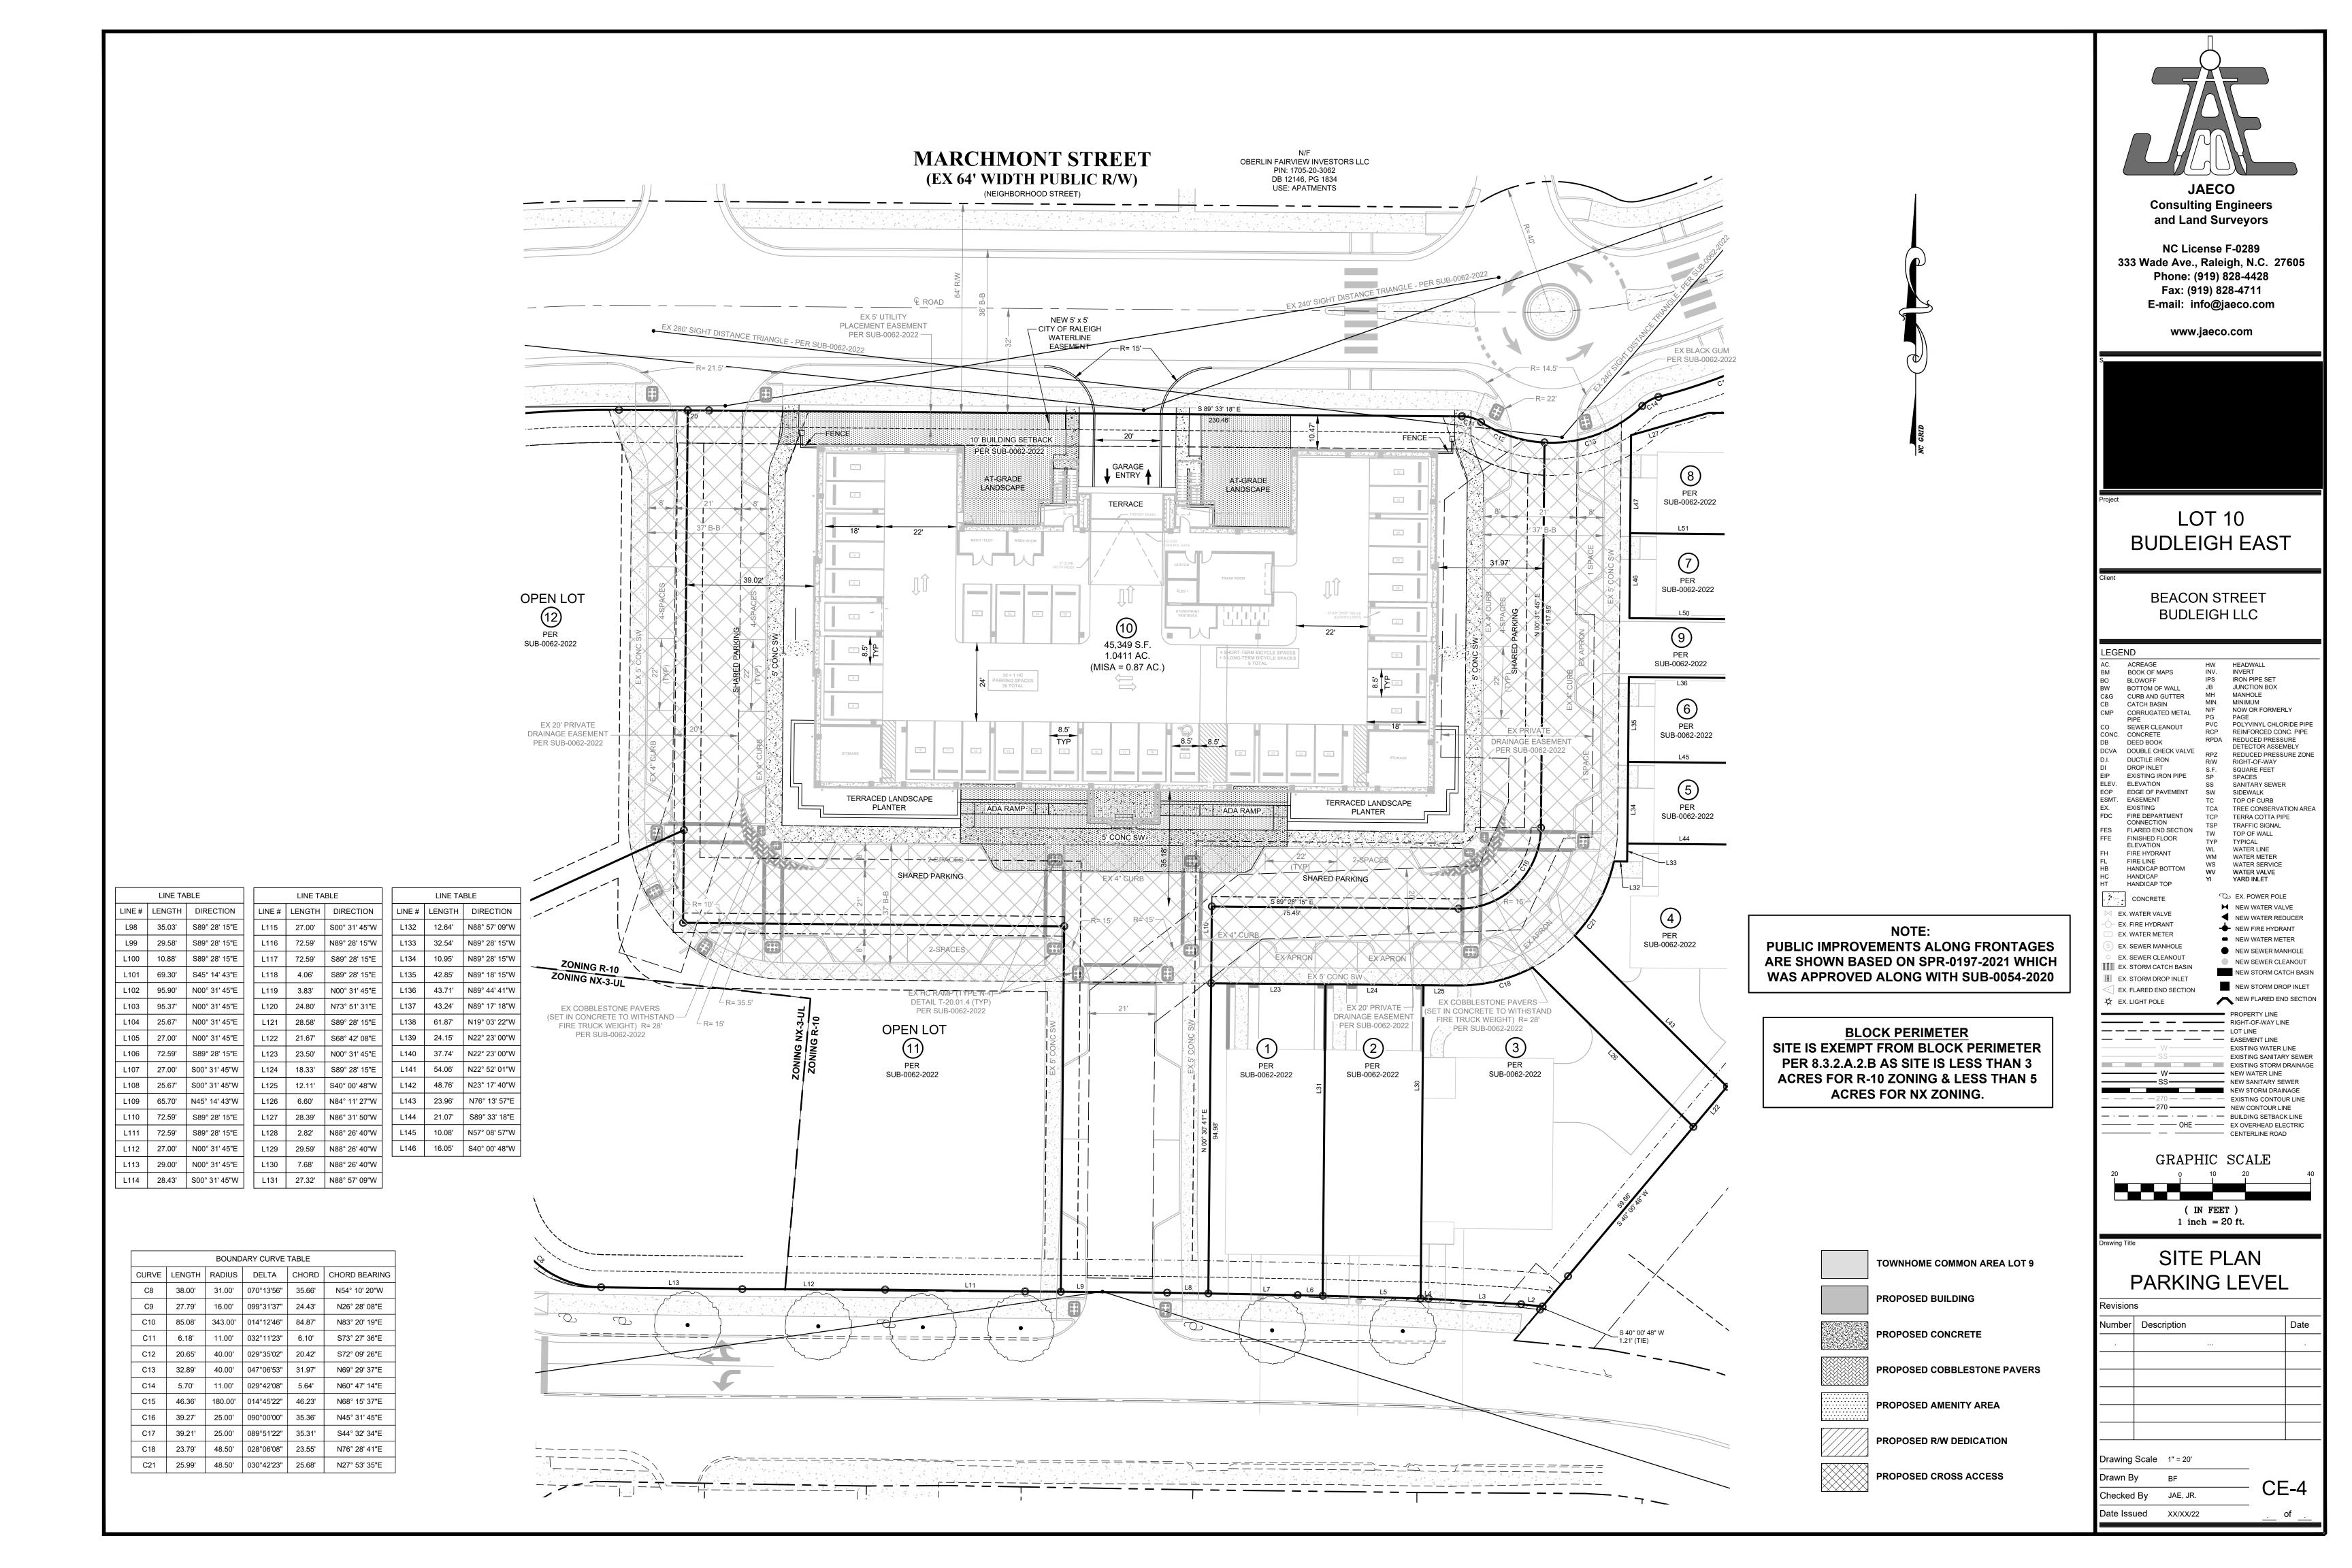

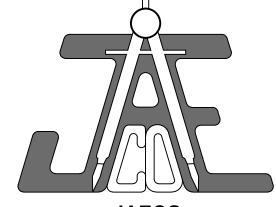

Consulting Engineers and Land Surveyors

NC License F-0289 333 Wade Ave., Raleigh, N.C. 27605 Phone: (919) 828-4428 Fax: (919) 828-4711



LOT 10 **BUDLEIGH EAST**

BEACON STREET BUDLEIGH LLC


LEGE	ND		
AC.	ACREAGE	HW	HEADWALL
BM	BOOK OF MAPS	INV.	INVERT
во	BLOWOFF	IPS	IRON PIPE SET
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C&G	CURB AND GUTTER	MH MIN.	MANHOLE MINIMUM
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СО	SEWER CLEANOUT	PVC	POLYVINYL CHLORIDE
CONC.	CONCRETE	RCP	REINFORCED CONC. PI
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ESMT.	EASEMENT	TC	TOP OF CURB
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FL	FIRE LINE	WM	WATER METER
HB	HANDICAP BOTTOM	WS	WATER SERVICE
HC	HANDICAP	WV YI	WATER VALVE YARD INLET
HT	HANDICAP TOP	11	TARD INLET
4,	CONCRETE		EX. POWER POLE
⋈ F	K. WATER VALVE	×	•
Τ.	K. FIRE HYDRANT	•	NEW WATER REBOOL
	K. WATER METER	-	► NEW FIRE HYDRANT
(S) EX	K. SEWER MANHOLE	-	NEW WATER METER
0 EX	K. SEWER CLEANOUT		
E>	K. STORM CATCH BASIN		
∭ E>	K. STORM DROP INLET		NEW STORM CATCH B.
< E>	K. FLARED END SECTION		NEW STORM DROP INL
₽ EX	K. LIGHT POLE		NEW FLARED END SEC
=		=	PROPERTY LINE RIGHT-OF-WAY LINE LOT LINE
			EASEMENT LINE EXISTING WATER LINE
	SS		EXISTING SANITARY SEV
			EXISTING STORM DRAIN
	—— W——		NEW WATER LINE
	ss		NEW SANITARY SEWER
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	270 ——		NEW CONTOUR LINE
	_ · · · · _		BUILDING SETBACK LINE
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	<u> </u>		CENTERLINE ROAD
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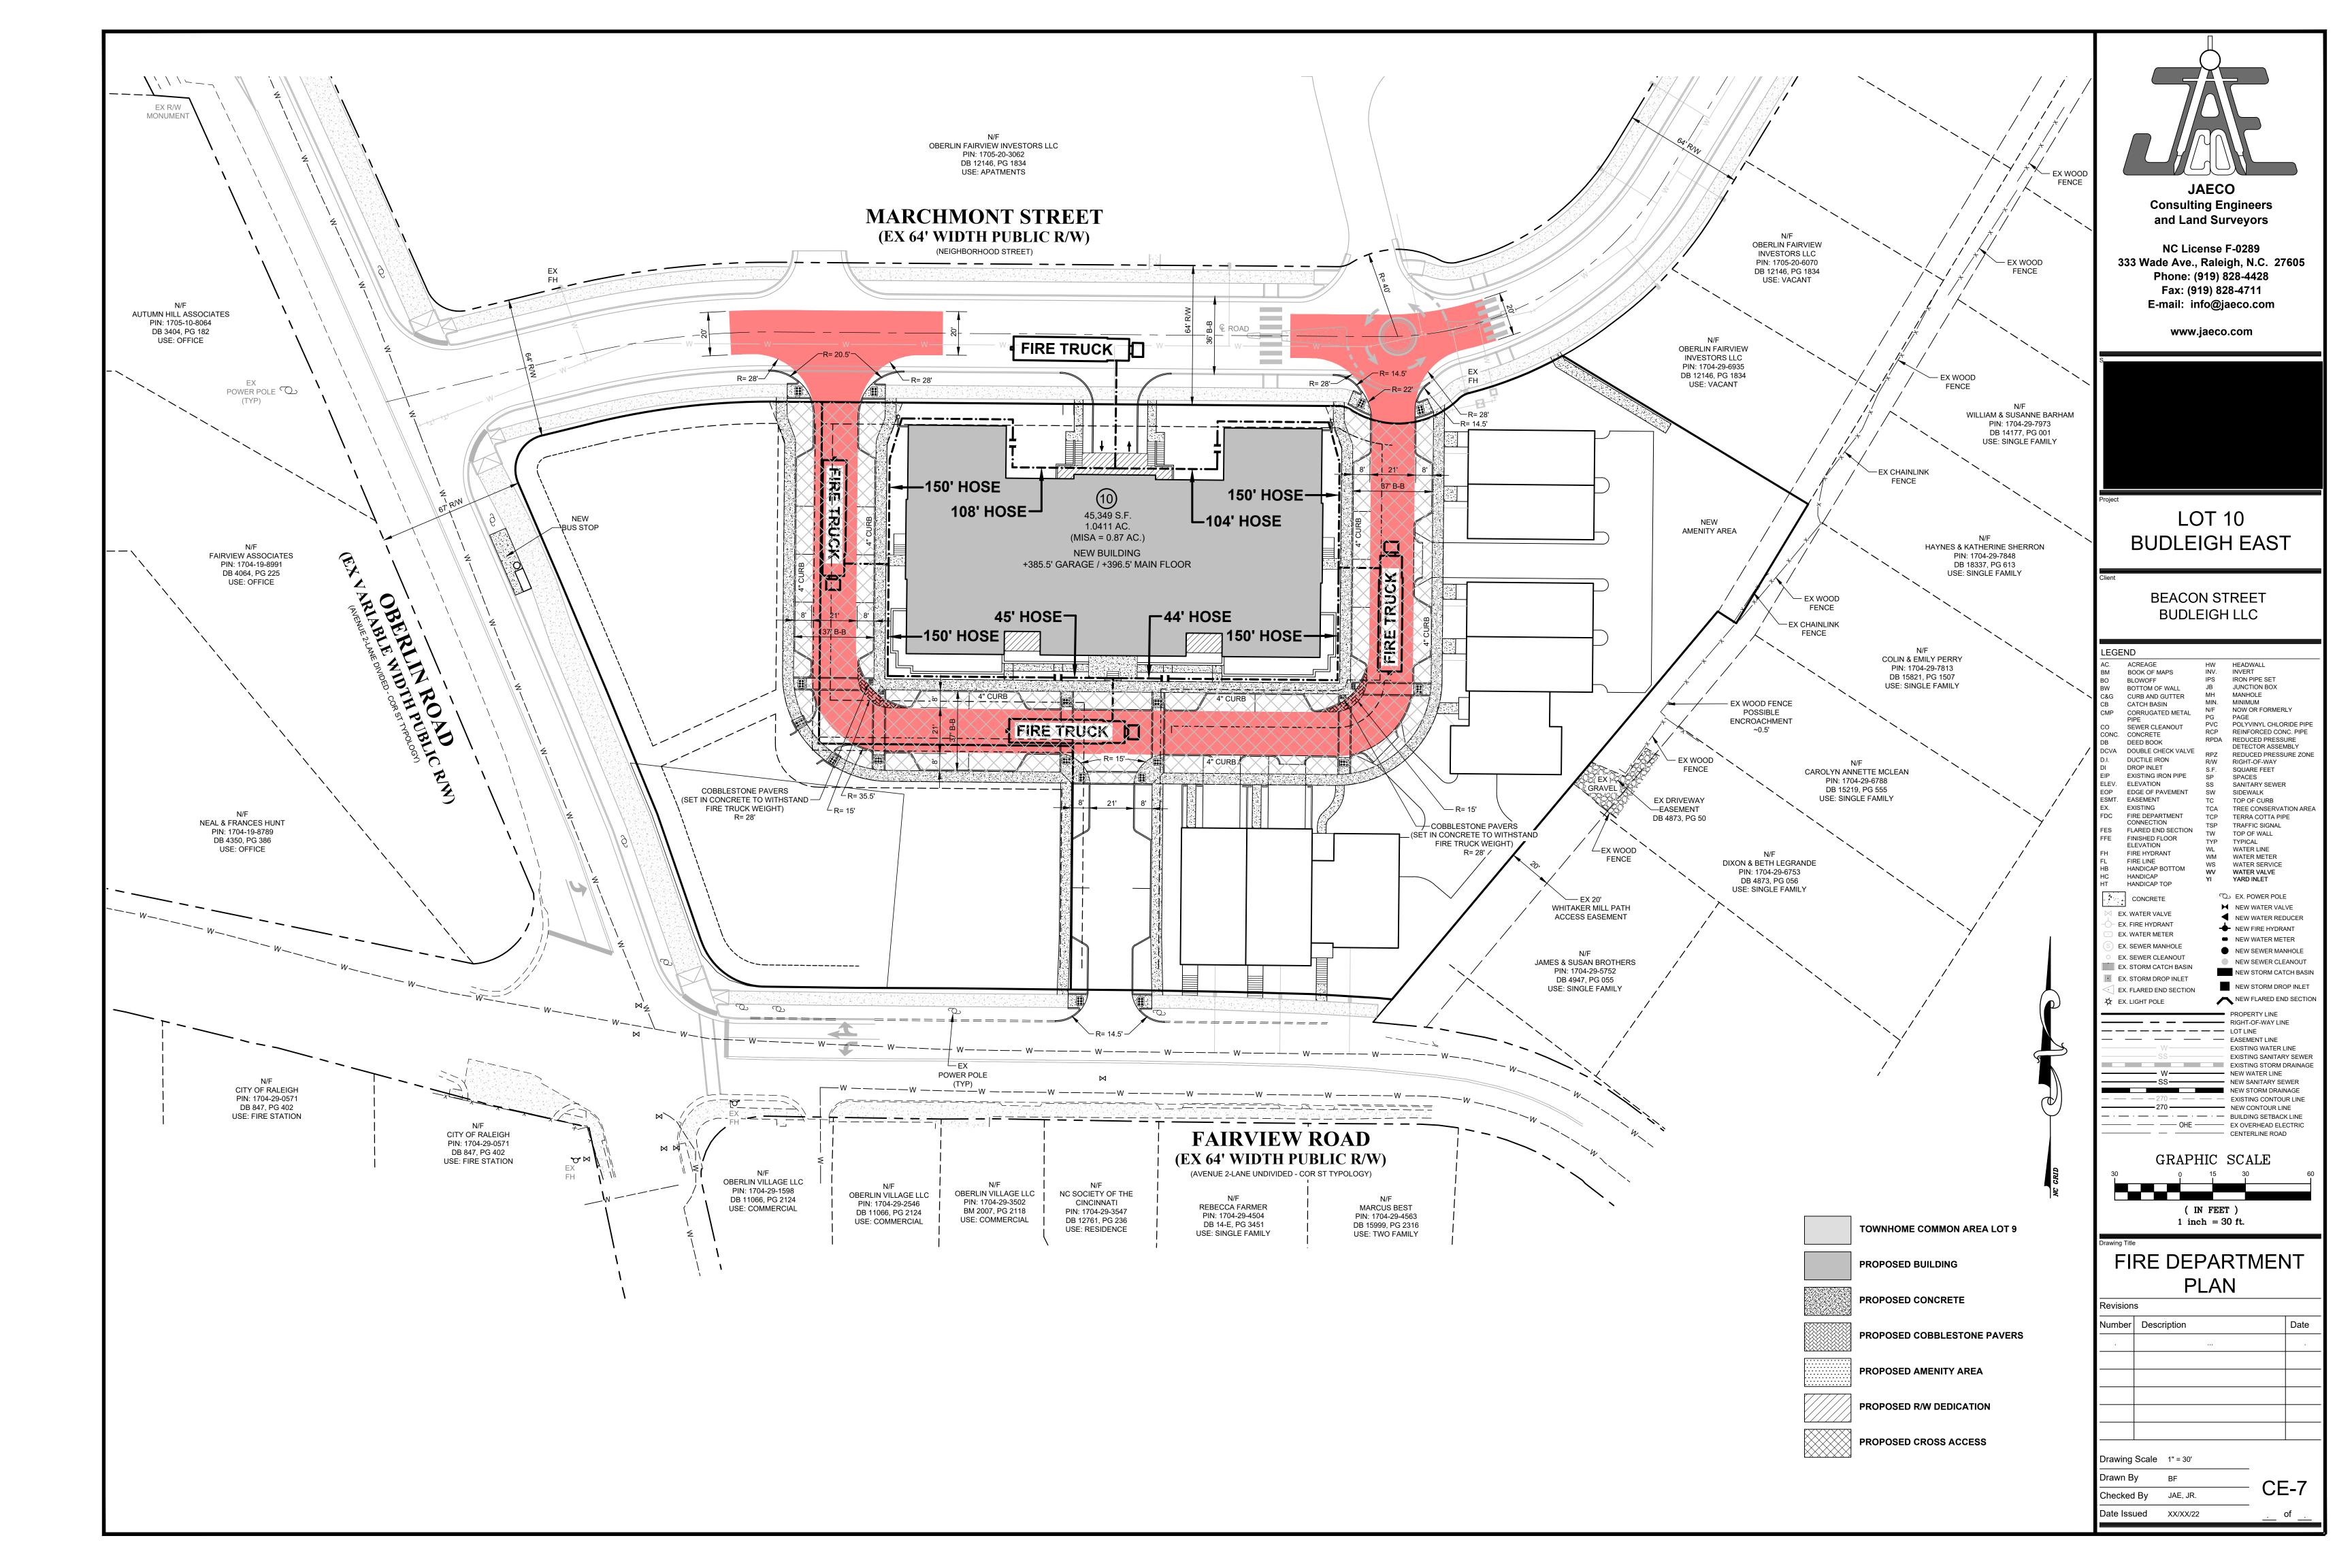
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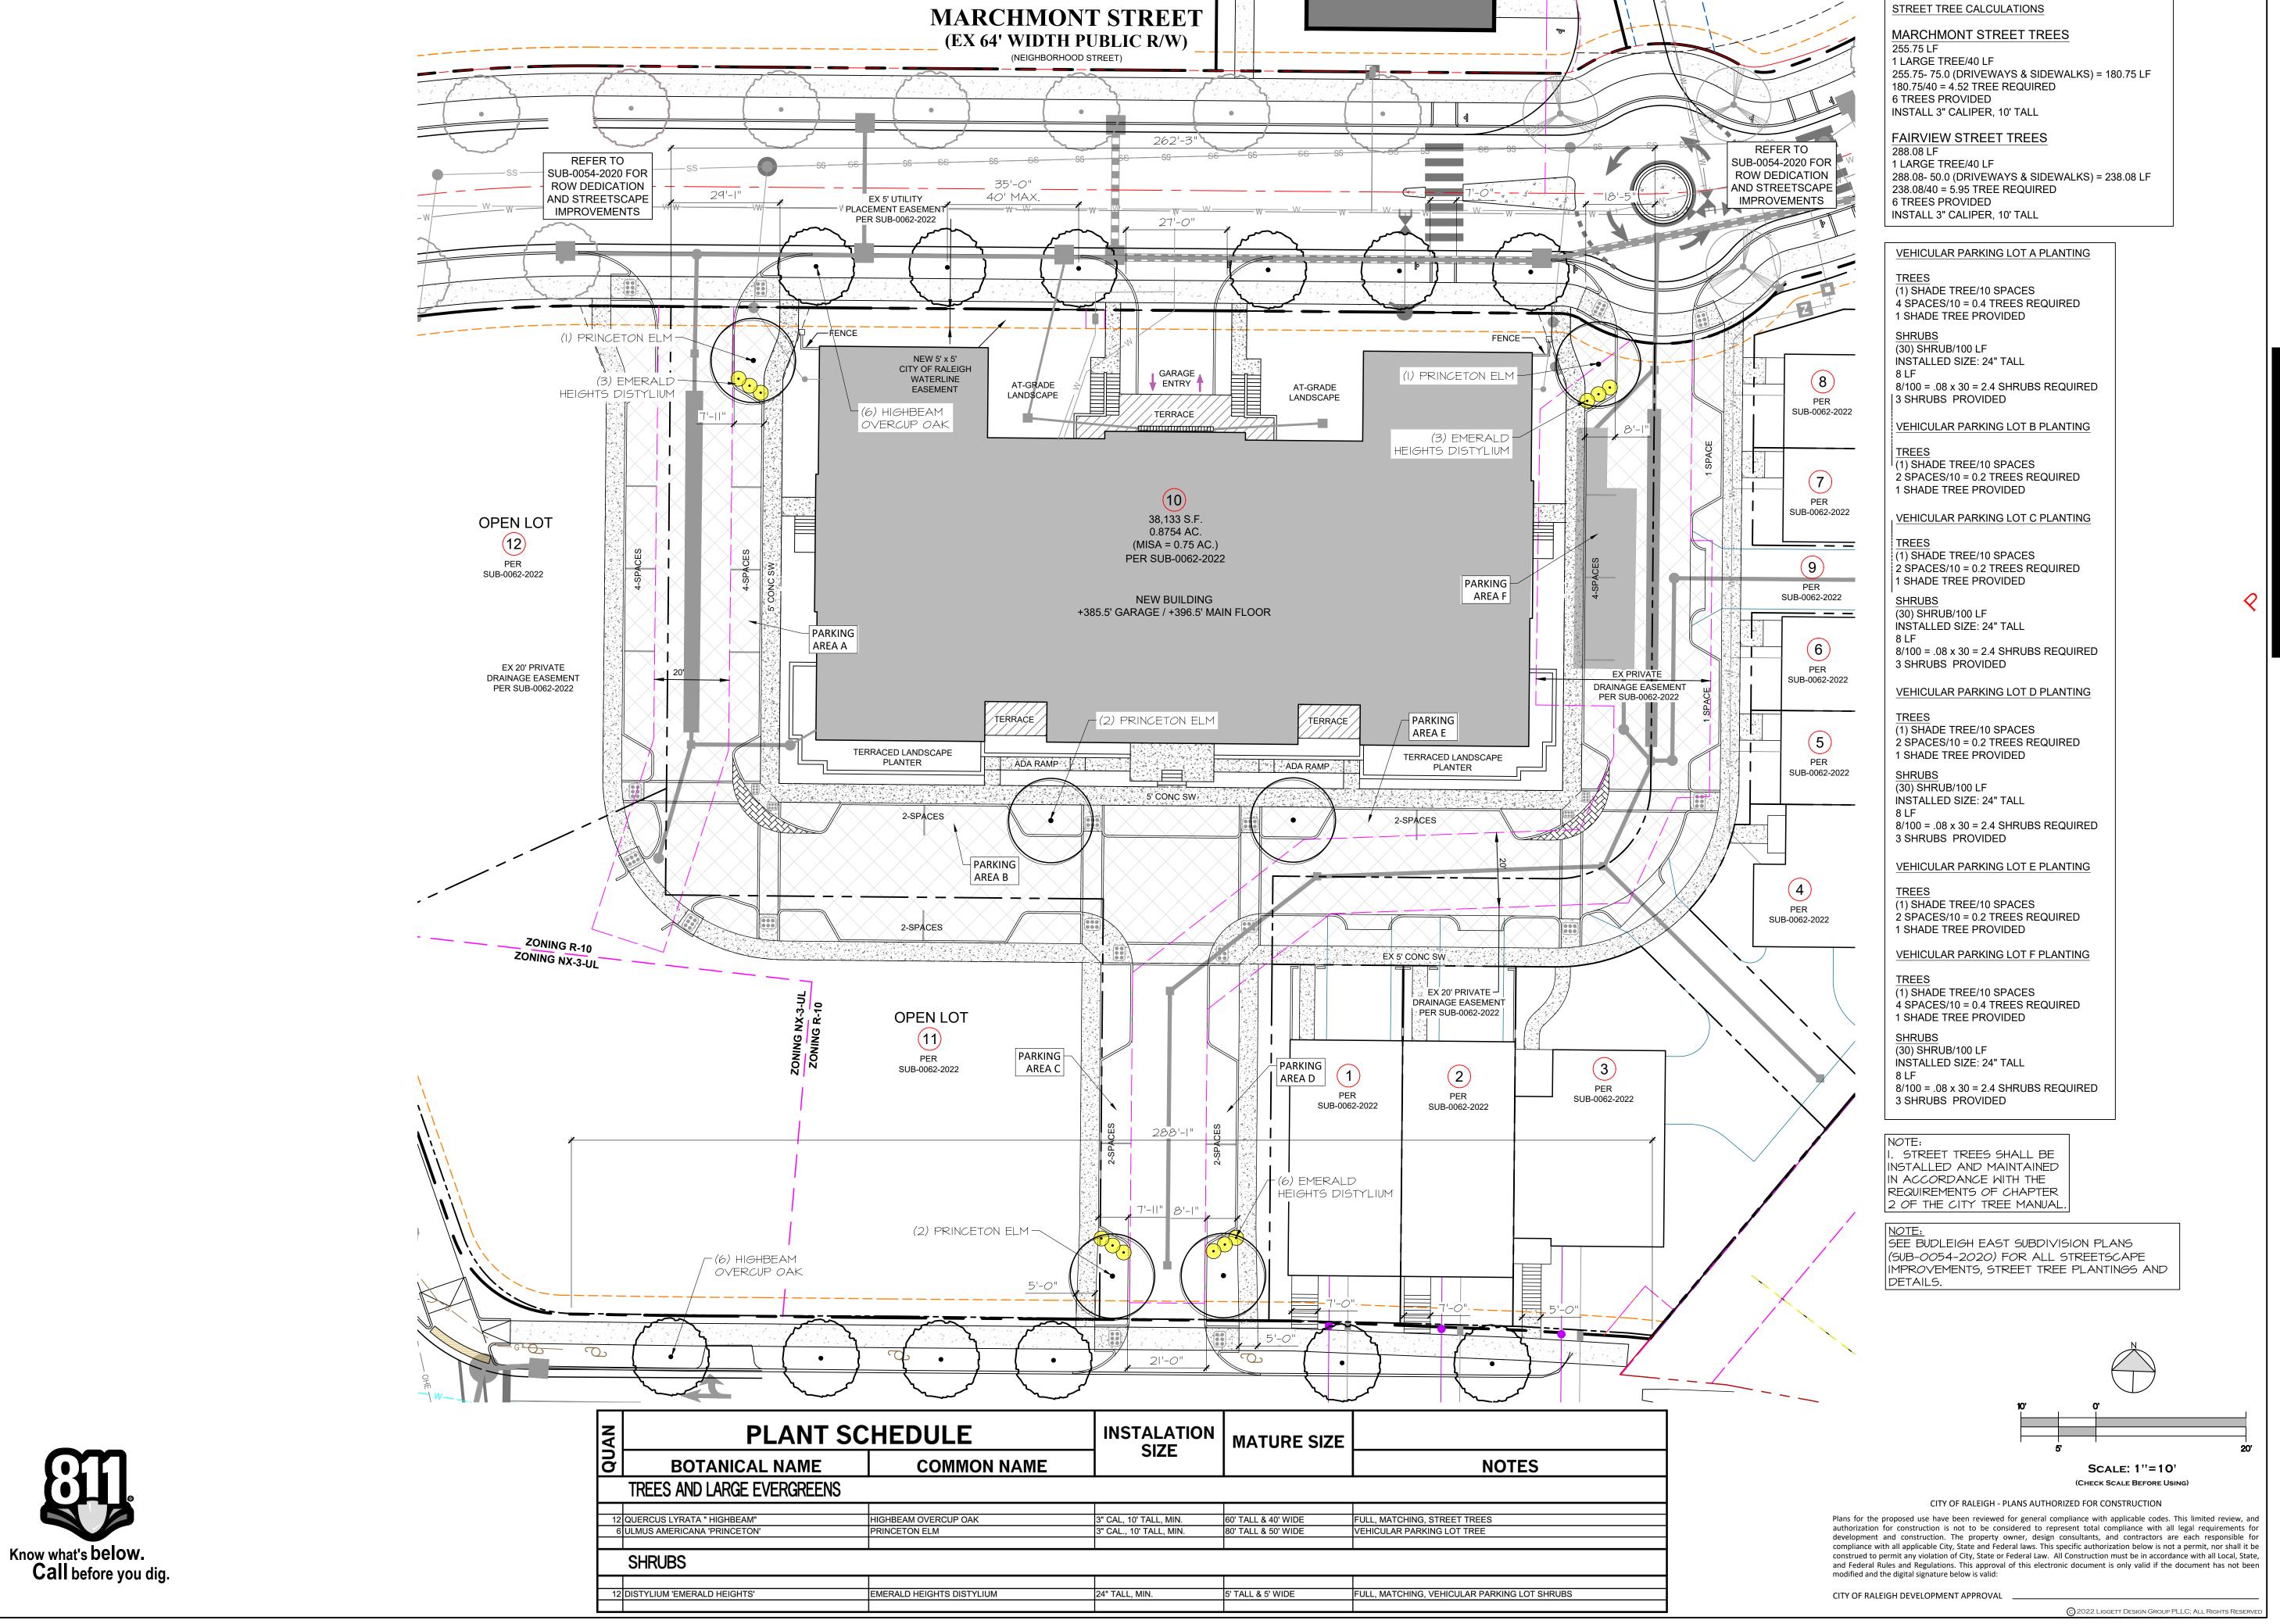
UTILITY PLAN

Revisions						
lumber	Descri	iption				Date
· · · · · · · · · · · · · · · · · · ·						
Orawing Scale 1" = 20'						
Drown By DE						

CE-5





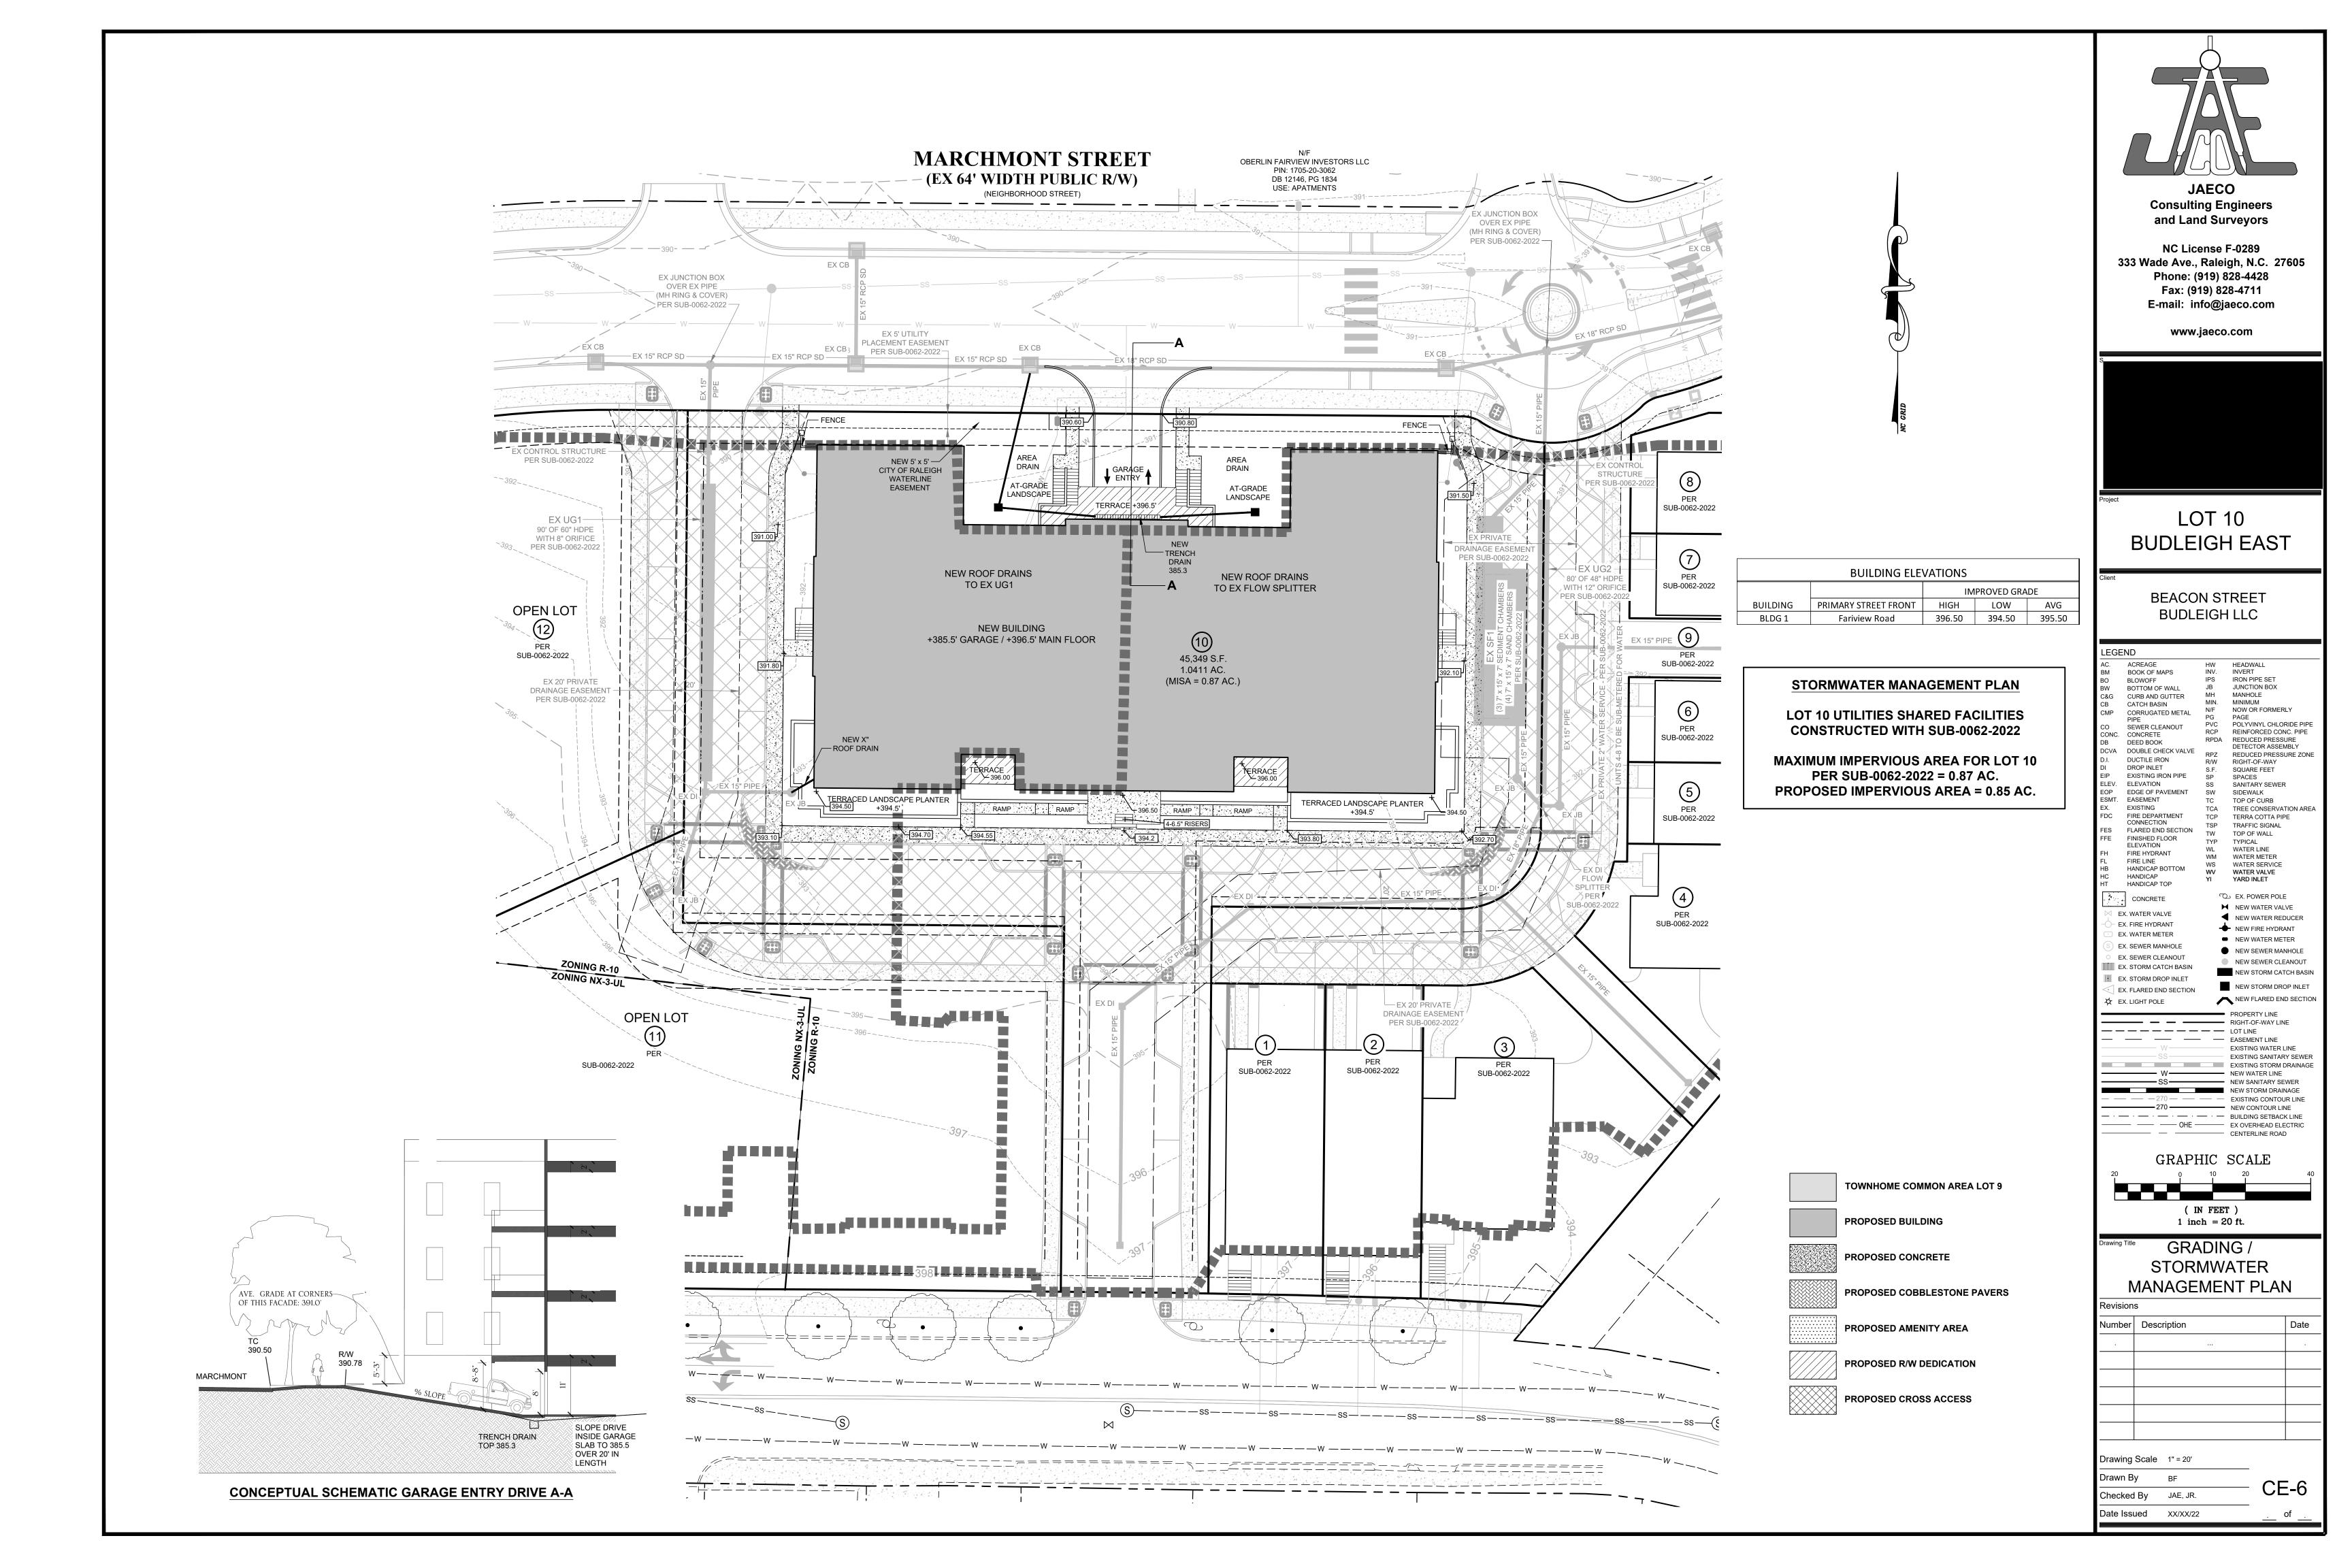



DESIGN GROUP


LANDSCAPE ARCHITECTURE

SITE PLANNING & DESIGN

725-A PERSHING ROAD RALEIGH, NC 27608 PHONE 919.833.0303 Fax 919.833.1116 MAIL@LIGGETTDESIGNGROUP.COM

CONSULTANTS

JOHN A. EDWARDS & CO 333 Wade Ave. - Raleigh, NC (919) 828-4428

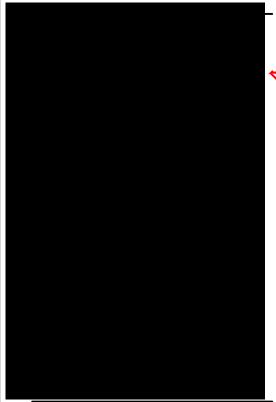

CLIENT

ISSUED FOR: REVIEW ISSUED DATE: 4/12/2023 REVISIONS:

DRAWING TITLE:

PLANTING PLAN

DRAWN BY: AS/RW/WAB CHECKED BY:

1''=10'

SHEET NUMBER:

OF 2

PLANTING NOTES

- 1. Prior to the start of any excavation for the project, the contractor shall notify NC One Call or equivalent to locate all existing utilities.
- 2. Contractor shall maintain or provide positive drainage away from all building foundations, structures and within planting beds.
- 3. Contractor shall supply all plant materials in quantities sufficient to complete all plantings shown on this drawing. Clarify any discrepancies with the Landscape Architect prior to ordering plant material.
- 4. All plants shall meet or exceed the minimum standards set by the U.S.D.A. for Nursery Stock, sponsored by the American Association of Nurserymen, Inc., Washington, D.C.
- 5. All plants shall bear the same relationship to finished grade as to the original grades before digging. The Contractor shall revise grades at a minimum of $\pm 1/2\%$ to ensure smooth transitions between planting beds and lawn areas.
- 6. Mulch install 3" of shredded pine bark mulch in plant beds around buildings, patio, etc., and 3" of clean pine straw in all other natural areas with new planting and on slopes, unless otherwise noted on plans.
- 7. All plant materials are subject to the approval of the Landscape Architect at the nursery and at the job site.
- 8. Contractor is encouraged to provide the Landscape Architect with concerns and/or suggestions regarding proposed plant materials, prior to placing a purchase order for plants.
- 9. Contractor is responsible for verifying all quantities. Drawings symbols shall rule over plant lists if there are discrepancies between the two.
- 10. All trees located adjacent to walks and drives shall have 6' of clearance height to first branching.
- 11. All trees shall be placed a minimum of 3' from sidewalks, curbs and hardscape, and a minimum of 6' from fire hydrants and other utilities, unless otherwise noted on plans.
- 12. All plants shall be installed as per generally accepted planting standards.
- 13. All dead and or diseased plants shall be replaced within warranty period at no charge to Owner/Client.
- 14. All plants and stakes shall be set plumb unless otherwise specified.
- 15. Refer to Existing Conditions Plan, Demo Plan and/or Planting Plan for trees/shrubs to be either removed or to remain undisturbed.
- 16. Landscape Architect shall select and layout all the perennial beds.
- 17. All planting bed edges to be smooth flowing arcs, unless otherwise specified. Bed edges shall be smooth, consistent, hand trenched 3 to 4 inches deep, and "V" shaped. All excavated material shall be removed from the bed edge and planting bed.
- 18. If the landscape contractor observes any deficiencies in the site conditions or which could negatively affect plant establishment, survival, or guarantee, notify the Owner and Landscape Architect prior to procurement and/or installation.
- 19. Any disturbed areas that are not planted or grassed as part of the landscape plan shall be restored to their previous existing condition (including raking uneven areas, seeding grassed areas and for natural areas spreading minimum 3" depth of pine straw, leaf litter or pine bark mulch per direction of Landscape Architect).

LANDSCAPE MAINTENANCE AGREEMENT

during the months of February and March.

- "The Owners of the Property and their Agents, Heirs or Assigns shall be responsible for the installation, preservation and maintenance of all plantings and physical features shown on this plan. The Owners shall be responsible for annual maintenance of the vegetation to include but not limited to":
- 1. a. Fertilization: Zeon Zoysia lawns: Fertilize lawns twice per year (March 30 May 15), and again (June 30 July 31) according to soil test. Ttifway 419 Bermuda lawns: fertilize lawns twice per year (March 30 May 15), and again (June 15 August 15) according to soil test.
- 1. b. Fertilization: Deciduous trees, evergreen trees and evergreen shrubs: Fertilize trees and shrubs per soil test. A deep root fertilizer shall be used for deciduous trees, evergreen trees and evergreen shrubs and applied once per year (Feb. 28 March 30). Fertilizer shall be watered in.
- 1. c. Fertilization: Shrubs, groundcover and seasonal plants not listed in a (2):Fertilize shrubs, groundcover and seasonal plants per soil test. A complete controlled release fertilizer shall be used for shrubs, groundcover and seasonal plants and applied (Feb. 28 March 30), and again in (June 15 July 31). Fertilizer shall be spread evenly under all plants (where applicable) and watered in. **(Planting areas with trees, shrubs, groundcover and seasonal plants

may receive fertilization 2x/year due to the planting "arrangement", however, over-fertilization shall not be acceptable.

- 2. Pruning: Removal of dead or diseased wood, or removal of tree branches for sight distance/safety reasons; the Shigo standards should be adhered to. The pruning of shrubs shall be limited to the pruning necessary to maintain the natural shape of the plant except for sheared hedges and sheared upright evergreen trees.
- 3. Pest control: Pre-emergent weed control for lawns to be applied in Sept. November. Tree, shrub and groundcover bed pre-emergent control to be applied in February. Chemical treatment for insect infestation and disease may be applied and shall be specific to the problem.
- 4. Mulching: Mulching shall be maintained at a depth of 2 3" in plant beds and tree saucers. As a minimum, mulch shall be reapplied at least every year
- 5. Mowing: Zoysia lawns shall be maintained at a height of 2" 2¼" and shall be mowed approximately 60 times per year. Tifway 419 Bermuda lawns shall be maintained at a height of 2" 2¼" and shall be mowed approximately 72 times per year. Grasses used for stabilization and ornamental use shall not be
- 6. Plant protection: Avoid excess intrusion into the root zone area of established plantings including equipment, vehicular and pedestrian traffic, construction activities and materials.
- 7. Watering: If an irrigation system is utilized, the system shall be regulated to provide approximately 1" of rainfall per week during the growing season.
- 8. Warranty: Remove/replace all dead and or diseased plant material at each maintenance visit.


PREPARATION AND INSTALLATION FOR PLANTING SOD AREAS


- 1. Provide soil ph testing, adjust the ph range of soils that are unacceptable per local cooperative extension service standards. Incorporate agricultural lime, fertilizer, and superphosphate uniformly at the rate specified per soil ph testing results.
- 2. Site to be fine graded before permanent planting and seeding or sodding is installed.

the NEWLY SOD areas until the grass reaches a height of 4 inches tall.

- 3. Soil shall be loosened to a depth of 4 -6 inches by disking, raking, roto-tilling or other acceptable means. Continue tillage until a well-pulverized, firm, reasonably uniform seedbed is prepared 4 to 6 inches deep. Chisel compacted areas and spread topsoil 3 inches deep over adverse soil conditions.
- 4. Rake and remove all loose rock (over 1" diameter), roots, and other obstructions leaving surface reasonably smooth. Contractor shall incorporate/till-in 50/50 soil amendment in all plant beds.
- 5. All sod and installation techniques shall adhere to turfgrass producers international guideline specifications, current edition.
- 6. Sod areas to be sodded with workable size rolls that are not broken or stretched. Sod shall be free of thatch. Sod shall be installed within 24 hours of arrival at the site.
- 7. Water 1 inch minimum within the first hour of sod or seed installation. Begin irrigation system during the following 3 days keeping the sodded or seeded area moist.
- 8. Sod shall be laid parallel to the contours and shall have staggered joints on slopes greater than 3:1 or in drainage swales sod shall be
- staked.

 9. Apply starter fertilizer at time of sodding at rate recommended by manufacturer. Contractor is responsible for the initial watering.
- 10. Inspect all sodded areas and make necessary repairs or resod within the planting season, if possible. If grass stand should be over 60% damaged, Contractor shall consult with a conservation inspector on maintenance treatment and fertilization to determine the best type
- of treatment necessary in order to establish and maintain an acceptable stand of grass.
- 11. Contractor shall water and maintain all planting and NEWLY SOD areas until a maintenance contractor has been selected.12. Once an acceptable stand of grass has been established (of 95% or better), the Contractor shall repair all damaged areas and monitor

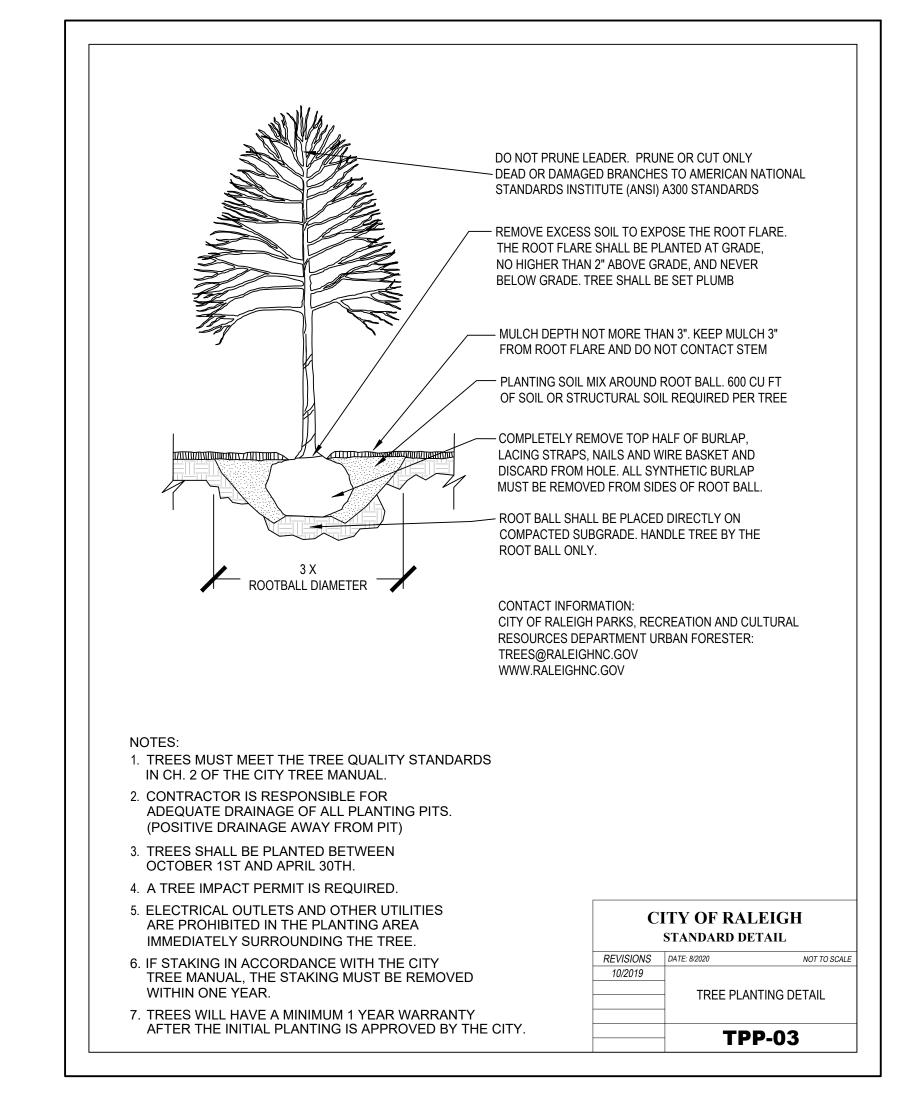

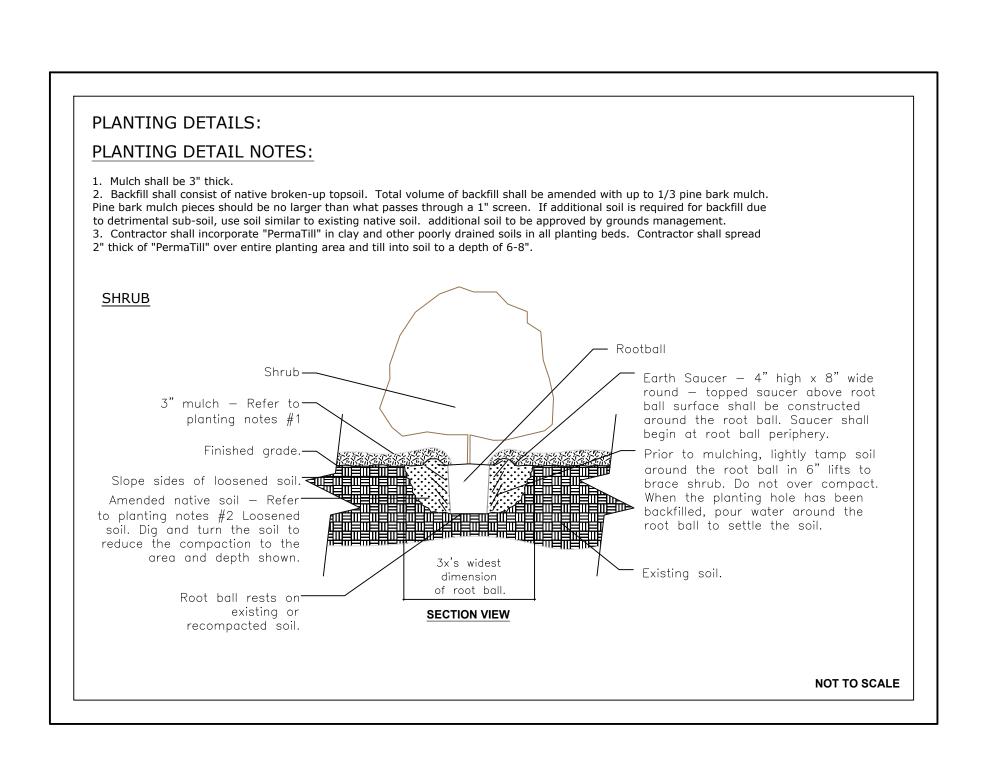




LANDSCAPE ARCHITECTURE SITE PLANNING & DESIGN

MAIL@LIGGETTDESIGNGROUP.COM

725-A PERSHING ROAD RALEIGH, NC 27608 PHONE 919.833.0303 FAX 919.833.1116

CONSULTANTS

JOHN A. EDWARDS & CO 333 Wade Ave. - Raleigh, NC (919) 828-4428

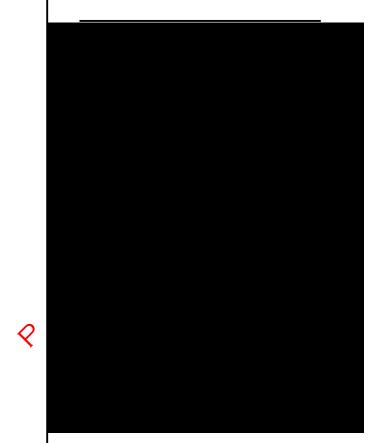

DLEIGH EAST ACON STREET BUDLIEGH, LLC O OBERLIN ROAD - RALEIGH, NC

REVIEW					
_					

DRAWING TITLE:

PLANTING NOTES & DETAILS

DRAWN BY: AS/RW/WAB
CHECKED BY:

1''=10'

SHEET NUMBER:

OF 2


CITY OF RALEIGH - PLANS AUTHORIZED FOR CONSTRUCTION

Plans for the proposed use have been reviewed for general compliance with applicable codes. This limited review, and authorization for construction is not to be considered to represent total compliance with all legal requirements for development and construction. The property owner, design consultants, and contractors are each responsible for compliance with all applicable City, State and Federal laws. This specific authorization below is not a permit, nor shall it be construed to permit any violation of City, State or Federal Law. All Construction must be in accordance with all Local, State, and Federal Rules and Regulations. This approval of this electronic document is only valid if the document has not been modified and the digital signature below is valid:

CITY OF RALEIGH DEVELOPMENT APPROVAL

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A201

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414 Bill Kennedy Way SE

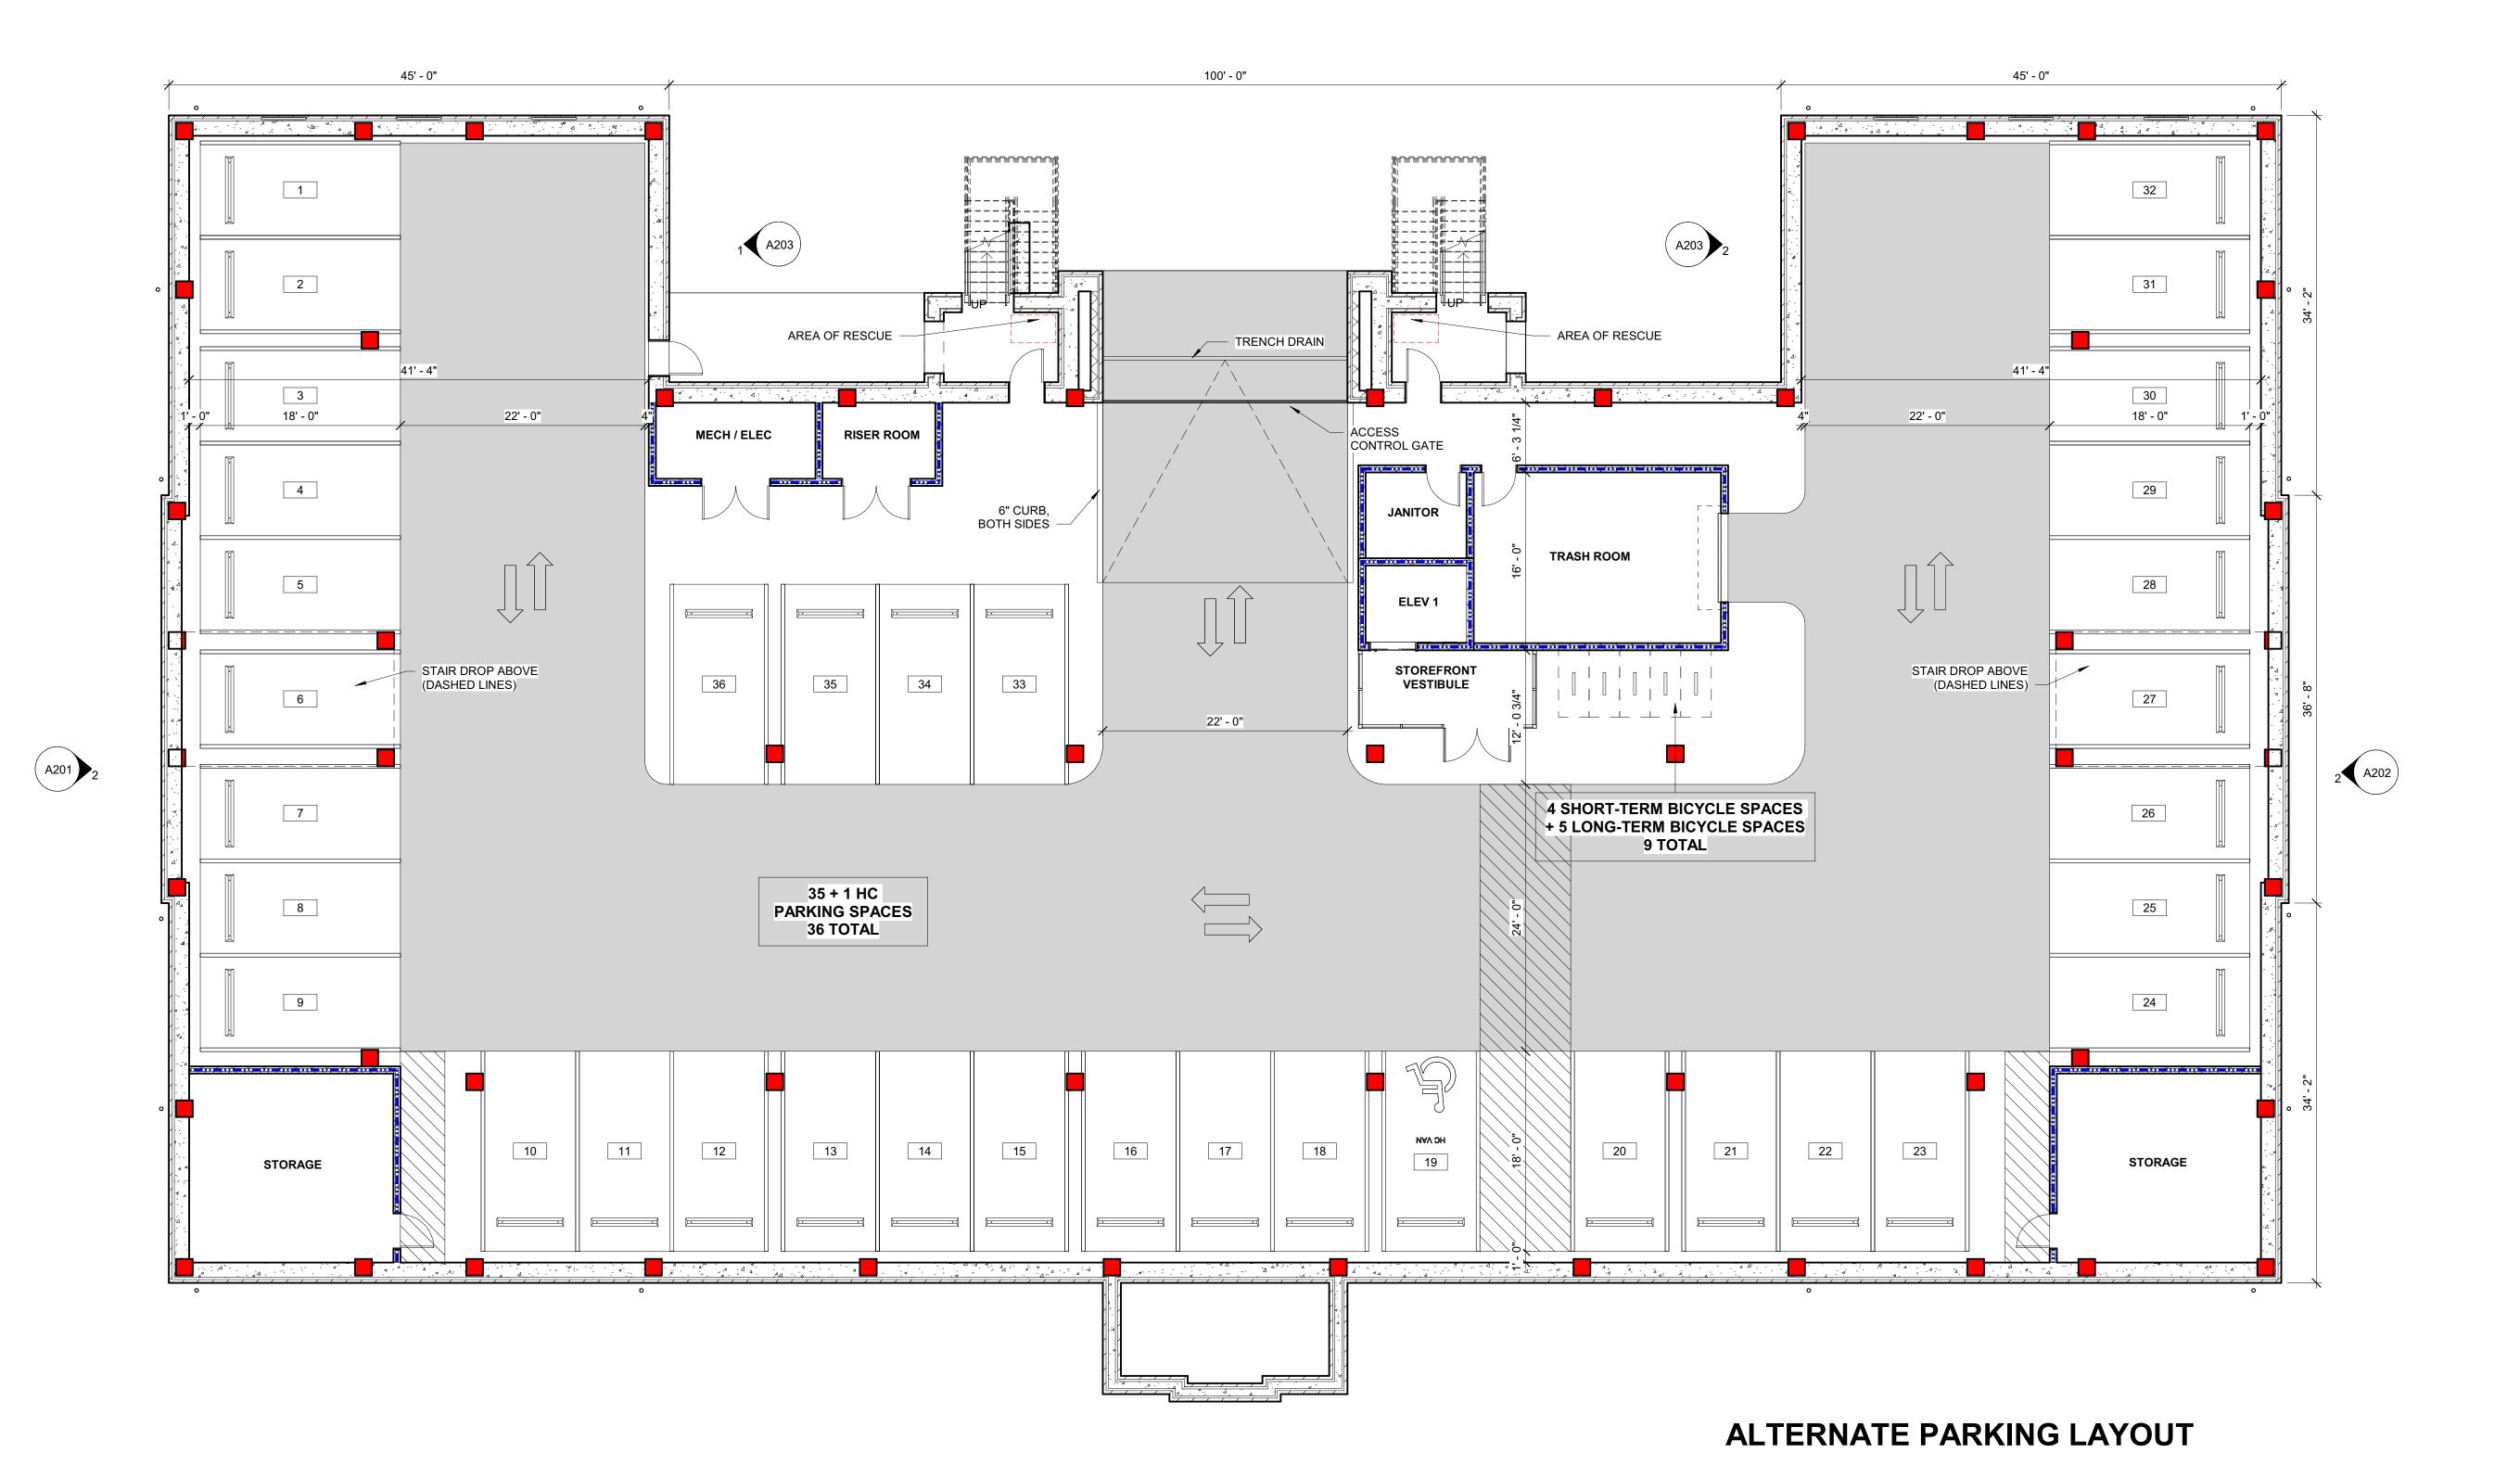Suite 301 Atlanta, GA 30316 678/325-6665 historicalconcepts.com

NOT FOR CONSTRUCTION

PROJECT: 022135 03.07.2023 DATE **REVISIONS:**

DRAWN BY: KS/RB CHECKED BY: LL

PARKING FLOOR PLAN

PER RALEIGH UDO, SEC. 1.5.7. HEIGHT, D. HEIGHT ENCROACHMENTS, THE PORTION OF BUILDING EXTENDING ABOVE THE MAXIMUM BUILDING HEIGHT COMPLIES WITH 3.G. ACCESSORY STRUCTURES AS AN ELEVATOR OR STAIRWAY ACCESS TO THE ROOF AND EXCEEDS THE MAXIMUM BUILDING HEIGHT BY LESS THAN 12 FEET. SEE BELOW FOR AREA CALCULATIONS DEMONSTRATING THE SIZE OF THE ACCESSORY STRUCTURE AS LESS THAN 25% OF THE ROOF AREA WITH A SETBACK OF AT LEAST 10'-0" FROM THE EDGE OF THE ROOF.

TOTAL ROOF AREA = 18,442 SF

STAIR 1 AREA = 216.25 SF

STAIR 2 AREA = 216.25 SF


ROOF AMENITY AREA = 1,037 SF

TOTAL ENCLOSED AREA = 1,469.5 SF

ENCLOSED ROOF AREA = 7.97% OF TOTAL ROOF AREA (1,465.5/18,442) x 100

MAX. ALLOWED 25% OF TOTAL ROOF AREA = 4,610.5 SF



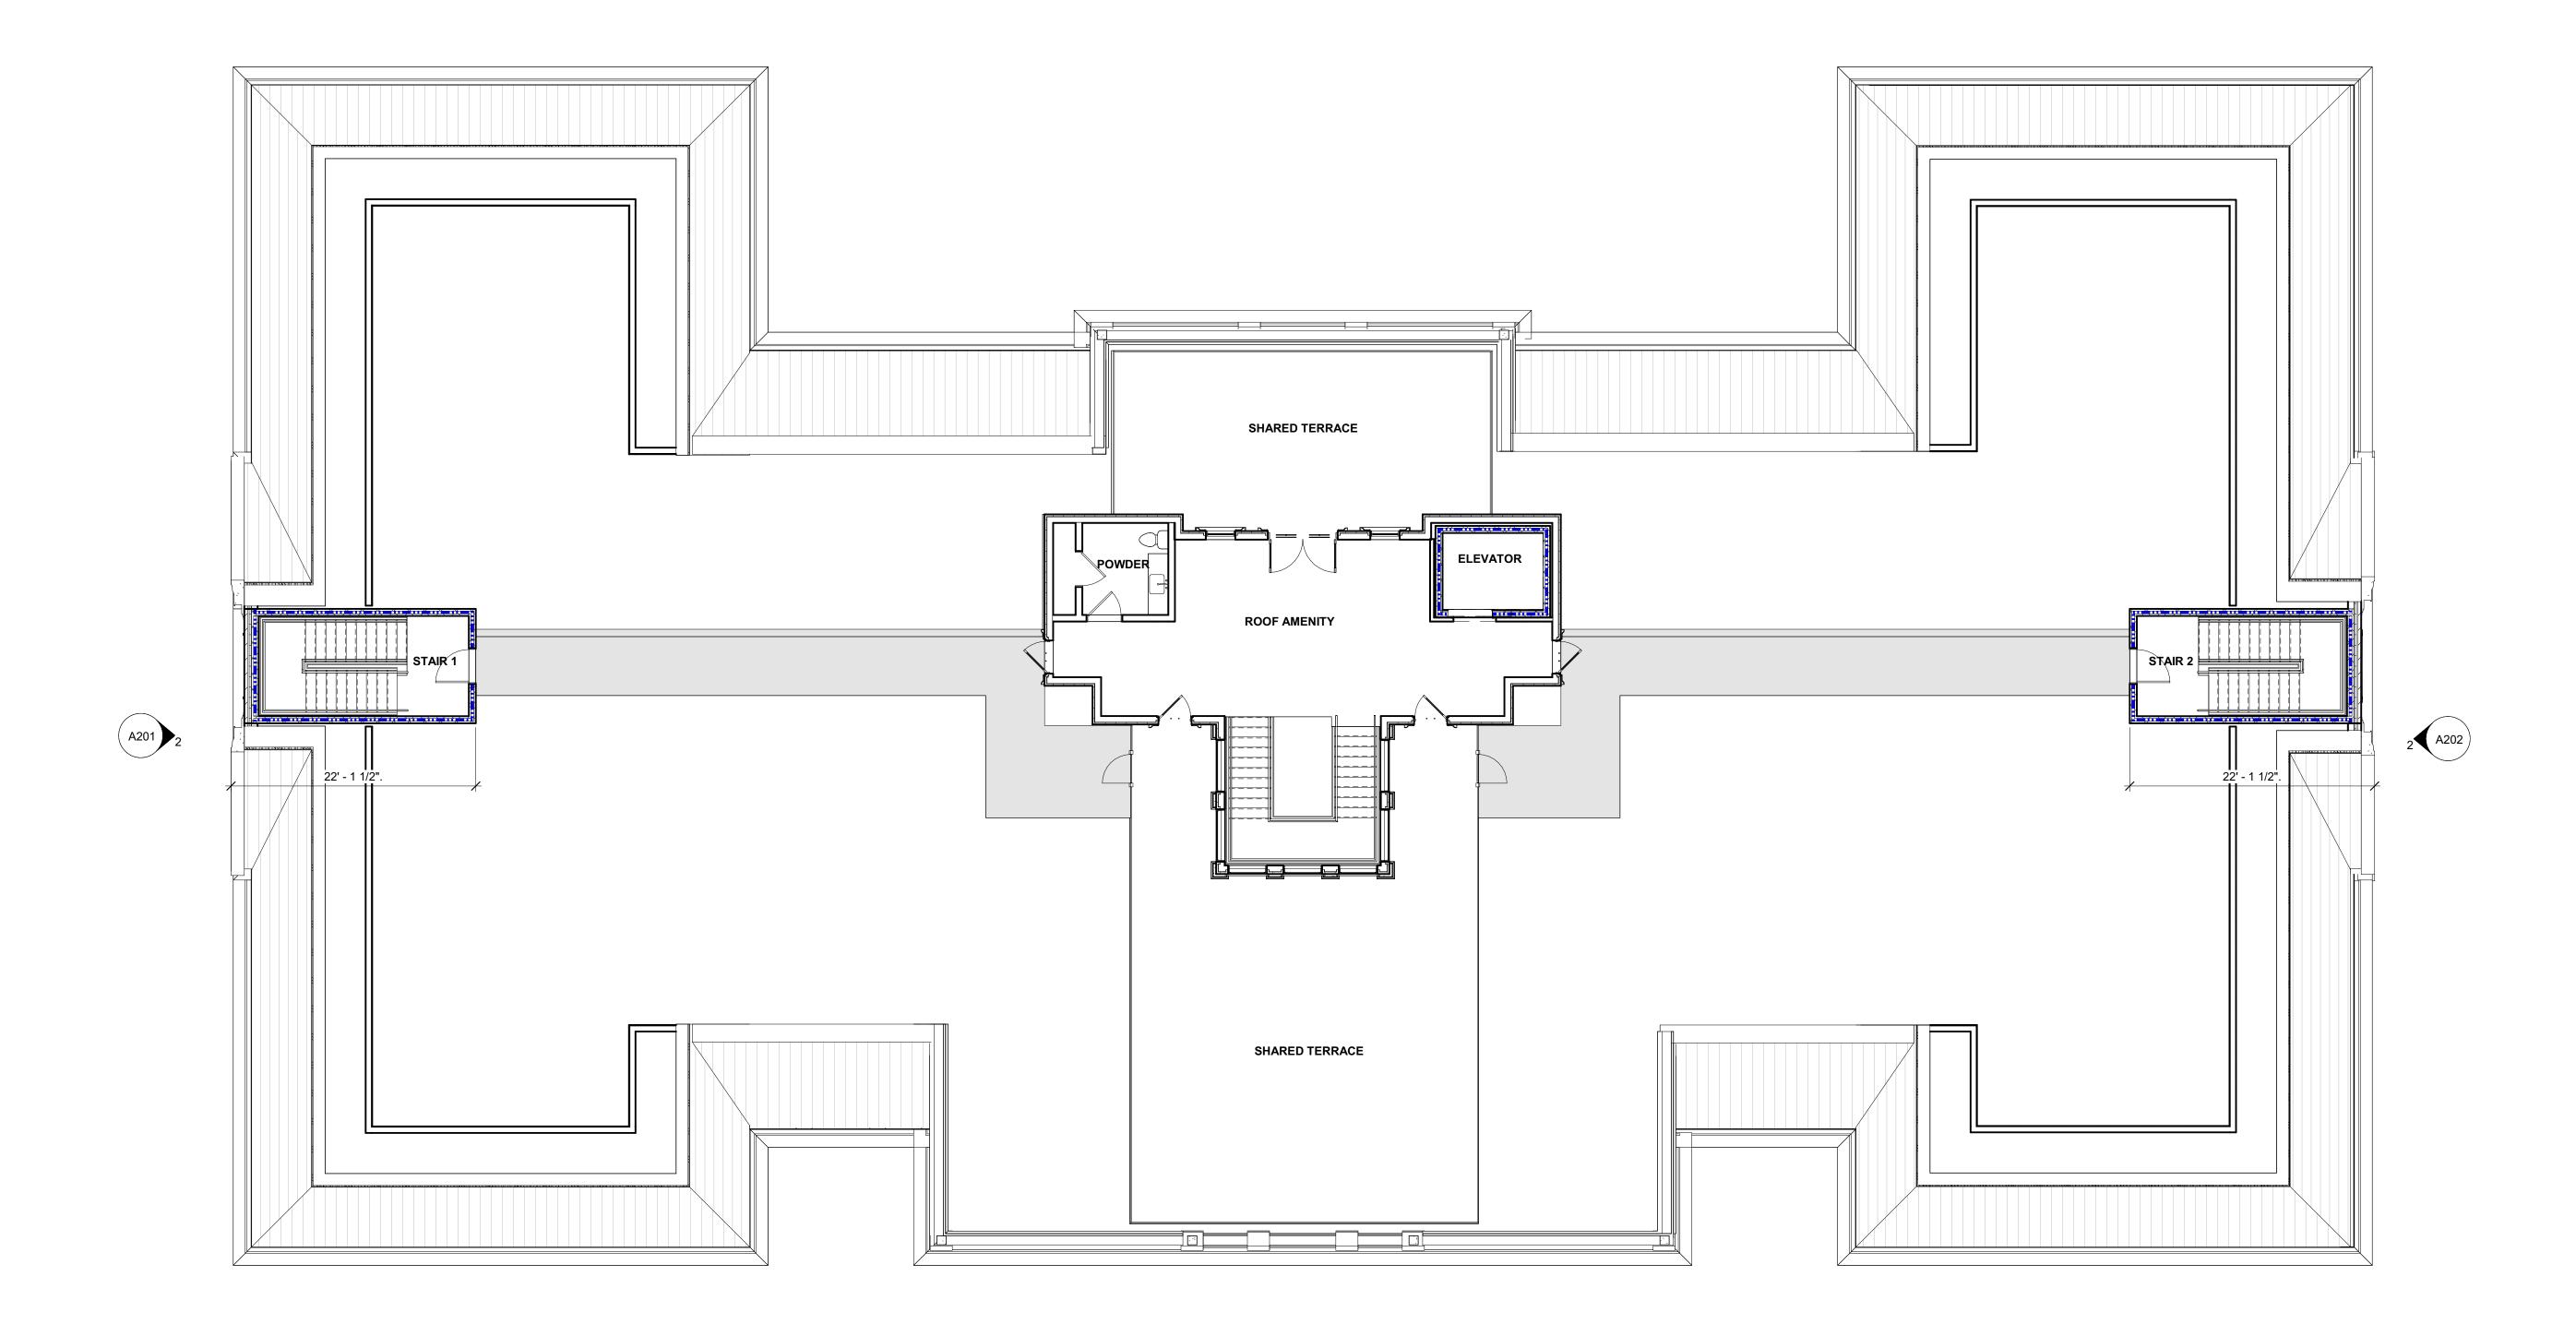

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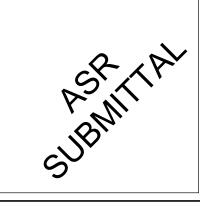
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OTH	PROJECT:	022135
AND OTH	DATE:	02.24.2023
RIGHT	REVISIONS:	DATE
PYF		

DRAWN BY: KS/RB
CHECKED BY: LL


ROOF DECK

A104

PER RALEIGH UDO, SEC. 1.5.7. HEIGHT, D. HEIGHT ENCROACHMENTS, THE PORTION OF BUILDING EXTENDING ABOVE THE MAXIMUM BUILDING HEIGHT COMPLIES WITH 3.G. ACCESSORY STRUCTURES AS AN ELEVATOR OR STAIRWAY ACCESS TO THE ROOF AND EXCEEDS THE MAXIMUM BUILDING HEIGHT BY LESS THAN 12 FEET. SEE SHEET A104 FOR AREA CALCULATIONS DEMONSTRATING THE SIZE OF THE ACCESSORY STRUCTURE AS LESS THAN 25% OF THE ROOF AREA WITH A SETBACK OF AT LEAST 10'-0" FROM THE EDGE OF THE ROOF.

AVERAGE GRADE CALCULATION

BUILDING ELEVATIONS						
		IMPROVED GRADE				
BUILDING	PRIMARY STREET FRONT	HIGH	LOW	AVG		
BLDG 1	Fariview Road	396.50	394.50	395.50		

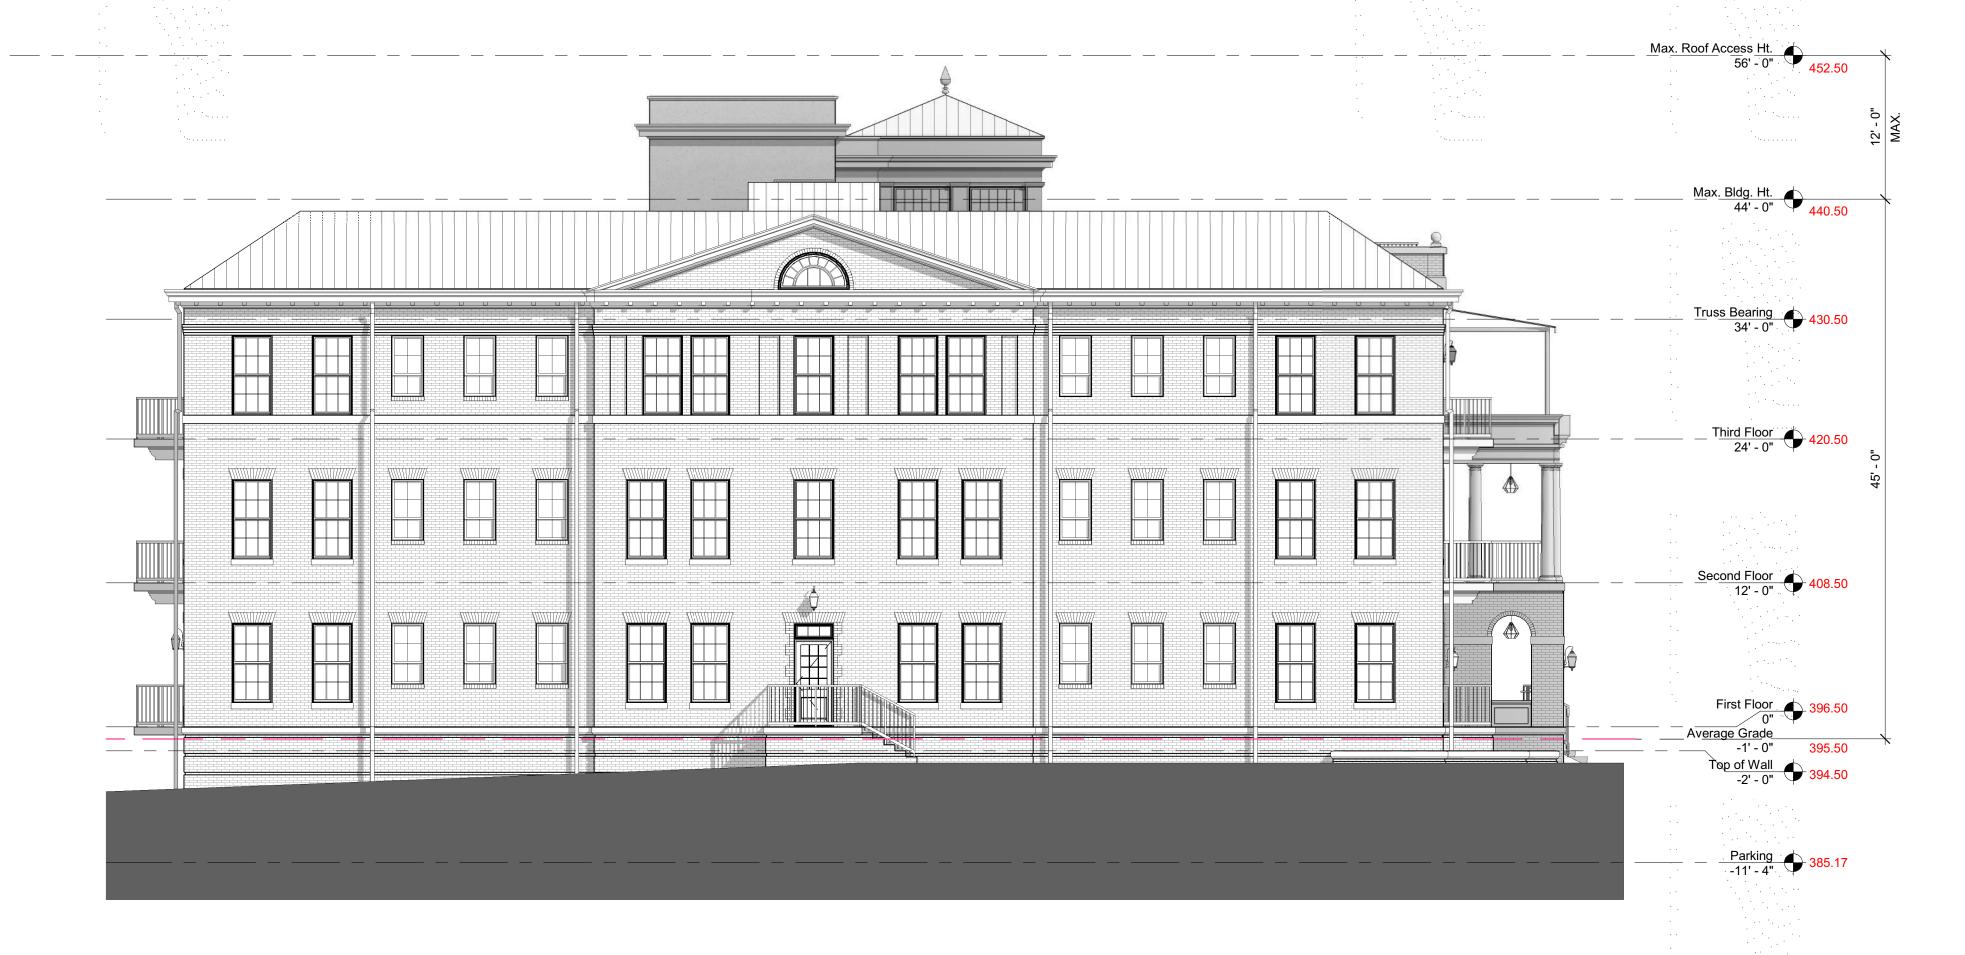

WEST ELEVATION (OBERLIN)

1/8" = 1'-0"



SOUTH ELEVATION (FAIRVIEW)

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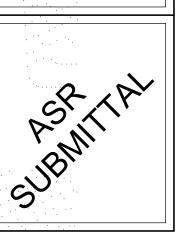
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022135 PROJECT: 02.24.2023 DATE: REVISIONS: DATE

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EXTERIOR ELEVATIONS

PER RALEIGH UDO, SEC. 1.5.7. HEIGHT, D. HEIGHT ENCROACHMENTS, THE PORTION OF BUILDING EXTENDING ABOVE THE MAXIMUM BUILDING HEIGHT COMPLIES WITH 3.G. ACCESSORY STRUCTURES AS AN ELEVATOR OR STAIRWAY ACCESS TO THE ROOF AND EXCEEDS THE MAXIMUM BUILDING HEIGHT BY LESS THAN 12 FEET. SEE SHEET A104 FOR AREA CALCULATIONS DEMONSTRATING THE SIZE OF THE ACCESSORY STRUCTURE AS LESS THAN 25% OF THE ROOF AREA WITH A SETBACK OF AT LEAST 10'-0" FROM THE EDGE OF THE ROOF.

AVERAGE GRADE CALCULATION

	BUILDING ELEVATIONS					
			IMPROVED GRADE			
	BUILDING	PRIMARY STREET FRONT	HIGH	LOW	AVG	
- 1	BLDG 1	Fariview Road	396.50	394.50	395.50	



GARAGE ENTRY

EAST ELEVATION (ST MARYS)

1/8" = 1'-0" Max. Roof Access Ht. 56' - 0" 452.50

- Max. Bldg. Ht. 44' - 0" 440.50

Truss Bearing 430.50


Third Floor 420.50

Second Floor 408.50

Av<u>erage Gra</u>de -1' - 0" 395.50

Top of Wall _____ 394.50

Parking -11' - 4" 385.17

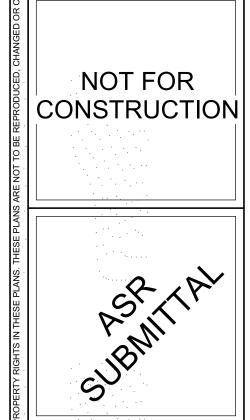

125 N. Harrington St.

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PROJECT:	022135		
DATE:	02.24.2023		
REVISIONS:	DATE		

DRAWN BY: KS/RB

CHECKED BY: LL **EXTERIOR ELEVATIONS**

NORTH ELEVATION (MARCHMONT)

A202