Administrative Site Review Application



Planning and Development Customer Service Center • One Exchange Plaza, Suite 400 | Raleigh, NC 27601 | 919-996-2500

This form is required when submitting site plans as referenced in Unified Development Ordinance (UDO) Section 10.2.8. Please check the appropriate building types and include the plan checklist document when submitting.

Office Use Only: Case #:			Planner (print):	<u> </u>
	ation request can be su		an tier. If assistance determini e via the <u>Permit and Developm</u>	ng a Site Plan Tier is needed
Site Plan Tier: Tier	Two Site Plan	Tier Three	e Site Plan	
_	and Development Typeck all that apply)	ре	Site Transa	ction History
Detached	General		Subdivision case #:	
Attached	Mixed use		Scoping/sketch plan case #:	
Townhouse	Civic		Certificate of Appropriateness #:	
Apartment	Cottage Cou	rt	Board of Adjustment #: Zoning Case #:	
Tiny house	Frequent Tra	ansit		
Open lot	Developmen	t Option	Design Alternate #:	
		GENERAL II	NFORMATION	
Development name:				
Inside City limits?	Yes No			
Property address(es):				
Site P.I.N.(s):				
Please describe the so	cope of work. Include a	ny additions,	expansions, and uses (UDO 6.	.1.4).
Current Property Ow	ner(s):			
Company:		Title:		
Address:				
Phone #:		Email:		
Applicant Name (If d	ifferent from owner. S	ee "who can	apply" in instructions):	
Relationship to owner	: Lessee or contract	purchaser	Owner's authorized agent	Easement holder
Company: Roers Companies Address:				

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Phone #:	Email:			
NOTE: please attach purchase agreement or contract, lease or easement when submitting this form.				
Developer Contact:				
Company:		Title:		
Address:				
Phone #:	Email:			
Applicant Name:				
Company:	Address:			
Phone #:	Email:			

DEVELOPMENT TYPE + SITE DATE TABLE (Applicable to all developments)			
SITE DATA	BUILDING DATA		
Zoning district(s) (please provide the acreage of each):	Existing gross floor area (not to be demolished):		
Gross site acreage:	Existing gross floor area to be demolished:		
# of parking spaces proposed:	New gross floor area:		
Max # parking permitted (7.1.2.C):	Total sf gross (to remain and new):		
Overlay District (if applicable):	Proposed # of buildings:		
Existing use (UDO 6.1.4):	Proposed # of stories for each:		
Proposed use (UDO 6.1.4):	Proposed # of basement levels (UDO 1.5.7.A.6)		

STORMWATER INFORMATION		
Imperious Area on Parcel(s):	Impervious Area for Compliance (includes ROW):	
Existing (sf) Proposed total (sf)	Existing (sf) Proposed total (sf)	

RESIDENTIAL & OVERNIGHT LODGING DEVELOPMENTS			
Total # of dwelling units:	Total # of hotel bedrooms:		
# of bedroom units: 1br <u>36</u> 2br <u>108</u> 3br <u>3</u>	7_ 4br or more		
# of lots:	Is your project a cottage court? Yes No		
	A frequent transit development? Yes No		

Continue to Applicant Signature Block on Page Three.

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APPLICANT SIGNATURE BLOCK

Pursuant to state law (N.C. Gen. Stat. § 160D-403(a)), applications for development approvals may be made by the landowner, a lessee or person holding an option or contract to purchase or lease land, or an authorized agent of the landowner. An easement holder may also apply for development approval for such development as is authorized by the easement.

By submitting this application, the undersigned applicant acknowledges that they are either the property owner or one of the persons authorized by state law (N.C.G.S. 160D-403(a)) to make this application, as specified in the application. The undersigned also acknowledges that the information and statements made in the application are correct and the undersigned understands that developments approvals are subject to revocation for false statements or misrepresentations made in securing the development approval, pursuant to N.C. Gen. Stat. § 160D-403(f).

The undersigned indicates that the property owner(s) is aware of this application and that the proposed project described in this application will be maintained in all respects in accordance with the plans and specifications submitted herewith, and in accordance with the provisions and regulations of the City of Raleigh Unified Development Ordinance.

The undersigned hereby acknowledges that, pursuant to state law (N.C.G.S. 143-755(b1), if this permit application is placed on hold at the request of the applicant for a period of six consecutive months or more, or if the applicant fails to respond to comments or provide additional information requested by the City for a period of six consecutive months or more, then the application review is discontinued and a new application is required to proceed and the development regulations in effect at the time permit processing is resumed shall apply to the new application.

Signature: Kevin Sturgeon

Printed Name: Kevin Sturgeon

Date: 5/12/2023

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Administrative Site Review Application

Planning and Development Customer Service Center • One Exchange Plaza, Suite 400 | Raleigh, NC 27601 | 919-996-2500

10.2.8. Please check the appropriate building types and include the plan checklist document when submitting.

This form is required when submitting site plans as referenced in Unified Development Ordinance (UDO) Section



Please review UDO Section 10.2.8. to determine the site plan tier. If assistance determining a Site Plan Tier is needed a Site Plan Tier Verification request can be submitted online via the Permit and Development Portal. (Note: There is a

Site Plan Tier: Tier Two Site Plan	Tier Three	Site Plan		
Building and Development T (Check all that apply)	ype		Site Transaction History	
□ Detached □ General □ Mixed use □ Townhouse □ Civic □ Cottage Cottag	ransit	Scoping/ske Certificate of Board of Ac Zoning Cas	case #: etch plan case #: of Appropriateness #: ljustment #: e #: Z-46-22 rnate #:	
	GENERAL IN	FORMATION	N	
Development name: Old Poole Multifamily Inside City limits? Yes No Property address(es): 4900 Old Poole Rd, Raleigh, NC 27610 Site P.I.N.(s): 1733027023 Please describe the scope of work. Include any additions, expansions, and uses (UDO 6.1.4).				
Multifamily development with amenity area and surface parking.				
Current Property Owner(s): Joan Broadwell Wilkerson				
Company:	C 28570	Title:		
Address: 422 Safe Harbor, Newport, NC 28570				
	Phone #: 919-573-1392 Email: buttons357@aol.com Applicant Name (If different from owner. See "who can apply" in instructions):			
Relationship to owner: Lessee or contract purchaser Owner's authorized agent Easement holder				
Company: Roers Companies Address: Two Carlson Parkway #400, Plymouth, MN 55447				

· ·		
<u> </u>		raleighnc.gov
Phone #: 651-395-0684 Email: kevin		.sturgeon@roerscompanies.com
NOTE: please attach purchase agreement or contract, lease or easement when submitting this form.		
Developer Contact: Kevin Sturgeon		
Company: Roers Companies		Title: Developer
Address: Two Carlson Parkway #400, Plymouth, MN 55447		
Phone #: 651-395-0684 Email: kevir		n.sturgeon@roerscompanies.com
Applicant Name: Roers Companies		
Company: Roers Companies	Address: Two Carlson Parkway #400, Plymouth, MN 55447	
Phone #: 651-395-0684	Email: kevin.sturgeon@roerscompanies.com	

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REVISION 1.23.23

DEVELOPMENT TYPE + SITE DATE TABLE (Applicable to all developments)			
SITE DATA	BUILDING DATA		
Zoning district(s) (please provide the acreage of each): RX-5-PL-CU	Existing gross floor area (not to be demolished): 0		
Gross site acreage: 13.55 AC.	Existing gross floor area to be demolished: 0		
# of parking spaces proposed: 330	New gross floor area: 240,253.38		
Max # parking permitted (7.1.2.C): 408	Total sf gross (to remain and new): 240,253.38		
Overlay District (if applicable): N/A	Proposed # of buildings: 2		
Existing use (UDO 6.1.4): Open	Proposed # of stories for each: 5		
Proposed use (UDO 6.1.4): Residential	Proposed # of basement levels (UDO 1.5.7.A.6) 1		

STORMWATER INFORMATION				
Imperious Area on Parcel(s):	Impervious Area for Compliance			
Existing (sf) 0 Proposed total (sf) 186,665	(includes ROW):			
	Existing (sf) 0 Proposed total (sf) $231,421$			
RESIDENTIAL & OVERNIGHT	LODGING DEVELOPMENTS			
Total # of dwelling units: 181	Total # of hotel bedrooms:			
# of bedroom units: 1br 36 2br 108 3br 37				
# of bedroom units: 1br <u>36</u> 2br <u>108</u> 3br <u>37</u>	4br or more			

Continue to Applicant Signature Block on Page Three.

A frequent transit development? Yes No


APPLICANT SIGNATURE BLOCK		, ,
Pursuant to state law (N.C. Gen. Stat. § 160D-403(a)), applications for deverthe landowner, a lessee or person holding an option or contract to purchase of the landowner. An easement holder may also apply for development approauthorized by the easement.	or lease land,	or an authorized agent
By submitting this application, the undersigned applicant acknowledges that one of the persons authorized by state law (N.C.G.S. 160D-403(a)) to make application. The undersigned also acknowledges that the information and structure and the undersigned understands that developments approvals are statements or misrepresentations made in securing the development approval 160D-403(f).	this application at the application at the application at the third application application application application at the application at the application application at the application	on, as specified in the le in the application are location for false
The undersigned indicates that the property owner(s) is aware of this applicatescribed in this application will be maintained in all respects in accordance submitted herewith, and in accordance with the provisions and regulations of Development Ordinance.	with the plans	and specifications
The undersigned hereby acknowledges that, pursuant to state law (N.C.G.S is placed on hold at the request of the applicant for a period of six consecutivals to respond to comments or provide additional information requested by months or more, then the application review is discontinued and a new application and the permit processing is resumed such as the permit processing is resumed to the permit processing in the permit processing is resumed to the permit processing is resumed to the permit processing in the permit processing is resumed to the permit processing in the permit processing in the permit processing is resumed to the permit processing in	ve months or return the City for a cation is requi	more, or if the applicant period of six consecutive red to proceed and the
Signature: Kevin Sturgeon	Date:	5/12/2023

Old Poole Rd. Multifamily

4900 Old Poole Road, Raleigh, NC 27610

City of Raleigh - Administrative Site Review Submittal: 05/12/2023

ASR Number: ASR-XXXX-2023

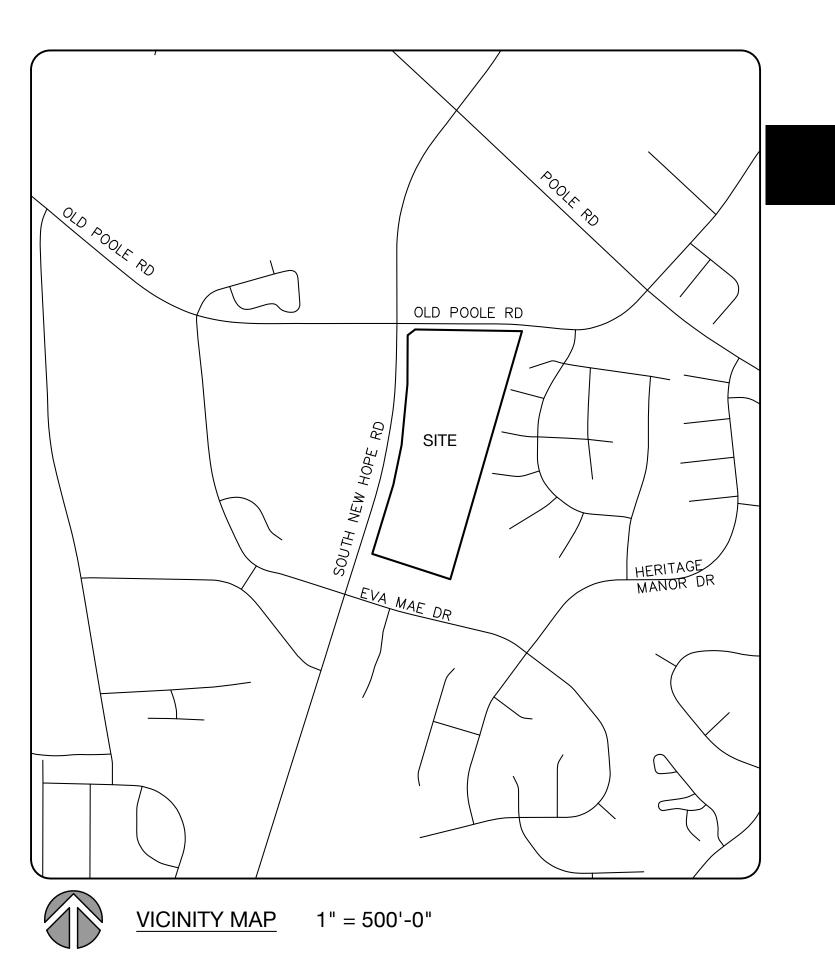

TAX PARCEL ID #:	1733027023	VEHICULAR PARKING:	
		MIN.:	NONE
TOTAL SITE AREA:	13.55 AC (± 590,367 SF)	0-1 BR MAX:	1.5 SPACE/UNIT (36X1.5 = 54)
		2 BR MAX:	2.25 SPACE/UNIT (108X2.25 = 243)
EXISTING ZONING:	RX-5-PL-CU	3 BR MAX:	3 SPACE/UNIT (37X3 = 111)
REZONING CASE NUMBER:	Z-46-22		
		MAX ALLOWED:	408 SPACES
EXISTING USE:	VACANT		
PROPOSED USE:	MULTI-FAMILY	PROVIDED:	330 SPACES (INCLUDES 8 ADA SPACES)
PRIMARY STREET:	OLD POOLE ROAD		
		BICYCLE PARKING:	
BUILDING UNIT DATA:		REQUIRED:	
		LONG-TERM:	52 (1 SPACE / 7 BR; 363/7 = 52)
BUILDING UNITS (TOTAL):	181	SHORT-TERM:	10 (1 SPACE / 20 UNITS; 181/20 = 9.05
		PROVIDED:	
1 BEDROOM:	36	LONG-TERM:	52 SPACES
2 BEDROOM:	108	SHORT-TERM:	10 SPACES
3 BEDROOM:	37		

CONTACT INFORMATION

ROERS COMPANIES

CONTACT: KEVIN STURGEON ADDRESS: 110 CHESHIRE LANE, SUITE 120

PHONE: 651-395-0684

MINNETONKA, MN 55305

CIVIL ENGINEER & LANDSCAPE ARCHITEC

URBAN DESIGN PARTNERS PLLC CONTACT: SALMAN MOAZZAM, PE

ADDRESS: 150 FAYETTEVILLE ST. SUITE 1310

RALEIGH, NC 27601 PHONE: 919-275-5002

CONTACT: TOM LIEBEL, FAIA, LEED FELLOW ADDRESS: 1414 KEY HIGHWAY, 2ND FLOOR

BALTIMORE, MD 21230 PHONE: 410-539-4300

Sheet Index

Sheet Number	Sheet Title
C-1.0	Cover Sheet
	Site Survey
C-2.1	Demolition Plan
C-2.2	Tree Conservation Area Plan
C-3.0	Site Plan
C-4.0	Grading Plan
C-4.1	Storm Drainage Infrastructure
C-5.1	BMP Plan & Details
C-6.0	Utility Plan
C-8.0	Site Specifications & Details
C-8.1	Site Specifications & Details
C-8.2	Site Specifications & Details
LS-1.0	Landscape Plan
LS-2.0	Landscape Notes & Details
LS-2.1	Landscape Details
A4.1.1	Architectural Elevations
A4.1.2	Architectural Elevations

GENERAL NOTES:

- 1. ALL CONSTRUCTION AND MATERIALS SHALL BE IN ACCORDANCE WITH CITY OF RALEIGH AND NCDOT STANDARDS AND SPECIFICATIONS IF APPLICABLE.
- 2. THE CONTRACTOR SHALL OBTAIN A RIGHT-OF-WAY PERMIT FOR ANY WORK WHICH REQUIRES THE CLOSURE OF A TRAVEL LANE(S), PARKING SPACE, OR SIDEWALK FROM RIGHT-OF-WAY SERVICES AT
- LEAST 48 HOURS IN ADVANCE. 3. NO WORK WILL BE ALLOWED WITHIN NCDOT ROW UNTIL ALL ENCROACHMENT AGREEMENTS ARE
- APPROVED BY NCDOT. 4. IF CONSTRUCTION PLANS FOR PUBLIC AND PRIVATE STREETS OR UTILITIES SHOWN ON THIS PLAN ARE REQUIRED, THEY MUST BE APPROVED BY THE PUBLIC WORKS DEPARTMENT AND PUBLIC UTILITIES DEPARTMENT PRIOR TO ISSUANCE OF PERMITS OR RECORDING OF ANY PLAT FOR THIS
- 5. FIELD ADJUSTMENTS TO THIS PLAN MAY BE REQUIRED BY CITY OF RALEIGH INSPECTOR AS NEEDED DURING CONSTRUCTION. 6. ALL PROPOSED CURB AND GUTTER WITHIN PUBLIC RIGHT OF WAY SHOWN ON PLANS TO BE 30" CITY
- OF RALEIGH STANDARD CONCRETE CURB AND GUTTER, AND ALL OTHER PROPOSED CURB AND GUTTER TO BE 24" CONCRETE CURB AND GUTTER UNLESS OTHERWISE STATED ON PLANS.
- 7. ALL DIMENSIONS SHOWN ARE TO BACK OF CURB, UNLESS OTHERWISE STATED ON PLANS.
- 8. WITHIN THE SIGHT TRIANGLES SHOWN ON THIS PLAN, NO OBSTRUCTION BETWEEN 2 FEET AND 8 FEET IN HEIGHT ABOVE THE CURB LINE ELEVATION SHALL BE LOCATED IN WHOLE OR PART. OBSTRUCTIONS INCLUDE BUT ARE NOT LIMITED TO ANY BERM, FOLIAGE, FENCE, WALL, SIGN, OR PARKED VEHICLE.
- 9. UNLESS NOTED, ACCESS ROUTE FOR EMERGENCY VEHICLES SHALL PROVIDE AN INSIDE TURNING
- RADIUS OF 28' MINIMUM.
- 10. TRASH AND CARDBOARD DUMPSTER(S) ENCLOSURE SHALL COMPATIBLE WITH MATERIAL AND/OR COLOR OF THE PRINCIPAL BUILDING.
- 11. ALL HVAC UNITS SHALL BE SCREENED FROM VIEW OF THE PUBLIC RIGHT OF WAY. 12. CONTRACTOR TO FIELD LOCATE AND VERIFY ALL EXISTING UTILITIES PRIOR TO CONSTRUCTION AND REPORT ANY DISCREPANCIES TO LANDSCAPE ARCHITECT PRIOR TO ANY CONSTRUCTION ACTIVITIES.
- CONTACT NC ONE AT 811 FOR FIELD LOCATION OF UNDERGROUND UTILITIES.
- 13. HANDICAP PARKING SPACE(S) AND HC ACCESS AISLE(S) SHALL BE NO GREATER THAN TWO PERCENT
- (2%) PITCH IN ANY DIRECTION(S) AS PER ADA STANDARDS. 14. PROVIDE SIGNAGE AND STRIPING OF HANDICAP SPACES AS PER ADA STANDARDS.
- 15. ALL RETAINING WALLS GREATER THAN 30" IN HEIGHT TO INCLUDE SAFETY RAIL OR FENCE. N
- RETAINING WALLS ARE PERMITTED IN THE RIGHT-OF-WAY UNLESS APPROVED BY ENCROACHMENT.
- 16. THE MINIMUM CORNER CLEARANCE FROM THE CURB LINE OF INTERSECTING STREETS SHALL BE AT LEAST 20 FEET FROM THE POINT OF TANGENCY OF THE CURB FOR RESIDENTIAL DRIVEWAY. NO DRIVEWAYS SHALL ENCROACH ON THIS MINIMUM CORNER CLEARANCE.
- 17. WC ACCESS RAMPS WILL BE PROVIDED IN ACCORDANCE WITH CITY OF RALEIGH PUBLIC WORKS DEPARTMENT STANDARDS, PROWAG STANDARDS AND ADAAG SPECIFICATIONS
- 18. ALL RAMPS AND HANDRAILS SHALL BE CONFORM TO ANSI STANDARDS. 19. ALL ABOVE GROUND UTILITY DEVICES (TO INCLUDE BUT NOT LIMITED TO TELEPHONE AND CABLE
- PEDESTALS, ELECTRICAL TRANSFORMERS, BACKFLOW DEVICE HOTBOX, ETC) SHALL BE SCREENED FROM OFF-SITE VIEW BY EVERGREEN SHRUBS, FENCE, OR WALL.
- 20. ALL SIDEWALKS MUST BE ACCESSIBLE TO PERSONS WHO ARE BLIND, HAVE LOW VISION AND PEOPLE WITH MOBILITY DISABILITIES. PEDESTRIAN EXISTING ROUTES AND ALTERNATE PEDESTRIAN ROUTES DURING CONSTRUCTION WILL BE REQUIRED TO BE COMPLIANT WITH THE PUBLIC RIGHTS OF WAY ACCESSIBILITY GUIDELINES (PPOWAG), 2010 ADA STANDARDS FOR ACCESSIBLE DESIGN AND THE MANUAL ON UNIFORM TRAFFIC CONTROL DEVICES (MUTCD).
- 21. IF UNFORESEEN CONDITIONS DEVELOP DURING CONSTRUCTION, REFER TO "CITY OF RALEIGH STREET DESIGN MANUAL" AND CONTACT PUBLIC WORKS DEPARTMENT FOR FURTHER GUIDANCE.
- 22. PRIOR TO START OF CONSTRUCTION, THE CONTRACTOR SHALL SCHEDULE A PRE-CONSTRUCTION MEETING WITH THE CITY OF RALEIGH PUBLIC WORKS DEPARTMENT / TRANSPORTATION FIELD SERVICES STAFF TO REVIEW THE SPECIFIC COMPONENTS OF THE PLAN AND OPERATION OF THESE FACILITIES DUFFING CONSTRUCTION. CONTACT ENGINEERING INSPECTIONS AT 919.996.2409 TO SET UP
- 23. THE CONTRACTOR SHALL CONDUCT THE WORK IN A SAFE MANNER AND WITH A MINIMUM AMOUNT OF
- 24. THE CONTRACTOR SHALL BE RESPONSIBLE FOR ALL TRAFFIC CONTROL AND SHALL ADHERE TO THE PROVISIONS OF THE MUTCD (MOST CURRENT EDITION).
- 25. ANY TEMPORARY STREET CLOSURE MUST BE SUBMITTED A MINIMUM OF 2 WEEKS PRIOR TO THE START OF WORK. SEE "RIGHT-OF-WAY CLOSURES" ON <u>WWW.RALEIGHNC.GOV</u>. COMPLETE AND SEND THE RIGHT-OF-WAY OBSTRUCTION PERMIT TO <u>RIGHTOFWAYSERVICES@RALEIGHNC.GOV</u>.
- 26. PRIOR TO CONSTRUCTION BEGINNING, ALL SIGNAGE AND TRAFFIC CONTROL SHALL BE IN PLACE.

DESIGN PARTNERS 150 fayetteville st ste 1310


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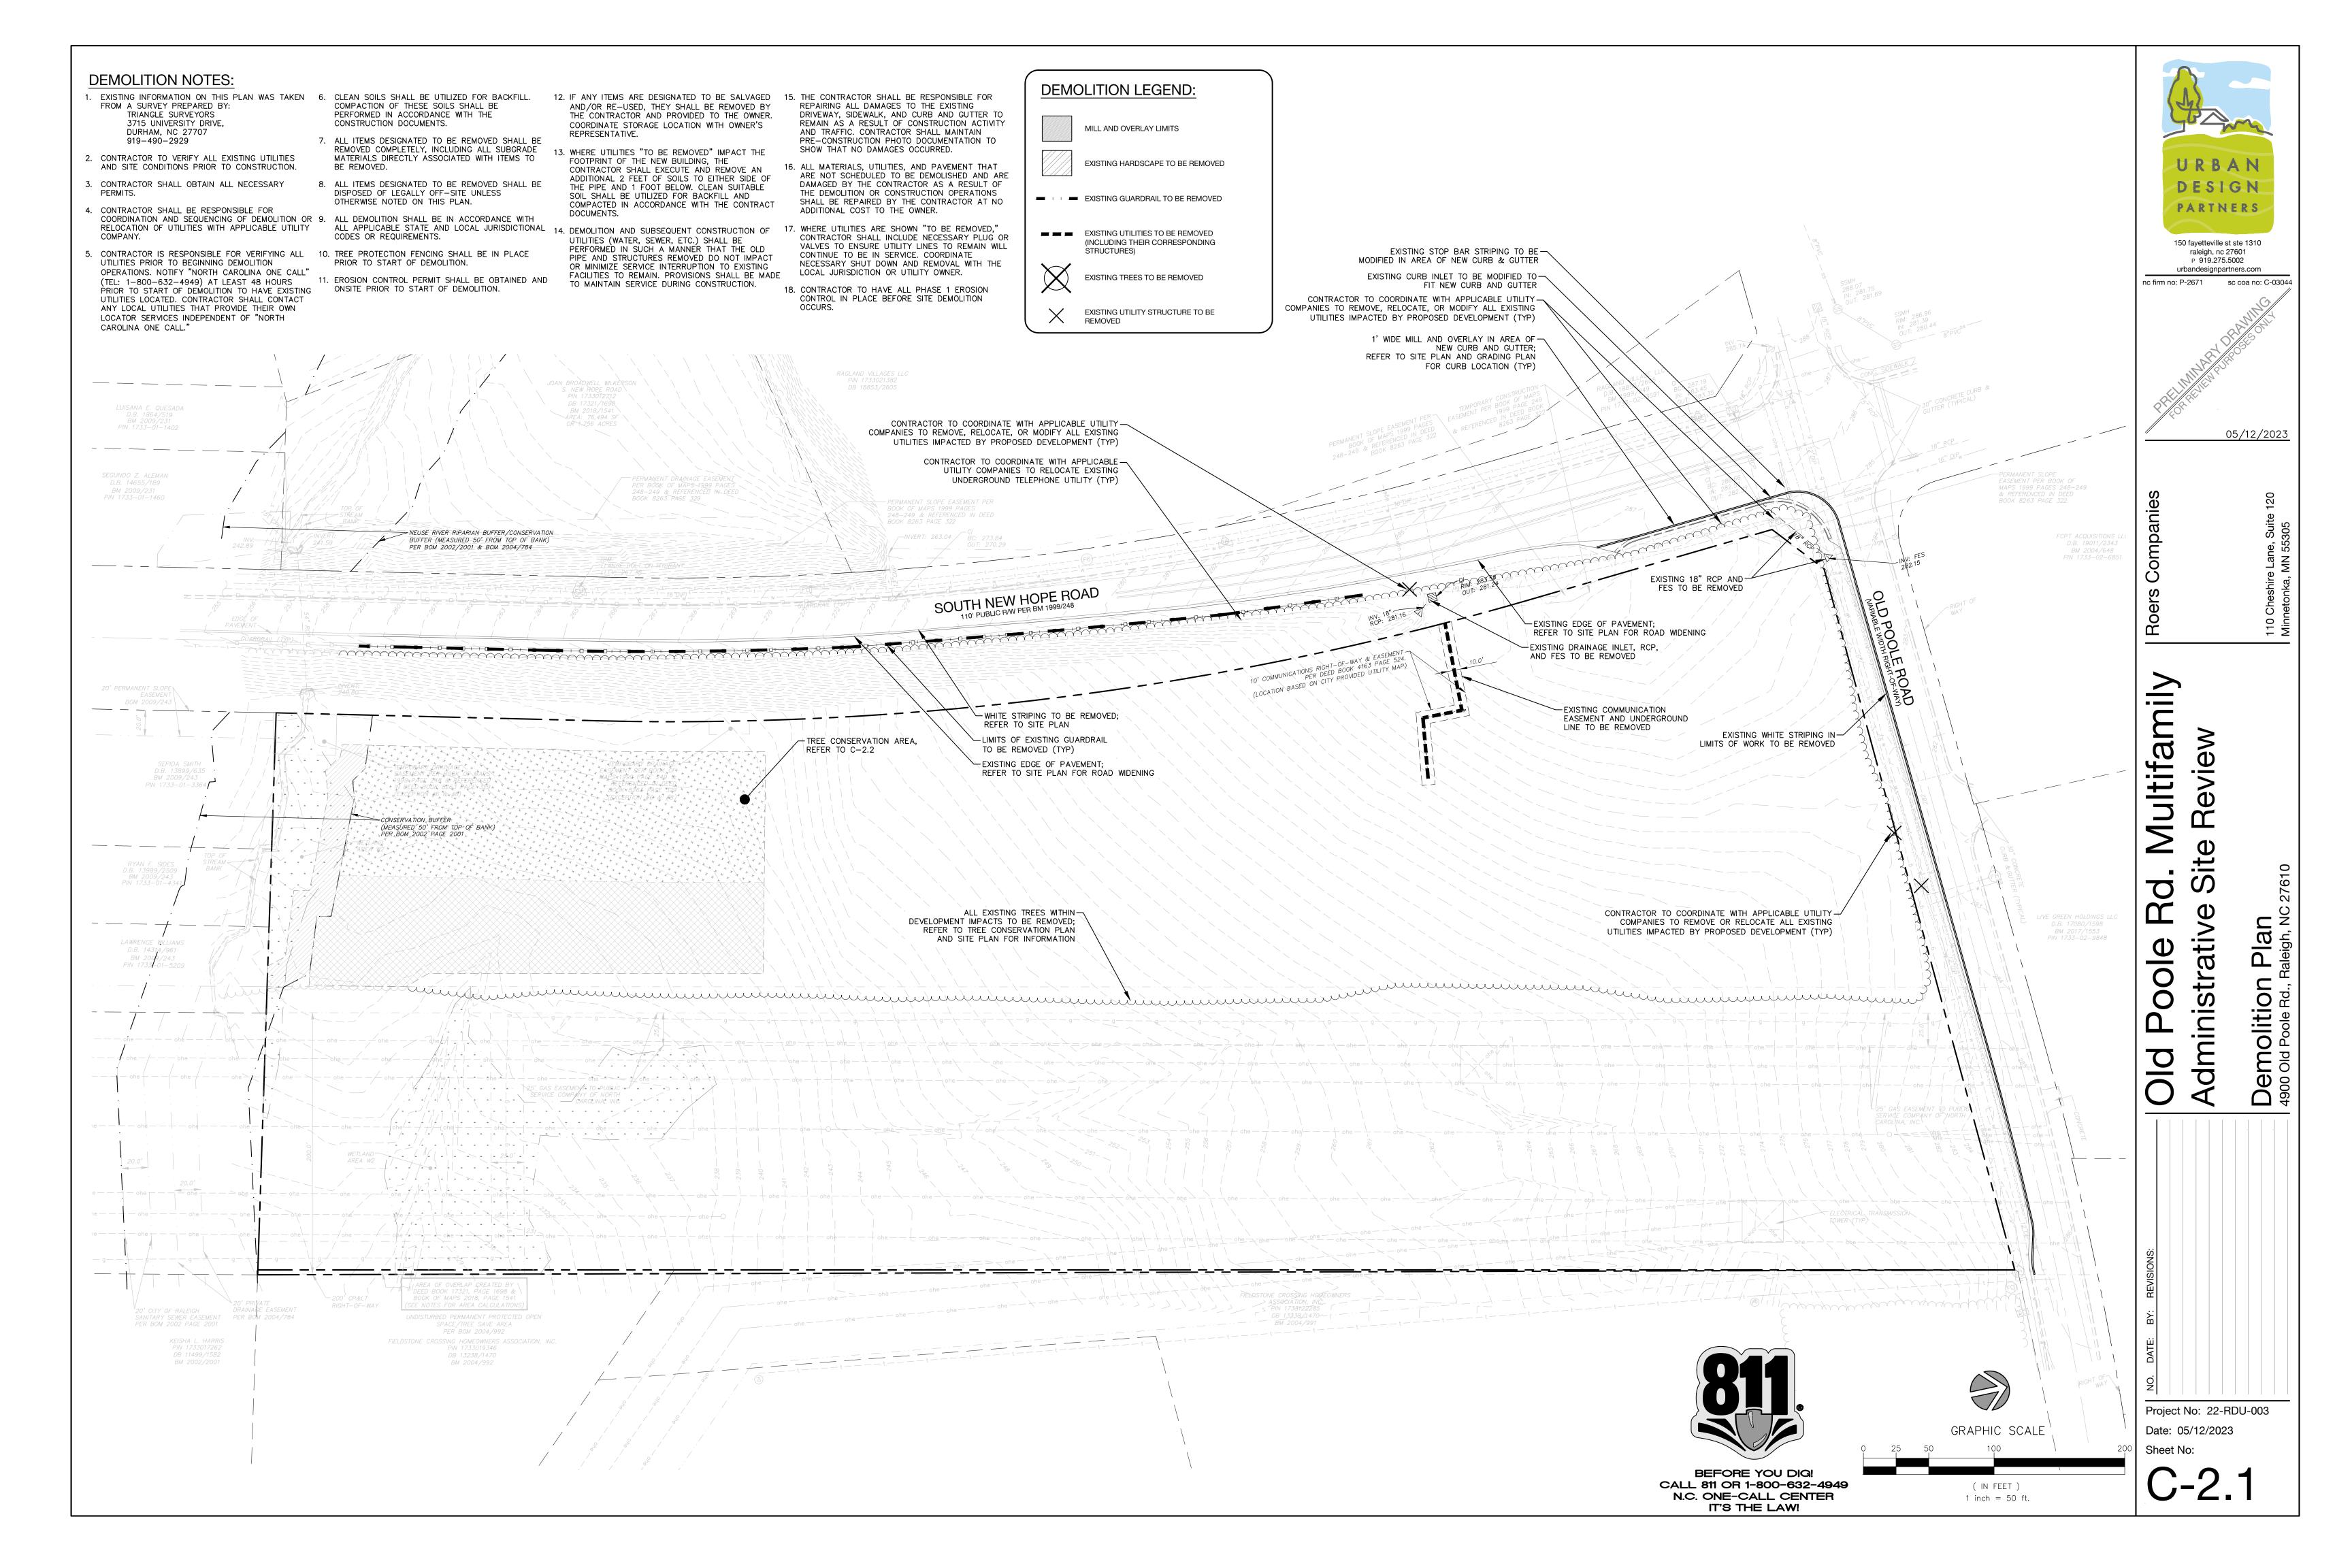
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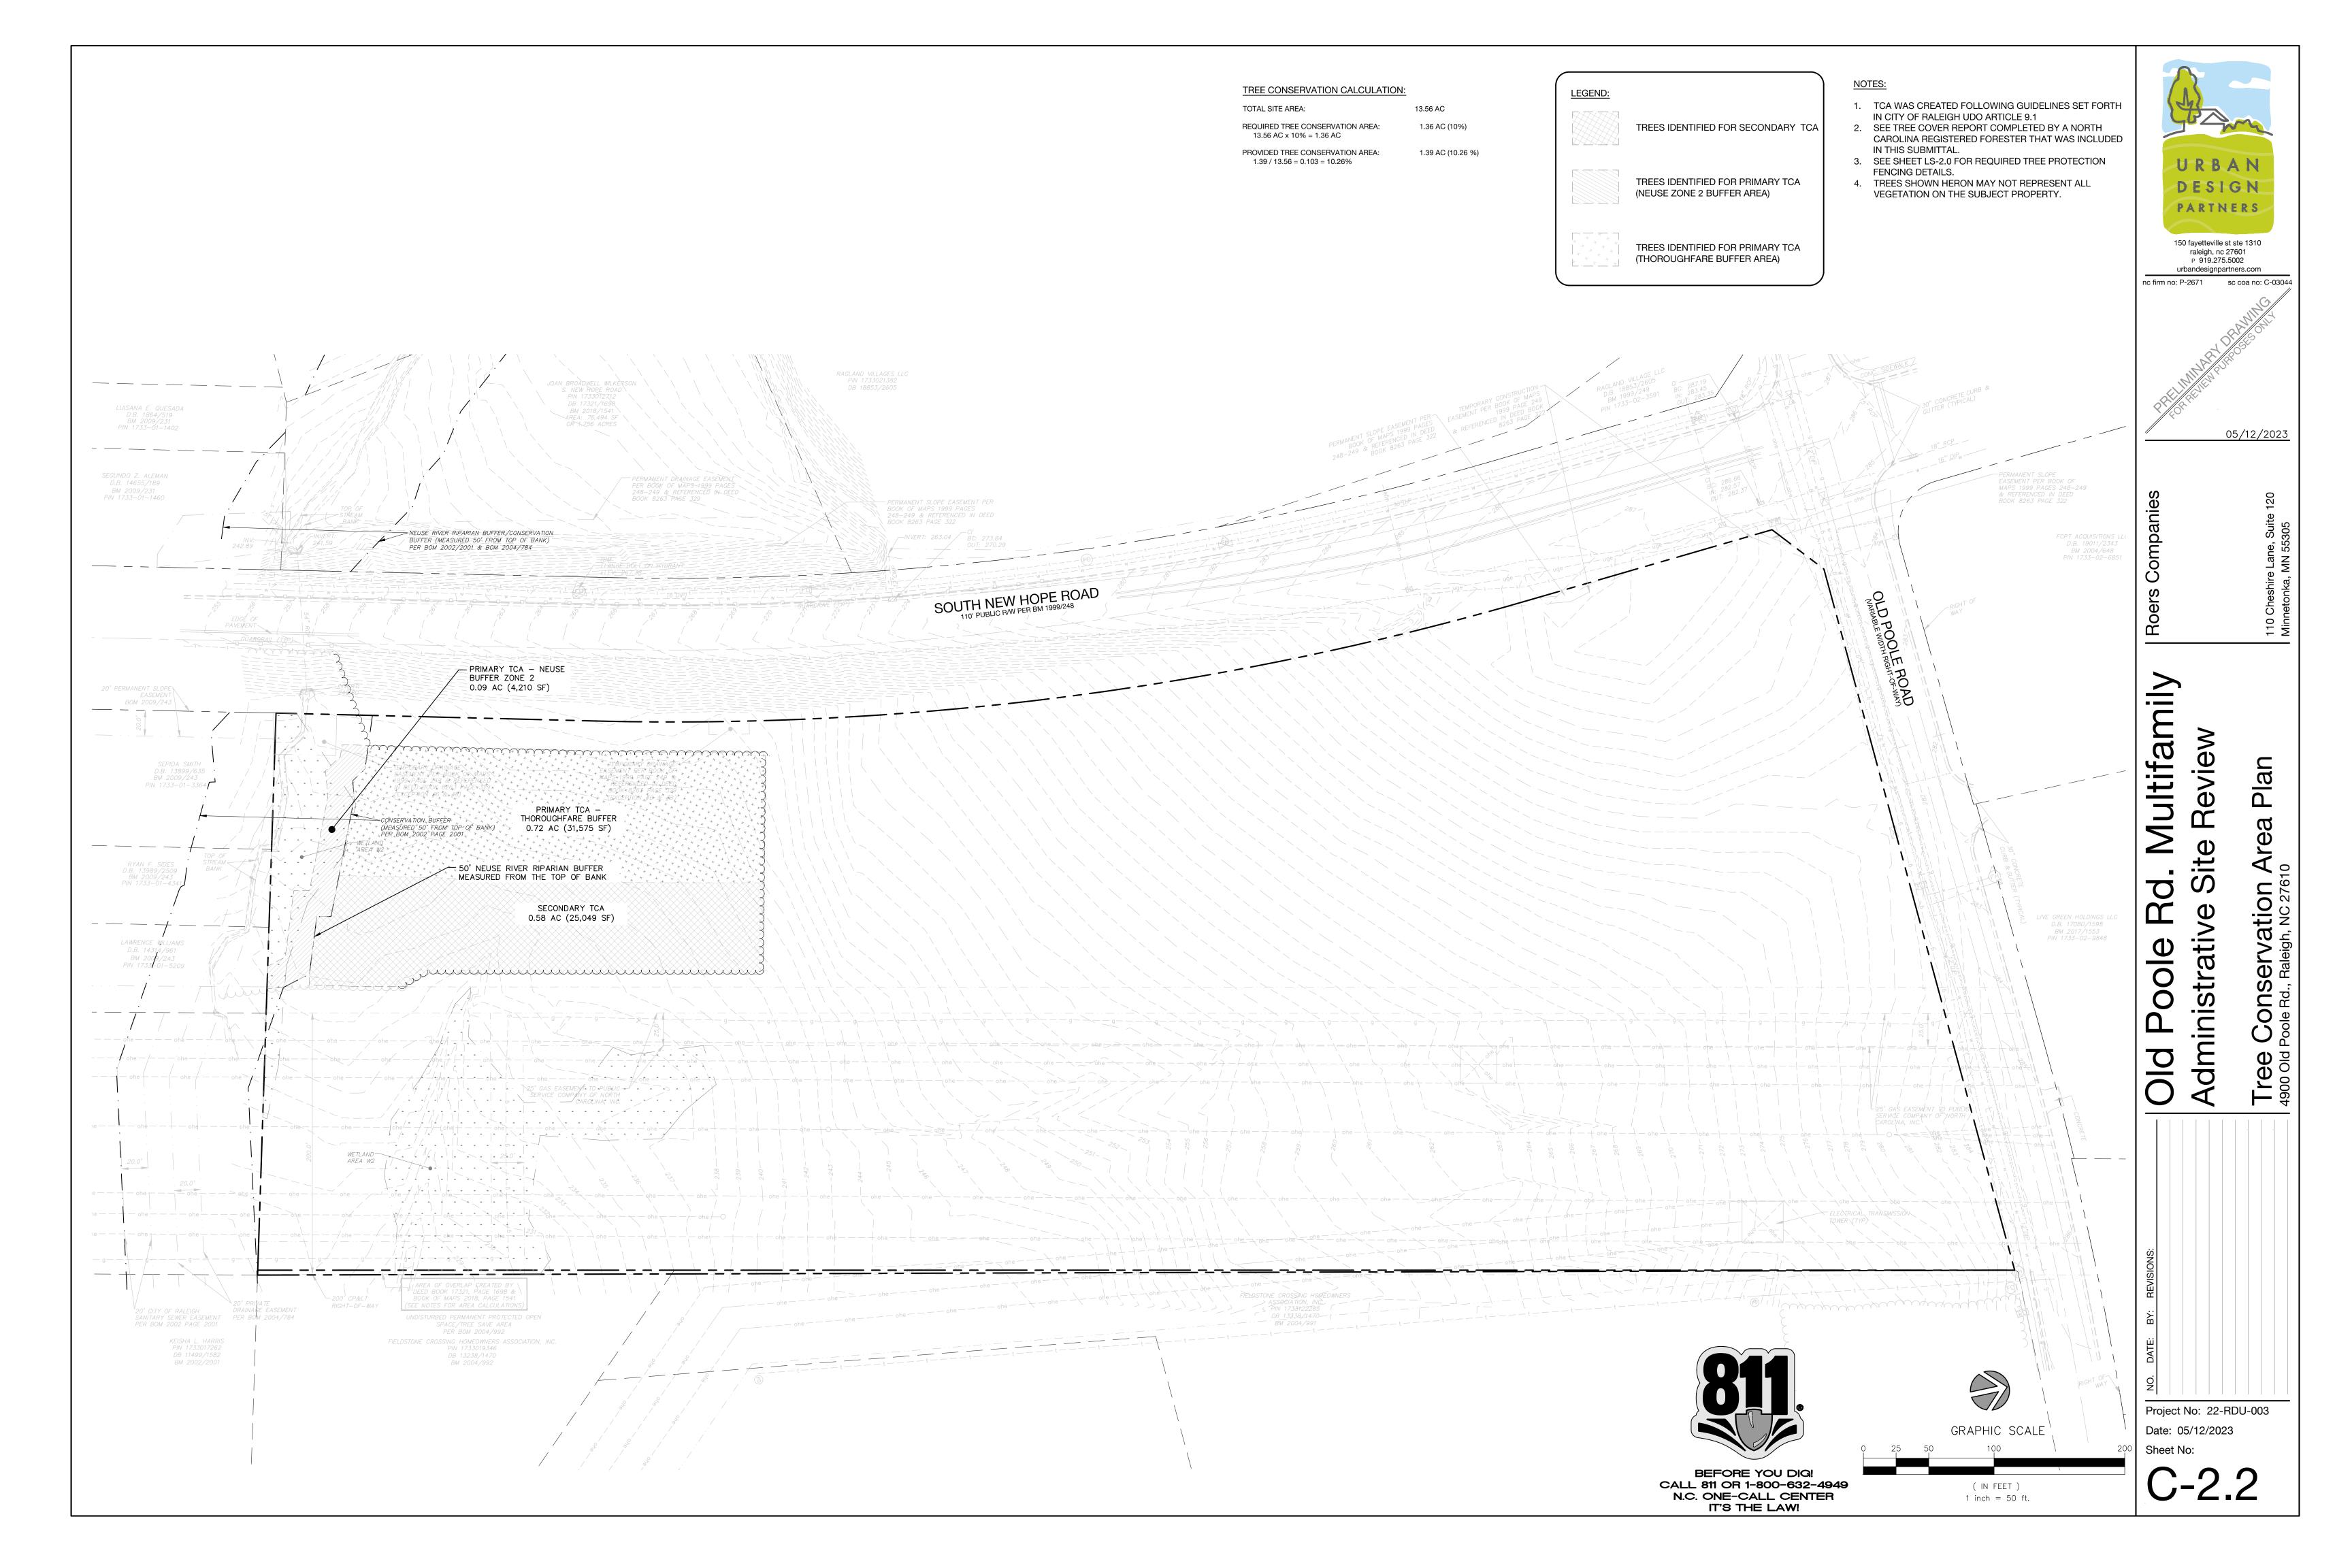
ultifamily


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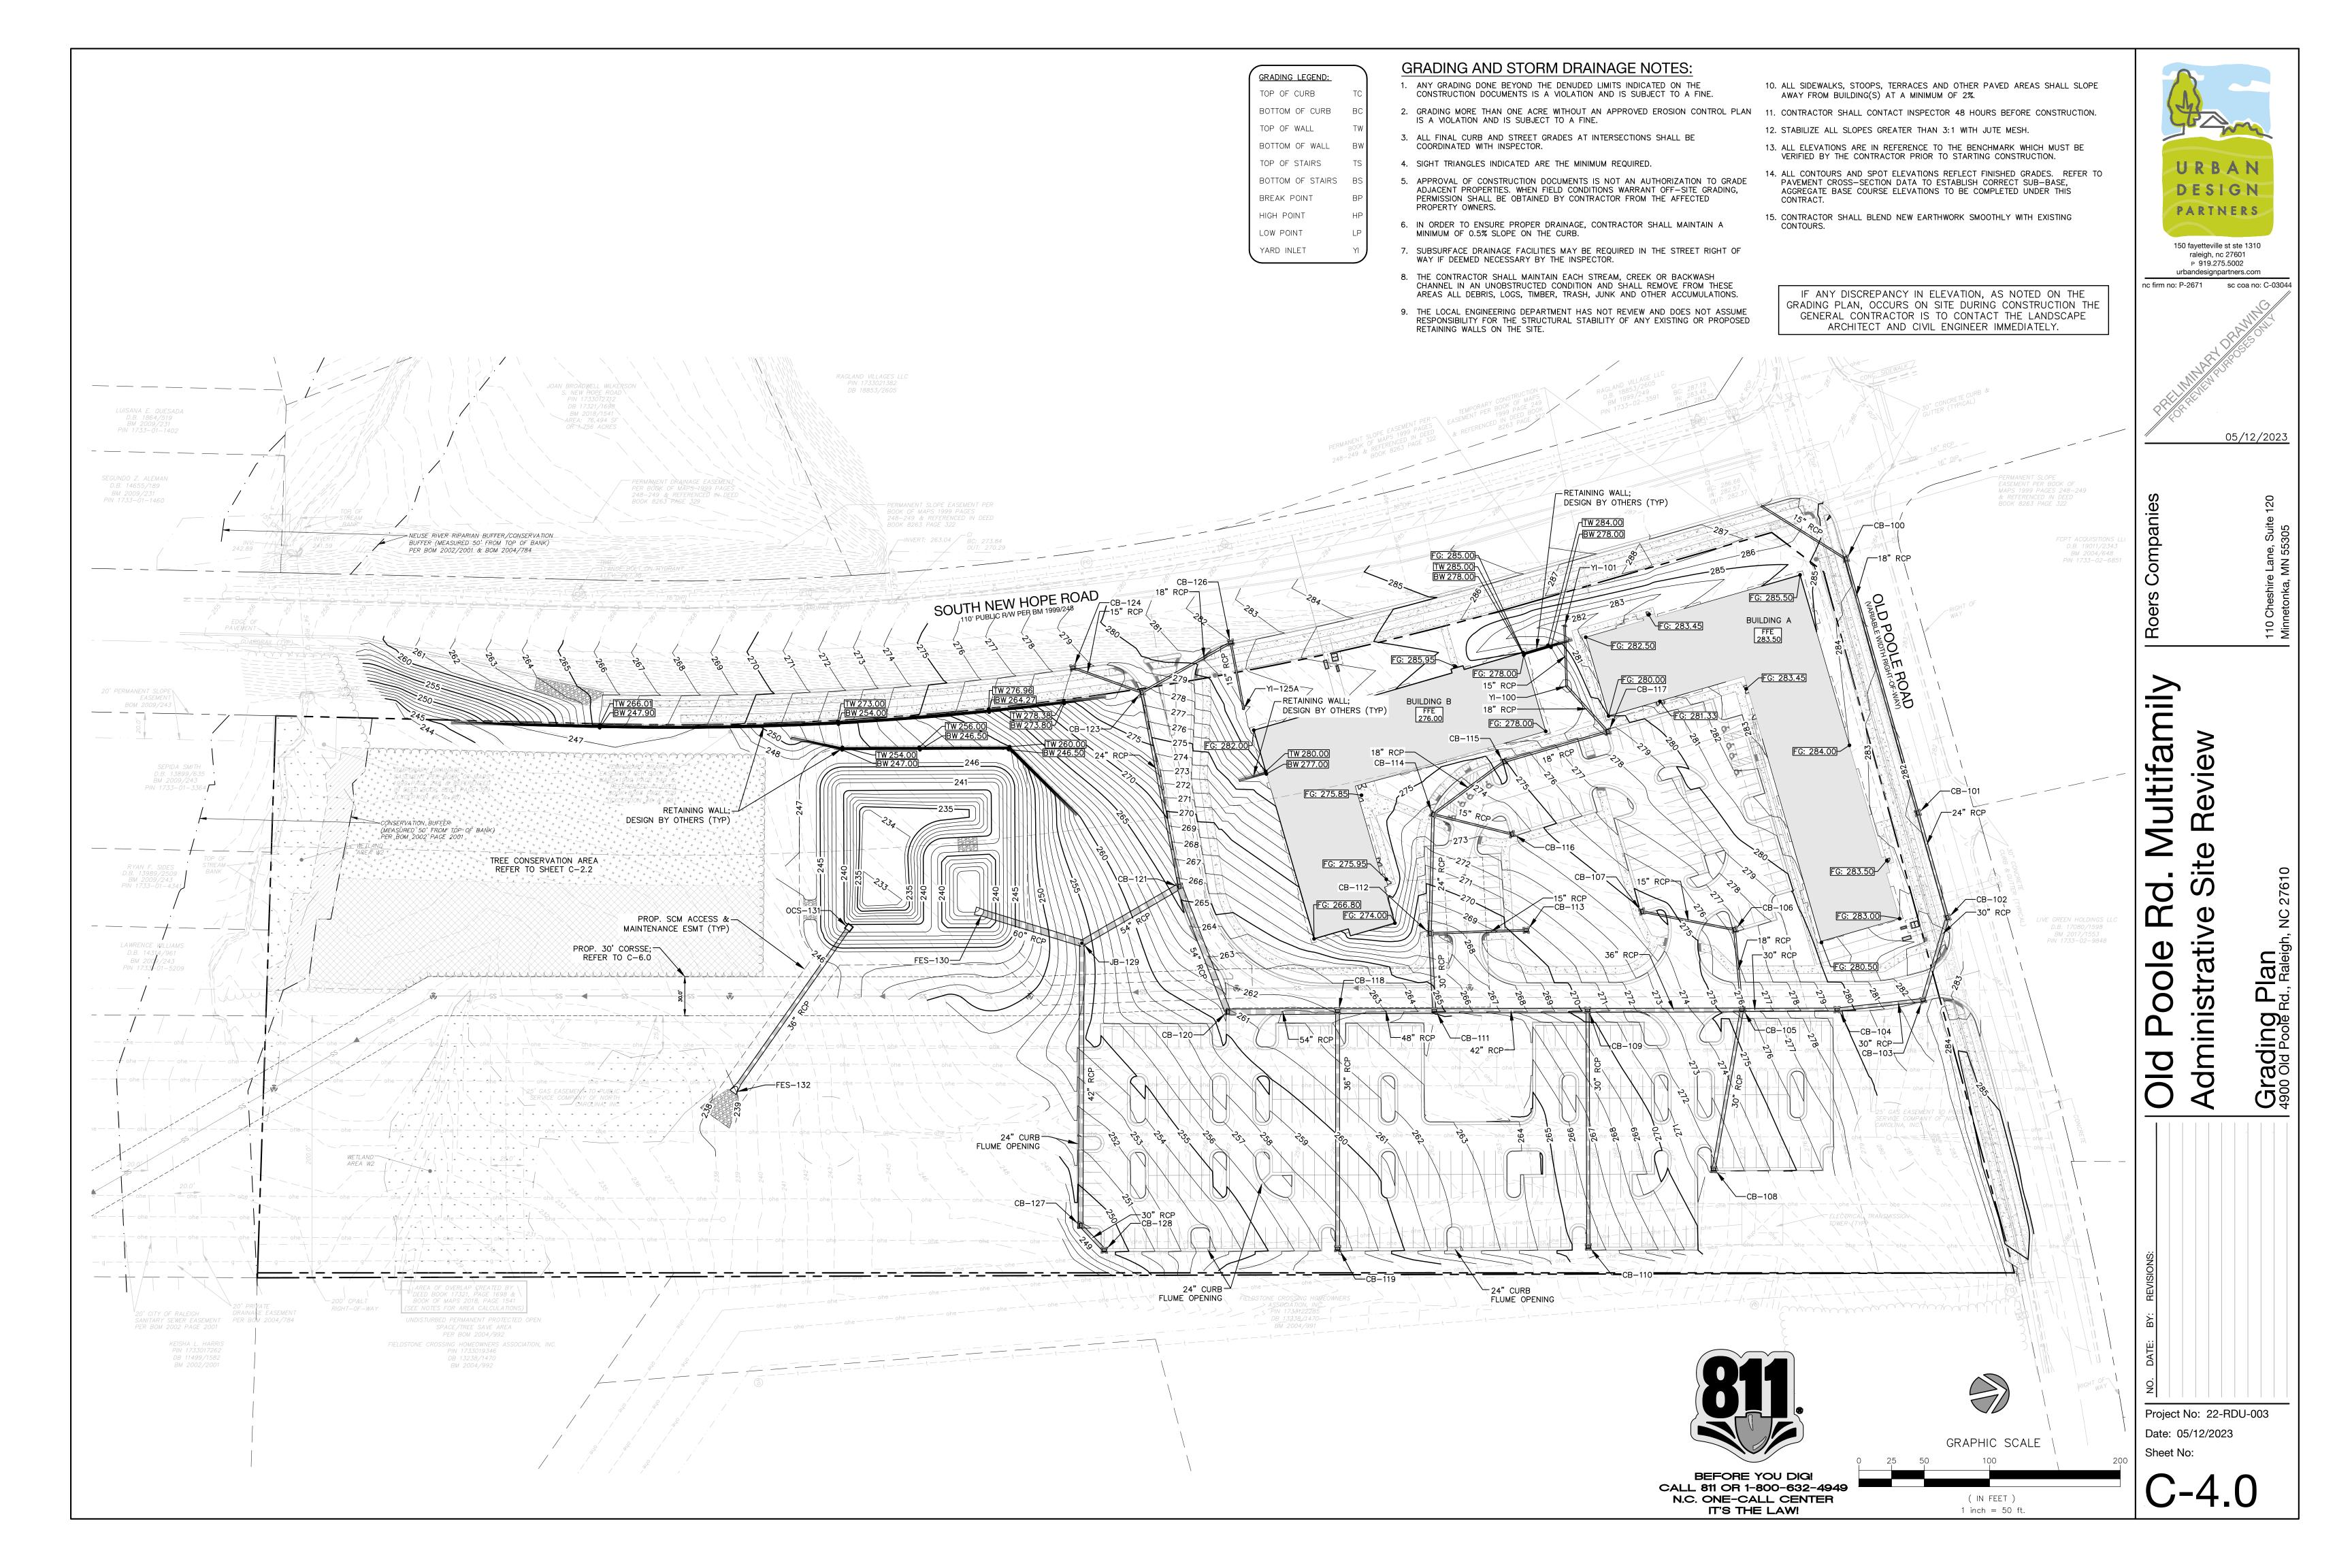
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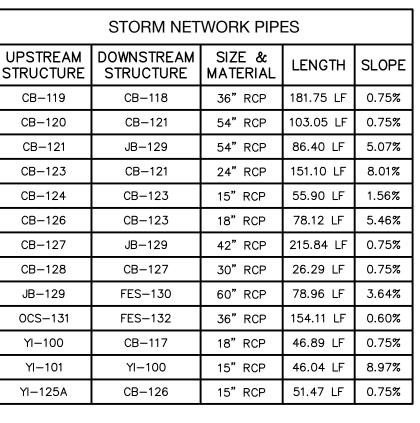


STORM NETWORK STRUCTURES		
STRUCTURE ID	STRUCTURE DETAILS	
CB-100	RIM: 283.93 INV IN: 278.93 () INV OUT: 278.43 (CB-101)	
CB-101	RIM: 281.41 INV IN: 275.91 (CB-100) INV OUT: 274.91 (CB-102)	
CB-102	RIM: 282.33 INV IN: 274.28 (CB-101) INV OUT: 274.28 (CB-103)	
CB-103	RIM: 282.26 INV IN: 273.79 (CB-102) INV OUT: 273.79 (CB-104)	
CB-104	RIM: 279.35 INV IN: 271.85 (CB-103) INV OUT: 271.35 (CB-105)	
CB-105	RIM: 275.86 INV IN: 267.86 (CB-104) INV IN: 268.10 (CB-106) INV IN: 265.91 (CB-108) INV OUT: 265.91 (CB-109)	
CB-106	RIM: 276.70 INV IN: 268.57 (CB-107) INV OUT: 268.57 (CB-105)	
CB-107	RIM: 274.36 INV OUT: 269.11 (CB-106)	
CB-108	RIM: 271.84 INV OUT: 266.84 (CB-105)	
CB-109	RIM: 270.22 INV IN: 261.22 (CB-105) INV IN: 259.01 (CB-110) INV OUT: 259.01 (CB-111)	
CB-110	RIM: 265.37 INV OUT: 260.37 (CB-109)	
CB-111	RIM: 264.61 INV IN: 255.61 (CB-109) INV IN: 256.61 (CB-112) INV OUT: 255.61 (CB-118)	
CB-112	RIM: 267.31 INV IN: 259.81 (CB-114) INV IN: 262.31 (CB-113) INV OUT: 259.31 (CB-111)	
CB-113	RIM: 270.68 INV OUT: 265.68 (CB-112)	
CB-114	RIM: 273.36 INV IN: 267.36 (CB-115) INV IN: 267.34 (CB-116) INV OUT: 265.86 (CB-112)	
CB-115	RIM: 274.94 INV IN: 268.94 (CB-117) INV OUT: 268.94 (CB-114)	
CB-116	RIM: 273.31 INV OUT: 267.81 (CB-114)	
CB-117	RIM: 278.65 INV IN: 270.93 (YI-100) INV OUT: 270.93 (CB-115)	
CB-118	RIM: 262.06 INV IN: 253.06 (CB-111) INV IN: 250.60 (CB-119) INV OUT: 250.60 (CB-120)	
CB-119	RIM: 257.47 INV OUT: 251.97 (CB-118)	

STORM NETWORK STRUCTURES	
STRUCTURE ID	STRUCTURE DETAILS
CB-120	RIM: 260.88 INV IN: 249.97 (CB-118) INV OUT: 249.97 (CB-121)
CB-121	RIM: 265.58 INV IN: 249.20 (CB-120) INV IN: 259.08 (CB-123) INV OUT: 249.20 (JB-129)
CB-123	RIM: 277.69 INV IN: 271.69 (CB-126) INV IN: 272.69 (CB-124) INV OUT: 271.19 (CB-121)
CB-124	RIM: 278.56 INV OUT: 273.56 (CB-123)
CB-126	RIM: 281.96 INV IN: 276.48 (YI-125A) INV OUT: 275.96 (CB-123)
CB-127	RIM: 248.91 INV IN: 241.88 (CB-128) INV OUT: 240.91 (JB-129)
CB-128	RIM: 249.08 INV OUT: 242.08 (CB-127)
FES-130	RIM: 242.00 INV IN: 236.42 (JB-129)
FES-132	RIM: -1.34 INV IN: -4.76 (OCS-131)
JB-129	RIM: 250.78 INV IN: 244.82 (CB-121) INV IN: 239.29 (CB-127) INV OUT: 239.29 (FES-130)
0CS-131	RIM: 240.39 INV OUT: -3.83 (FES-132)
YI-100	RIM: 276.78 INV IN: 271.78 (YI-101) INV OUT: 271.28 (CB-117)
YI-101	RIM: 280.91 INV OUT: 275.91 (YI-100)
YI-125A	RIM: 281.86 INV OUT: 276.86 (CB-126)

STORM NETWORK PIPES				
UPSTREAM STRUCTURE	DOWNSTREAM STRUCTURE	SIZE & MATERIAL	LENGTH	SLOPE
	CB-100	15" RCP	76.72 LF	2.75%
CB-100	CB-101	18" RCP	202.03 LF	1.25%
CB-101	CB-102	24" RCP	83.26 LF	0.75%
CB-102	CB-103	30" RCP	65.78 LF	0.75%
CB-103	CB-104	30" RCP	66.30 LF	2.93%
CB-104	CB-105	30" RCP	72.82 LF	4.78%
CB-105	CB-109	36" RCP	118.09 LF	3.98%
CB-106	CB-105	18" RCP	61.63 LF	0.75%
CB-107	CB-106	15" RCP	72.08 LF	0.75%
CB-108	CB-105	30" RCP	123.93 LF	0.75%
CB-109	CB-111	42" RCP	117.32 LF	2.90%
CB-110	CB-109	30" RCP	181.05 LF	0.75%
CB-111	CB-118	48" RCP	74.06 LF	3.45%
CB-112	CB-111	30" RCP	59.34 LF	4.54%
CB-113	CB-112	15" RCP	73.64 LF	4.57%
CB-114	CB-112	24" RCP	91.16 LF	6.63%
CB-115	CB-114	18" RCP	67.73 LF	2.34%
CB-116	CB-114	15" RCP	62.22 LF	0.75%
CB-117	CB-115	18" RCP	82.47 LF	2.41%
CB-118	CB-120	54" RCP	83.97 LF	0.75%

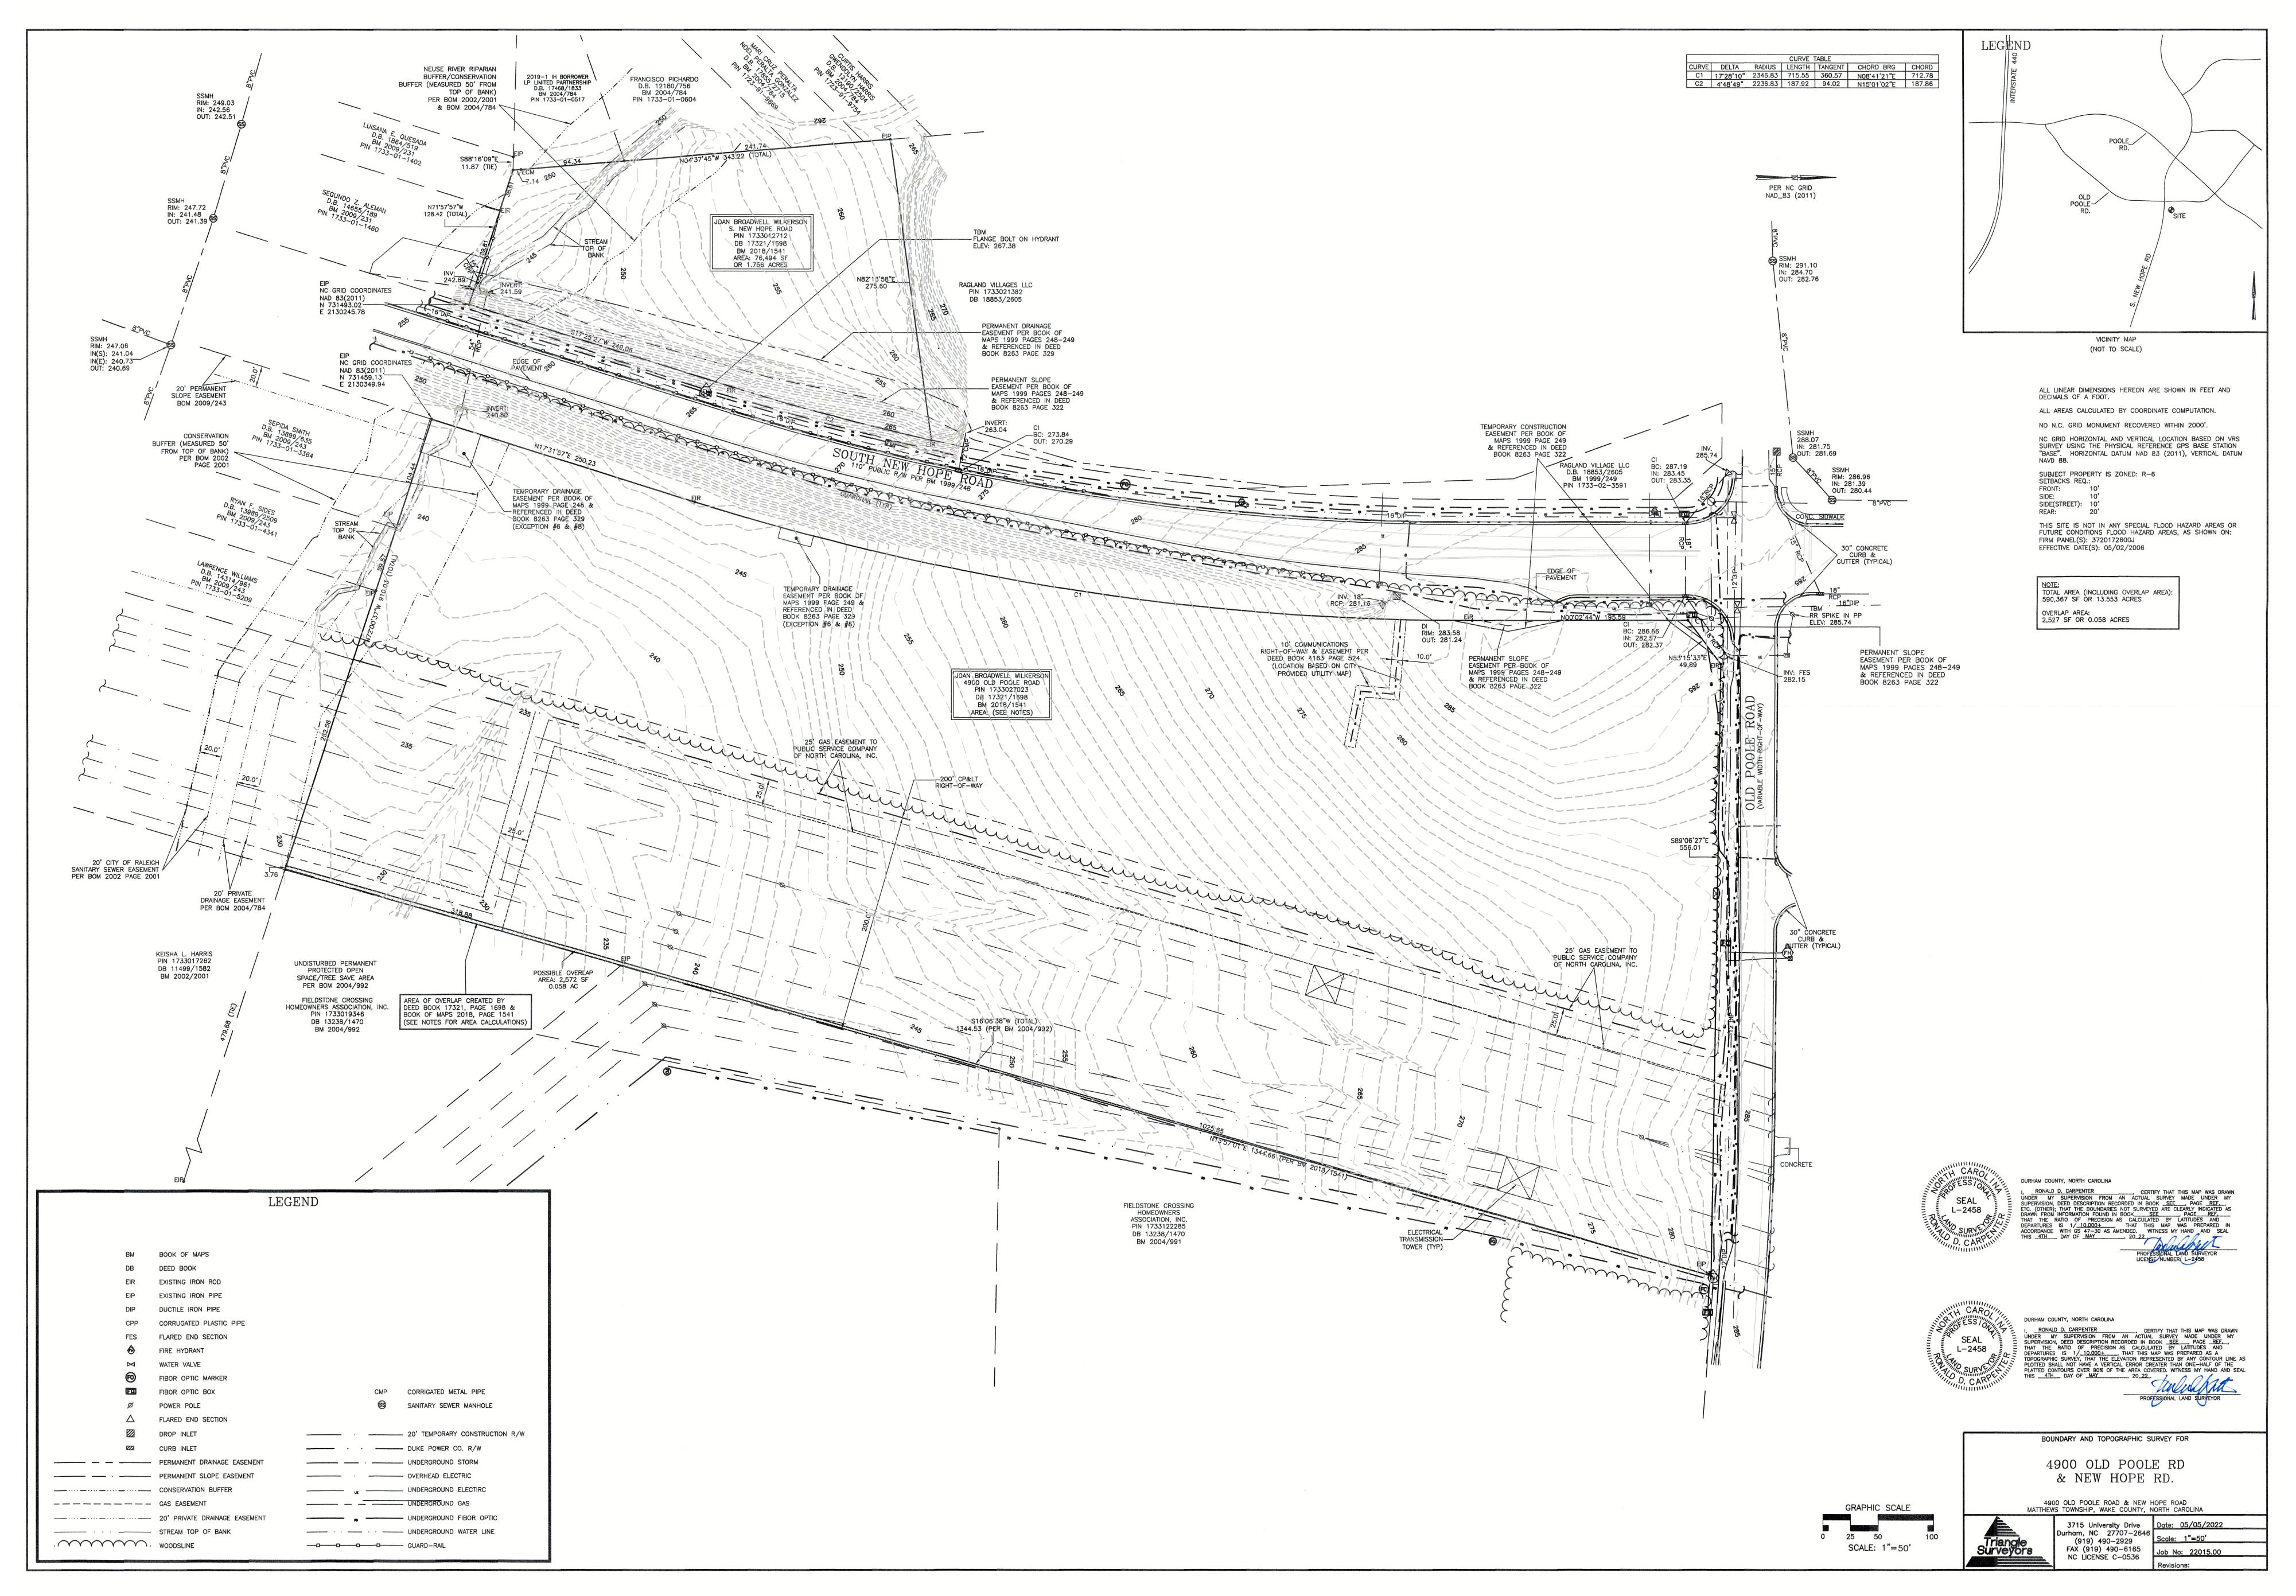	STORM NET	WORK PIPI	ES	
UPSTREAM STRUCTURE	DOWNSTREAM STRUCTURE	SIZE & MATERIAL	LENGTH	SLO
CB-119	CB-118	36" RCP	181.75 LF	0.7
CB-120	CB-121	54" RCP	103.05 LF	0.7
CB-121	JB-129	54" RCP	86.40 LF	5.0
CB-123	CB-121	24" RCP	151.10 LF	8.0
CB-124	CB-123	15" RCP	55.90 LF	1.5
CB-126	CB-123	18" RCP	78.12 LF	5.4
CB-127	JB-129	42" RCP	215.84 LF	0.7
CB-128	CB-127	30" RCP	26.29 LF	0.7
JB-129	FES-130	60" RCP	78.96 LF	3.6
OCS-131	FES-132	36" RCP	154.11 LF	0.6
YI-100	CB-117	18" RCP	46.89 LF	0.7
YI-101	YI-100	15" RCP	46.04 LF	8.9
YI-125A	CB-126	15" RCP	51.47 LF	0.7

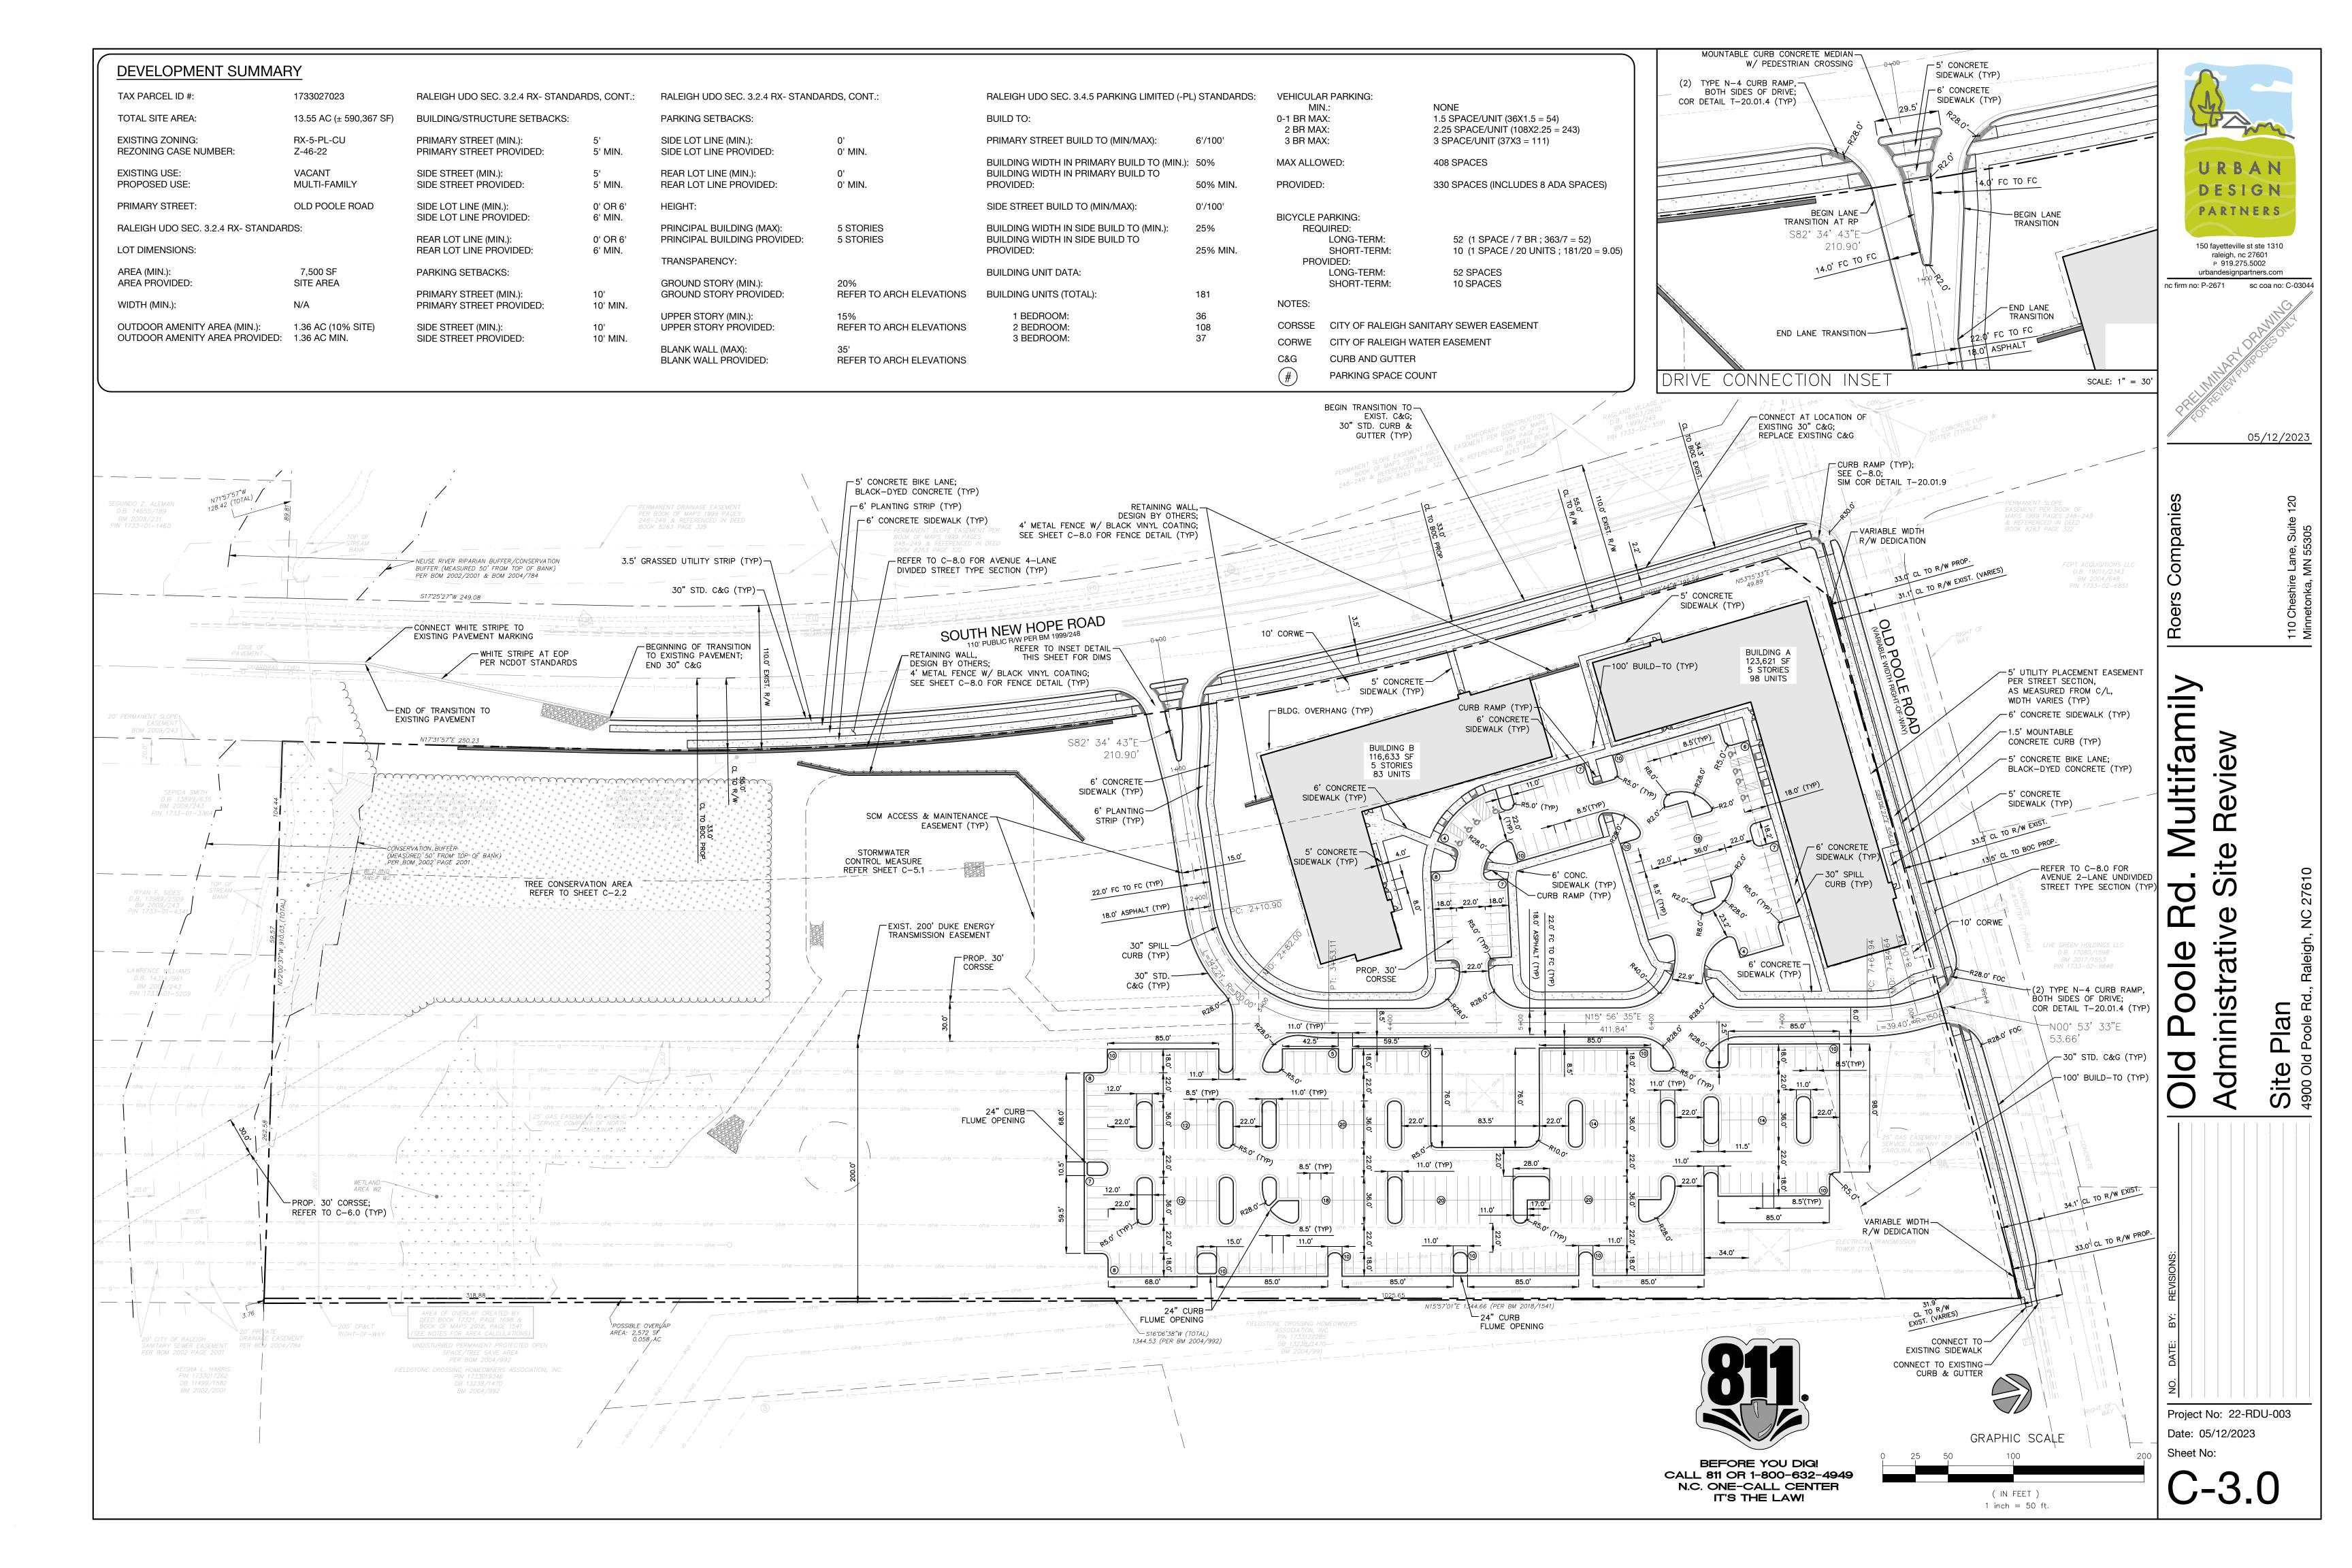



Multifamily

Rd

Poole

<u>PO</u>

Administrative


acture

Storm Drainage Infrastru 4900 Old Poole Rd., Raleigh, NC 27610

BEFORE YOU DIG! CALL 811 OR 1-800-632-4949 N.C. ONE-CALL CENTER IT'S THE LAW!

Project No: 22-RDU-003 Date: 05/12/2023 Sheet No:

C-4.1

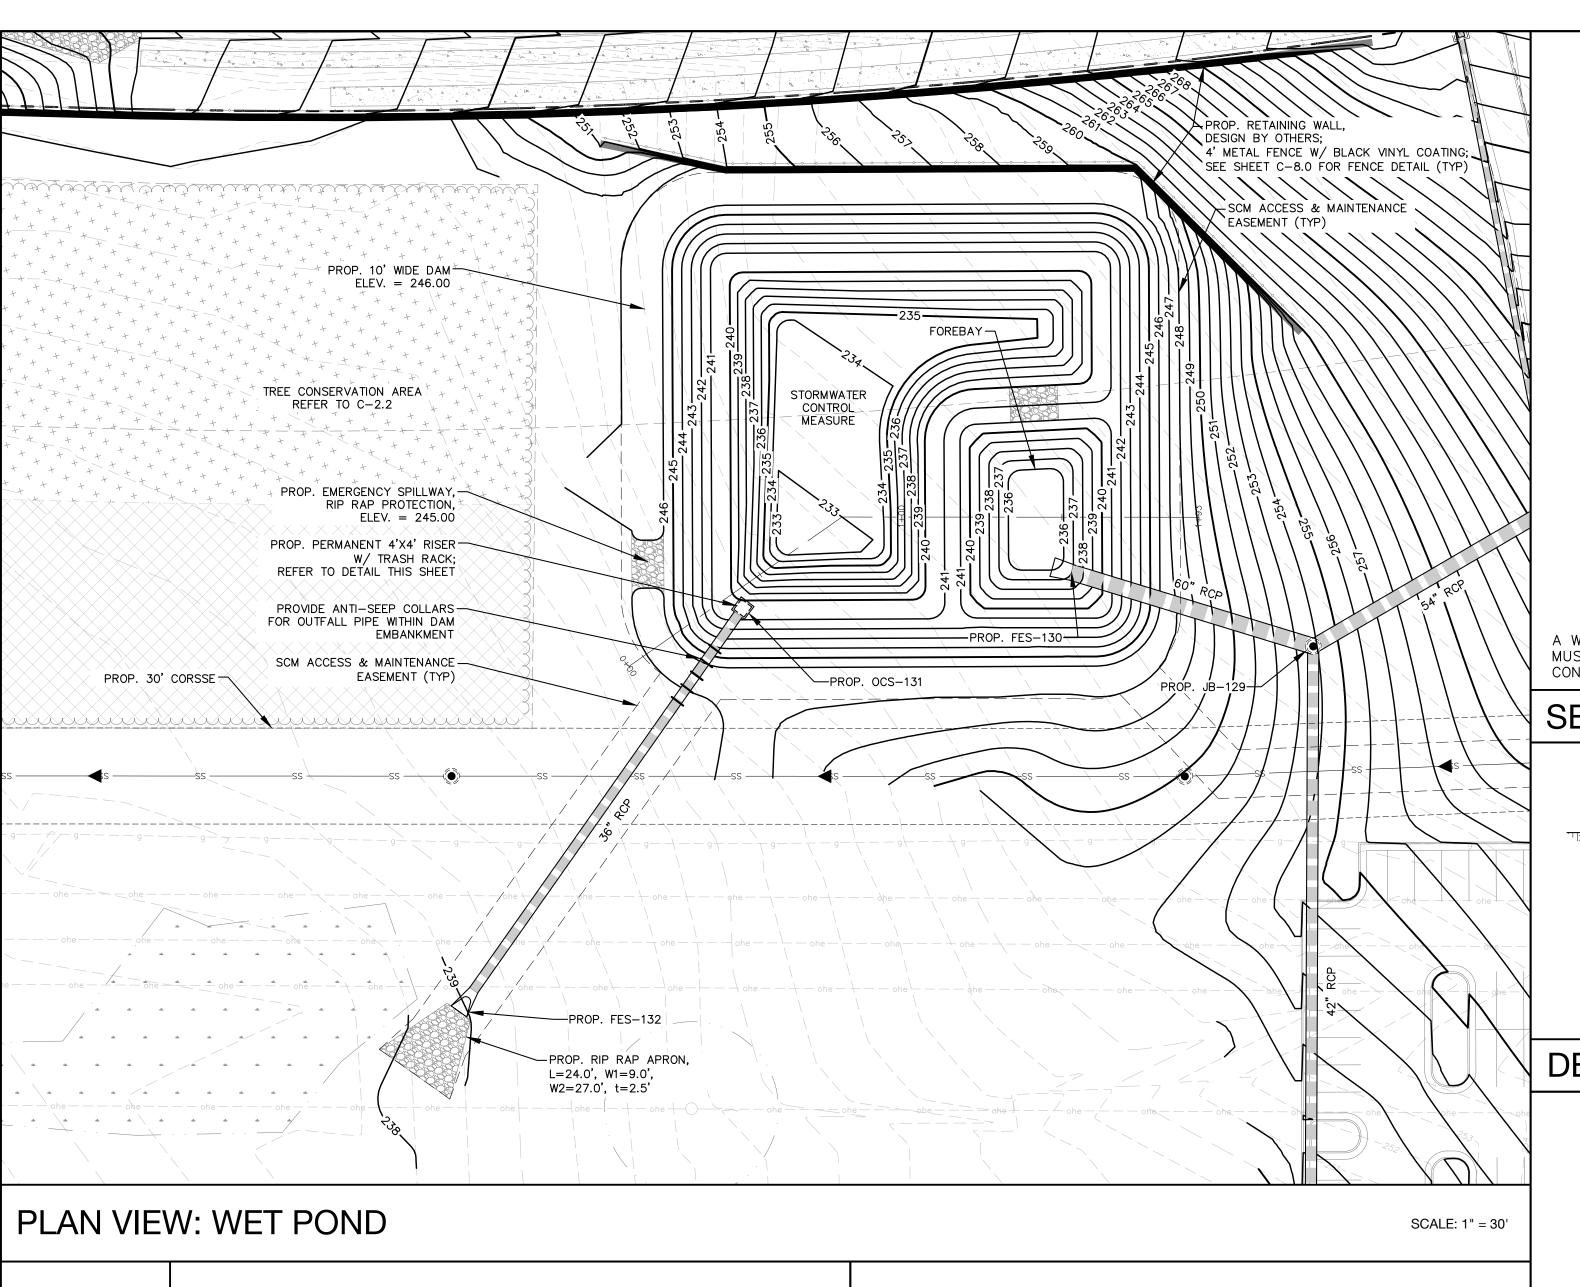

FACE OF OUTLET — STRUCTURE

1'-0"

6"ø PVC CAP⊸

DETAIL: WATER QUALITY ORIFICE SCALE: NTS

W/ 2.0"ø HOLE (WQv ORIFICE)

6"ø PVC-ELBOW

PERMANENT POOL

ELEVATION: 240.50 =

ELEVATION: 239.50


GRATE TOP: 244.50 100-YEAR WSE: 244.21 10-YEAR WSE: 243.42 2-YEAR WSE: 242.65 4'x4' CONCRETE OUTLET STRUCTURE (6" WALL THICKNESS) 1-YEAR WSE: 241.64 PERMANENT POOL ELEV: 240.50 WATER QUALITY ORIFICE: 240.50 36" RCP OUTLET: 240.50 6"ø PVC CAP W/2"ø HOLE (REFER TO DETAIL) ANTI-FLOTATION CONCRETE PAD 6.0'Wx6.0'Lx1.50'D POND BOTTOM ELEV: 233.00

A WATER-TIGHT SEAL (RUBBER BOOT OR EQUIVALENT) MUST BE PROVIDED BETWEEN ALL RISER AND PIPE JOINT CONNECTIONS TO MINIMIZE LEAKAGE

SECTION VIEW: OUTLET CONTROL STRUCTURE

TOP OF WET POND DAM ELEVATION: 246.00' 15.00' SPILLWAY ELEV: 245.00

DETAIL: SPILLWAY

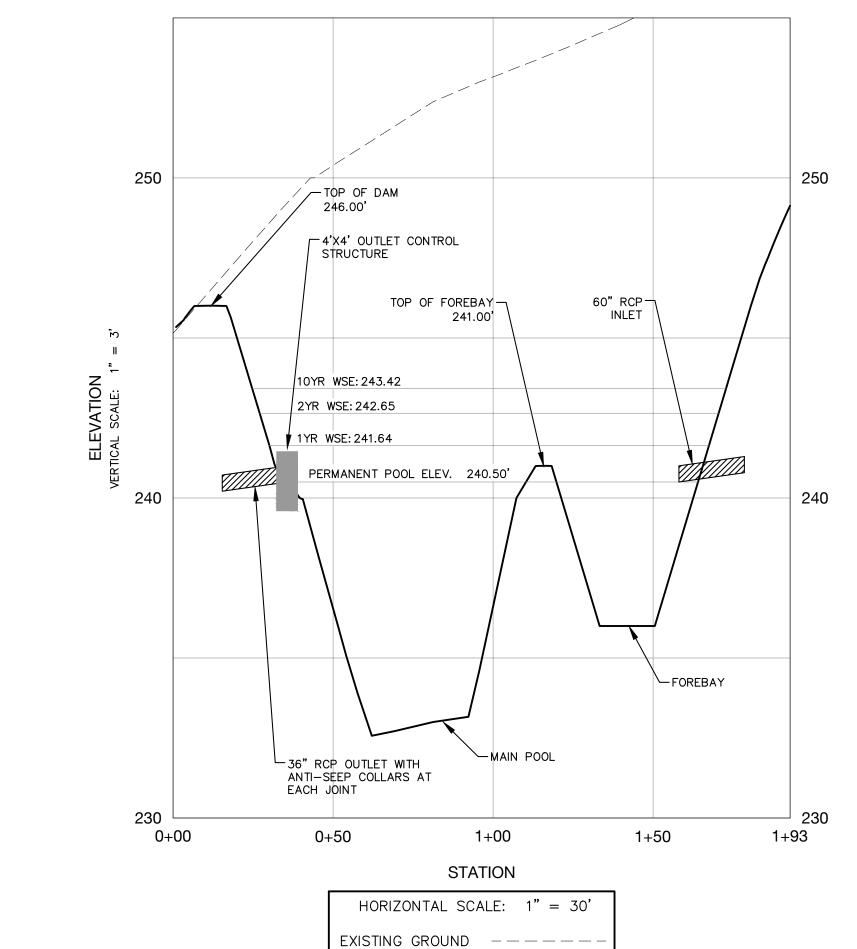

PROPOSED GRADE ----

SECTION: WET POND

BMP INSET TABLE - WET POND

<u>SITE INFORMATION</u> DRAINAGE AREA:

SCALE: NTS

TOP OF POND: 246.00

DRAINAGE AREA TOTAL IMPERVIOUS AREA: 5.35 AC DRAINAGE AREA IMPERVIOUS RATIO: 55.1% SITE IMPERVIOUS AREA: 5.00 AC DESIGN RAINFALL: 1-INCH 0.612 STORAGE VOLUMES SURFACE AREA: 9,487 @ PPE PERMANENT POOL ELEV: 240.50 LITTORAL SHELF ELEV: 240.00 LITTORAL SHELF WIDTH: 6 FT LITTORAL SHELF SLOPE: 6:1 FOREBAY 1 SURFACE AREA: 2554 SF @ TOP **VOLUME REQUIRED:** 6,333 CF **VOLUME PROVIDED:** 6,654 CF 5 FT PERM. POOL AREA REQUIRED: 7,030 SF

9.69 AC

SURFACE AREA PROVIDED: 9,487 SF PERM POOL ELEV: 240.50 TOP OF POND: 246.00 BOTTOM OF MAIN POOL: 233.00 **OUTLET DIAMETER:** 15 INCH SPILLWAY ELEVATION: 245.00 SPILLWAY WIDTH: 15.00 FT

SITE AREA

DESCRIPTION

DITCHES, AND SLOPES

HIGH QUALITY WATER

SLOPES FLATTER THAN 4:1

PAR 150 fayette raleig P 91 urbandes	BAN SIGN TNERS eville st ste 1310 h, nc 27601 9.275.5002 ignpartners.com
nc firm no: P-2671	sc coa no: C-03044
PRE INTERES	05/12/2023
S	50

GROUND STABILIZATION STABILIZATION STABILIZATION TIME TIME FRAME FRAME EXCEPTIONS PERIMETER DIKES, SWALES, 7 DAYS NONE 7 DAYS NONE

ZONES)

(HQW) ZONES IF SLOPE ARE 10' OR LESS IN LENGTH AND ARE NOT STEEPER SLOPES STEEPER THAN 3:1 7 DAYS THAN 2:1, 14 DAYS ARE ALLOWED 7 DAYS FOR SLOPES SLOPES FLATTER THAN 3:1 14 DAYS **GREATER THAN 50** FEET IN LENGTH NONE (EXCEPT FOR ALL OTHER AREAS WITH PERIMETERS AND HQW 14 DAYS

EXTENSIONS OF TIME MAY BE APPROVED BY THE PERMITTING AUTHORITY BASED ON WEATHER OR OTHER SITE-SPECIFIC CONDITIONS THAT MAKE COMPLIANCE IMPRACTICABLE

For Shoulders, Side Ditches, Slopes (3:1 to 2:1): Sericea Lespedeza (scarified) 50 lbs/acre (Sericea Lespedeza); and use the following combinations: Or add Weeping Love grass 10 lbs/acre Mar 1- Or add Hulled Common Jun 30 Bermudagrass Tall Fescue AND Browntop 120 lbs/acre (Tall Fescue); 35 lbs/acre (Browntop Mullet); 30 lbs/acre (Sorghum-Sudan Hybrids) Mullet or Sorghum-Sudan Sericea Lespedeza (unhulled 70 lbs/acre (Sericea Lespedeza); 120 unscarified) AND Tall Ibs/acre (Tall Fescue) AND Abruzzi Rye 25 lbs/acre

Seeding Schedule For Shoulders, Side Ditches, Slopes (Max 3:1):			
Date	Туре	Planting Rate	
Aug 15- Nov 1	Tall Fescue	300 lbs/acre	
Nov 1– Mar 1	Tall Fescue & Abruzzi Rye	300 lbs/acre	
Mar 1– Apr 15	Tall Fescue	300 lbs/acre	
Apr 15– Jun 30	Hulled Common Bermudagrass	25 lbs/acre	
Jul 1– Aug 15	Tall Fescue AND Browntop Millet or Sorghum-Sudan Hybrids***	125 lbs/acre (Tall Fescue); 35 lbs/acre (Browntop Millet); 30 lbs/acre (Sorghum-Sudan Hybrids)	



Details sigh, NC 27610

Plan

BMP 4900 Old P

Project No: 22-RDU-003

Date: 05/12/2023 Sheet No:

C-5.1



3.0 FT.

1"X1" ALUMINUM GRATING AND $^{-1}$

HATCH TO BE DESIGNED AND CERTIFIED BY MANUFACTURER. CONTRACTOR TO SUBMIT SHOP DRAWINGS TO ENGINEER

FOR APPROVAL PRIOR TO

DETAIL: OCS GRATING

FABRICATION


└ 2-1/2" EDGE


 \rightarrow HINGE(S)


6" STAINLESS STEEL -


ANCHOR BOLT. EPOXY IN PLACE


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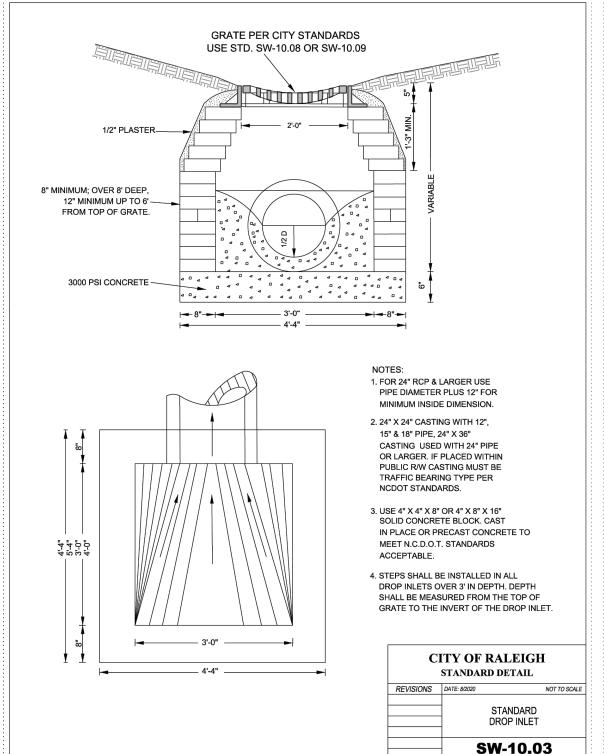


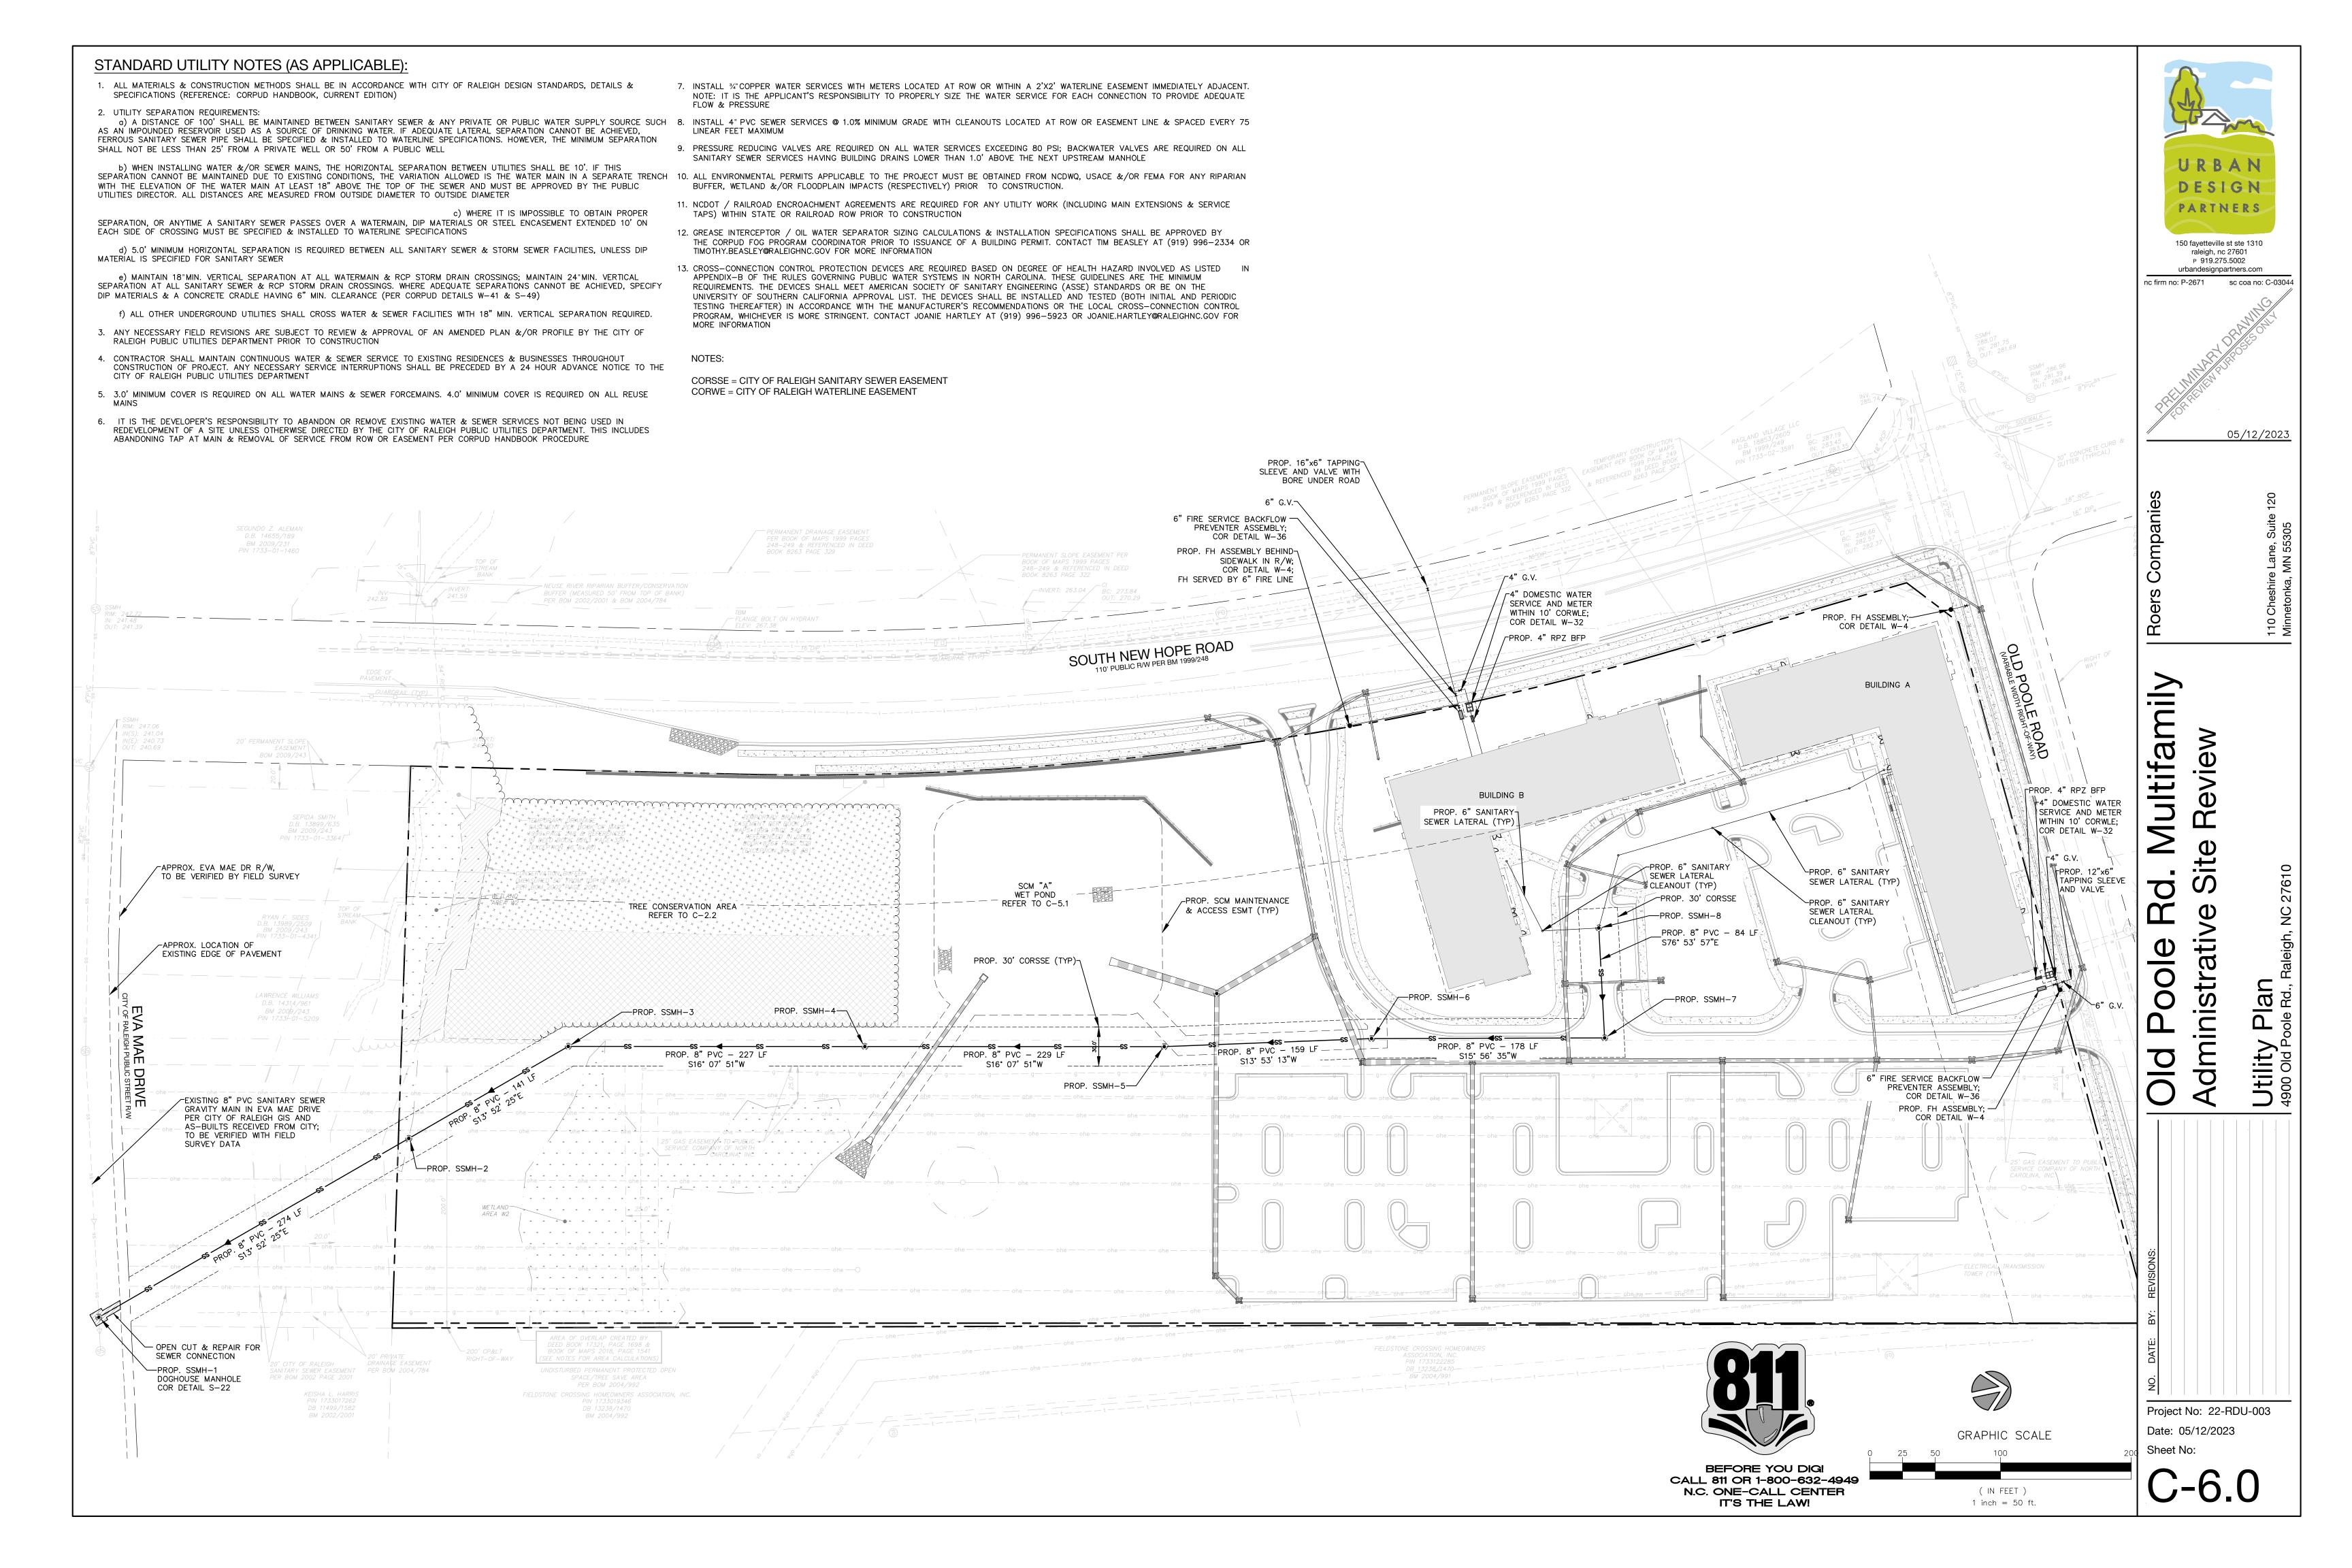


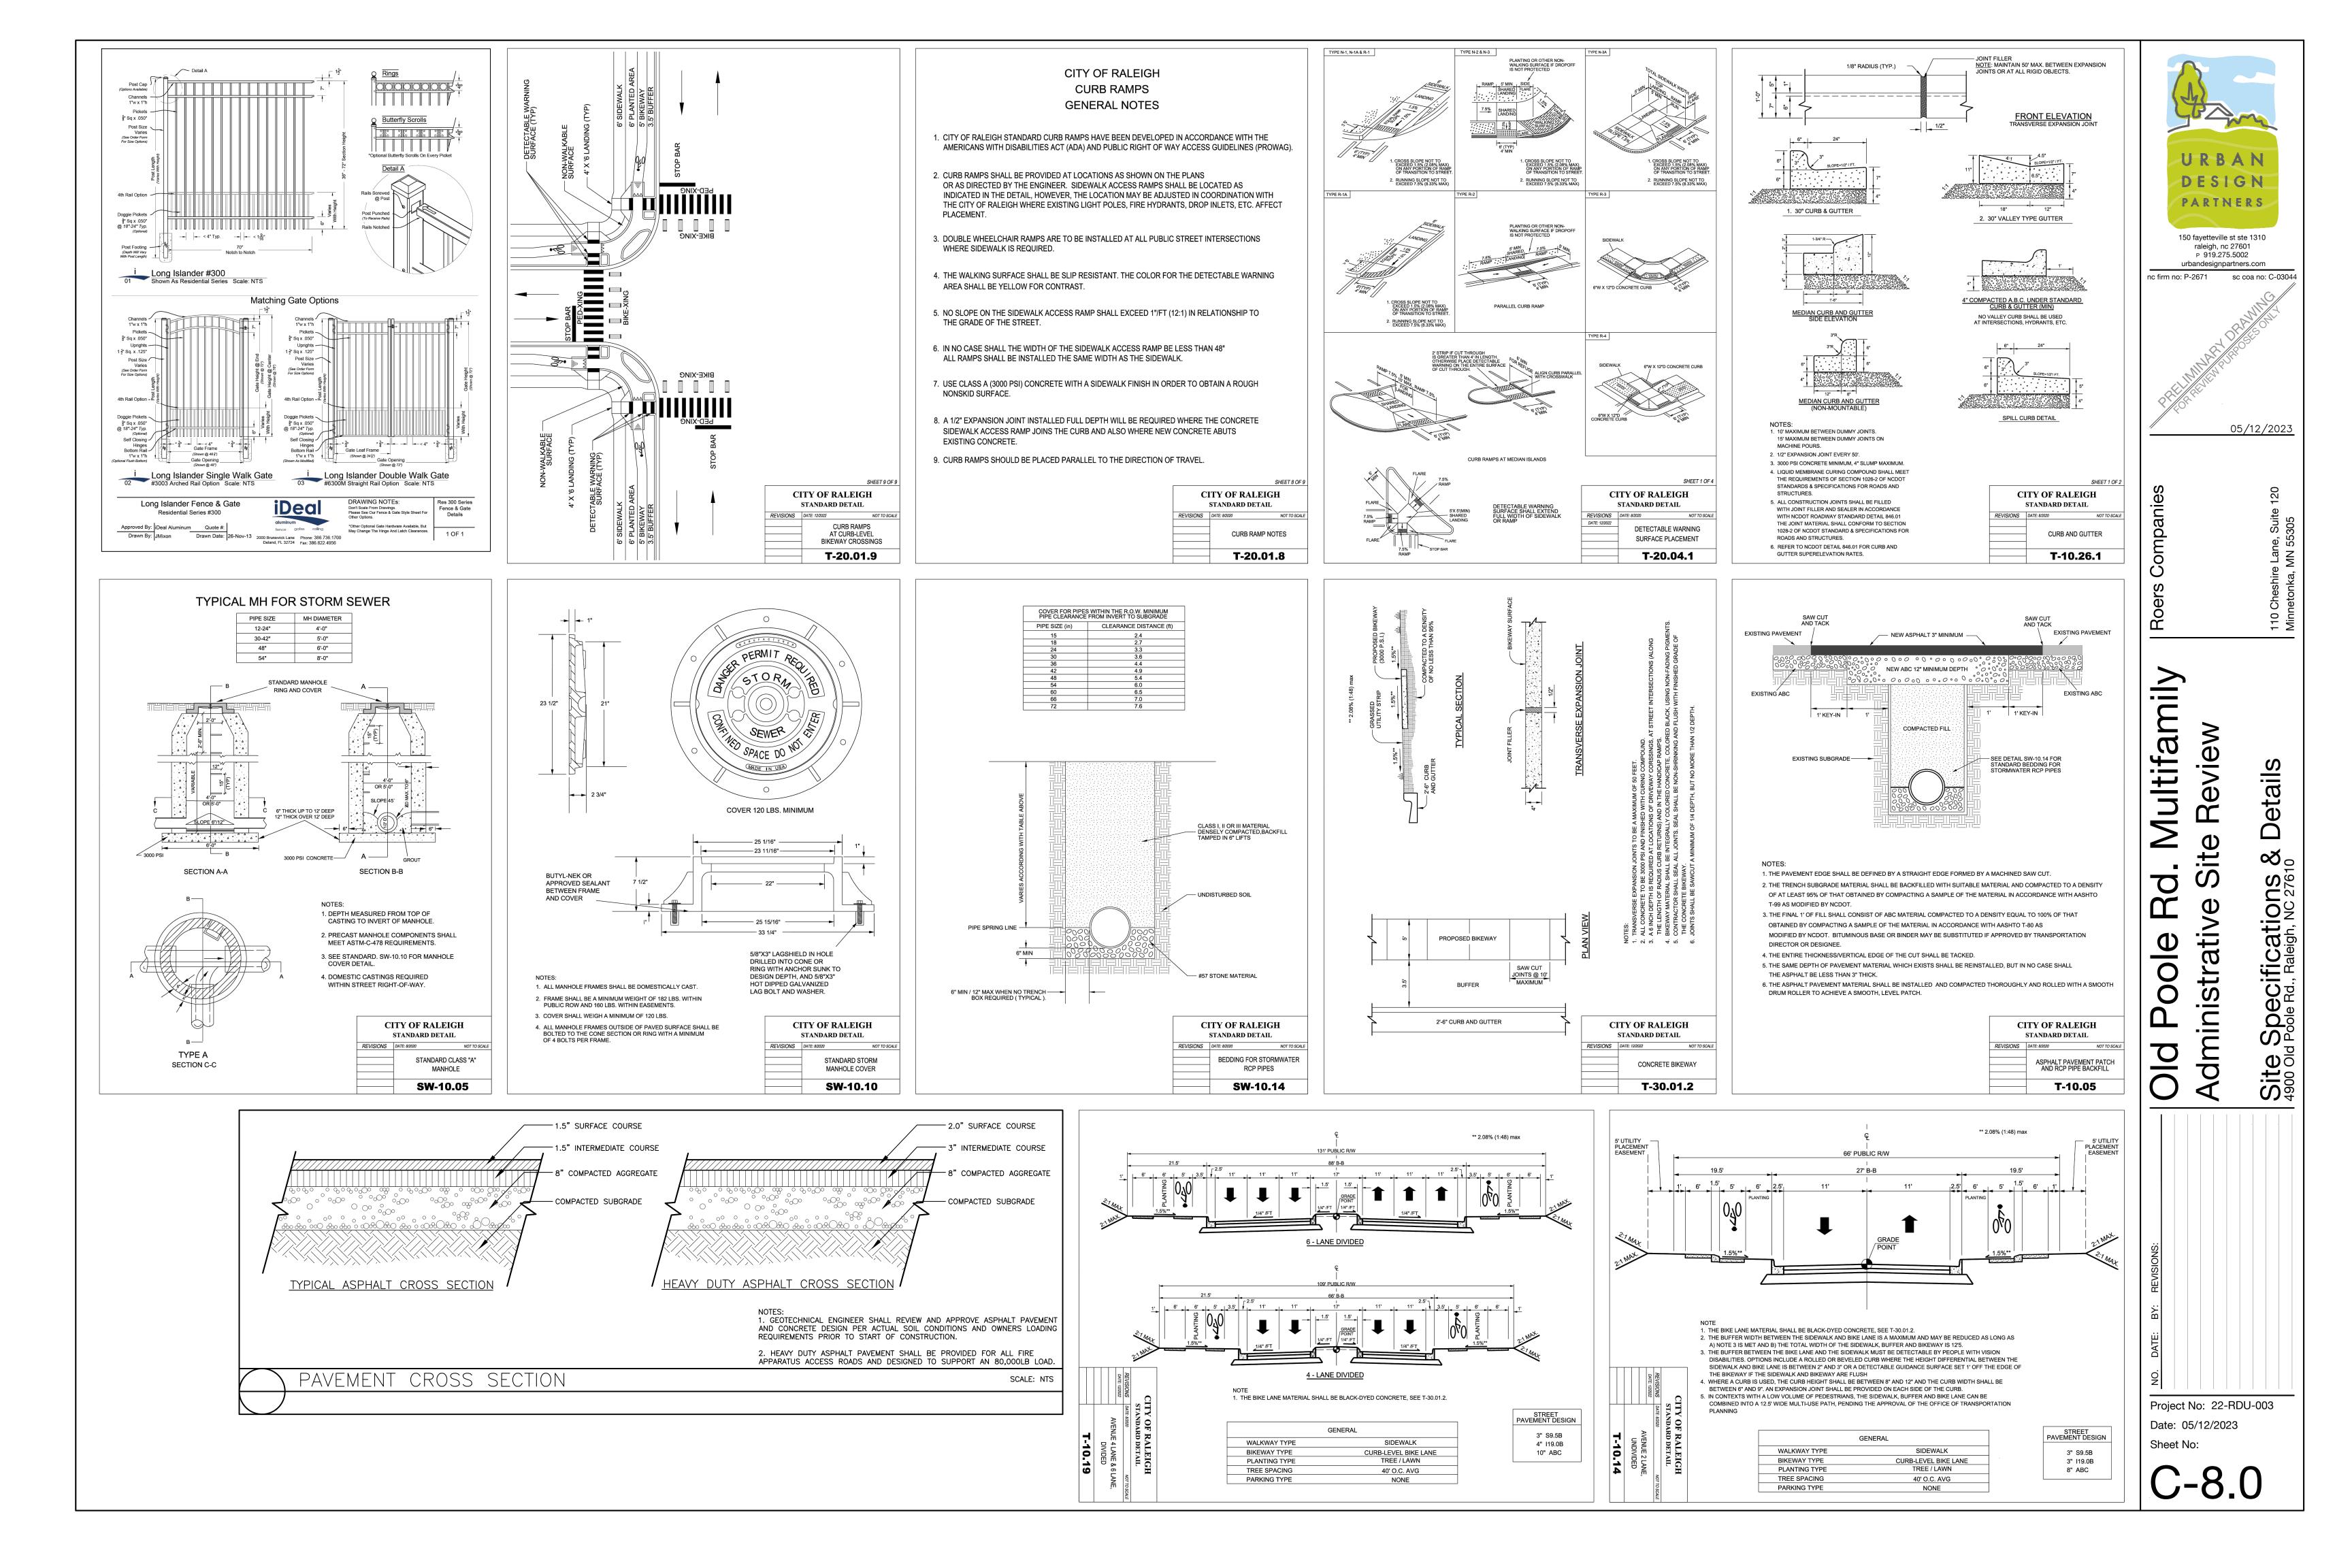


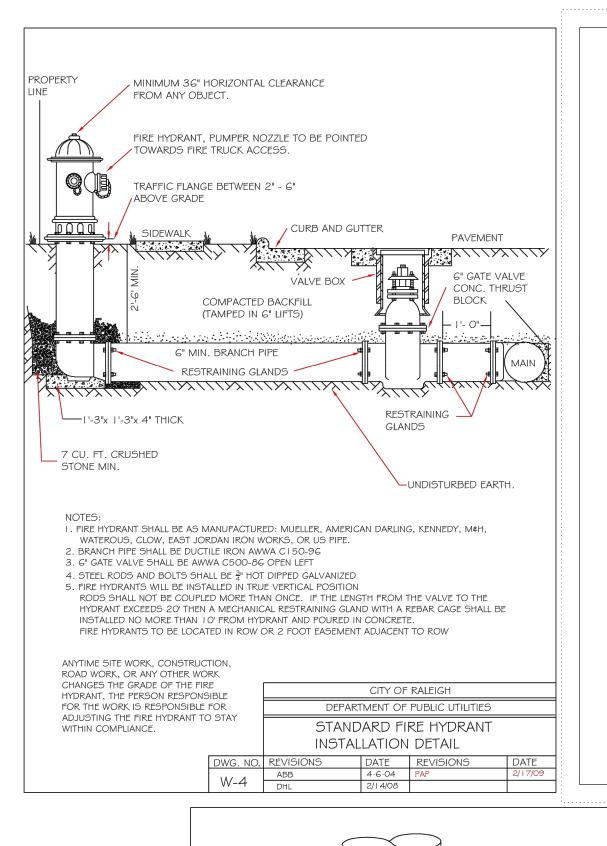


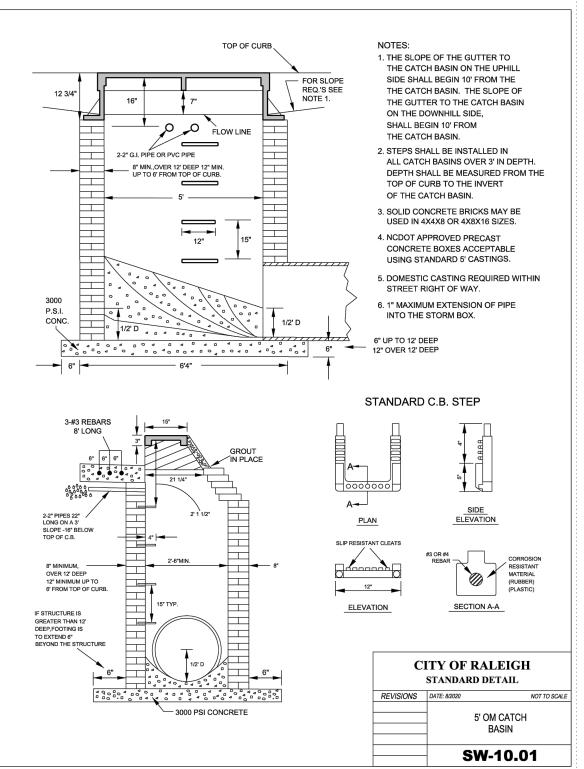


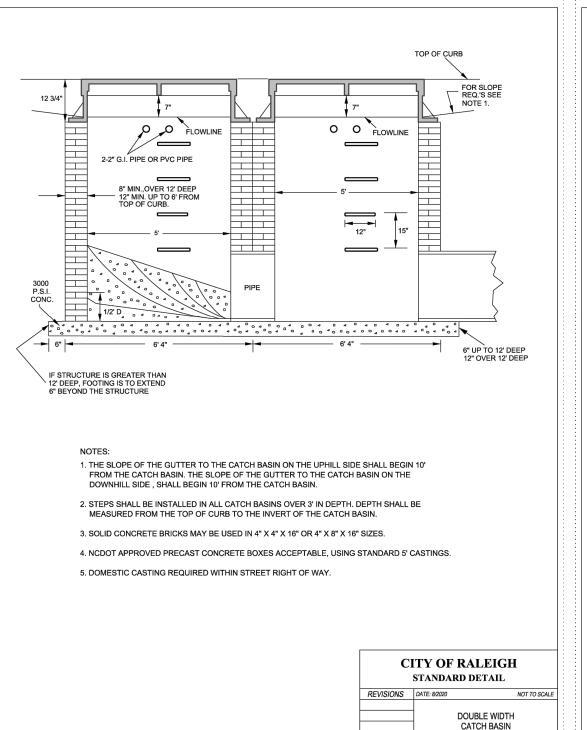

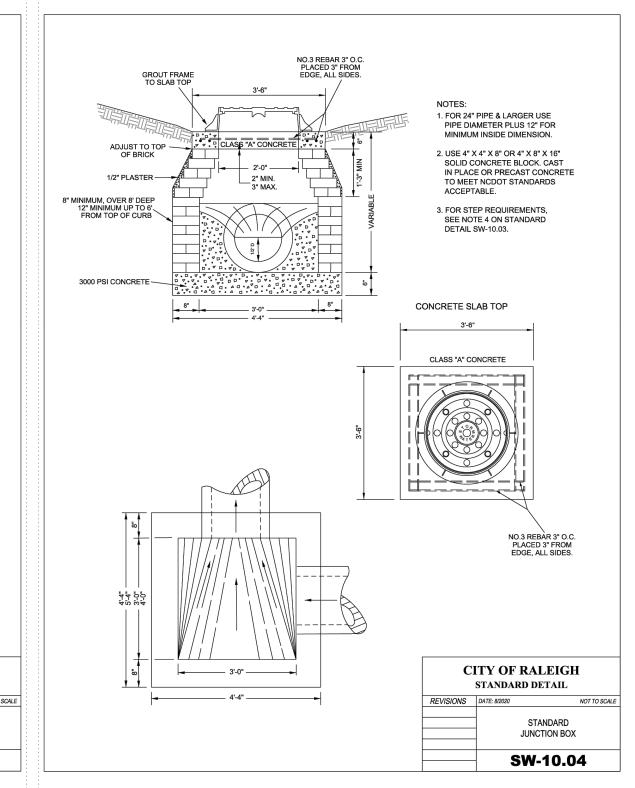


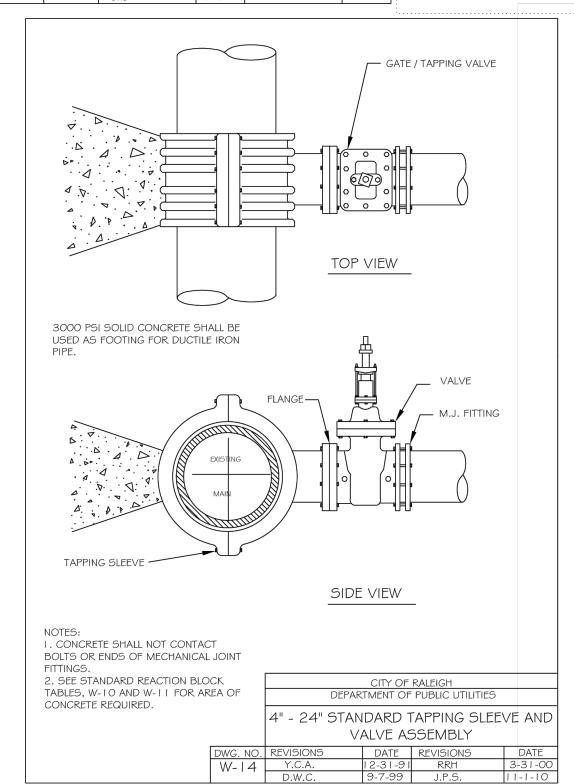


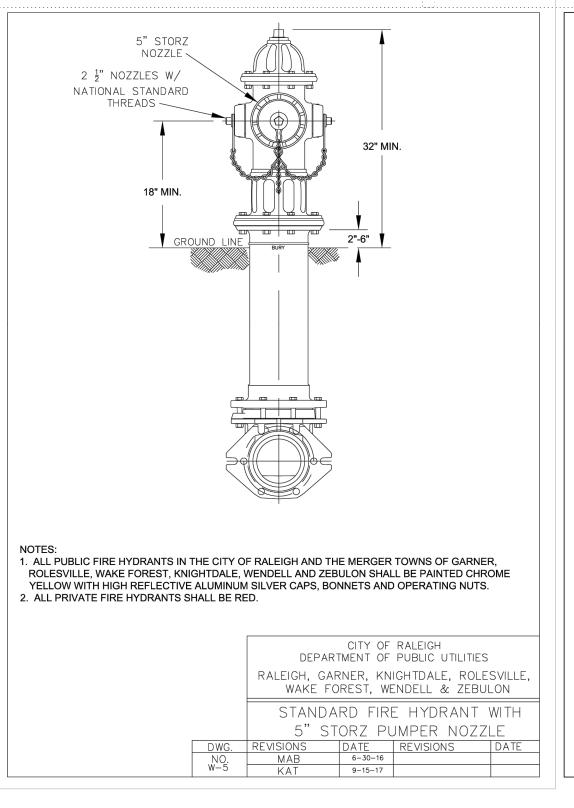

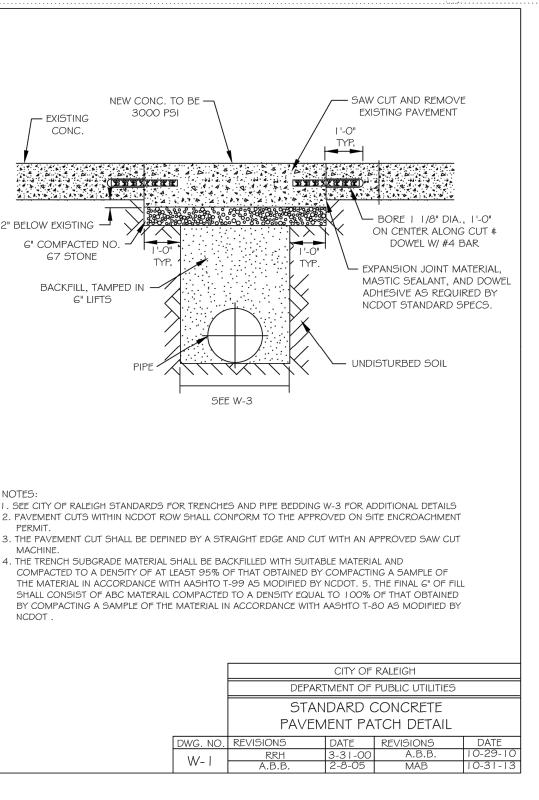

SW-10.02

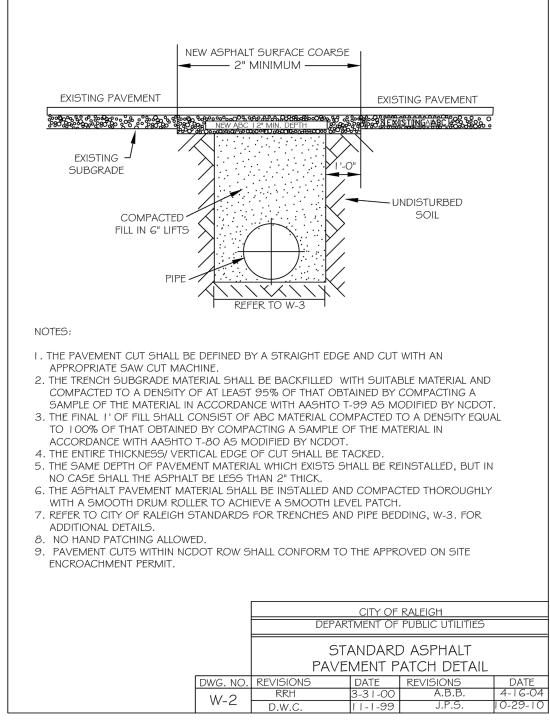

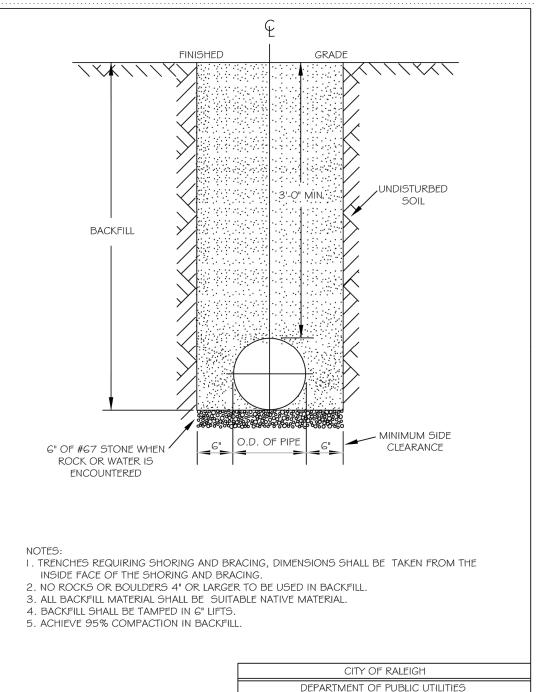

TRENCH BOTTOM DIMENSIONS & BACKFILLING

REQUIREMENTS FOR DUCTILE IRON




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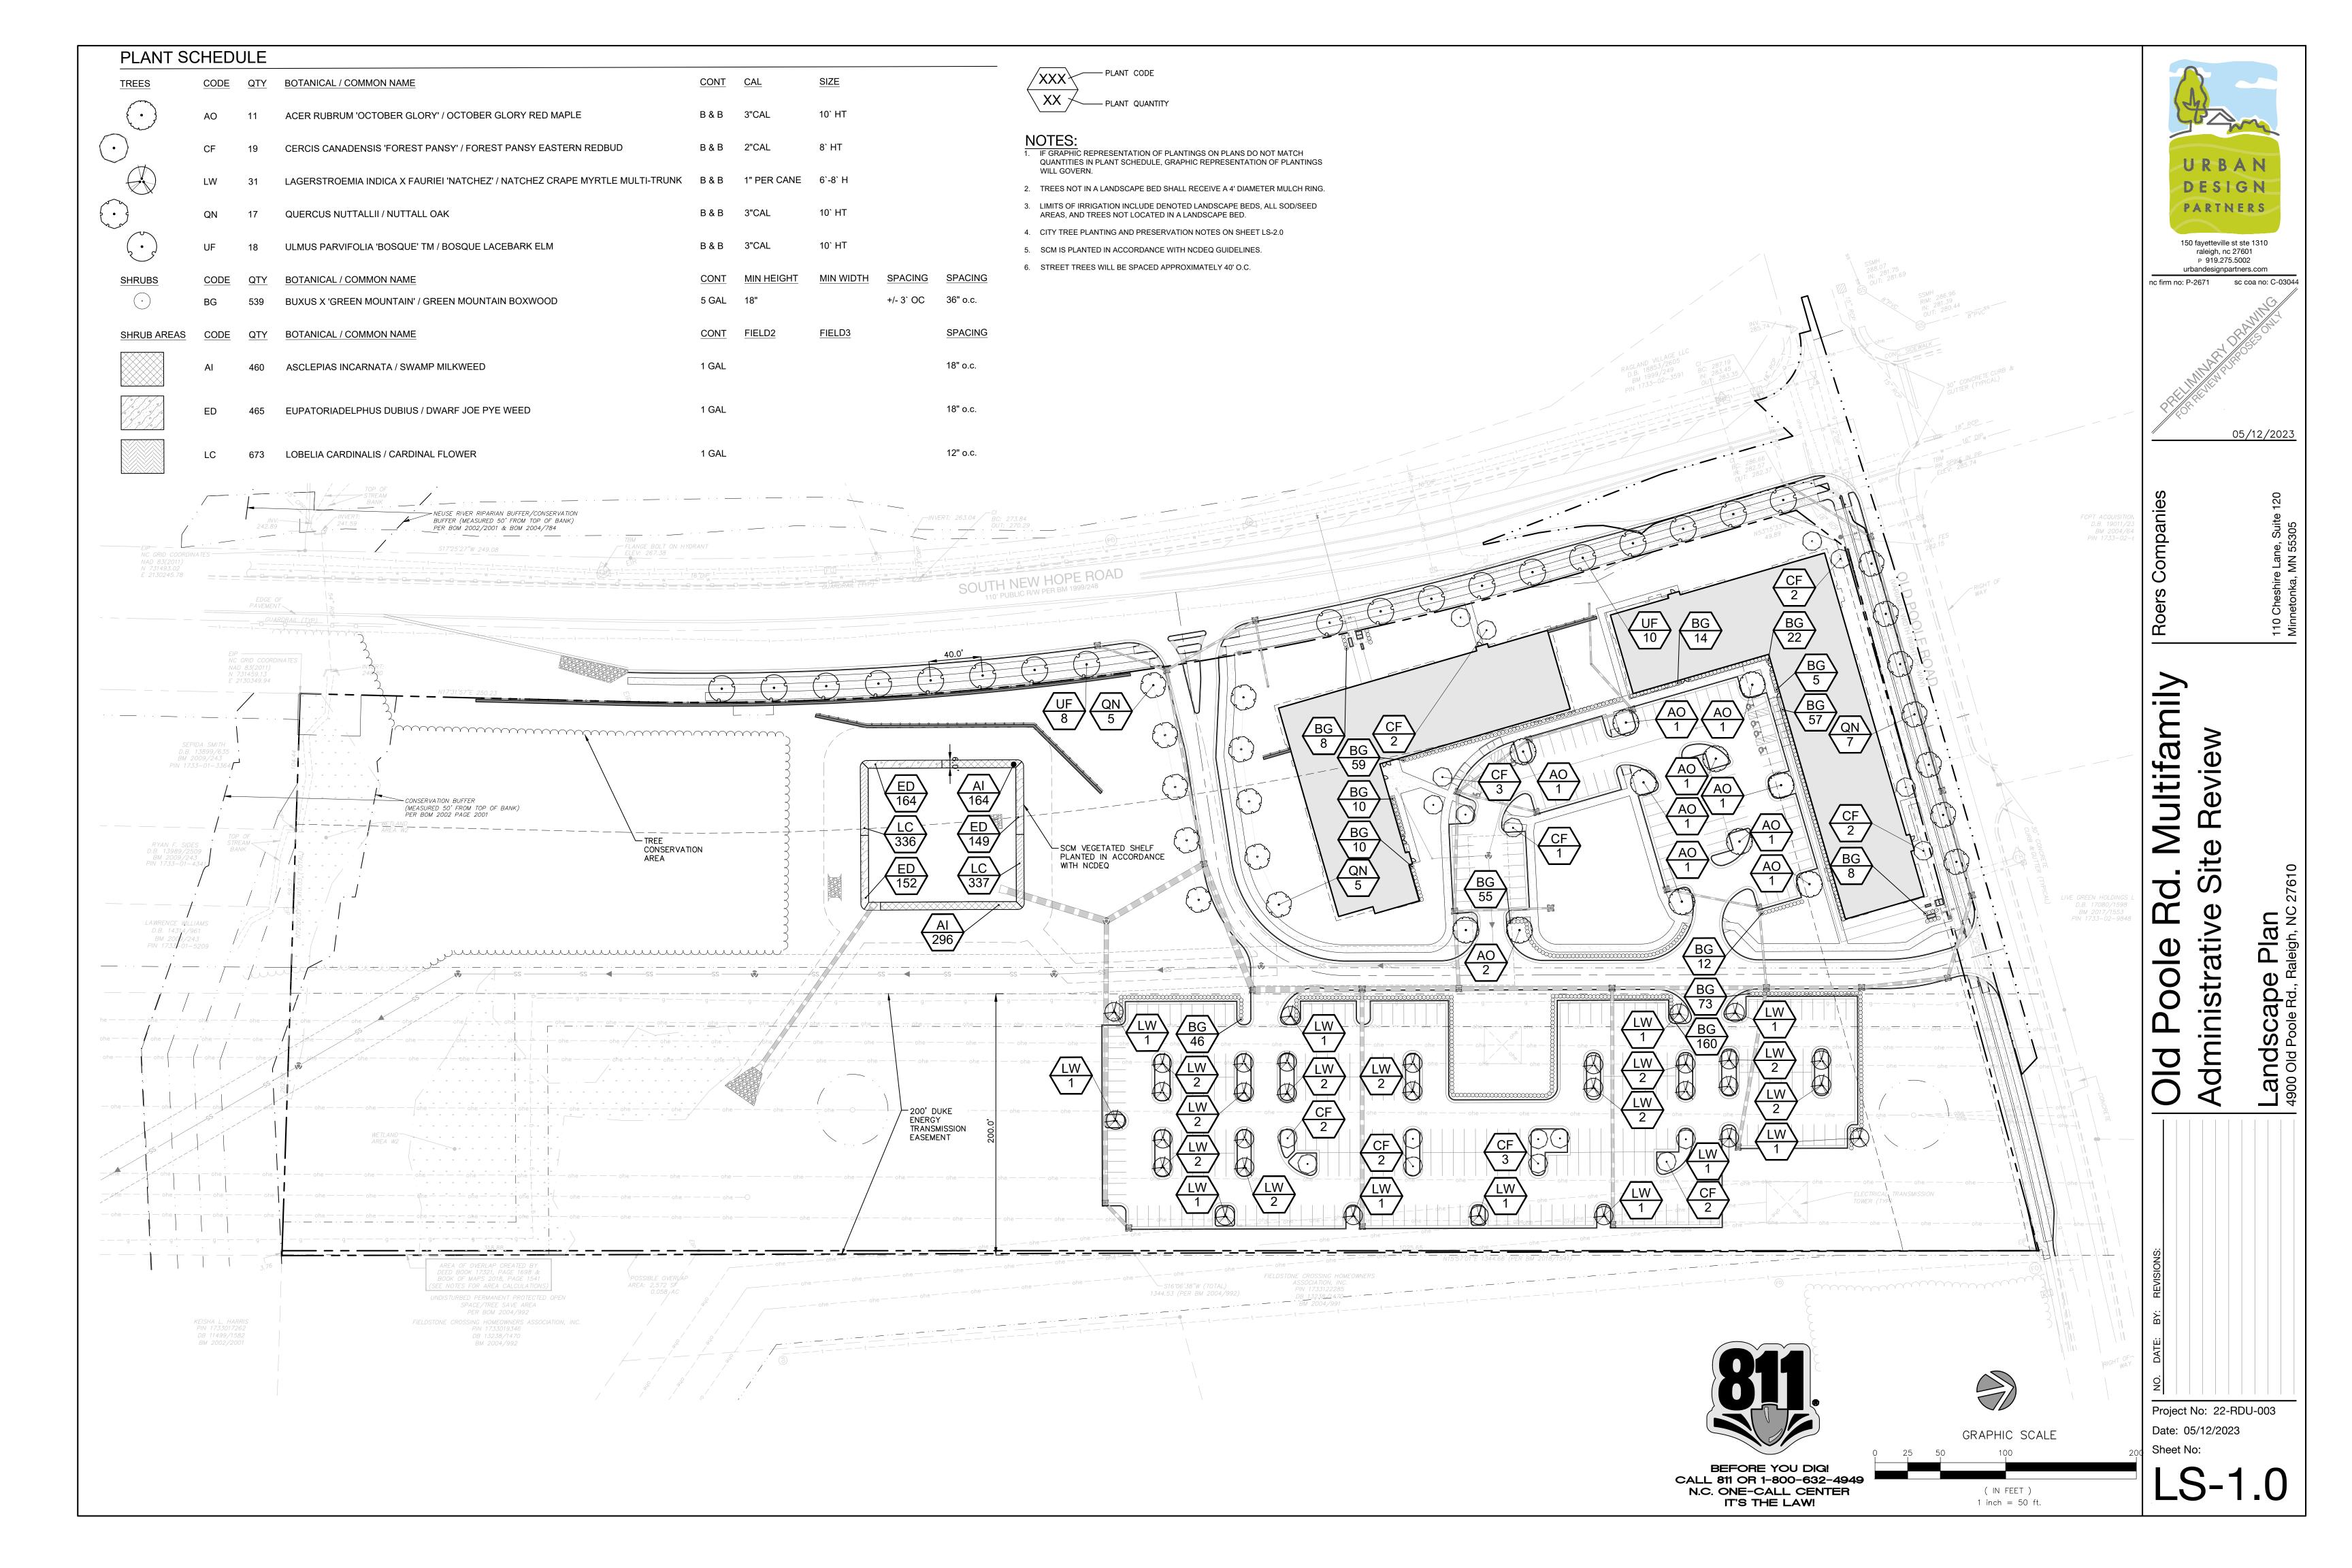
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OECIFICATIONS IN Paleigh, NC 27610

| No. DATE: 05/12/2023 | Sheet No:

C-8.1



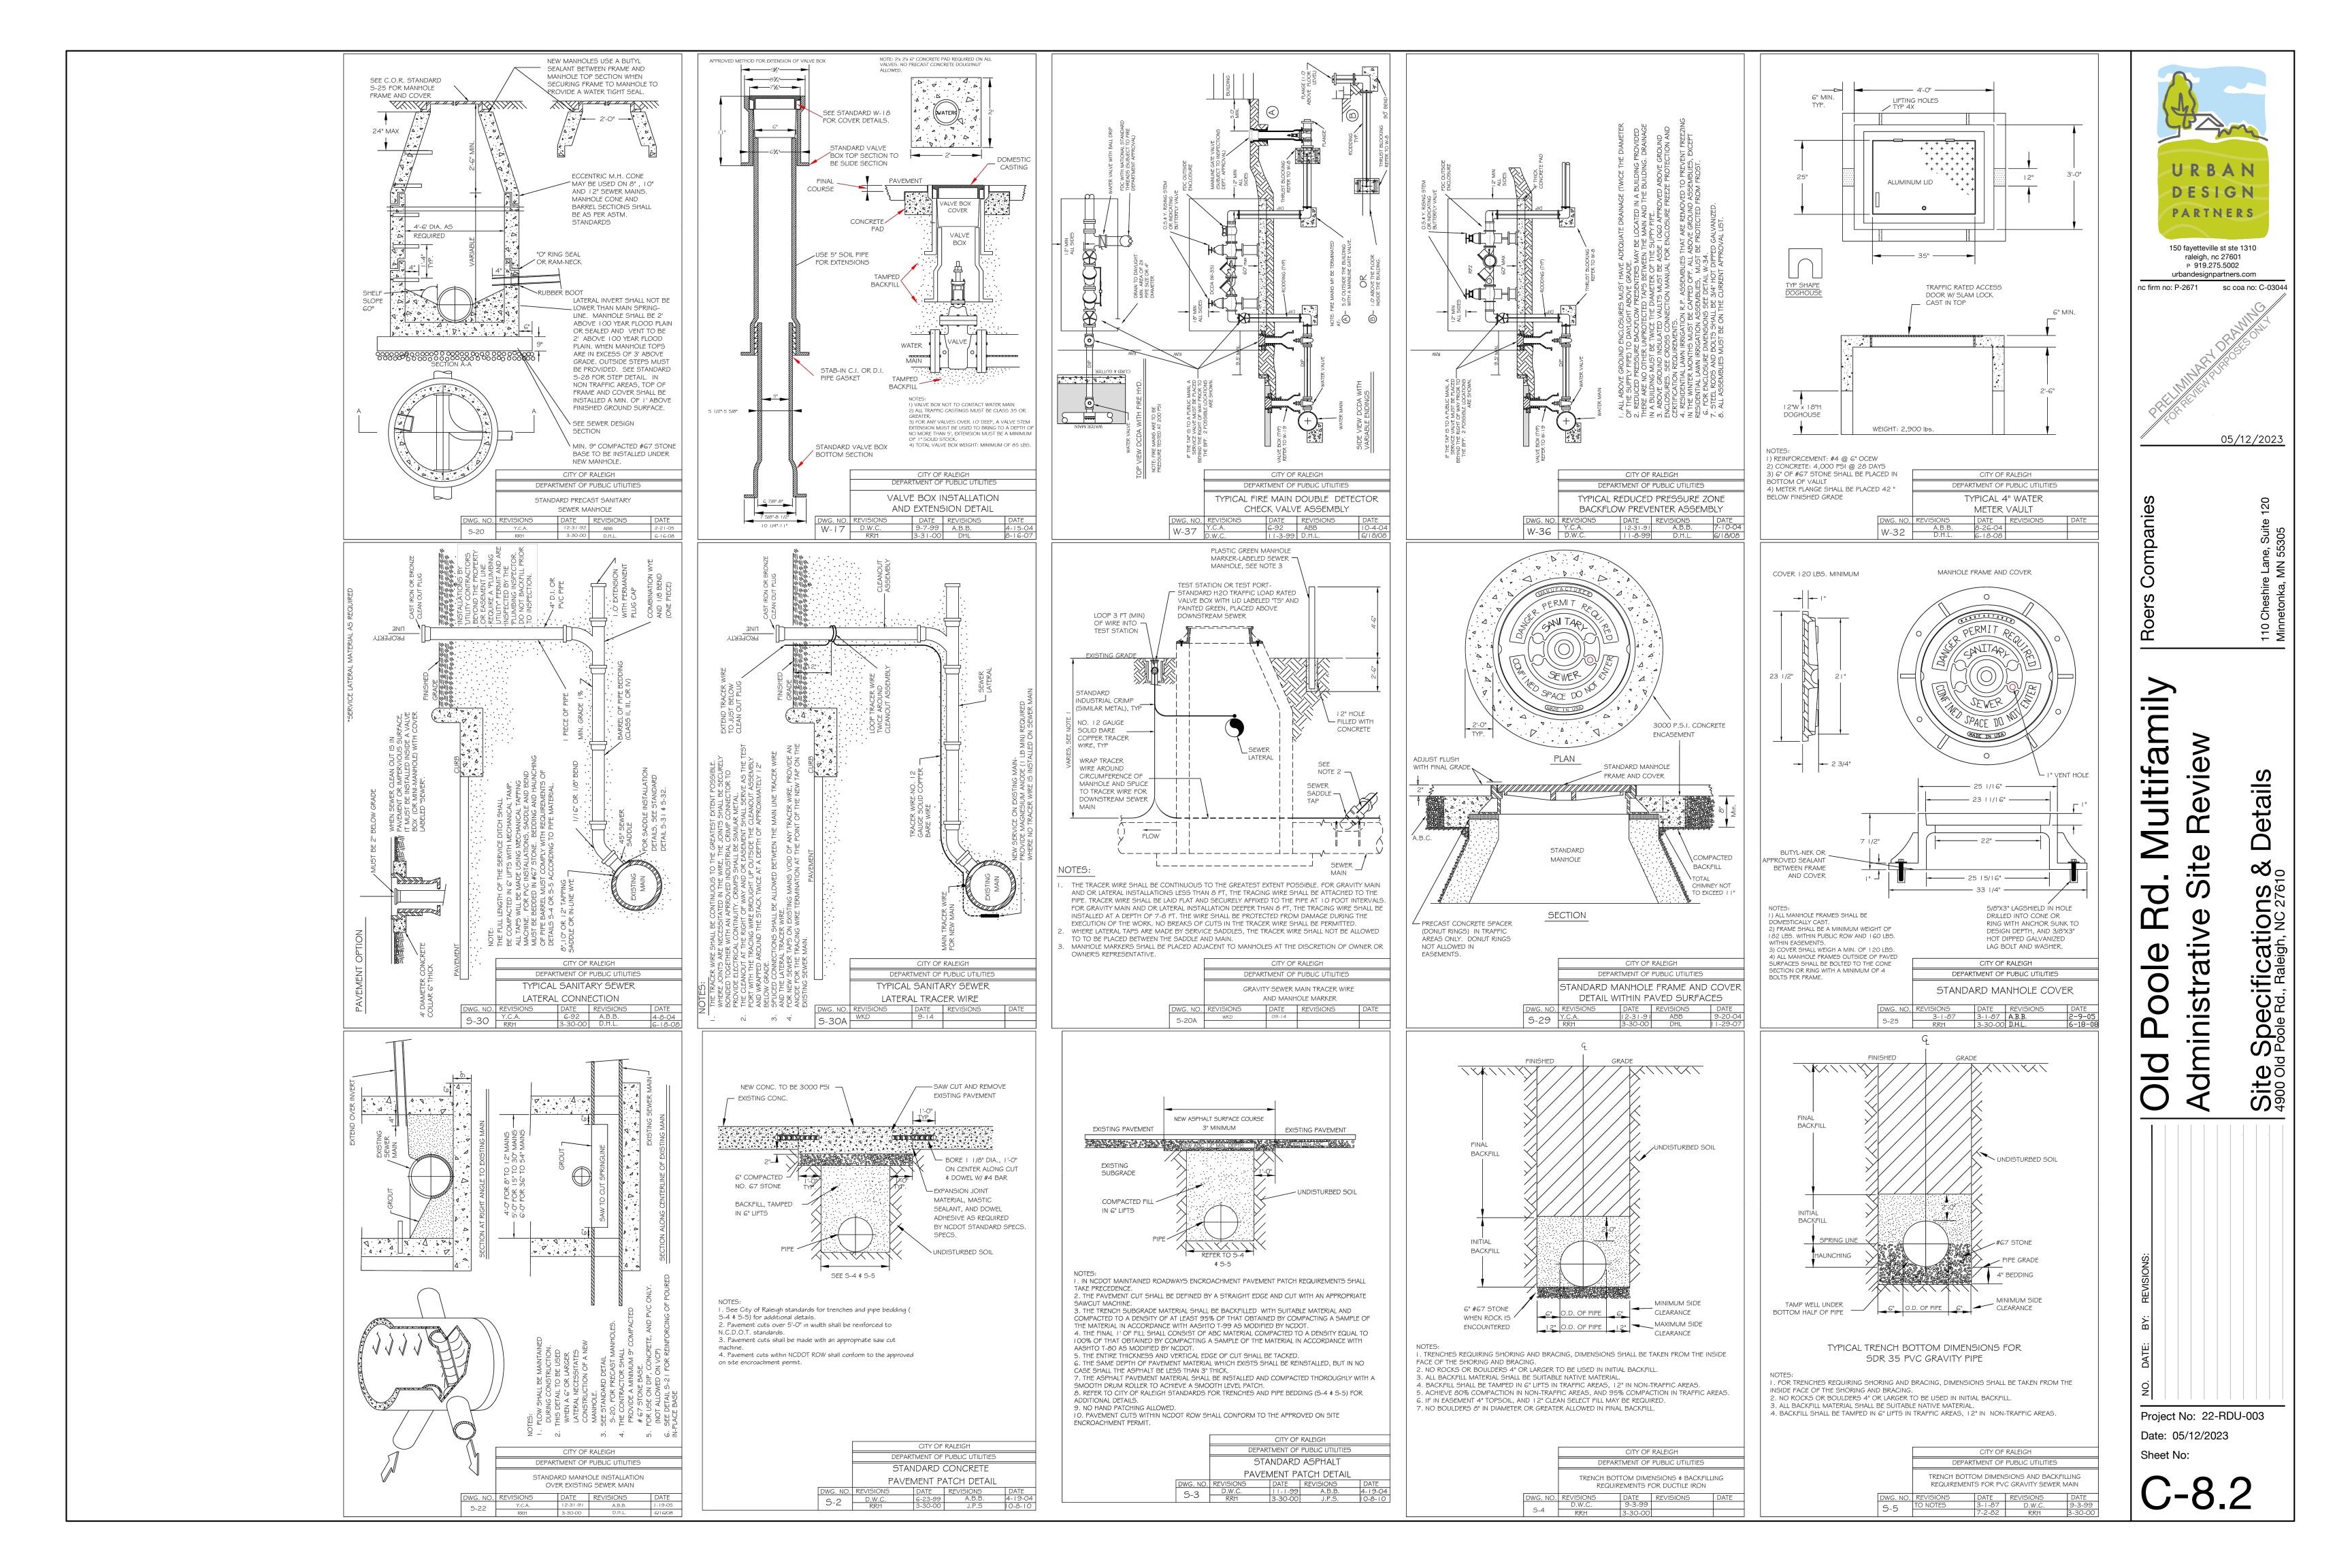

TREE PLANTING & PRESERVATION REQUIREMENTS:

MINIMUM TREE SIZE AT PLANTING IS 2" CALIPER AND 8' TALL FOR SINGLE-STEM TREES. ALL MULTI-STEM PLANTS MUST BE TREE FORM. ALL MULTI-STEM PLANTS MUST BE TREE FORM, MAXIMUM 3 TO 5 TRUNKS, AND MINIMUM 10' TALL. WHERE 3" SINGLE-STEM CALIPER TREES ARE SPECIFIED/REQUIRED THE MINIMUM HEIGHT SHALL BE 10' TALL.

- REQUIRED STREET TREES SHALL BE 3" IN CALIPER AND BE A MINIMUM OF 10' TALL PER CITY OF RALEIGH CITY TREE MANUAL.
- ALL NEW TREES MUST HAVE <u>STRAIGHT TRUNKS WITH STRONG CENTRAL LEADERS INTACT TO THE TOP OF THE CROWN</u> UNLESS MULTI—STEM TREES ARE SPECIFIED. ALL REQUIRED TREES SHALL BE TYPICAL OF THEIR SPECIES AND VARIETY, HAVE NORMAL GROWTH HABITS, HAVE WELL-DEVELOPED BRANCHES. BE VIGOROUS AND HAVE FIBROUS ROOT SYSTEMS. TREES WITH MAJOR GIRDLING ROOTS WILL NOT BE ACCEPTED. TREES WITH CO-DOMINANT BRANCHING WILL NOT BE ACCEPTED. TREES THAT HAVE BEEN SHEARED, TOPPED OR CUT BACK TO MULTIPLY THE BRANCHING STRUCTURE WILL NOT BE ACCEPTED. TREES SHALL BE FREE OF ABRASIONS, DAMAGE, DISEASE, PESTS AND CRACKS. ALL PRUNING CUTS GREATER THAN 1/2 INCH DIAMETER SHALL HAVE CALLUS TISSUE FORMED PRIOR TO PLANTING. NO PRUNING CUT ON THE TRUNK SHALL BE MORE THAN ONE-HALF THE DIAMETER OF THE CENTRAL LEADER AT THE HEIGHT WHERE THE CUT WAS MADE. ROOT FLARES SHALL BE LOCATED AT GRADE. TREES WITH MORE THAN 2" OF SOIL COVERING THE ROOT BALL/FLARE FROM WILL NOT BE ACCEPTED.
- SIZE OF REQUIRED PLANTS, SPREAD OF ROOTS AND SIZE OF BALLS SHALL BE IN ACCORDANCE WITH ANSI Z60.1 (LATEST EDITION) AS PUBLISHED BY THE AMERICAN NURSERY & LANDSCAPE ASSOCIATION, EXCEPT WHERE SPECIFIED/AUTHORIZED BY URBAN FORESTRY.
- 5. ALL REQUIRED TREES OF A PARTICULAR SPECIES AND VARIETY SHALL BE UNIFORM IN SIZE AND CONFIGURATION.
- 6. A MINIMUM OF 50% OF NEW TREES MUST BE NATIVE SPECIES, AND SITES WITH MORE THAN 20 TREES REQUIRED WILL HAVE TO INSTALL MULTIPLE
- (3 OR MORE) SPECIES PURSUANT TO THE TREE ORDINANCE GUIDELINES. 7. 75% OF REQUIRED TREES MUST BE LARGE MATURE SPECIES EXCEPT IN SITUATIONS WITH OVERHEAD POWER LINE CONFLICTS.
- 8. ALL STRAPPING, AND TOP 1/3 OF WIRE BASKET AND BURLAP MUST BE CUT AWAY AND REMOVED FROM ROOT BALL WHEN PLANTING.
- 9. FOR NEW PLANTING AREAS, REMOVE ALL PAVEMENT, GRAVEL SUB-BASE AND CONSTRUCTION DEBRIS; REMOVE COMPACTED SOIL AND ADD 18" NEW TOPSOIL, OR TILL AND AMEND THE TOP 18" OF EXISTING SOIL TO MEET TOPSOIL/PLANTING MIX STANDARDS FOR TREES (WITHIN ENTIRE MINIMUM AREA OF 274 SQUARE FEET).
- 10. TREES PLANTED ON PUBLIC PROPERTY WILL NEED APPROVAL FROM THE CITY ARBORIST AND/OR NCDOT.

- 11. IF ANY UTILITY IS BEING INSTALLED IN OR NEAR ANY REQUIRED TREE(S) OR TREE SAVE AREA(S), CALL URBAN FORESTRY SPECIALIST TO RESOLVE PRIOR TO UTILITY INSTALLATION.
- 12. IF TREES CONFLICT WITH ANY UTILITIES OR SIGNS; CALL URBAN FORESTER TO RESOLVE BEFORE PLANTING.
- 13. ADJUST TREE PLANTING LOCATIONS TO AVOID EXISTING UNDERGROUND UTILITIES. PLANT 10' FROM ALL UNDERGROUND UTILITIES.
- 18. NO LIGHT POLES, UTILITIES OR TRANSFORMERS CAN BE INSTALLED IN TREE ISLANDS.
- 19. TREES MUST MAINTAIN A MINIMUM DISTANCE OF 20' FROM LIGHT POLES WITHIN THE RIGHT-OF-WAY. SHOW SITE LIGHTING ON LANDSCAPE PLAN.

20. TREE PROTECTION MUST BE INSTALLED AND VERIFIED BY URBAN FORESTRY PRIOR TO STARTING ANY CONSTRUCTION ACTIVITY.

- 21. SHOW TREE PROTECTION AND TREES SAVE AREAS ON EROSION CONTROL, GRADING AND LANDSCAPE PLAN SHEETS.
- 22. COMMERCIAL TREE SAVE AREAS MUST BE RECORDED ON A FINAL PLAT.
- 23. TREE SAVE AREAS SHALL BE FREE OF INVASIVE PLANT SPECIES. IF AN AREA PROPOSED FOR TREE SAVE CONTAINS INVASIVE PLANT SPECIES AT TIME OF PROPOSAL, SUCH INVASIVE PLANT SPECIES SHALL BE REMOVED PRIOR TO FINAL CO.
- 24. THE AREA OF ANY EASEMENTS (WATER, SEWER, UTILITY, ETC.) CAN NOT BE COUNTED TOWARD THE TREE SAVE REQUIREMENT.
- 25. ANY ALTERATIONS TO TREE SAVE AREAS MUST BE ACCOMPLISHED WITHOUT MECHANIZED EQUIPMENT.
- 26. NO STRUCTURE WILL BE ALLOWED WITHIN 10' OF TREE SAVE AREAS UNLESS APPROVED BY URBAN FORESTRY.
- 27. CONTACT URBAN FORESTRY SPECIALIST PRIOR TO ANY CRANE SET-UP, MACHINERY OPERATION OR TEMPORARY BUILDING ERECTION THAT MAY IMPACT PROTECTED TREES OR TREE SAVE AREAS, INCLUDING TREES LOCATED IN STREET RIGHT OF WAY. IMPACTS MAY INCLUDE BUT ARE NOT LIMITED TO: ENCROACHING WITHIN TREE DRIP-LINES, EXCAVATION, SOIL COMPACTION, TREE TRIMMING, ERECTING AND DISMANTLING OF

TOPSOIL/PLANTING MIX - MINIMUM REQUIREMENTS:

CONSTRUCTION CRANES.

- 31. WHERE PAVEMENT CUTOUTS ON RENOVATED SITES ARE REQUIRED AND/OR WHERE NEW PLANTING STRIPS OR ISLANDS ARE REQUIRED. ALL PAVEMENT, CONSTRUCTION DEBRIS AND GRAVEL SUB-BASE MUST BE REMOVED BEFORE PREPARING SOIL AND PLANTING TREES. EXISTING COMPACTED SOIL MUST BE REMOVED AND REPLACED WITH 24" OF TOPSOIL/PLANTING MIX -OR- EXISTING SOIL MAY BE UNCOMPACTED TO A DEPTH OF 24" AND AMENDED TO MEET TOPSOIL STANDARDS FOR THE ENTIRE PLANTING AREA.
- 32. SOIL IN ALL PLANTING STRIPS OR ISLANDS, WHETHER EXISTING OR NEW (ON NEW OR RENOVATED SITES), MUST MEET THE MINIMUM TOPSOIL/PLANTING MIX SPECIFICATIONS. SOIL AMENDMENTS OR FRESH TOPSOIL/PLANTING MIX ARE OFTEN NEEDED FOR PLANTING AREAS AT SITES WHERE ORIGINAL TOPSOIL IS OF POOR QUALITY, HEAVILY COMPACTED OR WHERE TOPSOIL HAS BEEN COMPLETELY REMOVED DURING
- 33. TOPSOIL/PLANTING MIX SHOULD BE NATURAL, FERTILE, AGRICULTURAL SOIL CAPABLE OF SUSTAINING VIGOROUS PLANT GROWTH. IT SHOULD BE UNIFORM COMPOSITION THROUGHOUT, WITH ADMIXTURE OF SUBSOIL. IT SHOULD BE FREE OF STONES, LUMPS, LIVE PLANTS AND THEIR ROOTS, STICKS AND OTHER EXTRANEOUS MATTER. TOPSOIL SHOULD NOT BE USED WHILE IN A FROZEN OR MUDDY CONDITION.
- 34. TOPSOIL/PLANTING MIX SHALL HAVE AN ACIDITY RANGE OF PH 5.5-7.0 AND THE FOLLOWING COMPOSITION: CLAY (RED CLAY, WELL PULVERIZED) MINIMUM 10%; MAXIMUM 35%

COMPOST*/ORGANIC MINIMUM 5%; MAXIMUM 10% SILT MINIMUM 30%; MAXIMUM 50%

SINGLE STEM TREE

SCALE: NTS

COARSE SAND (FREE OF ROCKS, 0.5 TO 1.0 MM F) MINIMUM 30%; MAXIMUM 45%

*ORGANIC MATERIAL SUCH AS SAWDUST OR LEAF MOLD THAT HAS COMPLETED THE DECOMPOSITION PROCESS.

35. ALL PLANTING AREAS SHOULD BE TESTED FOR PROPER DRAINAGE. DRAINAGE SHOULD BE CORRECTED AS NECESSARY TO INSURE PROPER TREE GROWTH AND SURVIVAL. THE FOLLOWING LEVEL OF NUTRIENT ELEMENTS IS RECOMMENDED FOR PROPER GROWTH: CALCIUM 55 - 80% MAGNESIUM 10 - 30% POTASSIUM 5 - 8%

GENERAL NOTES WOOD STAKES ALL TREES ARE TO BE NURSERY GROWN, BURLAP AND BALL (B&B) MINIMUM TREE SIZE IS 2' CAL. (MEASURED 6' ABOVE THE ROOT BALL) 8' MINIMUM HEIGHT SAUCER BERM 2. REMOVE ALL TREATED OR PLASTIC-COATED BURLAP, STRAPPIN WIRE OR NYLON TWINE FROM ROOT BALL. AFTER SETTING IN HOLE, CUT AWAY TOP AND SIDES OF WIRE BASKET, IF ANY. PREPARED PLANTING MIX 3. INSTALL TOP OF PLANT BALL EVEN WITH OR 1' ABOVE EXISTING MINIMUM LIMIT OF MULCH 4. SET TREE IN VERTICAL POSITION PRIOR TO STAKING. SDAK PLANT BALL AND PIT IMMEDIATELY AFTER INSTALLATION. PLACE 4-6' DF SEASONED MULCH OR PINE NEEDLES AROUND BASE OF TREE, 3' DIAMETER MINIMUM. . WRAP TREES FROM GROUND TO LOWEST BRANCHES WITH BURLAP OR TREE WRAP PAPER (OPTIONAL). SECURE NEAR TOP AND BOTTOM WITH HEMP STRING ONLY. 9. GUY WIRES ARE NOT PERMITTED IN STREET RIGHT-OF-WAY. - *TREE BRACING STRAP - 2" X 2" DAK WOOD STAKES — *TREE WRAPING - REMOVE TOP 1/3 BURLAP FROM B & B TREES — 4" LAYER □F MULCH - 4" SAUCER BERM — FINISH GRADE —— EXISTING SUBGRADE

SECTION DR SINGLE STEM TREE STAKING

PLANTING MIX

*=OPTIONAL

TAMP SOIL UNDER BALL TO MINIMIZE SETTLEMEN

SINGLE STEM TREE ON A SLOPE Scale: NTS

SECTION DT_SINGLE STEM TREE ON SLOPE STAKING

GENERAL NOTES

ALL TREES ARE TO BE NURSERY GROWN, BURLAP AND BALL (B&B). MINIMUM TREE SIZE IS 2° CAL. (MEASURED 6° ABOVE THE ROOT BALL) 8° MINIMUM HEIGHT

3. INSTALL TOP OF PLANT BALL EVEN WITH OR 1' ABOVE EXISTING

5. SDAK PLANT BALL AND PIT IMMEDIATELY AFTER INSTALLATION. PLACE 4-6' OF SEASONED MULCH OR PINE NEEDLES AROUND BASE OF TREE, 3' DIAMETER MINIMUM.

B. ANY TREE PROPOSED FOR PLANTING ON THE STREET RIGHT-OF-WAY MUST BE APPROVED IN ADVANCE BY THE CIT' ARBORIST AS TO SPECIES, SIZE AND LOCATION (CITY ONLY).

9. GUY WIRES ARE NOT PERMITTED IN STREET RIGHT-OF-WAY.

*=DPTIDNAL

— *TREE WRAPING

4" SAUCER BERM

— PLANTING MIX

STAKES

- *TREE BRACING STRAP - 2" X 2" OAK WOOD

REMOVE TOP 1/3 BURLAP

FROM B & B TREES

— TAMP SOIL UNDER BALL

- EXISTING SUBGRADE · COMPACT FILL TO BE

BENCHED IN

TO MINIMIZE SETTLEMENT

— 4" LAYER □F MULCH

4. SET TREE IN VERTICAL POSITION PRIOR TO STAKING.

GENERAL PLANTING NOTES

- QUANTITIES NECESSARY TO COMPLETE THE WORK ON THE DRAWINGS SHALL BE FURNISHED BY THE CONTRACTOR. QUANTITY ESTIMATES HAVE BEEN MADE CAREFULLY, BUT THE LANDSCAPE ARCHITECT ASSUMES NO LIABILITY FOR ERRORS OR OMISSIONS. HIS ESTIMATES ARE ONLY AN AID FOR CLARIFICATION OF UNITS AND A CHECK FOR THE CONTRACTOR TO COMPARE WITH HIS OWN ESTIMATES. DIFFERENCES SHALL BE BROUGHT TO THE ATTENTION OF THE LANDSCAPE ARCHITECT. NO EXTRA COMPENSATION SHALL BE ALLOWED FOR EXTRA QUANTITIES NECESSARY TO COMPLETE THE WORK
- 2. CONTRACTOR SHALL BE RESPONSIBLE FOR INSTALLATION OF PLANT MATERIALS ACCORDING TO THE DRAWINGS AND PLANT SCHEDULE. CONTRACTOR SHALL PROVIDE SPECIFIC CULTIVARS AND/OR VARIETIES AS INDICATED ON THE PLANT SCHEDULE. ANY SUBSTITUTIONS INSTALLED WITHOUT PRIOR APPROVAL OF LANDSCAPE ARCHITECT WILL BE REJECTED AND SHALL BE REPLACED BY THE CONTRACTOR AT NO EXTRA COST TO THE OWNER.
- PLANTING PLANS INDICATE DIAGRAMMATIC LOCATIONS ONLY. SITE ADJUSTMENTS OF PLANTING DESIGN AND RELOCATION OF PLANT MATERIALS DUE TO ON SITE CONDITIONS SHALL BE APPROVED BY THE LANDSCAPE ARCHITECT PRIOR TO INSTALLATION. PLANTS INSTALLED PRIOR TO LANDSCAPE ARCHITECT'S APPROVAL ARE SUBJECT TO RELOCATION BY THE CONTRACTOR AT NO ADDITIONAL COST TO THE OWNER.
- 4. PLANTS SHALL BE SPECIMEN QUALITY AND SHALL BE SOUND, HEALTHY AND VIGOROUS, WELL-BRANCHED, AND DENSELY FOLIATED WHEN IN LEAF. PLANT MATERIAL SHALL BE FIRST QUALITY STOCK AND SHALL CONFORM TO THE CODE OF STANDARDS SET FORTH IN THE CURRENT

EDITION OF THE AMERICAN STANDARDS FOR NURSERY STOCK SPONSORED BY THE AMERICAN ASSOCIATION OF NURSERYMEN, INC.

- 5. HEIGHT AND SPREAD DIMENSION SPECIFIED REFER TO THE MAIN BODY OF THE PLANT AND NOT FROM BRANCH TIP TO TIP. IF A RANGE OF SIZE IS GIVEN, NO PLANT SHALL BE LESS THAN THE MINIMUM SIZE AND NOT LESS THAN 50% OF THE PLANTS SHALL BE AS LARGE AS THE MAXIMUM SIZE SPECIFIED.
- 6. SHADE TREES SHALL HAVE A STRONG CENTRAL LEADER UNLESS OTHERWISE SPECIFIED.
- 7. LEAVES MUST BE OF MEDIUM FOLIAGE, ALL GOOD LEAVES, MAXIMUM OF 10% CHLOROSIS ALLOWED, WITH NO EXTREME SUCCULENCE PLACE PLANTS UPRIGHT AND TURNED SO THAT THE MOST ATTRACTIVE SIDE IS VIEWED.
- 8. ROOTS MUST BE STURDILY ESTABLISHED IN BALL THAT HAS BEEN TIGHTLY WRAPPED AND SECURELY TIED WITH TWINE OR WIRE, OR PINNED.
- 9. PLACE PLANTS UPRIGHT AND TURNED SO THAT THE MOST ATTRACTIVE SIDE IS VIEWED.
- 10. PROVIDE 4" THICKNESS MULCH AT ALL PLANTS AND PLANTING BEDS. MULCH SHALL BE SINGLE HAMMERED HARDWOOD MULCH (UNLESS NOTED OTHERWISE). IT SHALL BE CLEAN, FRESH, AND FREE OF STICKS, BRANCHES, SOIL OR OTHER FOREIGN MATERIAL.
- 11. BACKFILL PLANTING MIXTURE SHALL BE ONE PART APPROVED PLANTING SOIL MIXED WITH ONE PART NATIVE SOIL FROM THE TREE PIT OR SHRUB BED AREA. LANDSCAPE CONTRACTOR SHALL SUBMIT SAMPLES OF PLANTING SOIL TO BE USED TO LANDSCAPE ARCHITECT FOR APPROVAL PRIOR TO PLANTING.
- 12. PLANTS SHALL BE SUBJECT TO REVIEW BY LANDSCAPE ARCHITECT AT NURSERY OR ON SITE PRIOR TO PLANTING. LANDSCAPE ARCHITECT WILL BE THE SOLE JUDGE OF THE QUALITY AND ACCEPTABILITY OF MATERIALS AND PLACEMENT. CONTRACTOR SHALL SUBMIT PHOTOS OF ALL TREES WITH BID SUBMITTAL IF REQUESTED BY LANDSCAPE ARCHITECT OR OWNER.
- 13. THE LANDSCAPE CONTRACTOR SHALL TAKE SOIL SAMPLES FROM ALL PARTS OF THE SITE AND SHALL HAVE THEM TESTED BY THE LOCAL COUNTY AGENT. THE CONTRACTOR SHALL PROVIDE ONE COPY OF THE TEST RESULTS TO THE LANDSCAPE ARCHITECT PRIOR TO ORDERING PLANT MATERIALS OR MAKING ANY AMENDMENTS TO THE ON SITE SOIL. ANY SOIL AMENDMENTS REQUIRED AS INDICATED BY THE SOIL TEST SHALL BE PROVIDED BY THE LANDSCAPE CONTRACTOR. THE LANDSCAPE CONTRACTOR SHALL NOTIFY THE LANDSCAPE ARCHITECT OF AMENDMENTS AND OBTAIN A WRITTEN APPROVAL FOR PROPOSED AMENDMENTS.
- 14. FERTILIZER SHALL BE A COMPLETE FERTILIZER; 50% OF NITROGEN OF WHICH IS DERIVED FROM NATURAL ORGANIC SOURCES OR UREAFORM. FERTILIZER SHALL BE DELIVERED TO THE SITE IN STANDARD SIZE UNOPENED CONTAINERS WHICH SHOW THE WEIGHT, CHEMICAL ANALYSIS, AND MANUFACTURER. IT SHALL BE STORED IN A DRY LOCATION UNTIL ITS USE. FERTILIZER FOR TREES, SHRUBS, AND GROUNDCOVER AREAS SHALL BE A SLOW RELEASE TYPE AND SHALL BE APPLIED AS FOLLOWS:

TREES: 1 LB / INCH OF CALIPER TREES AND SHRUBS 10-10-10 SHRUBS: ½ LB / INCH HEIGHT MARCH-MAY JUNE-OCTOBER 6-10-10 NOVEMBER-FEBRUARY 6-12-12

- 15. LANDSCAPE CONTRACTOR SHALL PERFORM PERCOLATION TESTS IN ALL TREE PITS. IF PITS DO NOT DRAIN WITHIN 30 MINUTES, CONTACT LANDSCAPE ARCHITECT AND DO NOT PLANT THE TREE WITHOUT ON SITE INSPECTION OF DRAINAGE. LANDSCAPE ARCHITECT MAY REQUIRE ADDITIONAL SUBSURFACE DRAIN LINES FROM THE TREE PITS.
- 16. IF SURFACE DRAINAGE IS NOT SUFFICIENT (STANDING WATER) NOTIFY LANDSCAPE ARCHITECT IN WRITING BEFORE INSTALLING THE PLANTS, OTHERWISE CONTRACTOR SHALL BE TOTALLY REPONSIBLE FOR THE GUARANTEE AND LIVABILITY OF THE PLANTS.
- 17. ALL UNDERGROUND UTILITIES SHALL BE LOCATED BEFORE DIGGING. THE CONTRACTOR SHALL BE FULLY RESPONSIBLE FOR ALL DAMAGE OF UNDERGROUND OR OVERHEAD UTILITY LINES.
- 18. CERTIFICATE OF INSPECTION AS MAY BE REQUIRED BY LAW FOR TRANSPORTATION OF PLANT MATERIALS SHALL ACCOMPANY EACH INVOICE FOR EACH SHIPMENT OF PLANTS. CERTIFICATES SHALL BE FILED WITH LANDSCAPE ARCHITECT PRIOR TO ACCEPTANCE OF MATERIAL. INSPECTION BY STATE OR FEDERAL AUTHORITIES AT THE PLACE OF GROWTH DOES NOT PRECLUDE REJECTION OF THE MATERIAL BY THE LANDSCAPE
- 19. ALL PLANT MATERIALS AND INSTALLED LANDSCAPE SUPPLIES SHALL BE WARRANTED FOR A PERIOD OF ONE YEAR AFTER FINAL ACCEPTANCE OF THIS PROJECT.
- 20. CONTRACTOR'S PRICES SHALL INCLUDE ALL LABOR AND MATERIALS NECESSARY TO COMPLETE THE WORK (i.e. MULCH, PLANTING, SOIL MIX, WOOD AND WIRE STAKING MATERIAL, ETC.).
- 21. THE COMPLETION OF THE CONTRACT WILL BE ACCEPTED AND NOTICE OF COMPLETION RECORDED ONLY WHEN THE ENTIRE CONTRACT IS COMPLETED TO THE SATISFACTION OF THE LANDSCAPE ARCHITECT, OWNER, AND THE OWNER'S CONSTRUCTION REPRESENTATIVE. WITHIN TEN DAYS NOTICE BY THE CONTRACTOR OF SUBSTANTIAL COMPLETION THE LANDSCAPE ARCHITECT WILL INSPECT THE PROPERTY. HE WILL EITHER APPROVE THE WORK FOR THE OWNER'S ACCEPTANCE OR WILL ISSUE A "PUNCH LIST" OF ITEMS TO BE COMPLETED OR CORRECTED. IF A PUNCH LIST IS ISSUED, FINAL ACCEPTANCE WILL BE DONE AS SOON AS THE CONTRACTOR COMPLETES ALL PUNCH LIST ITEMS.
- 22. AMENDED SOIL MEDIA REQUIREMENTS: A PLANTING MIX MAY BE DEVELOPED THAT WILL BE AN ACCEPTABLE PLANTING MEDIA BY AMENDING THE EXISTING SOIL OR BY REMOVING THE EXISTING SOIL AND REPLACING IT WITH NEW PLANTING MIX. THE PLANTING MIX SHALL HAVE UNIFORM COMPOSITION THROUGHOUT, WITH A MIXTURE OF SUBSOIL. IT SHALL BE FREE OF STONES, LUMPS, LIVE PLANTS AND THEIR ROOTS, STICKS, AND OTHER EXTRANEOUS MATTER. IT SHALL CONTAIN NO MAN MADE MATERIALS UNLESS OTHERWISE SPECIFIED. PLANTING MIX SHALL NOT BE USED WHILE IN A FROZEN OR MUDDY CONDITION.

*NOTE: CONTRACTOR TO PROVIDE TEST SAMPLES OF AMENDED SOIL WITH TESTING DATA FOR ALL BED AREAS AMENDED ON SITE. TEST SAMPLES SHALL FALL WITHIN TOLERANCES SHOWN ABOVE. PLANTING SHALL NOT BEGIN UNTIL SOIL HAS BEEN AMENDED AND SOIL TEST SAMPLES HAVE BEEN REVIEWED AND APPROVED BY OWNER AND LANDSCAPE ARCHITECT.

WOOD STAKES

SAUCER BERM

PLANTING MIX

MINIMUM LIMIT

PREPARED


OF MULCH

THIS DETAIL APPLIES TO BOTH

SINGLE STEM AND MULTI-STEM


<u>PLAN</u>

TREES

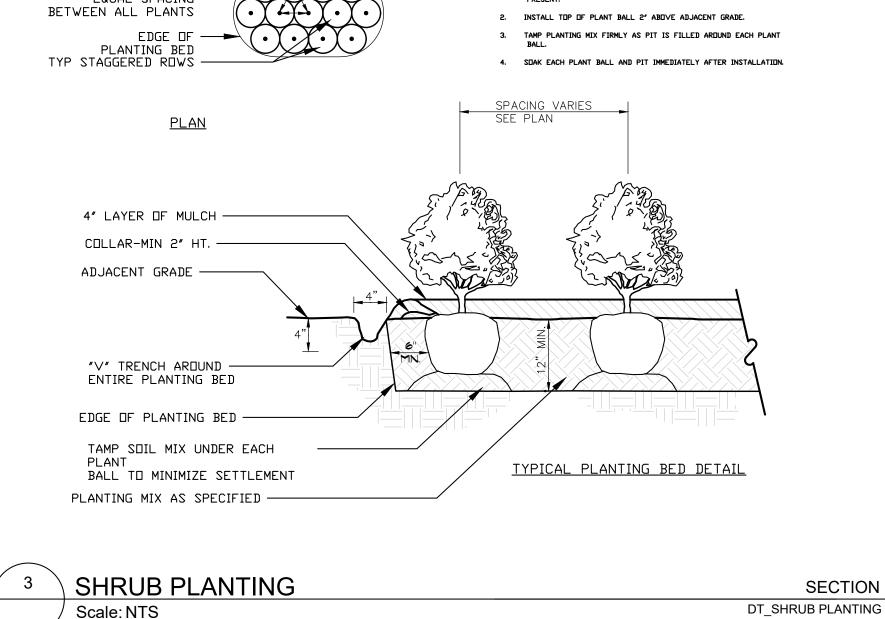

GENERAL NOTES:

1. DMIT COLLAR ARDUND EACH SHRUB WHEN IRRIGATION SYSTEM IS

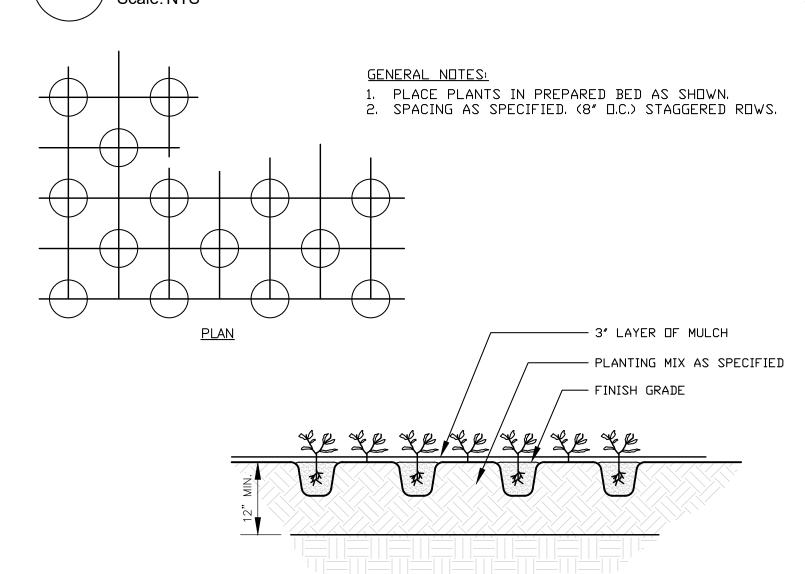





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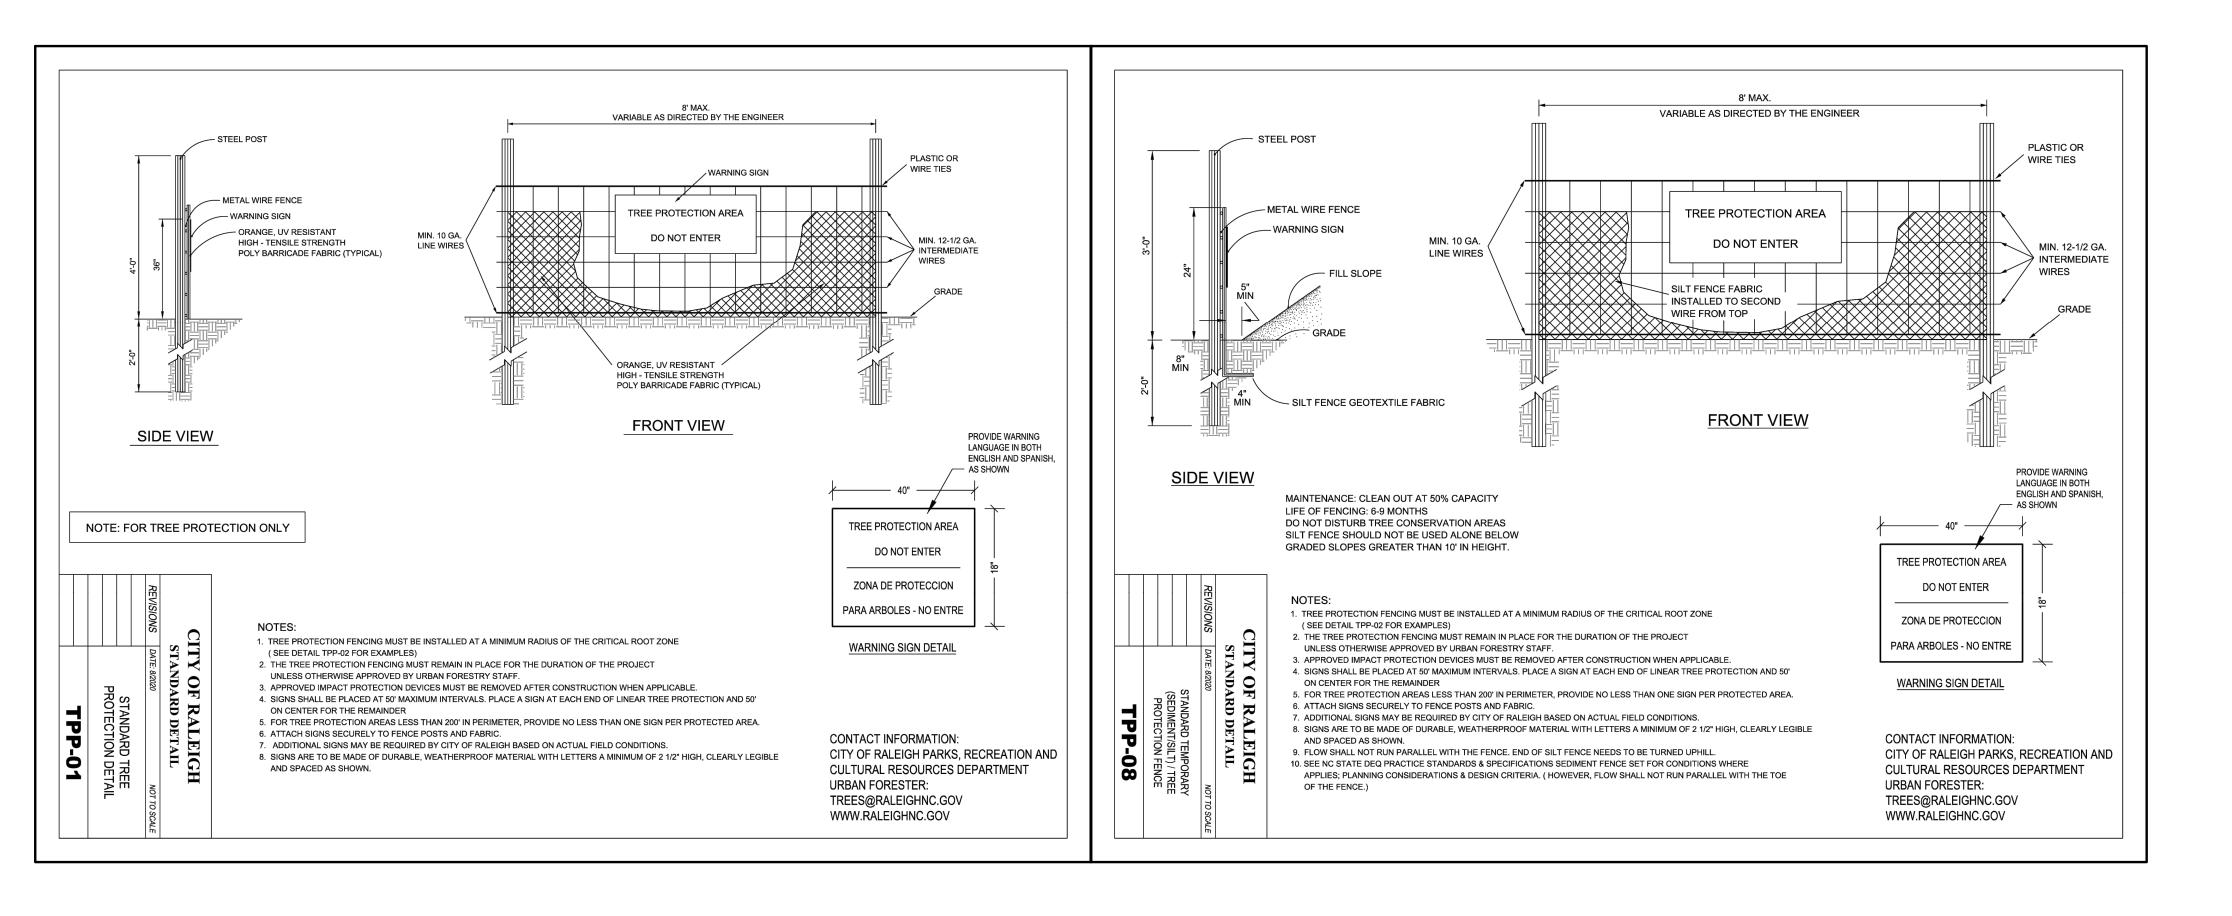
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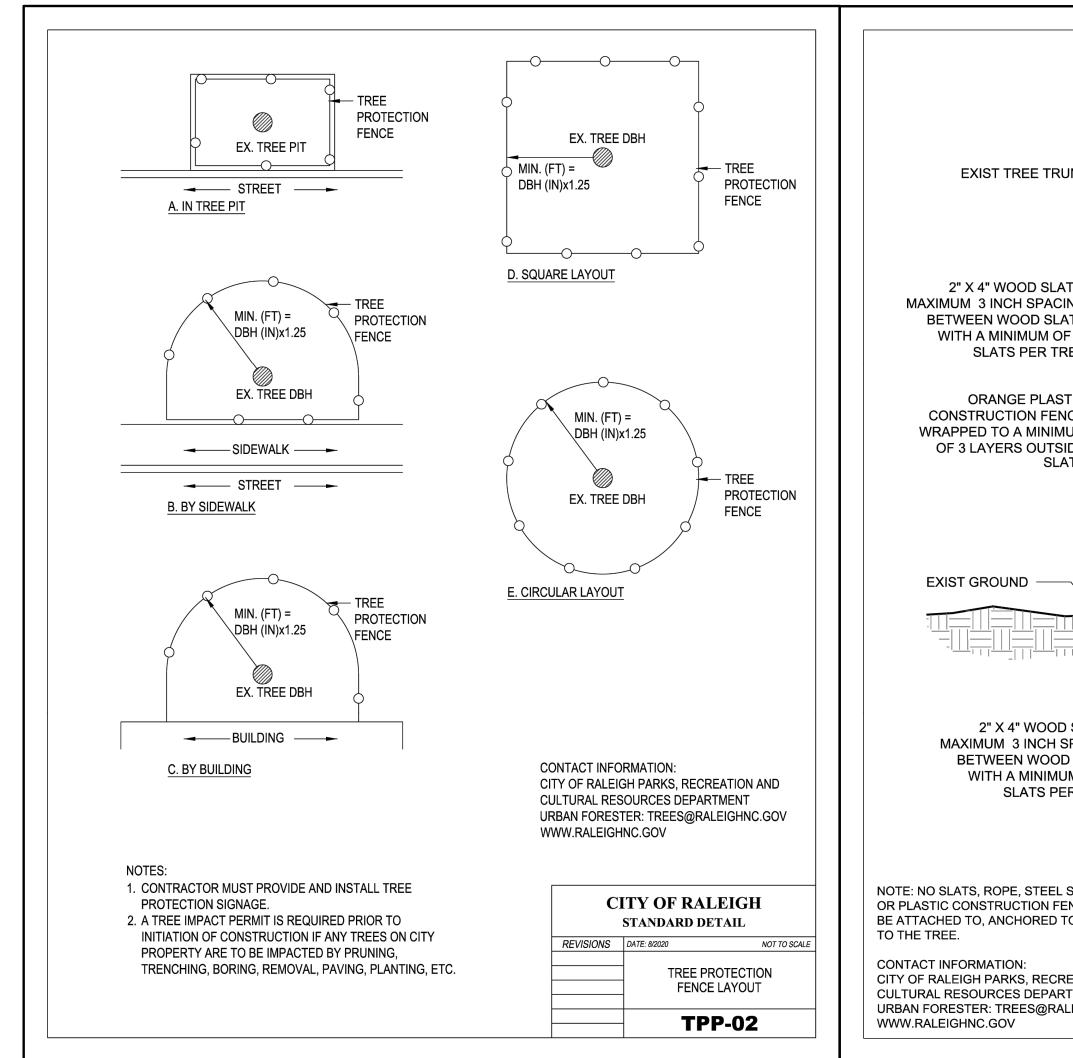
Date: 05/12/2023 Sheet No:


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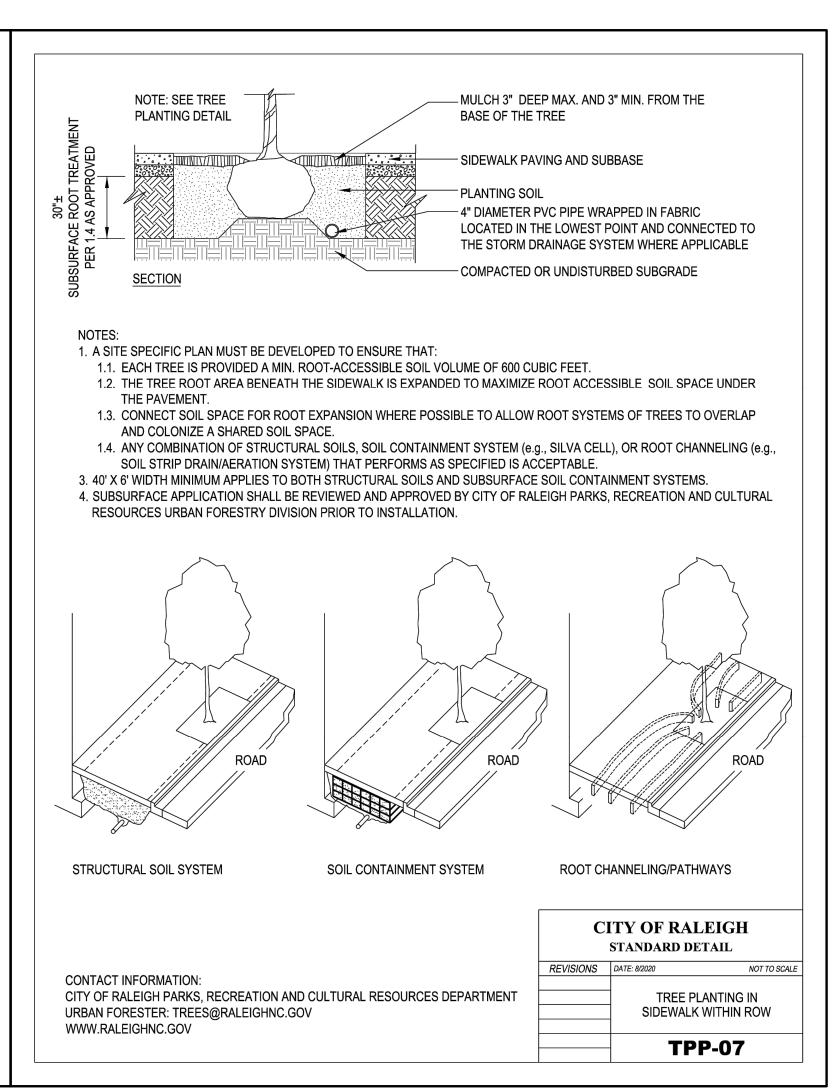
SECTION


DT_GROUNDCOVER PLANTING







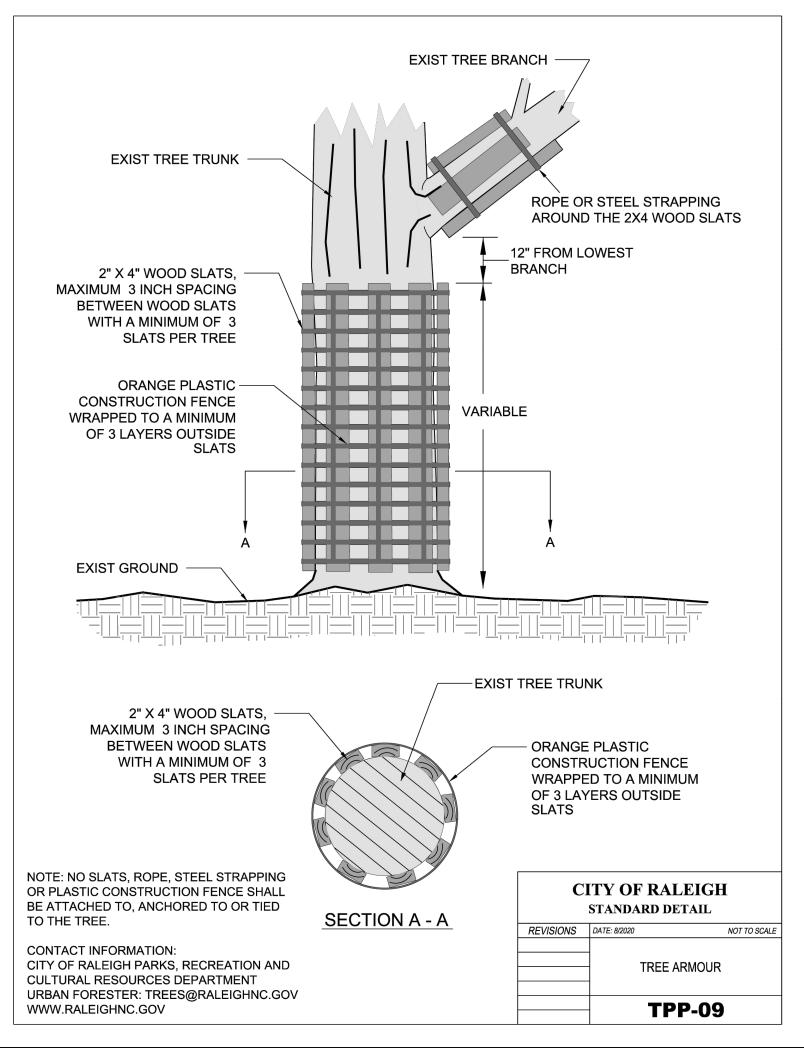

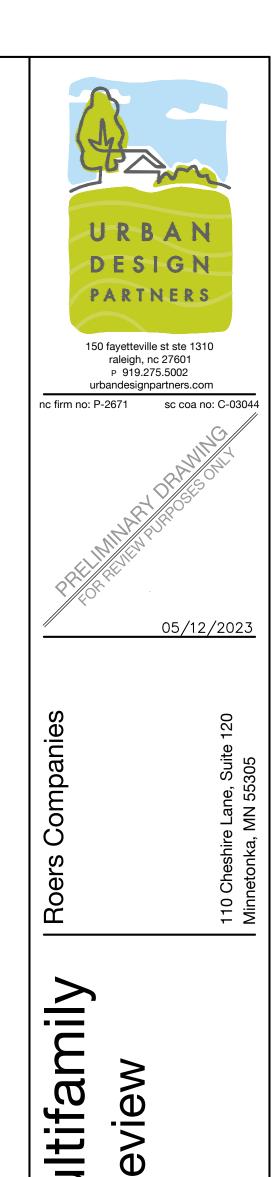

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Project No: 22-RDU-003

Date: 05/12/2023

Sheet No:

Setails igh, NC 2761

Scap Poole Rd.,

and 300 old

BUILDING A

ELEVATIONS



GENERAL NOTES

A. BUILDING FOUNDATIONS MUST HAVE A MINIMUM OF 12" EXPOSED BRICK ABOVE FINISHED GRADE (AFTER LANDSCAPING)

D. ALL WINDOWS WILL BE INSULATED, DOUBLE PANE, VINYL MEETING CURRENT NORTH CAROLINA MODEL ENERGY CODE.

4

KEY PLAN

B. PROVIDE SEAMLESS GUTTERS AND ALUMINUM DRIP EDGES.

C. ALL ROOF COVERINGS MUST HAVE A MINIMUM 30-YEAR WARRANTY.

BUILDING A WEST ELEVATION

A2.1.1 A4.1.1 1/16" = 1'-0"

A2.1.1 A4.1.1 1/16" = 1'-0"

A2.1.1 A4.1.1 1/16" = 1'-0"

FIBER CEMENT HORIZONTAL SIDING, TYP. -FIBER CEMENT VERTICAL SIDING, TYP. FIBER CEMENT PANELS WITH REVEALS, TYP. BRICK MASONRY VENEER, **BUILDING A SOUTH ELEVATION**

- FIBER CEMENT VERTICAL SIDING, TYP.



- FIBER CEMENT VERTICAL SIDING, TYP. Level 4 30' - 0" Level 3 20' - 0"

BUILDING A EAST ELEVATION

FIBER CEMENT

HORIZONTAL SIDING, TYP. —

FIBER CEMENT PANELS WITH REVEALS, TYP.

BRICK MASONRY VENEER,

FIBER CEMENT

HORIZONTAL SIDING, TYP.

_FIBER CEMENT PANELS _ WITH REVEALS, TYP. -

BRICK MASONRY VENEER,

TYP. —

GENERAL NOTES

- A. BUILDING FOUNDATIONS MUST HAVE A MINIMUM OF 12" EXPOSED BRICK ABOVE FINISHED GRADE (AFTER LANDSCAPING)
- B. PROVIDE SEAMLESS GUTTERS AND ALUMINUM DRIP EDGES.
- C. ALL ROOF COVERINGS MUST HAVE A MINIMUM 30-YEAR WARRANTY.
- D. ALL WINDOWS WILL BE INSULATED, DOUBLE PANE, VINYL MEETING CURRENT NORTH CAROLINA MODEL ENERGY CODE.

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KEY PLAN

BUILDING B ELEVATIONS

A4.1.2

Raleigh,

ROAD

OLD POOLE

PROJECT NO: 123456 DATE: August 25, 2022

REVISIONS
DATE DESCRIPTION

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