

Case File / Name: ASR-0033-2022
DSLC - CABARRUS AND DAWSON RESIDENCES

City of Raleigh
Development Services Department
One Exchange Plaza
Raleigh, NC 27602
(919) 996-2492
currentplanning@raleighnc.gov
www.raleighnc.gov

LOCATION: This 1.17 acre site zoned DX-12-UG is located on the southwest corner of the

intersection of W Cabarrus Street and S Dawson Street at 301 W. Cabarrus and

510-518 S. Dawson Street.

REQUEST: This is a proposed 12 story multi-unit apartment building (257 dwelling units) of

273,252 square feet with associated parking deck and amenities.

DESIGN

ADJUSTMENT(S)/

ALTERNATES, ETC: N/A

FINDINGS: City Administration finds that this request, with the below conditions of

approval being met, conforms to the Unified Development Ordinance. This approval is based on a preliminary plan dated July 11, 2023 by J DAVIS

ARCHITECTS.

CONDITIONS OF APPROVAL and NEXT STEPS:

This document must be applied to the second sheet of all future submittals except for final plats. This is a preliminary plan and as such no permits have been issued with this approval. To obtain permits and/or completion of the project, the following steps are required:

☑ <u>SITE PERMITTING REVIEW</u> - For land disturbance of 12,000 square feet or greater, public or private infrastructure, shared stormwater devices, etc. Site Permitting Review may be submitted upon receipt of this signed approval document.

The following items are required prior to approval of Site Permitting Review plans:

General

- 1. Approval letter from North Carolina Railroad Company (NCRR) and Northern Southern. (see NCRR letter of 6/8/23 attached)
- 2. A recombination map shall be recorded, recombining the existing lots into one parcel.
- 3. The solid waste will serve letter indicates the needs for compacted trash containers at the street no less than 3 days per week. Recycling is not cited and it is unclear as to the impacts to sidewalk accessibility. Prior to SPR approval there will be a detailed plan as to solid waste and an action plan of the developer for staging and return of carts without impact to pedestrians and ADA passage requirements.
- 4. Per discussion and email dated June 19th, the water and sewer utilities will be relocated to the Dawson Street side of the building for permitting through the SPR process and the developer will obtain the appropriate permits through the City of Raleigh and NCDOT for encroachment agreements prior to SPR approval. The current plan does not show that but per correspondence this condition of approval is based upon relocation to Dawson Street.
- Signal upgrades will be required at the intersection due to proximity of improvements and impact to
 existing signal at Dawson and Cabarrus Streets. A signal plan will need to be approved by NCDOT
 and the City of Raleigh prior to Site Permitting Review permit issuance.



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Engineering

- Required NCDOT encroachment and/or driveway permits must be approved and copies provided to the City of Raleigh Transportation Department – Mobility Strategy and Infrastructure Division prior to Site Permit review approval.
- A Traffic Control and Pedestrian (TCPED) Plan must be approved and a right-of-way occupancy permit must be obtained from Right-of-way Services for any construction activities within the right-of-way.

Stormwater

- 8. A surety equal to of the cost of clearing, grubbing and reseeding a site, shall be paid to the City (UDO 9.4.4).
- 9. A nitrogen offset payment must be made to a qualifying mitigation bank (UDO 9.2.2.B).
- 10. A stormwater control plan with a stormwater operations and maintenance manual and budget shall be approved (UDO 9.2).

☑ <u>LEGAL DOCUMENTS</u> - Email to legaldocumentreview@raleighnc.gov. Legal documents must be approved, executed, and recorded prior to or in conjunction with the recorded plat on which the associated easements are shown. Copies of recorded documents must be returned to the City within one business day of recording to avoid withholding of further permit issuance.

☑	Right of Way Deed of Easement Required
Ø	Slope Easement Deed of Easement Required

☑	Sidewalk Deed of Easement Required

☑ **RECORDED MAP(S)** - Submit plat to record new property lines, easements, tree conservation areas, etc.). Plats may be submitted for review when the Site Permitting Review plans, if required, have been deemed ready for mylar signature.

The following items must be approved prior to recording the plat:

Engineering

1. A sidewalk deed of easement, in addition to a plat showing the location of the easement, shall be submitted to the Planning and Development Services Department for review, and if acceptable, approved for recordation. Approved plats must be recorded at the Wake County Register of Deeds Office on or before the 14th day following approval by the City. The 14-day expiration date shall be clearly indicated on the plat. By the end of the next business day following recordation of the plat, all required legal instruments (including deeds of easement) shall be recorded, and recorded copies of the plat and all legal instruments required by the City in association with development approval shall be provided to the City. (Reference: UDO 8.1.7.A; 10.2.5.F.4.d)



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- 2. A slope easement deed of easement, in addition to a plat showing the location of the easement, shall be submitted to the Planning and Development Services Department for review, and if acceptable, approved for recordation. Approved plats must be recorded at the Wake County Register of Deeds Office on or before the 14th day following approval by the City. The 14-day expiration date shall be clearly indicated on the plat. By the end of the next business day following recordation of the plat, all required legal instruments (including deeds of easement) shall be recorded, and recorded copies of the plat and all legal instruments required by the City in association with development approval shall be provided to the City. (Reference: UDO 8.1.7.A; 10.2.5.F.4.d)
- 3. A public street right-of-way deed of easement, in addition to a plat showing the location of the easement, shall be submitted to the Planning and Development Services Department for review, and if acceptable, approved for recordation. Approved plats must be recorded at the Wake County Register of Deeds Office on or before the 14th day following approval by the City. The 14-day expiration date shall be clearly indicated on the plat. By the end of the next business day following recordation of the plat, all required legal instruments (including deeds of easement) shall be recorded, and recorded copies of the plat and all legal instruments required by the City in association with development approval shall be provided to the City. (Reference: UDO 8.1.7.A; 10.2.5.F.4.d)

Stormwater

 All stormwater control measures and means of transporting stormwater runoff to and from any nitrogen and stormwater runoff control measures shall be shown on all plats for recording as private drainage easements (UDO 9.2).

☑ <u>BUILDING PERMITS</u> - For buildings and structures shown on the approved plans. Commercial building permit plans must include the signed, approved Site Permitting Review plans attached, if applicable. Permit sets may be reviewed prior to the recordation of required plats, but cannot be approved.

The following items must be approved prior to the issuance of building permits:

General

1. A demolition permit shall be obtained.

Engineering

- A public infrastructure surety shall be provided to City of Raleigh Transportation Development Engineering Division (UDO 8.1.3) in the amount of 100% of the improvement cost for the NCDOT portion and 125% of the improvement cost for the City of Raleigh infrastructure.
- 3. A fee-in-lieu for full transit stop based upon UDO 8.11 shall be paid to the City of Raleigh (UDO 8.1.10).

Stormwater



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- 4. A surety equal to 125% of the cost of the construction of a stormwater device shall be paid to the Engineering Services Department (UDO 9.2.2.D.1.d).
- 5. A payment equal to twenty-four percent (24%) of the estimated cost of constructing all stormwater control facilities shown on the development plans shall be paid by the developer to the City stormwater facility replacement fund (UDO 9.2.2.G.3).
- 6. All stormwater control measures and means of transporting stormwater runoff to and from any nitrogen and stormwater runoff control measures shall be shown on all plats for recording as private drainage easements (UDO 9.2).

Urban Forestry

- 7. A tree impact permit must be obtained for the approved streetscape tree installation in the rights-of-way. This development proposes 8 street trees along S. Dawson Street and 5 street trees along W. Cabarrus Street.
- 8. A public infrastructure surety for 13 street trees in tree grates shall be provided to City of Raleigh Transportation - Development Engineering Division (UDO 8.1.3) in the amount of 100% of the improvement cost for the NCDOT portion, 8 street trees in tree grates, and 125% of the improvement cost for the City of Raleigh infrastructure, 5 street trees in tree grates.

The following are required prior to issuance of building occupancy permit:

General

- 1. All street lights and street signs required as part of the development approval are installed.
- 2. Required public right-of-way infrastructure improvements shall be, at a minimum, sufficiently completed to provide the necessary, safe emergency and vehicular access.
- Final inspection of all right of way street trees by Urban Forestry Staff.

Stormwater

- As-built impervious survey is accepted by the Engineering Services Department (UDO 9.2).
- 5. As-built drawings and associated forms for all Stormwater devices are accepted by the Engineering Services Department (UDO 9.2.2.D.3).

EXPIRATION DATES: The expiration provisions of UDO Section 10.2.8 E, including the ability to request extensions in the expiration date, apply to this site plan. If significant construction has not taken place on a project after administrative site review approval, that approval may expire and be declared void, requiring re-approval before permits may be issued. To avoid allowing this plan approval to expire the following must take place by the following dates:



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3-Year Expiration Date: August 9, 2026

Obtain a valid building permit for the total area of the project, or a phase of the project.

4-Year Completion Date:

Within four years after issuance of the first building permit for the site plan, the construction of the entire site plan must be completed unless an applicant has been granted vested rights. Failure to complete construction within this specified time frame shall automatically void the approved site plan for which no building permits have been issued.

I hereby certify the	his administrative decision.			
Signed:	Daniel L. Stegall	Date:	08/09/2023	
	Development Services Dir/Designee	_		_
Staff Coordinat	or: Michael Walters			

THIS SITE COMPLIES WITH UDO 18TH SUPPLEMENT DATED JANUARY, 2022


ASR-0033-2022

Administrative Site Review

1st Submittal: April 22, 2022 2nd Submittal: July 06, 2022 3rd Submittal: June 13, 2023 4th Submittal: July 11, 2023

Cabarrus & Dawson Residences

301 W Cabarrus St and 510 & 518 S Dawson Street, Raleigh, North Carolina 27601

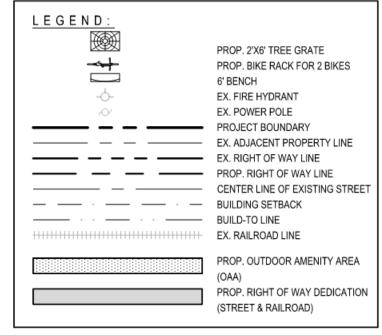

DAWSON STREET COORDINATION NOTE DAWSON STREET IS SCHEDULED FOR REPAVING, RESTRIPING, AND DOWN SPEED BY



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GFL WILL SERVE LETTER & NCDOT STREET TREE APPROVAL LETTER	_ 1.1	DETAILS	C-3	4TH FLOOR - OVERALL PLAN
EXISTING CONDITIONS PLAN	_ 1 OF 1	STORMFILTER & DETENTION BASIN DETAILS	C-4	12TH FLOOR - OVERALL PLAN
DEMOLITION PLAN	_ 2.1	LANDSCAPE PLAN (CODE COMPLIANT)	LP1.1	ROOF PLAN - OVERALL
SITE PLAN	_ LS1.1	PLANTINGS FOR RETAINING WALLS & PLANTERS	LP2.1	BUILDING OVERALL ELEVATIONS
TRANSPORTATION PLAN	LS2.1	LANDSCAPE DETAILS	LP9.1	BUILDING OVERALL ELEVATIONS
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Notes

- GENERAL NOTES ALL CONSTRUCTION SHALL BE IN ACCORDANCE WITH CITY OF RALEIGH AND/OR NCDOT STANDARDS.
- THE CONTRACTOR SHALL CONDUCT THE WORK IN A SAFE MANNER AND WITH A MINIMUM AMOUNT OF INCONVENIENCE TO TRAFFIC. 3. PRIOR TO CONSTRUCTION BEGINNING, ALL SIGNAGE AND TRAFFIC CONTROL SHALL BE IN PLACE.
- THE CONTRACTOR SHALL REPAIR ALL DAMAGED INFRASTRUCTURE IN THE RIGHT-OF-WAY AND RESTORE IT TO PREVIOUS OR BETTER CONDITION.
- 5. THE CONTRACTOR SHALL REPAIR ANY DAMAGES TO ADJACENT PROPERTIES AND RESTORE IT TO PREVIOUS OR BETTER CONDITION. IF UNFORESEEN CONDITIONS DEVELOP DURING CONSTRUCTION, REFER TO "CITY OF RALEIGH STREET DESIGN MANUAL" AND CONTACT THE DEVELOPMENT
- IF CONSTRUCTION PLANS FOR PUBLIC AND PRIVATE STREETS OR UTILITIES SHOWN ON THIS PLAN ARE REQUIRED, THEY MUST BE APPROVED BY TRANSPORTATION
- AND PUBLIC UTILITIES DEPARTMENTS PRIOR TO ISSUANCE OF PERMITS OR RECORDING OF ANY PLAT FOR THIS DEVELOPMENT. FIELD ADJUSTMENTS TO THIS PLAN MAY BE REQUIRED BY CITY OF RALEIGH INSPECTOR AS NEEDED DURING CONSTRUCTION.
- AND SUPPLEMENTAL INFORMATION WAS OBTAINED FROM WAKE COUNTY GIS IN MARCH 2022
- 10. WITHIN THE SIGHT TRIANGLES SHOWN ON THIS PLAN, NO OBSTRUCTION BETWEEN 2 FEET AND 8 FEET IN HEIGHT ABOVE THE CURB LINE ELEVATION SHALL BE LOCATED IN WHOLE OR PART. OBSTRUCTIONS INCLUDE BUT ARE NOT LIMITED TO ANY BERM, FOLIAGE, FENCE, WALL, SIGN, OR PARKED VEHICLE.
- UNLESS NOTED, ACCESS ROUTE FOR EMERGENCY VEHICLES SHALL PROVIDE AN INSIDE TURNING RADIUS OF 28' MINIMUM. UNLESS NOTED, ALL DIMENSIONS SHOWN ARE TO BACK OF CURB.
- 13. TRASH AND CARDBOARD DUMPSTER(S) ENCLOSURE SHALL COMPATIBLE WITH MATERIAL AND/OR COLOR OF THE PRINCIPAL BUILDING.
- . GROUND-MOUNTED MECHANICAL EQUIPMENT MUST ADHERE TO THE SCREENING REQUIREMENTS OF SEC 7.2.5.D.4 AND IS NOT ONLY LIMITED TO BEING VISIBLE CONTRACTOR TO FIELD LOCATE AND VERIFY ALL EXISTING UTILITIES PRIOR TO CONSTRUCTION AND REPORT ANY DISCREPANCIES TO LANDSCAPE ARCHITECT
- PRIOR TO ANY CONSTRUCTION ACTIVITIES. CONTACT NC ONE AT 811 FOR FIELD LOCATION OF UNDERGROUND UTILITIES. 16. HANDICAP PARKING SPACE(S) AND HC ACCESS AISLE(S) SHALL BE NO GREATER THAN TWO PERCENT (2%) PITCH IN ANY DIRECTION AS PER ADA STANDARDS.
- 17. PROVIDE SIGNAGE AND STRIPING OF HANDICAP SPACES AS PER ADA STANDARDS 18. ALL RETAINING WALLS GREATER THAN 30" IN HEIGHT TO INCLUDE SAFETY RAIL OR FENCE.
- 19. THE MINIMUM CORNER CLEARANCE FROM THE CURB LINE OF INTERSECTING STREETS SHALL BE AT LEAST 20 FEET FROM THE POINT OF TANGENCY OF THE CURB.

NO DRIVEWAYS SHALL ENCROACH ON THIS MINIMUM CORNER CLEARANCE.

- 20. WC ACCESS RAMPS WILL BE PROVIDED IN ACCORDANCE WITH CITY OF RALEIGH PUBLIC WORKS DEPARTMENT STANDARDS, PROWAG STANDARDS AND ADAAG
- 21. ALL RAMPS AND HANDRAILS SHALL BE CONFORM TO ANSI, NCSBC, AND ICC STANDARDS AND SPECIFICATIONS.
- 22. ALL ABOVE GROUND UTILITY DEVICES (TO INCLUDE BUT NOT LIMITED TO TELEPHONE AND CABLE PEDESTALS, ELECTRICAL TRANSFORMERS, BACKFLOW DEVICE
- HOTBOX, ETC) SHALL BE SCREENED FROM OFF-SITE VIEW BY EVERGREEN SHRUBS, FENCE, OR WALL. 23. THIS PROJECT TO HAVE ALL MECHANICAL/HVAC UNITS ON ROOF AND SCREENED WITH PARAPETS.
- 24. UTILITY PLACEMENT EASEMENT IS FOR INSTALLATION OF PRIVATE UTILITIES.
- 25. SPECIAL USE PERMIT REQUIRED FOR POOLS WITH ANY LINEAR DIMENSION GREATER 65 FEET OR WITH ANY AREA IN EXCESS OF 4,000 SQUARE FEET.

FIRE DEPARTMENT NOTES

- ALL SURVEY INFORMATION PROVIDED TO JDAVIS ARCHITECTS BY BASS, NIXON AND KENNEDY, INC. IN RALEIGH NORTH CAROLINA IN DIGITAL FORMAT IN MARCH 2022 1. THE APPARATUS ROAD SURFACE IS REQUIRED TO BE WITHIN 200 FEET (NFPA 13R) OR 250 FEET (NFPA13) TO ALL PORTIONS OF THE EXTERIOR WALL OF THE FIRST
 - 2. FIRE HYDRANT SHALL BE LOCATED WITHIN 400' AS MEASURED ALONG THE PATH OF APPARATUS ACCESS ROAD (NCFC 507.5.1)
 - ALL NEW FIRE HYDRANTS SHALL BE EQUIPPED WITH NST THREADS AND WITH A 5 INCH STORZ CONNECTION. FIRE FLOW ANALYSIS MUST BE PROVED AT TIME OF BUILDING PERMITS PER THE 2018 NCFC, SECTION 507.3.

SOLID WASTE INSPECTION STATEMENTS

- SOLID WASTE SERVICES ARE TO BE PROVIDED BY PRIVATE VENDOR.
- THE DEVELOPER WILL COMPLY WITH ALL REQUIREMENTS SET FORTH IN THE SOLID WASTE MANUAL. THIS PROJECT HAS A DUMPSTERS FOR SOLID WASTE AND SINGLE-STREAM RECYCLING.
- 4. DUMPSTERS ARE STORED IN THE BUILDING SERVICE AREA AND WILL BE ROLLED OUT AT THE TIME OF SERVICE. DUMPSTERS WILL BE REMOVED FROM POINT OF

THIS PROJECT SITE IS LESS THAN 2 ACRES. TREE CONSERVATION IS NOT REQUIRED PER UDO SEC. 9.1.2.

UDO SEC. 8.3.2 BLOCK STANDARDS THIS SITE GROSS ACREAGE IS LESS THAN THE MINIMUM 2.0 AC. AND IS EXEMPT FROM BLOCK PERIMETER STANDARDS

CROSS ACCESS

UDO SEC. 8.3.5.D.5 CROSS ACCESS

THIS SITE IS EXEMPT FROM CROSS ACCESS BECAUSE OF THE INTERVENING RAILROAD PER CODE SECTION 8.3.D.5.b.ii.

TRAFFIC CONTROL AND PEDESTRIAN PLAN (TCPED) NOTES PRIOR TO ANY WORK THAT IMPACTS THE RIGHT-OF-WAY, CLOSING OR DETOURING OF ANY STREET, LANE, OR SIDEWALK, THE CONTRACTOR MUST APPLY FOR A

- PERMIT WITH RIGHT-OF-WAY SERVICES. PLEASE DIRECT ANY QUESTIONS TO RIGHTOFWAYSERVICES@RALEIGHNC.GOV. THE STREET, LANE, SIDEWALK, CLOSURE PERMIT IS REQUIRED FOR ANY CLOSURE ON CITY STREETS AND ALL NCDOT STREETS WITHIN RALEIGH'S JURISDICTION.
- 3. A PERMIT REQUEST WITH A TCPED PLAN SHALL BE SUBMITTED TO RIGHT-OF-WAY SERVICES THROUGH THE CITY OF RALEIGH PERMIT AND DEVELOPMENT PORTAL. 4. PRIOR TO THE START OF WORK, THE CLIENT SHALL SCHEDULE A PRE-CONSTRUCTION MEETING WITH THE ENGINEERING INSPECTIONS COORDINATOR TO REVIEW
- THE SPECIFIC COMPONENTS OF THE APPROVED PLAN, AND ENSURE ALL PERMITS ARE ISSUED. 5. ALL TCPED PLANS SHALL COMPLY WITH ALL LOCAL, STATE, AND FEDERAL REQUIREMENTS AND STANDARDS, INCLUDING BUT NOT LIMITED TO:
- MANUAL ON UNIFORM TRAFFIC CONTROL (MUTCD);
- PUBLIC RIGHTS-OF-WAY ACCESSIBILITY GUIDELINES (PROWAG);
- AMERICAN DISABLILITY ACT (ADA) REQUIREMENTS; RALEIGH STREET DESIGN MANUAL (RSDM).
- ALL PUBLIC SIDEWALKS MUST BE ACCESSIBLE TO PEDESTRIANS WHO ARE VISUALLY IMPAIRED AND/OR PEOPLE WITH MOBILITY CONCERNS, EXISTING AND ALTERNATIVE PEDESTRIAN ROUTES DURING CONSTRUCTION SHALL BE REQUIRED TO BE COMPLIANT WITH THE PUBLIC RIGHTS OF WAY ACCESSIBLITY GUIDELINES
- (PROWAG), THE ADA STANDARDS FOR ACCESSIBLE DESIGN AND THE MANUAL ON UNIFORM TRAFFIC CONTROL DEVICES (MUTCD). 7. ALL PERMITS MUST BE AVAILABLE AND VISIBLE ON SITE DURING THE OPERATION

ENGINEER

Project Team

Compass Raleigh 1031, LLC 2217 Stantonsburg Road Greenville, North Carolina 27834 jeremy.small@eqtexeter.com

Raleigh-Dawson Assemblage, LLC Taft Family Vent-Frankie 2217 Stantonsburg Road Greenville, North Carolina 27834 jeremy.small@eqtexeter.com

DEVELOPER

101 West Elm Street, Suite 600 Conshohocken, Pennsylvania 19428

jeremy.small@eqtexeter.com

LANDSCAPE ARCHITECT JDavis Architects, PC 510 S. Wilmington Street Raleigh, North Carolina 27601 919.835.1500

kent@jdavisarchitects.com

919.835.1510 (fax)

JDavis Architects, PC 510 S. Wilmington Street Raleigh, North Carolina 27601 919.835.1500 919.835.1510 (fax) bille@jdavisarchitects.com

ARCHITECT

Crumpler Consulting Services, PLLC 2308 Ridge Road Raleigh, North Carolina 27612 josh@crumplerconsulting.com

SURVEYOR Bass, Nixon and Kennedy, Inc. 6310 Chapel Hill Road, Suite 250 Raleigh, North Carolina 27607 919.851.4422 919.851.8968 (fax) dan.gregory@BNKinc.com

Administrative Site Review Application

Site Plan Tier: Tier Two Site Plan

Gross site acreage: 1.17 AC

of parking spaces proposed: 288

Overlay District (if applicable): N/A



This form is required when submitting site plans as referenced in Unified Development Ordinance (UDO) Section 10.2.8. Please check the appropriate building types and include the plan checklist document when submitting.

Office Use Only: Case #

Please review UDO Section 10.2.8. as amended by text change case TC-14-19 to determine the site plan tier. If assistance determining a Site Plan Tier is needed a Site Plan Tier Verification request can be submitted online via the Permit and Development Portal. (Note: There is a fee for this verification service.)

Tier Three Site Plan ✓

Building Type		Site Transaction History
Detached	General	Subdivision case #:
Attachad	Missadusas	Scoping/sketch plan case #:
Attached	Mixed use	Certificate of Appropriateness #:
✓ Apartment	Open lot	
Townhouse	Civic	Zoning Case #:
		Administrative Alternate #:
	GENERAL IN	IFORMATION
Development name: Cabarrus and Daws	on Residences	
Inside City limits? Yes 🗸 No		
Property address(es): 301 W Ca	barrus St a	and 510 & 518 S Dawson St
Site P.I.N.(s): 1703565859, 1703		
Current Property Owner/Developer Cor	,	
NOTE: please attach purchase agree		
Company: Exeter Property Group Advisor		Title: Development Manager
Address: Five Radnor Corp Center,100 M		
Phone #: 240 620 2320	Email: Jeremy	y.Small@eqtexeter.com
Applicant Name: Ken Thompson		
Company: JDavis Architects	Address: 510	S Wilmington Street, Raleigh, NC 27601
Phone #: 919-612-6997	Email: kent@	jdavisarchitects.com
DEV		E + SITE DATE TABLE
0.77	(Applicable to a	Il developments)
SITE DATA		BUILDING DATA
Zoning district (if more than one, pleas acreage of each):	se provide the	Existing gross floor area (not to be demolished): 0 SF
DX-12-UG		Existing gross floor area to be demolished:

Proposed use (UDO 6.1.4):	Multi-Unit Living			
	STORMWATER	INFORMATION		
Existing Impervious Surface:		Proposed Impervi	ous Surface:	
Acres: 0.66 AC Square	e Feet: 28,617 SF	Acres: 1.12 AC	Square Fe	eet: 48,838 SF
Is this a flood hazard area?	Yes No 🗸	•		
If yes, please provide:				
Alluvial soils:				
Flood study:				
FEMA Map Panel #:				
Neuse River Buffer Yes	No 🗸	Wetlands	Yes 🗌	No 🗸

12,182 SF

New gross floor area: 273,252 SF

Proposed # of stories for each: 12

Proposed # of buildings: 1

Total sf gross (to remain and new): 273,252 SF

	RESID	ENTIAL DE	VELOPMENTS		
Total # of dwelling units: 257			Total # of hotel units: 0		
# of bedroom units: 1br 191	2br 66	3br 0	4br or more 0		
# of lots: 1			Is your project a cottage court?	Yes	No 🗸

SIGNATURE BLOCK

The undersigned indicates that the property owner(s) is aware of this application and that the proposed project described in this application will be maintained in all respects in accordance with the plans and specifications submitted herewith, and in accordance with the provisions and regulations of the City of Raleigh Unified Development Ordinance.

will serve as the agent regarding this application, and will receive and respond to administrative comments, resubmit plans and applicable documentation, and will represent the property owner(s) in any public meeting regarding this application.

I/we have read, acknowledge, and affirm that this project is conforming to all application requirements applicable with the proposed development use. I acknowledge that this application is subject to the filing calendar and submittal policy, which states applications will expire after 180 days of inactivity.

Signature: KOY

Date: 04.22.2022 Printed Name: Ken Thompson, RLA, Senior Associate, JDavis Architects

esiden

PROJECT: | EQT-21220

ISSUE: Administrative Site Review 04.22.2022 1st Review Comments 3rd Review Comments DRAWN BY: S CHECKED BY: CONTENT: COVER

ASR-0033-2022

GFL WILL SERVE LETTER



			λ	
20'	10'	0	20'	4
SCA	LE: 1" =	20'		

sid 518 PROJECT: EQT-21220 DATE ISSUE: Administrative Site Review 04.22.2022 07.06.2022 1st Review Comments

06.13.2023

07.11.2023

2nd Review Comments 3rd Review Comments


CONTENT: GFL WILL SERVE LETTER

ADMINISTRATIVE SITE REVIEW

REVISIONS:

DRAWN BY: SB CHECKED BY:

R:\2018\18224 - Cabarrus Dawson Mixed Use\SURVEY\18224CARLSON\dwg\18224 TOPO.dwg, 4/20/2022 1:21:40 PM, dang,

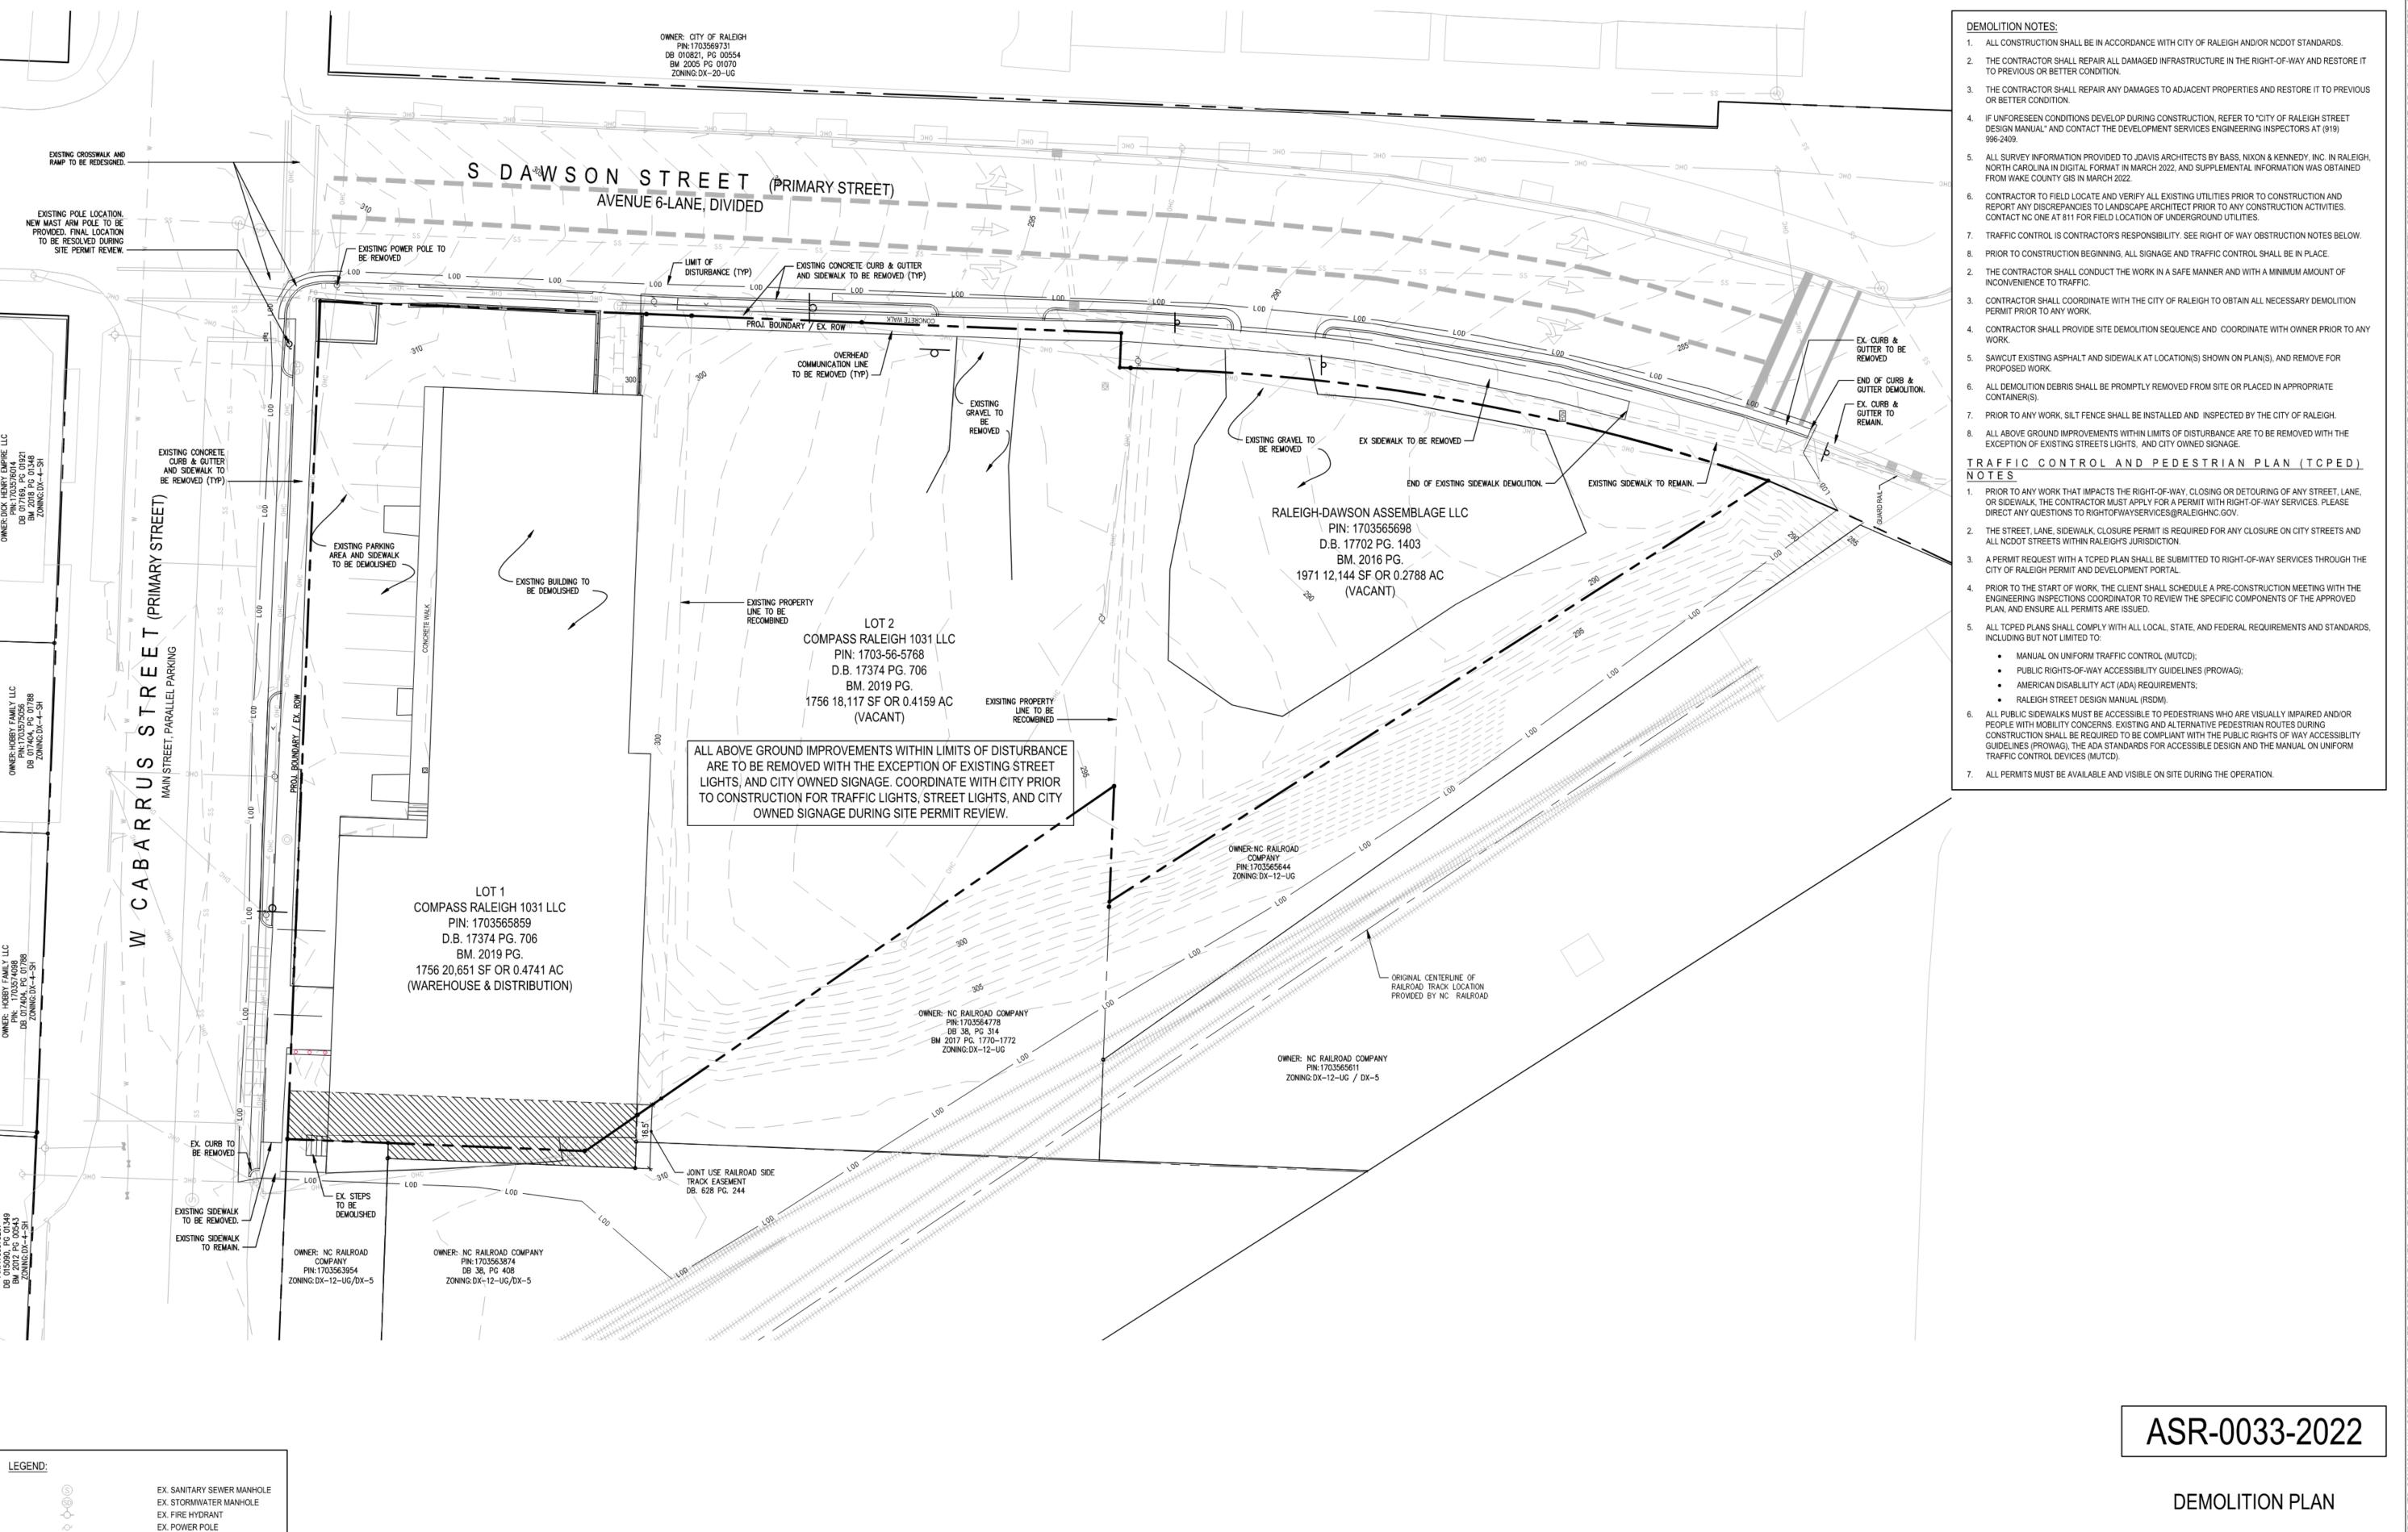

EX. ADJACENT PROPERTY LINE

EX. OVERHEAD UTILITY EX. SANITARY SEWER LINE

EX. STORMWATER LINE EX. WATER LINE EX. CONTOUR MAJOR LINE EX. CONTOUR MINOR LINE

EX. GAS LINE EX. RAILROAD LINE

LIMIT OF DISTURBANCE





20'	10'	0	20'	4
SCAL	_E: 1" =	20'		


Daws O

Caba 301 W Raleigh, I EQT

REVIEW SITE **ADMINISTRATIVE** PROJECT: EQT-21220 DATE

ISSUE: Administrative Site Review 04.22.2022 REVISIONS: 07.06.2022 1st Review Comments 2nd Review Comments 06.13.2023 3rd Review Comments 07.11.2023

DRAWN BY: S CHECKED BY: CONTENT: DEMOLITION PLAN

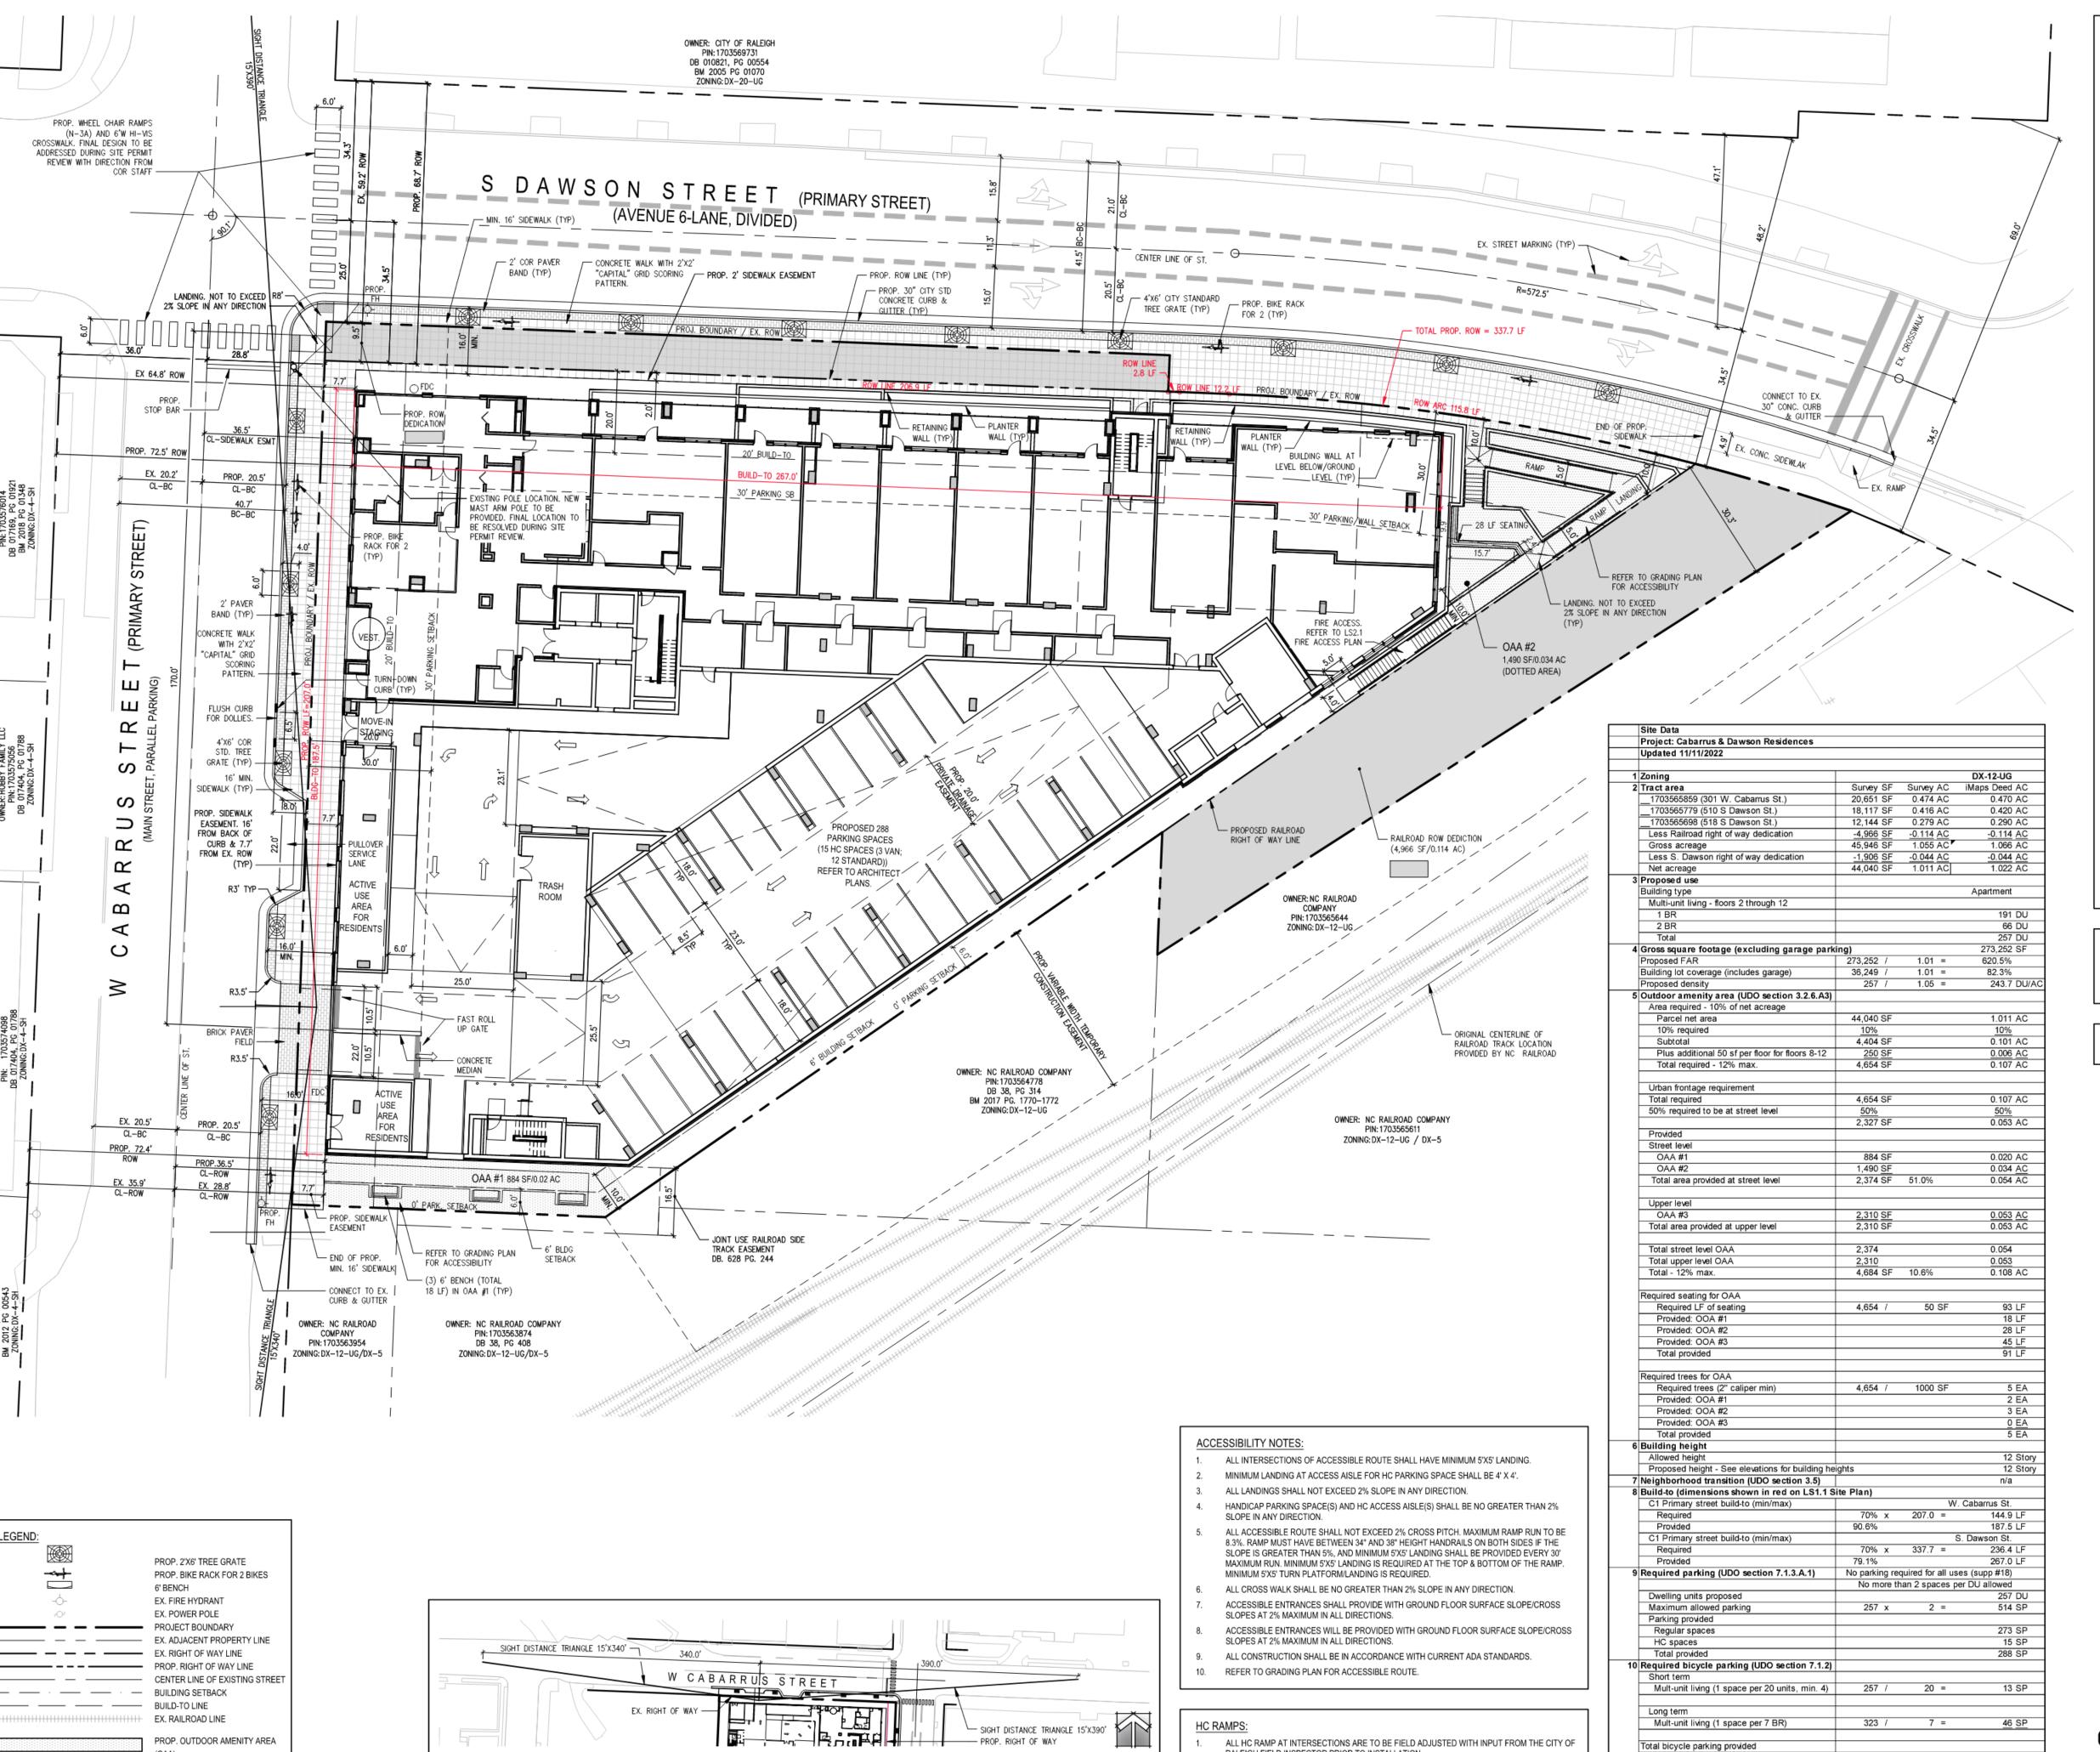

SIGHT DISTANCE TRIANGLES

RALEIGH FIELD INSPECTOR PRIOR TO INSTALLATION.

APPROPRIATE UTILITY COMPANY.

POWER POLES WHICH CONFLICT WITH FIELD LOCATED HC RAMPS ARE TO BE RELOCATED BY

(OAA)

PROP. RIGHT OF WAY DEDICATION

(STREET & RAILROAD)

GENERAL NOTES:

- ALL CONSTRUCTION SHALL BE IN ACCORDANCE WITH CITY OF RALEIGH AND/OR NCDOT
- THE CONTRACTOR SHALL CONDUCT THE WORK IN A SAFE MANNER AND WITH A MINIMUM AMOUNT OF INCONVENIENCE TO TRAFFIC.
- 3. PRIOR TO CONSTRUCTION BEGINNING, ALL SIGNAGE AND TRAFFIC CONTROL SHALL BE IN
- . THE CONTRACTOR SHALL REPAIR ALL DAMAGED INFRASTRUCTURE IN THE RIGHT-OF-WAY AND RESTORE IT TO PREVIOUS OR BETTER CONDITION.
- THE CONTRACTOR SHALL REPAIR ANY DAMAGES TO ADJACENT PROPERTIES AND RESTORE IT TO PREVIOUS OR BETTER CONDITION.
- IF UNFORESEEN CONDITIONS DEVELOP DURING CONSTRUCTION, REFER TO "CITY OF RALEIGH STREET DESIGN MANUAL" AND CONTACT THE DEVELOPMENT SERVICES ENGINEERING
- INSPECTORS AT (919) 996-2409.

 7. IF CONSTRUCTION PLANS FOR PUBLIC AND PRIVATE STREETS OR UTILITIES SHOWN ON THIS PLAN ARE REQUIRED, THEY MUST BE APPROVED BY TRANSPORTATION AND PUBLIC UTILITIES
- DEPARTMENTS PRIOR TO ISSUANCE OF PERMITS OR RECORDING OF ANY PLAT FOR THIS DEVELOPMENT.
- FIELD ADJUSTMENTS TO THIS PLAN MAY BE REQUIRED BY CITY OF RALEIGH INSPECTOR AS NEEDED DURING CONSTRUCTION.
- ALL SURVEY INFORMATION PROVIDED TO JDAVIS ARCHITECTS BY BASS, NIXON & KENNEDY, INC. IN RALEIGH, NORTH CAROLINA IN DIGITAL FORMAT IN MARCH 2022, AND SUPPLEMENTAL INFORMATION WAS OBTAINED FROM WAKE COUNTY GIS IN MARCH 2022.
- 10. WITHIN THE SIGHT TRIANGLES SHOWN ON THIS PLAN, NO OBSTRUCTION BETWEEN 2 FEET AND 8 FEET IN HEIGHT ABOVE THE CURB LINE ELEVATION SHALL BE LOCATED IN WHOLE OR PART. OBSTRUCTIONS INCLUDE BUT ARE NOT LIMITED TO ANY BERM, FOLIAGE, FENCE, WALL, SIGN, OR PARKED VEHICLE.
- UNLESS NOTED, ACCESS ROUTE FOR EMERGENCY VEHICLES SHALL PROVIDE AN INSIDE TURNING RADIUS OF 28' MINIMUM.
- 12. UNLESS NOTED, ALL DIMENSIONS SHOWN ARE TO BACK OF CURB.

UNDERGROUND UTILITIES.

- TRASH AND CARDBOARD DUMPSTER(S) ENCLOSURE SHALL COMPATIBLE WITH MATERIAL AND/OR COLOR OF THE PRINCIPAL BUILDING.
- GROUND-MOUNTED MECHANICAL EQUIPMENT MUST ADHERE TO THE SCREENING REQUIREMENTS OF SEC 7.2.5.D.4 AND IS NOT ONLY LIMITED TO BEING VISIBLE FROM THE PUBLIC RIGHT OF WAY.
- CONTRACTOR TO FIELD LOCATE AND VERIFY ALL EXISTING UTILITIES PRIOR TO CONSTRUCTION AND REPORT ANY DISCREPANCIES TO LANDSCAPE ARCHITECT PRIOR TO ANY CONSTRUCTION ACTIVITIES. CONTACT NC ONE AT 811 FOR FIELD LOCATION OF
- HANDICAP PARKING SPACE(S) AND HC ACCESS AISLE(S) SHALL BE NO GREATER THAN TWO PERCENT (2%) PITCH IN ANY DIRECTION AS PER ADA STANDARDS.
- 7. PROVIDE SIGNAGE AND STRIPING OF HANDICAP SPACES AS PER ADA STANDARDS.
- 8. ALL RETAINING WALLS GREATER THAN 30" IN HEIGHT TO INCLUDE SAFETY RAIL OR FENCE.
- 19. THE MINIMUM CORNER CLEARANCE FROM THE CURB LINE OF INTERSECTING STREETS SHALL BE AT LEAST 20 FEET FROM THE POINT OF TANGENCY OF THE CURB. NO DRIVEWAYS SHALL ENCROACH ON THIS MINIMUM CORNER CLEARANCE.
- WC ACCESS RAMPS WILL BE PROVIDED IN ACCORDANCE WITH CITY OF RALEIGH PUBLIC WORKS DEPARTMENT STANDARDS, PROWAG STANDARDS AND ADAAG SPECIFICATIONS
- ALL RAMPS AND HANDRAILS SHALL BE COMPLY WITH CURRENT ANSI, NCSBC, AND ICC STANDARDS AND SPECIFICATIONS.
- SWINGING DOORS AND GATE SHALL HAVE MANEUVERING CLEARANCE COMPLYING WITH CURRENT ANSI STANDARD.
- ALL ABOVE GROUND UTILITY DEVICES (TO INCLUDE BUT NOT LIMITED TO TELEPHONE AND CABLE PEDESTALS, ELECTRICAL TRANSFORMERS, BACKFLOW DEVICE HOTBOX, ETC) SHALL BE SCREENED FROM OFF-SITE VIEW BY EVERGREEN SHRUBS, FENCE, OR WALL.
- ALL HVAC EQUIPMENTS OF THIS PROJECT E TO BE LOCATED ON THE ROOF OF BUILDINGS AND SCREENED WITH PARAPETS.
- 25. UTILITY PLACEMENT EASEMENT IS FOR INSTALLATION OF PRIVATE UTILITIES.
- SPECIAL USE PERMIT REQUIRED FOR POOLS WITH ANY LINEAR DIMENSION GREATER 65 FEET OR WITH ANY AREA IN EXCESS OF 4,000 SQUARE FEET.

POOL IS PROPOSED ON THIRD FLOOR OF PROPOSED BUILDING. REFER TO THE FLOOR PLAN FOR THE SIZE AND DIMENSIONS.
POOL WILL NOT HAVE GREATER THAN 65 FEET LINEAR DIMENSION AND THE AREA WILL NOT EXCEED 4,000 SQUARE FEET.

SEE LS9.1 FOR SITE DETAILS.

PRIMARY STREET DETERMINATION (SEC. 1.5.4.C.1)

A LOT DEVELOPED WITH THE APARTMENT, GENERAL, MIXED-USE OR CIVIC BUILDING TYPES SHALL DESIGNATE ITS PRIMARY STREET USING THE CRITERIA SHOWN IN (A) THROUGH (G) BELOW. IF NO STREET MEETS CRITERIA (A) THROUGH (D), THEN THE STREET THAT THAT SATISFIES MORE OF CRITERIA (E) THROUGH (G) WILL BE DESIGNATED AS PRIMARY. IF THE

CRITERIA DO NOT APPLY OR DO NOT PRODUCE A CLEAR RESULT, TH DESIGNATED AS PRIMARY BY THE APPLICANT		
	CABARRUS	DAWSON
A. THE STREET WITH TRANSIT SERVICE;	NO	YES
B. THE STREET DESIGNATED AS A MAIN STREET OR URBAN		
THOROUGHFARE ON THE URBAN FORM MAP;	NO	NO
C. ANY STREET DESIGNATED AS A RETAIL STREET IN THE DOWNTOWN		
SECTION OF THE COMPREHENSIVE PLAN.	NO	NO
D. THE STREET DESIGNATED AS A MIXED-USE STREET ON THE RALEIGH		
STREET PLAN MAP;	YES	NO
PER SECTION 1.5.4.C.1, IF THREE OR FOUR STREETS MEET ANY OF		
CRITERIA (A) THROUGH (D), THE TWO STREETS THAT MEET MORE OF		
(A) THROUGH (D) WILL BE DESIGNATED AS PRIMARY; IF THEY MEET		
THE SAME NUMBER, THEN THE APPLICANT MAY CHOOSE THE TWO		
STREETS.	PRIMARY	PRIMARY

RESPONSE: BASED ON THE ABOVE, BOTH W. CABARRUS AND S. DAWSON ARE PRIMARY STREETS

ASR-0033-2022

SITE PLAN



14 SP

Know what's below.

Call before you dig.

On street - short term

Total provided

In park. deck - long term (Sheet A1.02 & 104.)

20'	10'	0	20'	40
SCA	LE: 1" =	20'		

Cabarrus & Dawson Residences

On Wind Cabarrus St and 510 & 518 S Dawson


ADMINISTRATIVE SITE REVIEW

PROJECT: EQT-21220

ISSUE:	Administrative Site Review	04.22.2022
REVISIONS:	1st Review Comments	07.06.2022
	2nd Review Comments	06.13.2023
	3rd Review Comments	07.11.2023
DRAWN BY:	KT, SB	
CHECKED BY:	кт	
CONTENT:	SITE PLAN	

DATE

LS1.1

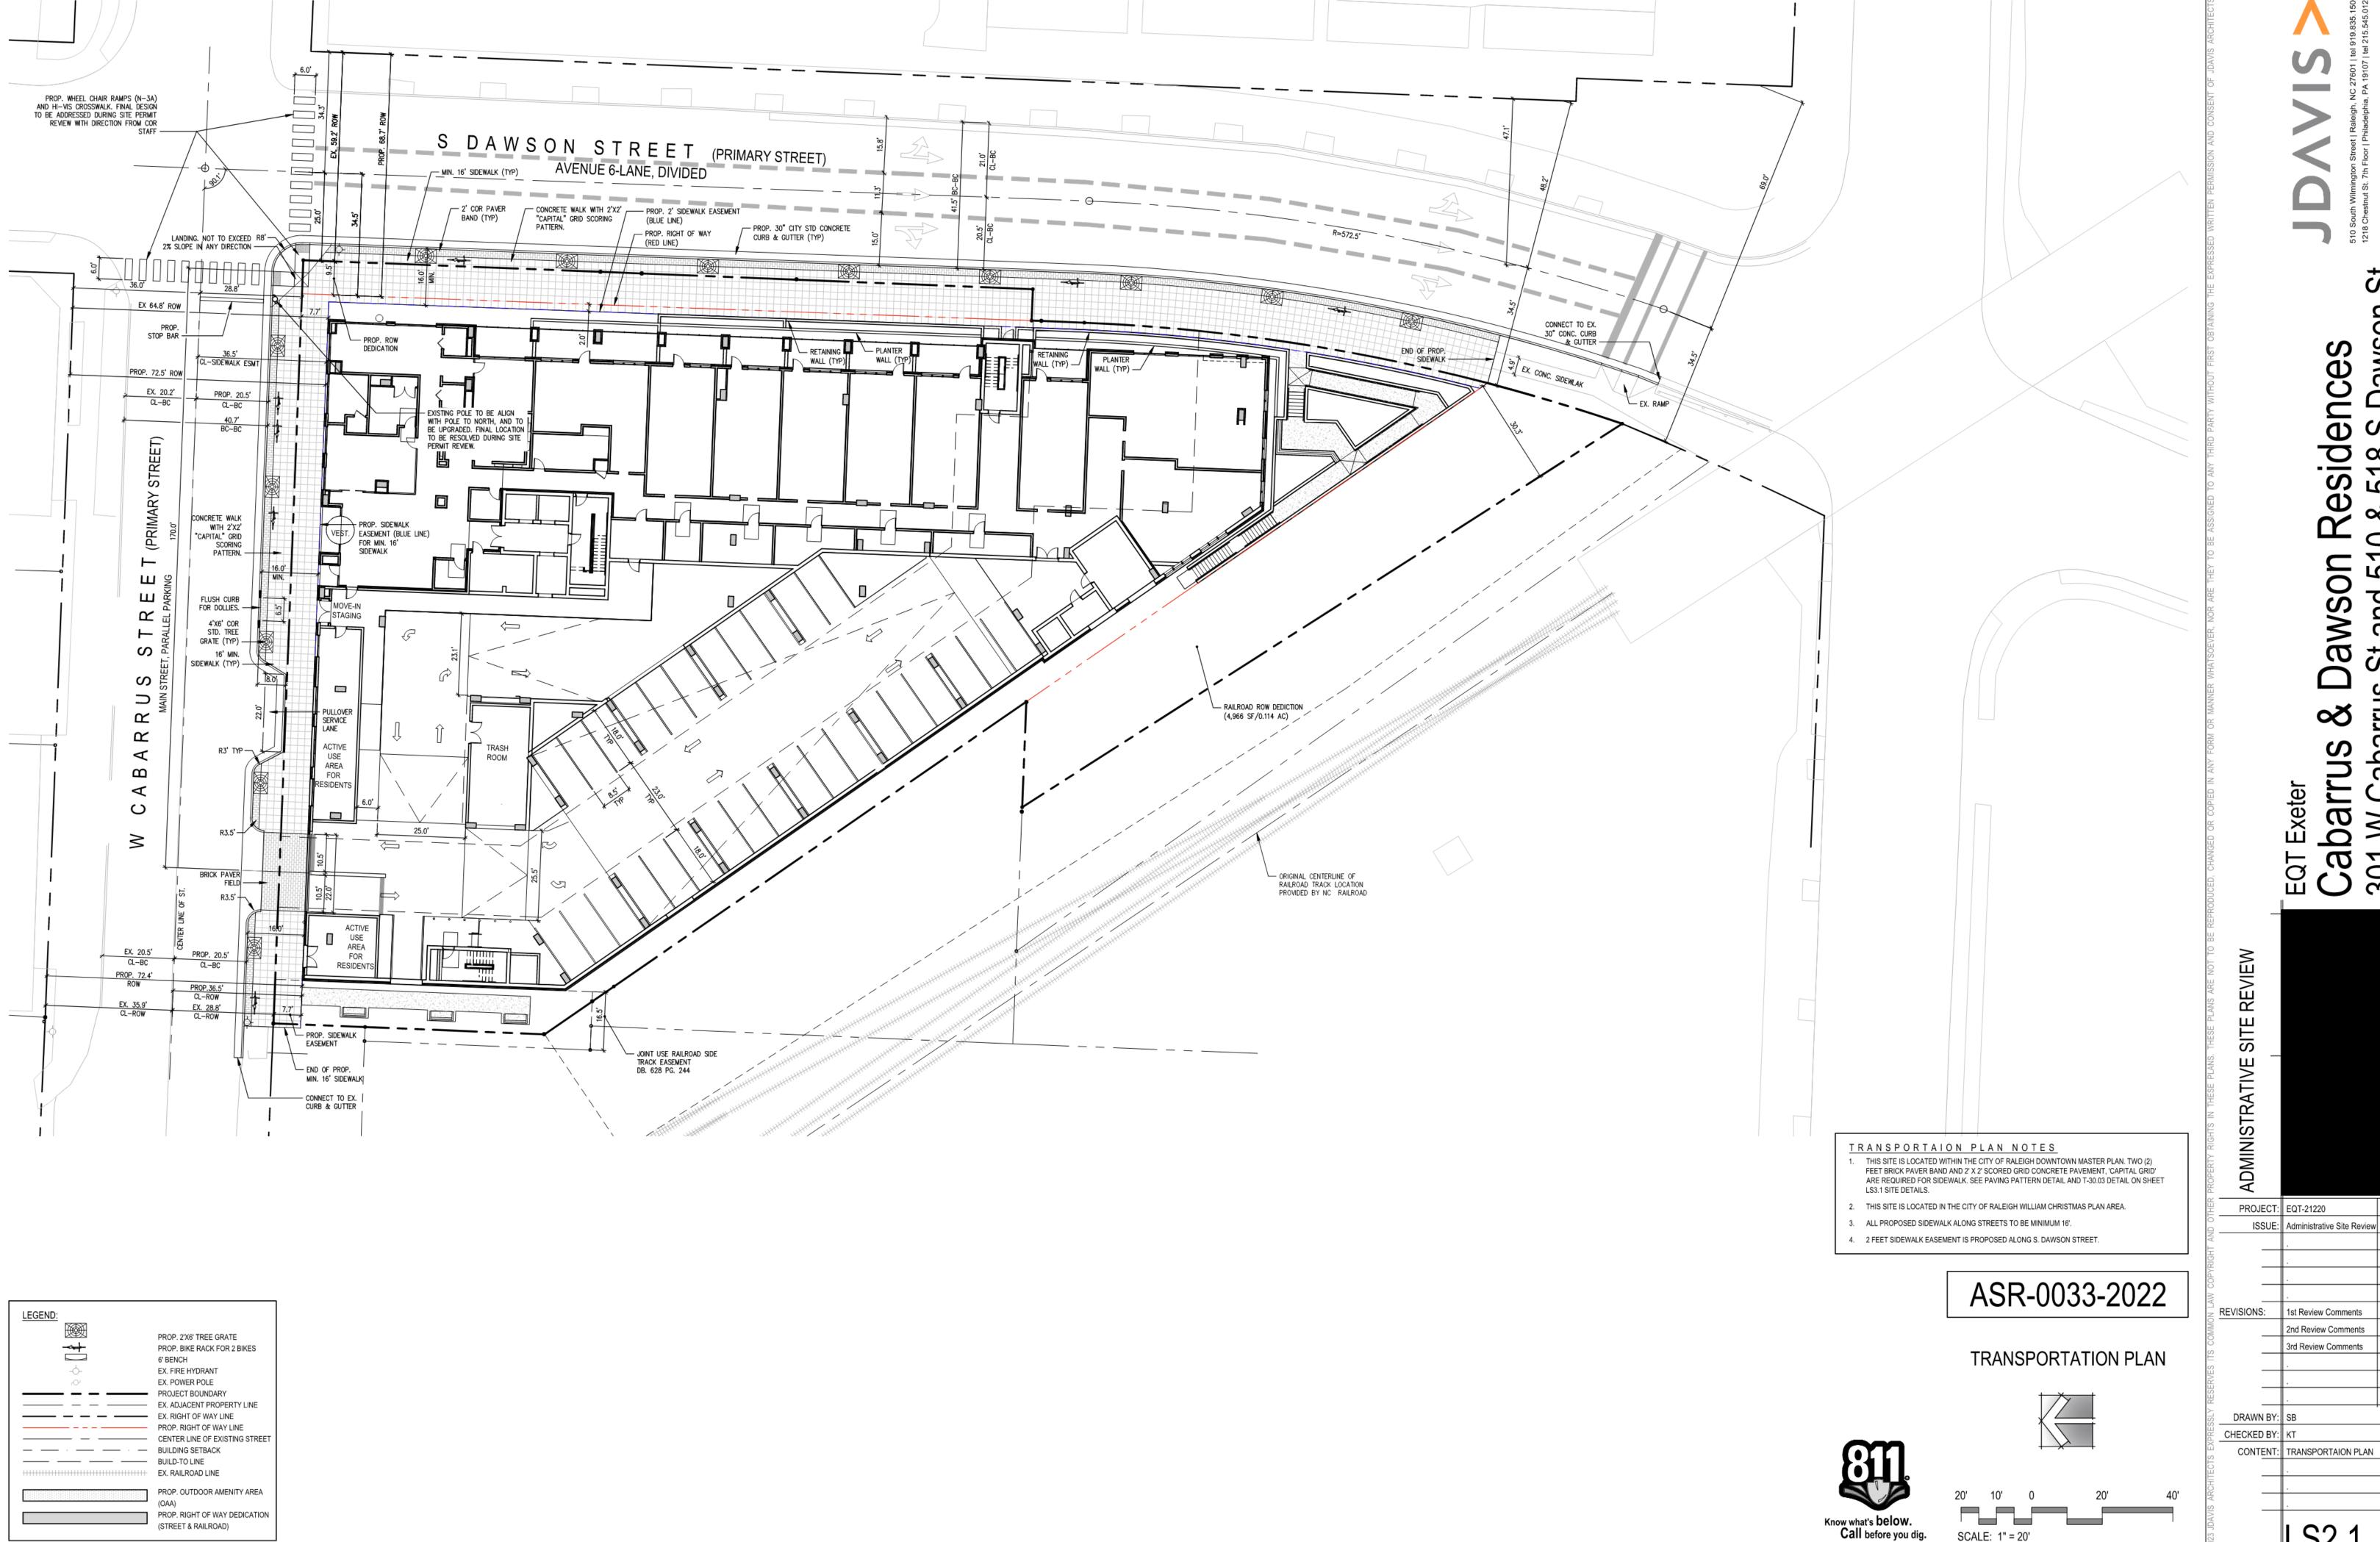


S Dawson Residences & 518 S Dawso Cabarrus St and 51 North Carolina 27601 Dawson

ISSUE: Administrative Site Review 04.22.2022 07.06.2022 1st Review Comments 2nd Review Comments 06.13.2023 3rd Review Comments 07.11.2023

LS2.1

SCALE: 1" = 20'

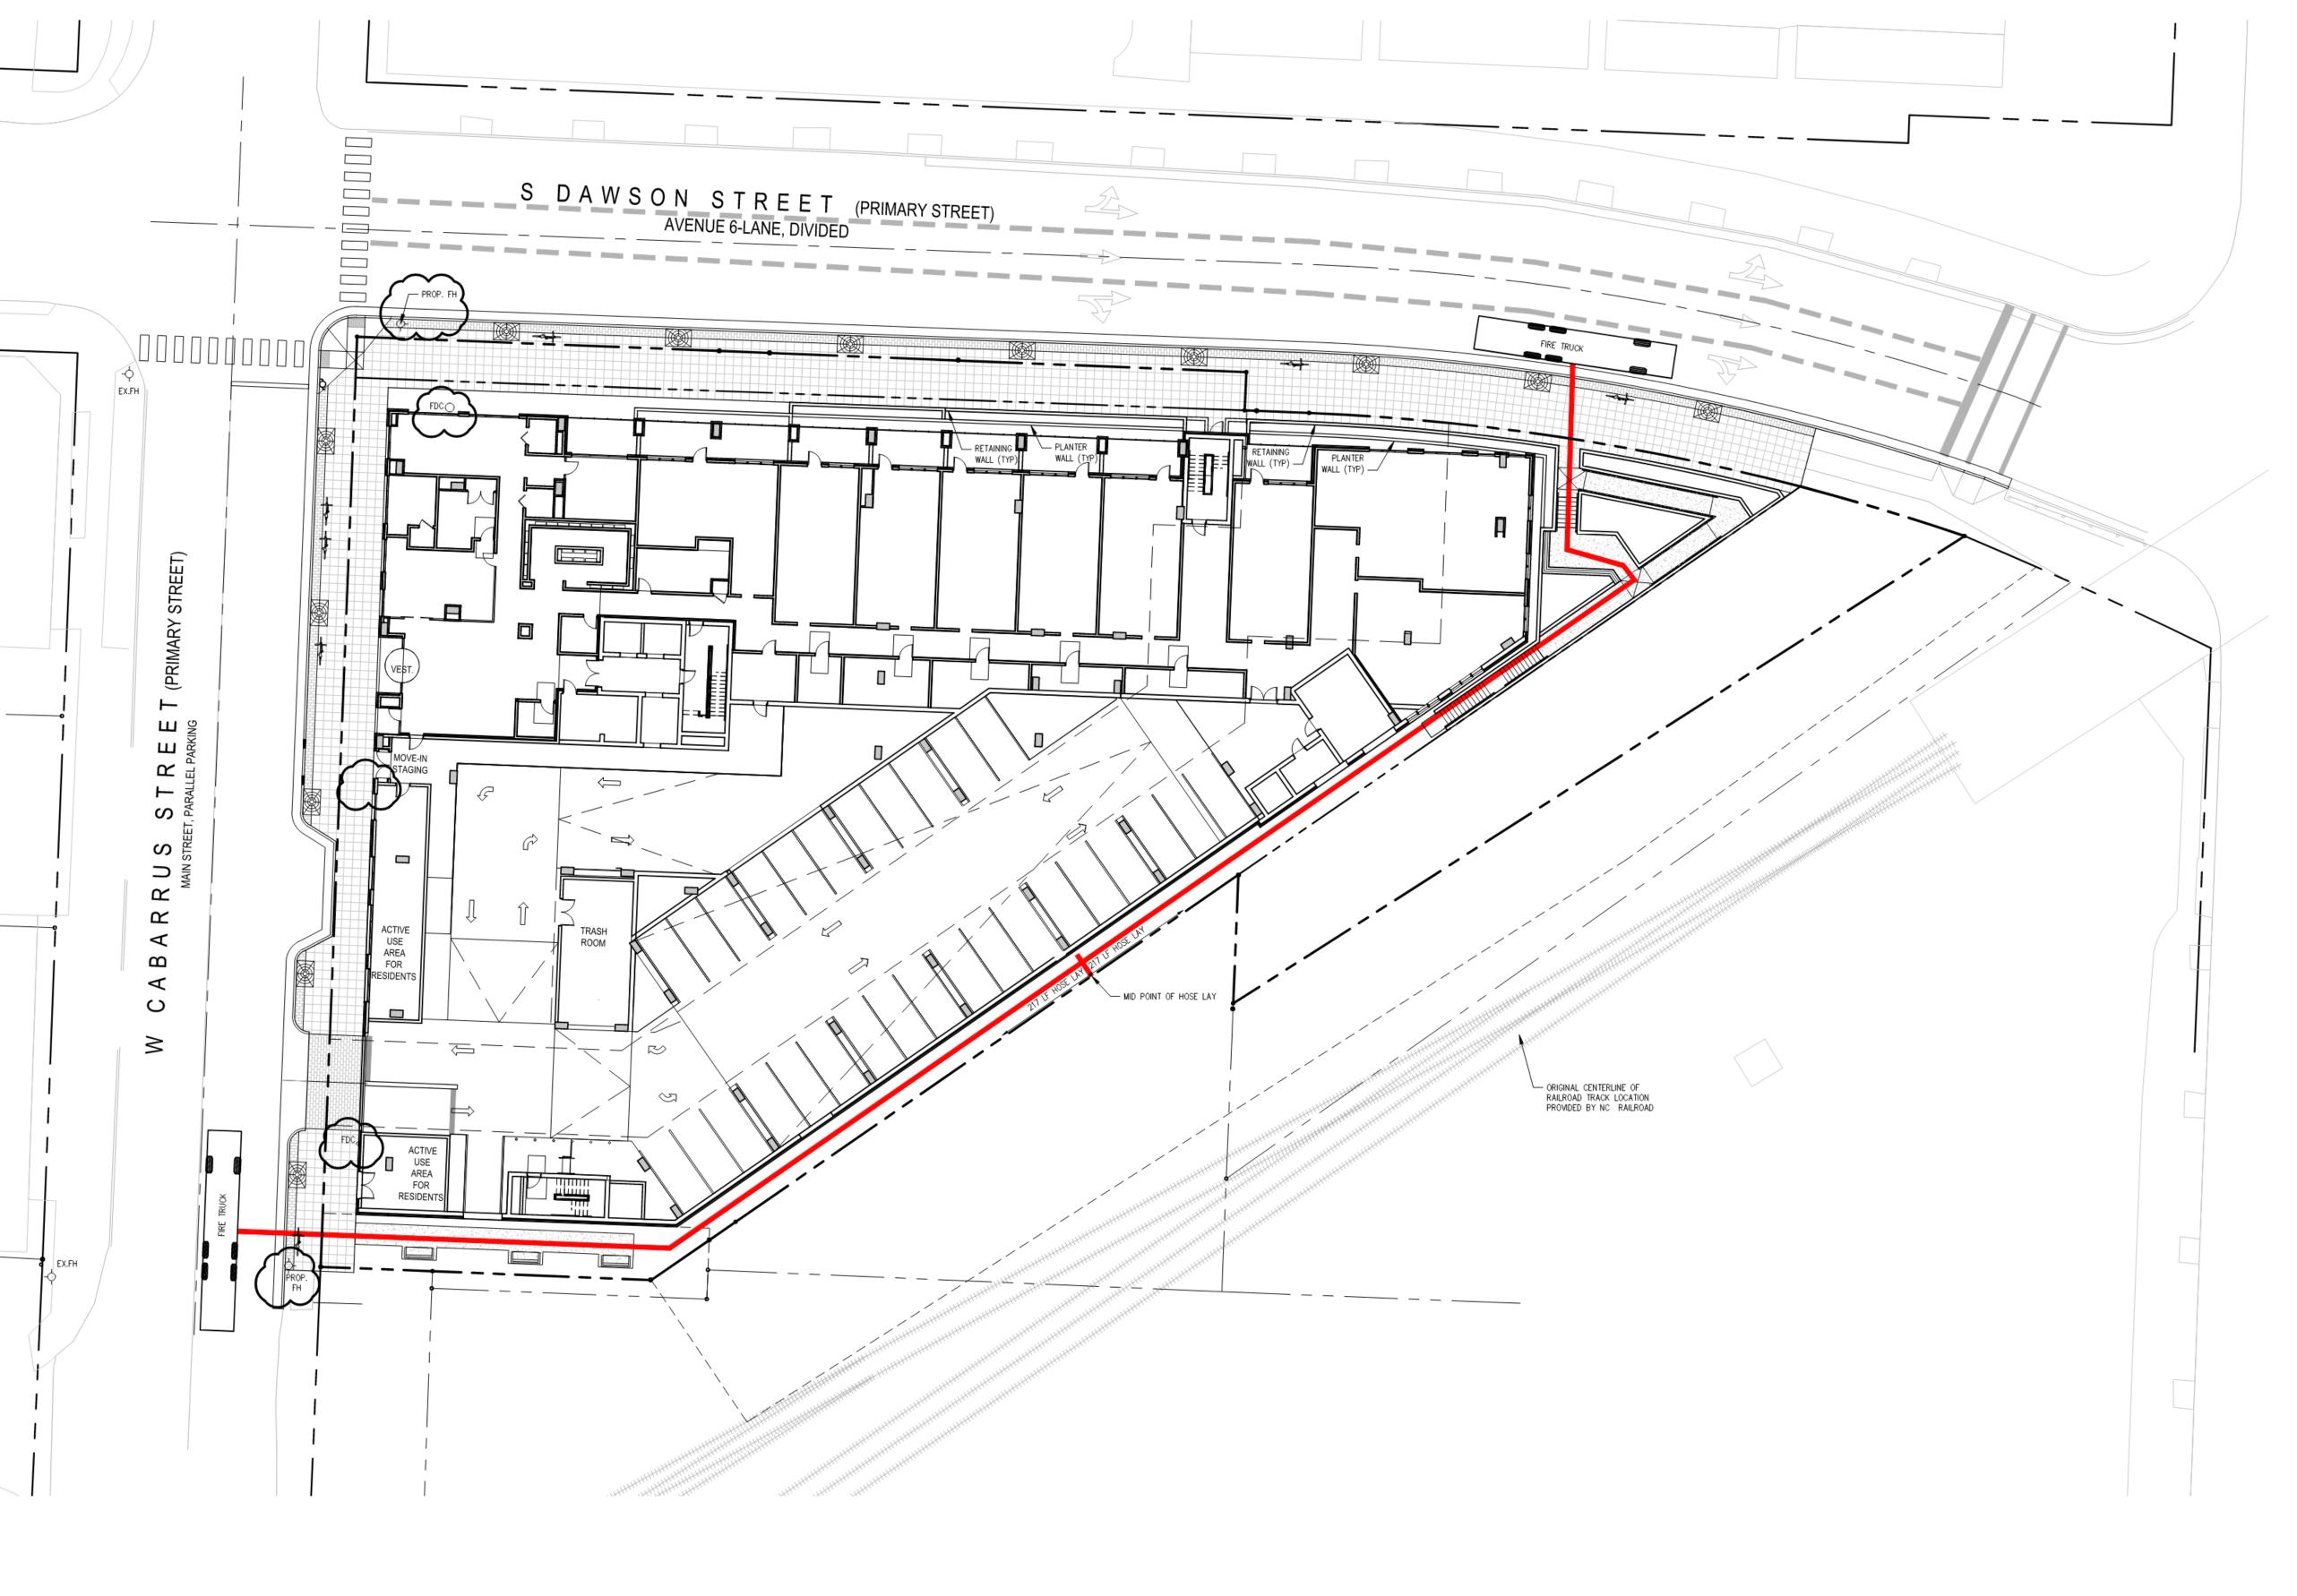

ASR-0033-2022

FIRE ACCESS PLAN



Know what's **below**. **Call** before you dig.

			<u> </u>	
20'	10'	0	20'	4
SCA	LE: 1" =	20'		
00/1		20		

FIRE ACCESS NOTES I. NFPA13 IS PROPOSED FOR THIS PROJECT.

THE FIRE APPARATUS ROAD SURFACE IS REQUIRED TO BE WITHIN 250 FEET (NFPA13) OF ALL PORTIONS OF THE EXTERIOR WALL OF THE FIRST FLOOR OF THE BUILDING (NCFC 503.1.1).

FIRE HYDRANT SHALL BE LOCATED WITHIN 400' AS MEASURED ALONG THE PATH OF THE FIRE APPARATUS ACCESS ROAD (NCFC 507.5.1).

SITE REVIEW

ADMINISTRATIVE

REVISIONS:

DRAWN BY: SB

CONTENT: FIRE ACCESS PLAN

CHECKED BY:

PROJECT: EQT-21220

ISSUE: Administrative Site Review 04.22.2022

1st Review Comments

2nd Review Comments

3rd Review Comments

LS2.2


DATE

07.06.2022


06.13.2023

07.11.2023

Cabarrus St and 510 North Carolina 27601

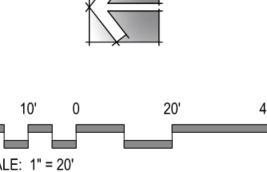

LEGEND: PROP. 2'X6' TREE GRATE PROP. BIKE RACK FOR 2 BIKES 6' BENCH EX. FIRE HYDRANT EX. POWER POLE PROP. FIRE HYDRANT PROP. FDC — EX. ADJACENT PROPERTY LINE PROP. RIGHT OF WAY LINE CENTER LINE OF EXISTING STREET PROPOSED HOSELAY
EX. RAILROAD LINE

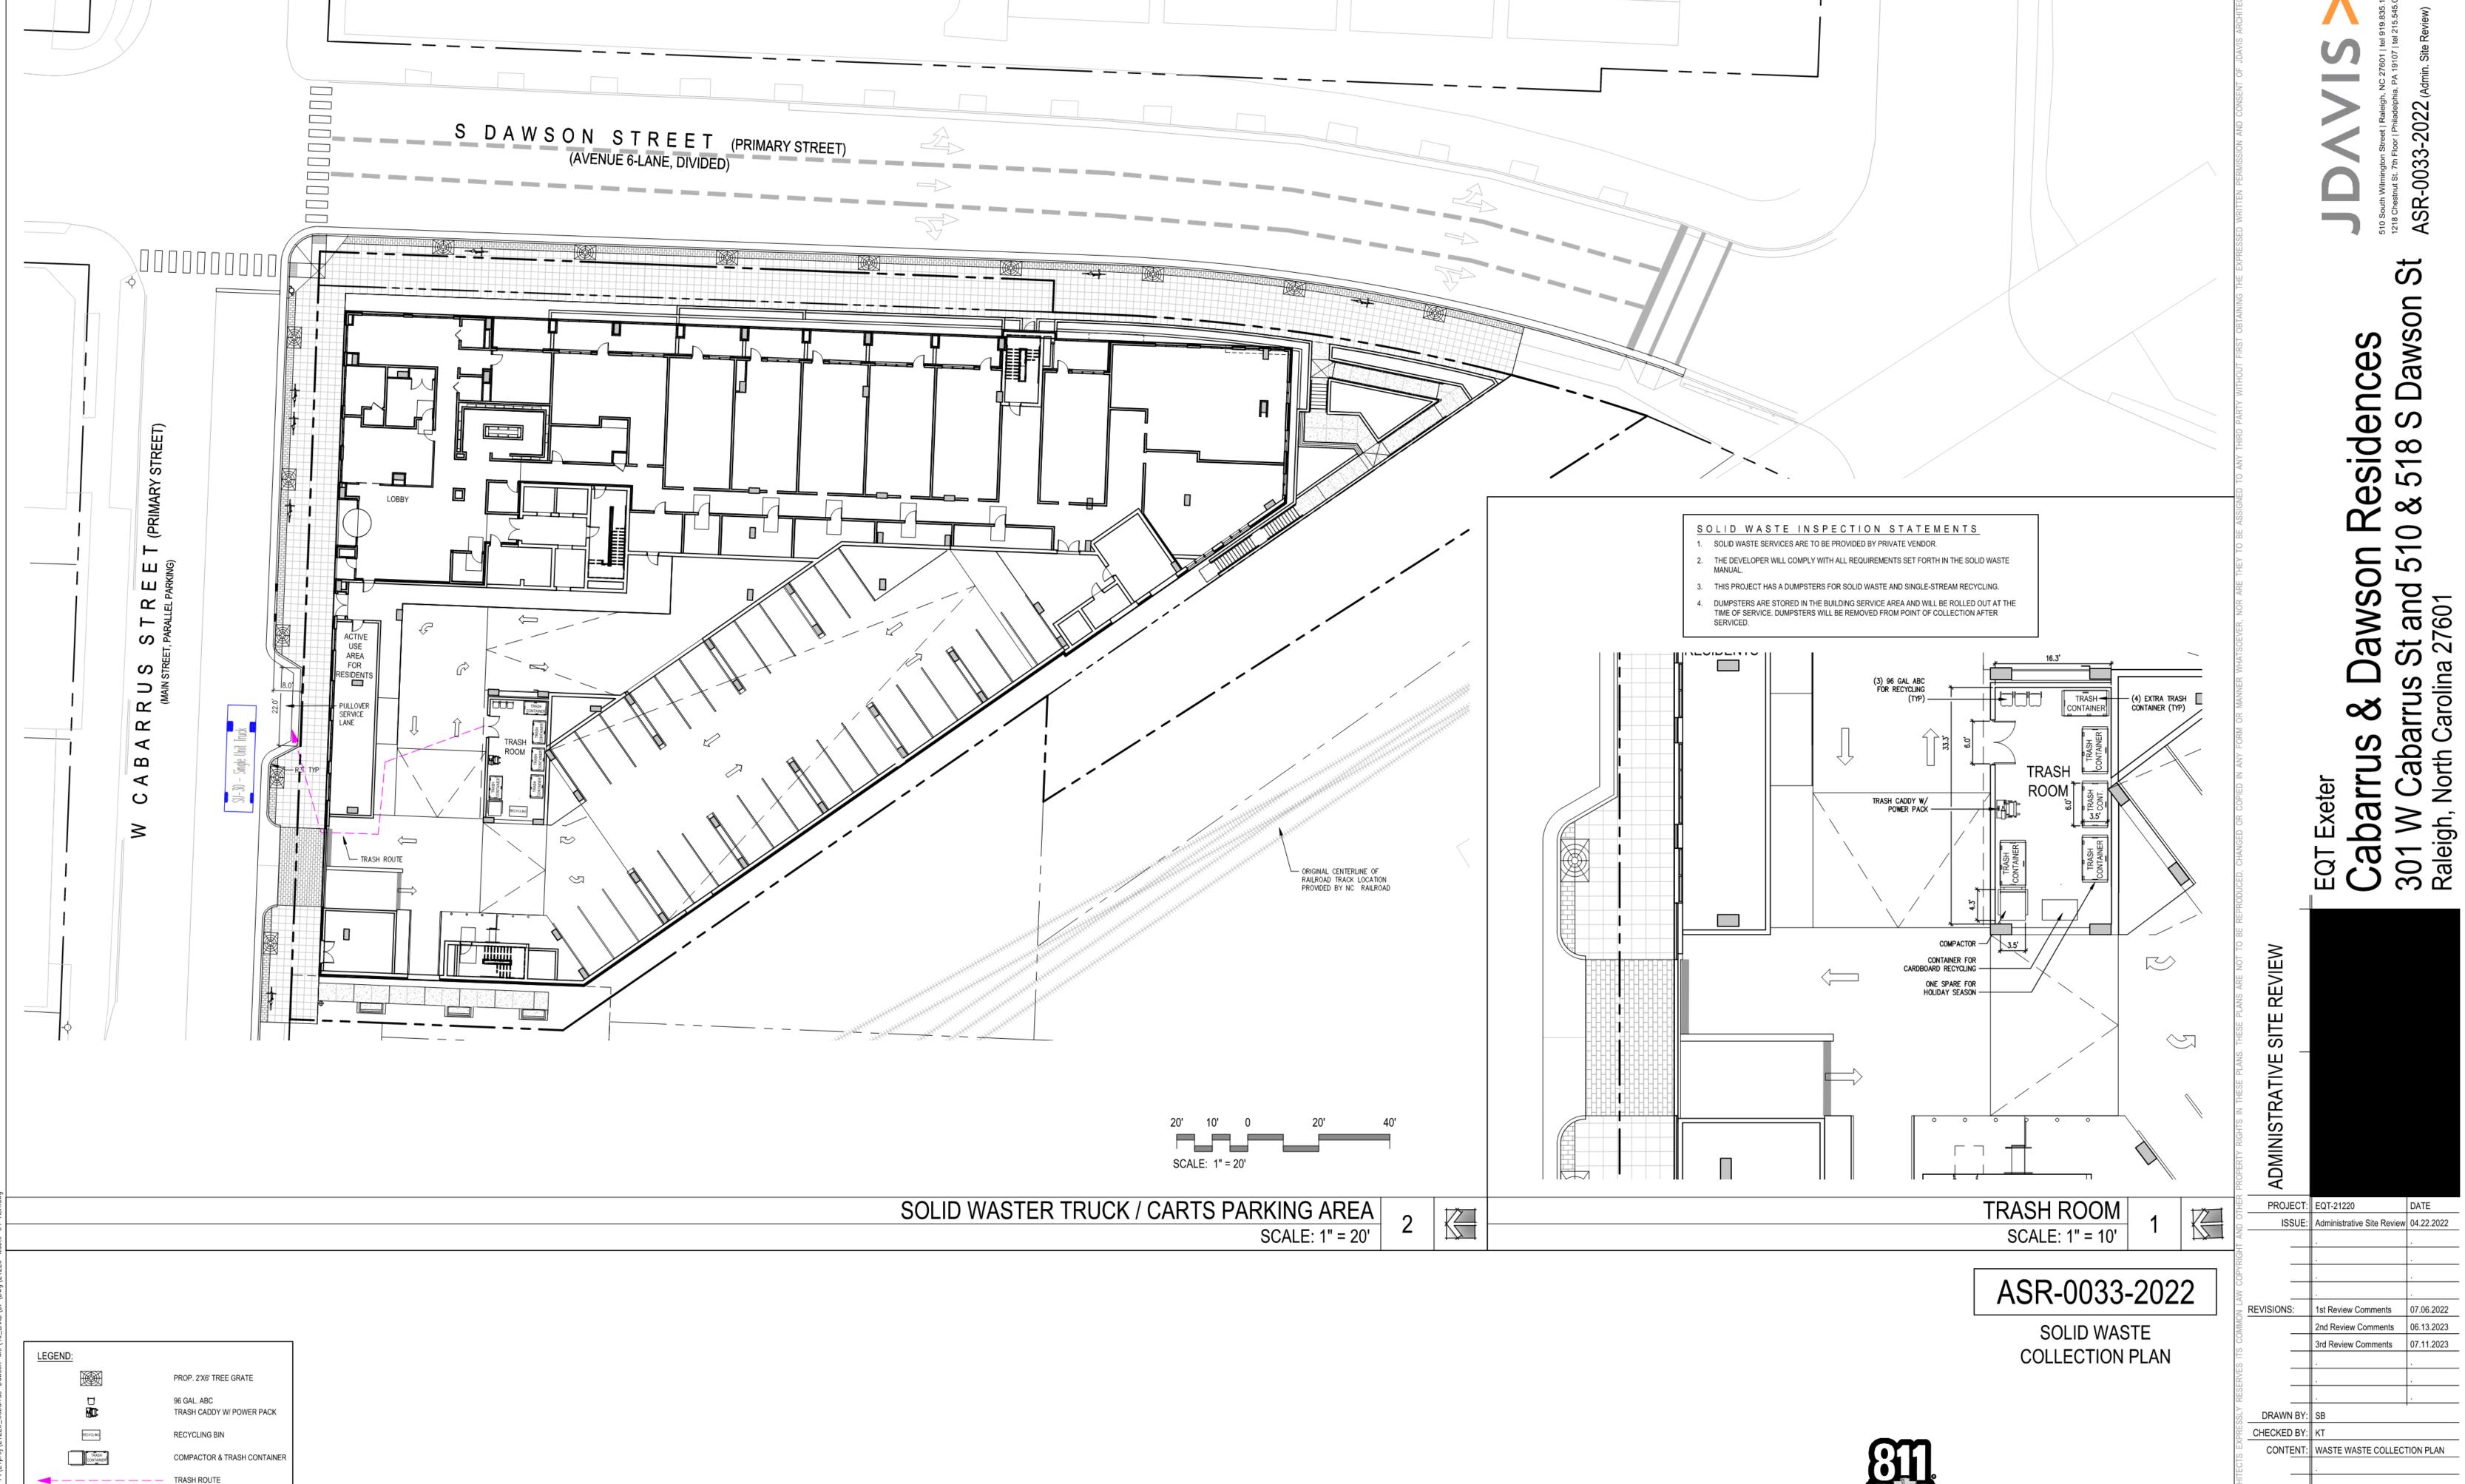


ISSUE: Administrative Site Review 04.22.2022 07.06.2022 06.13.2023 07.11.2023 CONTENT: WASTE WASTE COLLECTION PLAN

LS2.3

Know what's below.
Call before you dig.



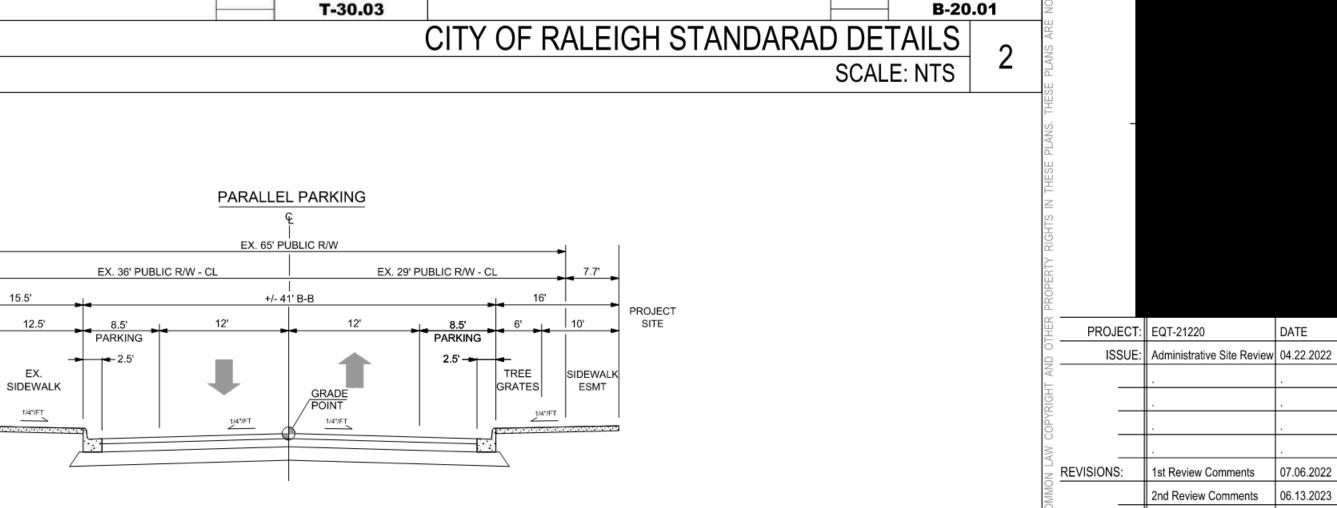

BIKE RACK

PAVEMENT DESIGN 3" S9.5B 3" I19.0B 8" ABC

W CABARRUS STREET - SECTION

SCALE: NTS

CITY OF RALEIGH

STANDARD DETAIL

BIKE RACK PLACEMENT

GENERAL WALKWAY TYPE SIDEWALK ON 2 SIDES PLANTING TYPE TREE GRATE TREE SPACING 40' O.C. AVG PARALLEL PARKING TYPE

ALUMINUM EDGE RESTRAINT

SECTION 1

SECTION 2

SET 1/4" (7 MM) BELOW TOP OF PAVERS AND CONTROL JOINTS @ 15' (4,58 M) OC

1, BRICK OR CONCRETE PAVERS ALLOWED ONLY UNDER SPECIAL CONDITIONS,

3. SCATTER SAND OR SCREENINGS OVER COMPLETE WORK AND SWEEP INTO CRACKS. 4. CONCRETE PAVERS SHOULD CONFORM TO REQUIREMENTS OF ASTM C-1319. BRICK PAVERS SHOULD CONFORM TO REQUIREMENTS OF ASTM C902-95

2. THICKNESS OF BASE MAY VARY WITH SUBGRADE/TRAFFIC CONDITIONS.

5, SEE CITY OF RALEIGH CODE SECTION 10-7001 (D) FOR CONDITIONS UNDER

WHICH CONCRETE / BRICK PAVERS ARE ALLOWED,

COMPACTED SOIL SUBGRADE

BRICK OR _ CONCRETE PAVER 2 3/8" (60 MM) MIN. THICKNESS

CONCRETE PAVER

COMPACTED SOIL SUBGRADE

2 3/8" (60 MM) MIN. THICKNESS

1" TO 1 1/2" (25 - 40 MM) COMPACTED BEDDING SAND

COMPACTED AGGREGATE BASE 4" (100 MM) MIN. THICKNESS

CITY OF RALEIGH

STANDARD DETAIL

CONCRETE/BRICK PAVER

SIDEWALK DETAIL

1" TO 1 1/2" (25 - 40 MM)

COMPACTED BEDDING SAND

COMPACTED AGGREGATE BASE 4" (100 MM) MIN. THICKNESS

GALVANIZED STAKE

INSTALLATION -

REFER TO MANUFACTURER'S

RECOMMENDATION FOR

NOTES:

ACHIEVED.

TREE GRATE-

NEW STREET TREE (TYP.)

PROPOSED 30"" — CONCRETE CURB & GUTTER

PROPER COMPACTION MUST BE ACHIEVED PRIOR TO POURING AND

INSTALLATION OF THE SIDEWALK. THE INSPECTOR WILL ENSURE THIS IS

4" x 8" (CAPITAL BLEND) CONCRETE PAVER: RUNNING BOND PATTERN PER CITY OF RALEIGH STREETSCAPE MASTER PLAN

SCORED CONCRETE
PAVING (TYP) PER CITY
OF RALEIGH SPEC'S:

CAPITAL GRID

SBF TREE GRATE D22 Series

0'-6" | 2'-0" | SCORED CONCRETE PAVING PER CITY OF RALEIGH SPEC'S: 'CAPITAL GRID'

PAVING PATTERN

(N.T.S.)


ACHIEVED AND CAN REQUIRE ADDITIONAL MEASURES IF IT IS NOT

3rd Review Comments

1st Review Comments 2nd Review Comments

07.11.2023

DRAWN BY: SB CHECKED BY: CONTENT: SITE DETAILS

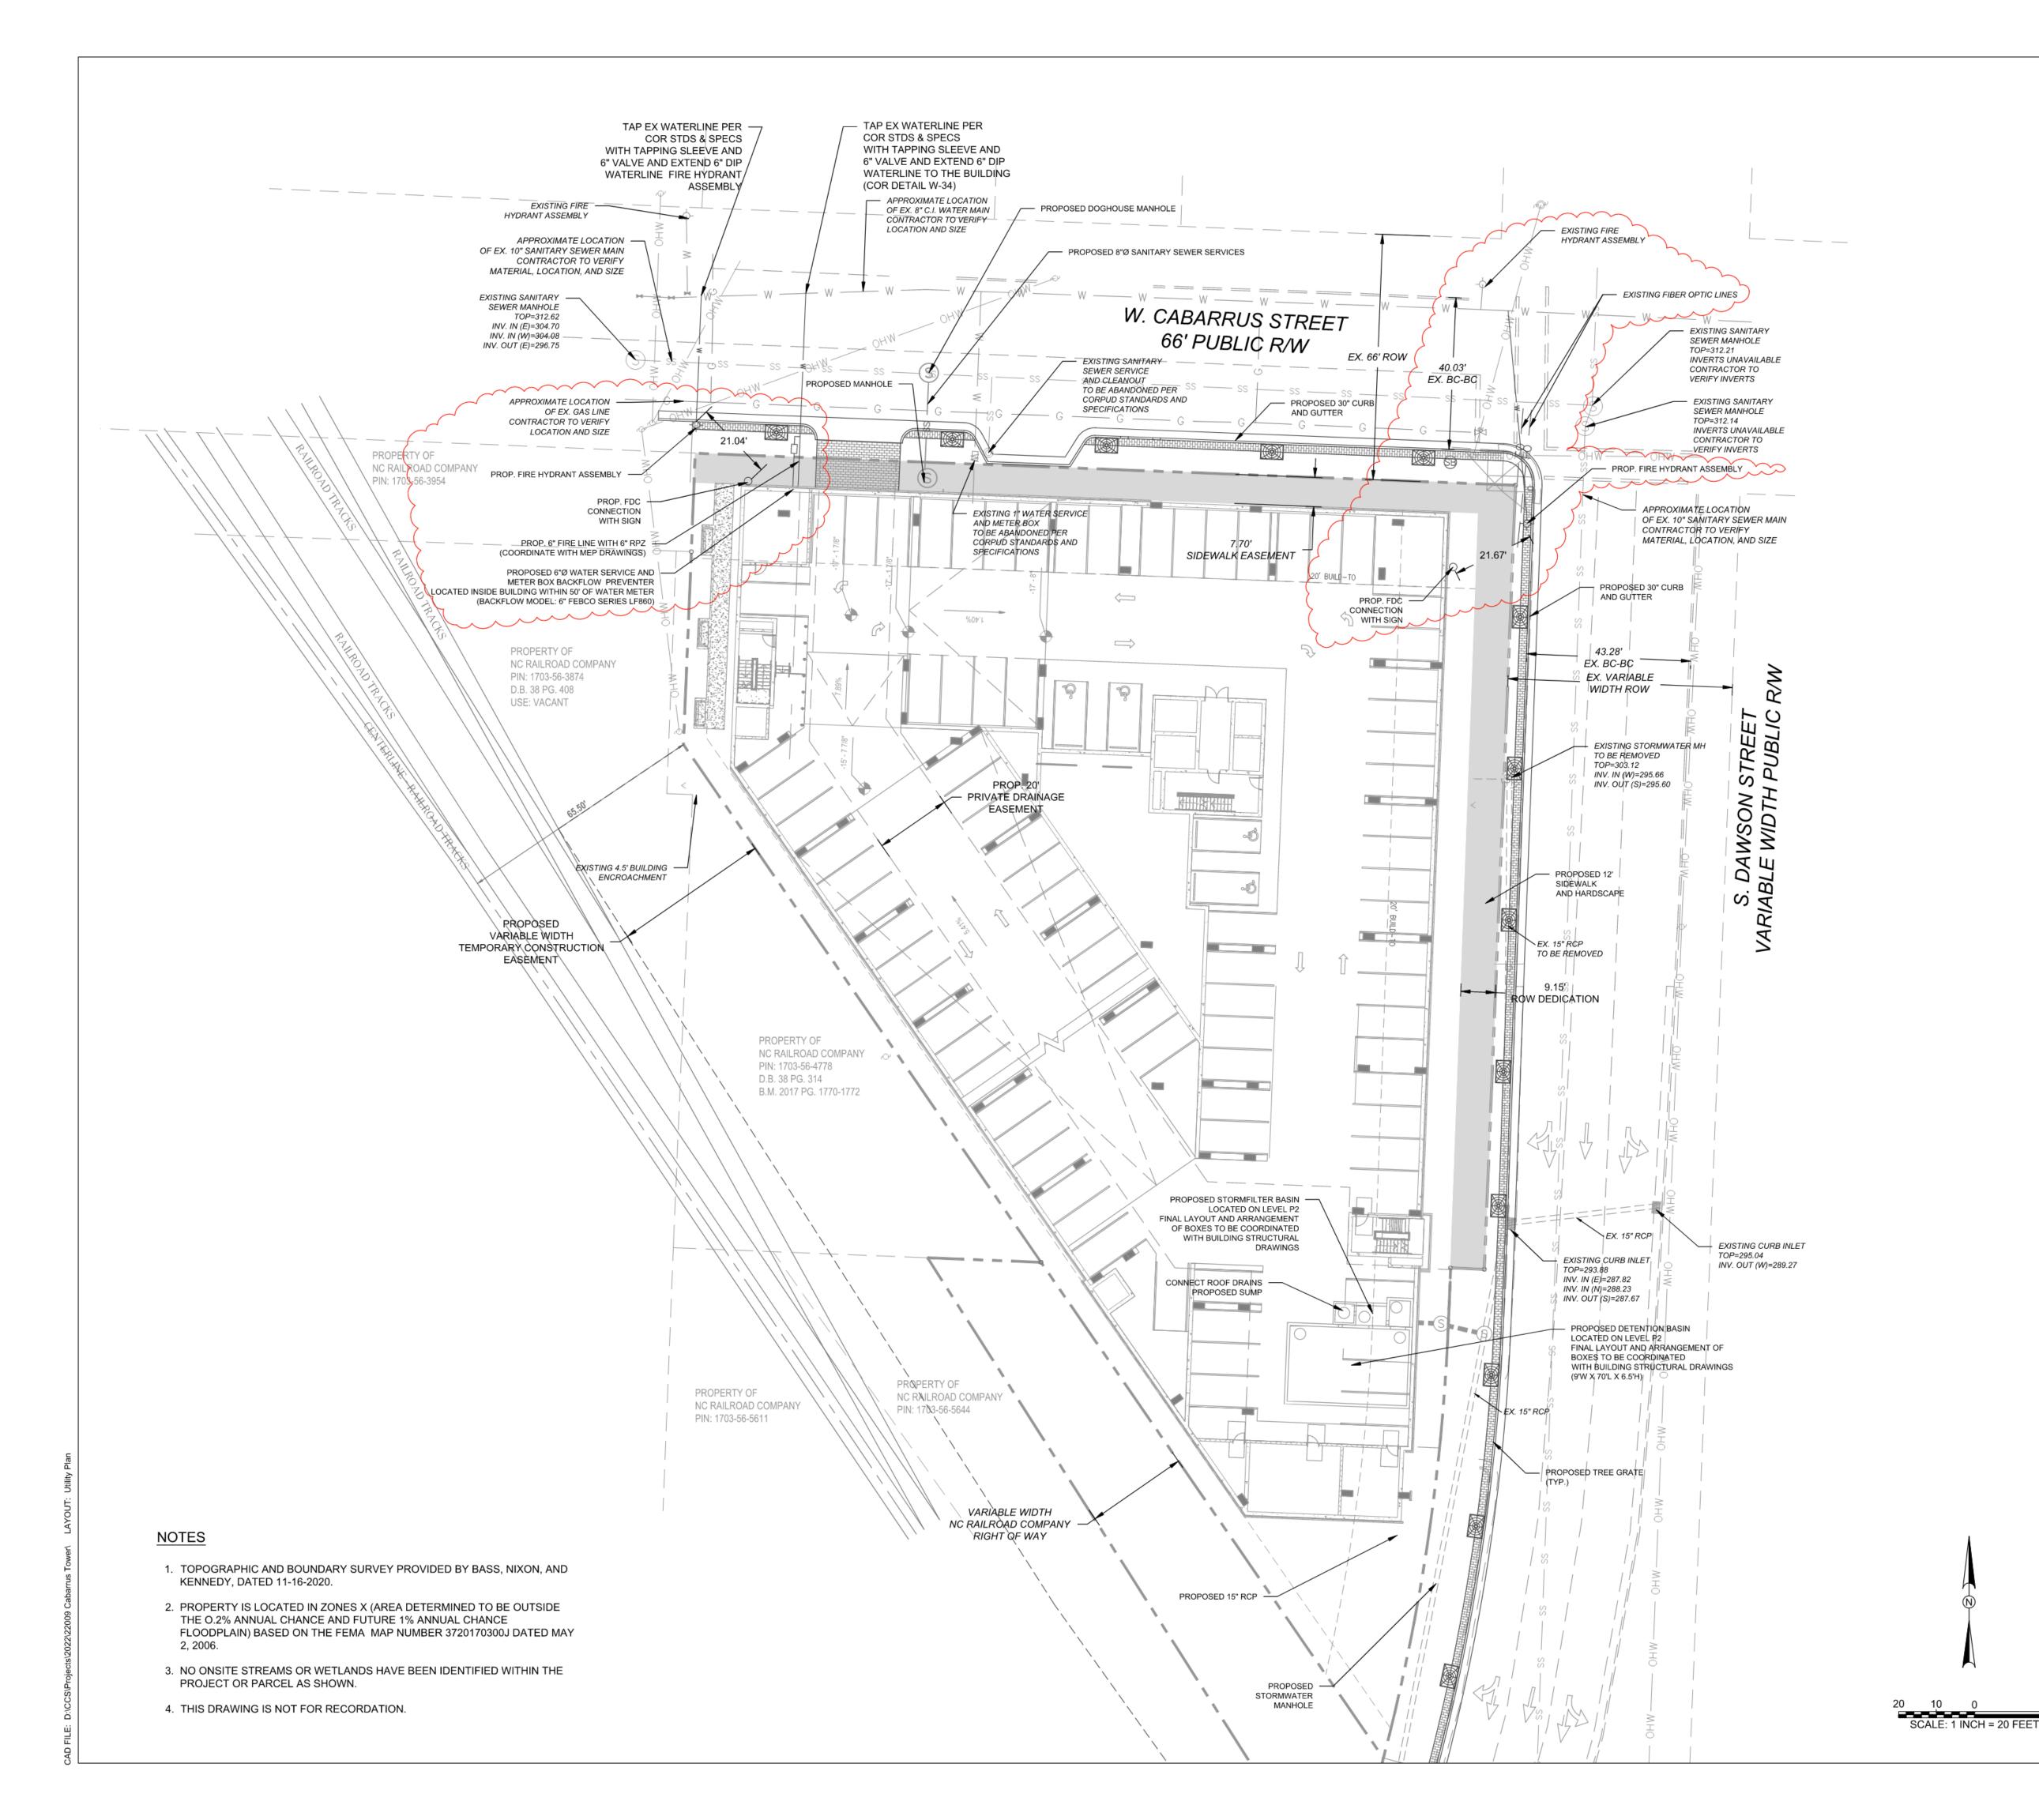

LEGEND

EXISTING ABUTTING PROPERTY LINE

EXISTING RIGHT-OF-WAY

EXISTING OVERHEAD POWER LINE

EXISTING ABUTTING PROPERTY LINE

EXISTING ABUTTING PROPERTY LINE

EXISTING BUILDING SETBACK LINE

EXISTING PARKING SETBACK LINE

EXISTING EDGE OF PAVEMENT

EXISTING SANITARY SEWER

EXISTING WATER MAIN

PROPOSED EDGE OF PAVEMENT

PROPOSED SANITARY SEWER SERVICE

PROPOSED WATER SERVICE

EXISTING PROPERTY LINE


CITY OF RALEIGH UTILITY NOTES

 ALL MATERIALS & CONSTRUCTION METHODS SHALL BE IN ACCORDANCE WITH CITY OF RALEIGH DESIGN STANDARDS, DETAILS & SPECIFICATIONS (REFERENCE: CORPUD HANDBOOK, CURRENT EDITION)

---- PROPOSED EASEMENT

- 2. UTILITY SEPARATION REQUIREMENTS:
- a. A DISTANCE OF 100' SHALL BE MAINTAINED BETWEEN SANITARY SEWER & ANY PRIVATE OR PUBLIC WATER SUPPLY SOURCE SUCH AS AN IMPOUNDED RESERVOIR USED AS A SOURCE OF DRINKING WATER. IF ADEQUATE LATERAL SEPARATION CANNOT BE ACHIEVED, FERROUS SANITARY SEWER PIPE SHALL BE SPECIFIED & INSTALLED TO WATERLINE SPECIFICATIONS. HOWEVER, THE MINIMUM SEPARATION SHALL NOT BE LESS THAN 25' FROM A PRIVATE WELL OR 50' FROM A PUBLIC WELL.
- b. WHEN INSTALLING WATER &OR SEWER MAINS, THE HORIZONTAL SEPARATION BETWEEN UTILITIES SHALL BE 10'. IF THIS SEPARATION CANNOT BE MAINTAINED DUE TO EXISTING CONDITIONS, THE VARIATION ALLOWED IS THE WATER MAIN IN A SEPARATE TRENCH WITH THE ELEVATION OF THE WATER MAIN AT LEAST 18" ABOVE THE TOP OF THE SEWER & MUST BE APPROVED BY THE PUBLIC UTILITIES DIRECTOR. ALL DISTANCES ARE MEASURED FROM OUTSIDE DIAMETER TO OUTSIDE DIAMETER.
- c. WHERE IT IS IMPOSSIBLE TO OBTAIN PROPER SEPARATION, OR ANYTIME A SANITARY SEWER PASSES OVER A WATERMAIN, DIP MATERIALS OR STEEL ENCASEMENT EXTENDED 10' ON EACH SIDE OF CROSSING MUST BE SPECIFIED & INSTALLED TO WATERLINE SPECIFICATIONS.
- d. 5.0' MINIMUM HORIZONTAL SEPARATION IS REQUIRED BETWEEN ALL SANITARY SEWER & STORM SEWER FACILITIES, UNLESS DIP MATERIAL IS SPECIFIED FOR SANITARY SEWER.
- e. MAINTAIN 18" MIN. VERTICAL SEPARATION AT ALL WATERMAIN & RCP STORM DRAIN CROSSINGS; MAINTAIN 24" MIN. VERTICAL SEPARATION AT ALL SANITARY SEWER & RCP STORM DRAIN CROSSINGS. WHERE ADEQUATE SEPARATIONS CANNOT BE ACHIEVED, SPECIFY DIP MATERIALS & A CONCRETE CRADLE
- HAVING 6" MIN. CLEARANCE (PER CORPUD DETAILS W-41 & S-49)
 f. ALL OTHER UNDERGROUND UTILITIES SHALL CROSS WATER & SEWER FACILITIES WITH 18" MIN. VERTICAL SEPARATION REQUIRED.
- ANY NECESSARY FIELD REVISIONS ARE SUBJECT TO REVIEW & APPROVAL OF AN AMENDED PLAN &/OR PROFILE BY THE CITY OF RALEIGH PUBLIC UTILITIES DEPARTMENT PRIOR TO CONSTRUCTION.
- 4. CONTRACTOR SHALL MAINTAIN CONTINUOUS WATER & SEWER SERVICE TO EXISTING RESIDENCES & BUSINESSES THROUGHOUT CONSTRUCTION OF PROJECT. ANY NECESSARY SERVICE INTERRUPTIONS SHALL BE PRECEDED BY A 24 HOUR ADVANCE NOTICE TO THE CITY OF RALEIGH PUBLIC UTILITIES DEPARTMENT.
- 5. 3.0' MINIMUM COVER IS REQUIRED ON ALL WATER MAINS & SEWER FORCEMAINS. 4.0' MINIMUM COVER IS REQUIRED ON ALL REUSE
- 6. ABANDON AND REMOVE EXISTING WATER AND SEWER SERVICES NOT BEING USED IN REDEVELOPMENT OF SITE AS DIRECTED BY THE CITY OF RALEIGH PUBLIC UTILITIES DEPARTMENT. THIS INCLUDES ABANDONING TAP AT MAIN & REMOVAL OF SERVICE FROM ROW OR EASEMENT PER CORPUD HANDBOOK PROCEDURE.
- 7. INSTALL 2" COPPER WATER SERVICES WITH METERS LOCATED AT ROW OR WITHIN A 2'X2' WATERLINE EASEMENT IMMEDIATELY ADJACENT. NOTE: IT IS THE APPLICANT'S RESPONSIBILITY TO PROPERLY SIZE THE WATER SERVICE FOR EACH CONNECTION TO PROVIDE ADEQUATE FLOW & PRESSURE.
- INSTALL 4" PVC SEWER SERVICES @ 1.0% MINIMUM GRADE WITH CLEANOUTS LOCATED AT ROW OR EASEMENT LINE & SPACED EVERY 75 LINEAR FEET MAXIMUM.
- PRESSURE REDUCING VALVES ARE REQUIRED ON ALL WATER SERVICES EXCEEDING 80 PSI; BACKWATER VALVES ARE REQUIRED ON ALL SANITARY SEWER SERVICES HAVING BUILDING DRAINS LOWER THAN 1.0' ABOVE THE NEXT UPSTREAM MANHOLE.
- ALL ENVIRONMENTAL PERMITS APPLICABLE TO THE PROJECT MUST BE OBTAINED FROM NCDWQ, USACE &/OR FEMA FOR ANY RIPARIAN BUFFER, WETLAND &/OR FLOODPLAIN IMPACTS (RESPECTIVELY) PRIOR TO CONSTRUCTION.
- 11. NCDOT / RAILROAD ENCROACHMENT AGREEMENTS ARE REQUIRED FOR ANY UTILITY WORK (INCLUDING MAIN EXTENSIONS & SERVICE TAPS) WITHIN STATE OR RAILROAD ROW PRIOR TO CONSTRUCTION.
- 12. GREASE INTERCEPTOR / OIL WATER SEPARATOR SIZING CALCULATIONS & INSTALLATION SPECIFICATIONS SHALL BE APPROVED BY THE CORPUD FOG PROGRAM COORDINATOR PRIOR TO ISSUANCE OF A BUILDING PERMIT. CONTACT TIM BEASLEY AT (919) 996-2334 OR timothy.beasley@raleighnc.gov FOR MORE INFORMATION.
- 13. CROSS-CONNECTION CONTROL PROTECTION DEVICES ARE REQUIRED BASED ON DEGREE OF HEALTH HAZARD INVOLVED AS LISTED IN APPENDIX-B OF THE RULES GOVERNING PUBLIC WATER SYSTEMS IN NORTH CAROLINA. THESE GUIDELINES ARE THE MINIMUM REQUIREMENTS. THE DEVICES SHALL MEET AMERICAN SOCIETY OF SANITARY ENGINEERING (ASSE) STANDARDS OR BE ON THE UNIVERSITY OF SOUTHERN CALIFORNIA APPROVAL LIST. THE DEVICES SHALL BE INSTALLED AND TESTED (BOTH INITIAL AND PERIODIC TESTING THEREAFTER) IN ACCORDANCE WITH THE MANUFACTURER'S RECOMMENDATIONS OR THE LOCAL CROSS-CONNECTION CONTROL PROGRAM, WHICHEVER IS MORE STRINGENT. CONTACT JOANIE HARTLEY AT (919) 996-5923 OR joanie.hartley@raleighnc.goc FOR MORE INFORMATION

MPLEF
g Services, PLLC
2308 Ridge Road
leigh, North Carolina 27612
Ph. 919-413-1704

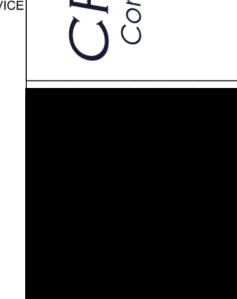

PRELIMINARY PLANS
NOT FOR CONSTRUCTION

REV.	DESCRIPTION	DATE
-	CITY OF RALEIGH COMMENTS	06/23/22
2	CITY OF RALEIGH COMMENTS	06/10/23
8	CITY OF RALEIGH COMMENTS	07/07/23

PROJECT NO.: 22009
DRAWN BY: JAC

DAW!

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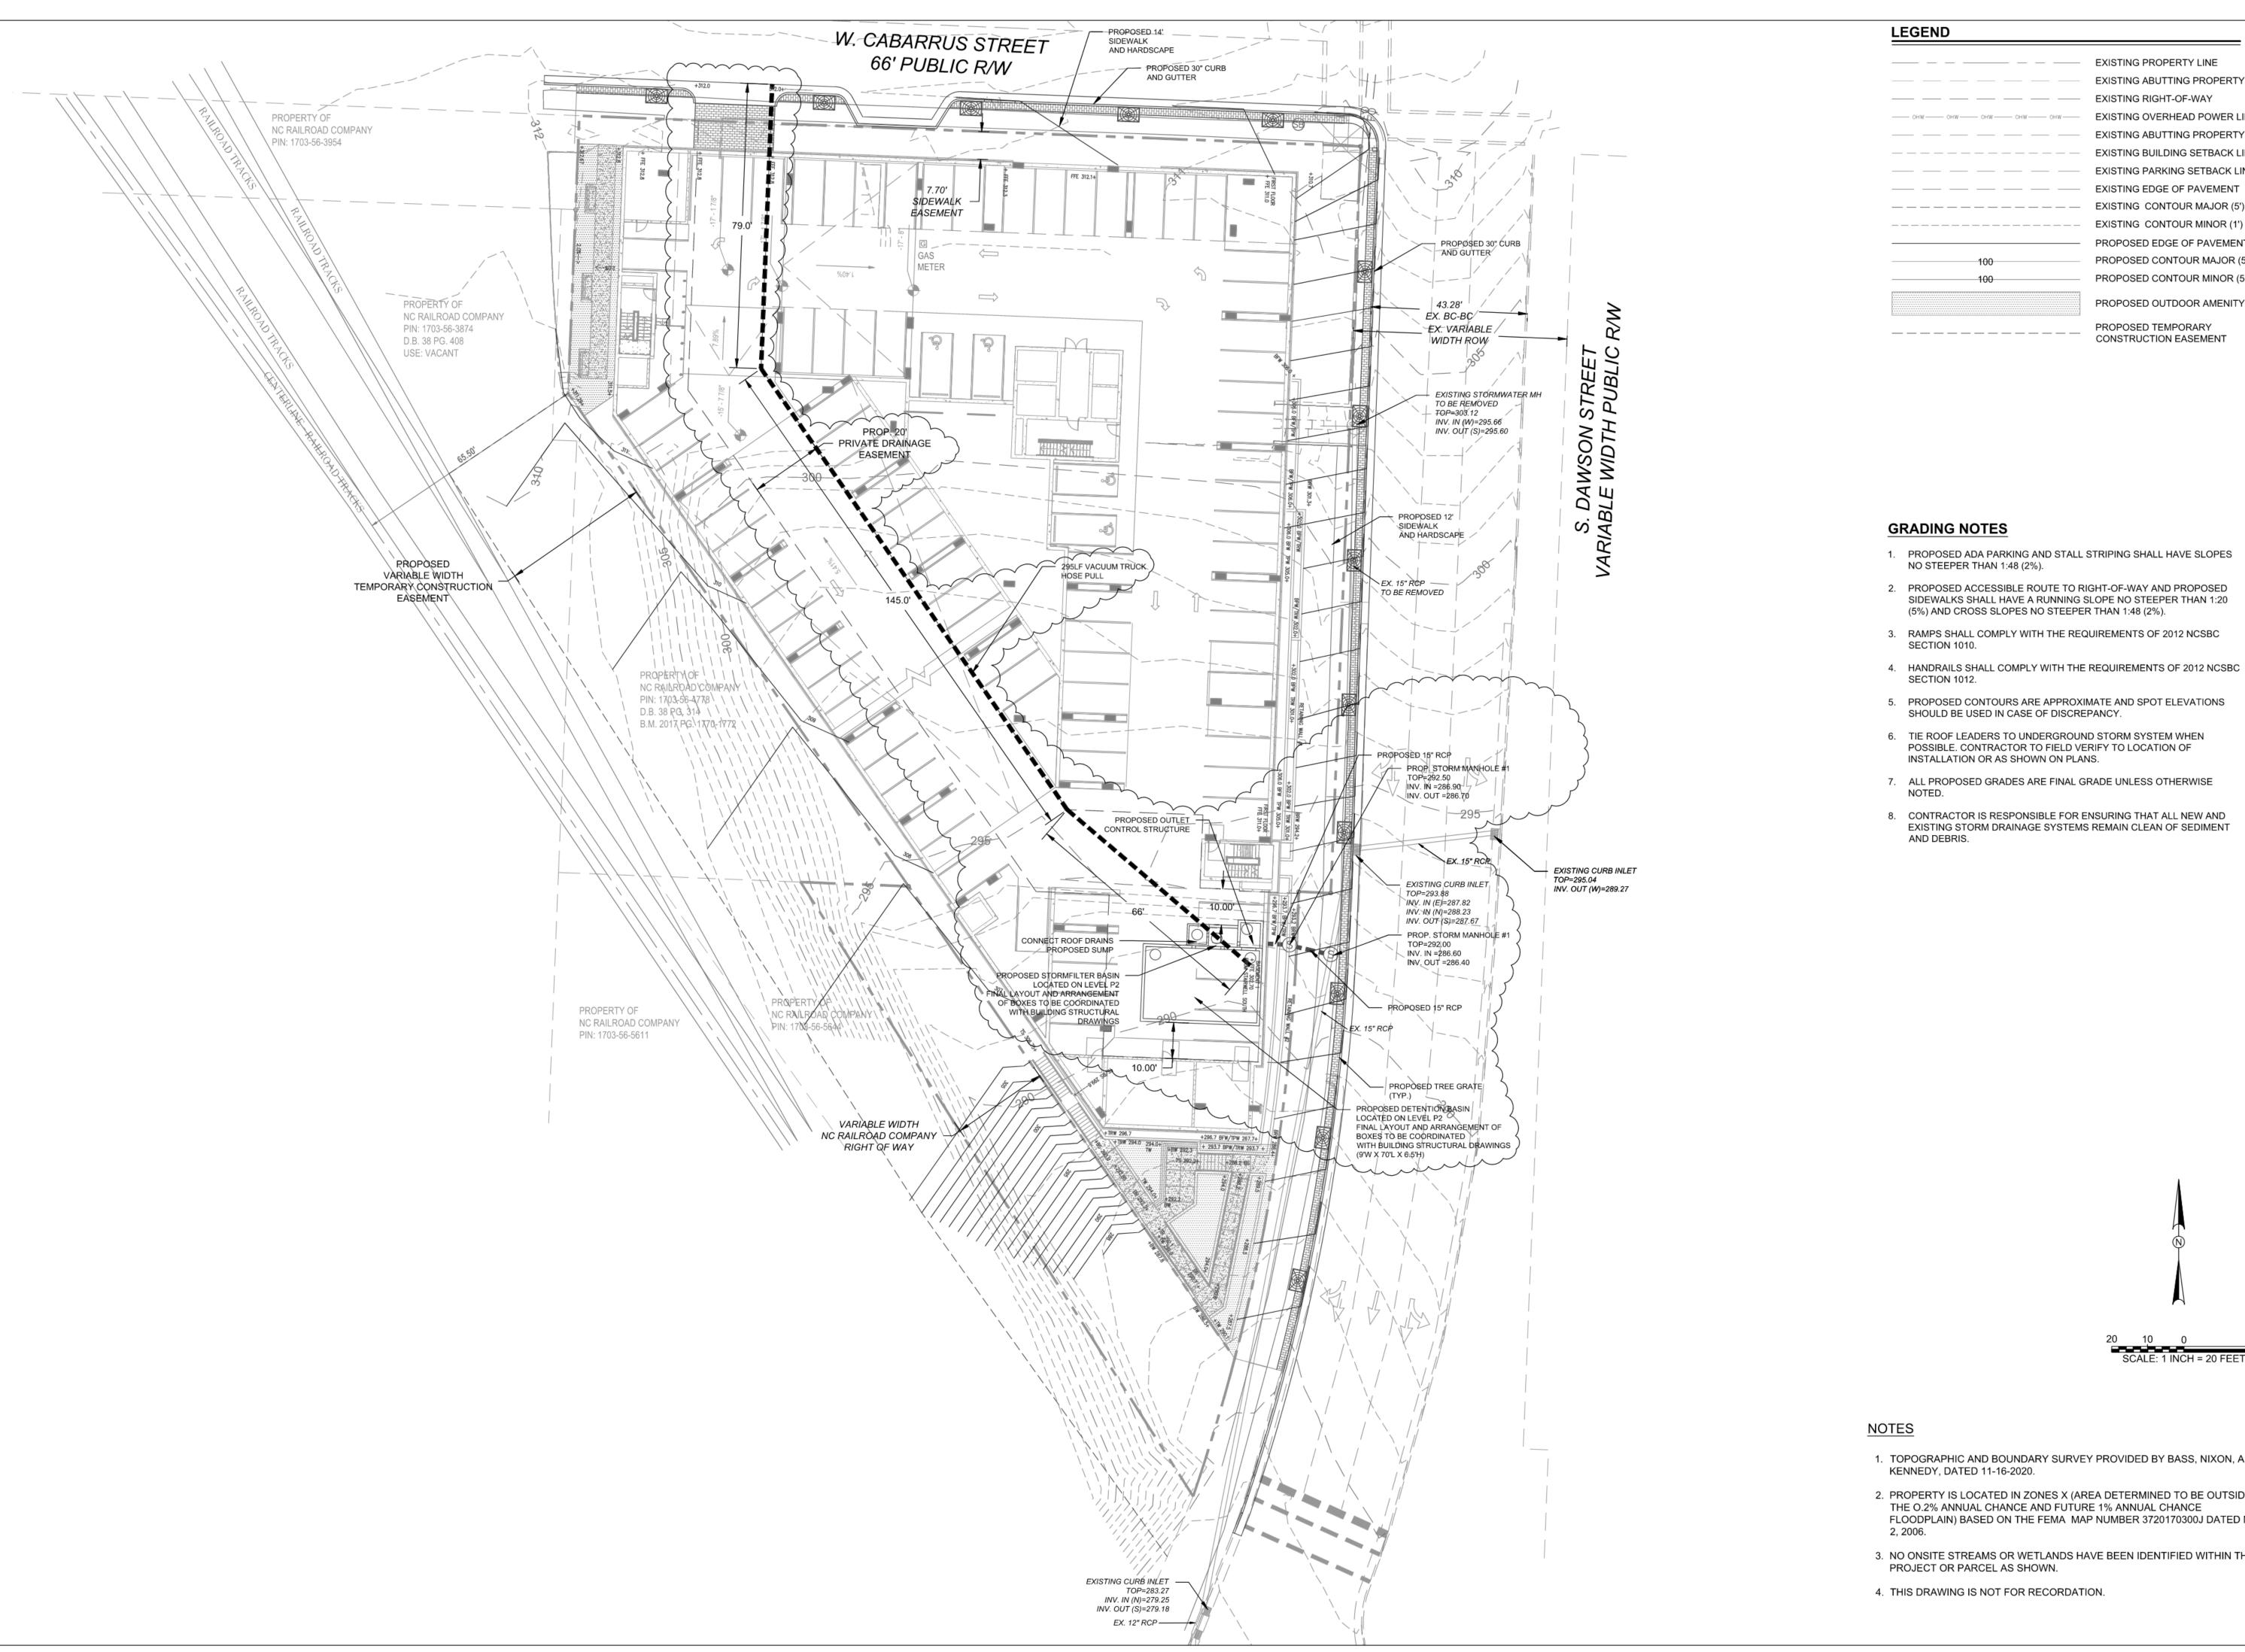
BARRU

DATE: 04/15/22 SCALE: 1" = 20'

CHECKED BY: JAC

C-1

1 of 4



EXISTING PROPERTY LINE EXISTING ABUTTING PROPERTY LINE EXISTING RIGHT-OF-WAY EXISTING OVERHEAD POWER LINE EXISTING ABUTTING PROPERTY LINE EXISTING BUILDING SETBACK LINE EXISTING PARKING SETBACK LINE EXISTING EDGE OF PAVEMENT EXISTING CONTOUR MAJOR (5') EXISTING CONTOUR MINOR (1') PROPOSED EDGE OF PAVEMENT PROPOSED CONTOUR MAJOR (5') PROPOSED CONTOUR MINOR (5') PROPOSED OUTDOOR AMENITY AREA

PRELIMINARY PLANS

NOT FOR CONSTRUCTION

REV.	DESCRIPTION	DATE	
	CITY OF RALEIGH COMMENTS	06/23/22	
	CITY OF RALEIGH COMMENTS	06/10/23	
	CITY OF RALEIGH COMMENTS	07/07/23	

RESIDENCE

DAWSON

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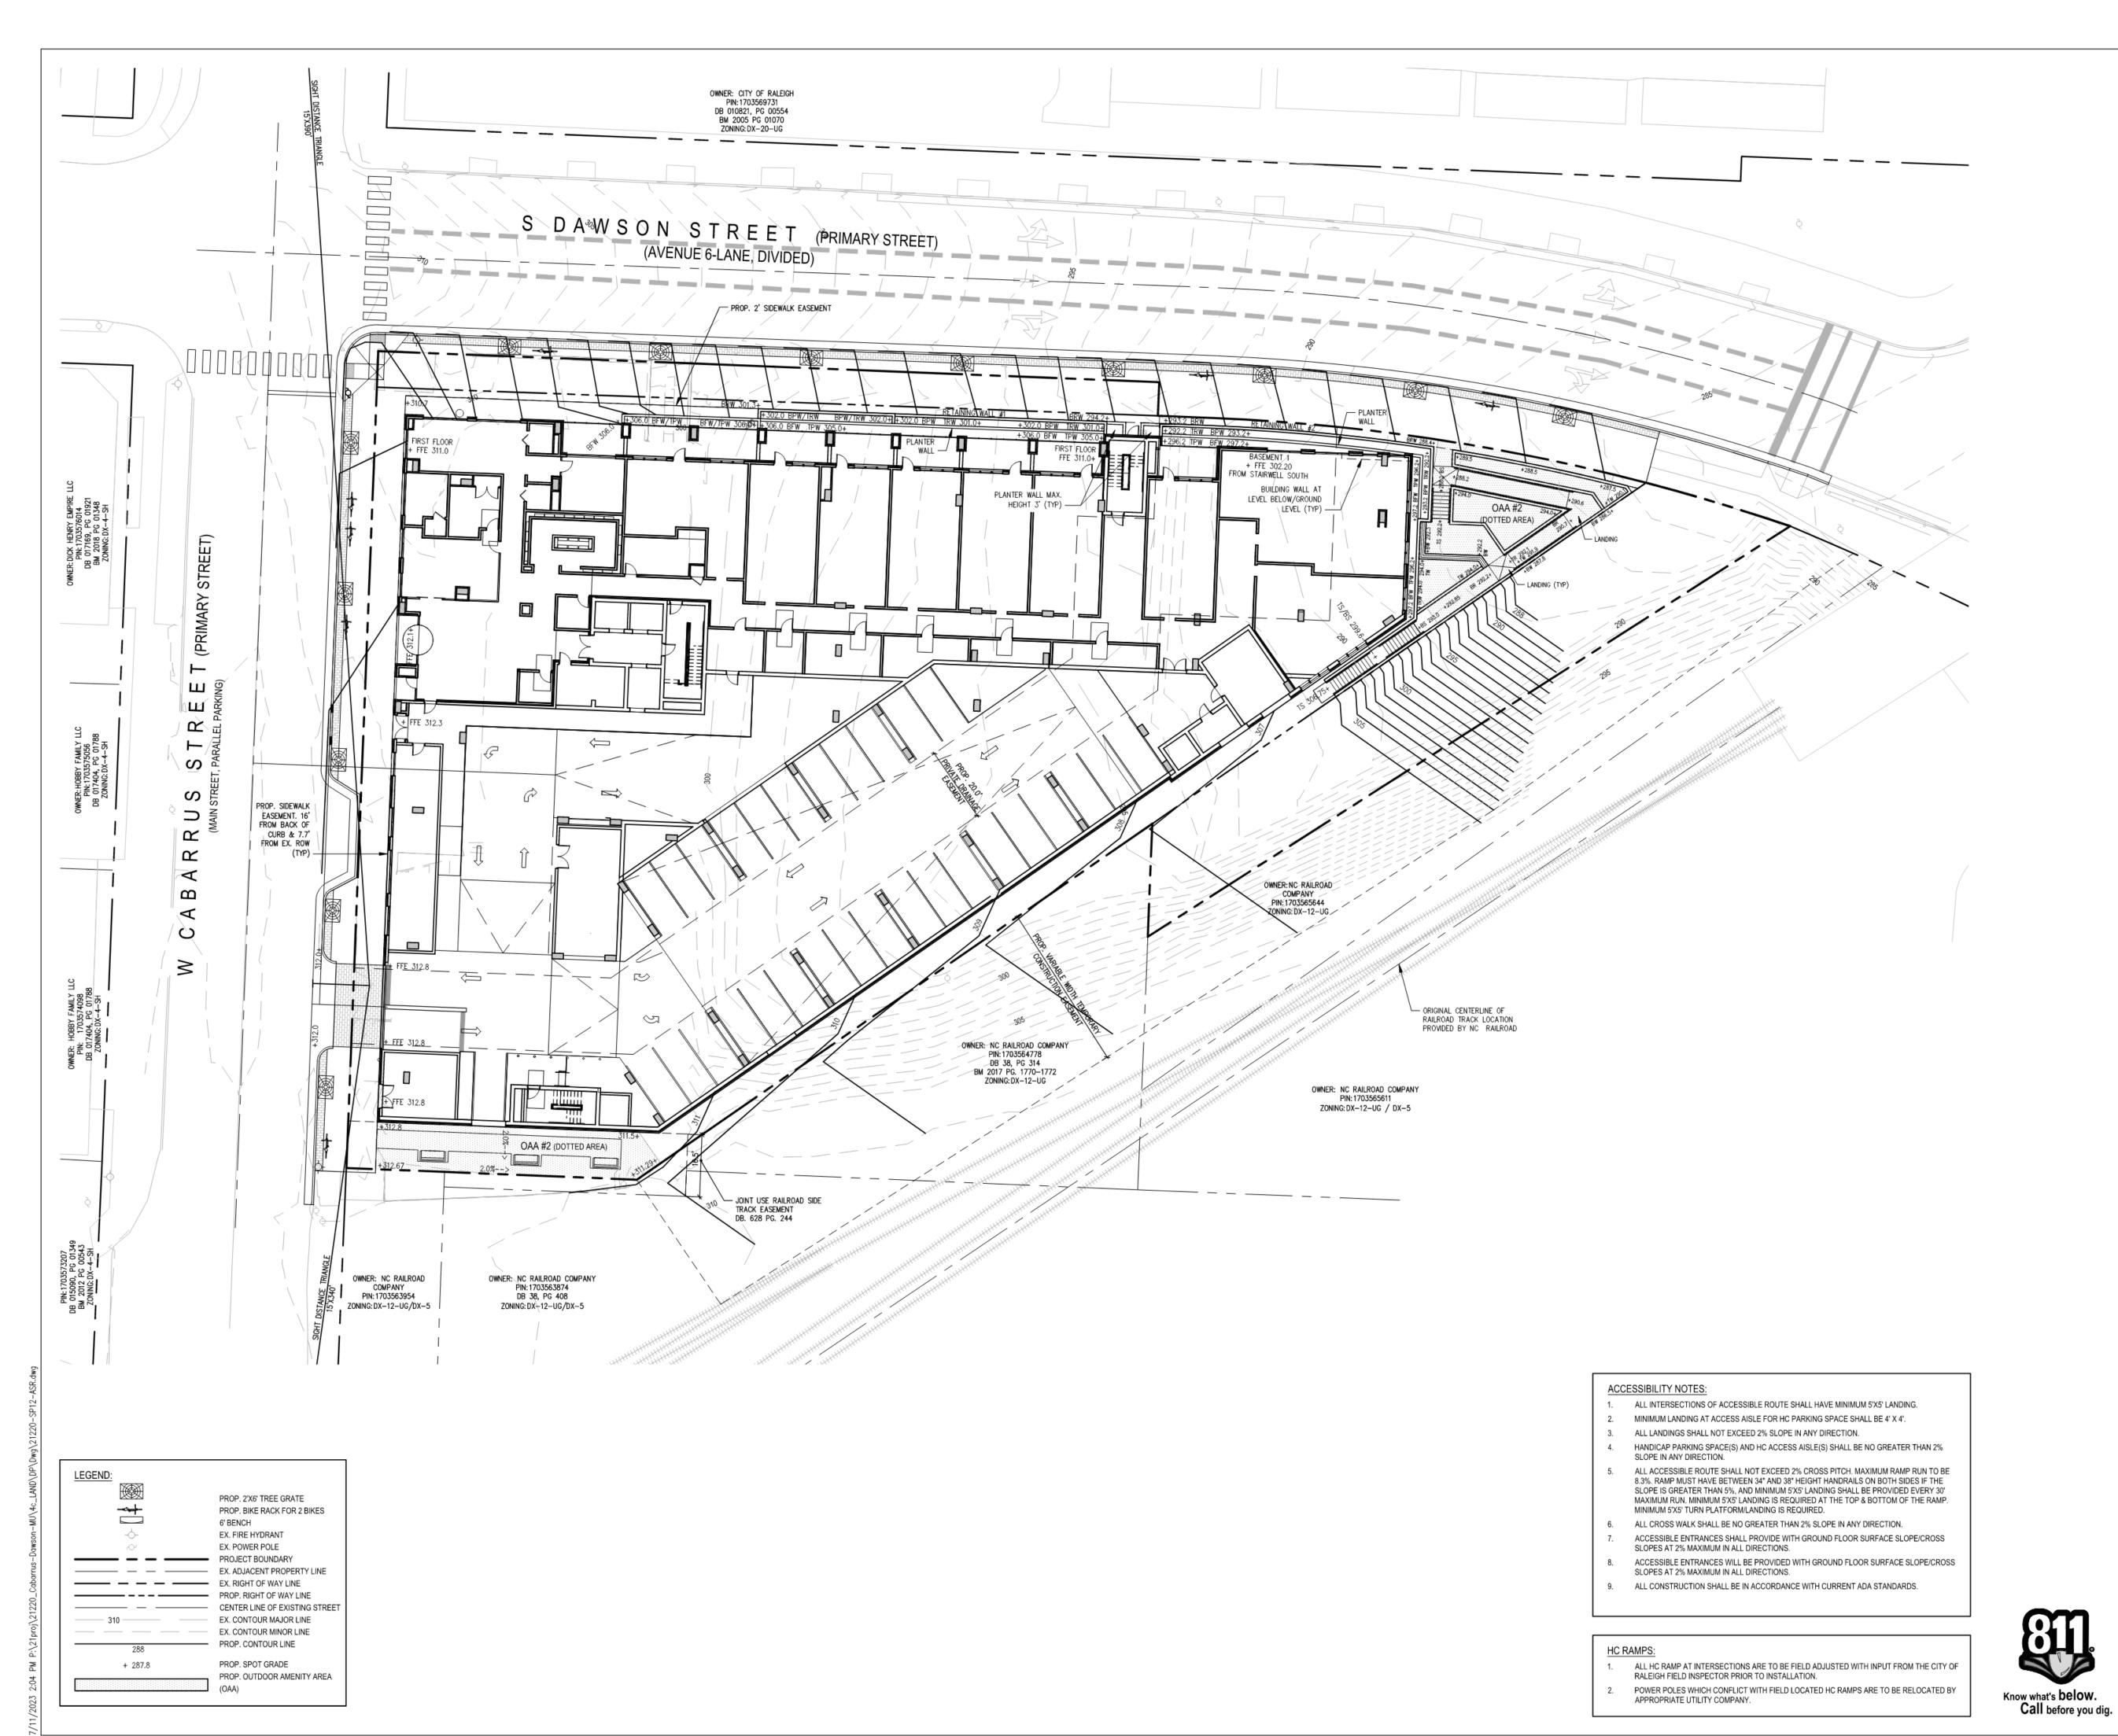
GRADING

- 1. TOPOGRAPHIC AND BOUNDARY SURVEY PROVIDED BY BASS, NIXON, AND
- 2. PROPERTY IS LOCATED IN ZONES X (AREA DETERMINED TO BE OUTSIDE THE O.2% ANNUAL CHANCE AND FUTURE 1% ANNUAL CHANCE FLOODPLAIN) BASED ON THE FEMA MAP NUMBER 3720170300J DATED MAY
- 3. NO ONSITE STREAMS OR WETLANDS HAVE BEEN IDENTIFIED WITHIN THE

PROJECT NO.: 22009 DRAWN BY: JAC CHECKED BY: JAC 04/15/22 1" = 20' SCALE:

C-2

2 of 4




ASR-0033-2022

GRADING PLAN



			<u> </u>	
20'	10'	0	20'	
SCAL	E: 1" =	20'		

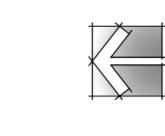

20'	10'	0	20'	4
SCA	LE: 1" =	20'		

PROJECT: EQT-21220 DATE ISSUE: Administrative Site Review 04.22.2022


REVISIONS: 07.06.2022 1st Review Comments 2nd Review Comments 06.13.2023 3rd Review Comments 07.11.2023


REVIEW


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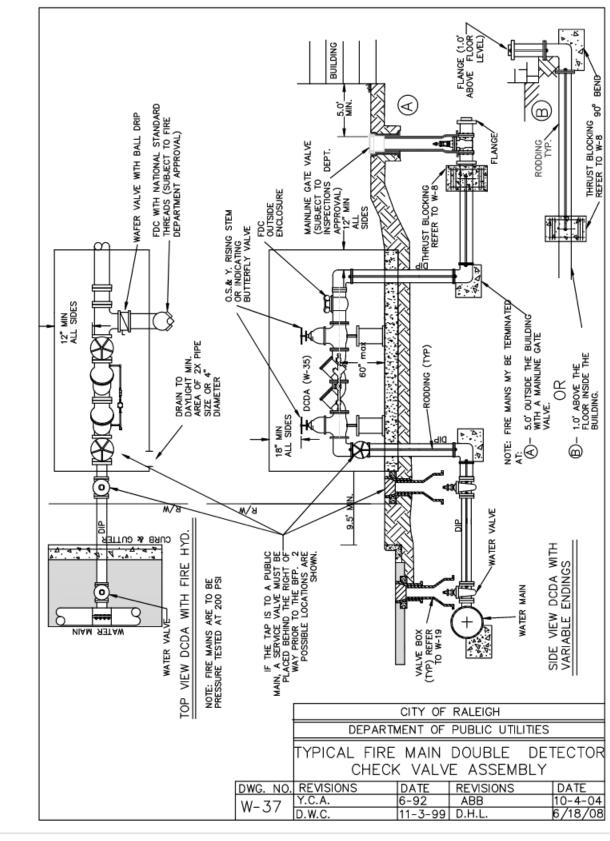
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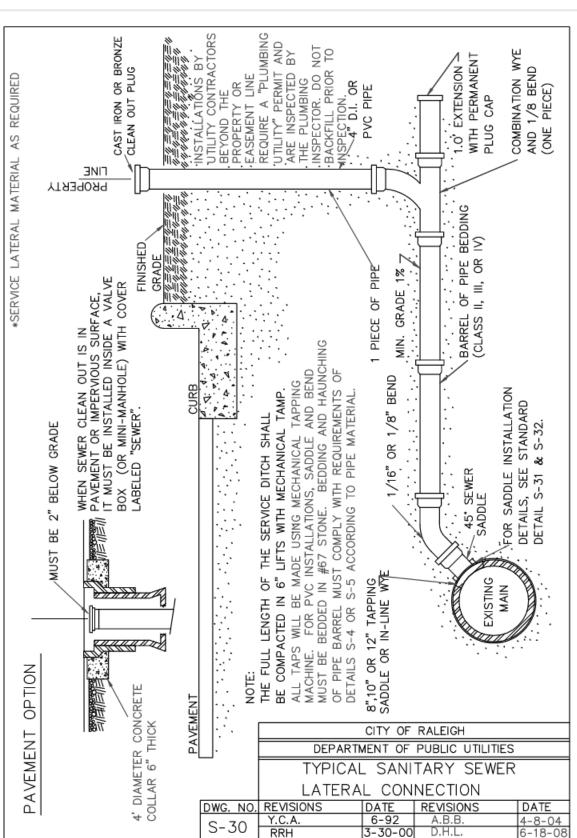
DRAWN BY: KT, SB CHECKED BY: CONTENT: GRADING PLAN







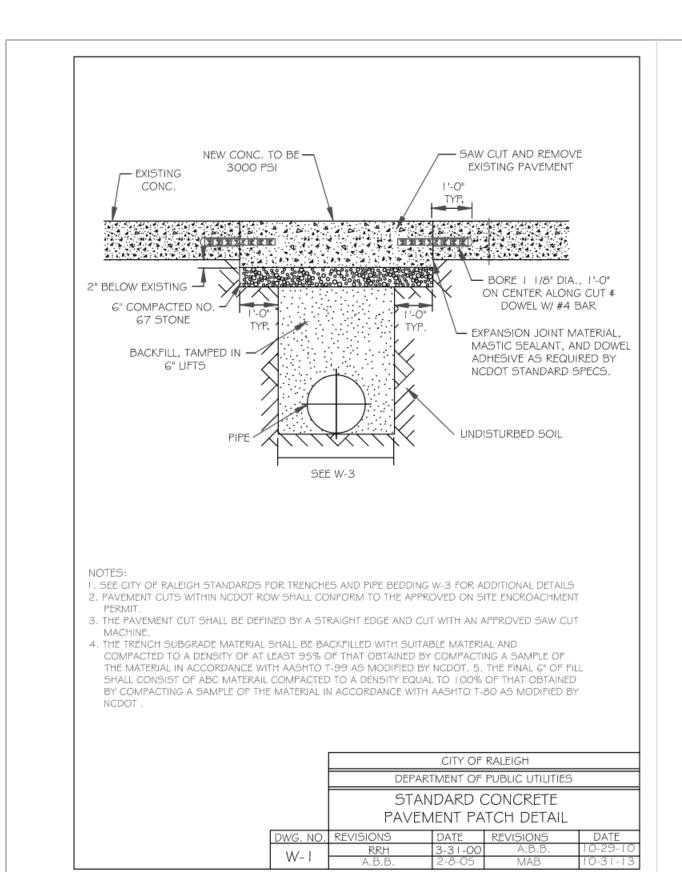


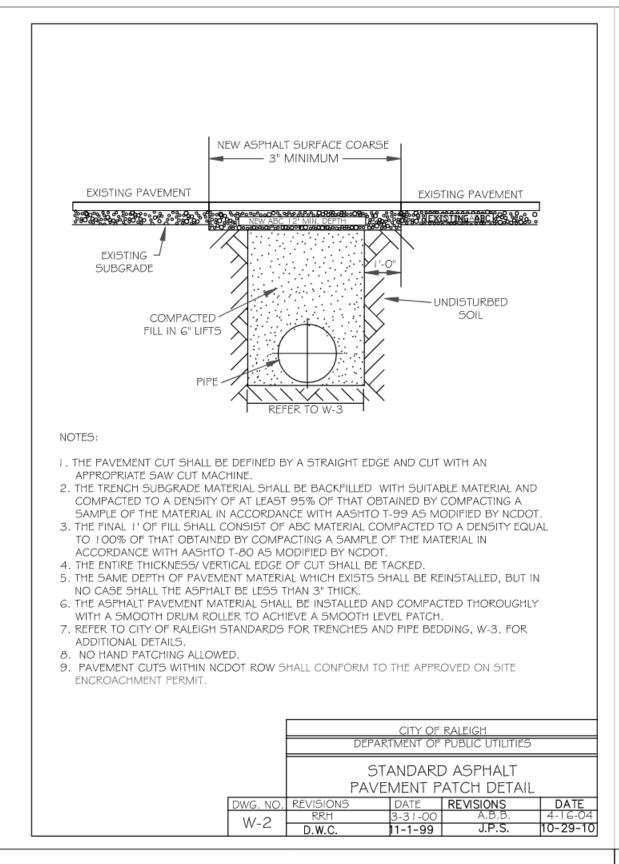


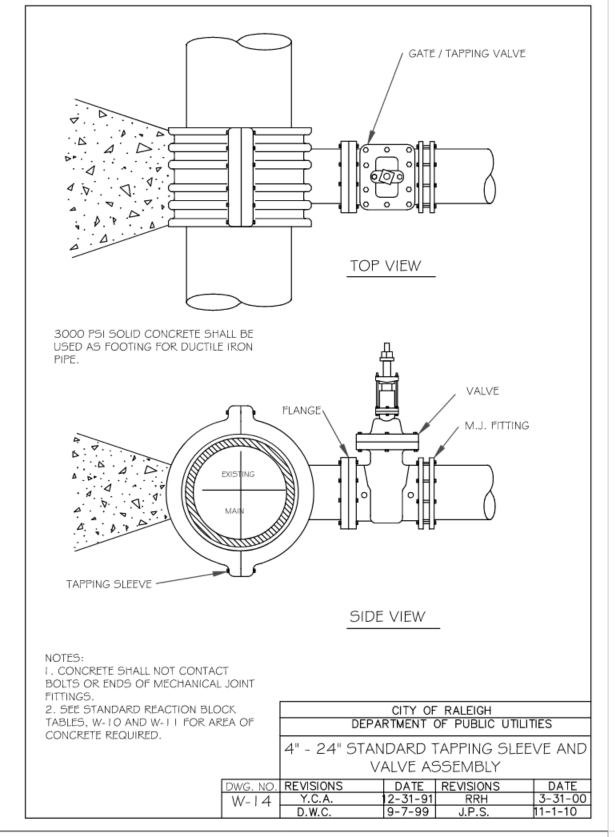

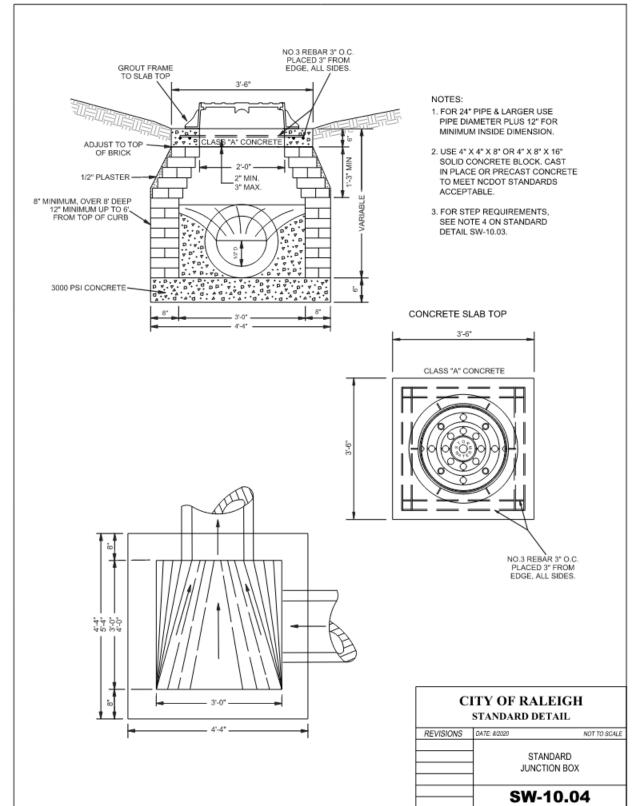

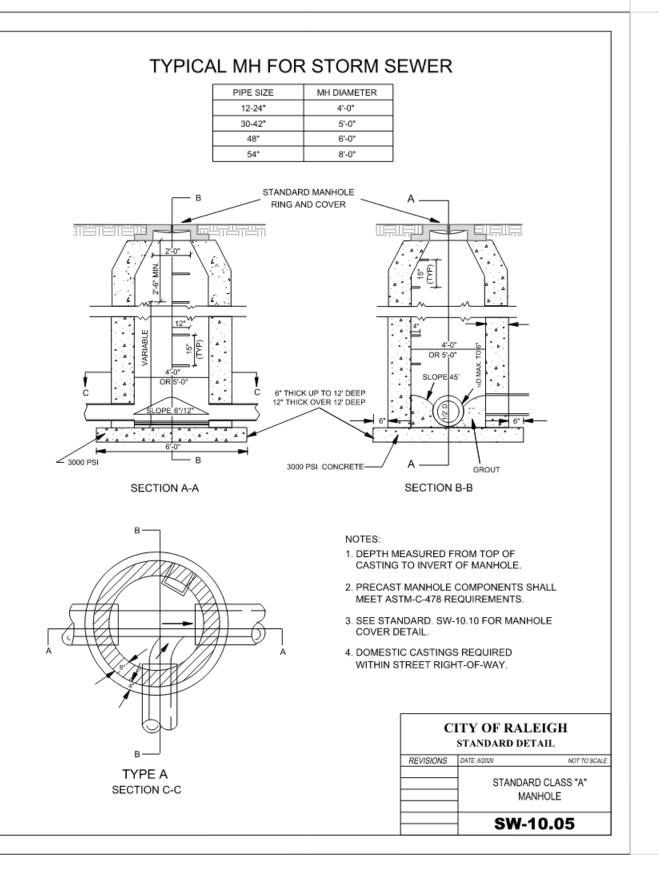

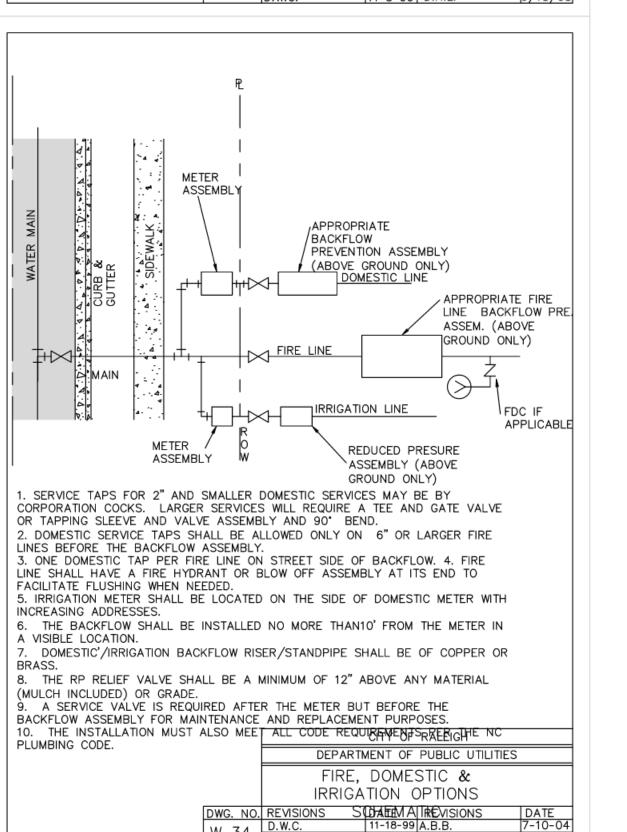

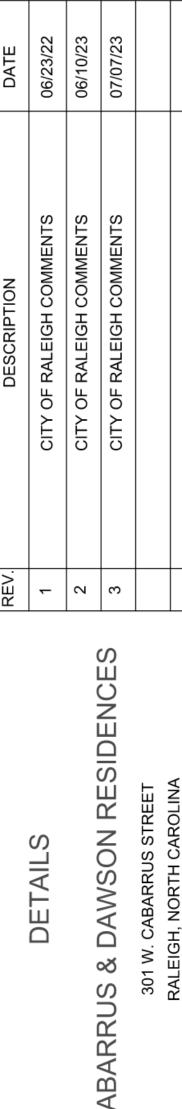

PRELIMINARY PLANS

NOT FOR CONSTRUCTION

ILE: D:\CCS\Projects\2002\22009 Cabarrus Tower\ LAYOUT: Details-1


PROJECT NO.: 22009
DRAWN BY: JAC
CHECKED BY: JAC


SCALE:


C-3


04/15/22 1" = 20'

3 of 4

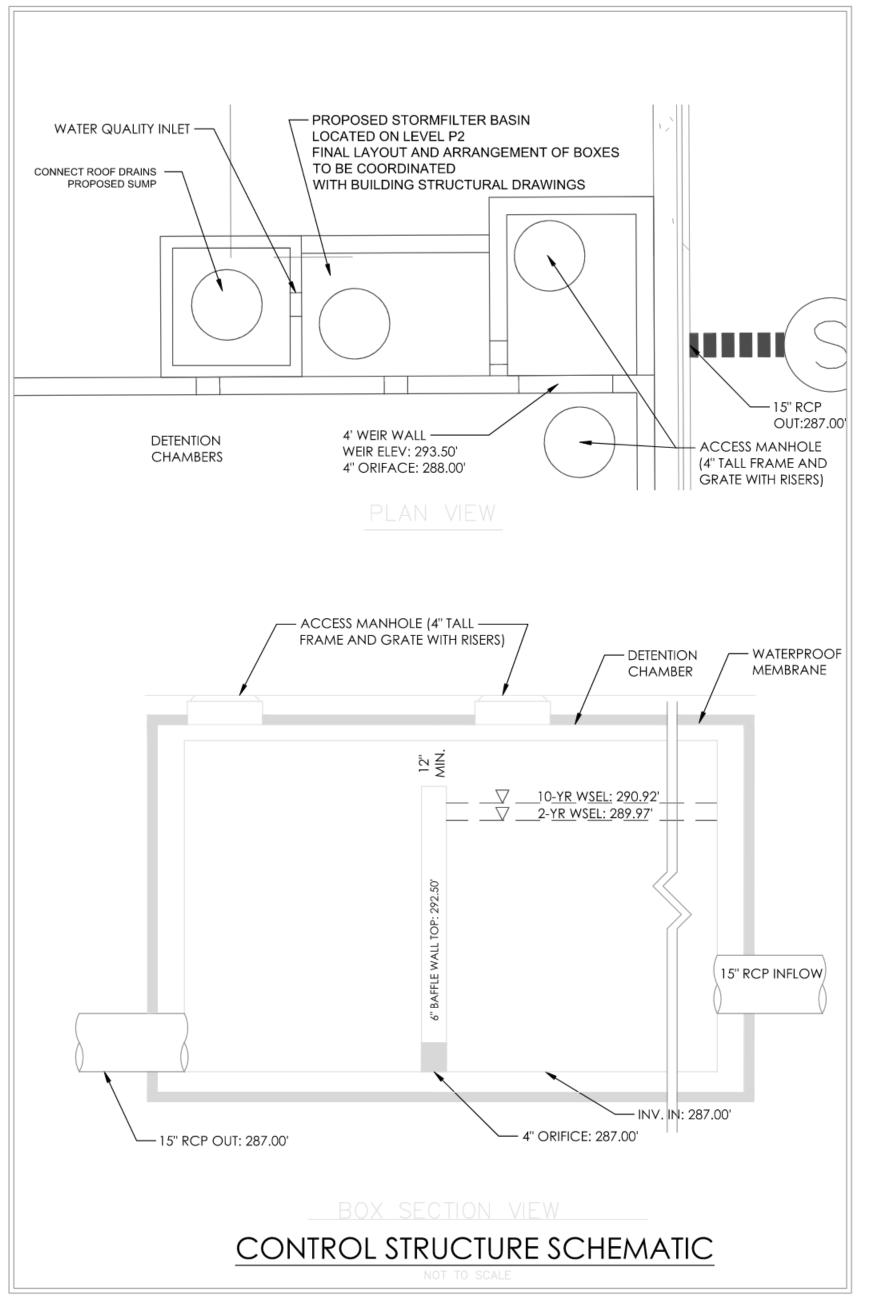


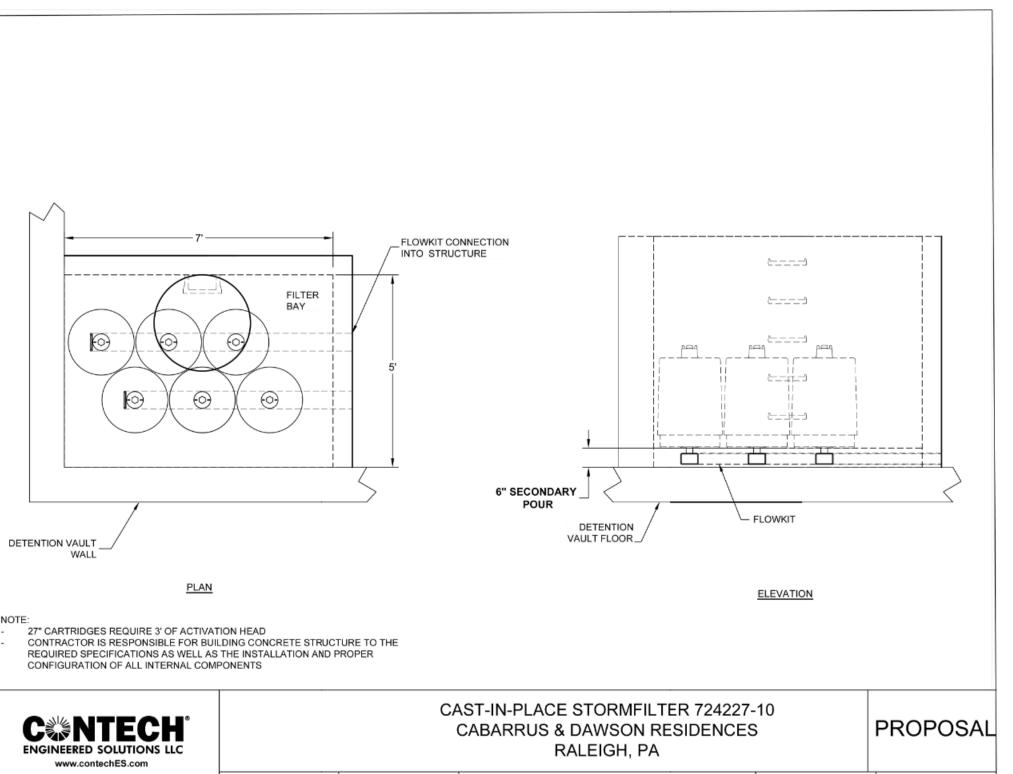

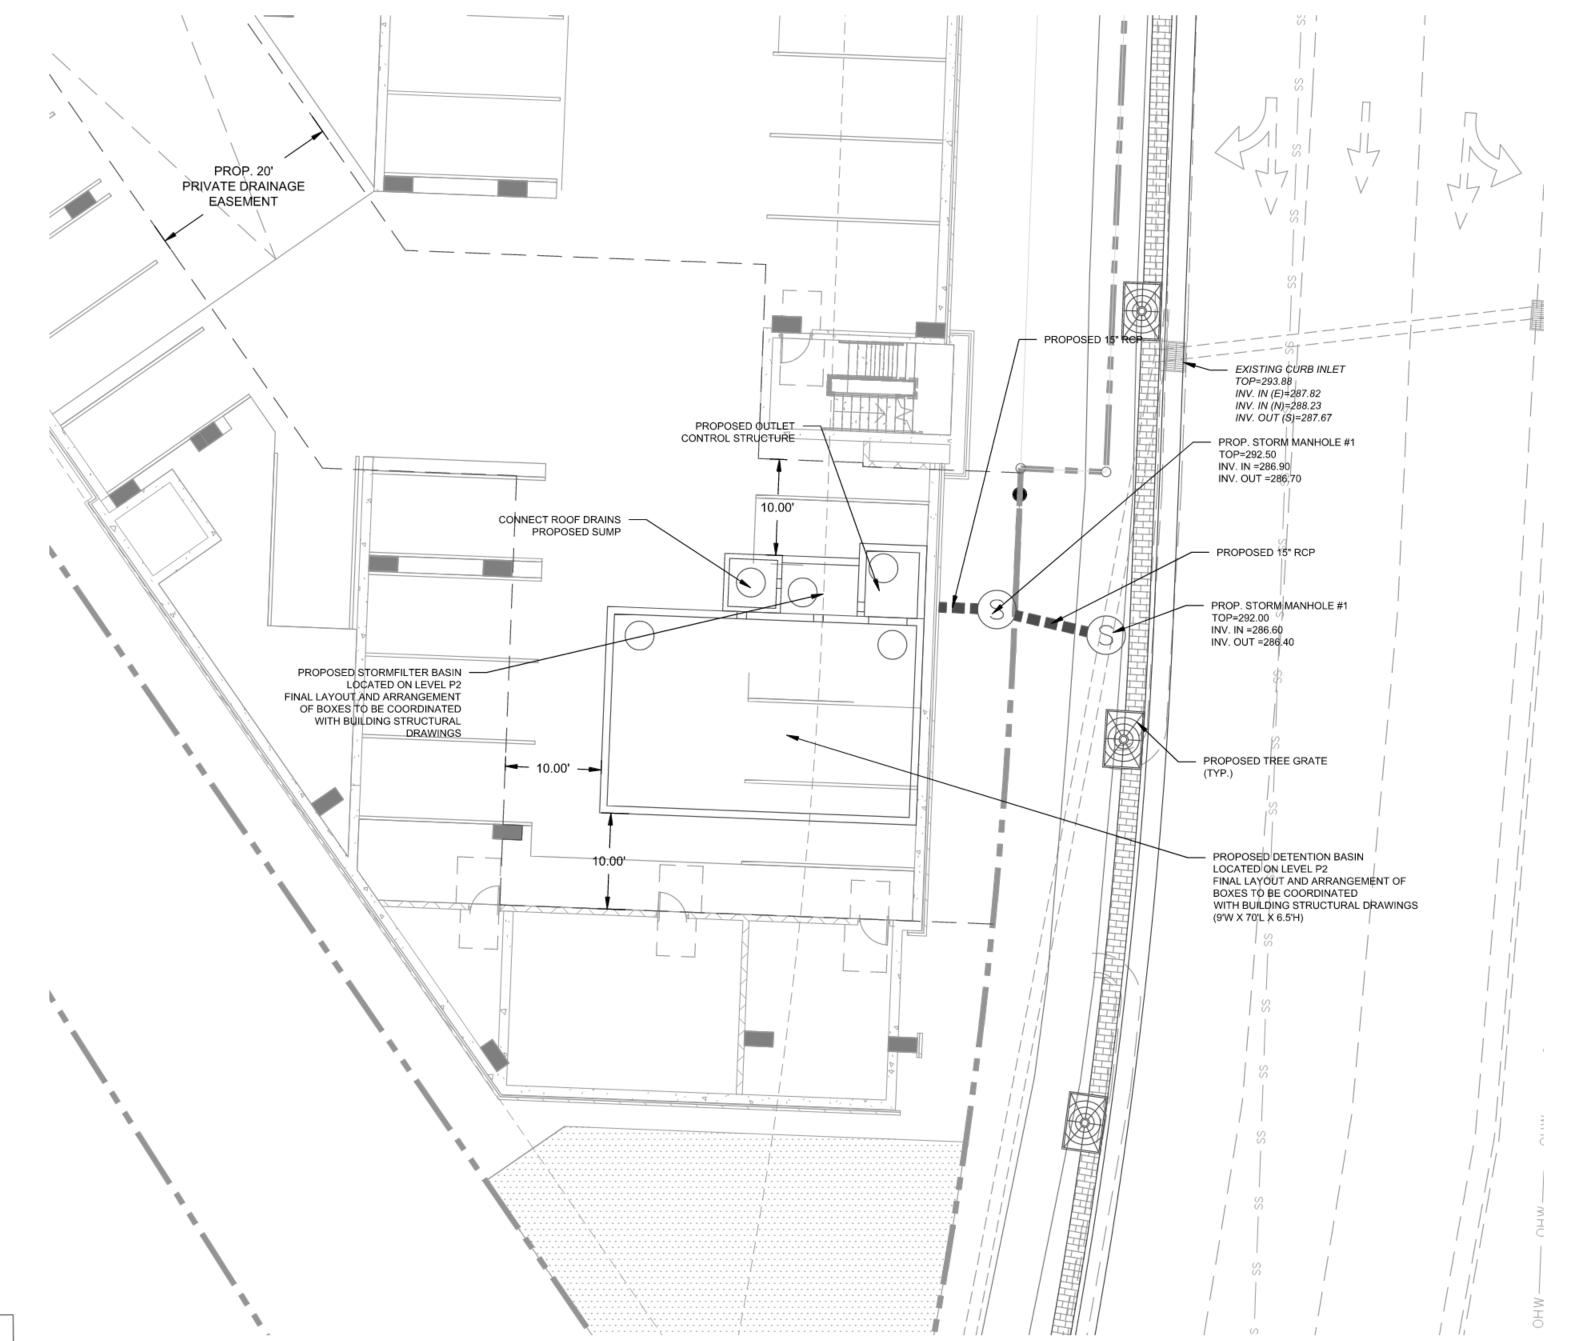

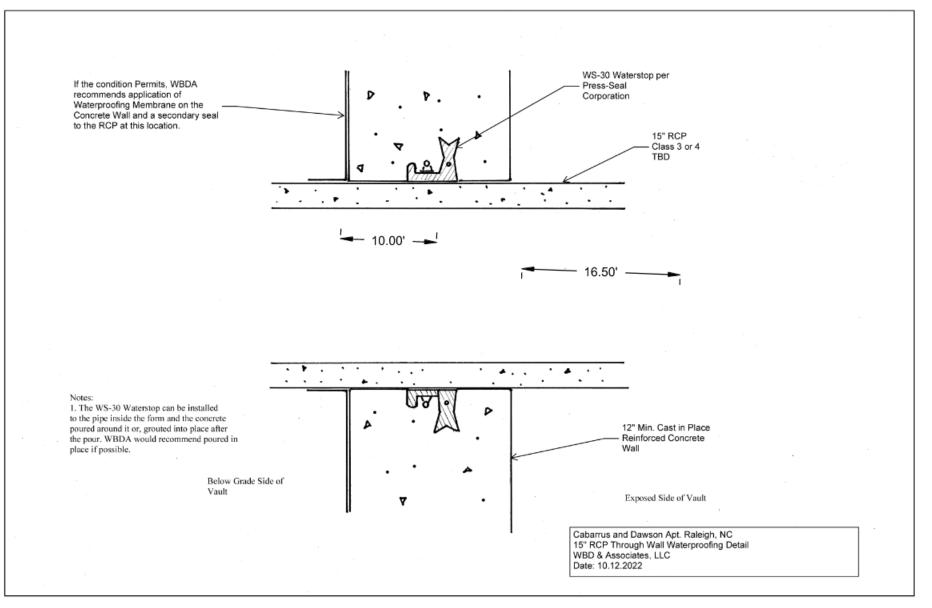



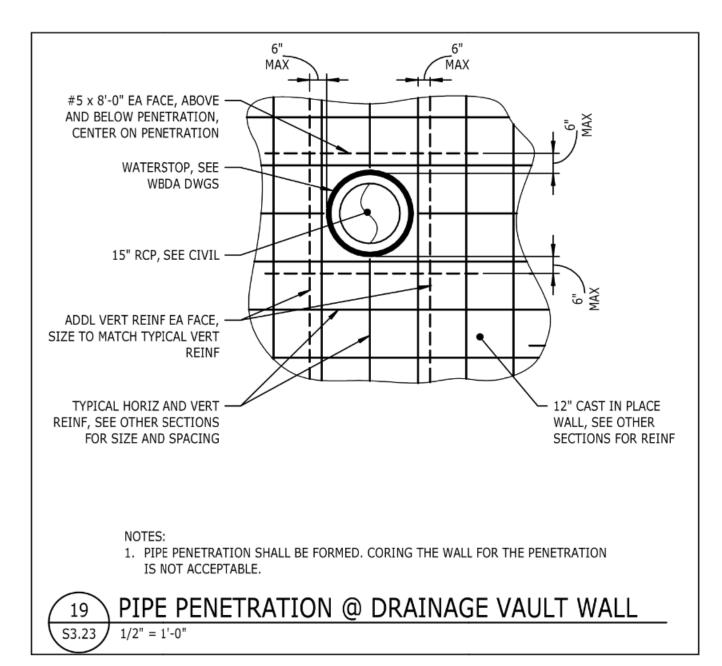

PR	NOT FO			NS
DATE	06/23/22	06/10/23	07/07/23	
DESCRIPTION	CITY OF RALEIGH COMMENTS	CITY OF RALEIGH COMMENTS	CITY OF RALEIGH COMMENTS	


S STORMFILTER AND DETENTION BASIN DETAILS ABARRUS & DAWSON RESIDENCE

PROJECT NO.: 22009 DRAWN BY: JAC CHECKED BY: JAC 04/15/22

SCALE:

4 of 4

1" = 20'

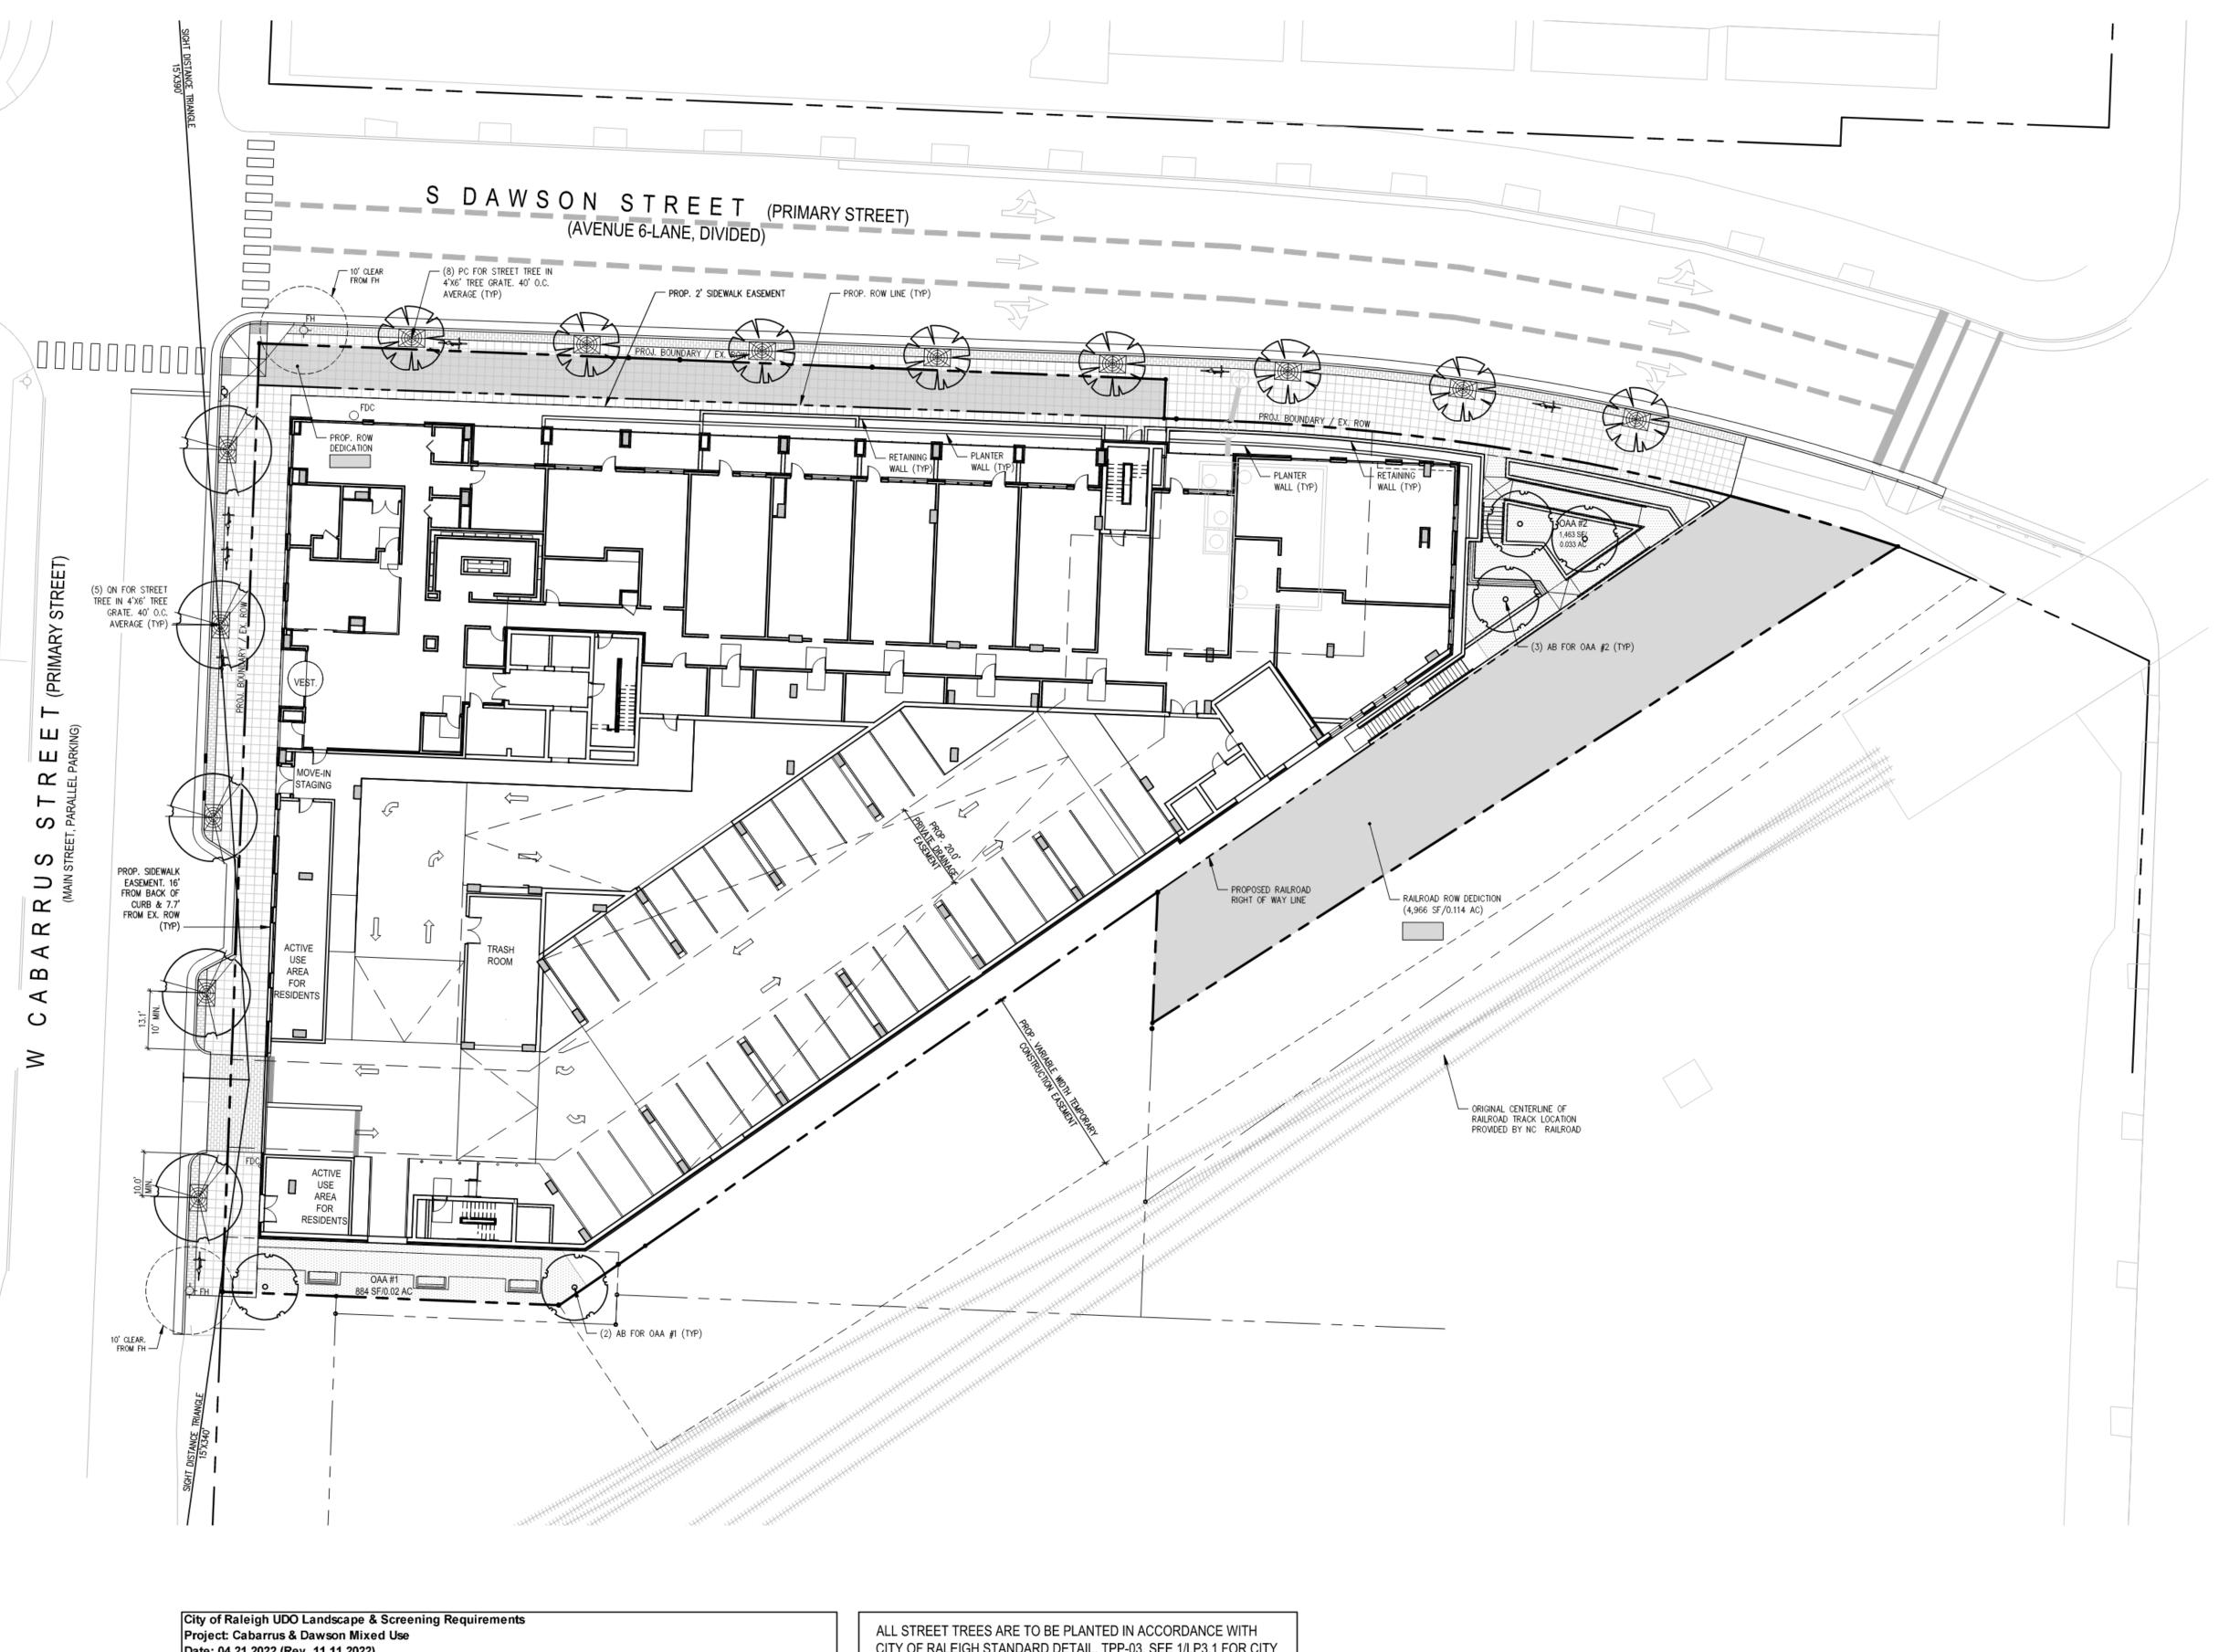

Date: 04.21.2022 (Rev. 11.11.2022) Street Tree - W Cabarrus Street 207 / 40 = 5 EA Length of Right of Way Shade Trees Required (3" cal. 10' ht. @ 40' o.c. average; round down) Shade Trees Provided (3" cal. 10' ht. @ 40' o.c. average) Street Tree - S Dawson Street NCDOT Street Length of Right of Way

Small Trees Required (1.5" cal. 6' ht. @ 40' o.c. average; round down) 330 | LF 330 | 40 = 8 EA 8 EA Small Trees Provided (1.5" cal. 6' ht. @ 40' o.c. average) Outdoor Amenity Area 4,495 / 1,000 = 4.5 Required Outdoor Amenity Area Required Trees (2" cal. min) per 1,000 SF Trees Provided (2" cal. min.) OAA #1 OAA #2 OAA #3 Total Trees Provided

CITY OF RALEIGH STANDARD DETAIL, TPP-03. SEE 1/LP3.1 FOR CITY OF RALEIGH DETAILS AND NOTES.

SEE LP2.1 FOR RETAINING WALL & PLANTER WALL PLANTINGS. SEE LP9.1 FOR LANDSCAPE DETAILS AND SPECIFICATIONS.

QTY	SYM	BOTANICAL NAME	COMMON NAME	*CALIPER	*HEIGHT	MATURE HT	MATURE W	REMA
TREES								
5	AB	Acer buergerianum	Trident Maple	2" MIN	6' MIN	20'-35'	20'-30'	OA
5	QN	Quercus nuttalli	Nuttall Oak	3" MIN	10' MIN	50'	45'	STR
8	PC	Pistacia chinensis	Chinese Pistache	1.5" MIN	6' MIN	25'	25'	STR

	PLANT LEGEN	I <u>D:</u>	
	\odot	(AB) Acer buergerianum; TRIDENT MAPLE FOR OUTDOOR AMENITY AREA	
]		(QN) Quercus nuttalli, NUTTALL OAK FOR STREET TREE	
		(PC) Pistachia chinensis, CHINESE PISTACHE FOR STREE TREE	
		4'x6' ADA TREE GRATE	Know what's below. Call before you dig.

ASR-0033-2022

CODE COMPLIANCE LANDSCAPE PLAN

SCALE: 1" = 20'

REVISIONS: 1st Review Comments 2nd Review Comments 3rd Review Comments DRAWN BY: SB, ML CHECKED BY: CONTENT: CODE COMPLIANCE LANDSCAPE PLAN

REVIEW

SITE

ADMINISTRATIVE

PROJECT: EQT-21220

ISSUE: Administrative Site Review 04.22.2022


Cabarru 301 W Ca Raleigh, Nort

DATE

07.06.2022

06.13.2023

07.11.2023

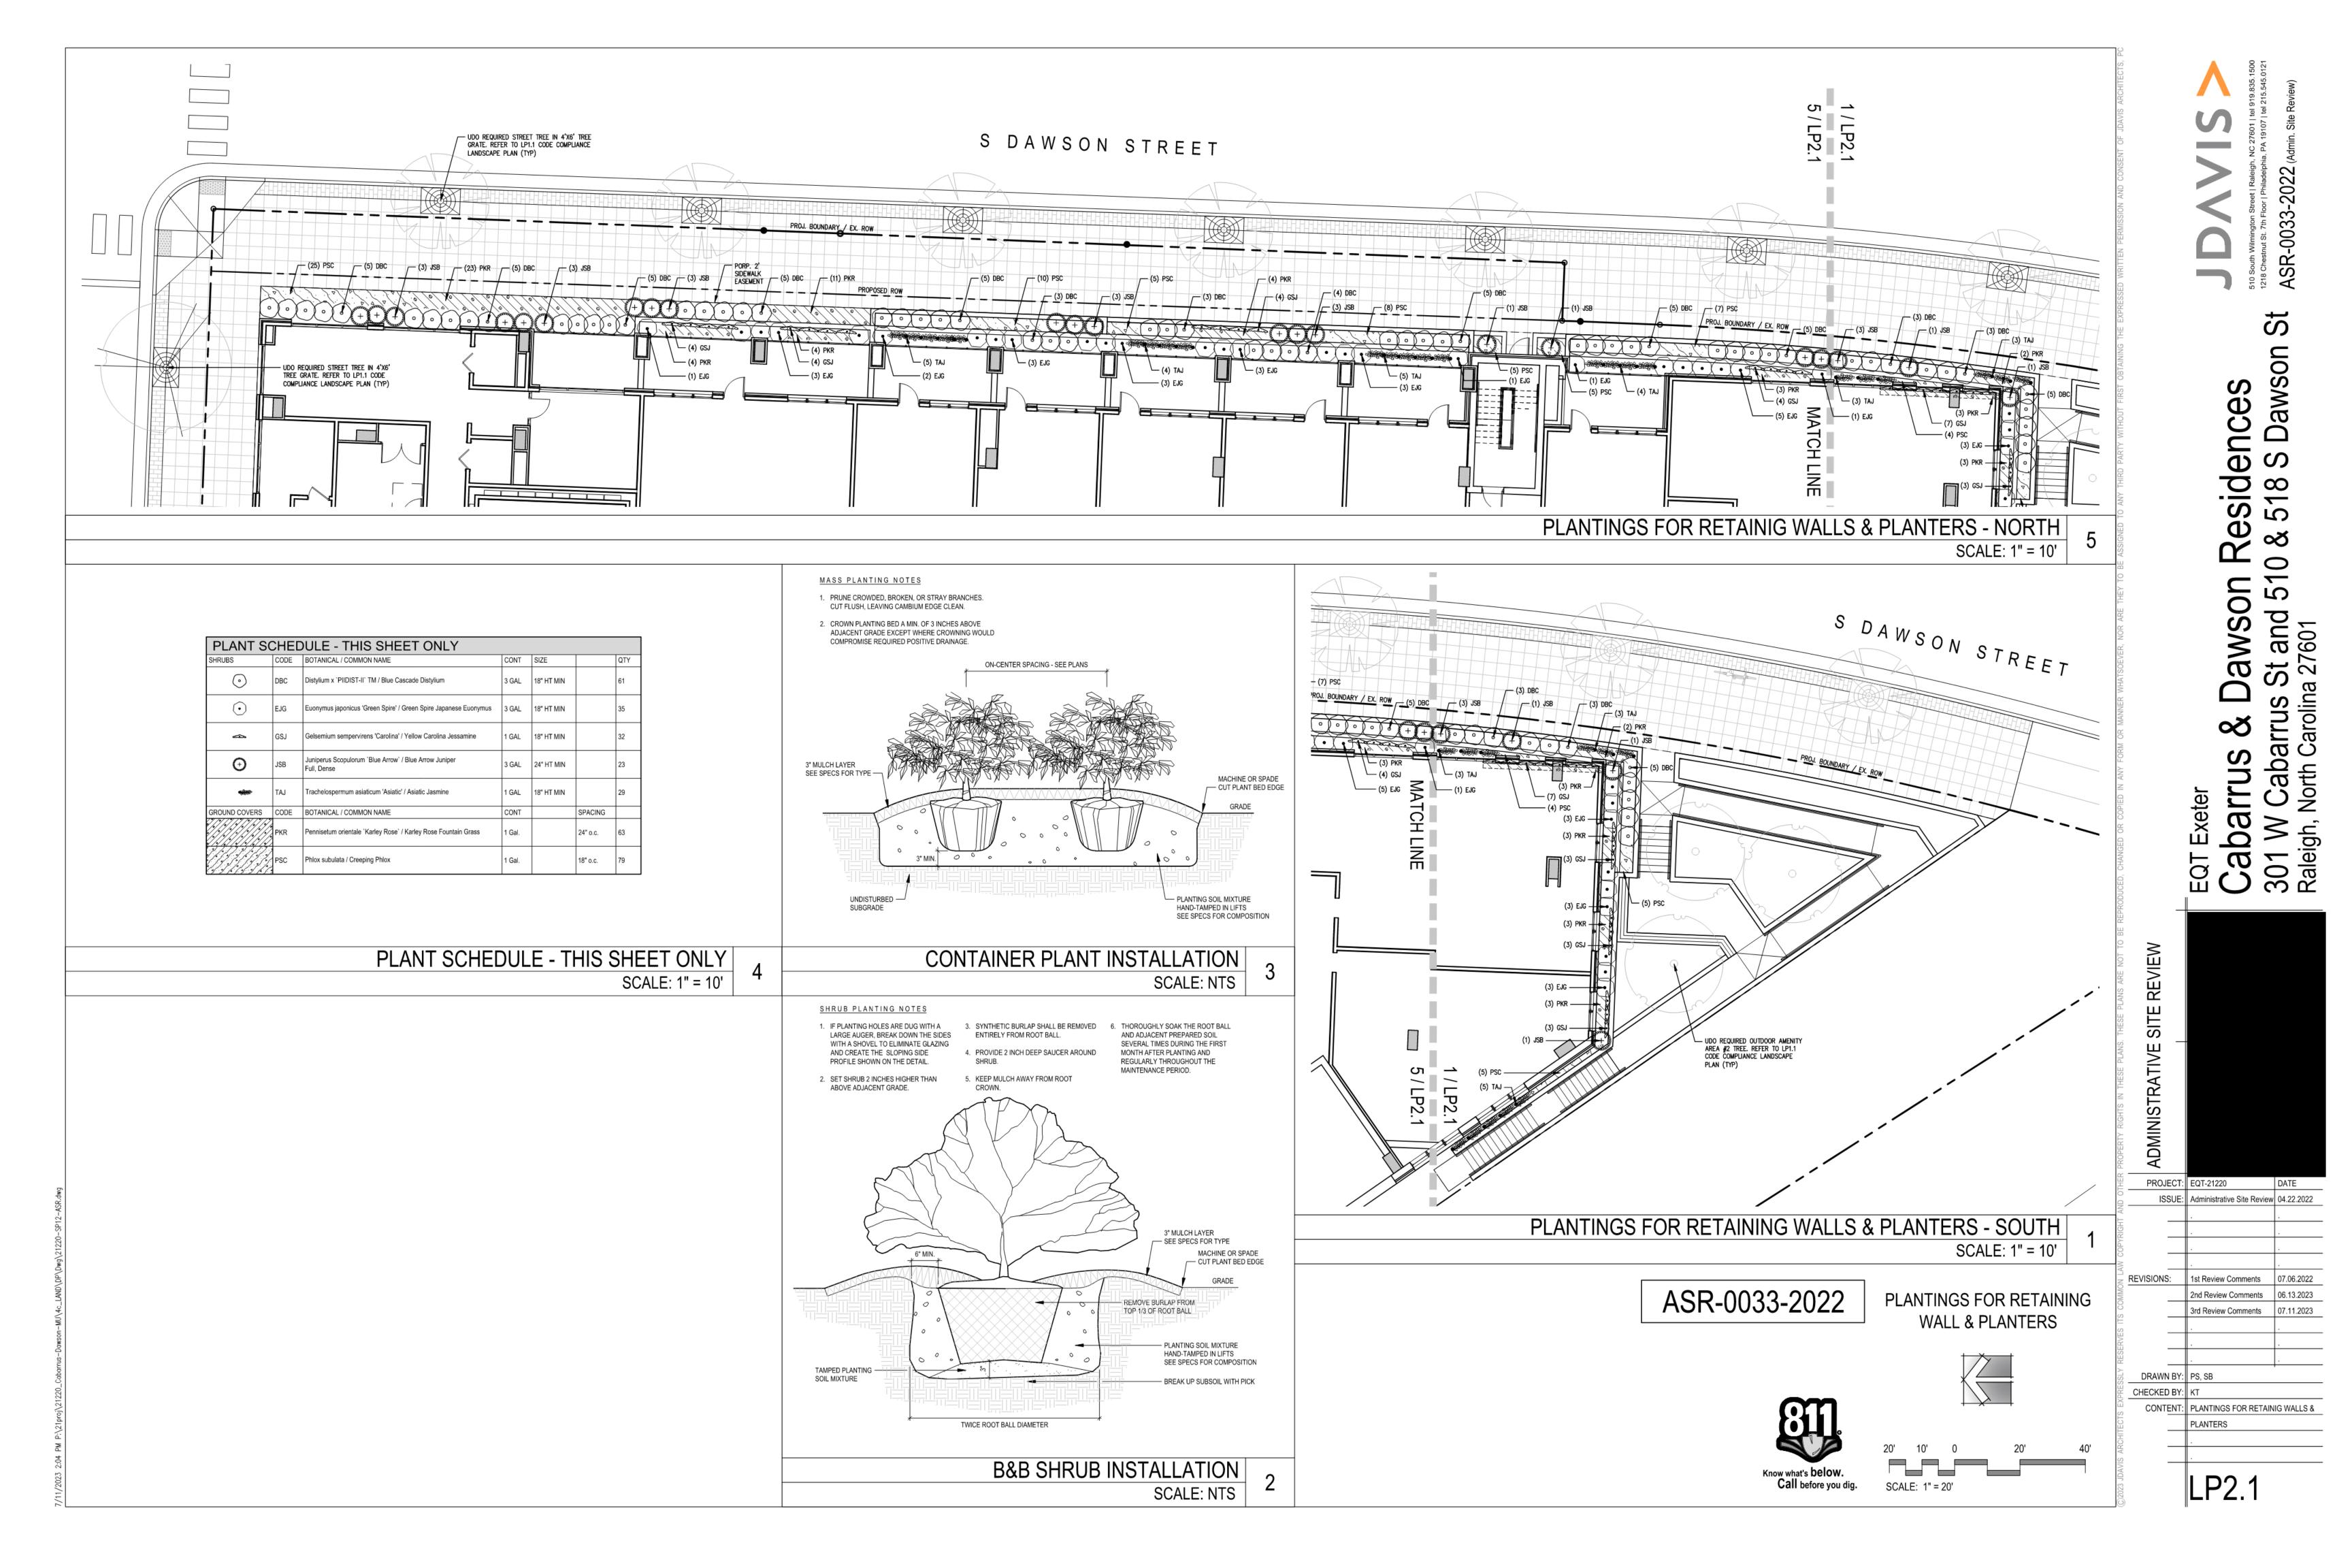

THE PARKS AND RECREATION DEPARTMENT IS RESPONSIBLE FOR PLAN REVIEW, INSPECTION, MONITORING AND ENFORCEMENT ASSOCIATED WITH TREE PLANTING AND MAINTENANCE ON PROPERTY OWNED OR CONTROLLED BYTHE CITY. TREE RELATED ACTIVITIES ARE CONDUCTED IN ADHERENCE TO CITY OF RALEIGH MUNICIPAL CODE TREES AND VEGETATION, PART 9 CHAPTER 8 AND THE CITY TREE MANUAL. WHERE THE

1. THE URBAN FORESTER OR DESIGNEE SHALL REVIEW ALL SITE PLANS WITH TREES IN THE RIGHT OF WAY AND ON CITY OWNED OR CONTROLLED PROPERTY. THIS APPLICATION PROCESS DESCRIBES THE REQUIREMENTS FOR PLAN REVIEW, PERMITTING, TREE

2. WHERE DEVELOPMENT ABUTS A STREET CONTROLLED BY THE NORTH CAROLINA DEPARTMENT OF TRANSPORTATION TREES MAY NOT BE REQUIRED OR WILL FALL UNDER THE LANDSCAPE REQUIREMENTS OF THE STATE. THE CITY IS STILL REQUIRED TO REVIEW AND APPROVE

THIS IS THE APPLICATION PROCESS FOR ACTIVITIES IMPACTING CITY TREES. IMPACTS INCLUDE BUT ARE NOT LIMITED TO PLANTING, REMOVAL, PRUNING, TRENCHING, BORING, EXCAVATING, FILLING, FERTILIZING, TREATING FOR DISEASE OR INSECTS, INSTALLING DECORATIONS AND

- VIII. URBAN TREE PIT DETAIL AND SUBSURFACE ROOT TREATMENT IF APPLICABLE WITH 600CUFT MINIMUM SOIL

1. A TREE MAINTENANCE FEE SHALL BE ASSESSED AT THE TIME OF PERMIT ISSUANCE FOR EACH STREET TREE TO BE INSTALLED. THIS

- 3. EXCEPTIONS AND DESIGN ALTERNATIVES ARE ENCOURAGED TO ACHIEVE SOIL VOLUME: URBAN FORESTER REVIEW REQUIRED. DESIGNS HAT GROUP TREES AND CONNECT ROOT SPACES WILL BE FAVORED AS WELL AS THE INTRODUCTION OF LID MATERIALS AND
 - c. MINIMUM 6 PATHS FROM EACH TREE, 3 ON EACH SIDE 20' MINIMUM EXTENSION FOR EACH PATH. CONNECT TO ADJACENT PIT
- - a. AMERICAN NATIONAL STANDARDS FOR TREE CARE OPERATIONS, ANSI A300. AMERICAN NATIONAL STANDARDS INSTITUTE, 11
 - b. AMERICAN NATIONAL STANDARD FOR NURSERY STOCK, ANSI Z60.1. AMERICAN NURSERY AND LANDSCAPE ASSOCIATION, 1250

CITY OF RALEIGH STANDARD DETAILS AND NOTES SCALE: NTS

REVISIONS: st Review Comments 07.06.2022 2nd Review Comments 07.11.2023 3rd Review Comments DRAWN BY: CHECKED BY: CONTENT:

ISSUE: Administrative Site Review 04.22.2022

DATE

PROJECT: EQT-21220

LANDSCAPE DETAILS AND

DRAWN BY: Author

CHECKED BY: Checker

CONTENT: BASEMENT 3 - ADD/ALTS

A1.00

OVERALL - PARKING 3 - GARAGE PLAN 1/16" = 1'-0" 1

4 5 4 81' - 10"

DRAWN BY: Author

CHECKED BY: Checker

CONTENT: BASEMENT 2 - OVERALL PLAN

A1.01

OVERALL - PARKING 2 - GARAGE PLAN 1/16" = 1'-0" 1

247' - 3"



DRAWN BY: Author

CHECKED BY: Checker

CONTENT: BASEMENT 1 - OVERALL PLAN

A1.02

OVERALL - PARKING 1 - BLDG/GARAGE PLAN 1

23' - 0"

DRIVE AISLE 266' - 5 1/4"

DRAWN BY: Author

CHECKED BY: Checker

CONTENT: 1ST FLOOR - OVERALL PLAN

A1.03

OVERALL - 1ST FLOOR - BLDG/GARAGE PLAN 1/16" = 1'-0" 1




DRAWN BY: Author

CHECKED BY: Checker

CONTENT: 2ND FLOOR - OVERALL PLAN

A1.04

OVERALL - 2ND FLOOR - GARAGE PLAN 1/16" = 1'-0" 1

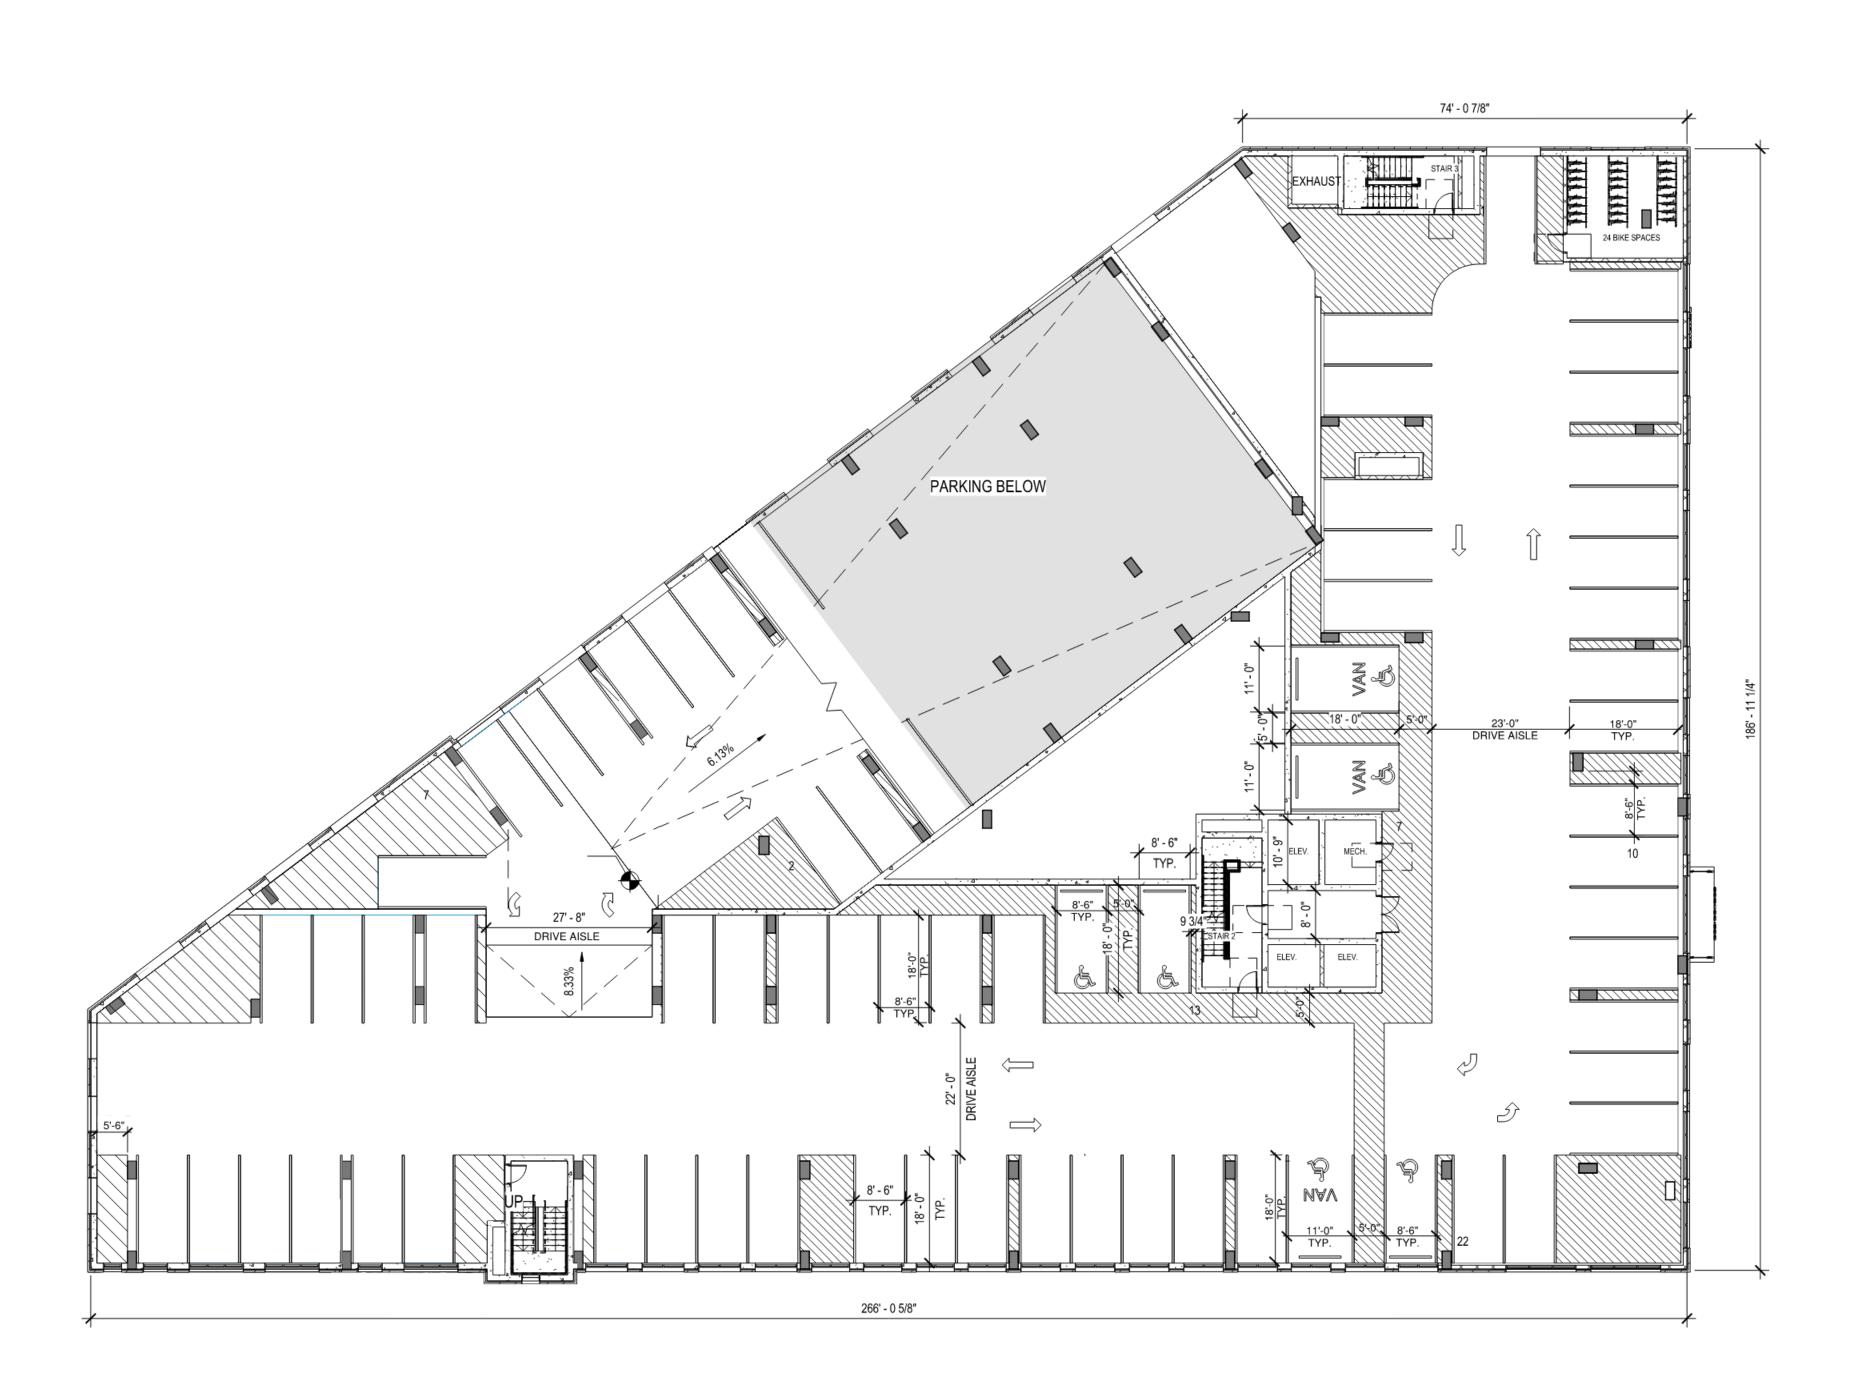

Z


DRAWN BY: Author

CHECKED BY: Checker

CONTENT: 3RD FLOOR - OVERALL PLAN

A1.05

OVERALL - 3RD FLOOR - BUILDING PLAN
1/16" = 1'-0"

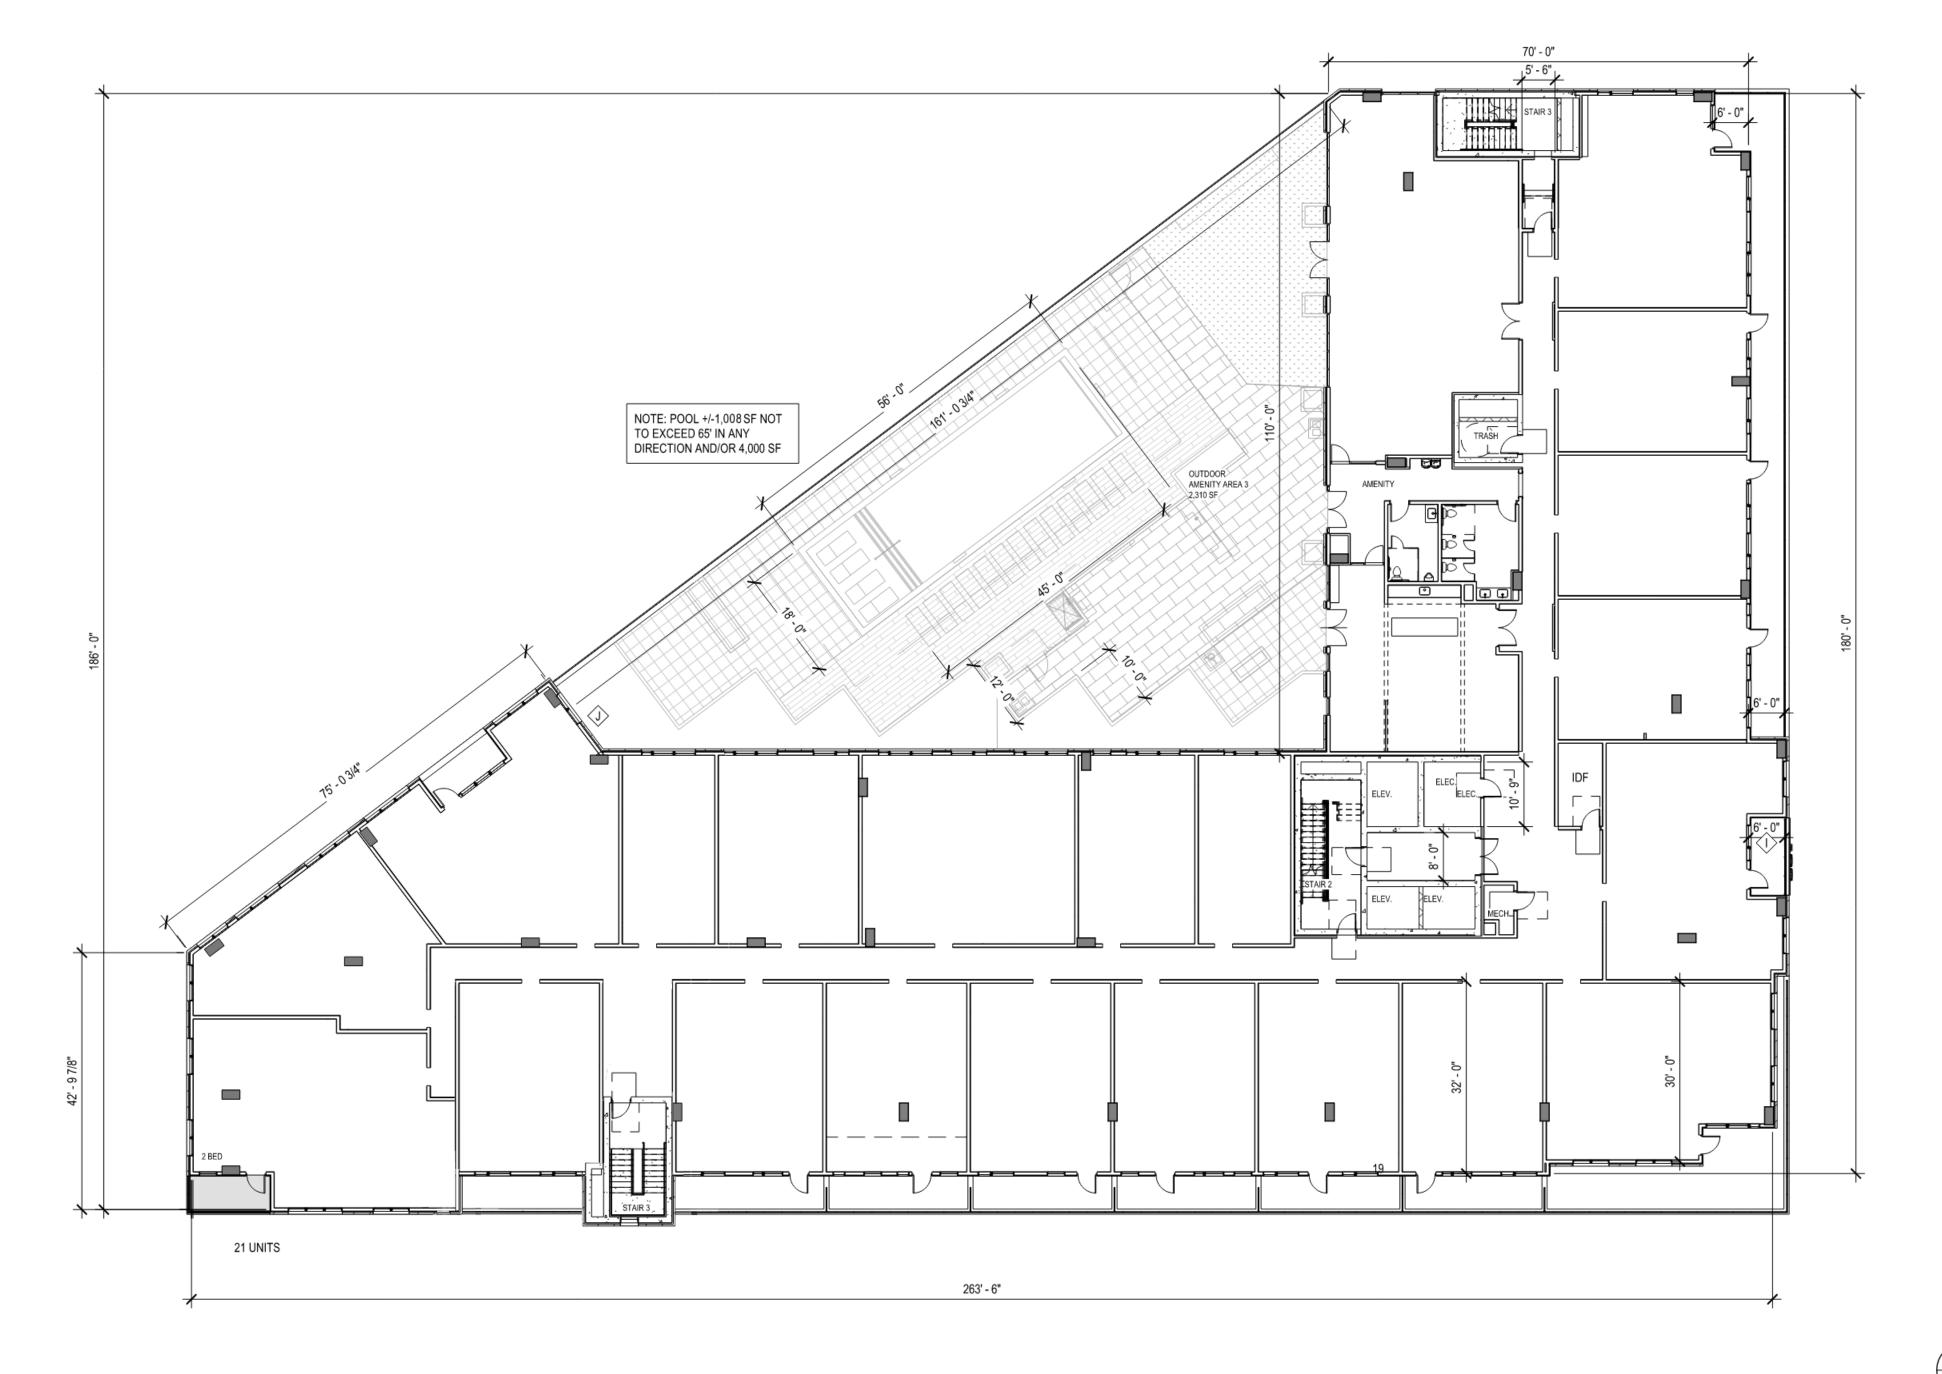




DRAWN BY: Author

CHECKED BY: Checker

CONTENT: 4TH FLOOR - OVERALL PLAN

A1.06

OVERALL -4th-11th Floor- BUILDING PLAN
1/16" = 1'-0"

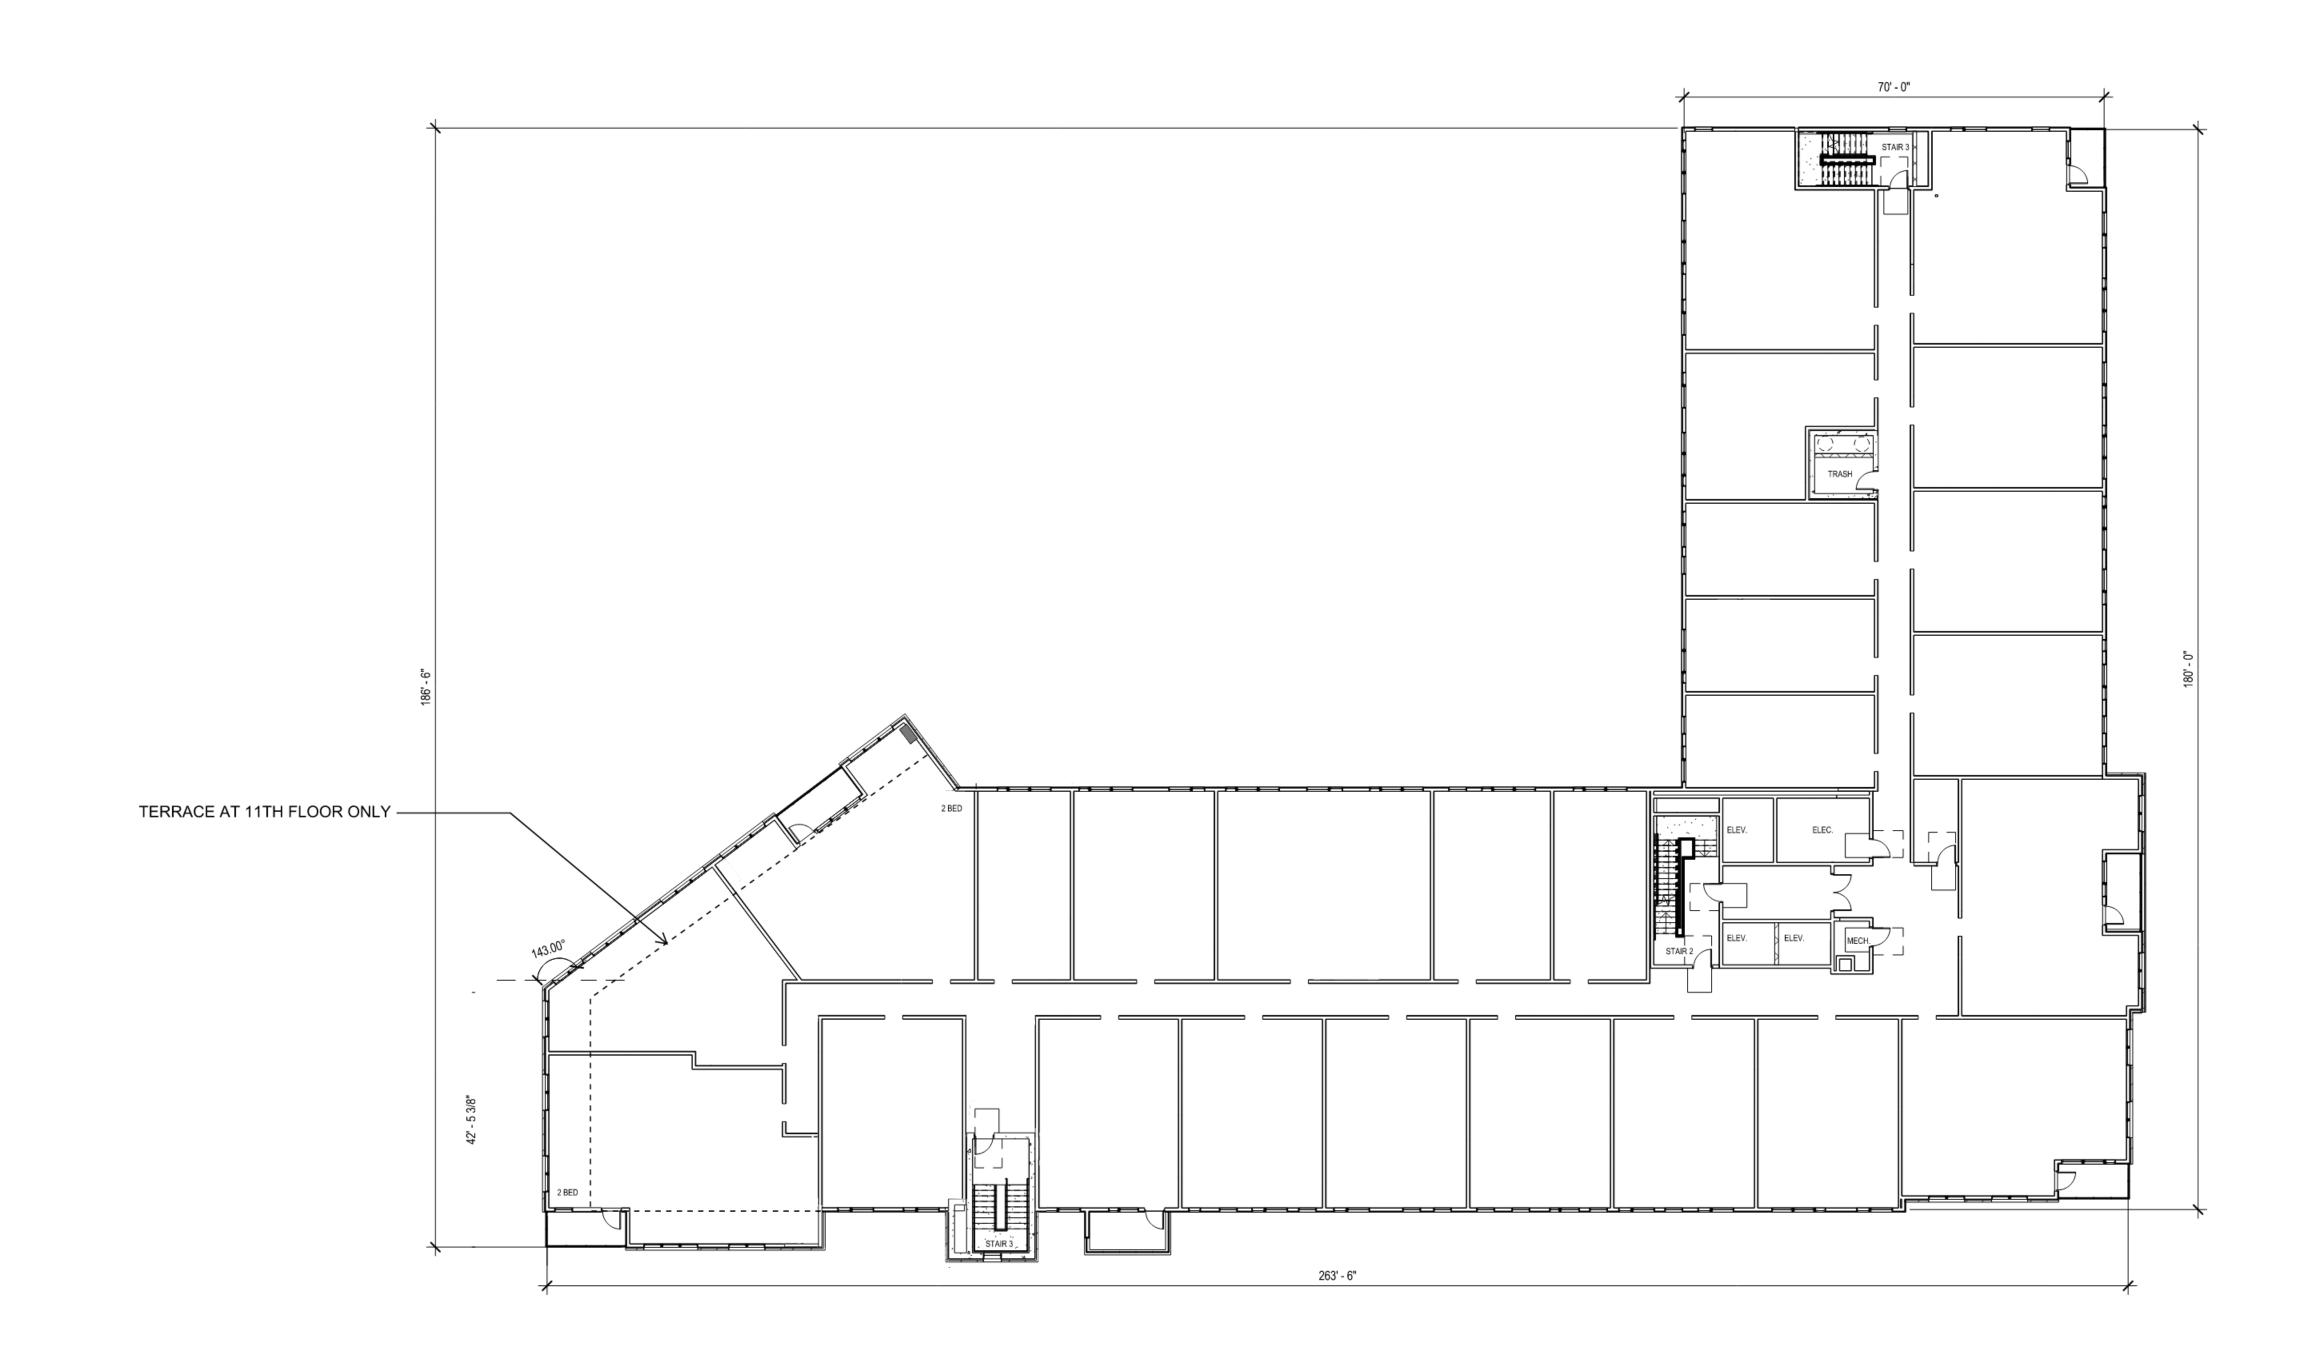

| Comments | Comments

DRAWN BY: Author


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CONTENT: 12TH FLOOR - OVERALL PLAN

CONTENT. 12TH FLOOR - OVERALL PL

A1.14

OVERALL - 12TH FLOOR - BUILDING PLAN
1/16" = 1'-0"



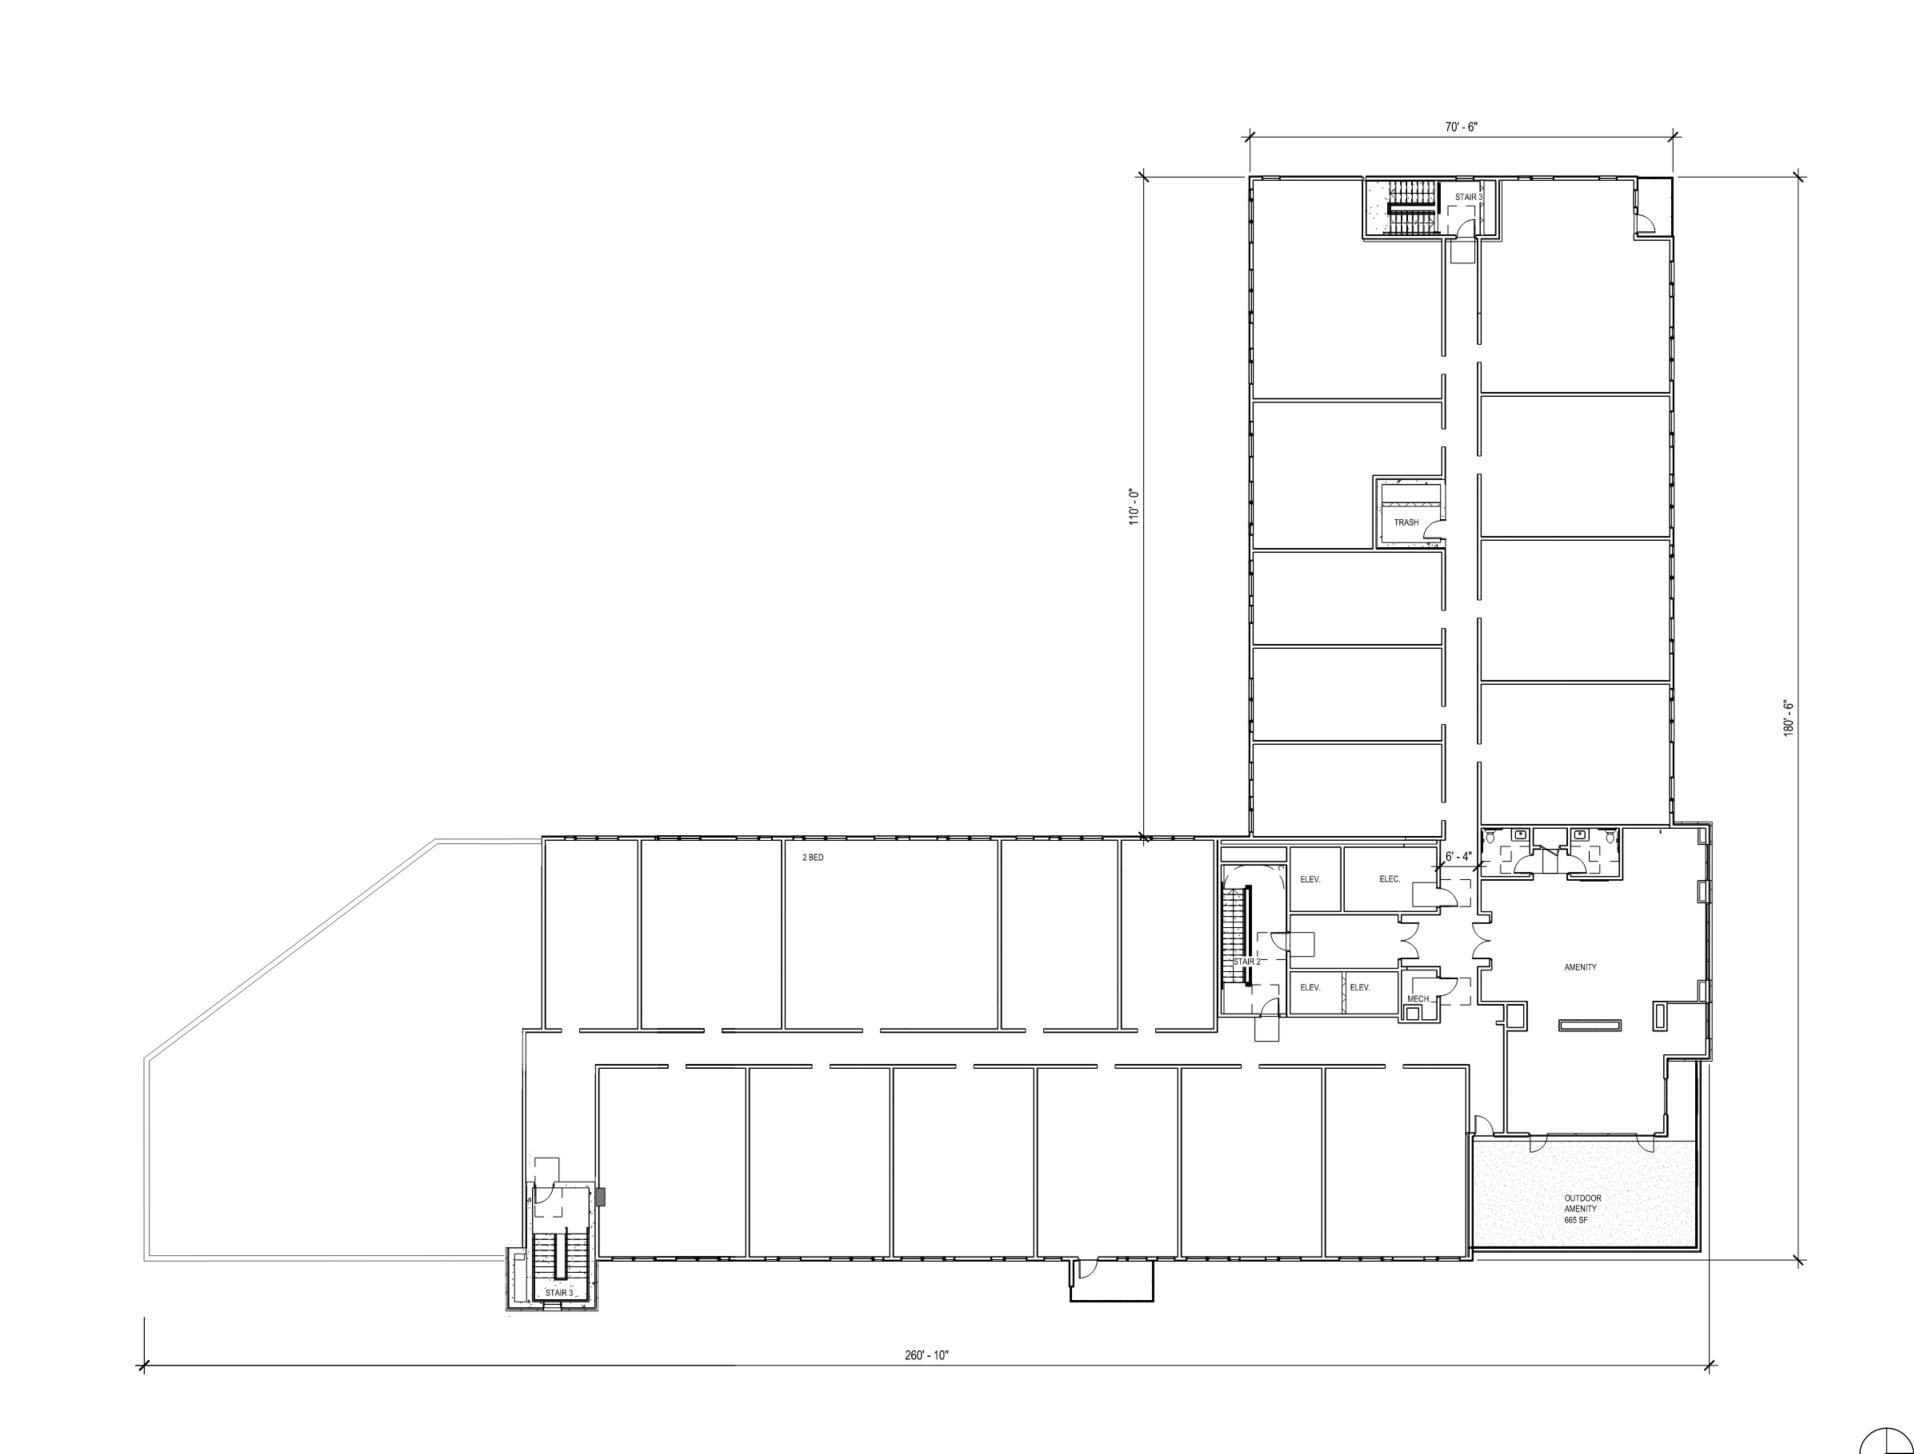

PROJECT: EQT-21220 ISSUE: Administrative Site Review 04.22.2022

REVISIONS: 1st Review Comments 07.06.2022

DRAWN BY: Author

CHECKED Checker

CONTENT: ROOF PLAN - OVERALL

OVERALL - ROOF PLAN
1/16" = 1'-0"

PROPSED LOCATION OF MECHANICAL EQUIPMENT





503.88 SF

503.88 SF X 20% = 100.78 SF

503.88 SF X 46% = 233.75 SF

233.75 SF X 50% = 116.88 SF

2917.56 SF X 15% = 437.64 SF

2917.56 SF X 37% = 1068.65 SF

637.17 SF X 15% = 95.58 SF

637.17 SF X 44% =278.90 SF

10 - 10TH FLOOR 94' - 2"

09 - 9TH FLOOR 84' - 2"

08 - 8TH FLOOR 74' - 2"

03 - 3RD FLOOR - PG/BLDG 21' - 6"

02 - 2ND FLOOR - PG/BLDG 11' - 6"

EAST - B&W

1/16" = 1'-0"

TRANSPARENCY (UDO SECTION 1.5.9, SECTION 3.2.6.F

B. DAWSON ST. - NON RESIDENTIAL GROUND LEVEL

GROUND STORY FACADE (MEASURED BETWEEN 0'-12')

RANSPARENCY PROVIDED BETWEEN 3' & 8' (MIN 50% OF REQ.)

5 ·0" 12'-0"

BASEMENT 1 NON RESIDENTIAL AREA
(FOR TRANSPARENCY)
INDICATED IN BLUE

BASEMENT - INDICATED

EXTENT OF FREE-STANDING RETAINING SHOWN IN YELLOW

EXTENT OF PLANTER WALL

IN BLUE

RESIDENT AL TERRACES WIRE DESSED FACADE RESIDENTIAL TERRACES WIRECESSED FACADE

FG 306.0 TPW 305.0

FG 302.0 FFE 301.7

NON RESIDENTIAL INDICATED IN BLUE (ALL OTHER AREAS ARE RESIDENTIAL USE (NOT APPLICABLE)

(FOR TRANSPARENCY) INDICATED IN BLUE

MIN. TRANSPARENCY REQUIRED

MIN. TRANSPARENCY REQUIRED

MIN. TRANSPARENCY REQUIRED

TRANSPARENCY PROVIDED

RANSPARENCY PROVIDED

UPPER STORY FACADE NON RESIDENTIAL

UPPER STORY FACADE NON RESIDENTIAL

TRANSPARENCY PROVIDED

EVER, NOR ARE THEY TO		SALIB SALIB
ED IN ANY FORM OR MANNER WHATSOE		
PLANS, THESE PLANS ARE NOT TO BE REPRODUCED, CHANGED OR COPIED IN ANY FORM OR MANNER WHATSOEVER, NOR ARE THEY T		
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SOERVES IIS COMMON LAW COPYRIGH AND OTHER PROPERTY RIGHTS IN THESE		
SOLVE		
- A	DRAWN B	/: Author
- MI	CHECKED B	+
3 -	CONTEN	+
SERVES		

ASR1

ASEMENT CALCULATIONS:			BASEMENT CALCULATIONS:	
ASEMENT 1			BASEMENT 1	
asement level façade (above and below grade)	1725	SF	Basement level façade (above and below grade)	1823
0% minimum required below grade:	863	SF	50% minimum required below grade:	912
roposed basement level façade below grade:	506	SF	Proposed basement level façade below grade:	1823
ercentage of façade below grade:	29.30%	Щ	Percentage of façade below grade:	100.00%
ASEMENT 2		-	WEST	
asement level façade (above and below grade)	721	SF	BASEMENT CALCULATIONS:	
0% minimum required below grade:	361	_		
			BASEMENT 1	
roposed basement level façade below grade:	329	SF	Basement level façade (above and below grade)	716
ercentage of façade below grade:	45.60%		50% minimum required below grade:	358
SOUTHWEST			Proposed basement level façade below grade:	716
ASEMENT CALCULATIONS:			Percentage of façade below grade:	100.00%
ASEMENT 1			SOUTH	
asement level façade (above and below grade)	4.550	CE	BASEMENT CALCULATIONS:	
asement level Taçade (above and below grade)	1550	2F		
	1550 775	—		
		—	BASEMENT 2	
0% minimum required below grade:		SF	BASEMENT 2 Basement level façade (above and below grade)	405
0% minimum required below grade: roposed basement level façade below grade:	775	SF		405
0% minimum required below grade: roposed basement level façade below grade: ercentage of façade below grade:	1322	SF	Basement level façade (above and below grade)	
0% minimum required below grade: roposed basement level façade below grade: ercentage of façade below grade: ASEMENT 2	1322	SF SF	Basement level façade (above and below grade) 50% minimum required below grade:	203
0% minimum required below grade: roposed basement level façade below grade: ercentage of façade below grade: ASEMENT 2 asement level façade (above and below grade)	775 1322 85.30%	SF SF SF	Basement level façade (above and below grade) 50% minimum required below grade: Proposed basement level façade below grade:	203 199
0% minimum required below grade: roposed basement level façade below grade: ercentage of façade below grade: ASEMENT 2 asement level façade (above and below grade)	775 1322 85.30%	SF SF SF	Basement level façade (above and below grade) 50% minimum required below grade: Proposed basement level façade below grade:	203 199
0% minimum required below grade: roposed basement level façade below grade: ercentage of façade below grade: ASEMENT 2 asement level façade (above and below grade) 0% minimum required below grade:	775 1322 85.30%	SF SF SF SF	Basement level façade (above and below grade) 50% minimum required below grade: Proposed basement level façade below grade: Percentage of façade below grade:	203 199 49.10%
20% minimum required below grade: roposed basement level façade below grade: ercentage of façade below grade: ASEMENT 2 asement level façade (above and below grade) 20% minimum required below grade: roposed basement level façade below grade:	1322 85.30% 655 328	SF SF SF SF	Basement level façade (above and below grade) 50% minimum required below grade: Proposed basement level façade below grade: Percentage of façade below grade: TOTAL BASEMENT FAÇADE AREA:	199 49.10%
o% minimum required below grade: roposed basement level façade below grade: ercentage of façade below grade: ASEMENT 2 asement level façade (above and below grade) o% minimum required below grade: roposed basement level façade below grade: ercentage of façade below grade:	1322 85.30% 655 328	SF SF SF SF	Basement level façade (above and below grade) 50% minimum required below grade: Proposed basement level façade below grade: Percentage of façade below grade: TOTAL BASEMENT FAÇADE AREA:	199 49.10%

Basement level façade (above and below grade)	1725	S
50% minimum required below grade:	863	-
. 5	1	t
Proposed basement level façade below grade:	506	5
Percentage of façade below grade:	29.30%	
BASEMENT 2		_
Basement level façade (above and below grade)	721	9
50% minimum required below grade:	361	5
Proposed basement level façade below grade:	329	9
	45.60%	-
Percentage of façade below grade:		L
	.	_
SOUTHWEST	•	_
SOUTHWEST BASEMENT CALCULATIONS:	•	_
SOUTHWEST BASEMENT CALCULATIONS: BASEMENT 1	1550	•
SOUTHWEST BASEMENT CALCULATIONS: BASEMENT 1 Basement level façade (above and below grade)	1550	-
SOUTHWEST BASEMENT CALCULATIONS: BASEMENT 1	1550 775	-
SOUTHWEST BASEMENT CALCULATIONS: BASEMENT 1 Basement level façade (above and below grade) 50% minimum required below grade:		Ş
SOUTHWEST BASEMENT CALCULATIONS: BASEMENT 1 Basement level façade (above and below grade)	775	,
SOUTHWEST BASEMENT CALCULATIONS: BASEMENT 1 Basement level façade (above and below grade) 50% minimum required below grade: Proposed basement level façade below grade:	775 1322	,
SOUTHWEST BASEMENT CALCULATIONS: BASEMENT 1 Basement level façade (above and below grade) 50% minimum required below grade: Proposed basement level façade below grade: Percentage of façade below grade:	775 1322	
SOUTHWEST BASEMENT CALCULATIONS: BASEMENT 1 Basement level façade (above and below grade) 50% minimum required below grade: Proposed basement level façade below grade: Percentage of façade below grade: BASEMENT 2	775 1322 85.30%	
SOUTHWEST BASEMENT CALCULATIONS: BASEMENT 1 Basement level façade (above and below grade) 50% minimum required below grade: Proposed basement level façade below grade: Percentage of façade below grade: BASEMENT 2 Basement level façade (above and below grade)	775 1322 85.30%	

5 \	ROOF BEARING 124' - 2"			
-0-	12 - 12TH FLOOR 114' - 2"	-	.g	
-n - n -	11 - 11TH FLOOR 104' - 2"	-	-0" 3'-6"	
50-01		-	10,	
-n- -D-	09 - 9TH FLOOR 84' - 2"	-	10, - 0,	
.n .n .n .n .n .n .n .n .n .n .n .n .n		_	10 0.1	
100.		_	96'-2"	
-00L	07 - 7TH FLOOR 64' - 2" 06 - 6TH FLOOR 54' - 2"	ASEMENT	10, - 0,,	
.DD.	05 - 5TH FLOOR	œ	10, - 0,,	
100.	05 - 5TH FLOOR 44' - 2" 04 - 4TH FLOOR 34' - 2"	STORIES ABOVE	10, - 0,,	
-8-71	34' - 2"	12 STC	12' - 8"	
	03 <u>- 3</u> RD FLOOR - PG/BLDG 21' - 6"	-	++	
	02 - <u>2ND FLO</u> OR <u>- PG/BLDG</u> 11' - 6"	-	<u> </u>	
	01 - 1ST FLOOR - PG/BLDG 0"	_	<u> </u>	
TRANS	ENTIAL AREA SPARENCY) IN BLUE	_	5'	- RESIDEN IAI EN RACES - WIRECESSEI FACADE
			4' 1 1 1 1 1 1 1 1 1 1 1 1 1 1 1 1 1 1 1	BASEMENT 2

		74' - 2"
		07 - 7TH FLOOR 64' - 2"
		06 - 6TH FLOOR 54' - 2"
		05 - 5TH FLOOR 44' - 2"
		04 - 4TH FLOOR 34' - 2"
		03 - 3RD FLOOR - PG/BLDG 21' - 6"
		02 - 2ND FLOOR - PG/BLDG 11' - 6"
510"	12'-0" 12'-0" 12'-0"	<u>.</u> .
	RASEMENT 1	NON RESIDENTIAL AREA (FOR TRANSPARENCY) INDICATED IN BLUE
		THE STATE OF THE SECOND ST

TRANSPARENCY (UDO SECTION 1.5.9, SECTION 3.2.6.F

CABARRUS ST. - NON RESIDENTIAL GROUND LEVEL

FRANSPARENCY PROVIDED BETWEEN 3' & 8' (MIN 50% OF REQ.)

INDICATED IN BLUE

NON RESIDENTIAL INDICATED IN BLUE (ALL OTHER AREAS ARE RESIDENTIAL USE (NOT APPLICABLE

2250.65 SF X 20% =450.13 SF

2250.65 SF X 48% = 1072.84 SF

1072.84 SF X 52% = 566.59 SF

1903.41 SF X 15% = 285.51 SF

1903.41 SF X 34% = 646.64 SF

849.75 SF X 15% = 127.46 SF

849.75 SF X 38% = 327.08 SF

1903.41 SF

849.75 SF

GROUND STORY FACADE (MEASURED BETWEEN 0'-12')

MIN. TRANSPARENCY REQUIRED

UPPER STORY FACADE NON RESIDENTIAL

UPPER STORY FACADE NON RESIDENTIAL

TRANSPARENCY PROVIDED

MIN. TRANSPARENCY REQUIRED

TRANSPARENCY PROVIDED


MIN. TRANSPARENCY REQUIRED

TRANSPARENCY PROVIDED

BASEMENT - INDICATED IN BLUE

NORTH - B&W 2 1/16" = 1'-0"

FG 288.4 FG 292.8 FG 297.2 TPW 296.2 TRW 292.2

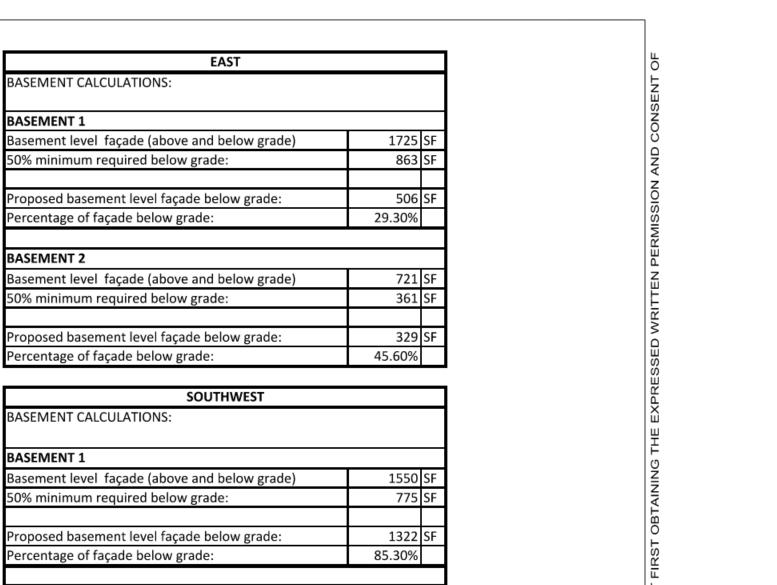

basement level raçade (above and below grade)	1330	эг
50% minimum required below grade:	775	SF
Proposed basement level façade below grade:	1322	SF
Percentage of façade below grade:	85.30%	
BASEMENT 2		
	655	SF
Basement level façade (above and below grade)		-
50% minimum required below grade:	328	SF
Proposed basement level façade below grade:	539	SF
Percentage of façade below grade:	82.30%	
NORTH		
BASEMENT CALCULATIONS:		
BASEMENT 1		_
Basement level façade (above and below grade)	1823	SF
50% minimum required below grade:	912	SF
Proposed basement level fasado below grade:	1823	SF
Proposed basement level façade below grade:	1823	31

_____<u>10 - 10</u>TH FLOOR 94' - 2"

_____03 <u>- 3RD FLOOR</u> - <u>PG/BLDG</u> 21' - 6"

____02 - 2ND FLOOR - PG/BLDG

____01 - 1ST FLOOR - PG/BLDG

SOUTHWEST ELEVATION B&W 3

FFE 301.7 FG 297.2 TPW 296.2

-01 - PARKING 1 - PG/BLDG

_-02 - _ PARKING 2 - PG/BLDG

09 - 9TH FLOOR 84' - 2"

roposed basement level laçade below grade.	1023
Percentage of façade below grade:	100.00%
WEST	
BASEMENT CALCULATIONS:	
DACEMENT 4	
BASEMENT 1	
Basement level façade (above and below grade)	716
50% minimum required below grade:	358
Proposed basement level façade below grade:	716
Percentage of façade below grade:	100.00%
COLITI	

SOUTH	
BASEMENT CALCULATIONS:	
BASEMENT 2	
Basement level façade (above and below grade)	405
50% minimum required below grade:	203
Proposed basement level façade below grade:	199
Percentage of façade below grade:	49.10%

Basement level façade (above and below grade)	405	SF
50% minimum required below grade:	203	SF
Proposed basement level façade below grade:	199	SF
Percentage of façade below grade:	49.10%	
TOTAL BASEMENT FAÇADE AREA:	7,595	SF
		SF
50% minimum required below grade:		
Proposed basement level façade below grade:	5,434	SF

		RODUCE
ROOF BEARING AND ADDRESS AND A		ROOF BEARING BEARING
5 6 9 12-12TH FLOOR		124 - 2 O P P P P P P P P P P P P P P P P P P
11 - 11TH FLOOR		114' - 2" WAY ON THE FLOOR OF T
		10.4'-2" JOHN FLOOR
		10 - 101 n r LOOK 94' - 2"
		- 09 - 9TH FLOOR 84' - 2"
		- 08 - 8TH FLOOR 74' - 2"
SVER DE SO		07 - 7TH FLOOR 64' - 2"
SUBJECTION OF STATE O		06 - 6TH FLOOR 54' - 2"
THE SECOND SECON		05 - 5TH FLOOR 44' - 2"
		1
FO P O P O P O P O P O P O P O P O P O P		03 - 3RD FLOOR - PG/BLDG
21 10 0 0 0 0 0 0 0 0 0 0 0 0 0 0 0 0 0		02 - 2ND FLOOR - PG/BLDG
		11'-6" WW COWN
BASEMENT 1 BASEMENT 1 BASEMENT 1	BASEMENT 1	O1 - PARKING 1 - PG/BLDG O"
BASEMENT 2 BASEMENT 2 -01 - PARKING - PG/BLDG 5' 4' - PG/BLDG	BASEMENT - INDICATED	5' 4' -02 - PARKING 2- PG/BLDG
FFE 301.7 FFE 292.8 FG 297.2	IN BLUE EXTENT OF FREE-STANDING RETAINING WALL SHOWN IN YELLOW	
TPW 296.2 \FG 293.2 \TRW 292.2	EXTENT OF PLANTER WALL	FFE 292.8 TRW 292.2
		ARCHIT

SOUTH - B&W 2

BASEMENT 1

BASEMENT 1

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PROJECT: 21220 ISSUE:

DRAWN BY: Author CHECKED Checker

CONTENT: OVERALL ELEVATIONS

WEST - B&W