

Administrative Approval Action

Case File / Name: ASR-0039-2023 DSLC - Lot 11 Budleigh East City of Raleigh
Development Services Department
One Exchange Plaza
Raleigh, NC 27602
(919) 996-2492
currentplanning@raleighnc.gov
www.raleighnc.gov

LOCATION: The site is located at 2500 Oberlin Rd specifically PIN 1704292734, on the

northeast corner of Oberlin Road and Fairview Road. The site is split zoned having both NX-3-UL and R-10 zoning. The site is also identified as Lot 11 in the Budleigh

east Subdivision, case SUB-0062-2022.

REQUEST: The request is to construct a three -story mixed use development consisting of 12

residential units with mixed use on the ground floor in a 26,300 square foot

building. The project has also incorporated underground parking.

DESIGN

ADJUSTMENT(S)/

ALTERNATES, ETC: N/A

FINDINGS: City Administration finds that this request, with the below conditions of

approval being met, conforms to the Unified Development Ordinance. This approval is based on a preliminary plan dated June 4, 2024 by Scott Dixon.

CONDITIONS OF APPROVAL and NEXT STEPS:

This document must be applied to the second sheet of all future submittals except for final plats. This is a preliminary plan and as such no permits have been issued with this approval. To obtain permits and/or completion of the project, the following steps are required:

☑ <u>SITE PERMITTING REVIEW</u> - For land disturbance of 12,000 square feet or greater, public or private infrastructure, shared stormwater devices, etc. Site Permitting Review may be submitted upon receipt of this signed approval document.

The following items are required prior to approval of Site Permitting Review plans:

General

- 1. Further review of the proposed streetscape plan following up on prior commenting of standing sidewalk connection practices.
- 2. Prior to Site Permit Review approval the site data table and application form shall reflect the maximum height limit of 3 stories.

Stormwater

3. A surety equal to of the cost of clearing, grubbing and reseeding a site, shall be paid to the City (UDO 9.4.4).

Urban Forestry

4. A tree impact permit must be obtained for the installation of tree protection fence around existing street trees to remain along Oberlin Road. Tree protection fence must be inspected by Urban Forestry staff prior to the issuance of a grading permit.

☑ <u>BUILDING PERMITS</u> - For buildings and structures shown on the approved plans. Commercial building permit plans must include the signed, approved Site Permitting Review plans attached, if applicable. Permit sets may be reviewed prior to the recordation of required plats, but cannot be approved.



Administrative Approval Action

Case File / Name: ASR-0039-2023 **DSLC - Lot 11 Budleigh East**

City of Raleigh **Development Services Department** One Exchange Plaza Raleigh, NC 27602 (919) 996-2492 currentplanning@raleighnc.gov www.raleighnc.gov

The following items must be approved prior to the issuance of building permits:

Urban Forestry

1. A tree impact permit must be obtained for the approved streetscape tree installations in the right-of-way. This development proposes 4 street trees along Fairview Road.

The following are required prior to issuance of building occupancy permit:

General

- 1. Final inspection of all right-of-way street trees by Urban Forestry Staff.
- All street lights and street signs required as part of the development approval are installed.
- 3. Required public right-of-way infrastructure improvements shall be, at a minimum, sufficiently completed to provide the necessary, safe emergency and vehicular access.

Stormwater

As-built impervious survey is accepted by the Engineering Services Department (UDO 9.2).

EXPIRATION DATES: The expiration provisions of UDO Section 10.2.8 E, including the ability to request extensions in the expiration date, apply to this site plan. If significant construction has not taken place on a project after administrative site review approval, that approval may expire and be declared void, requiring re-approval before permits may be issued. To avoid allowing this plan approval to expire the following must take place by the following dates:

3-Year Expiration Date: September 3, 2027

Obtain a valid building permit for the total area of the project, or a phase of the project.

4-Year Completion Date:

Within four years after issuance of the first building permit for the site plan, the construction of the entire site plan must be completed unless an applicant has been granted vested rights. Failure to complete construction within this specified time frame shall automatically void the approved site plan for which no building permits have been issued.

I hereby cer	tify this administrative decision.		
Signed:	Keegan McDonald	Date:	09/03/2024
oigilea	David Comic Distriction	Date	03/03/2024
	Development Services Dir/Designee		
Staff Coord	linator: Jeff Caines	Corre	ected 12/2/24



VICINITY MAP

DENSITY CALCULATION - LOT 11 FREQUENT TRANSIT OPTION

TOTAL ACREAGE: 24 064 S E /0 4926 AC

R-10 PORTION: 11,717 S.F. (0.269 AC.) BUILDING TYPE IN R-10 PORTION IS ALL APARTMENT (CONDO) THERE IS NO MIXED USE WITHIN THE R-10 ARE MAXIMUM DENSITY ON R-10: 14.65 UNITS (1DU / 80 5F) PROPOSED DENSITY ON R-10: 10 UNITS (1DU / 1,171 SF)

NX-3 UL PORTION: 9,347 S.F. (0,215 AC.) BUILDING TYPE MIXED USE WHICH INCLUDES OFFICE/RETAIL AND 2 APARTMENT UNITS (CONDO) PROPOSED RETAILLOFREE: 9,120 SF MAJAMUM RESIDENTIAL DENSITY ON NX-3 UL: NIA PROPOSED RESIDENTIAL DENSITY ON NX-3 UL: 2 UNITS (10U / 4,673 SF)

TOTAL PROPOSED RESIDENTIAL UNITS FOR LOT 11: 12 UNITS NO AFFORDABLE UNITS REQUIRED

VEHICLE PARKING SUMMARY

Beacon Street

INDEX

CF-0

CE-1

CE-2

CE-3

CF-4

CE-5

CE-6

CE-7

A104

A105

A201

A202

L-1 L-2 Raleigh, NC 27608 Attn: Justin Hime

We have reviewed the plans and have found that GFL Envir commercial waste and recycling services for this property.

COVER SHEET

SITE PLAN

UTILITY PLAN

ROOF DECK

OVERALL SUBDIVISION PLAN

SITE PLAN - PARKING LEVEL

TRANSPARENCY CALCULATIONS

FIRE DEPARTMENT PLAN

LANDSCAPE PLAN

LANDSCAPE DETAILS

EXTERIOR ELEVATIONS

EXTERIOR ELEVATIONS

EXISTING CONDITIONS

vice and the trash enclosure will be large enough to accommodate the volume of trash

PROPOSED 8 2-BR UNITS 2,25 SP PER UNIT MAX = 18 SPACES

PROPOSED 4 3-BR UNITS 3 SP PER UNIT MAX = 12 SPACES

PROPOSED RETAIL/OFFICE MAX (1/200SF) = 46 SPACES MAXIMUM ALLOWED PARKING = 76 SPACES

BICYCLE PARKING SUMMARY

SHORT-TERM (MIN) 1 PER 20 UNITS MIN 4 = 4 SPACES (12 UNITS) LONG-TERM (MIN) 1 PER 7 BR = 4 SPACES (28 BEDROOMS) SHORT-TERM RETAIL 1 PER 5,000SF (MIN 4) = 4 SPACES LONG TERM RETAIL NA

LONG-TERM RETAIL: MA SHORT-TERM OFFICE 1 PER 10,000SF (MIN 4) = 4 SPACES LONG-TERM OFFICE 1 PER 5,000SF (MIN 4) = 4 SPACES TOTAL BICYCLE PARKING PROVIDED (ALL IN GARAGE) SHORT-TERM-12 SPACES

ONG-TERM - 8 SPACES

AMENITY AREA CALCULAT	TION - LOT 11	
GROSS AREA	21.064 S.F. (0.4836 AC.)	
NET AREA		
REQUIRED AREA (10%)	2,106 S.F. (0.0483 AC.)	
REQUIRED ADA ACCESSIBLE (50% OF REQ'D).	1.053 S.F. (0.0242 AC.)	
PROVIDED AREA (10.6%)	2.246 S.F. (0.0516 AC.)	
DROVIDED ADA ACCESSIBI E AREA	1.116 S.F. (0.0256 AC.)	

SOLID WASTE SERVICES

DEVELOPERS HAVE REVIEWED AND ARE IN COMPLIANCE WITH THE REQUIREMENTS SET FORTH IN THE SOLID WASTE DESIGN MANUAL.

PRIVATE SERVICE TO BE PROVIDED.

BUILD-TO SUMMARY

NA3 UL FRONTAGE REQUIRED 89% BUILD-TO ON PRIMARY STREET UL LOT FRONTAGE ON OBERIN = 103.9; REQUIRED BUILD 10 (50%) = 13.9; VI UL LOT FRONTAGE ON FARINEW = 74.2; REQUIRED BUILD 10 (60%) = 37.1; PROVINCED BUILD 10 (60%)=51.8; SEE BUAGNAM SHEET CE-3.

PRIMARY STREET DESIGNATIONS

PER TC-5A-18 & SEC 1.5.4.C. THE PRIMARY STREETS SHALL BE

OBERLIN ROAD & FAIRVIEW ROAD

LOT 11 BUDLEIGH EAST

ADMINISTRATIVE SITE REVIEW - TIER 3
MIXED USE & APARTMENT BUILDINGS
FREQUENT TRANSIT DEVELPMENT OPTION

ASR-0039-2023

SUB-0062-2022(REV) RALEIGH, NORTH CAROLINA

JUNE 2024

OWNER/DEVELOPER:

BEACON STREET BUDLEIGH LLC

PO Box 6474 Raleigh, N.C. 27628 919-785-1445 sdixon@beacon-street.com

CIVIL ENGINEER:

RECORDED SUBDIVISION PLAT (SUB-0062-2022)

GRADING / STORMWATER MANAGEMENT PLAN

JAECO JOHN A. EDWARDS & COMPANY

Consulting Engineers NC License F-0289 333 Wade Ave., Raleigh, NC 27605 Phone: (919) 828-4428 Fax: (919) 828-4711

E-mail: info@jaeco.com



SITE DATA

OWNER: BEACON STREET BUDLEIGH LLC
PO BOX 6474
RALEIGH, NC 27628-6474

ADDRESS: 2550 OBERLIN RD
RALEIGH, NC 27608

PIN# (PARENT PARCEL) 1704-29-3852

AREA: PROPOSED LOT 11 (SUB-0062-2022)
21,064 S.F. (0.4836 AC.)

ZONING: R-10 (PROPOSED APARTMENTS) NX-3-UL (PROPOSED MIXED USE)

CURRENT USE: VACANT

REFERENCES: DR 18959 PG 2149

BM 2022, PG 386 WAKE COUNTY REGISTRY ALL CONSTRUCTION SHALL BE IN ACCORDANCE WITH CITY OF RALEIGH AND / OR NCDOT STANDARDS AND SPECIFICATIONS.

HORIZONTAL DATUM: No VERTICAL DATUM: No

Administrative Site Review Application



This form is required when submitting site plans as referenced in Unified Development Ordinance (UDO) Section

ce Use Only: Case #: ____

Please review UDO Section 10.2.8, to determine the site plan tier. If assistance determining a Site Plan Tier is need a Site Plan Tier Verification request can be submitted online via the Permit and Development Portal. (Note: There is

Site Plan Her: Tier Two Site Plan	Her Inree Site Han			
Building and Development Typ (Check all that apply)				
Detached General Attached Mixed use Townhouse Civic Apartment Cottage Cou Tiny house Frequent Tra Open lot	Zoning Case #: ansit Design Alternate #:			
	GENERAL INFORMATION			
Development name: LOT 11 BUDLEIGH	EAST			
Inside City limits? Yes 🗸 No 🗌				
Property address(es): 2550 OBERLIN RO	IAD .			
Site P.I.N.(s): 1704-29-3852				
	my additions, expansions, and uses (UDO 6.1.4). Apartment (condo) in the R-10 portion of site.			
Current Property Owner(s): Beacon Stree	et Budleigh LLC			
Company:	Title:			
Address: PO Box 6474, Raleigh, NC 276	ò28			
Phone # 919-785-1445 Email: sdixon@beacon-street.com				
Applicant Name (If different from owner, 5	see "who can apply" in instructions):			
Relationship to owner: Lessee or contract	purchaser Owner's authorized agent Easement holder			
Company:	Address:			
Page 1 of 3	REVISION 1,23,23			


Phone ff:	Email:	Email:				
NOTE: please attach purchase ag	reement or contr	act, lease or easement when submitting this form				
Developer Contact: Scott Dixon						
Company: Beacon Street Budleigh LLC Title: Vice President						
Address: PO Box 6474, Raleigh	NC 27628	<u> </u>				
Phone #: 919-785-1445	5 Email: sdixon@beacon-street.com					
Applicant Name: Beacon Street E	ludleigh LLC					
Company:	Address: PO Box 6474, Raleigh NC 27628					
Phone #: 919-785-1445	Email: sdixon@beacon-street.com					

DEVELOPMENT TYPE + SITE DATE TABLE (Applicable to all developments)					
BUILDING DATA					
Existing gross floor area (not to be demolished): n/a					
Existing gross floor area to be demolished: n/a					
New gross floor area: 26,300 sf					
Total of gross (to remain and new): 26,300 of					
Proposed # of buildings: 1					
Proposed # of stories for each: 4 + roof top areas (udo 1					
Proposed # of basement levels (UDO 1.5.7.A.6) ()					

STORMWATER	RINFORMATION		
Imperious Area on Parcel(s): Existing (sf) 2232 Proposed total (sf) 17500	Impervious Area for Compliance (includes ROW): Existing (sf) 2232 Proposed total (sf) 17500		
RESIDENTIAL & OVERNIGHT	LODGING DEVELOPMENTS		
Total # of dwelling units: 12	Total # of hotel bedrooms:		
# of bedroom units: 1br 2br 8 3br 4	4br or more		
# of lots: 1	Is your project a cottage court? Yes No		
	A frequent transit development? Yes No		





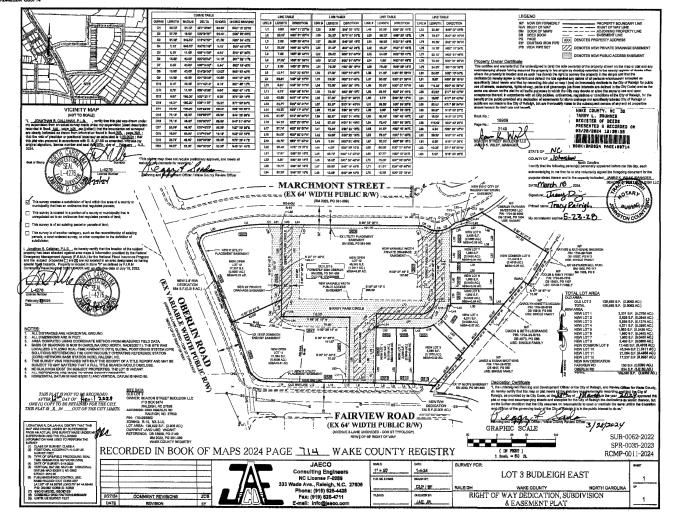



Consulting Engineers and Land Surveyors

NC License F-0289 Wade Ave., Raleigh, N.C. 276 Phone: (919) 828-4428 Fax: (919) 828-4711 E-mail: info@laeco.com

www.jaeco.com



LOT 11 BUDLEIGH EAST

> BEACON STREET BUDLEIGH LLC

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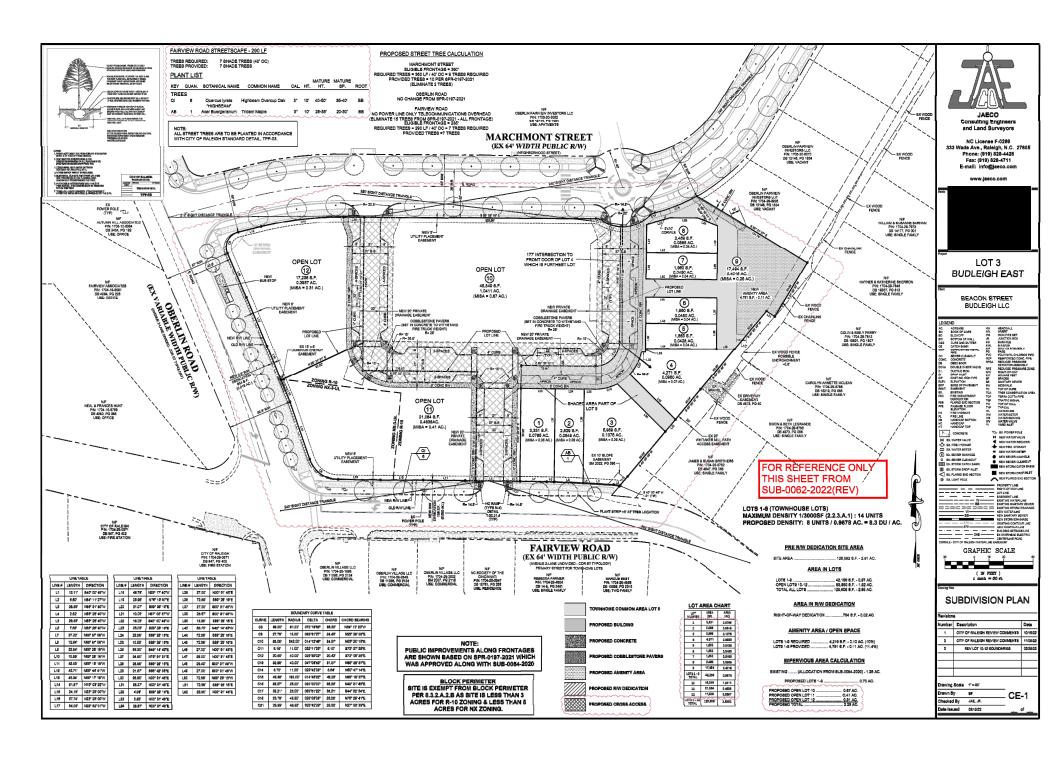
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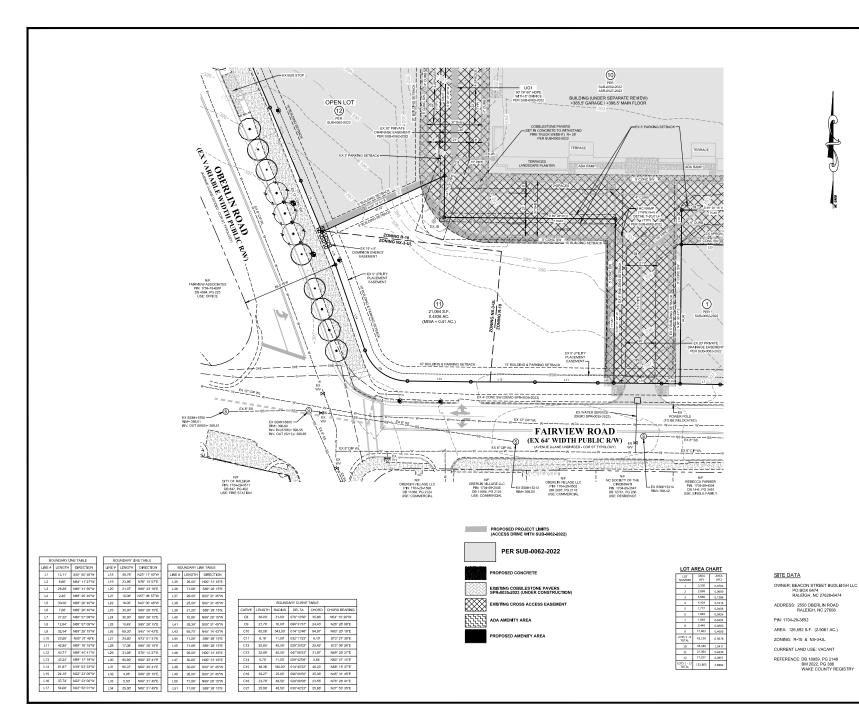
RECORDED
SUBDIVISION PLAT
SUB-0062-2022

Number	Description	Dat

Drawing Scale AS SHOWN
Drawn By BF
Checked By JAE, JR.

Date Issued XXXX/22







JAECO Consulting Engineers and Land Surveyors

NC License F-0289 Wade Ave., Raleigh, N.C. 276 Phone: (919) 828-4428 Fax: (919) 828-4711 F-mail: info@iaeco.com

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LOT 11 BUDLEIGH EAST

> BEACON STREET BUDLEIGH LLC

VC.	ACREAGE	HW	HEADWALL			
M.	BOOK OF MAPS	IW.	INVERT			
10	BLOWOFF	PS	INON PIPE SET			
DW.	BOTTOM OF WALL	16	JUNCTION BOX			
24.0	CURB AND GUTTER	101	MANHOLE			
8	CATCH BASIN	MIN	NOW OR FORMERLY			
MP	CORRUGATED METAL	PG PG	PAGE			
	PIPE	PVC	POLYVIWA CHLORIDE PI			
00	SEWER CLEANOUT	RCP	RENFORCED CONC. PIPE			
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GRAPHIC SCALE

(IN FEET)
1 inch = 20 ft.

EXISTING CONDITIONS PLAN

Number	Description	Date
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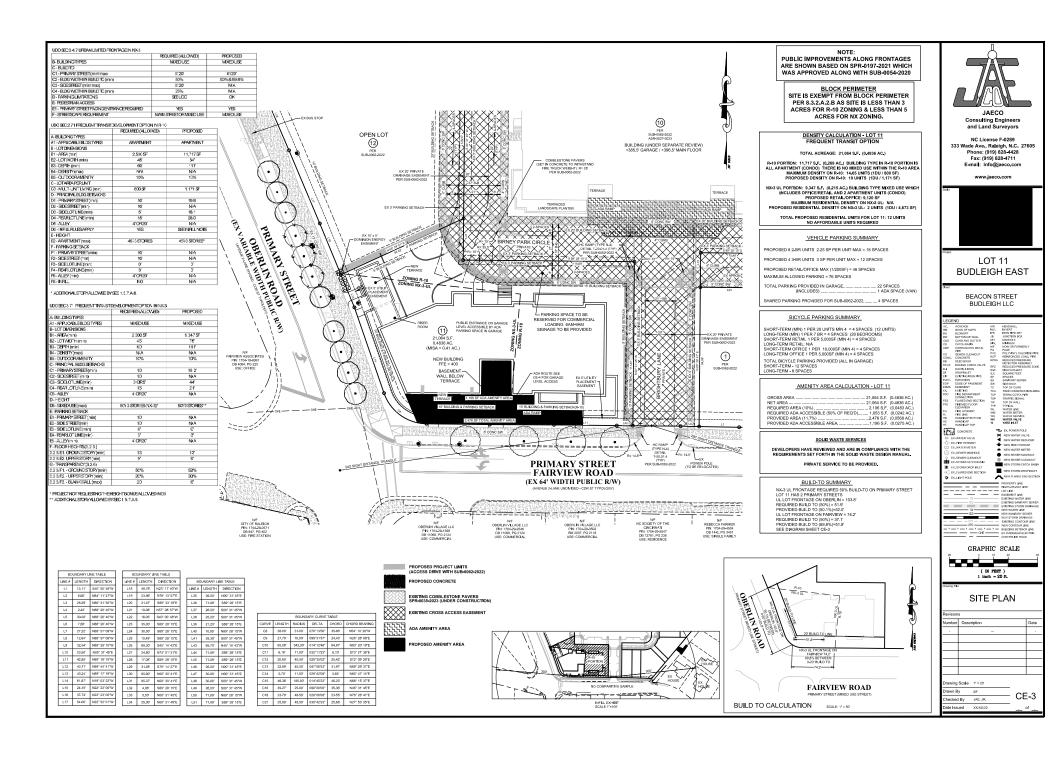
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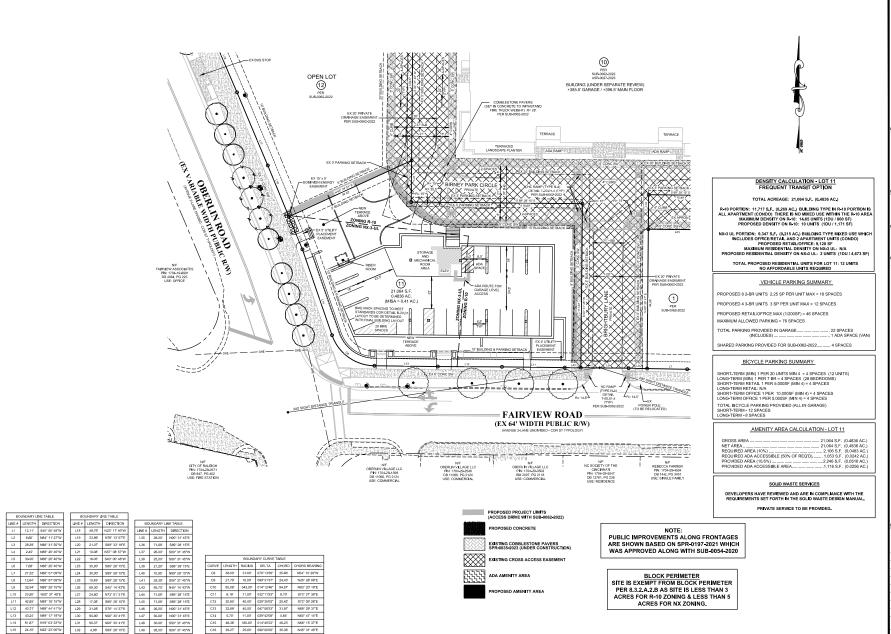
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Checked By JAE, JR.

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CE-2







Consulting Engineers

NC License F-0289 Vade Ave., Raleigh, N.C. 27605 Phone: (919) 828-4428 Fax: (919) 828-4711

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LOT 11 **BUDLEIGH EAST**

BEACON STREET


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EW.	BOTTOM OF WALL	JB.	JUNCTION BOX
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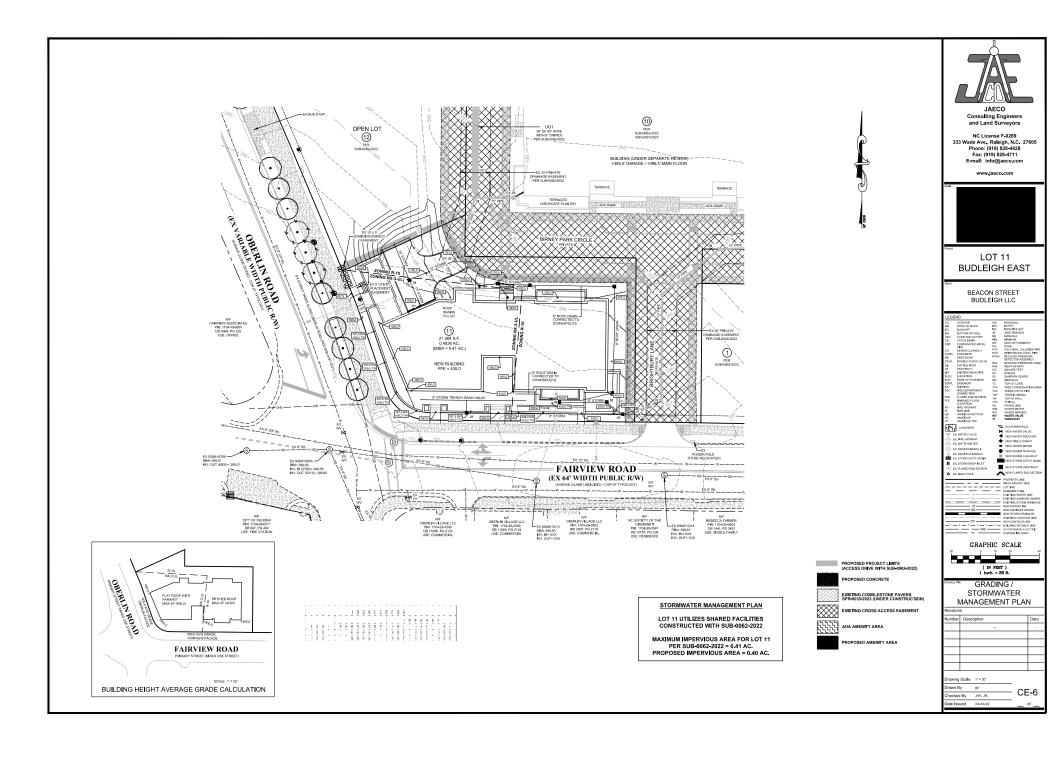
GRAPHIC SCALE


SITE PLAN PARKING LEVEL


Revision	5			
Number	Desc	ription		Date
Drawing	Scale	1" = 20"		
Drawn By		BF		

hecked By JAE, JR.



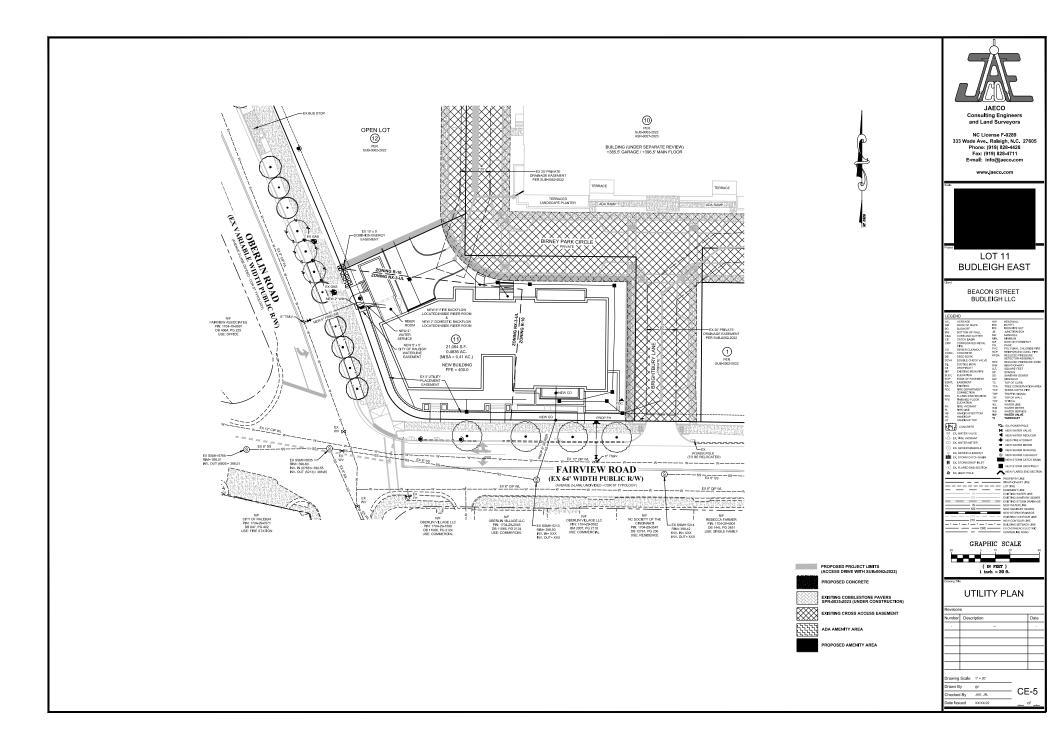

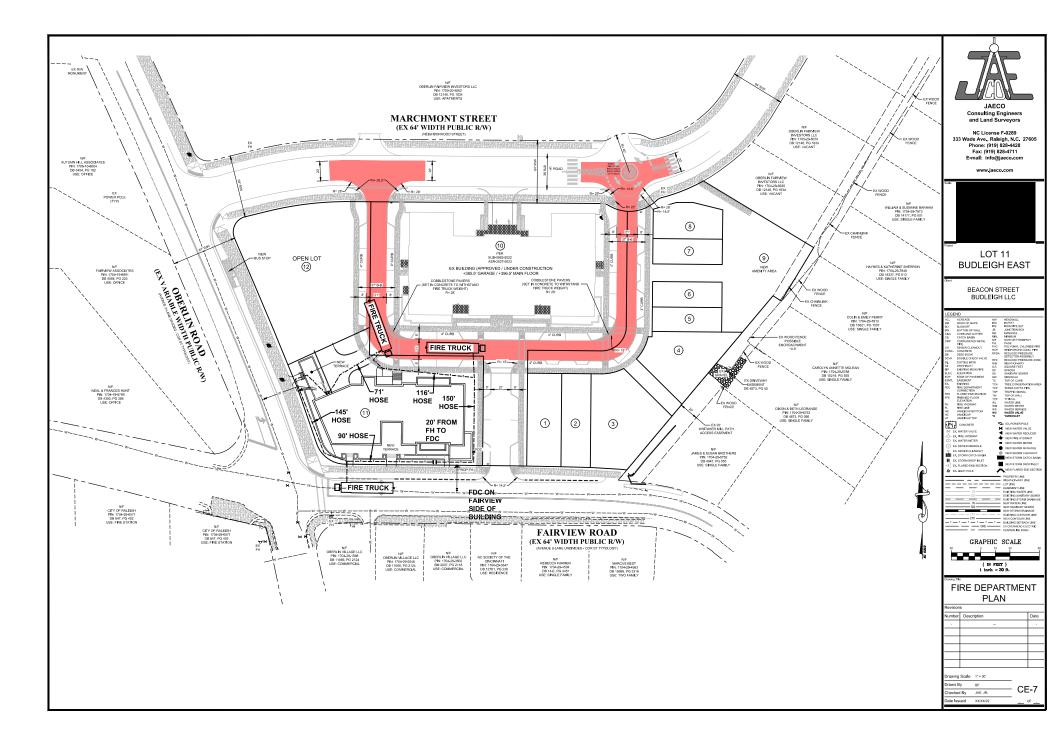

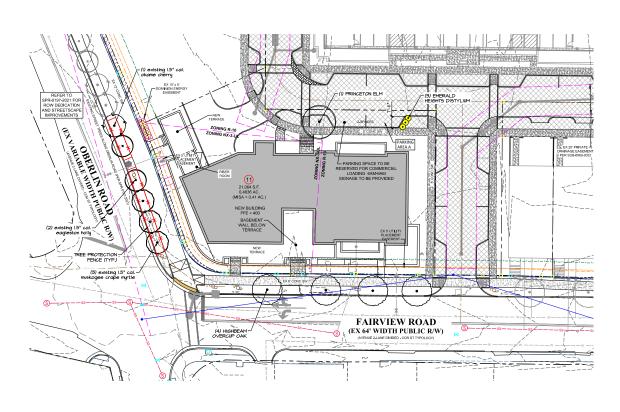

QUAN	LOT 11 PLANT SCHEDULE		INSTALATION MATURE SIZE					
ᇹ	BOTANICAL NAME	COMMON NAME	SIZE		NOTES			
	TREES AND LARGE EVERGREENS							
$\overline{}$								
					PULL, MATCHING, STREET TREES (APPROVED ON SPR-0005-0005 & SUB-0005-0005)			
\Box	LICHAUS AMERICANA PROMOBITORY	PRUNCETON BLM	3º CAL, 10º TALL, MIN. (SS)	BOT TALL & BO WIDE	VEHICULAR PARIGING LOT TIME			
SHRUBS								
- 3	DISTYLIUM TENERALD HEKSHTSY	EMERALD HEIGHTS DISTYLIUM	2/ TALL, MINL	S' TALL & S' WIDE	PULL, MATCHING, VEHICULAR PARKING LOT SHRUBS			
$\overline{}$								

VEHICULAR PARKING LOT A PLANTING


TREES
(1) SHADE TREE/10 SPACES
4 SPACES/10 = 0.4 TREES REQUIRED
1 SHADE TREE PROVIDED

SHRUBS (30) SHRUB/100 LF INSTALLED SIZE: 24" TALL 8 LF 8/100 = .08 x 30 = 2.4 SHRUBS REQUIRED 3 SHRUBS PROVIDED

NOTE:

I. STREET TREES SHALL BE INSTALLED AND MAINTAINED IN ACCORDANCE WITH THE REQUIREMENTS OF CHAPTER 2 OF THE CITY TREE MANUAL

NOTE:
SEE BUDLEIGH EAST SUBDIVISION PLANS
(SUB-0054-2020) FOR ALL STREETSCAPE
IMPROVEMENTS, STREET TREE PLANTINGS AND
DETAILS.

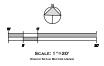



JOHN A. EDWARDS & CO 333 Wade Ave. - RALEIGH, NC (919) 828-4428



BUDLEIGH EAST BEACON STREET LOT BEACON STREET LOT 2550 OBERLIN ROAD - RALEIGH, NC

REVIEW 1/17/2024

PLANTING PLAN

DRAWN BY: AS/RW/WAB CHECKED BY:

L-1

OF 2



PLANTING NOTES


- 2. Contractor shall maintain or provide positive drainage away from all building foundations, structures and within planting beds.
- Contractor shall supply all plant materials in quantities sufficient to complete all plantings shown on this drawing. Clarify any discrepancies with the Landscape Architect prior to ordering plant material.
- All plants shall meet or exceed the minimum standards set by the U.S.D.A. for Nursery Stock, sponsored by the American Association of Nurserymen, Inc., Washington, D.C.
- All plants shall bear the same relationship to finished grade as to the original grades before digging. The Contractor shall revise grades at a minimum of +/-1/2% to ensure smooth transitions between planting beds and lawn ereas.
- 6. Mulch Install 3" of shredded pine bark mulch in plant beds around buildings, patio, etc., and 3" of clean pine straw in all other naturareas with new planting and on slopes, unless otherwise noted on plans.
- 7. All plant materials are subject to the approval of the Landscape Architect at the nursery and at the job site.
- Contractor is encouraged to provide the Landscape Architect with concerns and/or suggestions regarding proposed plant materials, prior to placing a purchase order for plants.
- 9. Contractor is responsible for verifying all quantities. Drawings symbols shall rule over plant lists if there are discrepancies between the two.
- 10. All trees located adjacent to walks and drives shall have 6' of clearance height to first branching.
- 11. All trees shall be placed a minimum of 3' from sidewalks, curbs and hardscape, and a minimum of 6' from fire hydrants and other utilities, unless otherwise noted on plans.
- 12. All plants shall be installed as per generally accepted planting standards.
- 13. All dead and or diseased plants shall be replaced within warranty period at no charge to Owner/Client
- 14. All plants and stakes shall be set plumb unless otherwise specified.
- 15. Refer to Existing Conditions Plan, Demo Plan and/or Planting Plan for trees/shrubs to be either removed or to ren
- 16. Landscape Architect shall select and layout all the perennial beds.
- All planting bed edges to be smooth flowing arcs, unless otherwise specified. Bed edges shall be smooth, com
 to 4 inches deep, and "V" shaped. All excavated material shall be removed from the bed edge and planting bed.
- 18. If the landscape contractor observes any deficiencies in the site conditions or which could negatively affect plant establishment, survival, or guarantee, notify the Owner and Landscape Architect prior to procurement and/or installation.
- 19. Any disturbed areas that are not planted or grassed as part of the landscape plan shall be restored to their previous existing condition (including raking uneven areas, seeding grassed areas and for natural areas spreading minimum 3" depth of pine straw, leaf litter or pine bark much per direction of Landscape Architect).


LANDSCAPE MAINTENANCE AGREEMENT

- The Owners of the Property and their Agents, Heirs or Assigns shall be responsible for the installation, preservation and maintenance of all plantings and physical features shown on this plan. The Owners shall be responsible for annual maintenance of the vegetation to include but not limited to":
- a. Fartilization: Zeon Zoyala kwrs: Fartilize lawns twice per year (March 30 May 15), and again (June 30 July 31) according to sol test. Tithway 419
 Bermuds transs fertilize trans twice per year (March 30 May 15), and again (June 15 August 15) according to soil test.
- b. Fertilization: Deciduous trees, evergreen trees and evergreen shrubs: Fertilize trees and shrubs per soil test. A deep root fertilizer shall be used for deciduous trees, evergreen trees and evergreen shrubs and applied once per year (Feb. 28 March 30). Fertilizer shall be used red in the contract of the person of the p
- 1. C. Feditazion: Broke, granutorior and seasonal plants on tited in a (2) Fedita entate, grundrose and seasonal plants per sell lest, A complete contrated in New Fedita and Bits used for himse, granutoriors are desecrable plant seed people (Feb. 20: Meditor) (3), and again in Line 1-July 31). Feditior and be spread evenly under all plants (where applicable) and vestered in. "("Esting seaso with trees, shrobs, grundroser and seasonal plants may receive fertilization 2-July 43).
- Pruning: Removal of dead or diseased wood, or removal of free branches for sight distance/bafety reasons; the Shigo standards should be adhered to.The pruning of shrubs shall be limited to the pruning necessary to maintain the natural shape of the plant except for shaared hedges and shapered invited.
- Pest control: Pre-emergent weed control for lawns to be applied in Sept. November. Tree, shrub and groundcover bed pre-emergent control to be applied in February. Chemical treatment for insect infestation and disease may be applied and shall be specific to the problem.
- Coysia lawns shall be maintained at a height of 2" 2½" and shall be mowed approximately 60 times per year. Tifway 419 Bermuda lawns sha ed at a height of 2" 2½" and shall be mowed approximately 72 times per year. Grasses used for stabilization and ornamental use shall not be
- excess intrusion into the root zone area of established plantings including equipment, vehicular and pedestrian traffic, construct
- 7. Watering: If an imigation system is utilized, the system shall be regulated to provide approximately 1" of rainfall per week during the g
- 8. Warranty: Remove/volace all dead and or diseased plant material at each maintenance visit.

PREPARATION AND INSTALLATION FOR PLANTING SOD AREAS

- Provide soil ph testing, adjust the ph range of soils that are unacceptable per local cooperative extension service standards. Incorpora
 agricultural lime, fertilizer, and superphosphate uniformly at the rate specified per soil ph testing results. 2. Site to be fine graded before permanent planting and seeding or sodding is installed.
- 3. Soil shall be loosened to a depth of 4.-6 inches by disking, raking, roto-tilling or other acceptable means. Continue tillage until a well-puterized, firm, reasonably uniform seedbed is prepared 4 to 6 inches deep. Chisel compacted areas and spread topsoil 3 inch over adverse coll conditions.
- Rake and remove all loose rock (over 1" diameter), roots, and other obstructions leaving surface reasonably smooth. Contractor shall incorporate/bil-in 50/50 soil amendment in all plant beds.
- 5. All sod and installation techniques shall adhere to turfgrass producers international guideline specifications, current edition 6. Sod areas to be sodded with workable size rolls that are not broken or stretched. Sod shall be free of thatch. Sod shall be installed within 24 hours of arrival at the site.
- Water 1 inch minimum within the first hour of sod or seed installation. Begin irrigation system during the following 3 days keeping the sodded or seeded area moist. 8. Sod shall be laid parallel to the contours and shall have staggered joints on slopes greater than 3:1 or in drainage swales sod shall be staked
- 9. Apply starter fertilizer at time of sodding at rate recommended by manufacturer. Contractor is responsible for the initial watering.
- 10. Inspect all sodded areas and make necessary repairs or resod within the planting season, if possible. If gress stand should be over 60% damaged, Contractor shall consult with a conservation inspector on maintenance treatment and fertilization to determine the best ty of treatment necessary in order to establish and maintain an acceptable stand of gress.
- 11. Contractor shall water and maintain all planting and NEWLY SOD areas until a maintenance contractor has been selected.
- 12. Once an acceptable stand of grass has been established (of 95% or better), the Contractor shall repair all damaged areas and mon the NCWLY SOO areas until the grass reaches a height of 4 inches tal.

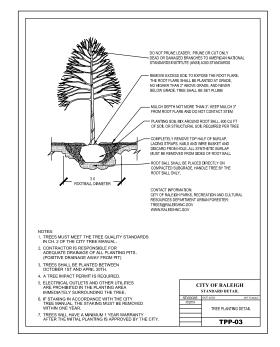

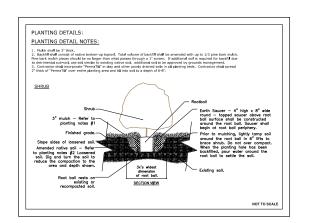



LANDSCAPE ARCHITECTURE SITE PLANNING & DESIGN

JOHN A, EDWARDS & CO 333 WADE AVE. - RALEIGH, NC (919) 828-4428



_ .AST .ET LOT ' EGH, LLC EIGH E/ ON STREE STREET BUDLIE ERLIN ROAD - R. UDDLE EACOP EACON STR 550 OBERI


REVIEW 1/17/2024

PLANTING NOTES & DETAILS

DRAWN BY: AS/RW/WAB CHECKED BY: SCALE: SHEET NUMBER

L-2

OF 2

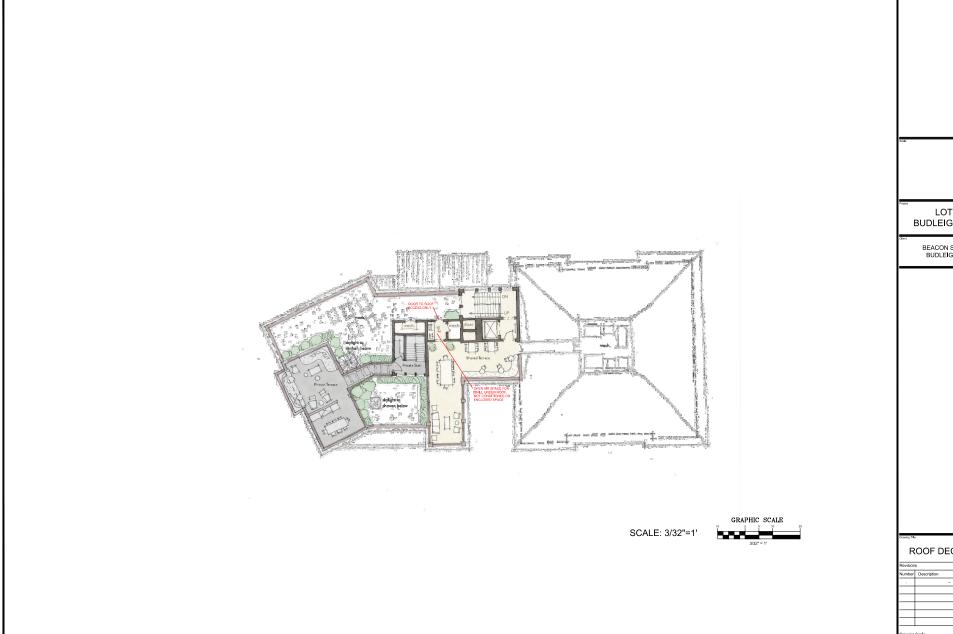

LOT 11 **BUDLEIGH EAST**

BEACON STREET BUDLEIGH LLC

ROOF DECK PLAN

Number	Description	Date
-		
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\neg		

UDO 1.5.9.B.

B. General Requirements

- The minimum percentage of windows and doors that must cover a ground story facade is measured between 0 and 12 feet above the surface of the finished ground floor for all above-grade portions of the facade. A minimum of 50% of the required transparency must be located between 3 and 8 feet from the surface of the finished ground floor.
- The minimum percentage of windows and doors that must cover an upper story facade is measured from top of the finished floor to the top of the finished floor above. When there is no floor above, upper story transparency
- is measured from the top of the finished floor to the top of the wall plate. In a mixed use building, or general building where an Urban Frontage is applied, a minimum of 60% of the street-facing, street-level window pane surface area must allow views into the ground story use for a depth of at least 8 feet. Windows shall not be made opaque by non-operable window treatments (except curtains, blinds or shades within the conditioned space).
- 4. Glass shall be considered transparent where it has a transparency higher than 80% and external reflectance of less than 25%. Glass on upper stories may have any level of transparency and external reflectance. C.....

UDO 3.2.6.F.

F.	Transparency	
F1	Ground story (min)	50%
F2	Upper story (min)	20%
F3	Blank wall (max)	20'

LOT 11 **BUDLEIGH EAST**

BEACON STREET BUDLEIGH LLC



SOUTHWEST ELEVATION

SCALE: 3/32"=1'

GRAPHIC SCALE

GROUND STORY CALCULATIONS

WINDOWS AND DOORS	FACADE SURFACE AREA	
SURFACE AREA	CODE-DEFINED HEIGHT x LENGTH OF	
(10) WINDGWS AND	STREET-FACING FACADE	
DOORS OF VARYING SIZES		***************************************
761 sq. ft.	12'-0" x 121'-6" = 1,458 sq. ft.	52% TRANSPARENCY ON GROUND STORY
1	L	ON GROCAD STORT

UPPER STORY CALCULATIONS


WINDOWS AND DOORS	FACADE SURFACE AREA	
SURFACE AREA	CODE-DEFINED HEIGHT x LENCTH OF	
(16) WINDOWS AND	STREET-FACING FACADE	
DOORS OF VARYING SIZES		
		30% TRANSPARENCY
487.5 sq. ft.	12'-0" x 135'-4" = 1,624 sq. ft.	ON UPPER STORY
1		ON OFFER STORT

Window and Door Calculations

Upper	Type	Width	Height	#Windows	Square Feet
	A	3.92	6	6	141.12
	В	3.92	9	4	141.12
	C	5.92	7	2	82.88
	D	3.92	8	2	62.72
	E	7.92	8	1	63.36
				Total:	491.2
Ground					
	F	9.71	11	4	427.24
	G	5.71	10	2	114.2
	H	1.71	5	2	17.1
	1	5.71	11	1	62.81
	J	12.71	11	1	139.81
				Total:	761.16

TRANSPARENCY CALCULATIONS

umber	Description		Date		
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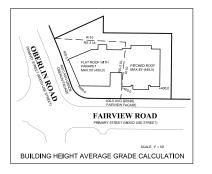
UDO 1.5.9.B.
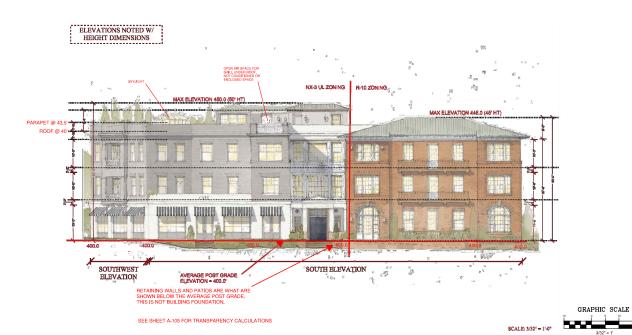
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UDO 3.2.6.F.

F.	Transparency	
F1	Ground story (min)	50%
F2	Upper story (min)	20%
F3	Blank wall (max)	20'



WEST AND SOUTH ELEVATION

LOT 11
BUDLEIGH EAST

BEACON STREET BUDLEIGH LLC

EXTERIOR ELEVATIONS

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nber	Description		Date	
wing	Scale			
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