

Administrative Approval Action

Case File / Name: ASR-0045-2022 DSLC - Hammell Drive Mixed-Use (SUB) City of Raleigh
Development Services Department
One Exchange Plaza
Raleigh, NC 27602
(919) 996-2492
currentplanning@raleighnc.gov
www.raleighnc.gov

LOCATION:

This 3.5 acre site zoned CX-20-UL CU is located on the east side of Lake Wheeler Road on the northeast and southeast corners of the intersection of Lake Wheeler Road and Hammell Drive at 1201 & 1209 Lake Wheeler Road and 1008 Hammell Drive.

REQUEST:

Two mixed use buildings consisting of both residential and retail with a total of 1,106,548 square feet of building space and 675 dwelling units.

- DA-13-2022 (APPROVED 09.01.2022) - DESIGN ALTERNATE FROM

REQUIREMENTS

SET FORTH IN UDO RELATED TO DRIVEWAY SPACING, BACKING INTO OR OUT OF THE RIGHT-OF-WAY AND STEPBACK RELIEF RELATED TO BUILDING

MASSING FOR BLDG A.

APPROVED WITH THE FOLLOWING CONDITIONS:

CHANGE IN MATERIAL OR COLOR AT BLDG B DRIVEWAY FROM HAMMELL

DRIVE

TO ALERT PEDESTRIANS OF THE DRIVEWAY.

BLDG B OPERATOR TO PROVIDE BLDG STAFF MEMBER ON-SITE WHEN

BACKING

MOVEMENT INTO OR OUT OF THE RIGHT-OF-WAY OCCURS.

PROVIDE CITY TRANSPORTATION REVIEW STAFF WITH TURNING TEMPLATE

FOR

VEHICLES BACKING FROM THE RIGHT-OF-WAY FOR THEIR APPROVAL.

DESIGN

ADJUSTMENT(S)/

ALTERNATES, ETC: N/A

FINDINGS: City Administration finds that this request, with the below conditions of

approval being met, conforms to the Unified Development Ordinance. This approval is based on a preliminary plan dated November 18, 2022 by

McAdams.

CONDITIONS OF APPROVAL and NEXT STEPS:

This document must be applied to the second sheet of all future submittals except for final plats. This is a preliminary plan and as such no permits have been issued with this approval. To obtain permits and/or completion of the project, the following steps are required:

☑ <u>SITE PERMITTING REVIEW</u> - For land disturbance of 12,000 square feet or greater, public or private infrastructure, shared stormwater devices, etc. Site Permitting Review may be submitted upon receipt of this signed approval document.

The following items are required prior to approval of Site Permitting Review plans:

General

1. That the SPR review reflects the addendum to the final TIA recommendations. The TIA recommendation diagram and mitigations must be shown on the SPR plan along with the necessary work on South Saunders Street.



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2. That an approved SPR for all road construction and improvements in the right-of-way and an infrastructure surety as outlined by SUB-0026-2022 is in place.

Engineering

- 3. An encroachment submittal for any privately maintained items within the public right-of-way shall be approved by City Council. The executed encroachment agreement shall be filed with the Development Services Department for the approval by City and returned to the Owner. The Owner is responsible to record the executed encroachment agreement with the Wake County Register of Deeds. A recorded copy of these documents must be provided to the Development Services Department.
- A Traffic Control and Pedestrian (TCPED) Plan must be approved and a right-of-way occupancy permit must be obtained from Right-of-way Services for any construction activities within the right-of-way.

Public Utilities

5. A Downstream Sewer Capacity Study in compliance with the City of Raleigh Public Utilities Department Handbook shall be submitted by the Project Engineer for review and approval.

Stormwater

- 6. A surety equal to of the cost of clearing, grubbing and reseeding a site, shall be paid to the City (UDO 9.4.4).
- 7. A nitrogen offset payment must be made to a qualifying mitigation bank (UDO 9.2.2.B).
- 8. A stormwater control plan with a stormwater operations and maintenance manual and budget shall be approved (UDO 9.2).

☑ <u>RECORDED MAP(S)</u> - Submit plat to record new property lines, easements, tree conservation areas, etc.). Plats may be submitted for review when the Site Permitting Review plans, if required, have been deemed ready for mylar signature.

The following items must be approved prior to recording the plat:

Stormwater

- A payment equal to twenty-four percent (24%) of the estimated cost of constructing all stormwater control facilities shown on the development plans shall be paid by the developer to the City stormwater facility replacement fund (UDO 9.2.2.G.3).
- The maximum allocated impervious area for all applicable lots in the subdivision should be identified on all maps for recording.
- 3. A surety equal to 125% of the cost of the construction of a stormwater device shall be paid to the Engineering Services Department (UDO 9.2.2.D.1.d).



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- All stormwater control measures and means of transporting stormwater runoff to and from any nitrogen and stormwater runoff control measures shall be shown on all plats for recording as private drainage easements (UDO 9.2).
- 5. The City form document entitled Declaration of Maintenance Covenant and Grant of Protection Easement for Stormwater Control Facilities shall be approved by the City and recorded with the county register of deeds office (UDO 9.2.2.G).

☑ <u>BUILDING PERMITS</u> - For buildings and structures shown on the approved plans. Commercial building permit plans must include the signed, approved Site Permitting Review plans attached, if applicable. Permit sets may be reviewed prior to the recordation of required plats, but cannot be approved.

The following items must be approved prior to the issuance of building permits:

General

- 1. Comply with all conditions of Z-60-20.
- 2. All conditions of approval for the accompanying subdivision case SUB-0026-2022 creating the lots and street right of way as shown on this plan shall be met and the subdivision plat be recorded.

Stormwater

3. Impervious restrictions for each lot must be recorded on a plat prior to building permit issuance.

Urban Forestry

4. Tree impact permits must be obtained for the approved streetscape tree installations in the rights-of-way. This development proposes 10 street trees along Hammell Drive, 6 street trees along Curfman Street, and 8 street trees along Lake Wheeler Road for a total of 24 street trees.

The following are required prior to issuance of building occupancy permit:

General

- 1. All street lights and street signs required as part of the development approval are installed.
- 2. That the development has provided and installed a location on the property or adjacent right-of-way to accommodate a City bikeshare station with no fewer than 8 docks, which shall be installed by the property owner, subject to approval of an encroachment agreement for such work by the City of Raleigh. (Condition 4 of Z-060-2020).
- 3. Final inspection of right-of-way street trees by Urban Forestry Staff.

Stormwater



Administrative Approval Action

Case File / Name: ASR-0045-2022 **DSLC - Hammell Drive Mixed-Use (SUB)**

City of Raleigh **Development Services Department** One Exchange Plaza Raleigh, NC 27602 (919) 996-2492 currentplanning@raleighnc.gov www.raleighnc.gov

- As-built impervious survey is accepted by the Engineering Services Department (UDO 9.2).
- 5. As-built drawings and associated forms for all Stormwater devices are accepted by the Engineering Services Department (UDO 9.2.2.D.3).

EXPIRATION DATES: The expiration provisions of UDO Section 10.2.8 E, including the ability to request extensions in the expiration date, apply to this site plan. If significant construction has not taken place on a project after administrative site review approval, that approval may expire and be declared void, requiring re-approval before permits may be issued. To avoid allowing this plan approval to expire the following must take place by the following dates:

3-Year Expiration Date: December 15, 2025

Obtain a valid building permit for the total area of the project, or a phase of the project.


4-Year Completion Date:

Within four years after issuance of the first building permit for the site plan, the construction of the entire site plan must be completed unless an applicant has been granted vested rights. Failure to complete construction within this specified time frame shall automatically void the approved site plan for which no building permits have been issued.

I hereby certify this administrative decision.			
Signed:	Daniel L. Stegall	Date:	12/15/2022
	Development Services Dir/Designee	_	
Staff Coordinato	r: Michael Walters		



	YPE + SITE DATE TABLE to all developments)
SITE DATA	BUE DING DATA
Zoning district (if more than one, please provide the acreage of each):	Existing gross floor area (not to be demolished); 0 sf
CX-20-UL-CU	Existing gross floor area to be demolished: 0 sf
Gross site acreage: 3.50 ac	New gross floor area: 1,106,548 SF
# of parking spaces required () required	Total of gross (to remain and new):: 1,106,548 SF
# of parking spaces proposed: 953	Proposed #of buildings: 2
Overlay District (if applicable): n/g	Proposed # of stories for each: 22 mores to be sales
Existing use (UDO 6.1.4) yacant	
Proposed use (UDO 6 1.4) Mixed use	-
1, 1, 1, 1, 1, 1, 1, 1, 1, 1, 1, 1, 1, 1	
	TER INFORMATION
Existing houseware feetings:	Proposer tours - 9 Surface: 105.338
	Acres 2.42 Square Feet 105,338
	L DEVELOPMENTS
Total # of dwelling units: 675	Total # of hotel units: 0
# of bedroom units: 1br 467 2br 201 3bi	7 4br or more 0
# of lats: 2	Is your project a cottage court? Yes No F
SKINAT	TURE BLOCK
becenth, and in accordance with the provisions and reg (David M Boyette, PE with an original to the provision of the property of the propert	ends in accordancy with the plants and peoidisalism's submission allowers of the City of Rateigh Linkset Development Chrismons. If serve as the agent regarding this application, and will receive and applicable documentation, and will represent the properly. It is conforming to all application requirements applicable with the ison of in submission of the plants of the properly.
Sman / 3	
Signature: Printed Name David M Bovette: PE	Unit 153.77, 202 Z

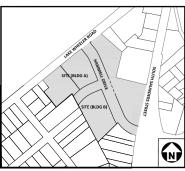

VICINITY MAP 1"=200'

HAMMELL DRIVE **MIXED-USE**

ADMINISTRATIVE SITE REVIEW

1008 HAMMELL DRIVE

RALEIGH, NORTH CAROLINA 27603

PROJECT NUMBER: MRE-21001

PROJECT CASE #: ASR-0045-2022 DATE: MAY 20, 2022

REVISED JULY 8, 2022 REVISED AUGUST 16, 2022 REVISED OCTOBER 3, 2022 REVISED NOVEMBER 18, 2022

SPECIAL APPROVALS NOTE:	
SET FORTH IN UDO RELATED TO DRIVEWA	DESIGN ALTERNATE FROM REQUIREMENTS Y SPACING, BACKING INTO OR OUT OF THE ATED TO BUILDING MASSING FOR BLDG A. TERNATE AGENDA ITEM.

PROVIDE CITY TRANSPORTATION REVIEW STAFF WITH TURNING TEMPLATE FOR VEHICLES BACKING FROM THE RIGHT-OF-WAY FOR THEIR APPROVAL.

SITE ADDRESS:	E ADDRESS: 1201 & 1209 LAKE WHEELER ROAD; 1008 HAMMELL I		
PIN (& DEEDED ACREAGE):	RALEIGH, NC, 27603 1703344393 (1.01 AC), 1703346438 (0.67 AC), 1703347251 (1.82 AC)		
TOTAL AREA:	3.50 AC.	door seek as one-see from seek	
ZONING:	CX-20-UL-CU: COMMERCIAL MIXED	USF (Z-060-20)	
EXISTING USE:	VACANT		
PROPOSED USE:	MULTI-FAMILY LIVING, RETAIL/REST	AURANT STRUCTURED PARKING	
RIVER BASIN:	NEUSE		
WATERSHED:	WALNUT CREEK		
AREA IN FLOODWAY/FLOODPLAIN: FLOODPLAIN/FIRM PANEL:	0 AC. 3720170200J		
PREVIOUS APPROVALS	REZONING: Z-60-20		
	RECOMBINATION PLAT: RCMP-0032	-2022	
TOTAL EXISTING LOTS TOTAL PROPOSED LOTS	2		
IMPERVIOUS SURFACE:	EXISTING IMPERVIOUS SURFACE TO	REMAIN:	
	0 SF / 0.00 AC		
	PROPOSED IMPERVIOUS SURFACE 1 105,338 SF / 2.42 AC	O BE ADDED:	
	NET IMPERVIOUS SURFACE CHANG 105,338 SF / 2.42 AC	E	
VEHICULAR PARKING SUMMARY:	MAXIMUM PARKING - SEE BLDG/PA	RKING SUMMARY TABLE	
	BLDG A - MAXIMUM ALLOWED = 73 BLDG B - MAXIMUM ALLOWED = 54		
	PROVIDED PARKING BLDG A - TOTAL PROVIDED = 541 SP BLDG B - TOTAL PROVIDED = 412 SP	ACES ACES	
ACCESSIBLE PARKING SUMMARY:	REQUIRED ADA PARKING		
Accessing Principles		ACES = 541 * 0.02 = 11 TOTAL (2 VAN) ACES = 9 TOTAL (2 VAN)	
	PROVIDED PARKING BLDG A - 22 TOTAL (4 VAN) BLDG B - 11 TOTAL (3 VAN)		
BICYCLE PARKING SUMMARY:	REQUIRED BIKE PARKING		
BICTCLE PRINCIPO SCHIMMALT.	NEQUIRED BIKE PARKING		
	BLDG A		
		P/20 UNITS = 20 SPACES RANT @ 1 SP/50,000 SF (MIN. 4) = 4 SPACES = 24 SPACES	
	LONG-TERM: 521 BEDS @ 1 SP 4,469 SF RESTAU TOTAL LONG-TERM BLDG A =	/7 BEDS = 74 SPACES RANT @ 1 SP/25,000 SF (MIN. 4) = 4 SPACES 78 SPACES	
	NLDG B		
	SHORT-TERM: 283 UNITS @ 15	P/20 UNITS = 14 SPACES RANT @ 1 SP/50,000 SF (MIN. 4) = 4 SPACES = 18 SPACES	
	LONG-TERM: 369 BEDS @ 1 SP 5,284 SF RESTAU TOTAL LONG-TERM BLDG B =	/7 BEDS = 53 SPACES RANT @ 1 SP/25,000 SF (MIN. 4) = 4 SPACES 57 SPACES	
I	DROLADED BIKE DARKING		
I	PROVIDED BIKE PARKING		
	BLDG A BLDI		
I		RT-TERM = 18 SPACES G-TERM = 60 SPACES	
OUTDOOR AMENITY AREA	SEE SHEET C2.00 FOR OUTDOOR AN		
BUILD-TO REQUIREMENTS	PRIMARY STREET BUILD-TO (MIN/M		
* AT REMINE	PRIMARY STREET BUILD-TO (MIN)MAX) 07/20" BLDG. WIDTH IN PRIMARY BUILD-TO (MIN) 50% SIDE STREET BUILD-TO (MIN)MAX) 07/20" BLDG. WIDTH IN SIDE BUILD-TO (MIN) 23%		
PROPOSED BUILD-TO	BLDG A	ny	
*FOR RESERVE DISTRIBUTION OF PROPERTY AND COMPANY AND STREETS	REQUIRED FOR LAKE WHEELER	186.6 LF OF 373.2 LF OF FRONTAGE (50%, 0'-20")	
	PROVIDED FOR LAKE WHEELER	350.6 LF (93.9%)	
FOR BLDG & ANNUALL IS PREMARY, CURPMAN & A SIDE STREET	REQUIRED FOR HAMMELL PROVIDED FOR HAMMELL	49.7 LF OF 198.8 LF OF FRONTAGE (25%, 0'-20') 194.8 LF (98.0%)	
	REQUIRED FOR CURFMAN PROVIDED FOR CURFMAN	48.3 LF OF 193.2 LF OF FRONTAGE (25%, 0'-20') 92.2 LF (47.7%)	
I	BLDG B		
I	REQUIRED FOR HAMMELL	129.7 LF OF 259.3 LF OF FRONTAGE (50%, 0'-20")	
I	PROVIDED FOR HAMMELL REQUIRED FOR CURFMAN	240.8 LF (92.9%) 46.6 LF OF 186.4 LF OF FRONTAGE (25%, 0'-20')	
1	REQUIRED FOR CURFMAN PROVIDED FOR CURFMAN	46.6 LF OF 186.4 LF OF FRONTAGE (25%, 0'-20') 69.2 LF [37.1%]	
BUILDING/STRUCTURE SETBACKS:	FROM PRIMARY STREET (MIN):	0' PER UDO SEC. 3.4.7	
	FROM SIDE STREET (MIN):	0' PER UDO SEC. 3.4.7	
I	FROM SIDE LOT LINE (MIN):	0' OR 6'	
I	FROM REAR LOT LINE (MIN): FROM ALLEY (MIN):	0' OR 6'	
PARKING SETBACKS:	FROM PRIMARY STREET (MIN):	10'	
rankinG 3C IDMCN3:	FROM SIDE STREET (MIN):	10'	
I	FROM SIDE LOT LINE (MIN):	0.083.	

BUILDING / PARKING SUMMARY TABLE: BLDG A - MAXIMUM PARKING CALCULATION

Bed (units)	6	3	sp/unit	18
esturant (sf)	4,469	100	sp/sf	45
OTAL ALLOWED				730
.DG B - MAXIMUM F	PARKING CAL	CULATION	,	
	Quantity	Max. A	llowed	Spaces
udio/1-Red (unitr)	100	1.5	on famile	207

| Quantity | Max. Allowed | Spaces | tudio/1-Bed (units) | 269 | 1.5 | sp/unit | 404 | Red (units) | 117 | 2.25 | sp/unit | 263

NOTES

LIGHTING PLAN PROVIDED WITH PRELIMINARY SUBDIVISION SUBMITTAL: SUB-0026-2022.

SHEET INDEX

C0.00	PROJECT NOTES
C0.01	TRAFFIC / ROADWAY
C1.00	EXISTING CONDITIONS AREA "A
C1.01	EXISTING CONDITIONS AREA "B
C1.02	DEMOLITION PLAN AREA "A"
C1.03	DEMOLITION PLAN AREA "B"
C2.00	OVERALL SITE PLAN
C2.01	SITE PLAN AREA "A"
C2.02	SITE PLAN AREA "B"
C3.00	GRADING PLAN AREA "A"
C3.01	GRADING PLAN AREA "B"
C3.02	SCM DETAILS
C3.03	SCM NOTES
C4.00	UTILITY PLAN AREA "A"
C4.01	UTILITY PLAN AREA "B"

SITE DETAILS LITHITY DETAILS C8.02 STORM DRAINAGE DETAILS

LANDSCAPE	ARCHITECTURE SHEETS
LS1.1	LANDSCAPE PLAN AREA "A"
LS1.2	LANDSCAPE PLAN AREA "B"
LS1.3	LANDSCAPE PLAN AREA "C"

LIGHTING PLANS

C8.00

C8.01

SL01	SITE LIGHTING PHOTOMETRIC P	LAN
\$1.02	SITE LIGHTING PHOTOMETRIC P	ΙΔΝ

BUILDING A ARCHITECTURAL SHEETS

SP-100	FIRST FLOOR SITE
SP-101	FIRST FLOOR
SP-102	SECOND FLOOR
SP-103	THIRD FLOOR
SP-107	SEVENTH FLOOR
SP-108	EIGHTH FLOOR
SP-109	TWENTIETH FLOOR
SP-110	ROOF
SP-201	SOUTHWEST ELEVATION
SP-202	NORTHWEST ELEVATION

BUILDING B ARCHITECTURAL SHEETS

BUILDING B - ROOF PLAN
BUILDING B - FLOOR PLAN USE TYPES
BUILDING B - AXON
BUILDING B - NORTH ELEVATION
BUILDING B - WEST ELEVATION
BUILDING B - SOUTH ELEVATION
BUILDING B - EAST ELEVATION
BUILDING B - EAST ELEVATION WITH BUILDING A
BUILDING B - STRIPING PLAN - LEVEL 01

SOUTHEAST ELEVATION

TR102 BUILDING B - STRIPING PLAN - LEVEL 02 BUILDING B - STRIPING PLAN - LEVEL 03 TR104 BUILDING B - STRIPING PLAN - LEVEL 04 BUILDING B - STRIPING PLAN - LEVEL 05 TR105 BUILDING B - STRIPING PLAN - LEVEL 06 TR106 BUILDING B - STRIPING DETAILS TR501

BLDG A - PARKING PROVIDED		
itandard Spaces	519	
Compact Spaces	18	
itnd ADA Spaces	4	
/an ADA Spaces	0	
OTAL SPACES	541	

andard Spaces	312
ompact Spaces	8
nd ADA Spaces	3
an ADA Spaces	89
OTAL SPACES	412

ATTENTION CONTRACTORS

The Construction Contractor responsible for the extension of water, sewer, and/or reuse, as approved in these plans, is responsible for contacting the Public Words apportment at (1919) 398—2499, and the Public Utilities Department at (1919) 398—398, and the Public Utilities Department at (1919) 398—3540 at least hearty four hoters; prior to beginning any of their construction.

Failure to notify both City Departments in advance of beginning construction, will result in the issuance of monetary fines, and require reinstallation of any water or sewer facilities not inspected as a result of this notification failure.

Failure to call for inspection, install a Downstream Plug, have Permitted Plans on the Jobaite, or any other Violation of City of Raleigh Standards will result in a <u>Fine and Posalble Exclusion</u> from future work in the City of Raleigh.

--- Bass





MCADAMS The John R. McAdams Company, Inc One Glenwood Avenue phone 919. 823. 4300 fax 919. 361. 2269 license number: C-0293, C-187

www.mcadamsco.com

CONTACT

boyette@mcadamsco.c PHONE: 919. 823. 4300

CLIENT

MREG MANAGEMENT 60 COLUMBUS CIRCLE, 20TH FLOOR NEW YORK, NEW YORK, 10023 CONTACT: CHUCHLLIN

PROJECT DIRECTORY

DEVELOPER
MREG MANAGEMENT
60 COLUMBIA CIRCLE, 20TH FLOOR
NEW YORK, NEW YORK 10023 PHONE: 212.484.8265

ARCHITECT GENSLER 530 HILLSBOROUGH STREET RALEIGH, NC, 27603 PHONE: 919. 645. 4317


ARCHITECT JDAVIS 510 S WILMINGTON STREET RALEIGH, NC, 27601 PHONE: 919. 835. 1500



ADMINISTRATIVE SITE REVIEW FOR:

HAMMELL DRIVE MIXED-USE RALEIGH, NORTH CAROLINA 27603 PROJECT NUMBER: MRE-21001

PRELIMINARY DRAWING - NOT RELEASED FOR CONSTRUCT

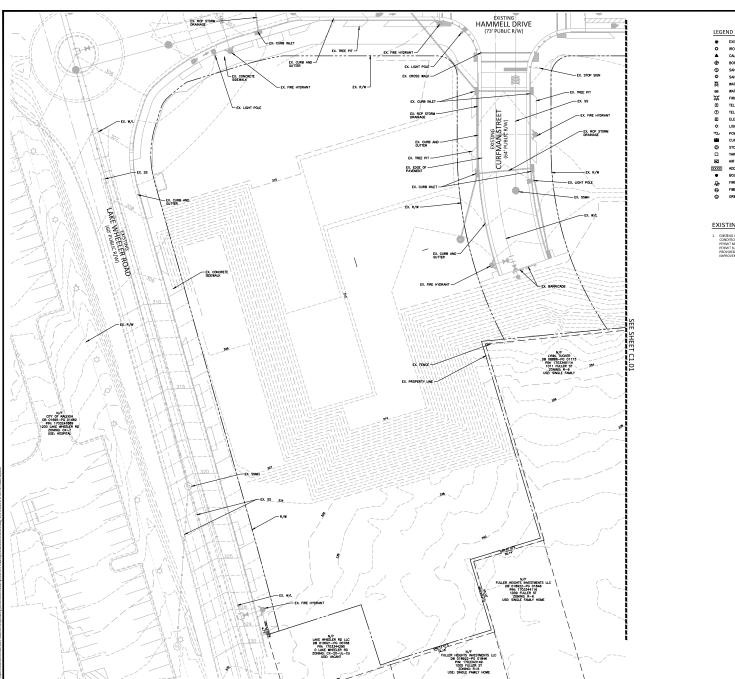

	EXISTING IRON PIPE	ě.	ACCESSIBLE PARKING
0	IRON PIPE SET	8	IRRIGATION CONTROL VALVE
_	CALCULATED POINT		FLOOD LIGHT
⊕	BORE HOLE		MAIL BOX
(3)	SANITARY SEWER MANHOLE	⊗	MONITORING WELL
٥	SANITARY SEWER CLEANOUT	nc	SIAMESE CONNECTION
×	WATER VALVE		SIGN
88	WATER METER	00	WELL
TT.	FIRE HYDRANT		WATER MANHOLE
00	TELEPHONE PEDESTAL	•□	LIGHT SINGLE
Φ	TELEPHONE MANHOLE	□•□	LIGHT DOUBLE
E	ELECTRIC BOX	=	CABLE BOX
•	LIGHT POLE	&	FIBER OPTIC VAULT
Ф	POWER POLE	*	SPRINKLER HEAD
	CURB INLET	sp	STORM DRAIN PIPE
0	STORM DRAINAGE MANHOLE	ou	OVERHEAD UTILITY LINES
	YARD INLET	—— w ——	WATER LINE
AC.	AIR CONDITIONER	——ss——	SANITARY SEWER LINE
XXXX	ADDRESS BOX	T	TELEPHONE LINE
•	BOLLARD	—— G ——	GAS LINE
Q.	FIRE CONNECTION	——UE ———	UNDERGROUND ELECTRIC
ē	FIBER OPTIC MARKER	ur	UNDERGROUND TELEPHONE

EXISTING CONDITIONS NOTES:

EXETING CONDITIONS SHOWN HERE ARE A COMBINATION OF THE EXISTING CONDITIONS SURRYLY OF THE STIE, WORK PROPOSED WITH MASS GRADING PENNT IN ASCAGO-2002 JAPPOWLA PROMOSE). THE PREIMINANT SUBMINIST PROVIDED BY THE CITY OF RALEIGH FOR THE LAKE WHELER BOAD IMPROVEMENTS.

The John R. McAdams Company, Inc. One Glenwood Avenue Suite 201 Raleigh, NC 27603 phone 919. 823. 4300 fax 919. 361. 2269 license number: C-0293, C-187

CLIENT

MACK REAL ESTATE GROUP 60 COLUMBUS CIRCLE, 20TH FLOOR NEW YORK, NEW YORK 10023 PHONE: 212.484.0068



HAMMELL DRIVE MIXED USE ADMINISTRATIVE SITE REVIEW 1008 HAMMELL DRIVE RALEIGH, NC, 27603

REVISIONS

SEE SHEET CO.00 FOR ALL PROJECT, SITE, GRADING, STORM DRAINAGE AND UTILITY NOTES

ALL CONSTRUCTION SHALL BE IN ACCORDANCE WITH THE CURRENT CITY OF RALEIGH ENGINEERING DESIGN AND CONSTRUCTION STANDARDS

NO. DATE 1 07.08.2022 2 08.16.2022 3 10.03.2022 4 11.18.2022


PLAN INFORMATION

PROJECT NO. FILENAME MRE21001-ASR-XC1 CHECKED BY DRAWN BY SCALE 1" = 20" DATE 05.20.2022

SHEET

EXISTING CONDITIONS AREA "A"

C1.00

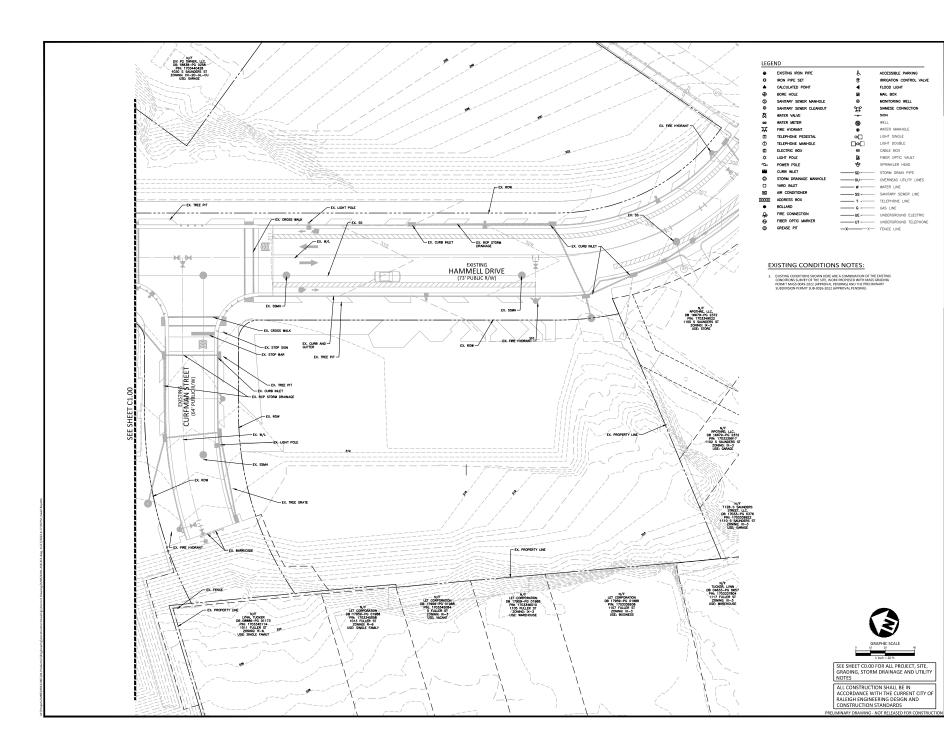



The John R. McAdams Company, Inc. One Glenwood Avenue Suite 201 Raleigh, NC 27603 phone 919. 823. 4300 fax 919. 361. 2269 license number: C-0293, C-187

CLIENT

MACK REAL ESTATE GROUP 60 COLUMBUS CIRCLE, 20TH FLOOR NEW YORK, NEW YORK 10023



HAMMELL DRIVE MIXED USE ADMINISTRATIVE SITE REVIEW 1008 HAMMELL DRIVE RALEIGH, NC, 27603

REVISIONS

0. DATE 07.08.2022 08.16.2022 10.03.2022 11.18.2022

PLAN INFORMATION


PROJECT NO. FILENAME MRE21001-ASR-XC1 CHECKED BY DRAWN BY

SCALE 1" = 20" DATE 05.20.2022

SHEET

EXISTING CONDITIONS

C1.01

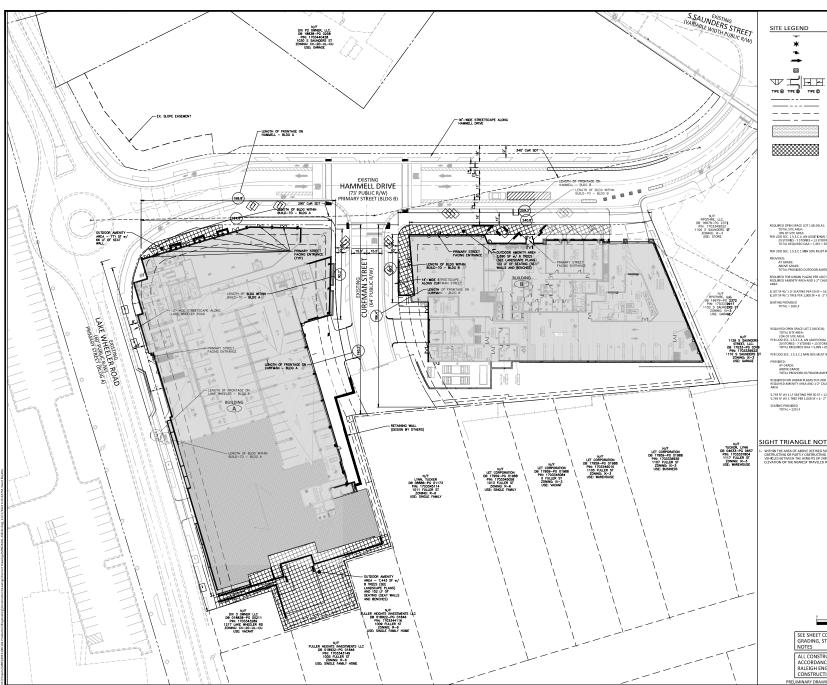



MCADAMS The John R. McAdams Company, Inc One Glenwood Avenue Suite 201 Raleigh, NC 27603

phone 919. 823. 4300 fax 919. 361. 2269 license number: C-0293, C-187

TRAFFIC DIRECTIONAL ARROW PARKING SPACE COUNT

LIGHT POLE POWER POLE

(XX)

RIGHT-OF-WAY LINE EASEMENT LINE CENTERLINE

HEAVY DUTY ASPHALT PAVEMENT OUTDOOR AMENITY

CLIENT

MACK REAL ESTATE GROUP 60 COLUMBUS CIRCLE, 20TH FLOOR NEW YORK, NEW YORK 10023



HAMMELL DRIVE MIXED USE ADMINISTRATIVE SITE REVIEW 1008 HAMMELL DRIVE RALEIGH, NC, 27603

MEQUINID OPPN SPACE LOT 1 (BLDG A):

1070A. STEAMEN.

78,578.5F (L.71, AC)

78,779.F (R.72, AC)

78,779.F (R.72, AC)

20,700B.5.7.5 (R.62, AC)

20,700B.5.7 (R.62, AC)

20,700B.

PROVIDED: AT GRADE: ABOVE GRADE: TOTAL PROVIDED OUTDOOR AMENITY AREA:

REQUIRED FOR URBAN PLAZAS PER UDO SEC. 1.5.3.C.3, 1 LF OF SEATING FOR EACH 50 SF OF REQUIRED AMENITY AREA AND 1-2" CALIPER TREE FOR EVERY 1,000 SF OF REQUIRED AMEN

8,107 SF W/ 1 LF SEATING PER 50 SF = 162 LF SEATING REQUIRED 8,107 SF W/ 1 TREE PER 1,000 SF = 8 - 2" CALIPER TREES REQUIRED

PER UDO SEC. 1.5.3.C.1 MIN 50% MUST BE AT GRADE (2,875 SF)

REQUIRED FOR URBAN PLAZAS PER UDO SEC. 1.5.3.C.3, 1 IF OF SEATING FOR EACH REQUIRED AMENITY AREA AND 1-2" CAUPER TREE FOR EVERY 1,000 SF OF REQUIR

TREES PROVIDED TOTAL = 6 TREES

SIGHT TRIANGLE NOTES:

SEE SHEET CO.00 FOR ALL PROJECT, SITE, GRADING, STORM DRAINAGE AND UTILITY

ALL CONSTRUCTION SHALL BE IN ACCORDANCE WITH THE CURRENT CITY OF RALEIGH ENGINEERING DESIGN AND

CONSTRUCTION STANDARDS

NOTES

REVISIONS

07.08.2022 08.16.2022 10.03.2022 11.18.2022


PLAN INFORMATION

PROJECT NO. FILENAME MRF21001-ASR-S1 CHECKED BY DRAWN BY

SCALE 1" = 30" DATE 05.20.2022 SHEET

OVERALL SITE PLAN

C2.00

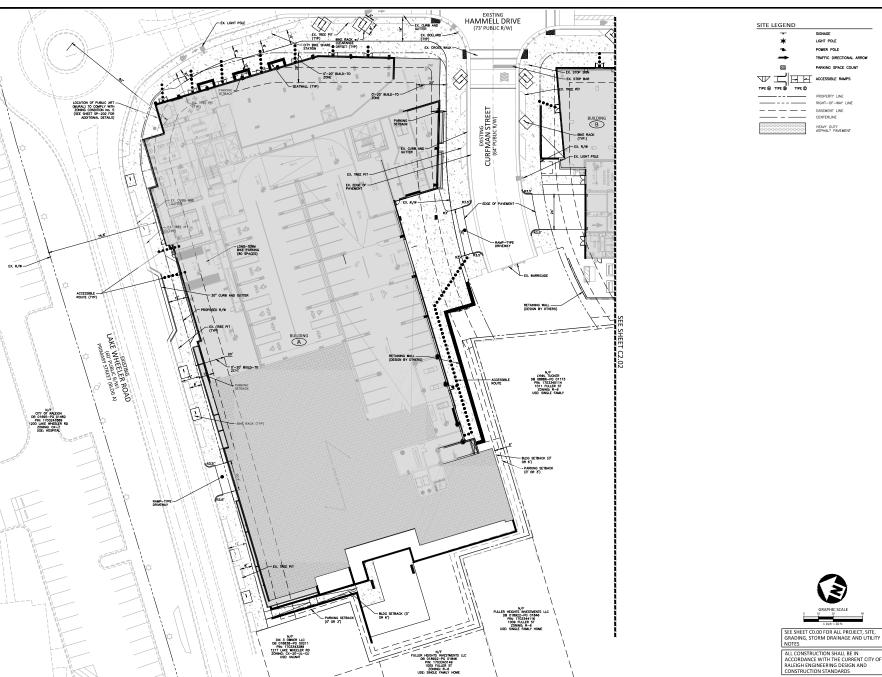



RIGHT-OF-WAY LINE EASEMENT LINE CENTERLINE

HEAVY DUTY ASPHALT PAVEMENT

CLIENT

MACK REAL ESTATE GROUP 60 COLUMBUS CIRCLE, 20TH FLOOR NEW YORK, NEW YORK 10023 PHONE: 212.484.0068



HAMMELL DRIVE MIXED USE ADMINISTRATIVE SITE REVIEW 1008 HAMMELL DRIVE RALEIGH, NC, 27603



REVISIONS

NO. DATE 1 07.08.2022 2 08.16.2022 3 10.03.2022 4 11.18.2022


PLAN INFORMATION

PROJECT NO. FILENAME MRE21001-ASR-S1 CHECKED BY DRAWN BY SCALE DATE 1" = 20' 05.20.2022

SHEET

SITE PLAN AREA "A"

C2.01

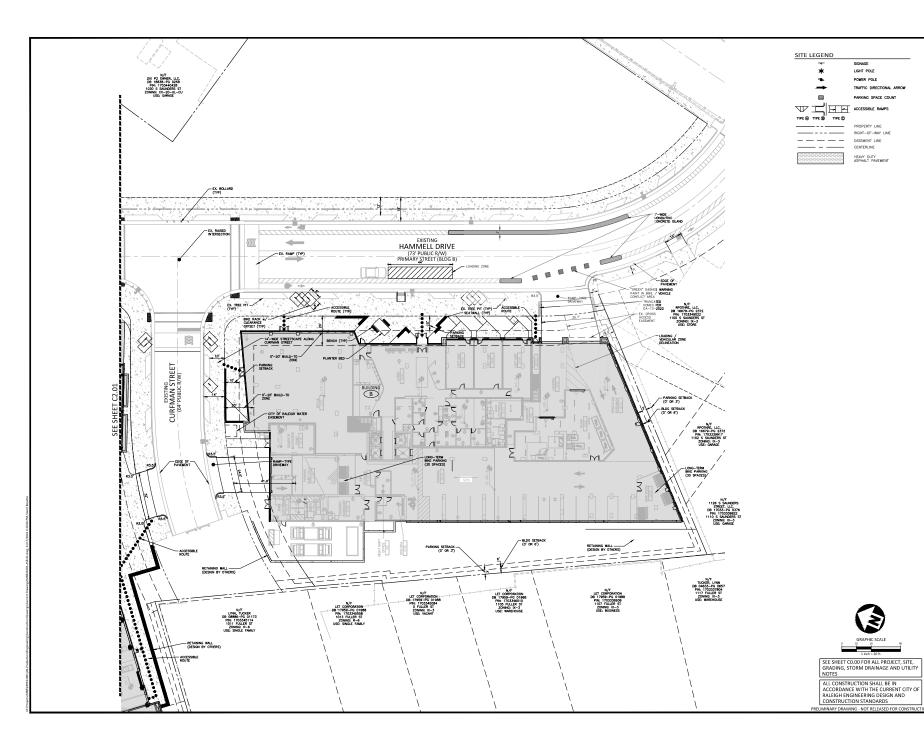



The John R. McAdams Company, Inc. One Glenwood Avenue Suite 201 Raleigh, NC 27603 phone 919. 823. 4300 fax 919. 361. 2269 license number: C-0293, C-187

CLIENT

MACK REAL ESTATE GROUP 60 COLUMBUS CIRCLE, 20TH FLOOR NEW YORK, NEW YORK 10023 PHONE: 212.484.0068



HAMMELL DRIVE MIXED USE ADMINISTRATIVE SITE REVIEW 1008 HAMMELL DRIVE RALEIGH, NC, 27603



REVISIONS


NO. DATE 1 07.08.2022 2 08.16.2022 3 10.03.2022 4 11.18.2022

PLAN INFORMATION

PROJECT NO. FILENAME MRE21001-ASR-S1 CHECKED BY DRAWN BY 1" = 20'

SCALE DATE 05.20.2022 SHEET

SITE PLAN AREA "B"

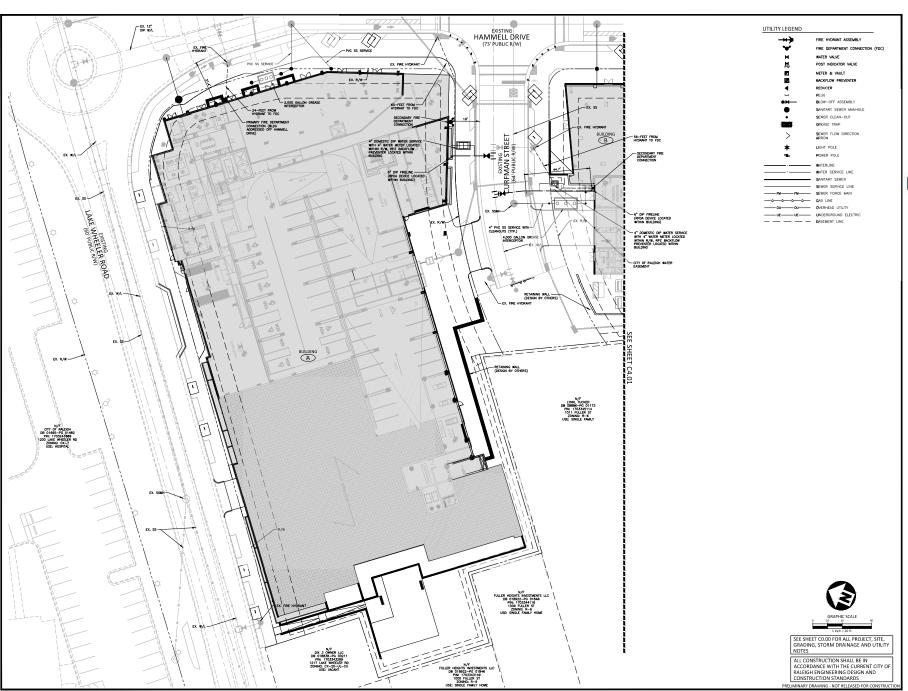



The John R. McAdams Company, Inc. One Glenwood Avenue Suite 201 Raleigh, NC 27603 phone 919. 823. 4300 fax 919. 361. 2269 license number: C-0293, C-187

CLIENT

MACK REAL ESTATE GROUP 60 COLUMBUS CIRCLE, 20TH FLOOR NEW YORK, NEW YORK 10023 PHONE: 212.484.0068



HAMMELL DRIVE MIXED USE ADMINISTRATIVE SITE REVIEW 1008 HAMMELL DRIVE RALEIGH, NC, 27603



REVISIONS

NO. DATE 1 07.08.2022 2 08.16.2022 3 10.03.2022 4 11.18.2022


PLAN INFORMATION

PROJECT NO. FILENAME MRE21001-ASR-U1 CHECKED BY DRAWN BY SCALE 1" = 20' DATE 05.20.2022

SHEET

UTILITY PLAN
AREA "A"

C4.00

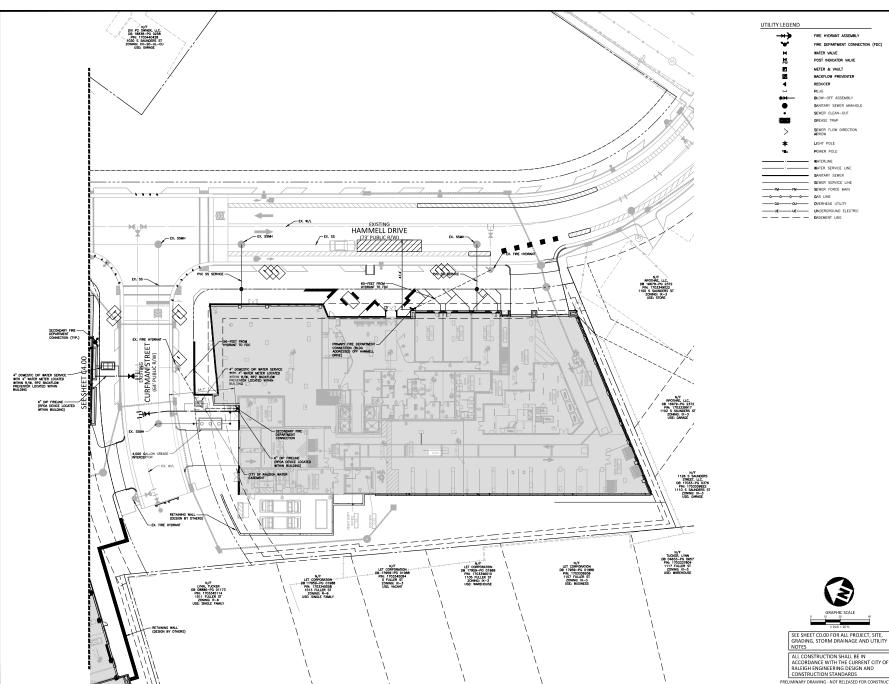



The John R. McAdams Company, Inc. One Glenwood Avenue Suite 201 Raleigh, NC 27603

phone 919. 823. 4300 fax 919. 361. 2269 license number: C-0293, C-187

CLIENT

MACK REAL ESTATE GROUP 60 COLUMBUS CIRCLE, 20TH FLOOR NEW YORK, NEW YORK 10023 PHONE: 212.484.0068



HAMMELL DRIVE MIXED USE ADMINISTRATIVE SITE REVIEW 1008 HAMMELL DRIVE RALEIGH, NC, 27603



REVISIONS

NO. DATE 1 07.08.2022 2 08.16.2022 3 10.03.2022 4 11.18.2022


PLAN INFORMATION

PROJECT NO. FILENAME MRF21001-ASR-U1 CHECKED BY DRAWN BY SCALE 1" = 20" DATE 05.20.2022

SHEET

UTILITY PLAN AREA "B"

C4.01

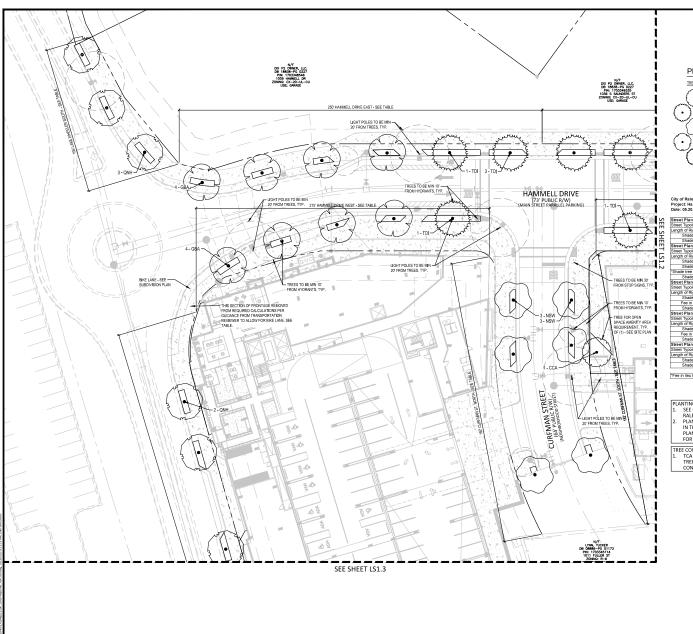



PLANT SCHEDULE

TREES	CODE	QTY	BOTANICAL / COMMON NAME	CONT	CAL	SIZE
\odot	CCA	12	Carpinus caroliniana / American Hombeam	888	3*	10' MIN
(\cdot)	GBA	19	Ginkgo bitoba 'Autumn Gold' TM / Autumn Gold Maidenhair Tree	B&B	3*	10' MIN
	NSW	6	Nyssa sylvatics 'Wildfire' / Wildfire Tupelo	B&B	3*	10' MIN
(\cdot)	QNH	11	Querous nuttalli 'QNFTA' TM / Highpoint Nuttall Cek	B&B	3"	10' M I N
0	TDI	6	Taxodium distichum / Bald Cypress	888	3"	10' MIN

City of Raleigh UDO Streetscape Requirements
Project: Hammell Drive Mixed Use (1008 Hammell Drive)
Date: 05.20.2022 (Rev. 07.07.1022) (Rev.08.15.2022) (Rev.09.26.2022)

Street Typology		г		Mai	in Street Parallel	Parking
Length of Right of Way		Г		П	630	L
Shade Trees Required (3' cal. 10' ht. (0) 40' o.c. average)	630	7	40	=	15.8	E/
Shade Trees Provided (3" cal. 10" ht. @ 40" o.c. average)		Г		\top	15	E
Street Plantings - Hammell Drive (West)		_				
Street Typology		Г		Mai	in Street Parallel	Parkin
Length of Right of Way		Г		Т	472	L
Shade Trees Required (3* cal. 10" ht. @ 40" o.c. average)	472	1	40	=	11.8	E
Shade Trees Removed (3' cal. 10' ht. @ 40' o.c. average)		Г		П	- 1	
*Shade tree removed from calculations per guidance from transportation re	eviewer to allow	for	bike	lane.		
Shade Trees Provided (3" cal. 10" ht. @ 40" o.c. average)		Г		П	10	E
Street Plantings- Curfman Street (North)		_				
Street Typology		Г		П	Neighborhoo	d Stree
Length of Right of Way		Г		т	192	L
Shade Trees Required (3' cal. 10' ht. @ 40' o.c. average)	192	1	40	=	4.8	E
Fee in lieu for shade tree* (3" cal. 10" ht. (0 40" o.c. average)		Г		\Box	- 1	
Shade Trees Provided (3" cal. 10" ht. @ 40" o.c. average)		Г		П	3	E
Street Plantings- Curfman Street (South)		_	_			
Street Typology		Г		т	Neighborhoo	d Stree
Length of Right of Way		Г		П	182	L
Shade Trees Required (3* cal. 10" ht. @ 40" o.c. average)	182	1	40	=	4.6	E
Fee in lieu for shade tree* (3" cal. 10" ht. @ 40" o.c. average)		Г		т	- 1	
Shade Trees Provided (3" cal. 10" ht. @ 40" o.c. average)		Г		П	3	E
Street Plantings- Lake Wheeler Road (South)	•	_				
Street Typology		Г		т	Avenue 2-Lane	Divide
Length of Right of Way		Г		П	467	L
Shade Trees Required (3" cal. 10" ht. @ 40" o.c. average)	467	7	40	-	11.7	E
Shade Trees Provided (3" cal. 10" ht. (@ 40" o.c. average)		Г		П	11	E

*Fee in lieu for shade trees provided for the remainder of Curfman St. due to slose constraints. See civils grading plan

PLANTING NOTES:

1. SEE LSI, 2: FOR STANDARD CITY OF RALEIGH PLANTING DETAILS

2. PLANT TYPES AND QUANTITIES SHOWN IN THE SCHEDULE ARE FOR THE ENTIRE PLANTING PLAN - SEE PLANTING PLA

FREE CONSERVATION AREA PLAN: TCA PLAN IS NOT APPLICABLE AS NO TREES ON SITE QUALITY FOR TREE CONSERVATION PER UDO 9.1



MCADAMS

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phone 919. 823. 4300 fax 919. 361. 2269 license number: C-0293, C-187 www.mcadamsco.com

CLIENT

MACK REAL ESTATE GROUP 60 COLUMBUS CIRCLE, 20TH FLOOR NEW YORK, NEW YORK 10023 PHONE: 212.484.0068



HAMMELL DRIVE MIXED USE ADMINISTRATIVE SITE REVIEW 1008 HAMMELL DRIVE RALEIGH, NC, 27603





REVISIONS

NO.	DATE	
1	07.06.2022	CITY OF RALEIGH COMME
2	08.16.2022	CITY OF RALEIGH COMME
2	10.02.1023	CITY OF BALLICH COMMIS

PLAN INFORMATION

PROJECT NO FILENAME 21200_CODE REQUIRED_ASR_08 CHECKED BY DRAWN BY JEA

SCALE 1" = 20' 05.20.2022

DATE SHEET


LANDSCAPE PLAN AREA "A"

LS1.1

GRAPHIC SCALE

SEE CIVIL SHEETS FOR ALL PROJECT, SITE, GRADING, STORM DRAINAGE AND UTILITY NOTES ALL CONSTRUCTION SHALL BE IN

ALL CONSTRUCTION SHALL BE IN ACCORDANCE WITH THE CURRENT CITY OF RALEIGH ENGINEERING DESIGN AND CONSTRUCTION STANDARDS

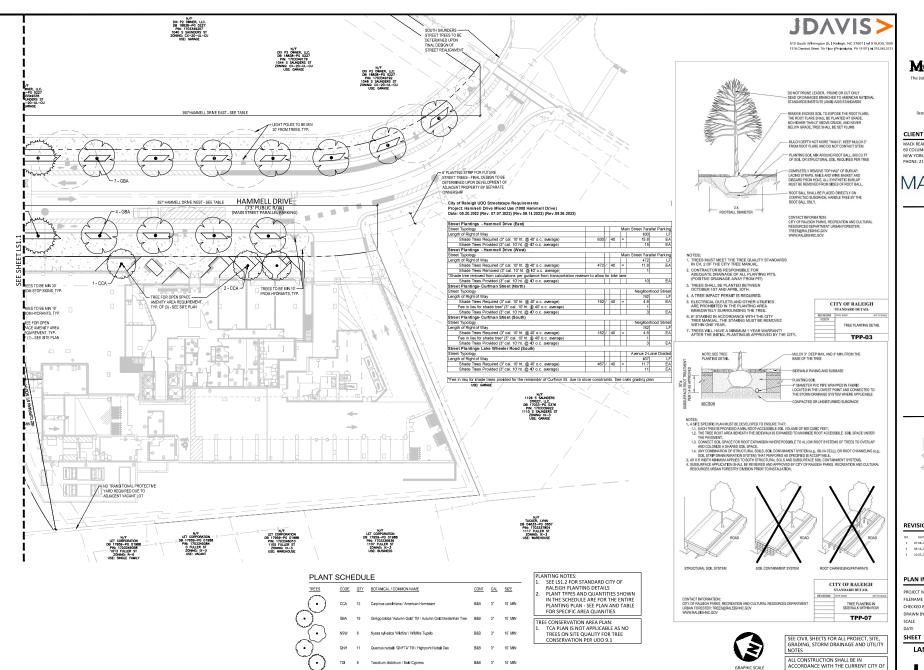



MCADAMS

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phone 919. 823. 4300 fax 919. 361. 2269 license number: C-0293, C-187

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MACK ESTATE GROUP

USE HAMMELL DRIVE MIXED L ADMINISTRATIVE SITE REVIEW 1008 HAMMELL DRIVE RALEIGH, NC, 27603





REVISIONS


NO.	DATE	
1	07.06.2022	CITY OF RALEIGH COMMEN
2	08.16.2022	CITY OF RALEIGH COMMEN
3	10.03.2022	CITY OF RAIFIGH COMMEN

PLAN INFORMATION

_	
PROJECT NO.	21200
FILENAME	21200_CODE REQUIRED_ASR_0
CHECKED BY	JEA
DRAWN BY	JEA
SCALE	1" = 20'

LANDSCAPE PLAN AREA "B"

LS1.2 RALEIGH ENGINEERING DESIGN AND CONSTRUCTION STANDARDS

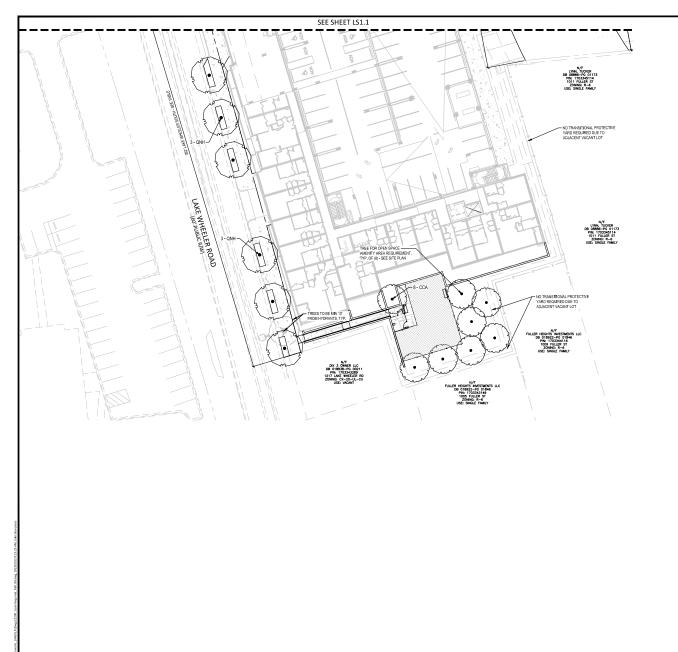



PLANT SCHEDULE

	TREES	CODE	QTY	BOTANICAL / COMMON NAME	CONT	CAL	SIZE
m	\odot	CCA	12	Carpinus caroliniana / American Hombeam	B8B	3"	10" MIN
ۥ)	GBA	19	Ginkgo biloba 'Autumn Gold' TM / Autumn Gold Maidenhair Tree	B&B	3"	10° MIN
-	$\langle \cdot \rangle$	NSW	6	Nyssa sylvatica Wildfire' / Wildfire Tupelo	888	3"	10° MIN
(•	\sum_{m}	QNH	11	Quercus nuttallii 'QNFTA' TM / Highpoint Nuttall Oak	B8B	3"	10" MIN
~~	\odot	TDI	6	Taxodium distictum / Bald Cypress	888	3"	10" MIN
	Marrie .						

City of Raleigh UDO Streetscape Requirements Project: Hammell Drive Mixed Use (1008 Hammell Drive) Date: 05.20.2022 (Rev. 07.07.1022) (Rev. 08.15.2022) (Rev. 09.26.2022)

Street Typology		П		Mai	in Street Parallel	Parking
Length of Right of Way		Н		П	630	LF
Shade Trees Required (3' cal. 10' ht. 60; 40' o.c. average)	630	1	40	=	15.8	EA
Shade Trees Provided (3" cal. 10" ht. @ 40" o.c. average)		Т		\Box	15	EA
Street Plantings - Hammell Drive (West)		_				
Street Typology		Г		Mai	in Street Parallel	Parking
Length of Right of Way		Г		П	472	LF
Shade Trees Required (3' cal. 10' ht. @ 40' o.c. average)	472	1	40	=	11.8	EA
Shade Trees Removed (3' cal. 10' ht. @ 40' o.c. average)		Т		\Box	- 1	
*Shade tree removed from calculations per guidance from transportation re	viewer to allow	for	bike	lane.		
Shade Trees Provided (3" cal. 10" ht. @ 40" o.c. average)		Г		П	10	EA
Street Plantings- Curfman Street (North)		_				
Street Typology		П		П	Neighborhoo	d Street
Length of Right of Way		Т		\Box	192	LF
Shade Trees Required (3' cal. 10' ht. (2) 40' o.c. average)	192	1	40	-	4.8	EA
Fee in lieu for shade tree* (3* cal. 10' ht. (8) 40' o.c. average)		Г		\Box	- 1	
Shade Trees Provided (3" cal. 10" ht. @ 40" o.c. average)				П	3	EA
Street Plantings- Curfman Street (South)		_	_			
Street Typology		Г		П	Neighborhoo	d Street
Length of Right of Way		Г		П	182	LF
Shade Trees Required (3' cal. 10' ht. @ 40' o.c. average)	182	1	40	=	4.6	EA
Fee in lieu for shade tree* (3* cal. 10' ht. (0) 40' o.c. average)		П		П	- 1	
Shade Trees Provided (3" cal. 10" ht. @ 40" o.c. average)		Г		П	3	EA
Street Plantings- Lake Wheeler Road (South)		_				
Street Typology				П	Avenue 2-Lane	Divided
Length of Right of Way		Г		П	467	LF
Shade Trees Required (3" cal. 10" ht. @ 40" o.c. average)	467	1	40	-	11.7	EA
Shade Trees Provided (3" cal. 10" ht. @ 40" o.c. average)		Г		П	11	EA

"Fee in lieu for shade trees provided for the remainder of Curlman St. due to slose constraints. See civils grading plan

PLANTING NOTES:

1. SEE LS1.2 FOR STANDARD CITY OF RALEIGH PLANTING DETAILS

2. PLANT TYPES AND QUANTITIES SHOWN IN THE SCHEDULE ARE FOR THE ENTIRE PLANTING PLAN - SEE PLAN AND TABLE FOR SPECIFIC AREA QUANTITIES

TREE CONSERVATION AREA PLAN:

1. TCA PLAN IS NOT APPLICABLE AS NO
TREES ON SITE QUALITY FOR TREE
CONSERVATION PER UDO 9.1



MCADAMS The John R. McAdams Company, Inc. One Glenwood Avenue Suite 201 Raleigh, NC 27603

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HAMMELL DRIVE MIXED USE ADMINISTRATIVE SITE REVIEW 1008 HAMMELL DRIVE RALEIGH, NC, 27503





REVISIONS

0.	DATE	
	07.06.2022	CITY OF RALEIGH COMMENTS
	08.16.2022	CITY OF RALEIGH COMMENTS
	10.03.2022	CITY OF RALEIGH COMMENTS

PLAN INFORMATION

PROJECT NO. 21200 FILENAME 21200_CODE REQUIRED_ASR_08 CHECKED BY JEA DRAWN BY JEA

SCALE 1" = 20' DATE 05.20.2022

SHEET


LANDSCAPE PLAN


AREA "C" LS1.3

GRAPHIC SCALE

SEE CIVIL SHEETS FOR ALL PROJECT, SITE, GRADING, STORM DRAINAGE AND UTILITY NOTES

ALL CONSTRUCTION SHALL BE IN ACCORDANCE WITH THE CURRENT CITY OF RALEIGH ENGINEERING DESIGN AND CONSTRUCTION STANDARDS

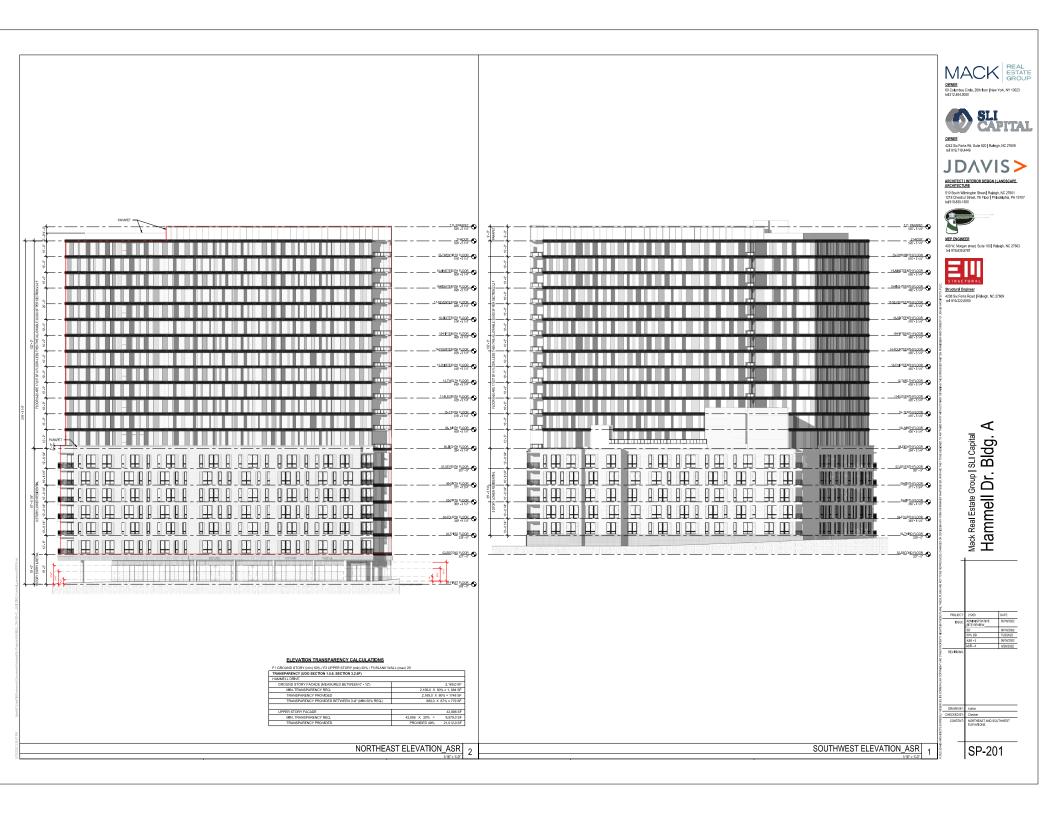

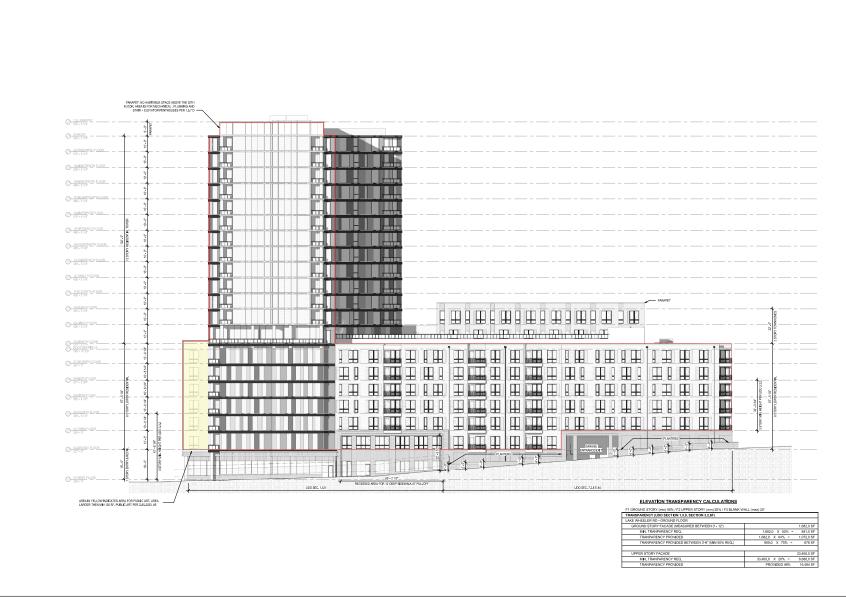

MACK REAL ESTATE GROUP

OWNER 60 Columbus Circle, 20th floor | New York, NY 10023 b) 212.484.0050



4242 Six Forks Rd, Suite 820 | Ralleigh, NC 27809 tel: 919.719.4449





400 W. Morgan street. Suite 100 | Raleigh, NC 27603 tel: 919,835,9781



Structural Engineer


4208 Six Forks Road | Raleigh, NC 27609 set 919.322.5550

⋖ Mack Real Estate Group | SLI Capital Hammell Dr. Bldg.

ISSUE: ADMINISTRATIVE SITE REVIEW

SP-202

NORTHWEST ELEVATION_ASR 1

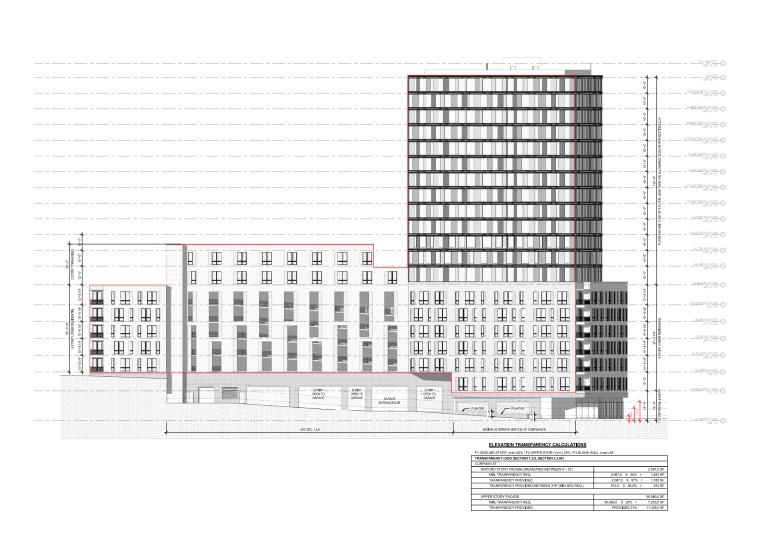

MACK STATE
GROUP

OWNER

ON Calculus Civils 20th for Disas Vot. NY 10023

OWNER 60 Columbus Circle, 20th floor | New York, NY 10023 let 212.484.0050



OWNER 4242 Six Forks Rd, Suite 820 | Raleigh, NC 27809 tet 919,719,4449

JDAVIS>

ARCHITECT LINTERIOR DESIGN | LANDSCAPE ARCHITECTURE

510 South Wilmington Street | Rateigh, NC 27601 1218 Chesthut Street, 7th Floor | Philadelphia, PA 15



MEP ENGINEER 400 W. Morgan street. Suite 100 | Raleigh, NC 27603 bit 919,835,9781



Structural Engineer 4208 Six Forks Road | Raleigh, NC 27809 set 919.322.5550

08 Six Forks Road | Raleigh, NC 21 F 919.322.5550

Mack Real Estate Group I SLI Capital Hammell Dr. Bldg. A


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ISSUE ADMINISTRATIVE (619/20)
30 (619/20)
397 E0 77/20/20
ASR - 4 9/20/20
VISIONS


DRAWN BY: Author
ECKED BY: Checker
CONTENT: SOUTHEAST EXTERIOR
ELEVATIONS

SP-203

SOUTHEAST ELEVATION_ASR 1

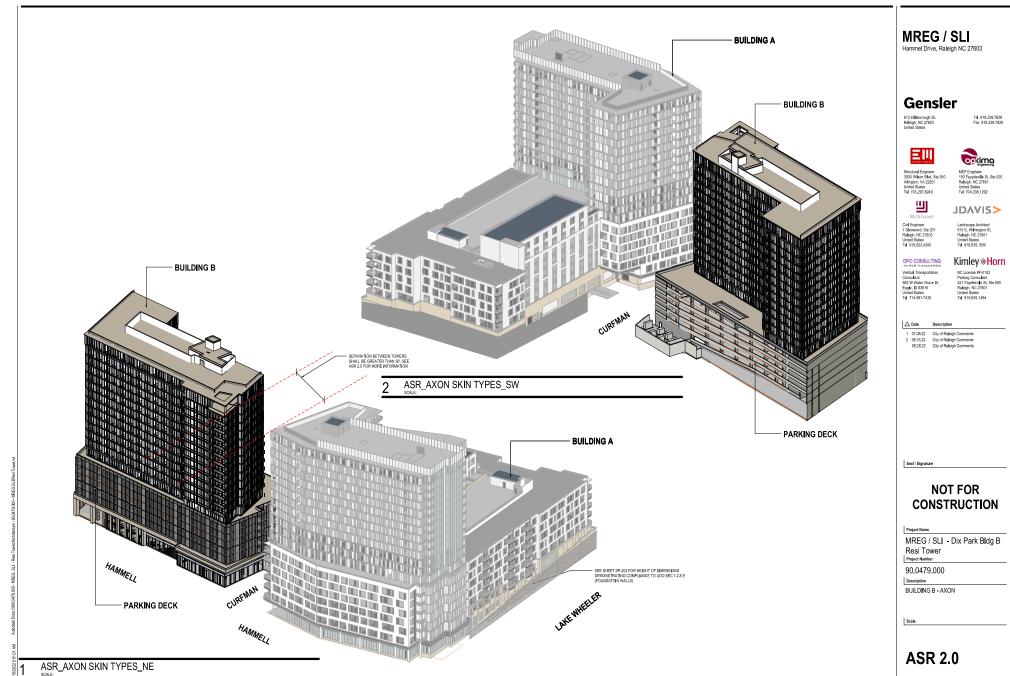

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MREG / SLI Hammel Drive, Raleigh NC 27603

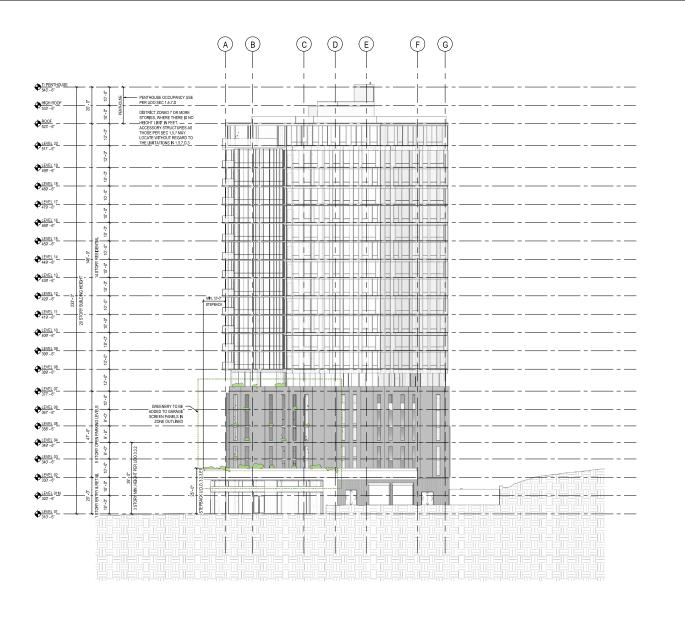Gensler

613 Hillsborough St Raleigh, NC 27603 United States

LEVEL 20 TOTAL WALL AREA = 1,300 SF (100°-0" X 12°-0") LEVEL 20 TRANSPARENT AREA = 832 SF (69°-0" X 12°-0") LEVEL 20 TRANSPARENCY % = 64% (20% REQUIRED)

LEVEL 19 TOTAL WALL AREA = 993 SF (82-9" X 12-0") LEVEL 19 TRANSPARENT AREA = 546 SF (45-6" X 12-0") LEVEL 19 TRANSPARENCY % = 55% (20% REQUIRED)

LEVEL 18 TOTAL WALL AREA = 827 SF (82-9" X 10"-0")
LEVEL 18 TRANSPARENT AREA = 446 SF (44-7" X 10"-0")
LEVEL 18 TRANSPARENCY % = 54% (20% REQUIRED)

LEVEL 17 TOTAL WALL AREA = 827 SF (82'-9" X 10'-0")
LEVEL 17 TRANSPARENT AREA = 446 SF (44'-7" X 10'-0")
LEVEL 17 TRANSPARENCY % = 54% (20% REQUIRED)

LEVEL 16 TOTAL WALL AREA = 827 SF (82-9" X 10-0")
LEVEL 16 TRANSPARENT AREA = 446 SF (44"-7" X 10-0")
LEVEL 16 TRANSPARENCY % = 54% (20% REQUIRED)

LEVEL 15 TOTAL WALL AREA = 827 SF (82-9" X 10"-0")
LEVEL 15 TRANSPARENT AREA = 446 SF (44-7" X 10"-0")
LEVEL 15 TRANSPARENCY % = 54% (20% REQUIRED)

LEVEL 14 TOTAL WALL AREA = 827 SF (82-9" X 10-0")
LEVEL 14 TRANSPARENT AREA = 446 SF (44-7" X 10-0")
LEVEL 14 TRANSPARENCY % = 54% (20% REQUIRED)

LEVEL 13 TOTAL WALL AREA = 827 SF (82'9' X 10'-0')
LEVEL 13 TRANSPARENT AREA = 446 SF (44'-7' X 10'-0')
LEVEL 13 TRANSPARENCY % = 54% (20'% REQUIRED)

LEVEL 12 TOTAL WALL AREA = 827 SF (82'-9" X 10'-0")
LEVEL 12 TRANSPARENT AREA = 446 SF (44'-7" X 10'-0")
LEVEL 12 TRANSPARENCY % = 54% (20% REQUIRED)

LEVEL 11 TOTAL WALL AREA = 827 SF (82-9" X 10-0")
LEVEL 11 TRANSPARENT AREA = 446 SF (44"-7" X 10-0")
LEVEL 11 TRANSPARENCY % = 54% (20% REQUIRED)

LEVEL 10 TOTAL WALL AREA = 827 SF (82-9" X 10'-0")
LEVEL 10 TRANSPARENT AREA = 446 SF (44'-7" X 10'-0")
LEVEL 10 TRANSPARENCY % = 54% (20% REQUIRED)

LEVEL 08 TOTAL WALL AREA = 827 SF (82-9" X 10"-0")
LEVEL 08 TRANSPARENT AREA = 446 SF (44"-7" X 10"-0")
LEVEL 08 TRANSPARENCY % = 54% (20% REQUIRED)

LEVEL 07 TOTAL WALL AREA LEVEL 07 TRANSPARENT AREA = 621 SF (51° 9" X 12° 0") LEVEL 07 TRANSPARENCY % = 64% (20% REQUIRED) (UDO 1.5.9 8 3.2.6)

GLASS SHALL BE CONSIDERED TRANSPARENT WHERE IT HAS TRANSPARENCY HIGHER THAN 80% AND EXTERNAL REFLECTANCE OF LESS THAN 15%, GLASS ON UPPER STORIES MAY HAVE ANY LEVEL OF TRANSPARENCY AND EXTERNAL REFLECTANCE, (UDO 1.5.9. B.4

LEVEL 01 TOTAL WALL AREA (AGP TO 12'0"

LEVEL 01 TRANSPARENT AREA LEVEL 01 TRANSPARENCY % TRANSPARENCY % REQUIRED UDO 1.5.9 & 3.2.6

LEVEL 1 TRANSPARENT AREA

(3'0" - 8'0" ABOVE AVERAGE GRADE) 50% OF REQUIRED TRANSPARENCY,

= 1,498 SF (74'-11" X 20'-0") = 749 SF (37'-5" X 20'-0") = 50% = 50% (749 SF)

= 419 SF (83'-10" X 5'-0")

= 374 SF (UDO 1.5.9.B.1)



cima

Structural Engineer 3000 Wilson Blvd, Ste 350 Arlington, VA 22201 United States Tel 703.297.8249

MEP Engineer 150 Fayetteville St, Ste 520 Raleigh, NC 27601 United States Tel 704.338.1292 Ш JDAVIS>

Civil Engineer 1 Glenwood, Ste 201 Raleigh, NC 27603 United States Tel 919.823.4300

Landscape Architect 510 S. Wilmington St. Raleigh, NC 27601 United States Tel 919.835.1500

Kimley » Horn Vertical Transportation Consultant 582 W Water Grove Dr Eagle, ID 83616 United States Tel 714.981.7435

NC License #F-0102 Parking Consultant 421 Fayetteville St, Ste 600 Rateigh, NC 27601 United States Tel 919.835.1494

△ Date Description

05.18.22 ASR Submission

1 07.08.22 City of Rateigh Comments 2 08.16.22 City of Rateigh Comments 09.28.22 City of Rateigh Comments

NOT FOR CONSTRUCTION

Project Name

MREG / SLI - Dix Park Bldg B Resi Tower Project Number

90.0479.000

Description

BUILDING B - NORTH ELEVATION

Scale

1/16" = 1'-0"

ASR 2.1

ASR - NORTH ELEVATION

MREG / SLI

Hammel Drive, Raleigh NC 27603

Gensler

613 Hillsborough St Raleigh, NC 27603 United States



op time

Structural Engineer 3000 Wilson Blvd, Sie 350 Arlington, VA 22201 United States Tel. 703.297.8249

MEP Engineering
150 Fayettering St., Ste 520
Raleigh, NC 27601
United States
Tel 704.338.1292



Civil Engineer 1 Glenwood, Ste 201 Raleigh, NC 27603 United States Tel 919.823.4300 Landscape Architect 510 S. Wilmington St. Raleigh, NC 27601 United States Tel. 919.835.1500

Vertical Transportation Consultant 582 W Water Grove Dr Eagle, ID 83616 United States Tel 714.981.7435

Kimley»Horn NC License #F-0102 Parking Consultant 421 Fayetteville St, Ste 600 Raleigh, NC 27601 United States Tel 919.835.1494

△ Date Description

05.18.22 ASR Submission 1 07.08.22 City of Rateigh Comments 2 08.16.22 City of Rateigh Comments 09.28.22 City of Rateigh Comments

NOT FOR CONSTRUCTION

Project Name

MREG / SLI - Dix Park Bldg B Resi Tower Project Number

90.0479.000

Description

BUILDING B - WEST ELEVATION

Scale

1/16" = 1'-0"

ASR 2.2

ASR - WEST ELEVATION

MREG / SLI

Hammel Drive, Raleigh NC 27603

Gensler

613 Hillsborough St Raleigh, NC 27603 United States



cima MEP Engineer 150 Fayetteville St, Ste 520 Raleigh, NC 27601 United States Tel 704.338.1292

Structural Engineer 3000 Wilson Blvd, Sie 350 Arlington, VA 22201 United States Tel. 703.297.8249



Civil Engineer 1 Glenwood, Ste 201 Raleigh, NC 27603 United States Tel 919.823.4300

Landscape Architect 510 S. Wilmington St. Raleigh, NC 27601 United States Tel. 919.835.1500

Vertical Transportation Consultant 582 W Water Grove Dr Eagle, ID 83616 United States Tel 714.981.7435

Kimley » Horn NC License #F-0102 Parking Consultant 421 Fayetteville St, Ste 600 Raleigh, NC 27601 United States Tel 919.835.1494

△ Date Description

05.18.22 ASR Submission
1 07.08.22 City of Raleigh Comments
2 08.16.22 City of Raleigh Comments
09.28.22 City of Raleigh Comments

Seal / Signature

NOT FOR CONSTRUCTION

Project Name

MREG / SLI - Dix Park Bldg B Resi Tower Project Number

90.0479.000

Description

BUILDING B - SOUTH ELEVATION

Scale

1/16" = 1'-0"

ASR 2.3

ASR - SOUTH ELEVATION

ASR 2.4

ASR 2.5