# **Administrative Site Review Application**



Development Services Customer Service Center • One Exchange Plaza, Suite 400 | Raleigh, NC 27601 | 919-996-2495

This form is required when submitting site plans as referenced in Unified Development Ordinance (UDO) Section 10.2.8. Please check the appropriate building types and include the plan checklist document when submitting.

Office Use On	ıly: Transactio	n#: FSR-00	52-201	Planning Coordinator:		
Building Type				Site Transaction History		
	Detached	$\square$	General	Subdivision transaction #:		
	Attached	$   \overline{\mathcal{L}} $	Mixed use	Sketch transaction #: Certificate of Appropriateness #:		
	Apartment		Open lot	· · · · · · · · · · · · · · · · · · ·		
	Townhouse		Civic	Zoning Case #: Administrative Alternate #:		
		(	GENERAL IN	IFORMATION		
Development r	name:SOHI					
Inside City limi	ts? 🔽 Yes [	No				
Property addre	ess(es): 2701 :	S. Wilmington S	St. Raleigh,	NC 27603		
Site P.I.N.(s):1	702565746	,	***************************************			
Demolition of buildings, par	existing buil- king lot, ame	ding (restauran	t/bar) and p landscaping	expansions, and change of use. parking lot. Construction of four (4) two-story g. Uses in the buildings are restaurant, retail, office, s is 24,945 sf.		
•	-	eloper Contact N				
NOTE: please attach purchase agreement when submitting this form.						
Company:SOHI LLC Title:						
<u> </u>		St. Unit 2808 Ra				
Phone #:919-334-8976 Email:davidcmeeker@gmail.com						
Applicant Nam	ie:Graham Si	mith				
Company:Site	Company:Site Collaborative Address:821 Wake Forest Rd. Raleigh, NC 27604					
Phone #:919.	805.3586		m@sitecollaborative.com			

	PE + SITE DATE TABLE all developments)				
SITE DATA	BUILDING DATA				
Zoning district (if more than one, please provide the acreage of each):	Existing gross floor area (not to be demolished):				
CX-3	Existing gross floor area to be demolished: 5,461 sf				
Gross site acreage:1.36 AC	New gross floor area:24,945 sf				
# of parking spaces required:66	Total sf gross (to remain and new):24,945 sf				
# of parking spaces proposed:66	Proposed # of buildings:4				
Overlay District (if applicable):N/A	Proposed # of stories for each: 2				
Existing use (UDO 6.1.4):Restaurant/Bar					
Proposed use (UDO 6.1.4):Restaurant, Office, Reta	aille				
STORMWAT	ER INFORMATION				
Existing Impervious Surface: Acres: 1.06 Square Feet: 46,200	Proposed Impervious Surface:  Acres: 1.0 Square Feet: 43,580				
Is this a flood hazard area? Yes No If yes, please provide: Alluvial soils: Flood stu FEMA Map Panel #:					
Neuse River Buffer Yes No	Wetlands Yes No				
RESIDENTIAL	DEVELOPMENTS				
Total # of dwelling units:	Total # of hotel units:				
# of bedroom units: 1br: 2br: 3br:	4br or more:				
# of lots:	Is your project a cottage court? Yes No				
SIGNATI	URE BLOCK				
In filing this plan as the property owner(s), I/we do here executors, administrators, successors, and assigns join all dedications as shown on this proposed development	ntly and severally to construct all improvements and make				
I hereby designate Graham Smith	to serve as my agent regarding				
this application, to receive and response to administrat represent me in any public meeting regarding this appl					
I/we have read, acknowledge, and affirm that this proje with the proposed development use. I acknowledge the submittal policy, which states applications will expire at					
Signature: Signature:	Date:7-25-19				
Printed Name:David Meeker					

# **Administrative Site Review Checklist**



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Use this checklist as a guide for Administrative Site Review submittals requirements.

This checklist must be submitted with your application.

## **MAILED NOTIFICATION REQUIREMENTS**

Mailed notice is required for projects that:

- 1. Include new buildings greater that 25,000 square feet, or additions that represent a 10% increase in building area or 25,000 square feet (whichever is greater), AND;
- 2. The subject property is located within 100 feet of a property that is zoned: R-1, R-2, R-4, R-6, R-10 If your project requires mailed notice, click here to download the letter template and other helpful information.

Please check one of the following:

Yes, my project meets the mailed notification requirement and my letters are provided with this application.

The mailed notification is not applicable for my project.

GENERAL REQUIREMENTS	APPL	CANT	CITY STAFF		FF
Applicant to provide the following plan information:	YES	N/A	YES	NO	N/A
1. Cover sheet and/or second sheet: include project name and location; site data table (include Property Identification Numbers (PINs), Zoning, Overlay District(s), Frontage Type, Current Use(s), Proposed Use(s), Building Square Footage(s), residential density and unit data, existing and proposed parking calculations); general notes; sheet index and legend defining symbols with north arrow; contact information for owner, applicant, and all consultants; vicinity map no smaller than 1"=500" and no larger than 1"=1000"; and adopted zoning conditions (if any)	, X				
2. Existing conditions sheet: including, but not limited to - graphic scale; site size with meets and bounds; setbacks/ build-to lines; existing structures; utilities and easements; topography, infrastructure (adjacent streets with names and r/w width, sidewalks, water, and sewer); built improvements (parking, driveways, alleys); and vegetation	対				
3. Demolition plan: Clearly indicate items to be removed	X				
4. Proposed site plan: including but not limited to – north arrow and graphic scale; show and distinguish between existing and proposed conditions (structures, streets, driveways, parking, storage areas, service areas, etc.); setback/build-to lines; proposed property lines streetscape; mechanical equipment (HVAC, generators, etc.); sidewalks, walkways, trails; solid waste facilities; parking and parking calculations (UDO Section 7.1.2); amenity area (UDO Section 1.5.3.) open space and/or greenways; transition protective yard (UDO Section 7.2.4); Site Data (Square footages for proposed and existing uses; Parking calculations; amenity area calculations; Setback/Build-to; transitional protective yard type (UDO Section 7.2.4.B.)	, A				

Please continue to page two >

GENERAL REQUIREMENTS  Applicant to provide the following plan information:		APPLICANT		CITY STAFF		
		N/A	YES	NO	N/A	
5. Proposed grading plan: including but not limited to - Limits of land disturbance; grading; structural improvements with finished floor elevations; stream buffers with labels; labeled impervious surfaces (and calculations); tree protection fencing information; retaining walls with top and bottom of wall; stormwater ponds, bioretention facilities, etc.	×			·		
6. Proposed stormwater plan: include preliminary stormwater quantity and quality summary and calculations package. If not required, provide notes indicating such and reference UDO section on front cover		×				
7. <b>Proposed Utility Plan:</b> All utilities (shown underground); above ground utilities and equipment with required screening ( <i>UDO Section 7.2.5.D.</i> ); include Fire	×		되			
8. <b>Lighting Plan:</b> Pole mounted fixture locations and details (with height labeled to top of fixture; building mounted fixture locations; graphics and notes conveying compliance with UDO Section 7.4		×		D'	- <u>1</u>	
9. Proposed tree conservation plan: for secondary tree conservation areas, include two copies of the tree cover report completed by a certified arborist, NC licensed landscape architect, or NC registered forester. If not required, provide notes indicating such and reference UDO section on front cover		×		4		
10. Proposed landscape plan: (UDO Section 7.2) including but not limited to – existing vegetation to remain; proposed landscaping meeting minimum size and species mixing requirements; plant list; label yard types; show and label parking lot landscaping (UDO Section 7.1.7.) include existing and/or proposed parking lot light fixtures	×		Y			
11. Architectural Elevations showing existing and/or proposed building height per UDO Section 1.5.7., 2.3, 3.2., and 3.3., transparency per UDO Section 1.5.9., 2.3 and 3.2, and blank wall area per UDO Section 1.5.10.	×					

NOTE: Revisions to previously approved site plans must contain the following minimum information:

REQUIREMENTS FOR REVISIONS TO EXISTING SITE PLANS Applicant to provide the following plan information:		CANT	CITY STAFF		
		N/A	YES	NO	N/A
Provide documentation showing Development Services Staff have approved the proposed site plan changes as a revision					
2. Provide narrative of the proposed revisions on the cover page and modify the project name to include revision					
List date of previously approved site plan.					
<ol> <li>Cloud areas of proposed change on all applicable sheets, and provide a legend specifying the proposed changes on all applicable sheets</li> </ol>					
<ol> <li>Provide updated site data table including building square footages, parking calculations, etc.</li> </ol>					
Provide documented history of impervious surfaces with dates				Ш	Ш

# SOHI

# ADMINISTRATIVE SITE REVIEW

CITY OF RALEIGH TRANSACTION #: \_\_\_\_\_ CITY OF RALEIGH CASE #: \_\_\_\_\_

**Administrative Site Review Application** 

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This form is required when submitting site plans as referenced in Unified Development Ordinance (UDO) Section 10.2.8. Please check the appropriate building types and include the plan checklist document when submitting.

**Site Transaction History** 

Certificate of Appropriateness #:

**DEVELOPMENT SERVICES** 


Office Use Only: Transaction #:

Townhouse

# of bedroom units: 1br:

2br:

**Building Type** 

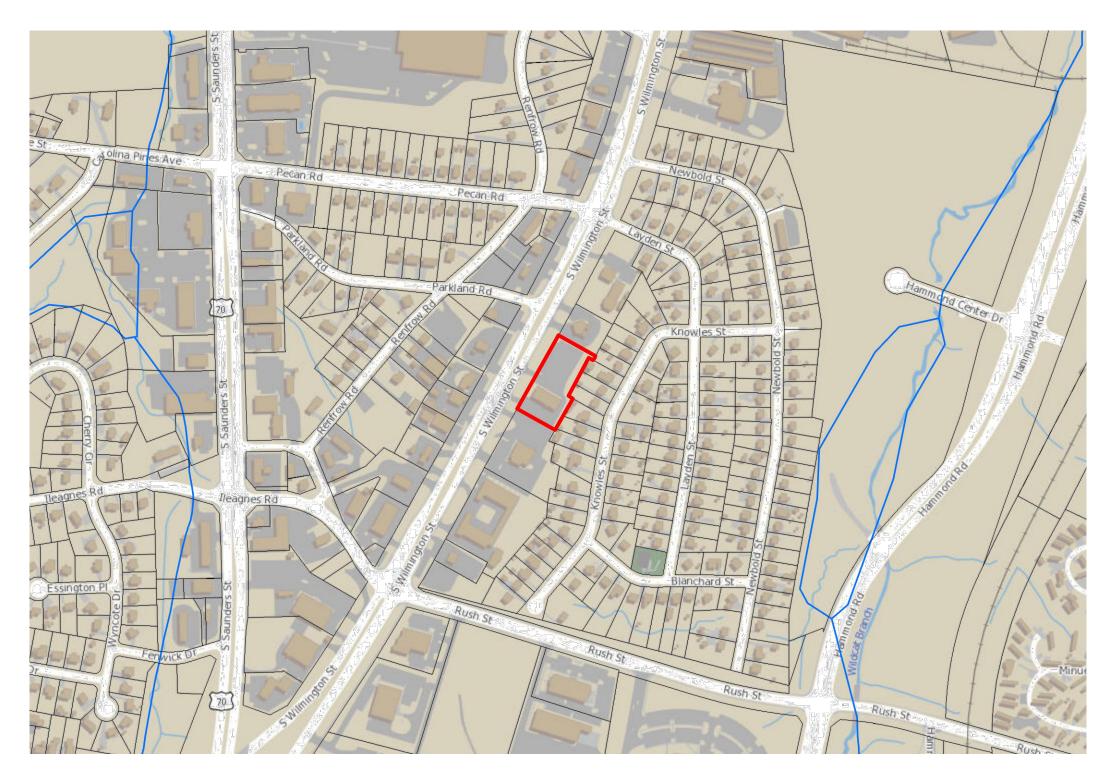

# **VICINITY MAP**

# **SOLID WASTE SERVICES:**

1. SOLID WASTE ON SITE TO UTILIZE PRIVATE SERVICE.

2. ALL ON-SITE AMENITIES RELATED TO GARBAGE DISPOSAL INCLUDING - BUT NOT LIMITED TO - DUMPSTER ENCLOSURE, PAVEMENT, AND CURB RADII SHALL COMPLY WITH THE CITY'S SOLID WASTE DESIGN MANUAL. REFER TO SHEET L200

**STORMWATER** 

THIS PROJECT DOES NOT INCREASE OVERALL IMPERVIOUS SURFACE AREA FROM EXISTING CONDITIONS AND THEREFORE IS EXEMPT FROM REQUIRED STORMWATER CONTROLS IN ACCORDANCE WITH CITY OF RALEIGH UDO 9.2.2.A.3.C

TREE CONSERVATION

LIGHTING PLAN

1. THIS PROJECT DOES NOT HAVE ANY ADDITIONAL PARKING LOT LIGHTING AT THIS TIME. LIGHTING FOR THE BUILDING WILL BE PROVIDED AT BUILDING PERMITS IN ACCORDANCE WITH SEC. 7.4

1. THE LOT SIZE IS UNDER 2 ACRES AND THEREFORE IS NOT REQUIRED TO

PROVIDE A TREE CONSERVATION PLAN PER SEC. 9.1.2.

	SHEET INDEX		
COV	COVER		
L100	EXISTING CONDITIONS		
L101	DEMOLITION PLAN		
L200	LAYOUT & MATERIALS PLAN		
L201	SITE DETAILS		
L202	SITE DETAILS		
L203	SITE DETAILS		
L300	GRADING PLAN		
L400	PLANTING PLAN		
L401	PLANTING NOTES & DETAILS		
C700	UTILITY PLAN		
A1	ARCHITECTURAL ELEVATIONS		

SCALE: 1" =400'

SITI	SITE DATA SUMMARY		
PROJECT NAME	SOHI		
EXISTING STREET ADDRESS	2701 S. WILMNGTON ST., RALEIGH, NC 27603		
LOT AREA	1.36 ACRES		
CURRENT ZONING	CX-3		
OVERLAY DISTRICT(S)	NONE		
PARCEL NUMBER	1702565746		
REAL ID NUMBER	0005710		
DEED BOOK / DEED PAGE	BM 017422 / PG 000492		
EXISTING GROSS BUILDING AREA	5,461 SF		
EXISTING BUILDING USE	RESTAURANT		
PROPOSED GROSS BUILDING AREA	25,000 SF		
PROPOSED BUILDING USE	MIXED USE		
EXISTING IMPERVIOUS AREA	46,200 SF		
PROPOSED IMPERVIOUS AREA	43,580 SF		
NET CHANGE IN IMPERVIOUS AREA	-2,620 SF		
TOTAL AREA DISTURBED	65,650 SF (1.51) AC		

# GENERAL INFORMATION Development name:SOHI Inside City limits? X Yes No Property address(es): 2701 S. Wilmington St. Raleigh, NC 27603 Site P.I.N.(s):1702565746 Please describe the scope of work. Include any additions, expansions, and change of use. Demolition of existing building (restaurant/bar) and parking lot. Construction of four (4) two-story buildings, parking lot, amenity area, and landscaping. Uses in the buildings are restaurant, retail, office, and light manufacturing. Gross area for the buildings is 24,945 sf. Current Property Owner/Developer Contact Name: NOTE: please attach purchase agreement when submitting this form. Company:SOHI LLC Address:301 Fayetteville St. Unit 2808 Raleigh, NC 27601 Phone #:919-334-8976 Email:davidcmeeker@gmail.com Applicant Name:Graham Smith Company:Site Collaborative Address:821 Wake Forest Rd. Raleigh, NC 27604 Email:graham@sitecollaborative.com Phone #:919.805.3586

DEVELOPMENT TYPE + SITE DATE TABLE (Applicable to all developments)				
SITE DATA	BUILDING DATA			
Zoning district (if more than one, please provide the acreage of each):	Existing gross floor area (not to be demolished):			
CX-3	Existing gross floor area to be demolished: 5,461 sf			
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STORMWATER	INFORMATION	
Existing Impervious Surface:  Acres: 1.06 Square Feet: 46,200	Proposed Impervious Surface: Acres: 1.0 Square Feet:	43,580
Is this a flood hazard area? Yes X No If yes, please provide: Alluvial soils: Flood stu  FEMA Map Panel #:		
FEMA Map Panel #: Neuse River Buffer	Wetlands Yes	] No
RESIDENTIAL D	EVELOPMENTS	
Total # of dwelling units:  Total # of hotel units:		

3br:

# of lots:	Is your project a cottage court?  Yes No
	SIGNATURE BLOCK
executors, administrators, success	wner(s), I/we do hereby agree and firmly bind ourselves, my/our heirs, sors, and assigns jointly and severally to construct all improvements and make roposed development plan as approved by the City of Raleigh.
I hereby designate Graham Smit this application, to receive and res represent me in any public meeting	sponse to administrative comments, to resubmit plans on my behalf, and to
with the proposed development us	d affirm that this project is conforming to all application requirements applicable se. I acknowledge that this application is subject to the filing calendar and lications will expire after 180 days of inactivity.
Signature:	Date:7-25-19
Printed Name:David Meeker	·

4br or more:

# CONTACT INFORMATION

PROPERTY OWNER

SOHI, LLC

301 FAYETTEVILLE ST. UNIT 2808

RALEIGH, NC 27601 CONTACT:DAVID MEEKER PHONE: 919.334.8976

EMAIL: DAVIDCMEEKER@GMAIL.COM

**ARCHITECT** 

MAURER ARCHITECTURE 115.5 E. HARGETT ST. SUITE 300

RALEIGH, NC 27601

CONTACT: MIKE MORRISON

PHONE: 919.829.4969

EMAIL: MIKE@MAURERARCHITECTURE.COM

LANDSCAPE ARCHITECT

SITE COLLABORATIVE, INC.

821 WAKE FOREST RD

RALEIGH, NC 27604

CONTACT: GRAHAM H. SMITH

PHONE: 919.805.3586

EMAIL: GRAHAM@SITECOLLABORATIVE.COM

CIVIL ENGINEER

GROUNDED ENGINEERING

P.O. BOX 37132 RALEIGH, NC 27627 CONTACT: SEAN DOLLE

PHONE: 919.438.3694

EMAIL: SEAN@GROUNDED-ENGINEERING.COM

821 Wake Forest Road Raleigh, NC 27604 | 919.805.3586

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without written authorization of Site

MINGTON S(S)

PROJECT NUMBER: 19022

PROJECT PHASE: ADMINISTRATIVE

SITE REVIEW

07.25.2019

SHEET TITLE: COVER

SHEET NUMBER:

COV



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> 7603  $\sim$ S EIGH STRE MINGTON MSOHI, 2701

PROJECT NUMBER: 19022


PROJECT PHASE: ADMINISTRATIVE


SITE REVIEW

DATE: 07.25.2019

SHEET TITLE: EXISTING CONDITIONS

SHEET NUMBER:

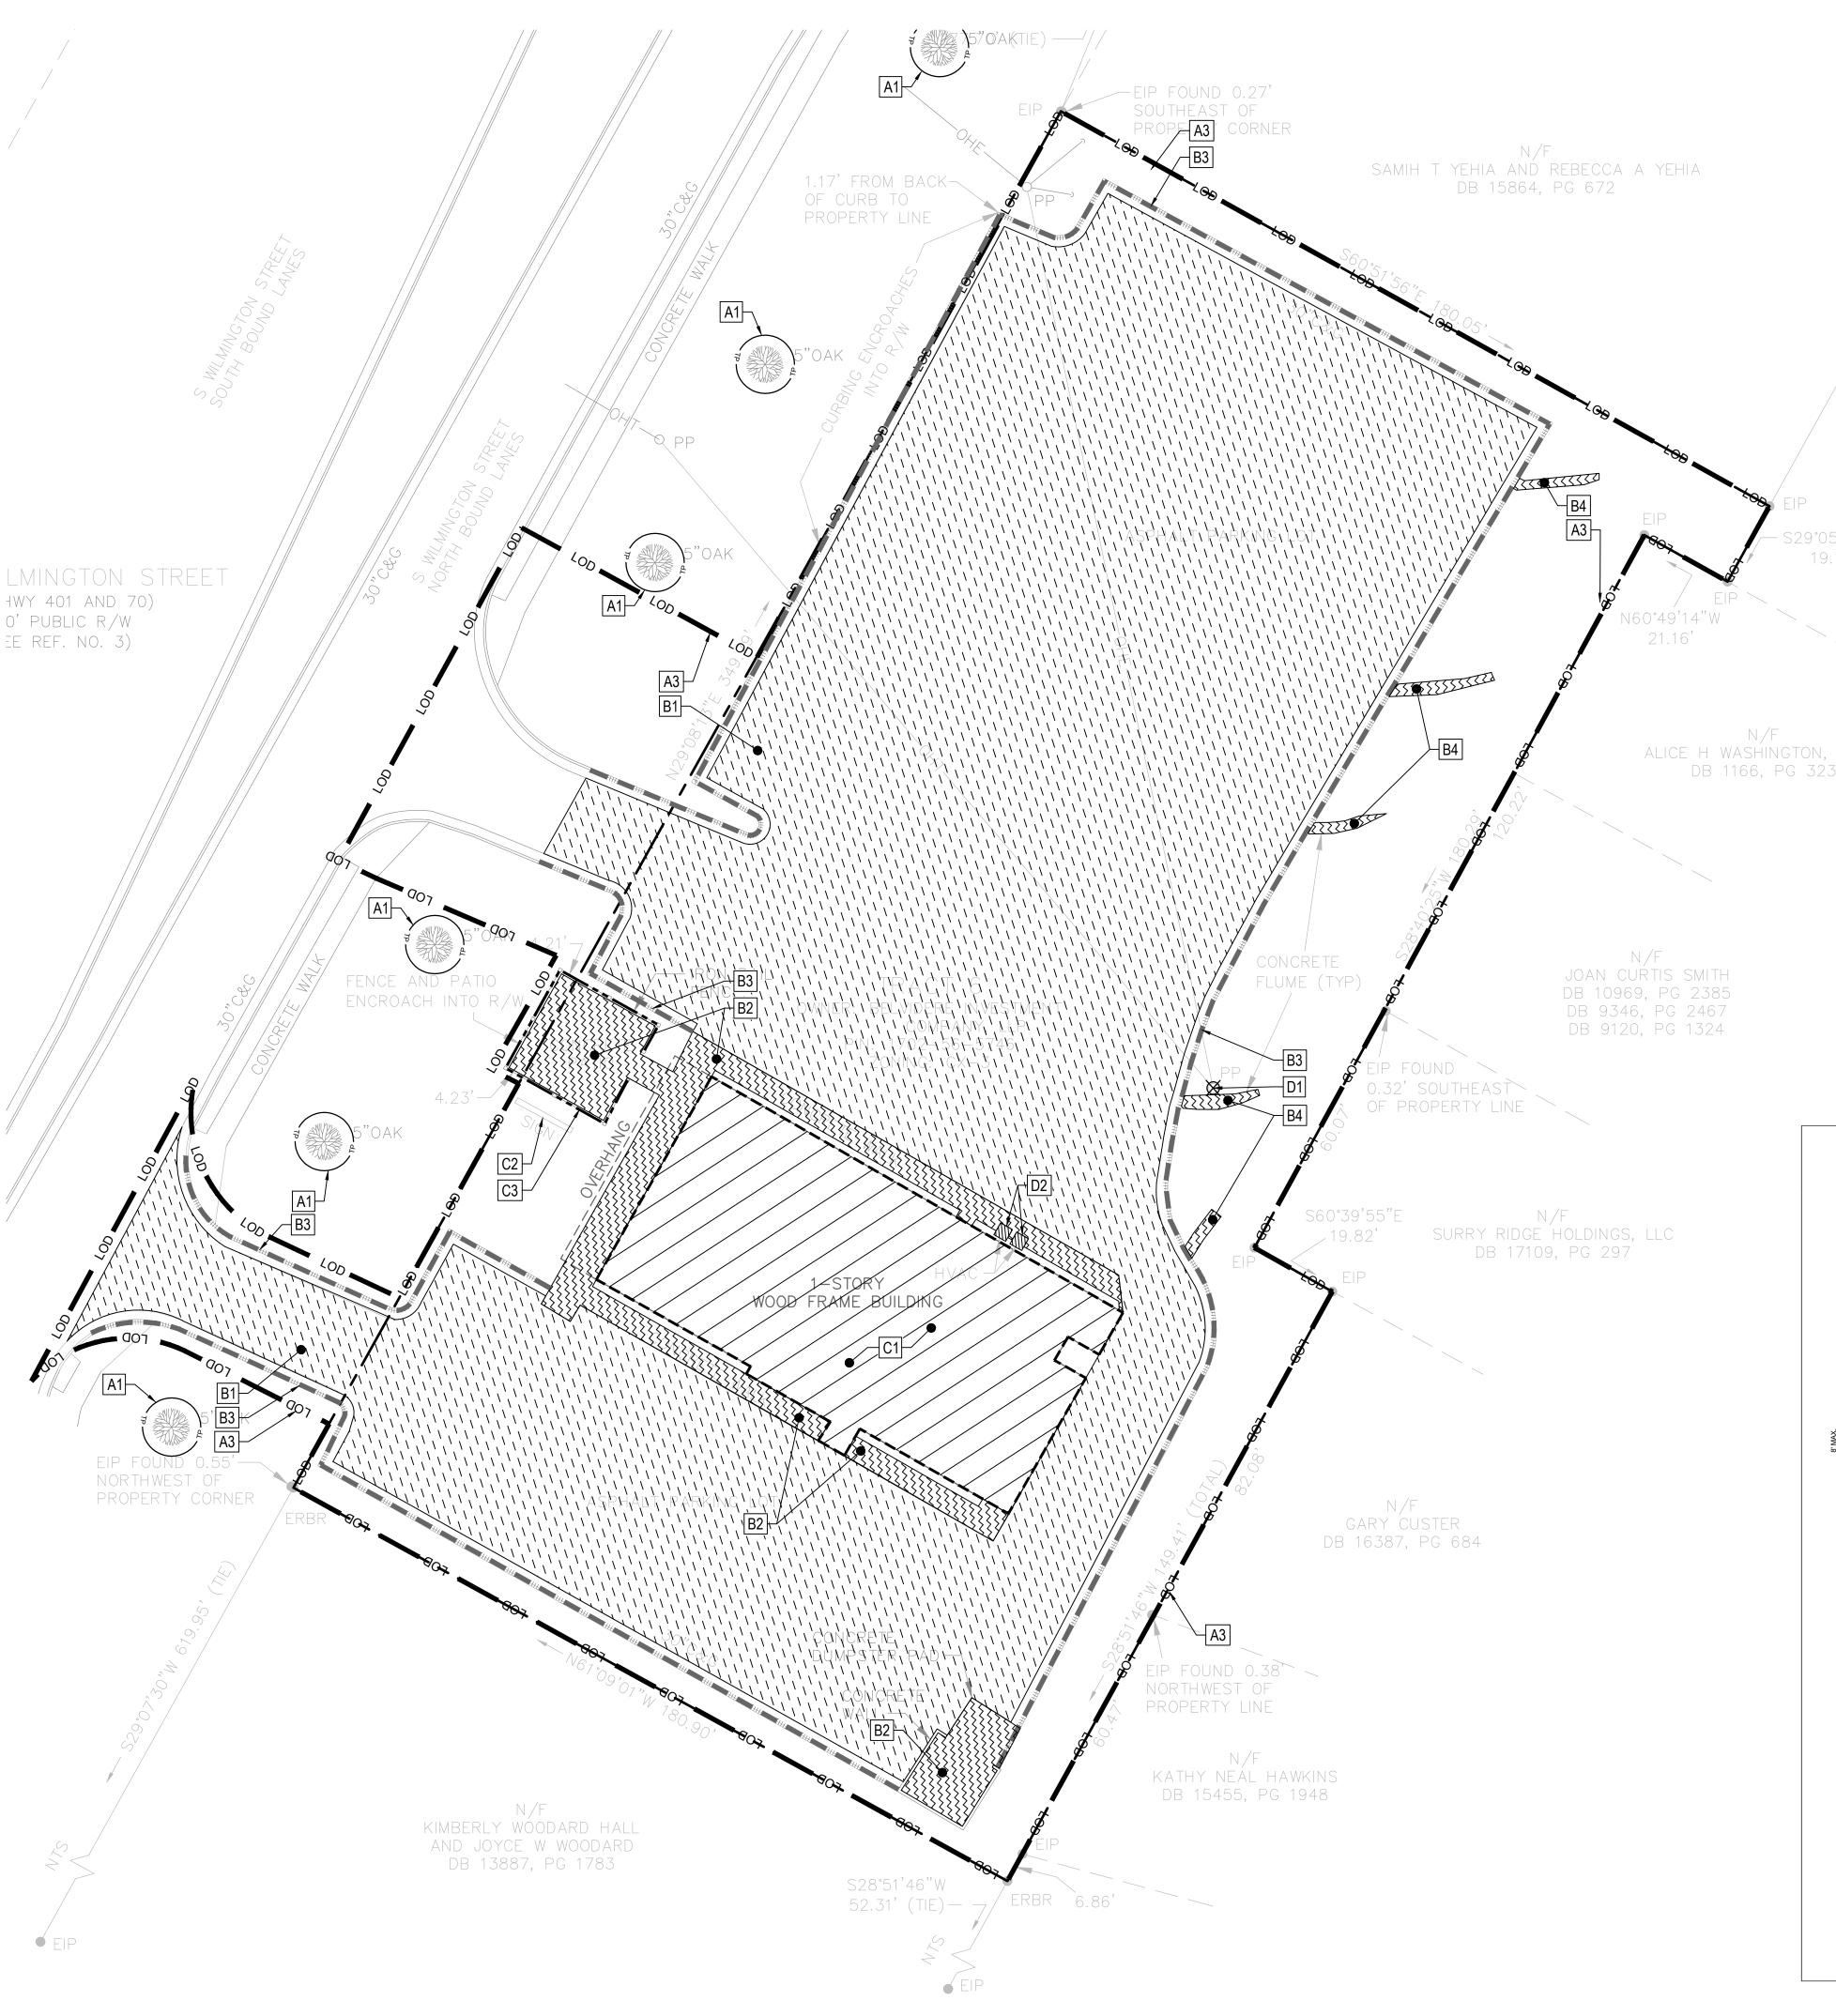

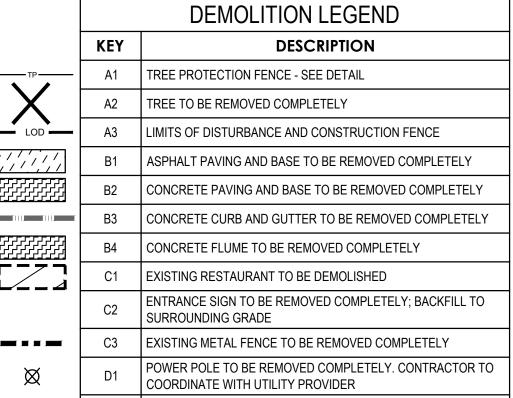

# DRY UTILITY BOX/DEVICE TO BE REMOVED COMPLETELY -

CONTRACTOR TO COORDINATE WITH UTILITY PROVIDER

4, 3, 4, 3, 4, 4, 3, 4, 3, 4, OTES:
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SIGHS ARE 1

> **CITY OF RALEIGH** STANDARD DETAIL

> > STANDARD TREE PROTECTION DETAIL

> > > TPP-01

# **DEMOLITION NOTES**

- 1. THE CONTRACTOR SHALL NOTIFY THE N.C. ONE CALL CENTER AT 811 OR 1-800-632-4949 PRIOR TO STARTING
- 2. THE CONTRACTOR SHALL NOTIFY THE LOCAL GOVERNING PUBLIC UTILITIES DEPARTMENT PRIOR TO STARTING WORK.
- 3. ALL DEMOLITION, AND ANY SUBSEQUENT CONSTRUCTION, SHALL BE PERFORMED IN ACCORDANCE WITH THESE PLANS AND SPECIFICATIONS SET FORTH AND APPROVED BY THE LOCAL GOVERNING MUNICIPALITY OR THE STATE. THE CONTRACTOR IS RESPONSIBLE FOR OBTAINING ALL REQUIRED PERMITS.
- 4. THE CONTRACTOR SHALL NOT MAKE ANY LANE CLOSURES OR CHANGES TO THE EXISTING TRAVEL PATTERNS ON ANY PUBLIC STREET WITHOUT PRIOR APPROVAL FROM THE LOCAL GOVERNING MUNICIPALITY TRANSPORTATION DEPARTMENT AND/OR STATE TRANSPORTATION DEPARTMENT.
- 5. LANE CLOSURE, TRAFFIC CONTROL PLAN, OR PEDESTRIAN CONTROL PLAN TO BE COORDINATED WITH APPROPRIATE STAFF OF THE LOCAL GOVERNING MUNICIPALITY AND/OR STATE DEPARTMENT OF TRANSPORTATION PRIOR TO ANY CONSTRUCTION IN PUBLIC RIGHT-OF-WAY.
- THE CONTRACTOR IS RESPONSIBLE FOR CONFORMING TO ALL LOCAL, STATE AND FEDERAL REQUIREMENTS REGARDING REMOVAL AND DISPOSAL OF MATERIALS AND
- 7. CONTRACTOR SHALL REFER TO CIVIL SHEETS FOR SANITARY SEWER AND WATER REMOVALS AND RELOCATIONS.
- 8. RELOCATION OF EXISTING UTILITIES TO BE COORDINATED WITH THE LOCAL UTILITY PROVIDER(S).
- 9. WHERE UTILITIES (TO BE REMOVED) IMPACT THE FOOTPRINT OF THE NEW BUILDING, CONTRACTÓR SHALL EXCAVATE AND REMOVE AN ADDITIONAL 2 FEET OF SOILS TO EITHER SIDE OF PIPE, AND 1 FOOT BELOW TO REMOVE UNSUITABLE SOILS, IF UNSUITABLE SOILS EXIST.
- 10. CLEANOUTS LOCATED IN AREAS OF DEMOLITION OR SUBSEQUENT CONSTRUCTION THAT ARE TO REMAIN, SHALL BE PROTECTED FROM DAMAGE AND RAISED TO FLUSH WITH NEW GRADE.
- 11. ELECTRICAL OR GAS UTILITY SERVICES TO BE REMOVED SHALL BE REMOVED AND RELOCATED (AS INDICATED) BY THE UTILITY PROVIDER. CONTRACTOR SHALL SCHEDULE AND COORDINATE THIS WORK WITH THE APPROPRIATE SERVICE PROVIDER. ALL SERVICES SHOULD BE RE-INSTALLED PRIOR TO THE INSTALLATION OF PAVEMENT, SIDEWALKS, CURB AND GUTTER, OR OTHER PERMANENT
- 12. REMOVE EXISTING CONCRETE (WHERE REQUESTED) TO FIRST COLD JOINT OR SAWCUT JOINT TO OBTAIN A CLEAN EDGE FOR NEW CONSTRUCTION. SAWCUT EXISTING ASPHALT DRIVE AT LIMITS OF NEW CURBING TO OBTAIN A CLEAN EDGE.
- 13. CONTRACTOR SHALL RETAIN AND STOCKPILE CONCRETE WHEELSTOPS WHICH ARE IN USEABLE CONDITION FOR RE-INSTALLATION AT THE END OF THE PROJECT.
- 14. CONTRACTOR SHALL RESTORE THE LAYDOWN AND STAGING AREA TO ORIGINAL CONDITIONS AND TO THE SATISFACTION OF THE OWNER, PRIOR TO DEMOBILIZATION AT THE CONCLUSION OF THE PROJECT.
- 15. CLEAN SOILS SHALL BE UTILIZED FOR BACKFILL. COMPACTION OF THESE SOILS PERFORMED IN ACCORDANCE WITH SPECIFICATIONS, GEOTECHNICAL REPORT, AND SITE PLAN.
- 16. ALL FENCING TO BE REMOVED SHALL BE REMOVED AT NEXT NEAREST POLE.
- 17. ALL GRAVEL TO BE REMOVED (SURFACE OR SUBSURFACE) SHALL BE STOCKPILED AND REUSED ON SITE WHERE
- 18. ALL ITEMS DESIGNATED TO BE REMOVED SHALL BE REMOVED COMPLETELY, INCLUDING ALL SUBGRADE MATERIALS DIRECTLY ASSOCIATED WITH ITEMS TO BE
- 19. ALL ITEMS DESIGNATED TO BE REMOVED SHALL BE DISPOSED OF LEGALLY OFFSITE UNLESS OTHERWISE NOTED ON THIS PLAN.
- 20. ALL TREES TO BE REMOVED SHALL BE GROUND DOWN TO A MINIMUM DEPTH OF 12" BELOW PROPOSED FINISH GRADE.
- 21. ALL TREE PROTECTION FENCING SHALL REMAIN IN PLACE DURING DEMOLITION AND CONSTRUCTION.



Raleigh, NC 27604 | 919.805.3586

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Collaborative Inc. The ideas and design Collaborative Inc. O0

> $\mathcal{C}$ MINGTON

S S 'S PROJECT NUMBER: 19022

PROJECT PHASE: ADMINISTRATIVE


SITE REVIEW DATE:

07.25.2019

SHEET TITLE:

**DEMOLITION** PLAN

SHEET NUMBER:

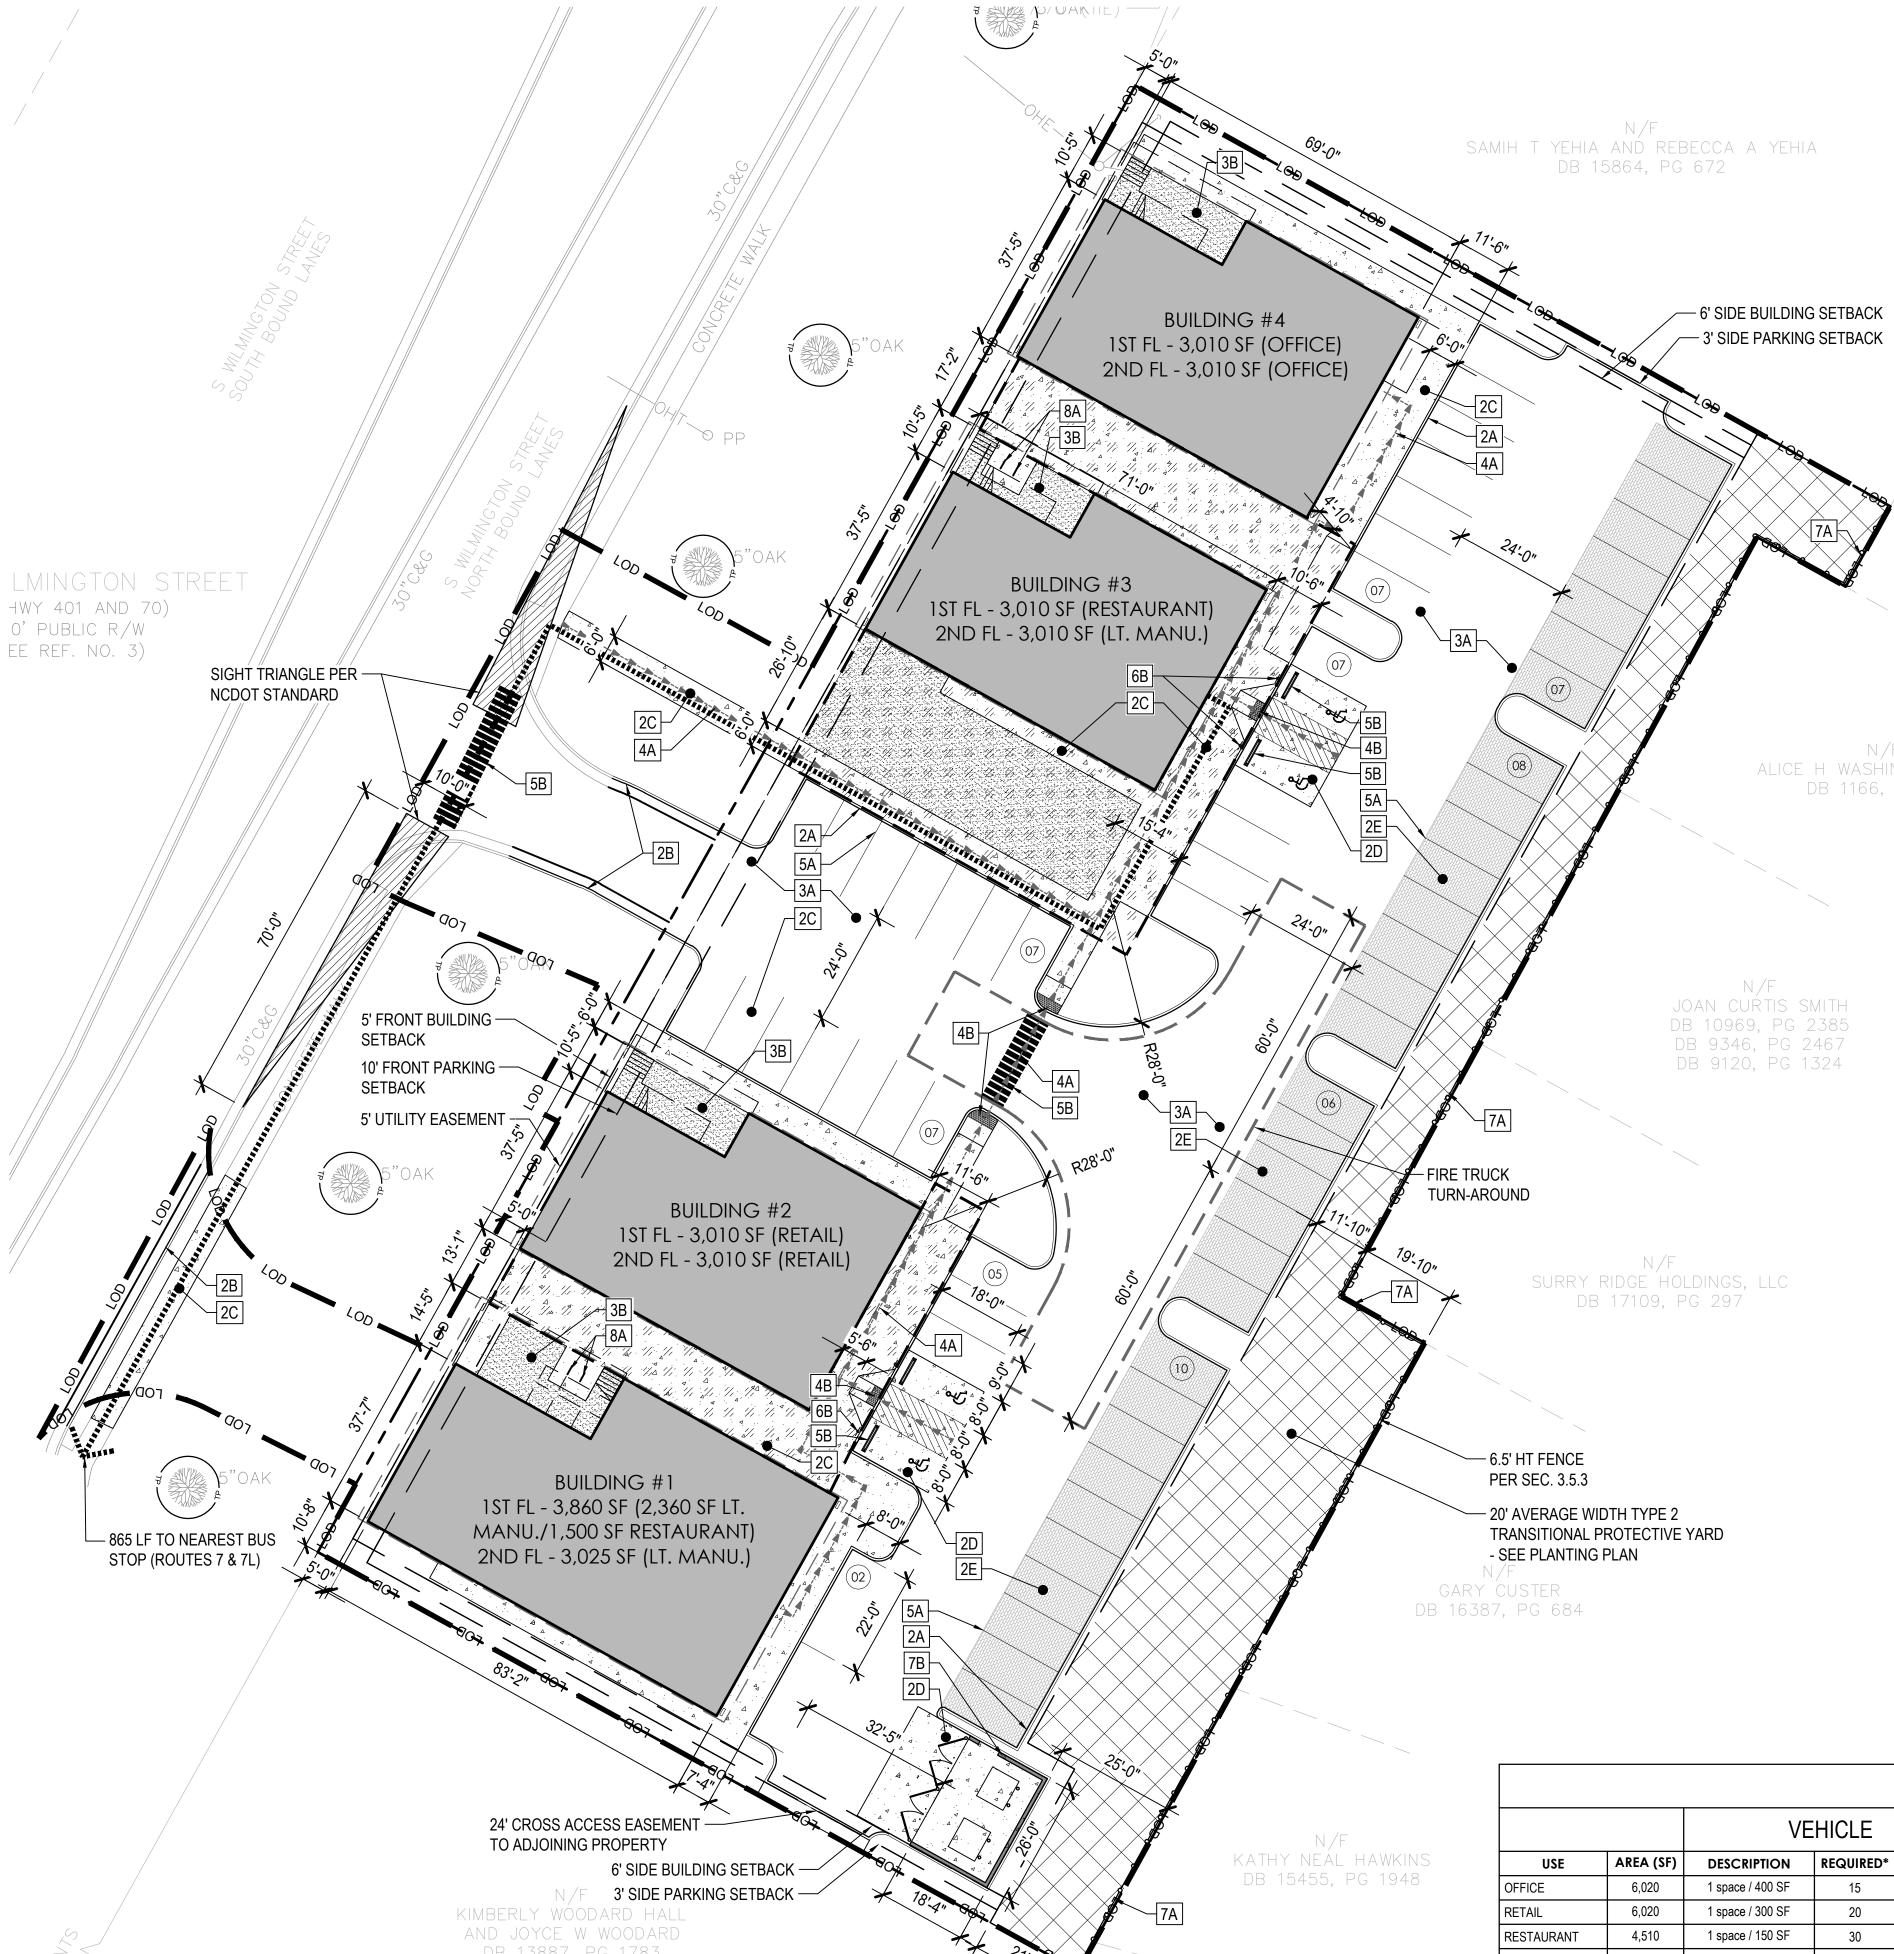

KEY	DESCRIPTION	DETAIL SHEE
1A	PLANTING BED - TRIPLE SHREDDED HARDWOOD MULCH - SEE PLANTING PLAN	
1B	LIMITS OF PLANTING BED - 4" DEEP 'V' SPADED EDGE - SEE PLANTING PLAN	
1C	BERMUDA SOD ON AMENDED SOIL. SEE PLANTING PLAN.	
2A	8" WIDE CONCRETE CURB (INSIDE SITE ONLY).	1/L20
2B	30" WIDE CONCRETE CURB & GUTTER PER CITY OF RALEIGH STANDARDS (INSIDE R.O.W ONLY).	T-10.26 L202
2C	4" THICK CONCRETE PAVING. SAWCUT EXISTING TO NEAREST CONTROL JOINT.	2/L20
2D	8" THICK CONCRETE PAVING. SAWCUT EXISTING TO NEAREST CONTROL JOINT.	2/L20
2E	VEHICLE-RATED PERMEABLE PAVERS. BELGARD AQUALINE SERIES, SINGLE PIECE HATTERAS COLOR. INSTALLED PER MANUFACTURERS SPECIFICATIONS.	5/L20
3A	HEAVY DUTY ASPHALT	6/L20
3B	CRUSHED GRANITE AGGREGATE WITH ALUMINUM EDGING	7/L20
4A	ACCESSIBLE ROUTE - 5% MAX. LONGITUDINAL SLOPE, 2% MAX. CROSS SLOPE	
4B	ACCESSIBLE CURB RAMP WITH WARNING DETECTION DEVICE.	T-20.01. L202
5A	4" WIDE PARKING STRIPE (TYP.) AS SHOWN ON PLAN.	
5B	6' WIDE CROSSWALK	
6A	ACCESSIBLE PARKING SIGN - PER MUTCD AND CITY OF RALEIGH STANDARD.	8/L20
6B	PRECAST CONCRETE WHEELSTOPS PER CITY OF RALEIGH STANDARDS.	9/L20
7A	6.5' HT. PRIVACY FENCE FOR TRANSITIONAL PROTECTIVE YARD - PER CITY OF RALEIGH STANDARDS AND MANUFACTURERS SPECIFICATION	4/L20
7B	DUMPSTER ENCLOSURE TO MATCH ARCHITECTURE - PER CITY OF RALEIGH STANDARDS.	10,11/L
8A	BIKE RACK - ANOVA FURNISHINGS MODEL CIRCLEBRS2. SURFACE MOUNTED INSTALLED PER MANUFACTURERS SPECIFICATIONS.	5/L20
	•	

AMENITY AREA REQUIREMENTS PERCENT | REQUIRED | PROPOSED ZONING | LOT AREA (SF) (SF) (SF) 5,929 6,230 59,292 10 CX-3

ACCESSIBLE PARKING					
TOTAL # OF SPACES REQUIRED PROVIDE					
66	3 (2 REGULAR + 1 VAN)	4 (VAN)			

PARKING										
		VEHICLE			BICYCLE (SHORT TERM)			BICYCLE (LONG TERM)**		
USE	AREA (SF)	DESCRIPTION	REQUIRED*	PROVIDED	DESCRIPTION	REQUIRED	PROVIDED	DESCRIPTION	REQUIRED	PROVIDED
OFFICE	6,020	1 space / 400 SF	15	15	1 space / 10,000 SF	1	1	1 space / 5,000 SF	1	2
RETAIL	6,020	1 space / 300 SF	20	20	1 space / 5,000 SF	1	2	NONE	0	0
RESTAURANT	4,510	1 space / 150 SF	30	30	1 space / 50,000 SF	1	1	1 space / 25,000 SF	1	1
LIGHT MANUFACTURING	8,395 (4,000 SF office)	1 space / 600 SF office + 1 space / 3,000 of additional indoor area	8	1	NONE	0	0	1 space / 40,000 SF	1	1
SUBTOTAL	24,945		73	66		3	4		3	4
REDUCTIONS		10%*	-7							
TOTAL	24,945		66	66	Min. 4 required	4	4	Min. 4 required	4	4

\* NOTE: REDUCTION OF 10% DUE TO PROXIMITY TO BUS ROUTES 7 & 7L PER SEC. 7.1.4.A

\*\* NOTE: BICYCLE RACKS LOCATED UNDERNEATH BUILDING STAIRWELL AND OVERHAND TO SATISFY CITY LONG-TERM BICYCLE PARKING REQUIREMENT.

GENERAL SITE NOTES					
1.	ALL CONSTRUCTION IN RIGHT-OF				
2.	SIDEWALKS ALONG RIGHT-OF-WA				

- F-WAY PER CITY OF RALEIGH STANDARD.
- /AY ARE PUBLIC AND MUST BE ACCESSIBLE TO PERSONS WHO ARE BLIND, HAVE LOW VISION AND PEOPLE WITH MOBILITY DISABILITIES. EXISTING PEDESTRIAN ROUTES AND ALTERNATE PEDESTRIAN ROUTES DURING CONSTRUCTION ARE REQUIRED TO BE COMPLIANT WITH THE PUBLIC RIGHTS OF WAY ACCESSIBILITY GUIDELINES (PROWAG), 2010 ADA STANDARDS FOR ACCESSIBLE DESIGN AND THE MANUAL ON UNIFORM TRAFFIC CONTROL DEVICES (MUTCD).
- 3. ALL PAVEMENTS TO SLOPE POSITIVELY AWAY FROM ALL BUILDINGS.PONDING OF WATER IS PROHIBITED.
- 4. PROVIDE CONSTRUCTION JOINTS IN CONCRETE WALKWAYS AS SHOWN IN PLANS. IF NOT SHOWN ON PLANS - MAX SPACING @ 10'
- THROUGHOUT PROJECT SITE, ALL DIMENSIONS TO BE FIELD VERIFIED. NOTIFY THE LANDSCAPE ARCHITECT OF ANY DISCREPANCY. ALL DIMENSIONS ARE TO OUTSIDE FACE OF BUILDING, TO CENTERLINE, CENTER TO CENTER ON STRIPES, AND/OR FACE OF CURB, UNLESS OTHERWISE NOTED.
- BUILDING AND PUBLIC ROADWAY STAKE OUT SHALL BE PERFORMED BY A REGISTERED LAND SURVEYOR.
- 7. GUARDRAILS MUST BE INSTALLED ON THE OPEN SIDES OF ELEVATED WALKING SURFACES THAT EXCEED 30 INCHES IN HEIGHT. ALL GUARDRAILS MUST BE A MINIMUM HEIGHT OF 42 INCHES ABOVE THE LEADING EDGE OF THE TREAD OR WALKING SURFACE. GUARDRAILS SHALL HAVE BALUSTERS SUCH THAT A 4 INCH DIAMETER SPHERE CANNOT PASS THROUGH ANY OPENING UP TO A HEIGHT OF 34 INCHES. FROM 34 INCHES TO 42 INCHES ABOVE THE WALKING SURFACE, A 8 INCH DIAMETER SPHERE SHALL NOT PASS.
- THE CONTRACTOR, AT ALL TIMES, MUST KEEP THE PREMISES FREE FROM ACCUMULATIONS OF WASTE MATERIALS OR RUBBISH CAUSED BY THE CONTRACTOR, THE CONTRACTOR'S EMPLOYEES OR THE CONTRACTOR'S SUBCONTRACTOR. ALL DEBRIS SHALL BE REMOVED FROM THE PROJECT SITE ON A DAILY BASIS.
- IF DEPARTURES FROM THE DRAWINGS OR SPECIFICATIONS ARE DEEMED NECESSARY BY THE CONTRACTOR, DETAILS OF SUCH DEPARTURES FROM THE CONTRACT DOCUMENTS SHALL BE MADE WITH THE EXPRESS WRITTEN
- 10. LANDSCAPE ARCHITECT AND/OR OWNER DISCLAIM ANY ROLE IN THE CONSTRUCTION MEANS AND/OR METHODS ASSOCIATED WITH THE PROJECT AS SET FORTH IN THESE PLANS.

PERMISSION OF THE OWNER.

EXISTING SERVICES.

- 11. EXISTING UTILITIES AND STRUCTURES SHOWN, BOTH UNDERGROUND AND ABOVE, ARE BASED ON A FIELD DATA PROVIDED TO LANDSCAPE ARCHITECT. THE CONTRACTOR SHALL LOCATE EXISTING UTILITIES, UNDERGROUND LINES, AND STRUCTURES AS NECESSARY TO AVOID DAMAGING OR DESTROYING
- 12. THE CONTRACTOR IS RESPONSIBLE FOR FIELD VERIFYING THE ACTUAL AND EXACT LOCATION, SIZE, AND MATERIAL COMPOSITION OF ANY EXISTING WATER OR SEWER SERVICE PROPOSED FOR CONNECTION OR USE ON THIS PROJECT. THE RELOCATION OF ANY UTILITY SERVICES REQUIRED TO COMPLETE ANY PORTION OF THESE CONSTRUCTION PLANS.
- 13. CONTRACTOR SHALL MAINTAIN AN "AS BUILT" SET OF DRAWINGS TO RECORD ANY FIELD CHANGES, ALONG WITH ANY PIPING PRIOR TO CONCEALMENT. DRAWINGS SHALL BE GIVEN TO THE OWNER AT THE END OF THE PROJECT.
- 14. THE CONTRACTOR IS RESPONSIBLE FOR OBTAINING ALL REQUIRED PERMITS. ALL CONSTRUCTION SHALL BE IN ACCORDANCE WITH PERMITS AS ISSUED,

AND ANY AND ALL APPLICABLE STATE, COUNTY AND LOCAL CODES.

- 15. EXISTING IMPROVEMENTS DAMAGED OR DESTROYED DURING CONSTRUCTION SHALL BE REPLACED OR RESTORED TO THEIR ORIGINAL CONDITION, AND TO THE SATISFACTION OF THE OWNER OF THE IMPROVEMENTS.
- 16. THE CONTRACTOR SHALL OBTAIN AND PAY FOR ALL INSPECTIONS, CERTIFICATIONS, AND/OR ANY OTHER REQUIREMENTS WHICH MUST BE MET UNDER CONTRACT.
- 17. CONTRACTOR SHALL REFER TO ARCHITECTURAL PLANS FOR DETAILS OF
- BUILDINGS AND BUILDING DIMENSIONS. 18. CONTRACTOR SHALL COORDINATE CONSTRUCTION OF ALL UNDERGROUND UTILITIES FOR THIS PROJECT WITH THE OWNER'S REPRESENTATIVE PER ALL
- APPLICABLE REGULATIONS. 19. CONTRACTOR SHALL COORDINATE WITH OTHER CONTRACTOR'S ON SITE AND UTILITY PROVIDERS DURING CONSTRUCTION TO ENSURE SMOOTH

TRANSITION BETWEEN DISCIPLINES.

- 20. ALL DEMOLITION, AND ANY SUBSEQUENT CONSTRUCTION, SHALL BE PERFORMED IN ACCORDANCE WITH THESE PLANS AND SPECIFICATIONS SET FORTH AND APPROVED BY THE CITY OF RALEIGH. THE CONTRACTOR IS RESPONSIBLE FOR OBTAINING ALL REQUIRED PERMITS. ALL TREE
- PROTECTION FENCING SHALL REMAIN IN PLACE DURING CONSTRUCTION. 21. TRAFFIC CONTROLS FOR ANY UTILITY WORK WITHIN THE PUBLIC RIGHT OF WAY SHALL BE PERFORMED IN COMPLIANCE WITH STANDARDS OF THE NORTH CAROLINA MANUAL ON UNIFORM TRAFFIC CONTROL DEVICES (MUTCD).
- 22. ALL CROSSWALK MARKINGS WITHIN RIGHT-OF-WAY SHALL BE CONSTRUCTED OF THERMOPLASTIC MATERIALS AND CONSTRUCTED IN ACCORDANCE WITH NCDOT SPECIFICATIONS. CONTRACTOR TO INSTALL CROSSWALKS IN SUCH A MANNER THAT CROSSWALKS ARE ALIGNED BETWEEN HANDICAP/WALKWAY ACCESS POINTS OR PERPENDICULAR TO THE ROADWAY / DRIVE LANE.
- 23. ALL SIGNS AND PAVEMENT MARKINGS ARE TO MEET MUTCD (MANUAL ON UNIFORM TRAFFIC CONTROL DEVICES) AND NCDOT STANDARDS.
- 24. ALL SIGNS SHALL USE PRISMATIC SHEETING THAT MEETS MINIMUM RETROREFLECTIVITY STANDARDS FOUND IN THE LATEST EDITION OF THE

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MINGT MS S .

PROJECT NUMBER: 19022

> PROJECT PHASE: ADMINISTRATIVE


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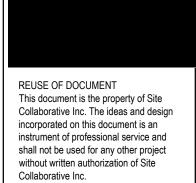
07.25.2019

SHEET TITLE:

LAYOUT & MATERIALS PLAN

SHEET NUMBER: **L200** 



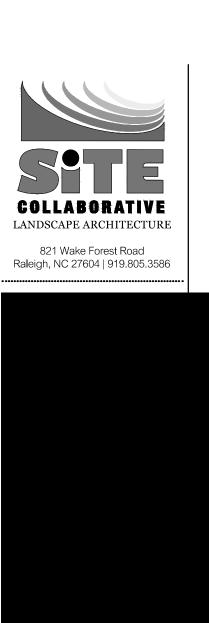





19022

PROJECT PHASE: ADMINISTRATIVE SITE REVIEW

DATE:


07.25.2019

SHEET TITLE: SITE

DETAILS

SHEET NUMBER:



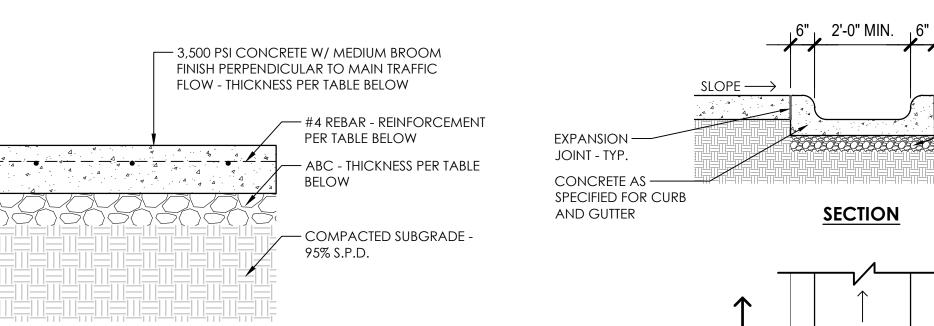

PAVEMENT TYPE	ABC	REINFORCEMENT	CONCRETE
Service Drive Area/Dumpster Pad	4"	#4 @ 12" o.c, b.w.	8"
Accessible Parking Spaces	4"	#4 @ 12" o.c, b.w.	6"
Pedestrian Sidewalks	4"	None	4''

# 1. CONTRACTOR TO CONTACT LANDSCAPE ARCHITECT TO REVIEW

- FORMS PRIOR TO POURING. 2. SEE PLANS FOR JOINT LOCATIONS.
- 3. SEE 4/L201 FOR JOINT DETAIL

— FINISH GRADE OR SIDEWALK

- SURFACING PER LAYOUT

- BASE COURSE VARIES PER

SURFACING SPECIFIED IN LAYOUT & MATERIALS PLAN


- COMPACTED SUBGRADE


& MATERIALS PLAN


- 3500 PSI CONCRETE

8"-

PER LAYOUT & MATERIALS PLAN

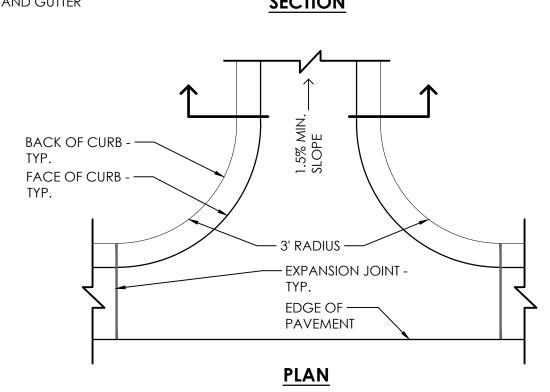

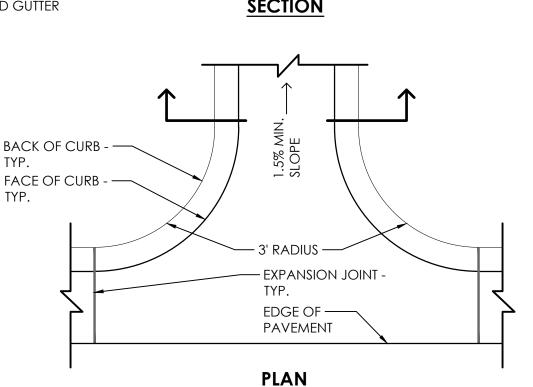

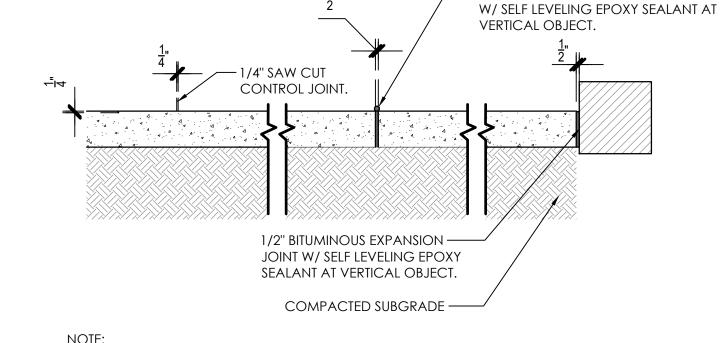

- 1/2" BITUMINOUS EXPANSION JOINT

SCALE: 3/4'' = 1'-0''

- COMPACTED

COMPACTED

SUBGRADE


ABC


- 1. TYP. CONTROL JOINT NOTED AS CJ ON THE PLAN OR 10' O.C. MAX IF NOT
- NOTED ON PLAN. 2. TYP. EXPANSION JOINT NOTED AS EJ ON PLAN OR 50' O.C. MAX IF NOT


CONCRETE CONSTRUCTION JOINTS


- NOTED ON PLAN
- 3. EJ @ WALL OR VERTICAL ELEMENT



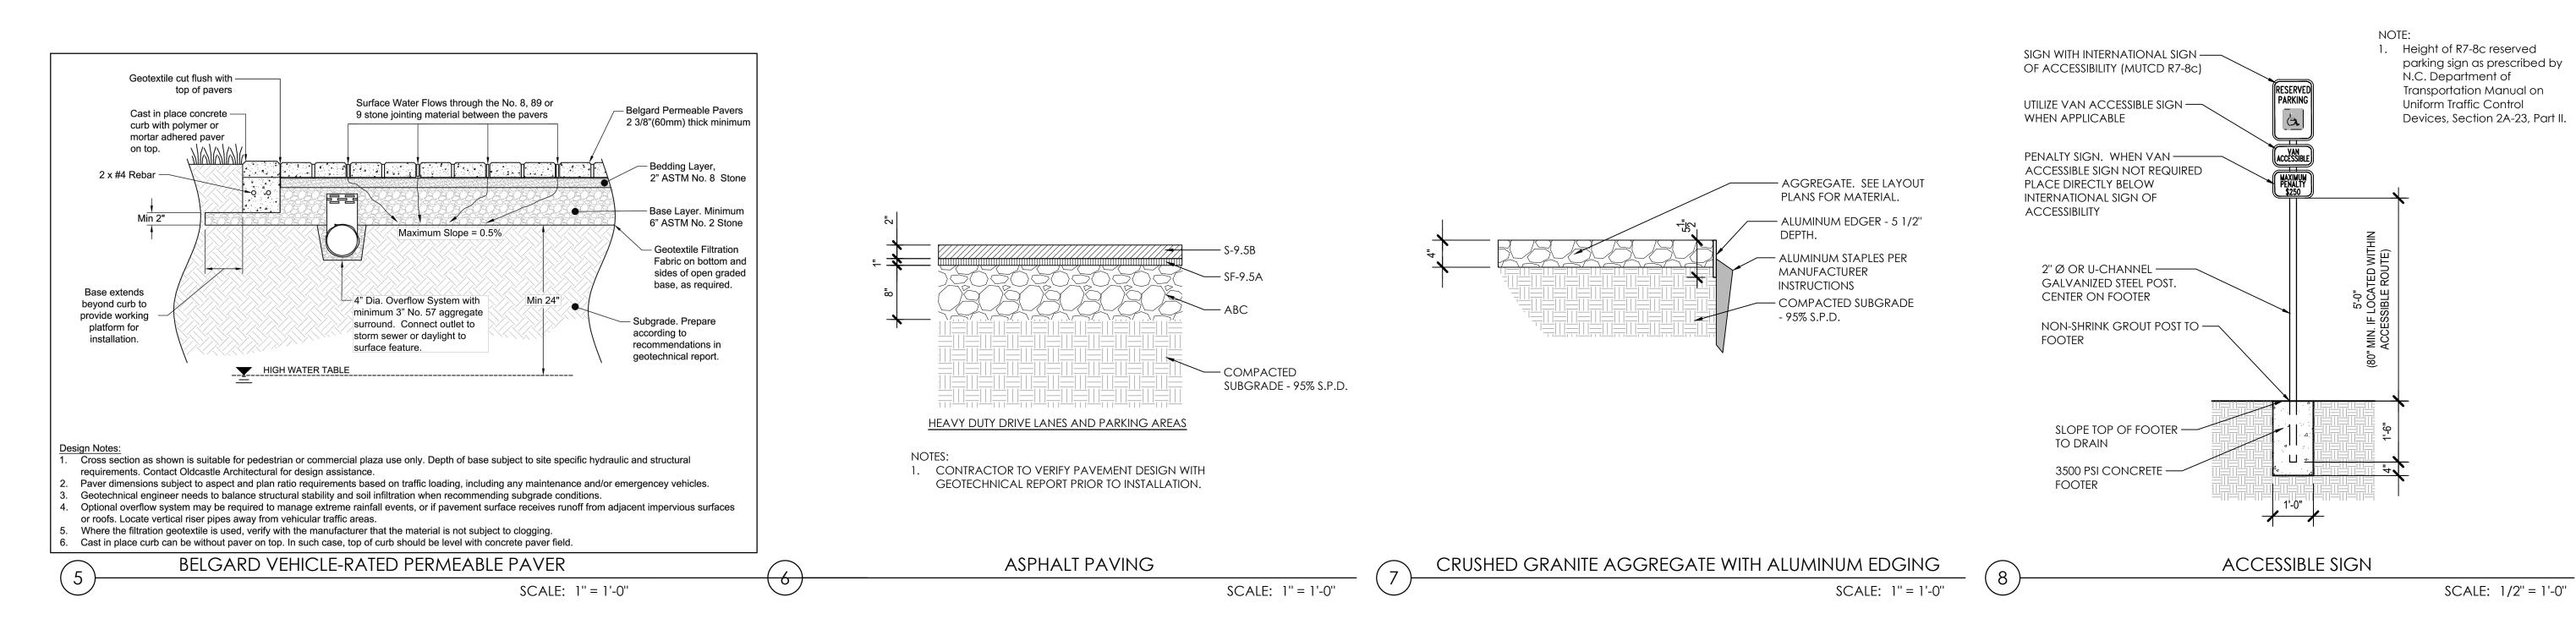

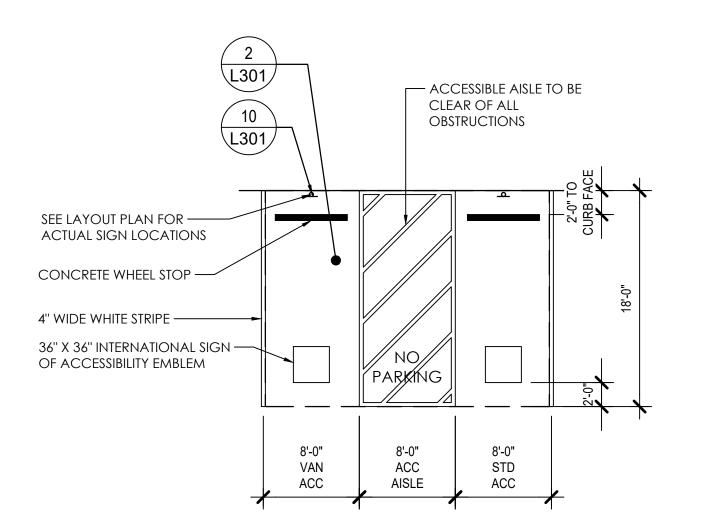

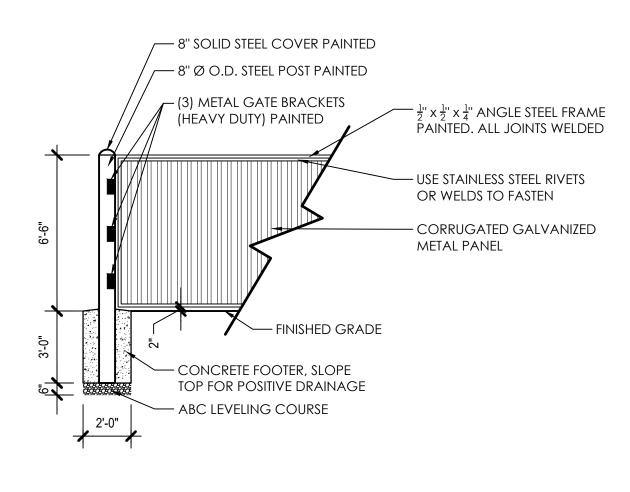

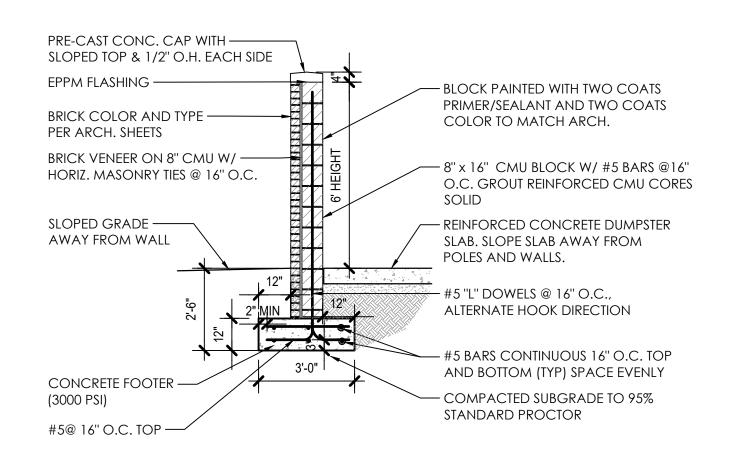

1. ALL SURFACES PAINTED WITH TWO COATS PRIMER/SEALANT AND TWO COATS COLOR TO MATCH ARCHITECTURE.

DUMPSTER ENCLOSURE GATE


SCALE: 1/4" = 1'-0"


SCALE: NTS

DUMPSTER ENCLOSURE

ACCESSIBLE PARKING SPACE

SCALE: 1/8" = 1'-0"

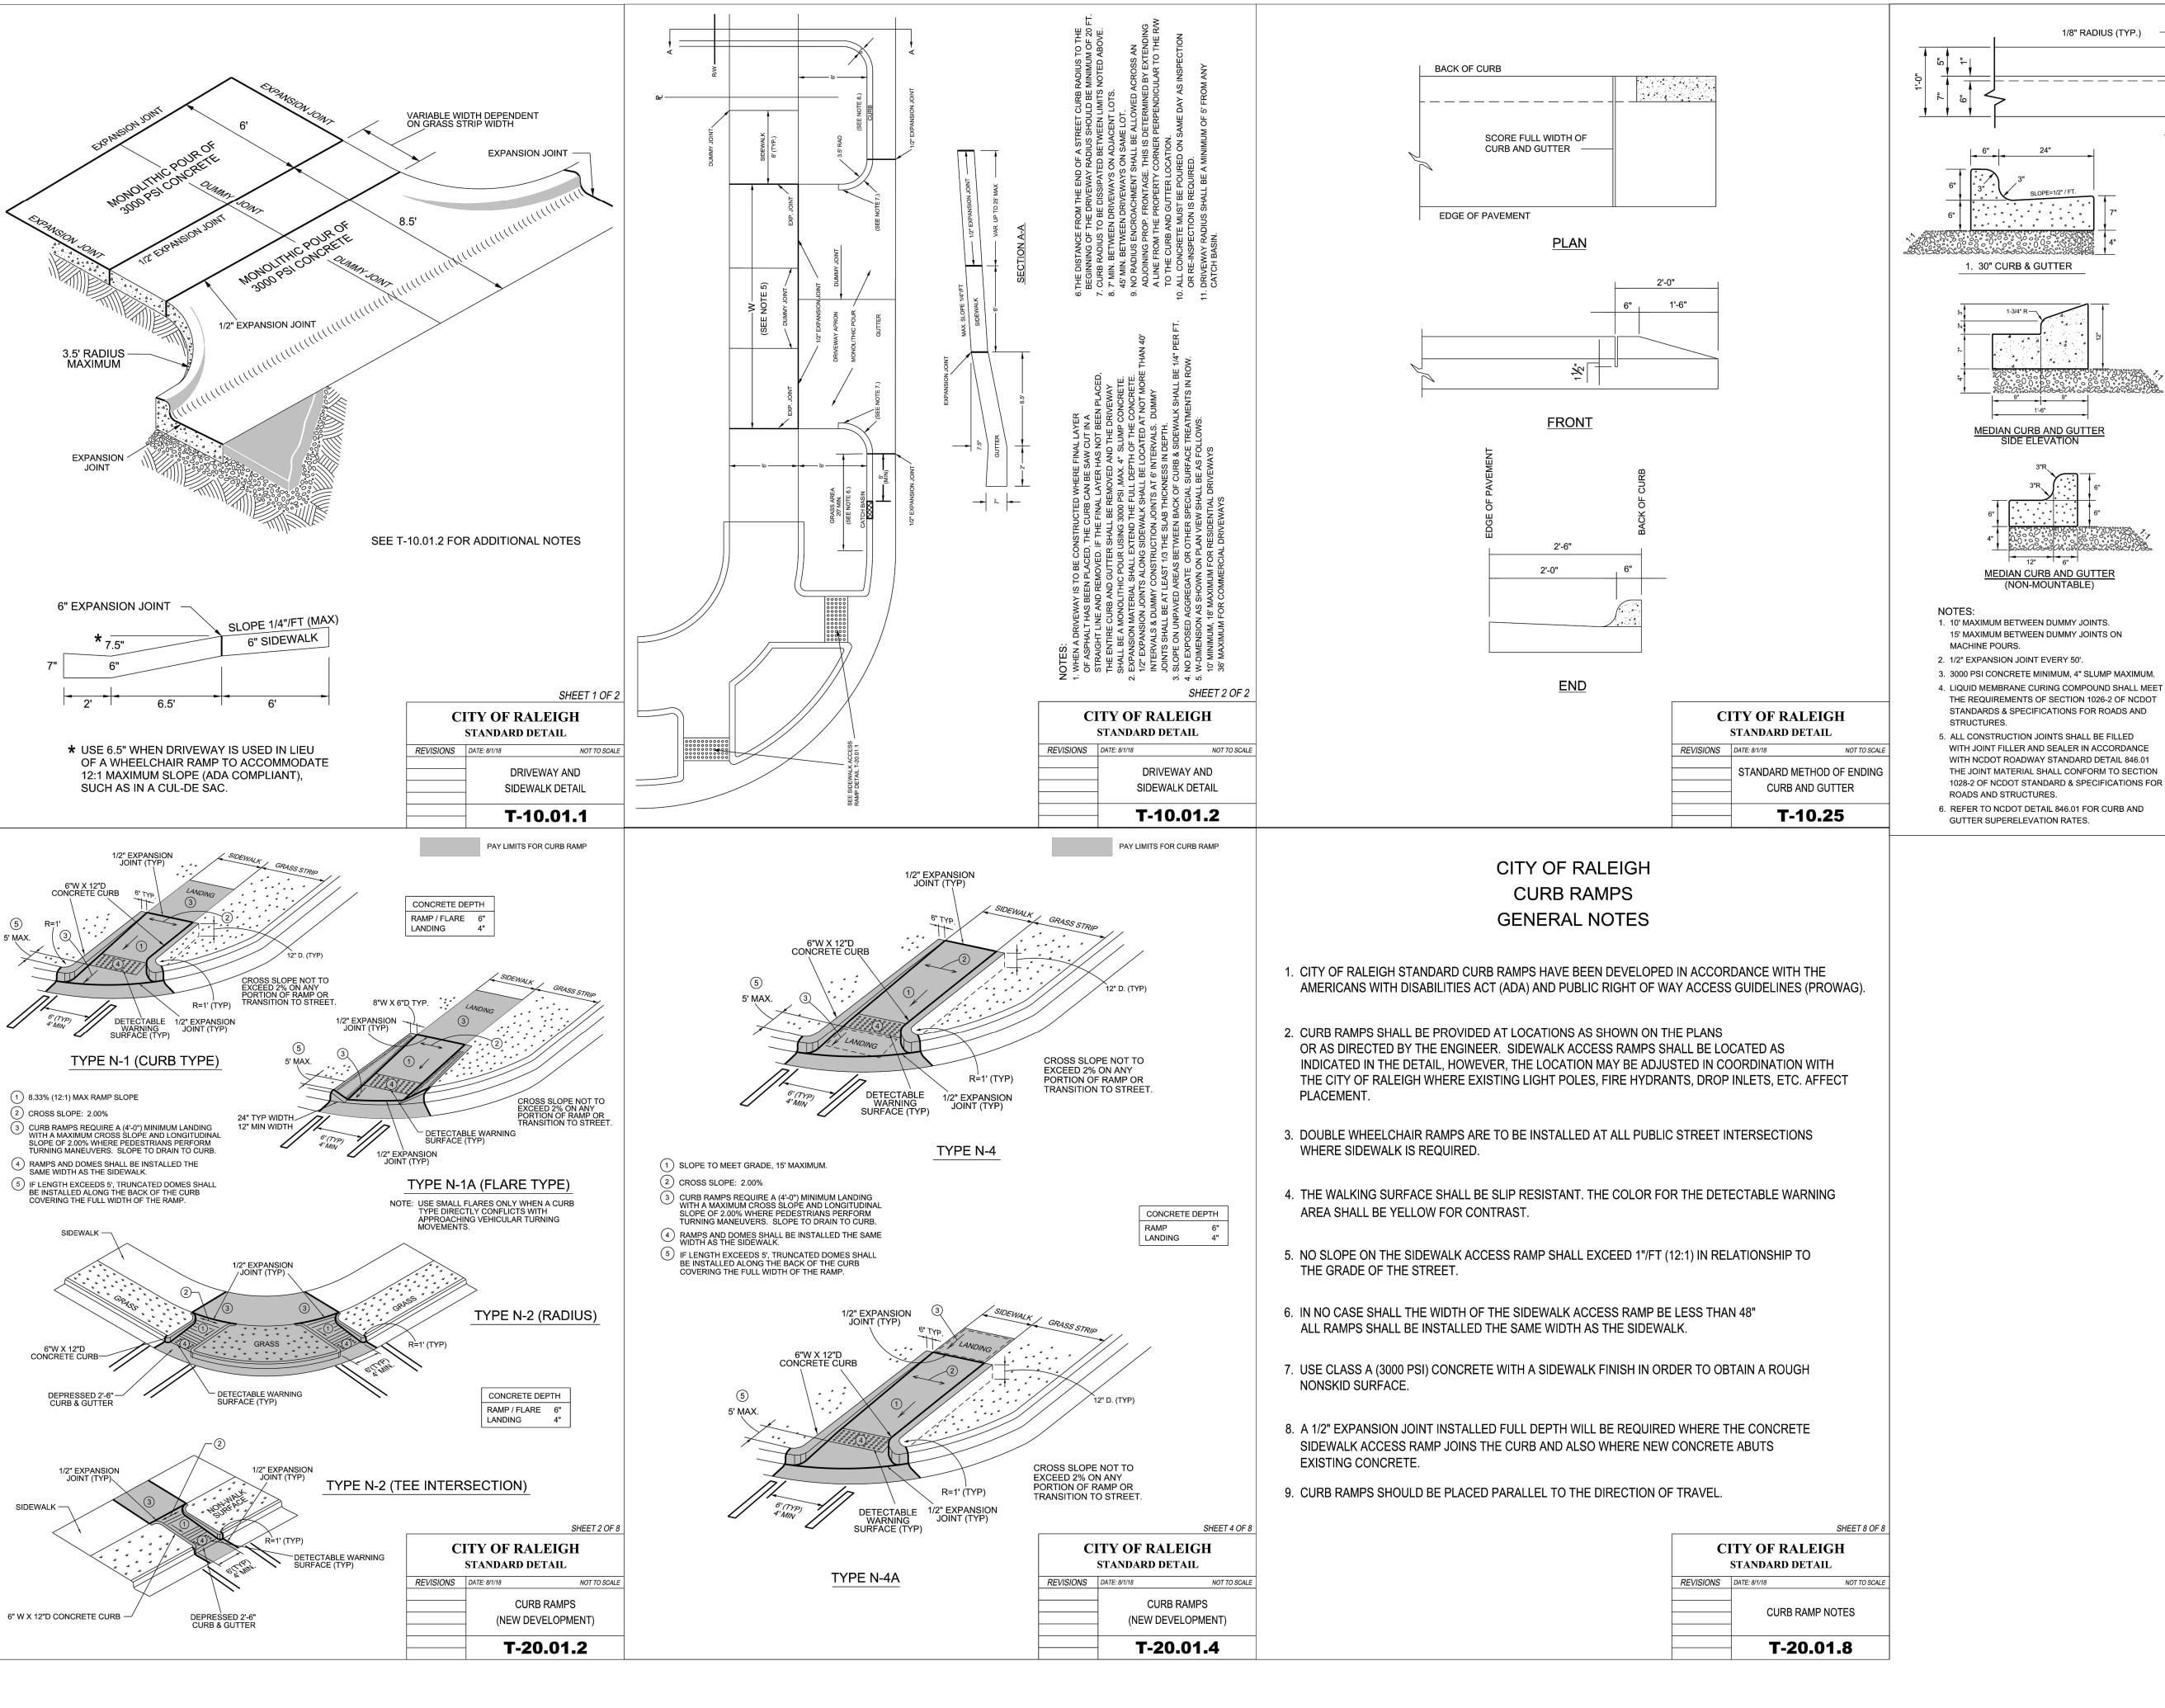

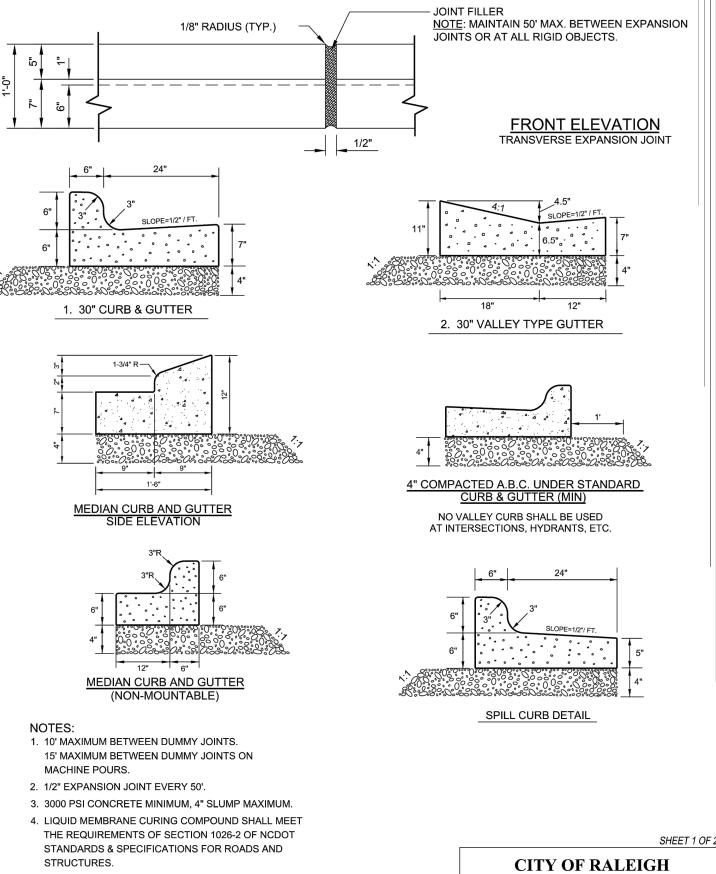

41, LLC 1 S WILMINGTON STREET, RALEIGH, NC 2

LANDSCAPE ARCHITECTURE

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STANDARD DETAIL

CURB AND GUTTER

T-10.26.1

REVISIONS DATE: 8/1/18

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7603

without written authorization of Site

PROJECT NUMBER:
19022

PROJECT PHASE:
ADMINISTRATIVE

SITE REVIEW

DATE:


07.25.2019


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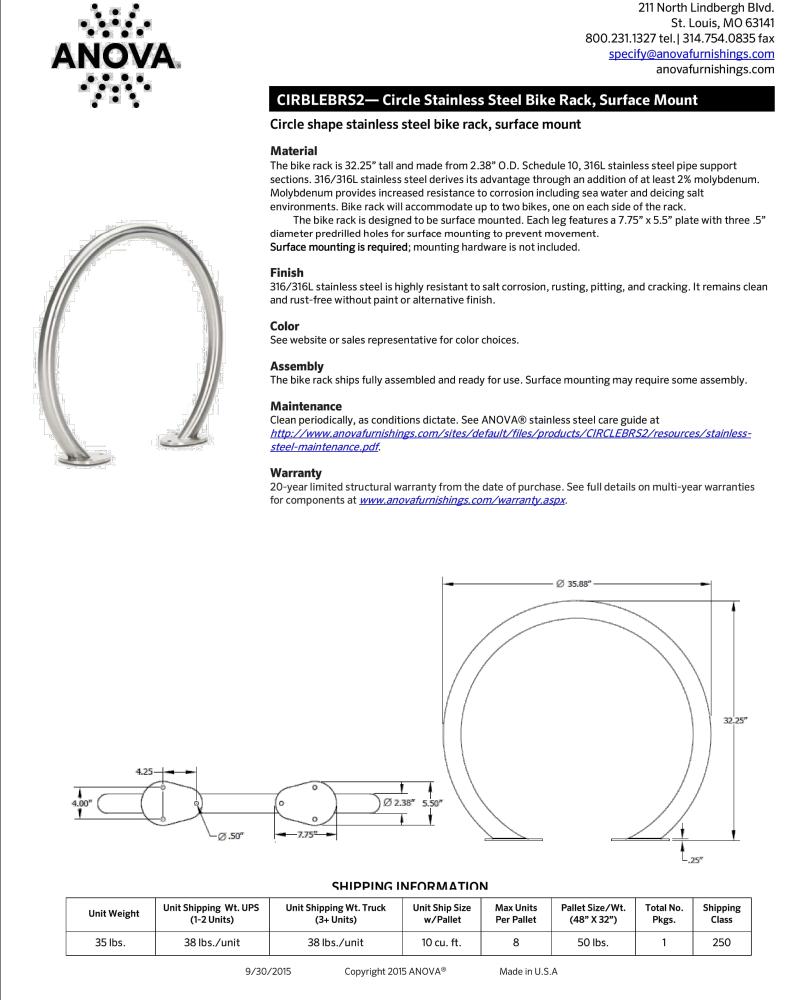
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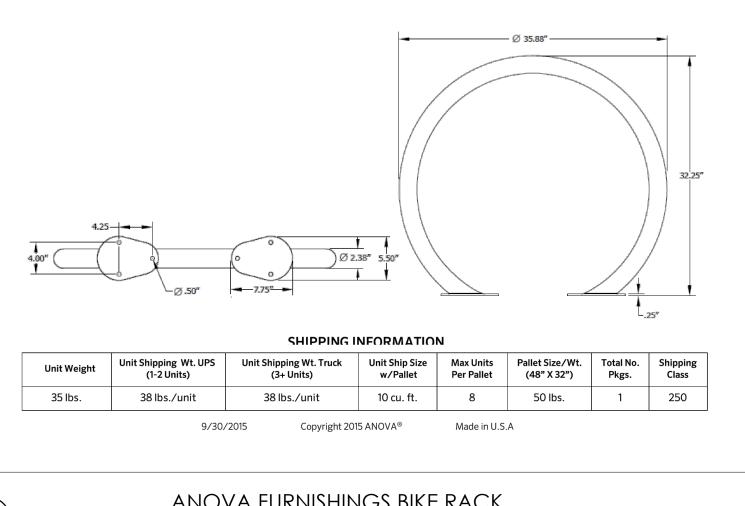
SITE DETAILS

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7603  $\mathcal{C}$ WILMINGTON SOH SOH 2701 PROJECT NUMBER: PROJECT PHASE: ADMINISTRATIVE

ANOVA FURNISHINGS BIKE RACK

SCALE: NTS

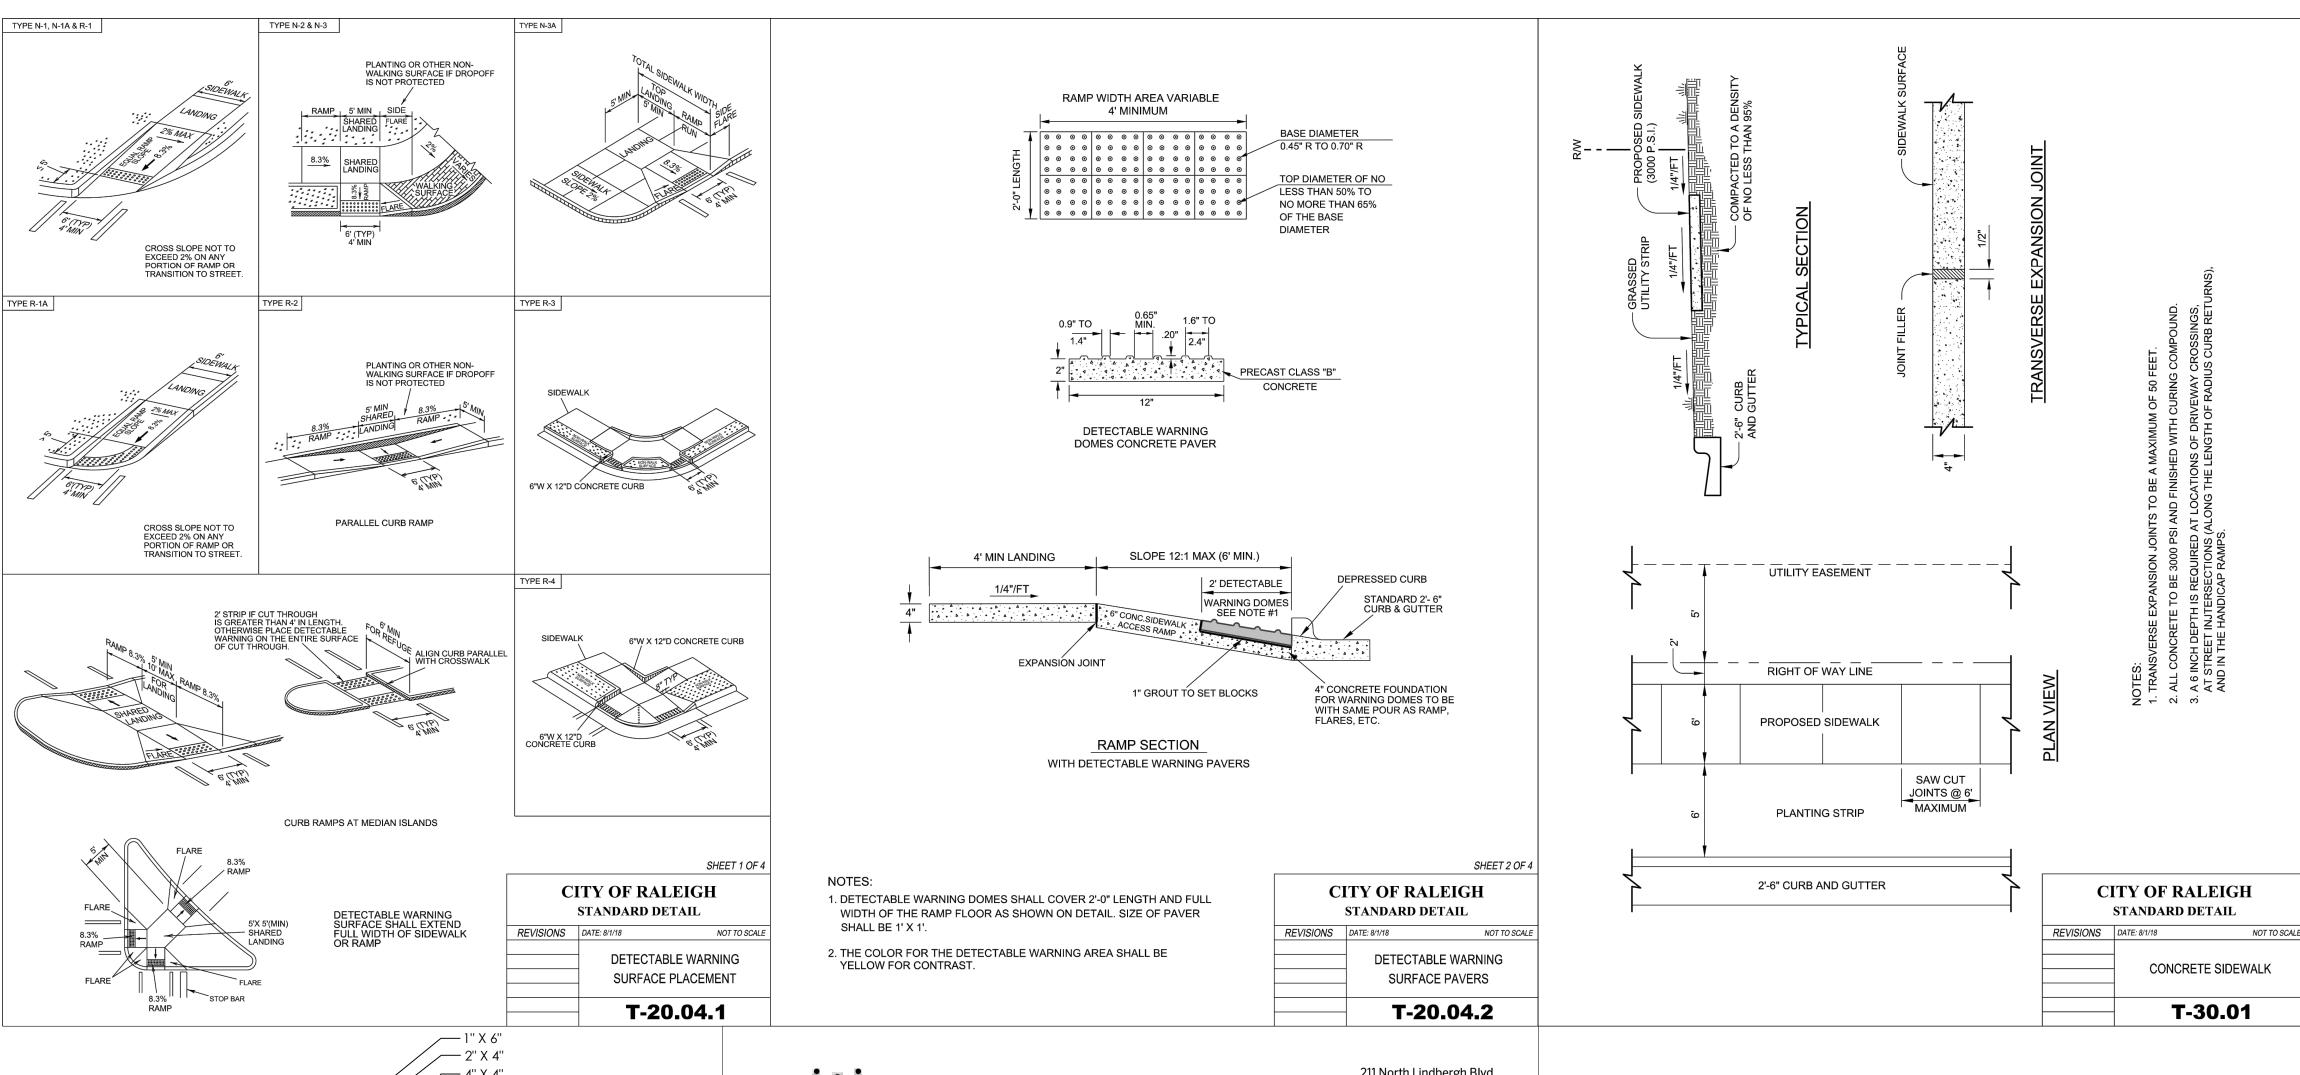**L203** 

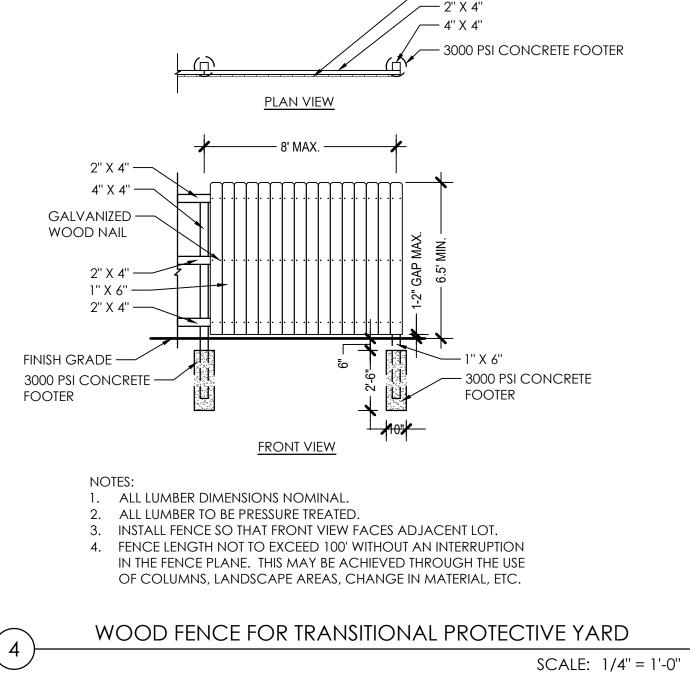SITE

DETAILS

19022

DATE:

SITE REVIEW

07.25.2019

SHEET TITLE:

SHEET NUMBER:



# **GRADING NOTES**

- 1. ORIGINAL EXISTING CONDITIONS SHOWN AS 'EXISTING' IN THIS PLAN SET HAS BEEN COMPILED FROM SURVEY DATA PROVIDED BY JAMES DITENHAFER. CONTRACTOR TO FIELD VERIFY ALL INFORMATION AND REPORT ANY DISCREPANCIES.
- ALL DIMENSIONS AND GRADES SHOWN ON THE PLANS SHALL BE FIELD VERIFIED BY THE CONTRACTOR PRIOR TO CONSTRUCTION. CONTRACTOR SHALL NOTIFY LANDSCAPE ARCHITECT. IF ANY DISCREPANCIES EXIST PRIOR TO PROCEEDING WITH CONSTRUCTION FOR NECESSARY PLAN OR GRADE CHANGES. NO EXTRA COMPENSATION SHALL BE PAID TO CONTRACTOR FOR ANY WORK DONE DUE TO DIMENSIONS OR GRADES SHOWN INCORRECTLY ON THESE PLANS IF SUCH NOTIFICATION HAS NOT BEEN GIVEN.
- 3. ALL PAVEMENTS TO SLOPE POSITIVELY AWAY FROM ALL BUILDINGS. PONDING OF WATER IS PROHIBITED.
- 4. THE GENERAL CONTRACTOR IS RESPONSIBLE FOR MAINTENANCE OF EROSION CONTROL METHODS DURING CONSTRUCTION, AND THE OWNER IS RESPONSIBLE FOR MAINTENANCE OF ALL PERMANENT EROSION CONTROL METHODS AFTER CONSTRUCTION IS COMPLETE, IF ANY PERMANENT METHODS ARE REQUIRED.
- 5. CONSTRUCTION AND MAINTENANCE OF ALL EROSION CONTROL DEVICES SHALL CONFORM TO THE STANDARDS SET FORTH IN THE CITY OF RALEIGH EROSION AND SEDIMENT CONTROL MANUAL.
- 6. INSPECTOR REFERS TO AUTHORIZED REGULATORY AGENCY SEDIMENTATION AND EROSION CONTROL INSPECTOR OR HIS/HER REPRESENTATIVE. FIELD INSPECTIONS MAY REQUIRE ADDITIONAL SEDIMENTATION AND EROSION CONTROL MEASURES AS DEEMED NECESSARY BY THE INSPECTOR, CLIENT, AND/OR CLIENT'S REPRESENTATIVES.
- 7. WHEN HAND PLANTING, MULCH (HAY OR STRAW) SHOULD BE UNIFORMLY SPREAD OVER SEEDED AREA WITHIN 24 HOURS
- 8. DURING UNSUITABLE GROWING SEASONS, MULCH WILL BE USED AS A TEMPORARY COVER ON SLOPES THAT ARE 4:1 OR STEEPER, MULCH WILL BE ANCHORED.
- 9. EROSION AND SEDIMENT CONTROL DEVICES MUST BE INSTALLED AND INSPECTED PRIOR TO ANY GRADING ON SITE. PLEASE CALL THE REGULATORY AUTHORITY FOR AN INSPECTION.
- 10. INSPECT AND MAINTAIN ALL EROSION CONTROL MEASURES EVERY 7 DAYS AND AFTER EACH SIGNIFICANT RAINFALL (0.5 INCHES OR GREATER) AND DOCUMENT WITH INSPECTION REPORTS.
- 11. EACH DEVICE IS TO BE MAINTAINED OR REPLACED IF SEDIMENT ACCUMULATION HAS REACHED ONE HALF THE CAPATOWN OF THE DEVICE.
- 12. LOCATE STOCKPILES UP SLOPE FROM EROSION CONTROL MEASURES. ALL SOIL STOCK PILES SHALL HAVE APPROPRIATE EROSION CONTROL PER THE LATEST VERSION OF THE CITY OF RALEIGH EROSION AND SEDIMENT CONTROL MANUAL INCLUDING SEEDING AND SILT FENCE AROUND THE BASE OF THE STOCK PILE.

G	GRADING LEGEND					
KEY	DESCRIPTION					
FG	FINISH GRADE					
MG	meet existing grade					
HP	HIGH POINT					
HPS	HIGH POINT OF SWALE					
LP	LOW POINT					
BS	BOTTOM OF STAIRS					
TS	TOP OF STAIRS					
BR	BOTTOM OF RAMP					
TR	TOP OF RAMP					
ВС	BOTTOM OF CURB					
TC	TOP OF CURB					
BWH	BOTTOM OF WALL (HIGH SIDE)					
BWL	BOTTOM OF WALL (LOW SIDE)					
TW	TOP OF WALL					
X%	SLOPE DIRECTION - POINTS DOWNWARD					
	GRADE BREAK					
<b>&gt;&gt;&gt;</b>	ACCESSIBLE ROUTE					



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LLC WILMINGTON ( SOHI, L 2701 S

PROJECT NUMBER:

19022 PROJECT PHASE:

ADMINISTRATIVE SITE REVIEW

DATE: 07.25.2019


SHEET TITLE: GRADING

SHEET NUMBER:

L300

PLAN



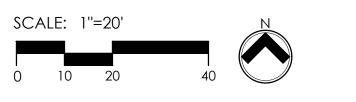

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7603  $\mathcal{C}$ S STRE MINGTON SOH SOH 2701

PROJECT NUMBER: 19022

PROJECT PHASE: ADMINISTRATIVE

SITE REVIEW

DATE:

07.25.2019

SHEET TITLE:

PLANTING PLAN

SHEET NUMBER:

# PLANTING NOTES

- 1. ROUGH GRADING TO BE COMPLETED PRIOR TO THE START OF PLANT INSTALLATION. SUBSTANTIAL COMPLETION SIGN-OFF BY LANDSCAPE ARCHITECT CONTRACTOR TO ENSURE NO CHANNELIZED FLOWS AROUND THE SITE.
- 2. CONTRACTOR RESPONSIBLE FOR LOCATING ALL UTILITIES AND UNDERGROUND IMPEDIMENTS PRIOR
- 3. ALL WEEDS, NON-NATIVE INVASIVE SPECIES, AND EXOTIC SPECIES LOCATED WITHIN THE PROJECT CONTRACTOR LIMITS SHALL BE ELIMINATED PRIOR TO PLANTING BED CREATION, PLANTING, AND SEEDING/SODDING OPERATIONS.
- 4. PLANTING SHOULD OCCUR IMMEDIATELY AFTER CONSTRUCTION TO STABILIZE AREAS OF BARE SOIL.
- 5. IT SHALL BE NOTED THAT ALL SECTIONS OF THE SITE THAT ARE SLOPED 3:1 OR HIGHER WILL BE COVERED WITH EROSION CONTROL STABILIZATION COIR FABRIC (WITH 1" SQUARE OPENINGS) PRIOR TO PLANTING TO ENSURE IMMEDIATE STABILIZATION. LANDSCAPE CONTRACTOR SHALL CUT FABRIC AT EACH PLANT LOCATION AND PLACE PLANTS ACCORDING TO PLAN. ALL FABRIC SHALL BE RE-STAKED PER ENGINEERS ORIGINAL DRAWINGS IMMEDIATELY AFTER PLANTING.
- 6. PLANTS ARE TO BE PURCHASED BY SCIENTIFIC NAMES. THEY SHALL BE REPRESENTATIVE OF THEIR SPECIES, MEET ALL NOTED CONDITIONS OF SPECIFICATIONS, AND SHALL BE IN VIGOROUS GROWING CONDITION MEETING ANSI STANDARD Z60.
- 7. LANDSCAPE ARCHITECT OR OWNER MAINTAINS RIGHT TO REJECT ANY PLANT DUE TO AESTHETICS OR STRUCTURAL DEFICIENCY AT ANY TIME.
- 8. CONTRACTOR RESPONSIBLE FOR FURNISHING AND INSTALLING ALL PLANTS SHOWN ON PLANS IN LOCATIONS SHOWN. QUANTITIES GIVEN ON THE PLANT LEGEND ARE FOR CONTRACTOR'S CONVENIENCE ONLY. IF DISCREPANCIES OCCUR, THE PLANS SHALL OVERRULE THE PLANT LEGEND. CONTRACTOR SHALL LOCATE ALL PLANTS AWAY FROM KNOWN PERMANENT FIXTURES. IF CONFLICT ARISES WITH PLAN. CONTRACTOR SHALL NOTIFY PROJECT MANAGER OR DESIGNEE PRIOR TO PROCEEDING.
- 9. ALL PLANT MATERIAL SHALL CONFORM TO OR EXCEED THE AMERICAN STANDARD FOR NURSERY STOCK (LATEST EDITION) AS PUBLISHED BY THE AMERICAN ASSOCIATION OF NURSERYMEN.
- 10.ALL PLANT MATERIAL SHALL BE FREE OF ALL PESTS, DISEASES, AND CANKERS, IN HEALTHY CONDITION, AND FREE OF MECHANICAL DAMAGE AT THE TIME OF PLANTING.
- 11.IT IS THE RESPONSIBILITY OF THE CONTRACTOR TO ENSURE A HEALTHY AND VIABLE PLANT AND THE PLANT SHALL BE REJECTED IF DEEMED UNHEALTHY OR UNFIT AT ANY TIME DURING THE CONTRACT OR
- 12.IF ANY PLANT/MATERIAL SUBSTITUTIONS ARE REQUESTED BY CONTRACTOR, THEN NOTICE SHALL BE GIVEN TO PROJECT MANAGER OR DESIGNEE AT MINIMUM SEVENTY-TWO (72) HOURS (NOT INCLUDING WEEKENDS) PRIOR TO DESIRED ORDERING DATE/TIME. WHEN SUBSTITUTIONS ARE REQUESTED BY CONTRACTOR, SUGGESTED ACCEPTABLE REPLACEMENTS SHALL ALSO BE PRESENTED AT TIME FOR FULL AND COMPLETE REVIEW BY LANDSCAPE ARCHITECT OR OWNER.
- 13. BALLED AND BURLAPPED PLANTS/TREES TO BE PLANTED PRIOR TO CONTAINER OR BEDDING PLANTS.
- 14. BALLED AND BURLAPPED MATERIAL SHALL COMPLY WITH THE FOLLOWING GUIDELINES: 14.1. TREES DESIGNATED B&B SHALL BE PROPERLY DUG WITH FIRM, NATURAL BALLS OF SOIL RETAINING AS MANY FIBROUS ROOTS AS POSSIBLE, IN SIZES AND SHAPES AS SPECIFIED IN THE AMERICAN STANDARD FOR NURSERY STOCK ANSI Z60.1.
- 14.2. ROOT BALLS SHALL BE FIRMLY WRAPPED WITH NONSYNTHETIC, ROTTABLE BURLAP AND SECURED WITH NAILS AND HEAVY, NONSYNTHETIC TWINE.
- 14.3. ROOT COLLAR SHALL BE APPARENT AT SURFACE OF BALL, OR THE CONTRACTOR WILL BE
- RESPONSIBLE FOR REMOVING EXCESS SOIL FROM THE TOP OF THE ROOTBALL 14.4. REMOVE ALL BURLAP, LACING, AND WIRE BASKET FROM AT LEAST THE TOP 1/2 OF THE ROOTBALL
- AND DISCARD FROM PLANTING HOLE. 14.5. DO NOT MANEUVER BY TRUNK. HANDLE BY ROOT BALL ONLY.
- 15. CONTAINERIZED PLANTS SHALL COMPLY WITH THE FOLLOWING GUIDELINES:
- 15.1. MATERIAL SHALL HAVE FIRM, NATURAL BALLS OF SOIL RETAINING AS MANY FIBROUS ROOTS AS POSSIBLE, IN SIZES AND SHAPES AS SPECIFIED IN THE AMERICAN STANDARD FOR NURSERY STOCK
- 15.2. ROOT COLLAR SHALL BE APPARENT AT SURFACE OF BALL, OR THE CONTRACTOR WILL BE
- RESPONSIBLE FOR REMOVING EXCESS SOIL FROM THE TOP OF THE ROOTBALL. 15.3. REMOVE CONTAINER PRIOR TO PLANTING.
- 16.TREES TO BE STAKED WILL BE DESIGNATED BY THE LANDSCAPE ARCHITECT. TREE STAKING FOR CANOPY AND LARGE EVERGREEN TREES SHALL NOT EXCEED 90 DAYS.

# 17.PLANT BED PREPARATION:

ALL PLANT BEDS ARE TO RECEIVE A MINIMUM OF 4" OF APPROVED TOPSOIL TILLED IN TO A DEPTH OF 8" TO ENSURE INTEGRATION WITH EXISTING SOIL. APPROVED TOPSOIL IS TO BE PREFERABLY FROM ON-SITE STOCKPILE FROM STRIPPING OPERATIONS - SEE EROSION AND SEDIMENT CONTROL PLANS. IF ON-SITE TOPSOIL IS NOT AVAILABLE, CONTRACTOR SHALL PROVIDE TO SITE ACCORDINGLY.

- 18.ALL MULCH TO BE CERTIFIED TO BE FREE OF WEEDS, NON-NATIVE INVASIVE SPECIES AND THEIR LARVAE. MULCH SAMPLE SUBMITTAL SHALL BE PROVIDED TO LANDSCAPE ARCHITECT BEFORE SITE
- 19.SEED/SODDED BED PREPARATION: ALL AREAS TO BE SEEDED/SODDED ARE TO RECEIVE A MINIMUM OF 2" OF APPROVED TOPSOIL SEEDING/SODDING NOTES FILLED INTO ALL DEBRIS, ROCKS, ETC. LARGER THAN .5" ARE TO BE REMOVED PRIOR TO SEEDING/SODDING OR PLANTING. A DEPTH OF 4" TO ENSURE INTEGRATION WITH EXISTING SOIL.
- APPROVED TOPSOIL IS TO BE PREFERABLY FROM ON-SITE STOCKPILE FROM STRIPPING OPERATIONS -SEE EROSION AND SEDIMENT CONTROL PLANS. IF ON-SITE TOPSOIL IS NOT AVAILABLE, CONTRACTOR SHALL PROVIDE TO SITE ACCORDINGLY.

# SEEDING/SODDING NOTES

- 1. ROUGH GRADING TO BE COMPLETED PRIOR TO THE START OF PLANT INSTALLATION. SUBSTANTIAL COMPLETION SIGN-OFF BY LANDSCAPE ARCHITECT CONTRACTOR TO ENSURE NO CHANNELIZED FLOWS AROUND THE SITE.
- 2. ALL SEEDED/SODDED AREAS SHALL BE FINISHED GRADE AT THE THICKNESS OF THE SOD.
- 3. NO SEEDED/SODDED AREAS SHALL BE SODDED UNTIL ALL OTHER CONSTRUCTION ACTIVITIES, INCLUDING PLANTING AND MULCHING HAVE OCCURRED AND LANDSCAPE ARCHITECT HAVE REVIEWED THE FINAL GRADING.
- 4. SOD AREAS WILL BE ACCEPTED WHEN IN COMPLIANCE WITH ALL THE FOLLOWING CONDITIONS:
- 4.1. ROOTS ARE THOROUGHLY KNIT TO THE SOIL 4.2. ABSENCE OF VISIBLE JOINTS
- 4.3. ALL AREAS SHOW A UNIFORM STAND OF SPECIFIED GRASS IN HEALTHY CONDITION
- 4.4. AT LEAST 30 DAYS HAVE ELAPSED SINCE THE COMPLETION OF WORK UNDER THIS SECTION.

# 5. QUALITY GUARANTEE:


- 5.1. SOD SHALL BE UNIFORM IN COLOR, LEAF TEXTURE, LEAF AND ROOD DENSITY, AND FREE FROM WEED, DISEASES, AND OTHER VISIBLE IMPERFECTIONS AT TIME OF FINAL ACCEPTANCE. GUARANTEE DOES NOT COVER DAMAGE AS A RESULT OF FERTILIZERS, PESTICIDES, OR OTHER APPLICATIONS NOT SUPERVISED BY THE CONTRACTOR OR AS A RESULT OF ACTS OF GOD OR VANDALISM.
- 5.2. SEED SHALL BE UNIFORM IN COLOR, LEAF TEXTURE, LEAF AND ROOD DENSITY, AND FREE FROM WEED, DISEASES, AND OTHER VISIBLE IMPERFECTIONS AT TIME OF FINAL ACCEPTANCE. GUARANTEE DOES NOT COVER DAMAGE AS A RESULT OF FERTILIZERS, PESTICIDES, OR OTHER APPLICATIONS NOT SUPERVISED BY THE CONTRACTOR OR AS A RESULT OF ACTS OF GOD OR VANDALISM.
- 6. CONTRACTOR SHALL BE RESPONSIBLE FOR ENSURING THAT THE SEED/SOD IS PROPERLY IRRIGATED DURING THE GROW-IN PERIOD AND SHALL BE RESPONSIBLE IF THE SOD SUFFERS IRREPARABLE HARM.
- 7. SEED/SOD IS SUBJECT TO INSPECTION AND ACCEPTANCE. LANDSCAPE ARCHITECT AND/OR CLIENT RESERVES THE RIGHT TO REJECT AT ANY TIME OR PLACE PRIOR TO ACCEPTANCE, ANY WORK AND SOD WHICH IN THE LANDSCAPE ARCHITECTS OPINION FAILS TO MEET THESE SPECIFICATIONS REQUIREMENTS.

# 8. SOD STANDARDS:

- 8.1. GENERAL: HEALTHY, THICK TURF HAVING UNDERGONE A PROGRAM OF REGULAR FERTILIZATION, MOWING AND WEED CONTROL; FREE OF OBJECTABLE WEEDS; UNIFORM IN GREEN COLOR, LEAF TEXTURE AND DENSITY; HEALTHY, VIGOROUS ROOT SYSTEM; INSPECTED AND FOUND FREE OF DISEASE, NEMATODES, PEST AND PEST LARVAE BY THE ENTOMOLOGIST OF THE STATE DEPARTMENT OF AGRICULTURE.
- 8.2. EACH PIECE OF SOD: SANDY-LOAM SOIL BASE THAT WILL NOT BREAK, CRUMBLE OR TEAR
- DURING SOD INSTALLATION. 8.3. THICKNESS: MINIMUM 3/4" THICK, EXCLUDING THE TOP GROWTH THATCH.
- 8.4. THATCH: NOT TO EXCEED 1/2" UNCOMPRESSED.
- 8.5. SIZE: CUT IN STRIPS 18" WIDE NO MORE THAN 24 HOURS PRIOR TO DELIVERY.

# 9. SOD DELIVERY, STORAGE AND HANDLING GUIDELINES ARE AS FOLLOWS:

- 9.1. SOD SHALL BE DELIVERED ON PALLETS PROPERLY LOADED ON VEHICLES AND WITH ROOT SYSTEM PROTECTED FROM EXPOSURE TO SUN, WIND, AND HEAT IN ACCORDANCE WITH STANDARD PRACTICE AND LABELED WITH BOTANICAL AND COMMON NAME OF EACH GRASS SPECIES IN ACCORDANCE WITH FEDERAL SEED ACT. SOD THAT HAS BEEN DAMAGED BY POOR HANDLING OR IMPROPER STORAGE IS SUBJECT TO REJECTION BY THE LANDSCAPE ARCHITECT OR OWNER.
- PROTECT FROM DEHYDRATION, CONTAMINATION, FREEZING AND HEATING AT ALL TIMES. KEEP STORED SOD MOIST AND UNDER SHADE OR COVERED WITH MOISTENED BURLAP.
- DO NOT DROP SOD ROLLS FROM CARTS, TRUCKS OR PALLETS.
- 9.1.3. DO NOT DELIVER MORE SOD THAN CAN BE INSTALLED WITHIN 36 HOURS.
- 9.1.4. DO NOT STACK SOD MORE THAN 2 FEET DEEP.

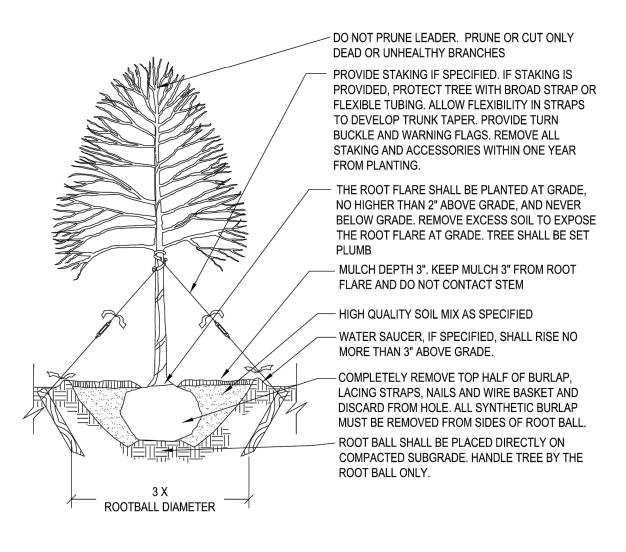

CONTACT INFORMATION: CITY OF RALEIGH PARKS, RECREATION AND CULTURAL RESOURCES DEPARTMENT URBAN FORESTER: TREES@RALEIGHNC.GOV WWW.RALEIGHNC.GOV

# 1. CONTRACTOR IS RESPONSIBLE FOR

- ADEQUATE DRAINAGE OF ALL PLANTING PITS. (POSITIVE DRAINAGE AWAY FROM PIT) 2. ADHERE TO STANDARDS IN THE CITY TREE
- MANUAL. 3. STREET TREES MUST BE 3" CALIPER AT
- INSTALLATION WITH A 5' MINIMUM FIRST BRANCH HEIGHT.
- 4. PLANTING SEASON OCTOBER APRIL 5. A TREE IMPACT PERMIT IS REQUIRED.
- 6. ELECTRICAL OUTLETS AND OTHER UTILITIES ARE PROHIBITED IN THE PLANTING AREA

IMMEDIATELY SURROUNDING THE TREE.

CITY OF RALEIGH STANDARD DETAIL				
REVISIONS	DATE: 8/1/18	NOT TO S		
	TREE PLA	NTING DETAIL		
	TD	D 03		

**TPP-03** 

SET SHRUB 1" HIGHER -

THAN SURROUNDING


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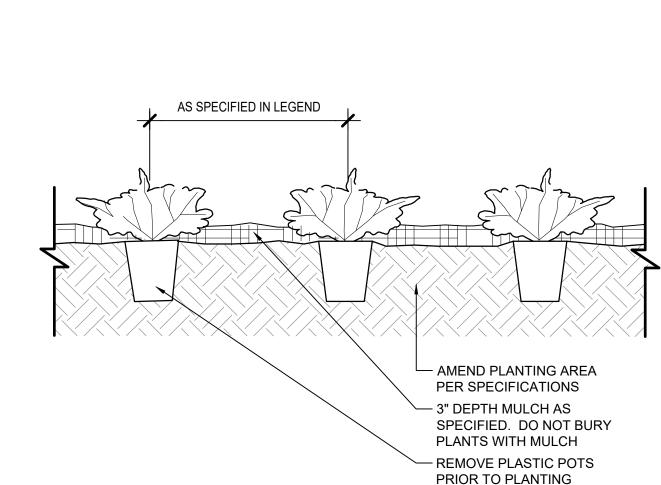
SUBGRADE -

SHOWN ON PLANS

GRADE

**ROW TREE PLANTING** 



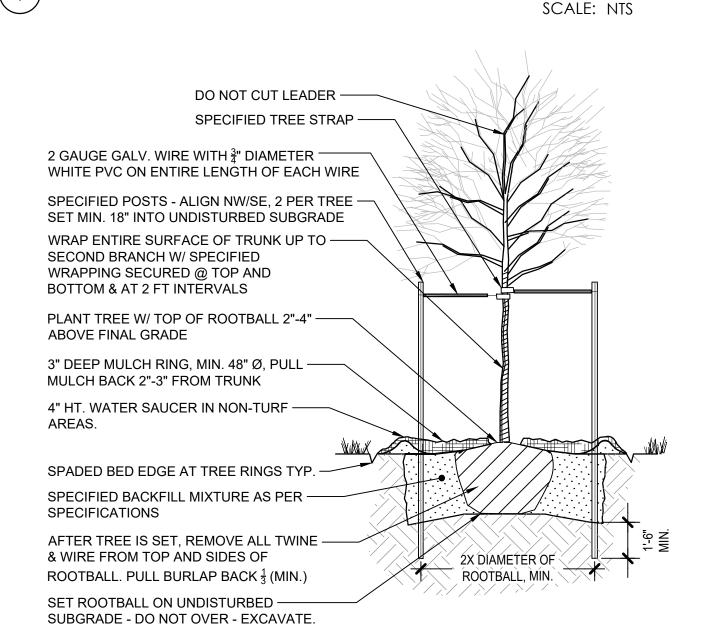


2x DIAMETER OF ROOTBALL, MIN


SHRUB PLANTING

GROUND COVER

TREE PLANTING

SCALE: 1/4'' = 1'-0''

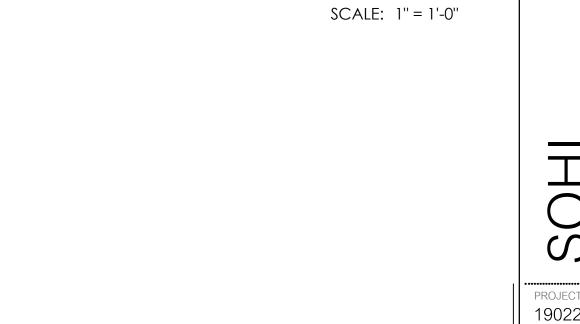

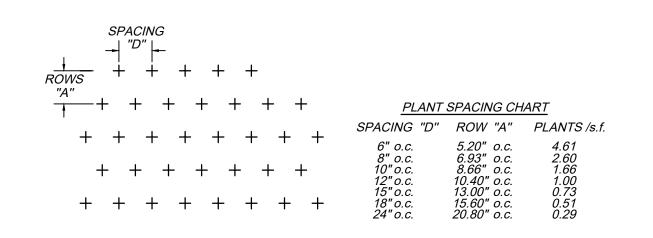

TRIANGULAR SPACING FOR GROUNDCOVERS

SCALE: NTS



PRUNE ALL DAMAGED

**IMMEDIATELY PRIOR** 

- SPECIFIED MULCH

- FILL WITH SPECIFIED

- ROOTBALL. SCORE

ROOTBOUND PLANTS

SCALE: 3/4'' = 1'-0''

SOIL MIX

SIDES OF

ONLY

OR DEAD WOOD

TO PLANTING

3" DEEP



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S S .

PROJECT NUMBER: 19022 PROJECT PHASE: **ADMINISTRATIVE** 

SITE REVIEW DATE: 07.25.2019

SHEET TITLE:

PLANTING NOTES & DETAIL

**L401** 

SHEET NUMBER:



4909 Liles Road Raleigh, NC 27606 919.438.3694 (o) Firm License C-3898

ALL CONSTRUCTION SHALL CONFORM WITH CITY OF RALEIGH STANDARDS AND SPECIFICATIONS.

# CITY OF RALEIGH STANDARD UTILITY NOTES

1. ALL MATERIALS & CONSTRUCTION METHODS SHALL BE IN ACCORDANCE WITH CITY OF RALEIGH DESIGN STANDARDS, DESTAILS, & SPECIFICATIONS (REFERENCE: CORPUD HANDBOOK, CURRENT EDITION).

# 2. UTILITY SEPARATION REQUIREMENTS:

UTILITIES DEPARTMENT PRIOR TO CONSTRUCTION.

SERVICE FROM ROW OR EASEMENT PER CORPUD HANDBOOK PROCEDURE.

- a. A DISTANCE OF 100' SHALL BE MAINTAINED BETWEEN SANITARY SEWER & ANY PRIVATE OR PUBLIC WATER SUPPLY SOURCE SUCH AS AN IMPOUNDED RESERVOIR USED AS A SOURCE OF DRINKING WATER. IF ADEQUATE LATERAL SEPARATION CANNOT BE ACHIEVED, FERROUS SANITARY SEWER PIPE SHALL BE SPECIFIED & INSTALLED TO WATERLINE SPECIFICATIONS. HOWEVER, THE MINIMUM SEPARATION SHALL NOT BE LESS THAN 25' FROM A PRIVATE WELL OR 50' FROM A PUBLIC WELL;
- b. When installing water &/Or sewer mains, the horizontal separation between utilities shall be 10'. If the separation cannot be maintained due to existing conditions, the variation allowed is the water main in a separate trench with the elevation of the water main at least 18" above the top of the sewer & must be approved by the public utilities director. All distances are measured from outside diameter to outside diameter;
- c. Where It is impossible to obtain proper separation, or anytime sanitary sewer passes over a watermain, dip materials or steel encasement extended 10' on each side of crossing must be specified & installed to waterline specifications; d. 5.0' minimum horizontal separation is required between all sanitary sewer & storm sewer facilities, unless dip material is specified for sanitary sewer;
- e. MAINTAIN 18" MIN. VERTICAL SEPARATION AT ALL WATERMAIN & RCP STORM DRAIN CROSSINGS. MAINTAIN 24" MIN. VERTICAL SEPARATION AT ALL SANITARY SEWER & RCP STORM DRAIN CROSSINGS. WHERE ADEQUATE SEPARATIONS CANNOT BE ACHIEVED, SPECIFY DIP MATERIALS & A CONCRETE CRADLE HAVING 6" MIN. CLEARANCE (PER CORPUD DETAILS W-41 & S-49);

  f. ALL OTHER UNDERGROUND UTILITIES SHALL CROSS WATER & SEWER FACILITIES WITH 18" MIN. VERTICAL SEPARATION REQUIRED.

3. ANY NECESSARY FIELD REVISIONS ARE SUBJECT TO REVIEW & APPROVAL OF AN AMENDED PLAN &/OR PROFILE BY THE CITY OF RALEIGH PUBLIC

4. CONTRACTOR SHALL MAINTAIN CONTINUOUS WATER & SEWER SERVICE TO EXISTING RESIDENCES & BUSINESSES THROUGOUT CONSTRUCTION OF PROJECT. ANY NECESSARY SERVICE INTERRUPTIONS SHALL BE PRECEDED BY A 24 HOUR ADVANCE NOTICE TO THE CITY OF RALEIGH PUBLIC UTILITIES DEPARTMENT

5. 3.0' MINIMUM COVER IS REQUIRED ON ALL WATER MAINS & SEWER FORCEMAINS. 4.0' MINIMUM COVER IS REQUIRED ON ALL REUSE MAINS.

6. IT IS THE DEVELOPER'S RESPONSIBILITY TO ABANDON OR REMOVE EXISTING WATER & SEWER SERVICES NOT BEING USED IN REDEVELOPMENT OR A SITE UNLESS OTHERWISE DIRECTED BY THE CITY OF RALEIGH PUBLIC UTILITIES DEPARTMENT. THIS INCLUDES ABANDONING TAP AT MAIN & REMOVAL OF

7. INSTALL WATER SERVICES WITH METERS LOCATED AT ROW OR WITHIN A 2' X 2' WATERLINE EASEMENT IMMEDIATELY ADJACENT. NOTE: IT IS THE APPLICANT'S RESPONSIBILITY TO PROPERLY SIZE THE WATER SERVICE FOR EACH CONNECTION TO PROVIDE ADEQUATE FLOW & PRESSURE.

8. INSTALL SANITARY SEWER SERVICES @ 1.0% MINIMUM GRADE WITH CLEANOUTS LOCATED AT ROW OR EASEMENT LINE & SPACED EVERY 75 LINEAR FEET MAXIMUM.

9. PRESSURE REDUCING VALVES ARE REQUIRED ON ALL WATER SERVICES EXCEEDING 80 PSI; BACKWATER VALVES ARE REQUIRED ON ALL SANITARY SEWER SERVICES HAVING BUILDING DRAINS LOWER THAN 1.0' ABOVE THE NEXT UPSTREAM MANHOLE.

10. ALL ENVIRONMENTAL PERMITS APPLICABLE TO THE PROJECT MUST BE OBTAINED FROM NCDWQ AND USACE &/OR FEMA FOR ANY RIPARIAN BUFFER, WETLAND &/OR FLOODPLAIN IMPACTS (RESPECTIVELY) PRIOR TO CONSTRUCTION.

11. NCDOT / RAILRAOD ENCROACHMENT AGREEMENTS ARE REQUIRED FOR ANY UTILITY WORK (INCLUDING MAIN EXTENSIONS & SERVICE TAPS) WITHIN STATE OR RAILROAD ROW PRIOR TO CONSTRUCTION.

12. GREASE INTERCEPTOR / OIL WATER SEPARATOR SIZING CALCULATIONS & INSTALLATION SPECIFICATIONS SHALL BE APPROVED BY CORPUD FOG PROGRAM COORDINATOR PRIOR TO ISSUANCE OF A BUILDING PERMIT. CONTACT TIM BEASLEY AT (919) 996-2334 OR TIMOTHY.BEASLEY@RALEIGHNC.GOV FOR MORE INFORMATION.

13. CROSS-CONNECTION CONTROL PROTECTION DEVICES ARE REQUIRED BASED ON DEGREE OF HEALTH HAZARD INVOLVED AS LISTED IN APPENDIX-B OF THE RULES GOVERNING PUBLIC WATER SYSTEMS IN NORTH CAROLINA. THESE GUIDELINES AR THE MINIMUM REQUIREMENTS. THE DEVICES SHALL MEET MERICAN SOCIETY OF SANITARY ENGINEERING (ASSE) STANDARDS OR BE ON TEH UNIVERSITY OF SOUTHERN CALIFORNIA APPROVAL LIST. THE DEVICES SHALL BE INSTALLED AND TESTED (BOTH INITIAL AND PERIODIC TESTING THEREAFTER) IN ACCORDANCE WITH THE MANUFACTURER'S RECOMMENDATIONS OR THE LOCAL CROSS-CONNECTION CONTROL PROGRAM, WHICHEVER IS MORE STRINGENT. CONTACT JOANIE HARTLEY AT

# UTILITY NOTES

AND/OR NCDOT.

1. REFER TO GENERAL NOTES ON SHEETS PROVIDED BY SITE COLLABORATIVE.

(919) 996-5923 OR JOANIE.HARTLEY@RALEIGHNC.GOV FOR MORE INFORMATION.

- 2. EXISTING UTILITIES IN CONFLICT WITH PROPOSED IMPROVEMENTS SHALL BE REMOVED OR RELOCATED.
- 3. THIS PLAN IS DIAGRAMMATIC AND REPRESENTS THE APPROXIMATE LOCATION OF PROPOSED UTILITIES UNLESS SPECIFICALLY DIMENSIONED. THE CONTRACTOR SHALL COORDINATE THE ACTUAL AND PROPOSED LOCATION OF UTILITIES TO AVOID CONFLICTS.
- 4. PUBLIC WATER AND SANITARY SEWER LINE SIZES AND MATERIALS ARE BASED ON INFORMATION PROVIDED BY THE CITY OF RALEIGH.
  THE CONTRACTOR SHALL BE RESPONSIBLE FOR FIELD VERIFYING THIS INFORMATION.
  5. THE CONTRACTOR SHALL COORDINATE THE LOCATION OF ALL ELECTRIC, GAS, AND TELEPHONE SERVICE WITH THE APPROPRIATE
- UTILITY COMPANY PRIOR TO BEGINNING CONSTRUCTION. THE CONTRACTOR SHALL PROVIDE CONDUITS AS REQUIRED FOR THESE UTILITIES UNDER PAVED AREAS.

  6. CONTRACTORS MUST COORDINATE ALL SITE UTILITY INSPECTIONS WITH CITY OF RALEIGH PUBLIC UTILITIES INSPECTOR. THE CITY OF
- RALEIGH SHALL BE NOTIFIED BEFORE ANY WORK TAKES PLACE.
- 7. THE CONTRACTOR IS NOT AUTHORIZED TO USE UNMETERED WATER DURING CONSTRUCTION. THE CONTRACTOR SHALL CONTACT THE CITY OF RALEIGH PUBLIC UTILITIES DEPARTMENT FOR TEMPORARY METER AND SERVICE OPTIONS.
- 8. THE CONTRACTOR SHALL COORDINATE THE LOCATION OF ALL WATER AND SANITARY SEWER SERVICES WITH THE BUILDING PLANS PROVIDED BY OTHERS TO ENSURE THE CONNECTION LOCATION AND ELEVATION ARE COORDINATED.

  9. ALL SANITARY SEWER SERVICES SHALL HAVE A MINIMUM SLOPE OF 2.0%.
- 10. THE CONTRACTOR SHALL BE RESPONSIBLE FOR COORDINATING ALL UNDERGROUND UTILITIES TO ENSURE THERE ARE NO CONFLICTS AND THAT ALL UTILITIES MEETING THE MINIMUM CITY OF RALEIGH COVER AND SEPARATION REQUIREMENTS.
- 11. THE CONTRACTOR SHALL BE RESPONSIBLE FOR CONTACTING, COORDINATING, AND PAYMENT FOR ALL NECESSARY LOCATING SERVICES INCLUDING INDEPENDENT LOCATING SERVICES. THE CONTRACTOR SHALL HAVE ALL EXISTING UTILITIES LOCATED AT LEAST 48 HOURS PRIOR TO BEGINNING DEMOLITION, EXCAVATION, OR ANY OTHER FORM OF CONSTRUCTION. THE
- CONTRACTOR SHALL IMMIEDIATELY NOTIFY THE OWNERS REPRESENTATIVES OF ANY DISCREPANCIES OR CONFLICTS.

  12. ALL SUB-SURFACE UTILITIES IDENTIFIED ON THE CONSTRUCTION DOCUMENTS ARE SHOWN IN THEIR APPROXIMATE LOCATION BASED ON SURVEY INFORMATION, FIELD OBSERVATIONS, AND OTHER RECORD DRAWINGS WHICH MAY BE AVAILABLE. THESE
- BASED ON SURVEY INFORMATION, FIELD OBSERVATIONS, AND OTHER RECORD DRAWINGS WHICH MAY BE AVAILABLE. THESE DRAWINGS DO NOT NECESSARILY SHOW ALL EXISTING UTILITIES.

  13. THE CONTRACTOR SHALL MAINTAIN AS-BUILT DRAWINGS TO RECORD THE ACTUAL LOCATION OF ALL PIPING PRIOR TO CONCEALMENT. DRAWINGS WILL BE PROVIDED TO THE OWNER'S REPRESENTATIVE AT REGULAR INTERVALS THROUGHOUT THE
- PROJECT FOR RECORD KEEPING AND AT THE CONCLUSION OF CONSTRUCTION.

  14. IF DEPARTURES FROM THE PROJECT DRAWINGS OR SPECIFICATIONS ARE DEEMED NECESSARY BY THE CONTRACTOR, DETAILS OF SUCH DEPARTURES AND REASONS THERE FOR SHALL BE SUBMITTED TO THE OWNER'S REPRESENTATIVE FOR REVIEW. NO DEPARTURES FROM THE CONTRACT DOCUMENTS SHALL BE MADE WITHOUT THE EXPRESS WRITTEN PERMISSION OF THE OWNER'S
- 15. THE CONTRACTOR SHALL BE RESPONSIBLE FOR THE RELOCATION OF ANY EXISTING UTILITY INFRASTRUCTURE REQUIRED TO COMPLETE ANY PORTION OF CONSTRUCTION. THE CONTRACTOR SHALL ALSO BE RESPONSIBLE FOR THE COORDINATION AND COSTS OF ASSOCIATED WORK.
   16. THE ENGINEER AND/OR OWNER DISCLAIM ANY ROLE IN THE CONSTRUCTION MEANS AND/OR METHODS ASSOCIATED WITH
- THE PROJECT AS SET FORTH IN THESE PLANS.


  17. IF CONSTRUCTION MEANS AND METHODS REQUIRE ANY TEMPORARY LANE CLOSURES OR SIDEWALK CLOSURES ALONG PUBLIC ROADWAYS, THE CONTRACTOR SHALL BE RESPONSIBLE FOR OBTAINING ALL NECESSARY PERMITS FROM THE CITY OF RALEIGH

ATTENTION CONTRACTORS

THE CONSTRUCTION CONTRACTOR RESPONSIBLE FOR THE EXTENSION OF WATER, SEWER, AND/OR REUSE, AS APPROVED IN THESE PLANS, IS RESPONSIBLE FOR CONTACTING THE PUBLIC WORKS DEPARTMENT AT (919) 996-2409, AND THE PUBLIC UTILITIES DEPARTMENT AT (919) 996-5450 AT LEAST TWENTY FOUR HOURS PRIOR TO BEGINNING ANY OF THEIR CONSTRUCTION.

FAILURE TO NOTIFY BOTH CITY DEPARTMENTS IN ADVANCE OF BEGINNING CONSTRUCTION, WILL RESULT IN THE ISSUANCE OF MONETARY FINES, AND REQUIRE REINSTALLATION OF ANY WATER OR SEWER FACILITIES NOT INSPECTED AS A RESULT OF THIS NOTIFICATION FAILURE.

FAILURE TO CALL FOR INSPECTION, INSTALL A DOWNSTRAM PLUG, HAVE PERMITTED PLANS ON THE JOBSITE, OR ANY OTHER VIOLATION OF CITY OF RALEIGH STANDARDS WILL RESULT IN A FINE AND POSSIBLE EXCLUSION FROM FUTURE WORK IN THE CITY OF RALEIGH.

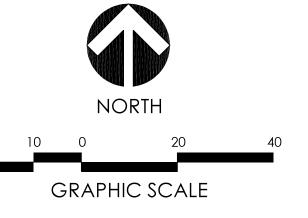

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ai, LLC I S WILMINGTON STREET, RALEIGH, NC 27

PROJECT NUMBER: 19022

PROJECT PHASE:
ADMINISTRATIVE
SITE REVIEW

SSS

DATE: 07.26.2019

07.26.2019


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SHEET TITLE:

SITE UTILITY PLAN

SHEET NUMBER:

C700



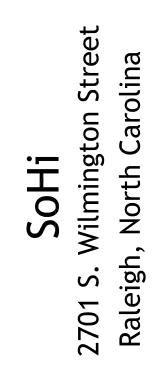


Submission

TURE SUITE 300 T STREET, SUITE CAROLINA 27601 FAX. 919-829-0860 ARCHITE MAURER 115.5 EAST HAF


7.26.19 DR. ШШ

CH. 19055 PROJ. # REVISIONS DATE


Administrative Site Review Proposed Elevations

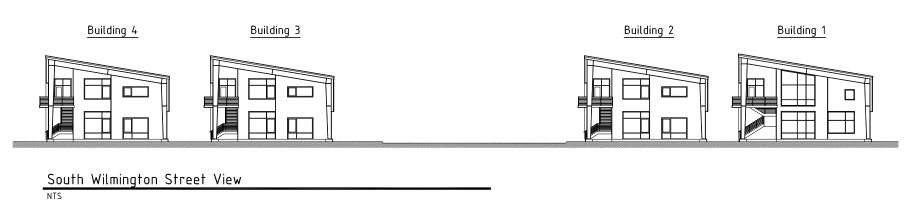

Both 'General' and 'Mixed Use' are shown to illustrate comlinace with each potential use

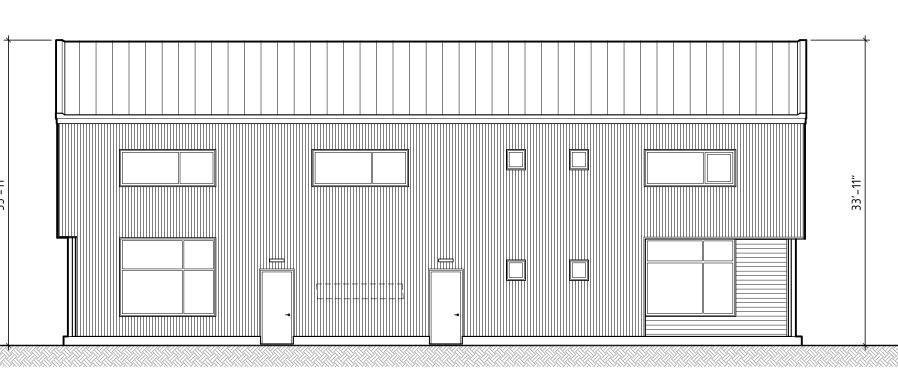

Side Elevation - Building: 1

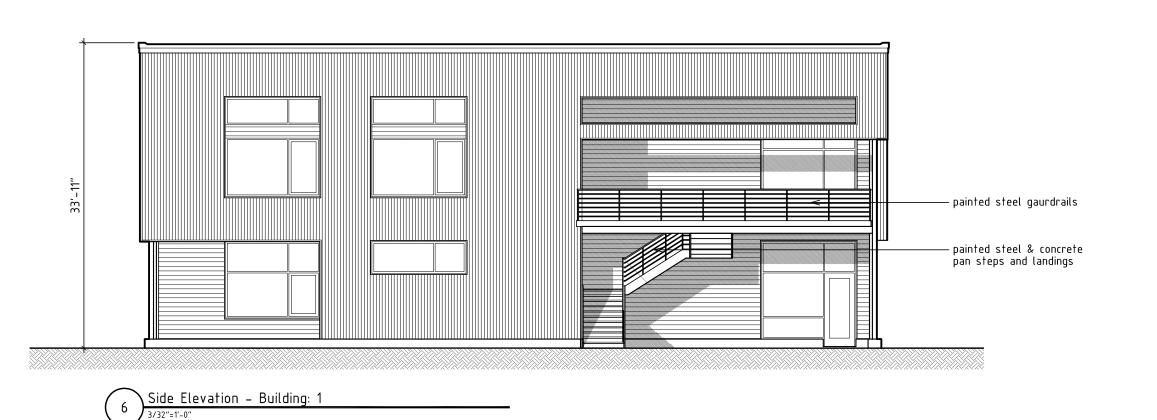

Parking Lot Elevation – Building: 1

