

Administrative Site Review Application

Planning and Development Customer Service Center • One Exchange Plaza, Suite 400 | Raleigh, NC 27601 | 919-996-2500



This form is required when submitting site plans as referenced in Unified Development Ordinance (UDO) Section 10.2.8. Please check the appropriate building types and include the plan checklist document when submitting.

Office Use Only: Case #: _____ Planner (print): _____

Please review UDO Section 10.2.8. to determine the site plan tier. If assistance determining a Site Plan Tier is needed a Site Plan Tier Verification request can be submitted online via the [Permit and Development Portal](#). (Note: There is a fee for this verification service.)

Site Plan Tier: Tier Two Site Plan		Tier Three Site Plan
Building and Development Type (Check all that apply)		Site Transaction History
Detached	General	Subdivision case #: _____
Attached	Mixed use	Scoping/sketch plan case #: _____
Townhouse	Civic	Certificate of Appropriateness #: _____
Apartment	Cottage Court	Board of Adjustment #: _____
Tiny house	Frequent Transit	Zoning Case #: _____
Open lot	Development Option	Design Alternate #: _____
GENERAL INFORMATION		
Development name: _____		
Inside City limits? Yes No		
Property address(es): _____		
Site P.I.N.(s): _____		
Please describe the scope of work. Include any additions, expansions, and uses (UDO 6.1.4). _____		
Current Property Owner(s):		
Company: _____		Title: _____
Address: _____		
Phone #: _____		Email: _____
Applicant Name (If different from owner. See “who can apply” in instructions):		
Relationship to owner: Lessee or contract purchaser Owner’s authorized agent Easement holder		
Company: _____		Address: _____

Phone #:	Email:
NOTE: please attach purchase agreement or contract, lease or easement when submitting this form.	
Developer Contact:	
Company:	Title:
Address:	
Phone #:	Email:
Applicant Name:	
Company:	Address:
Phone #:	Email:

DEVELOPMENT TYPE + SITE DATE TABLE (Applicable to all developments)	
SITE DATA	BUILDING DATA
Zoning district(s) (please provide the acreage of each):	Existing gross floor area (not to be demolished):
Gross site acreage:	Existing gross floor area to be demolished:
# of parking spaces proposed:	New gross floor area:
Max # parking permitted (7.1.2.C):	Total sf gross (to remain and new):
Overlay District (if applicable):	Proposed # of buildings:
Existing use (UDO 6.1.4):	Proposed # of stories for each:
Proposed use (UDO 6.1.4):	Proposed # of basement levels (UDO 1.5.7.A.6)

STORMWATER INFORMATION	
Imperious Area on Parcel(s): Existing (sf) _____ Proposed total (sf) _____	Impervious Area for Compliance (includes ROW): Existing (sf) _____ Proposed total (sf) _____

RESIDENTIAL & OVERNIGHT LODGING DEVELOPMENTS			
Total # of dwelling units:	Total # of hotel bedrooms:		
# of bedroom units: 1br <u>132</u> 2br <u>79</u> 3br <u>22</u> 4br or more <u>0</u>			
# of lots:	Is your project a cottage court?	Yes	No
	A frequent transit development?	Yes	No

Continue to Applicant Signature Block on Page Three.

APPLICANT SIGNATURE BLOCK

Pursuant to state law (N.C. Gen. Stat. § 160D-403(a)), applications for development approvals may be made by the landowner, a lessee or person holding an option or contract to purchase or lease land, or an authorized agent of the landowner. An easement holder may also apply for development approval for such development as is authorized by the easement.

By submitting this application, the undersigned applicant acknowledges that they are either the property owner or one of the persons authorized by state law (N.C.G.S. 160D-403(a)) to make this application, as specified in the application. The undersigned also acknowledges that the information and statements made in the application are correct and the undersigned understands that developments approvals are subject to revocation for false statements or misrepresentations made in securing the development approval, pursuant to N.C. Gen. Stat. § 160D-403(f).


The undersigned indicates that the property owner(s) is aware of this application and that the proposed project described in this application will be maintained in all respects in accordance with the plans and specifications submitted herewith, and in accordance with the provisions and regulations of the City of Raleigh Unified Development Ordinance.

The undersigned hereby acknowledges that, pursuant to state law (N.C.G.S. 143-755(b1)), if this permit application is placed on hold at the request of the applicant for a period of six consecutive months or more, or if the applicant fails to respond to comments or provide additional information requested by the City for a period of six consecutive months or more, then the application review is discontinued and a new application is required to proceed and the development regulations in effect at the time permit processing is resumed shall apply to the new application.

Signature: *Nandy O. Bizzell*

Date:

Printed Name:

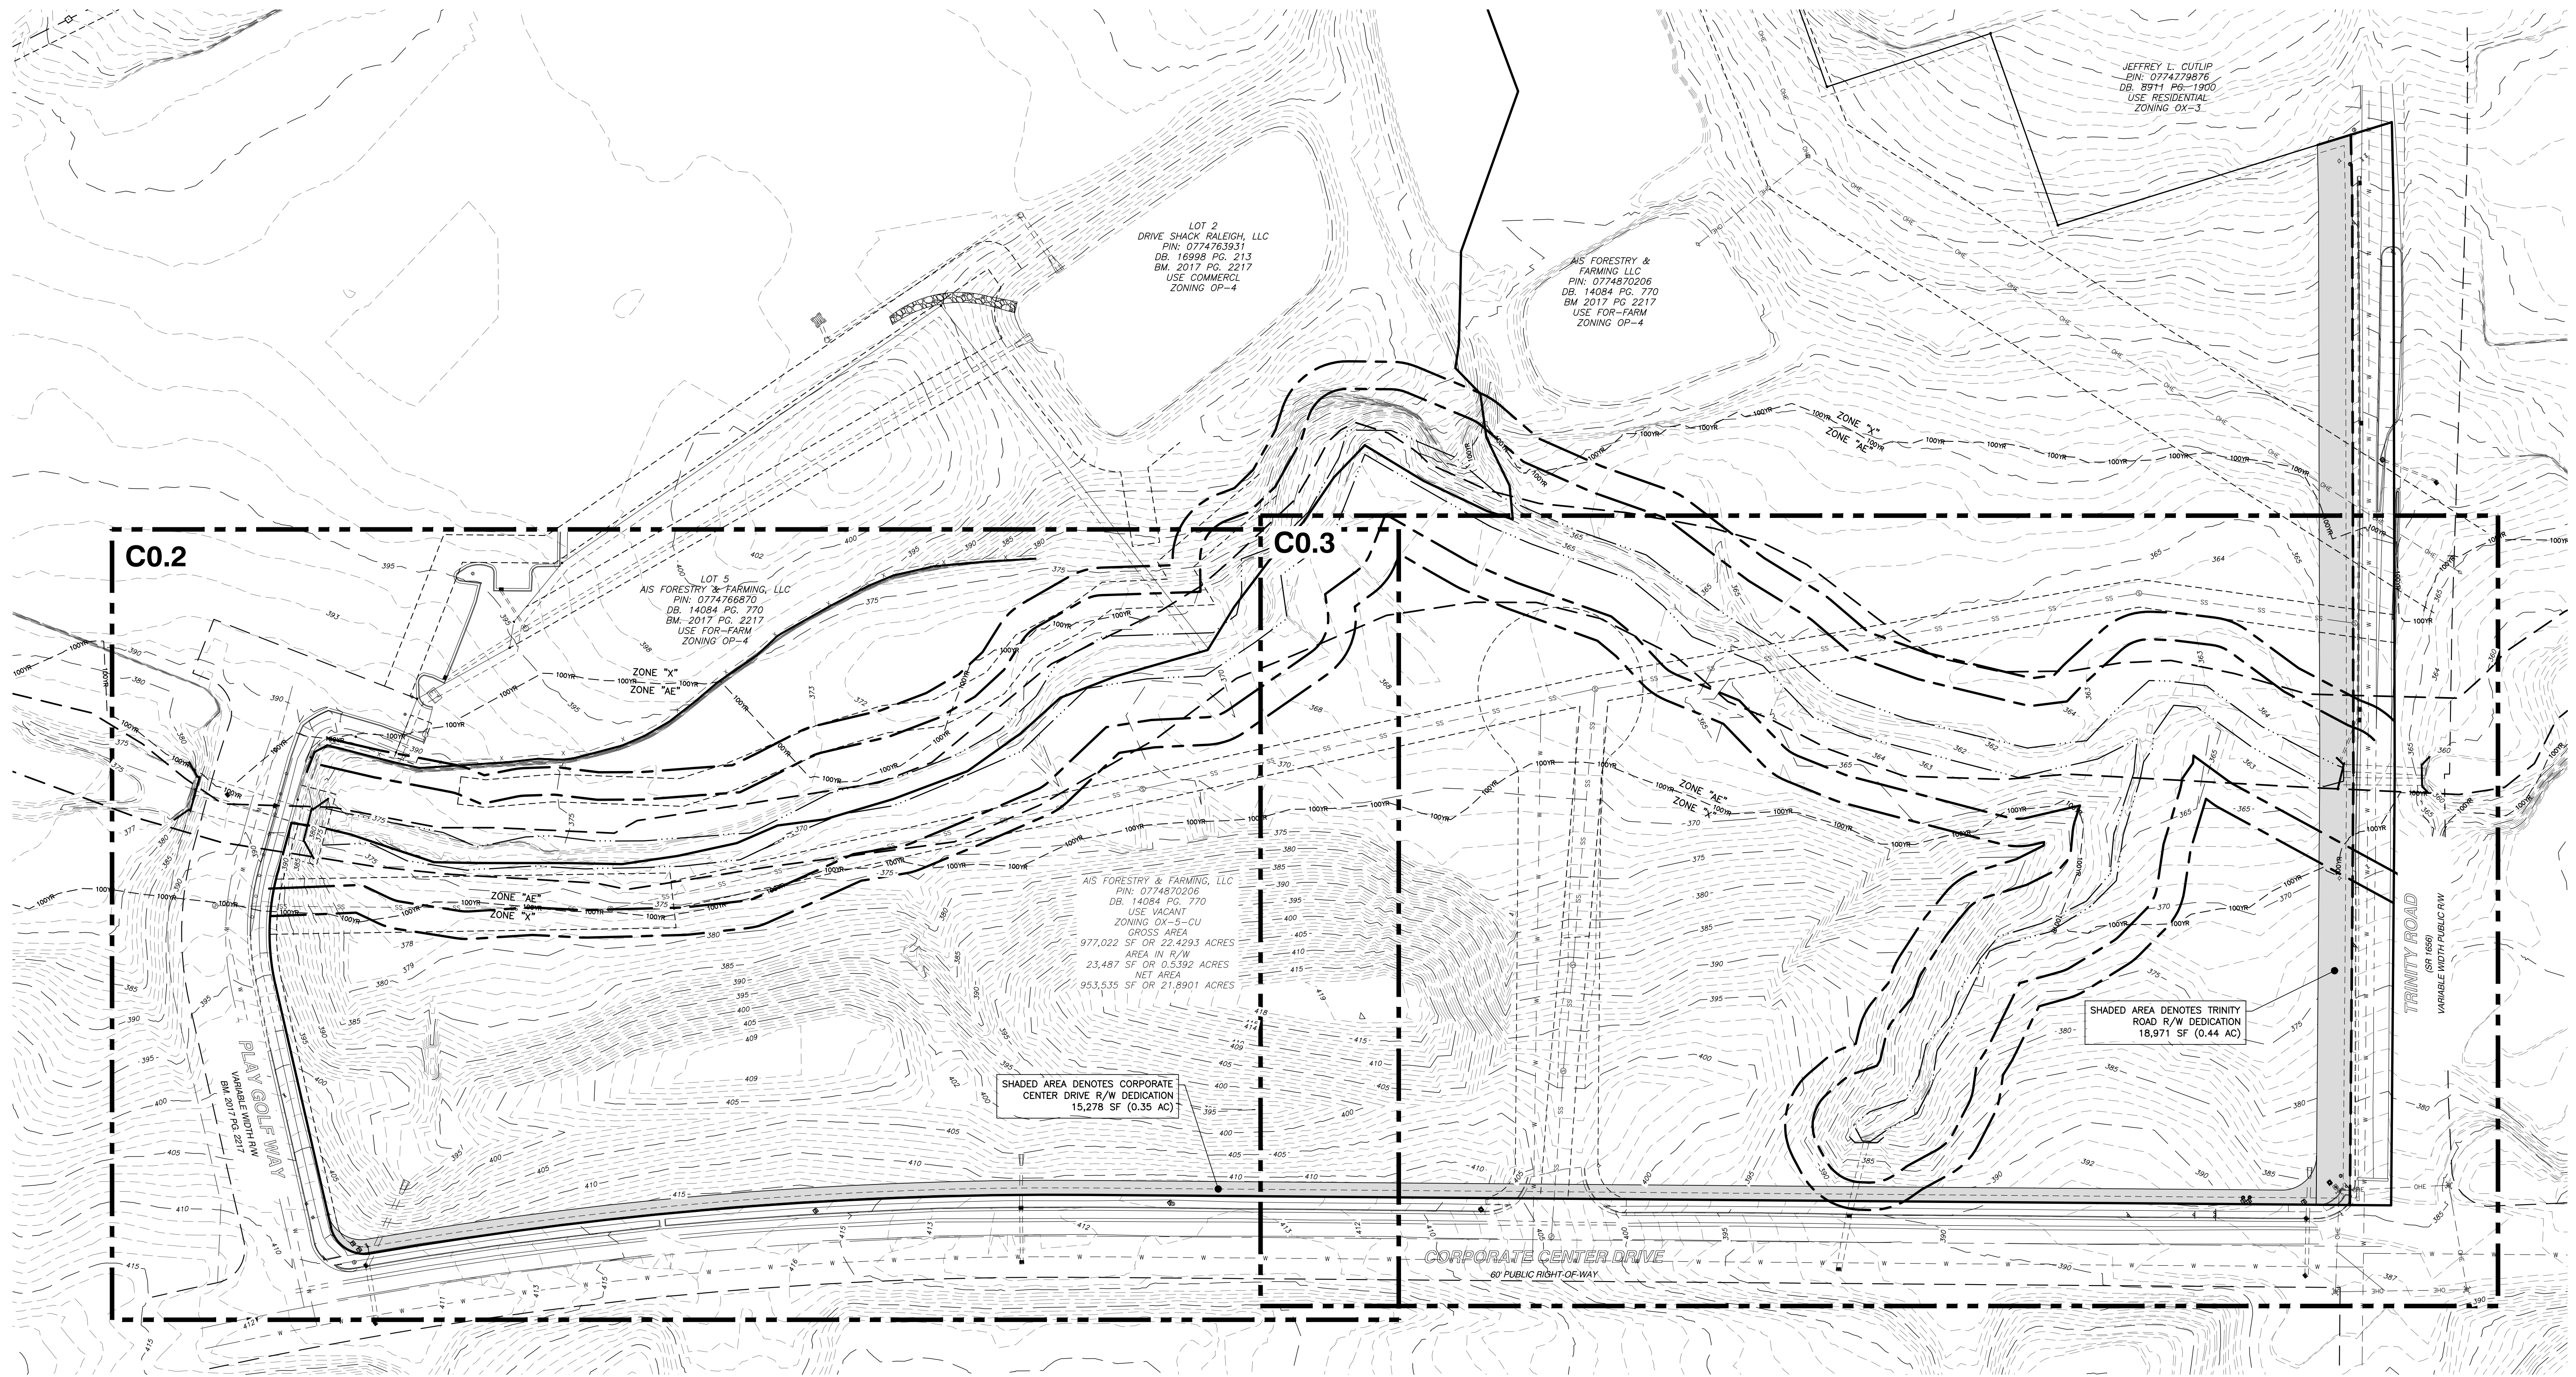

JEFFREY L. CUTLIP
 PIN: 0774779876
 DB: 8971 PG-1900
 USE: RESIDENTIAL
 ZONING OX-3

LOT 2
 DRIVE SHACK RALEIGH, LLC
 PIN: 0774763931
 DB: 16998 PG. 213
 BM: 2017 PG. 2217
 USE COMMERCIAL
 ZONING OP-4

AIS FORESTRY &
 FARMING, LLC
 PIN: 0774870206
 DB: 14084 PG. 770
 BM: 2017 PG. 2217
 USE FOR-FARM
 ZONING OP-4


LOT 5
 AIS FORESTRY & FARMING, LLC
 PIN: 0774768870
 DB: 14084 PG. 770
 BM: 2017 PG. 2217
 USE FOR-FARM
 ZONING OP-4

AIS FORESTRY & FARMING, LLC
 PIN: 0774870206
 DB: 14084 PG. 770
 USE VACANT
 ZONING OX-5-CU
 GROSS AREA
 977,022 SF OR 22,429.3 ACRES
 AREA IN R/W
 23,487 SF OR 0.5392 ACRES
 NET AREA
 953,535 SF OR 21,890.1 ACRES

SHADED AREA DENOTES CORPORATE
 CENTER DRIVE R/W DEDICATION
 15,278 SF (0.35 AC)

SHADED AREA DENOTES TRINITY
 ROAD R/W DEDICATION
 18,971 SF (0.44 AC)

NO WETLANDS EXIST ON-SITE
 FLOODPLAINS EXIST ON-SITE
 NOTE: ALL CONSTRUCTION ACTIVITY SHALL
 BE IN ACCORDANCE WITH CITY OF RALEIGH
 AND NCDOT STANDARDS AND
 SPECIFICATIONS AS APPLICABLE.

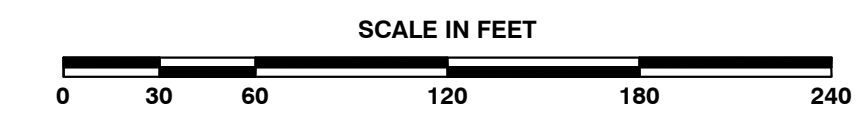

BASS, NIXON & KENNEDY, INC.
CONSULTING ENGINEERS
 6310 CHAPEL HILL ROAD, SUITE 250, RALEIGH, NC 27607
 TELEPHONE: (919)861-4422 FAX: (919)861-8868
 CERTIFICATION NUMBERS: NCBELS (C-0110), NCBOLA (C-0267)

NO.	DATE	DESCRIPTION	BY


RAB	DATE	DRAWN BY
03-23093	05-08-2023	

**CORPORATE CENTER
 DRIVE APARTMENTS**
1101 CORPORATE CENTER DRIVE
 CITY OF RALEIGH, WAKE COUNTY, NORTH CAROLINA

SHEET
C0.1


NOT RELEASED FOR CONSTRUCTION OR BID SOLICITATION

R:\2023\23093 - Corporate Center Drive Apartments\CIVIL\03 Preliminary\001 - 23093_Ex Conditions.dwg, Overall, 9/7/2023 4:01:51 PM, robert.burgoon

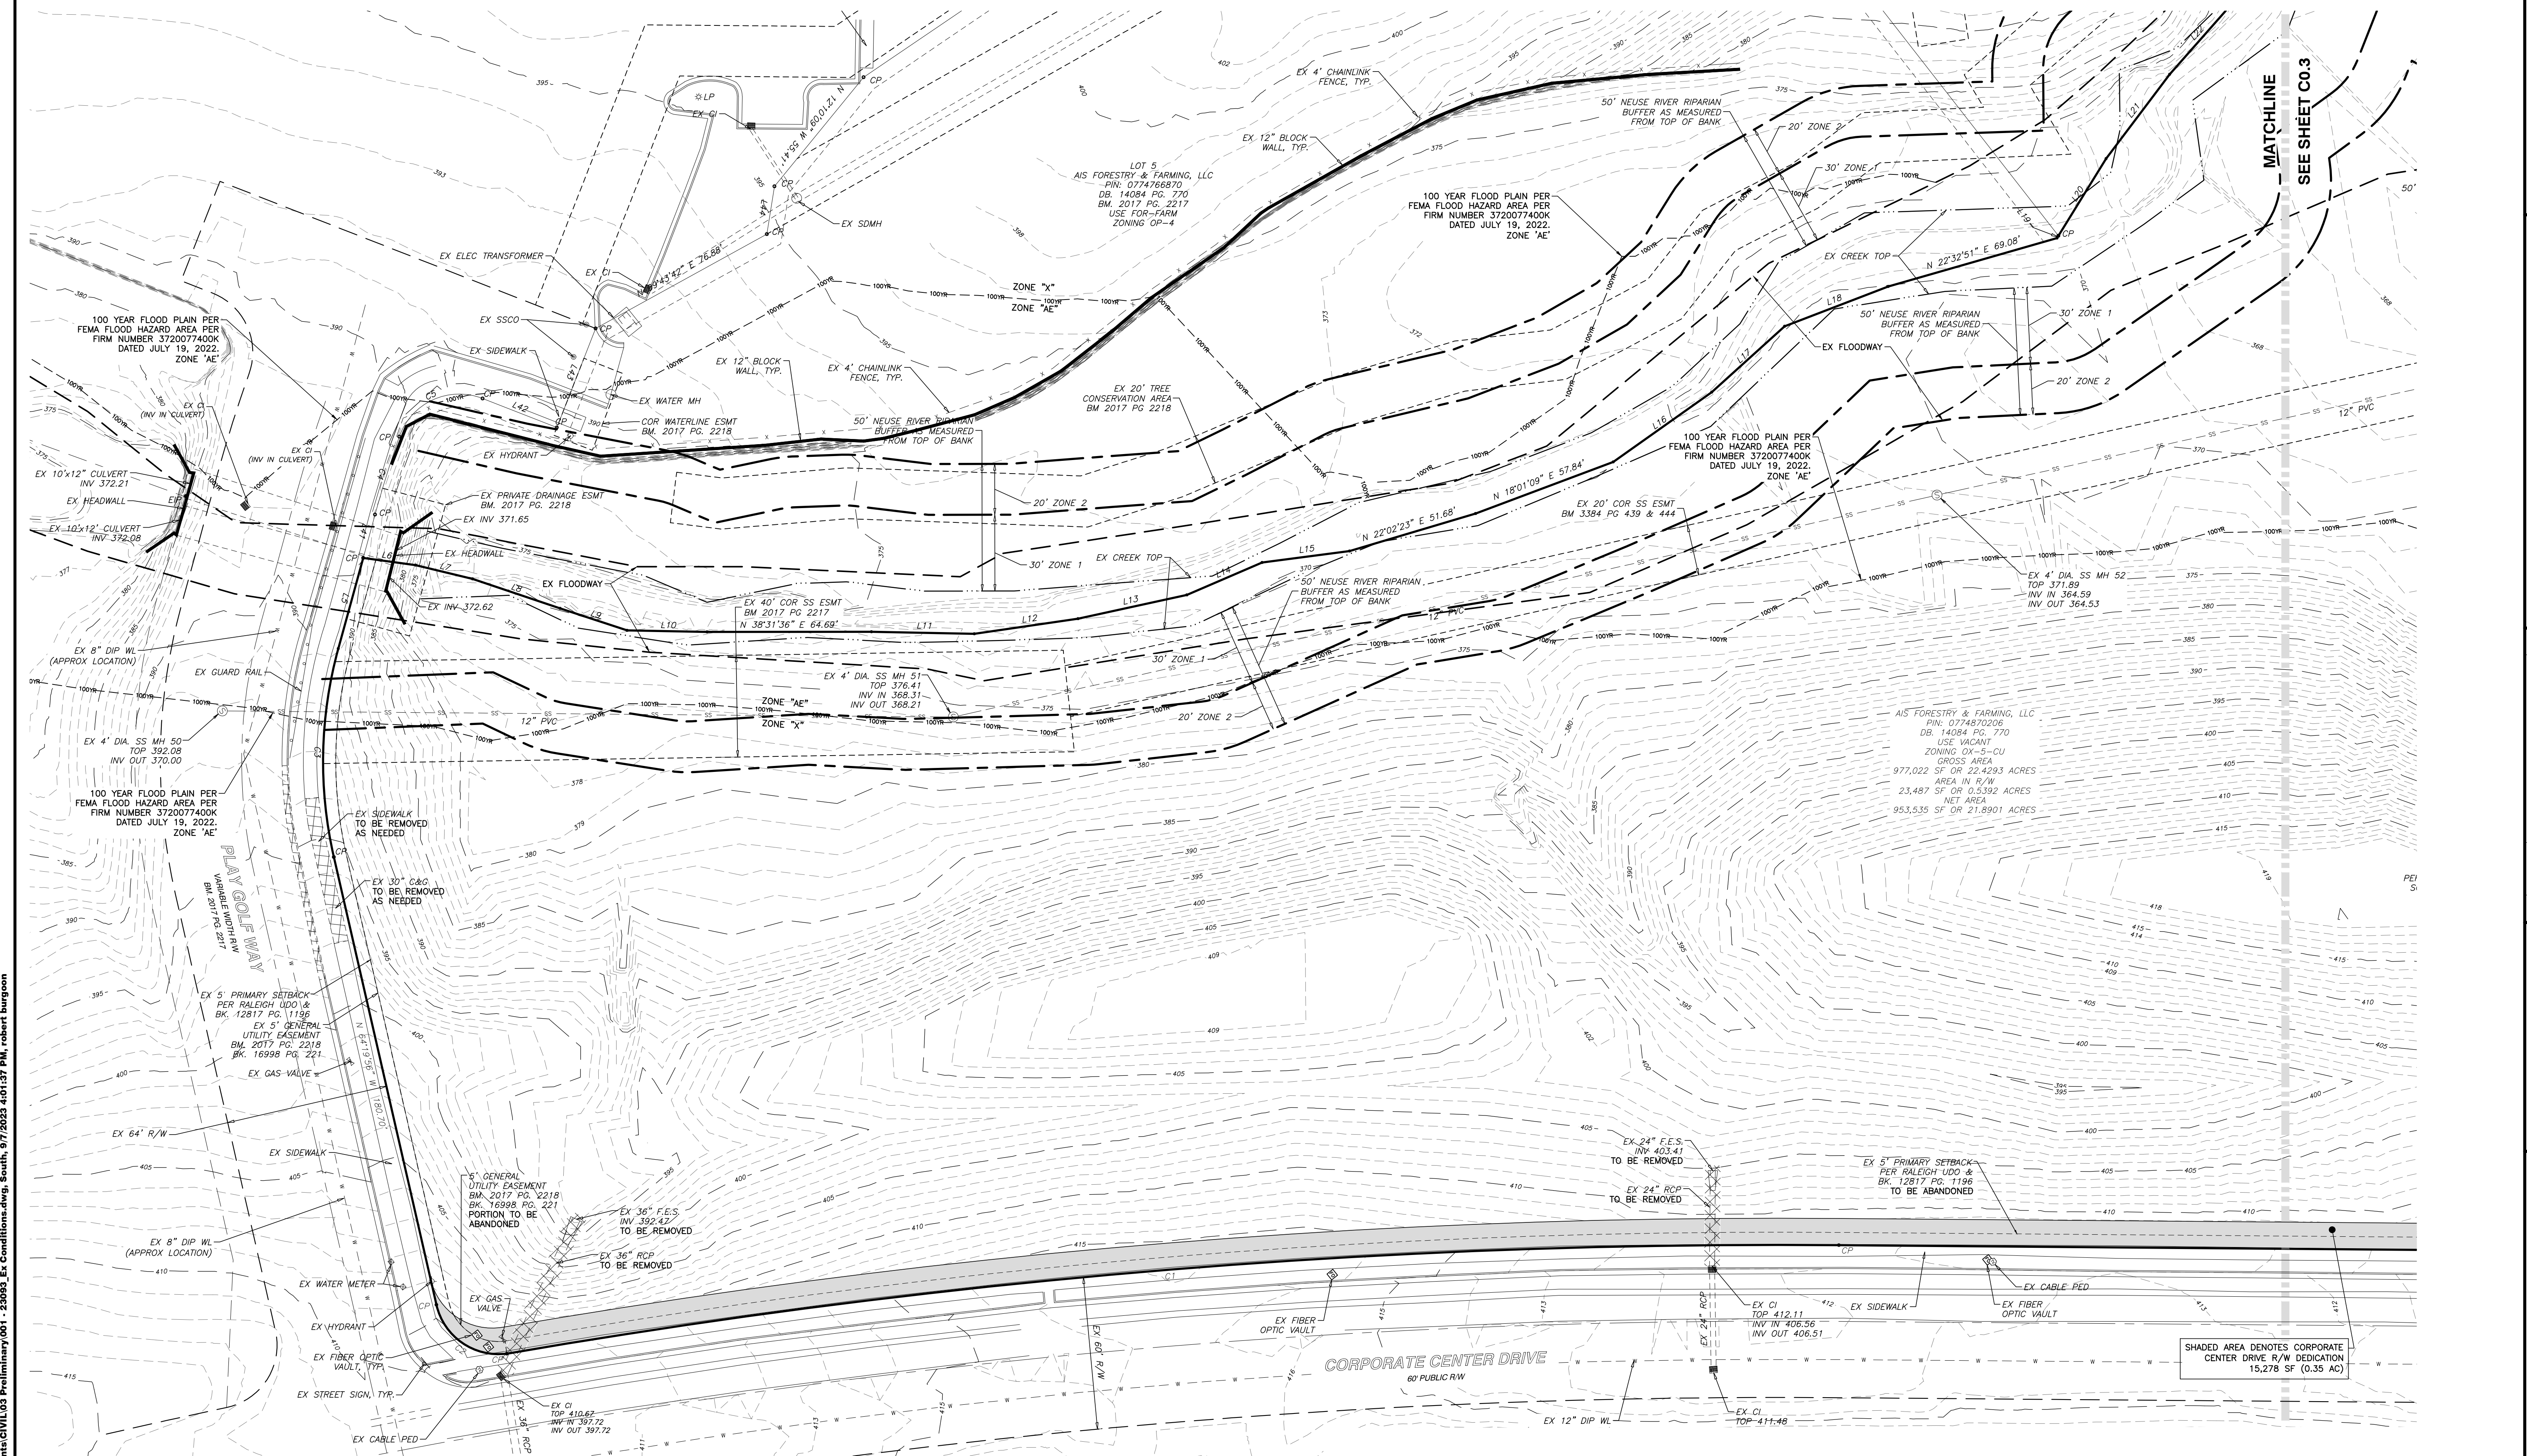


BOUNDARY LINE TABLE		BOUNDARY LINE TABLE			
LINE	BEARING	DISTANCE	LINE	BEARING	DISTANCE
L1	N 58°11'34" W	28.83'	L23	N 16°55'04" W	39.29'
L2	N 66°36'07" W	25.23'	L24	N 07°29'09" W	32.27'
L3	N 20°16'28" E	18.25'	L25	N 09°48'43" E	40.86'
L4	S 25°17'26" W	36.56'	L26	N 55°08'15" E	19.39'
L5	N 36°04'26" W	36.98'	L27	N 56°50'15" W	24.49'
L6	N 46°25'25" E	20.86'	L28	N 77°18'05" W	20.91'
L7	N 52°13'32" E	23.02'	L29	N 77°12'16" W	18.05'
L8	N 57°07'58" E	36.31'	L30	N 59°08'11" W	32.16'
L9	N 56°45'35" E	27.74'	L31	S 04°14'13" W	25.93'
L10	N 39°42'13" E	31.46'	L32	N 43°07'51" W	17.26'
L11	N 39°40'12" E	40.41'	L33	N 49°58'27" W	41.66'
L12	N 30°17'16" E	41.23'	L34	N 50°08'48" W	26.06'
L13	N 26°15'51" E	43.83'	L35	N 71°49'50" W	28.21'
L14	N 15°16'40" E	32.24'	L36	N 74°12'32" W	44.67'
L15	N 31°04'07" E	34.68'	L37	N 45°15'05" W	33.38'
L16	N 03°15'06" E	47.48'	L38	N 65°15'04" W	45.37'
L17	N 03°33'59" W	38.67'	L39	N 40°16'31" W	22.28'
L18	N 17°35'46" E	43.64'	L40	N 49°09'27" W	27.37'
L19	N 19°43'31" W	11.07'	L41	N 36°04'26" W	17.66'
L20	N 19°43'31" W	35.68'	L42	N 59°57'16" E	31.38'
L21	N 14°22'47" W	41.50'	L43	N 30°02'44" W	41.87'
L22	N 10°03'35" W	38.39'	L44	N 42°23'43" W	19.05'

BOUNDARY CURVE TABLE			
CURVE	RADIUS	LENGTH	CHORD DIRECTION
C1	2,943.04'	526.42'	S 33°54'47" W 525.71'
C2	25.00'	36.97'	S 73°20'57" W 33.69'
C3	168.00'	82.86'	N 50°12'17" W 82.02'
C4	468.00'	32.13'	N 34°06'27" W 32.12'
C5	25.00'	40.19'	N 13°54'24" E 36.00'

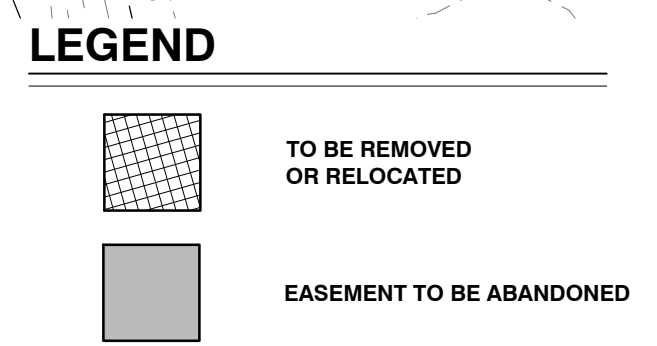

NO WETLANDS EXIST ON-SITE
FLOODPLAINS EXIST ON-SITE
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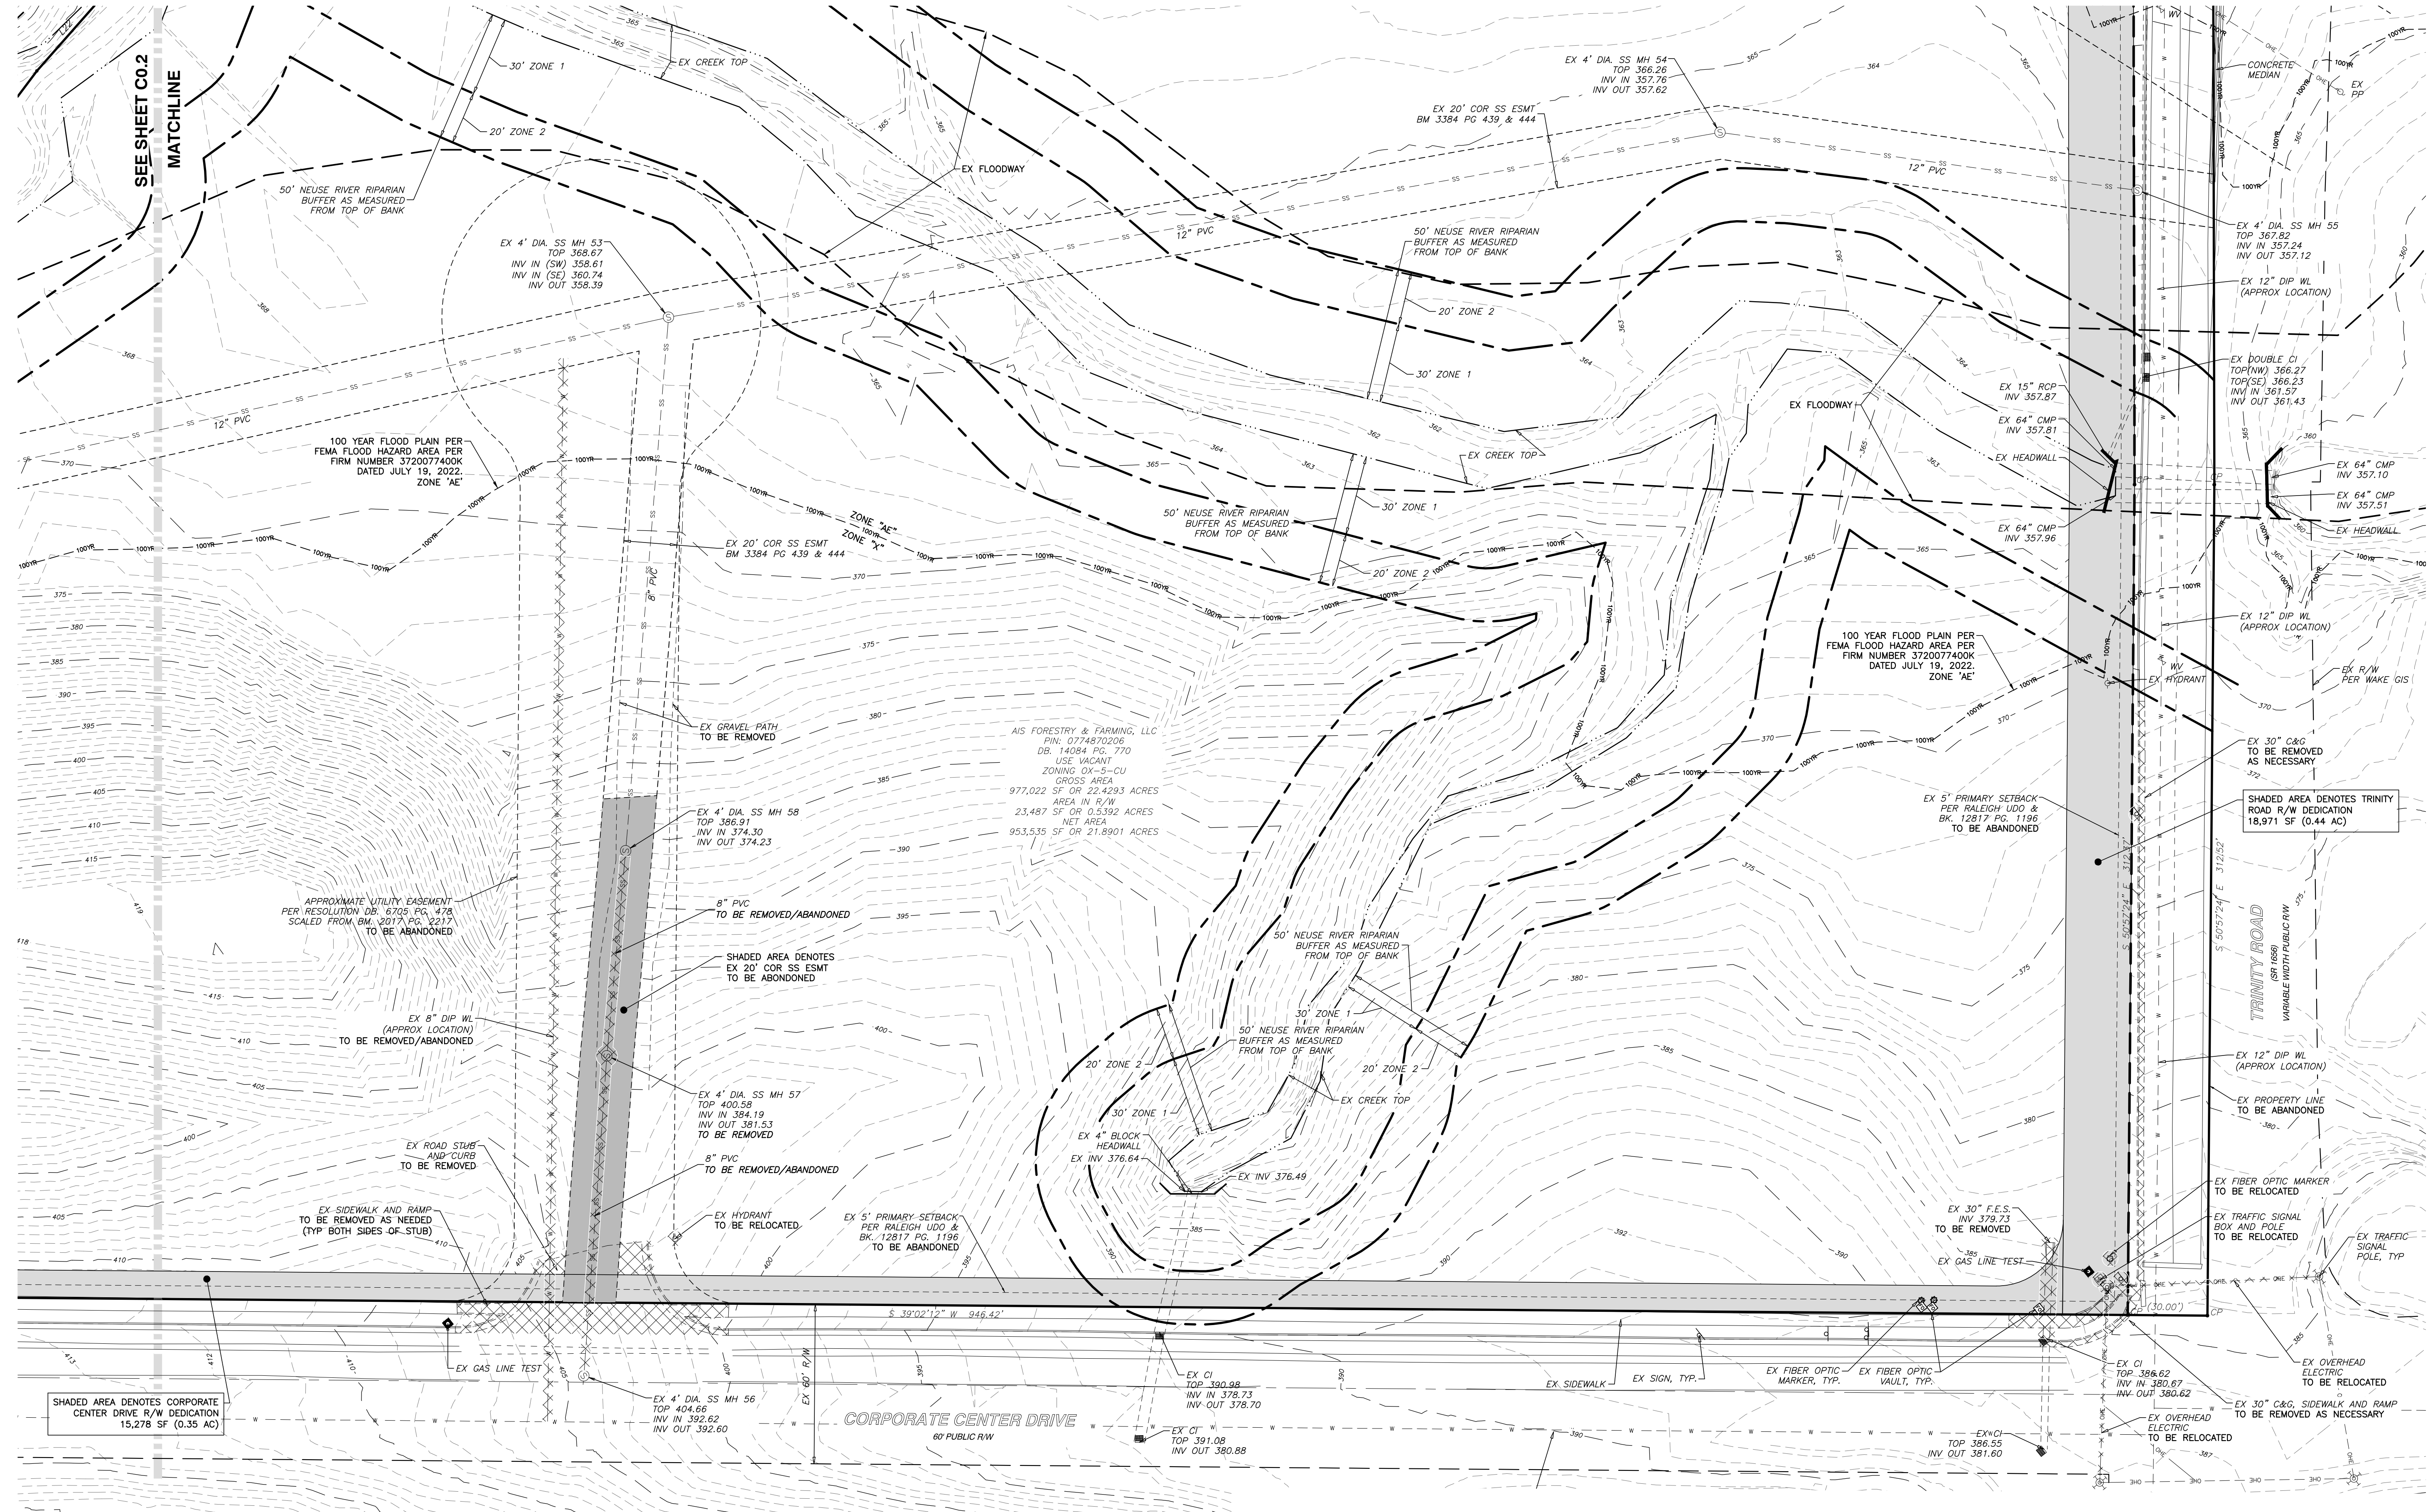
BASS, NIXON & KENNEDY, INC.
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 TELEPHONE: (919)861-4422 FAX: (919)861-8868
 CERTIFICATION NUMBERS: NCBELS (C-0110), NCBOLA (C-0267)

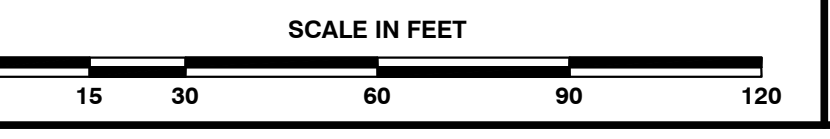ENLARGED EXISTING CONDITIONS & DEMOLITION PLAN - SOUTH

DATE: 05-06-2023
 DRAWN BY: RAB
 CHECKED BY: MDB

CORPORATE CENTER DRIVE APARTMENTS
1101 CORPORATE CENTER DRIVE
 CITY OF RALEIGH, WAKE COUNTY, NORTH CAROLINA

SHEET C0.2



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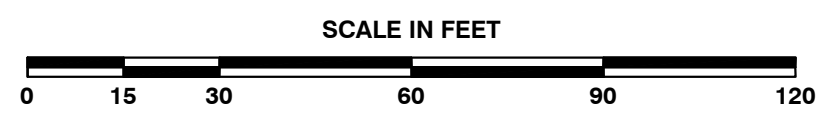
LEGEND

- TO BE REMOVED OR RELOCATED
- EASEMENT TO BE ABANDONED

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FLOODPLAINS EXIST ON-SITE
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 CERTIFICATION NUMBERS: NCBSLS (C-0110), NCBOLA (C-0267)

NO.	DATE	DESCRIPTION	BY

RAB: MDB
 DATE: 08-08-2023
 DRAWN BY: MDB
ENLARGED EXISTING CONDITIONS AND DEMOLITION PLAN - NORTH
 JOB NO.: 23093
 SCALE: 1" = 30'
 CHK BY: MDB

CORPORATE CENTER DRIVE APARTMENTS
1101 CORPORATE CENTER DRIVE
 CITY OF RALEIGH, WAKE COUNTY, NORTH CAROLINA

SHEET C0.3


NO.	DATE	DESCRIPTION	BY

03-23093	09-08-2023	RAB	
JOB NO.	DATE	DRAWN BY	
OVERALL SITE PLAN			
SCALE: 1" = 60'	CHK BY: MDB		

CORPORATE CENTER DRIVE APARTMENTS
1101 CORPORATE CENTER DRIVE
CITY OF RALEIGH, WAKE COUNTY, NORTH CAROLINA

SHEET **C1.0**

NOT RELEASED FOR CONSTRUCTION OR BID SOLICITATION

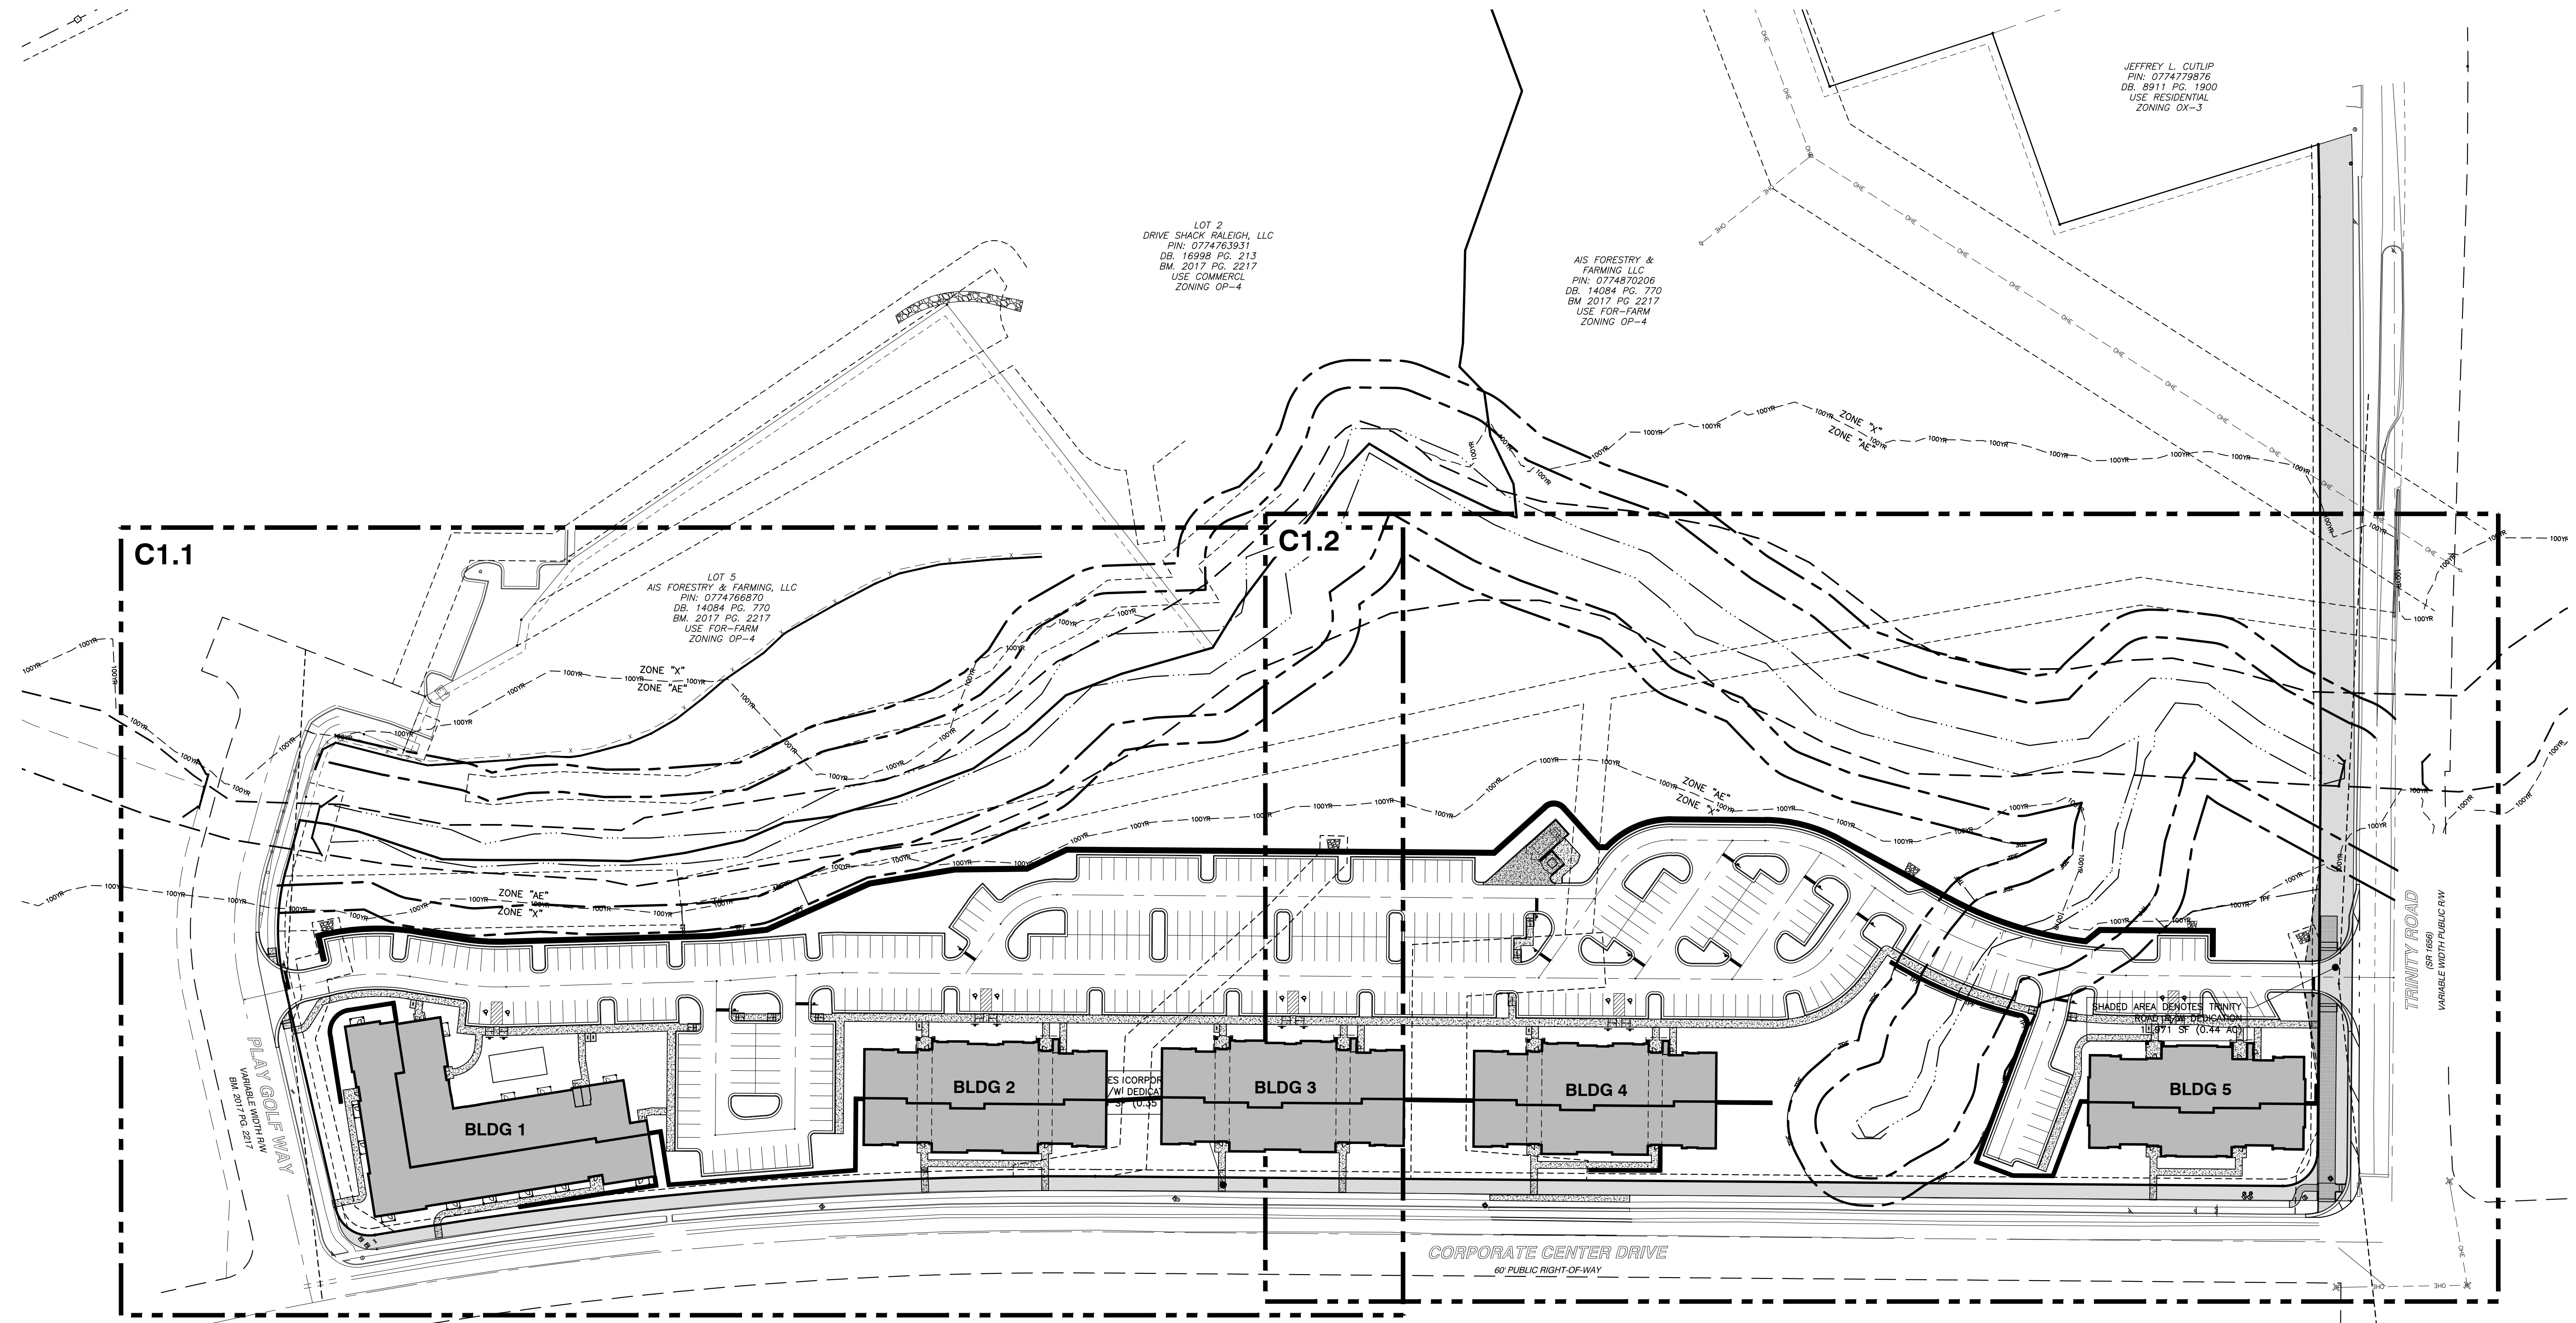

SITE DATA

PROJECT NAME: CORPORATE CENTER DRIVE APARTMENTS
PIN: 0774-87-0206
REAL ID NUMBER: 0206491
ADDRESS: 1101 CORPORATE CENTER DRIVE, RALEIGH, NORTH CAROLINA
ZONING: OX-5-CU W/SHOD-1 OVERLAY
FRONTAGE TYPE: N/A
BUILDING SETBACKS:
PRIMARY STREET: 5 FT SIDE LOT: 0 FT OR 6 FT
SIDE STREET: 5 FT REAR LOT: 0 FT OR 6 FT
USE:
EXISTING: VACANT
PROPOSED: APARTMENTS
SITE AREA:
EXISTING: 22.4293 AC
GROSS: 0.5392 AC
NET: 21.8901 AC
PROPOSED: 21.8901 AC
EXISTING NET: 0.3507 AC
R/W DEDICATION (CORPORATE CENTER DR): 0.4355 AC
R/W DEDICATION (TRINITY RD): 21.1039 AC
AMENITY AREA:
REQUIRED (10% OF SITE GROSS AREA): 0.1 x 21.89 AC = 2.19 AC
PROVIDED: 1.36 AC
ACTIVE: 7.41 AC
PASSIVE: 8.77 AC (40%)

BUILDING AREA:

BUILDING #	BASEMENT	1ST FLOOR	2ND FLOOR	3RD FLOOR	4TH FLOOR	TOTAL
BUILDING #1:	8,665 GSF	19,042 GSF	19,082 GSF	19,082 GSF	18,915 GSF	84,786 GSF
BUILDING #2:	7,287 GSF	12,993 GSF	13,091 GSF	13,091 GSF	13,091 GSF	59,553 GSF
BUILDING #3:	7,287 GSF	12,993 GSF	13,091 GSF	13,091 GSF	13,091 GSF	59,553 GSF
BUILDING #4:	7,287 GSF	12,993 GSF	13,091 GSF	13,091 GSF	13,091 GSF	59,553 GSF
BUILDING #5:	6,275 GSF	11,042 GSF	11,127 GSF	11,127 GSF	11,127 GSF	50,698 GSF

UNIT DATA:

BUILDING #	UNITS
BUILDING #1:	62 UNITS
BUILDING #2:	45 UNITS
BUILDING #3:	45 UNITS
BUILDING #4:	45 UNITS
BUILDING #5:	38 UNITS
TOTAL:	233 UNITS


RESIDENTIAL DENSITY: (233 UNITS/21.89 AC) 10.64 UNITS/AC

PARKING CALCULATIONS:

UNIT TYPE	SPACES PER UNIT	TOTAL SPACES
0-1 BDRM UNIT (1.5 SPACES PER UNIT):	1.5 x 132 UNITS	198 SPACES
2 BDRM UNIT (2.25 SPACES PER UNIT):	2.25 x 79 UNITS	178 SPACES
3 BDRM UNIT (3 SPACES PER UNIT):	3 x 22 UNITS	66 SPACES
TOTAL REQUIRED:		442 MAXIMUM SPACES
PROVIDED PARKING:		349 SPACES
REQUIRED BICYCLE PARKING (1 SPACE PER 20 UNITS):	233 UNITS/20 =	12 SPACES
PROVIDED BICYCLE PARKING:		14 SPACES


IMPERVIOUS: EXISTING: 0 AC
PROPOSED: 5.14 AC

DISTURBED AREA: 7.93 AC

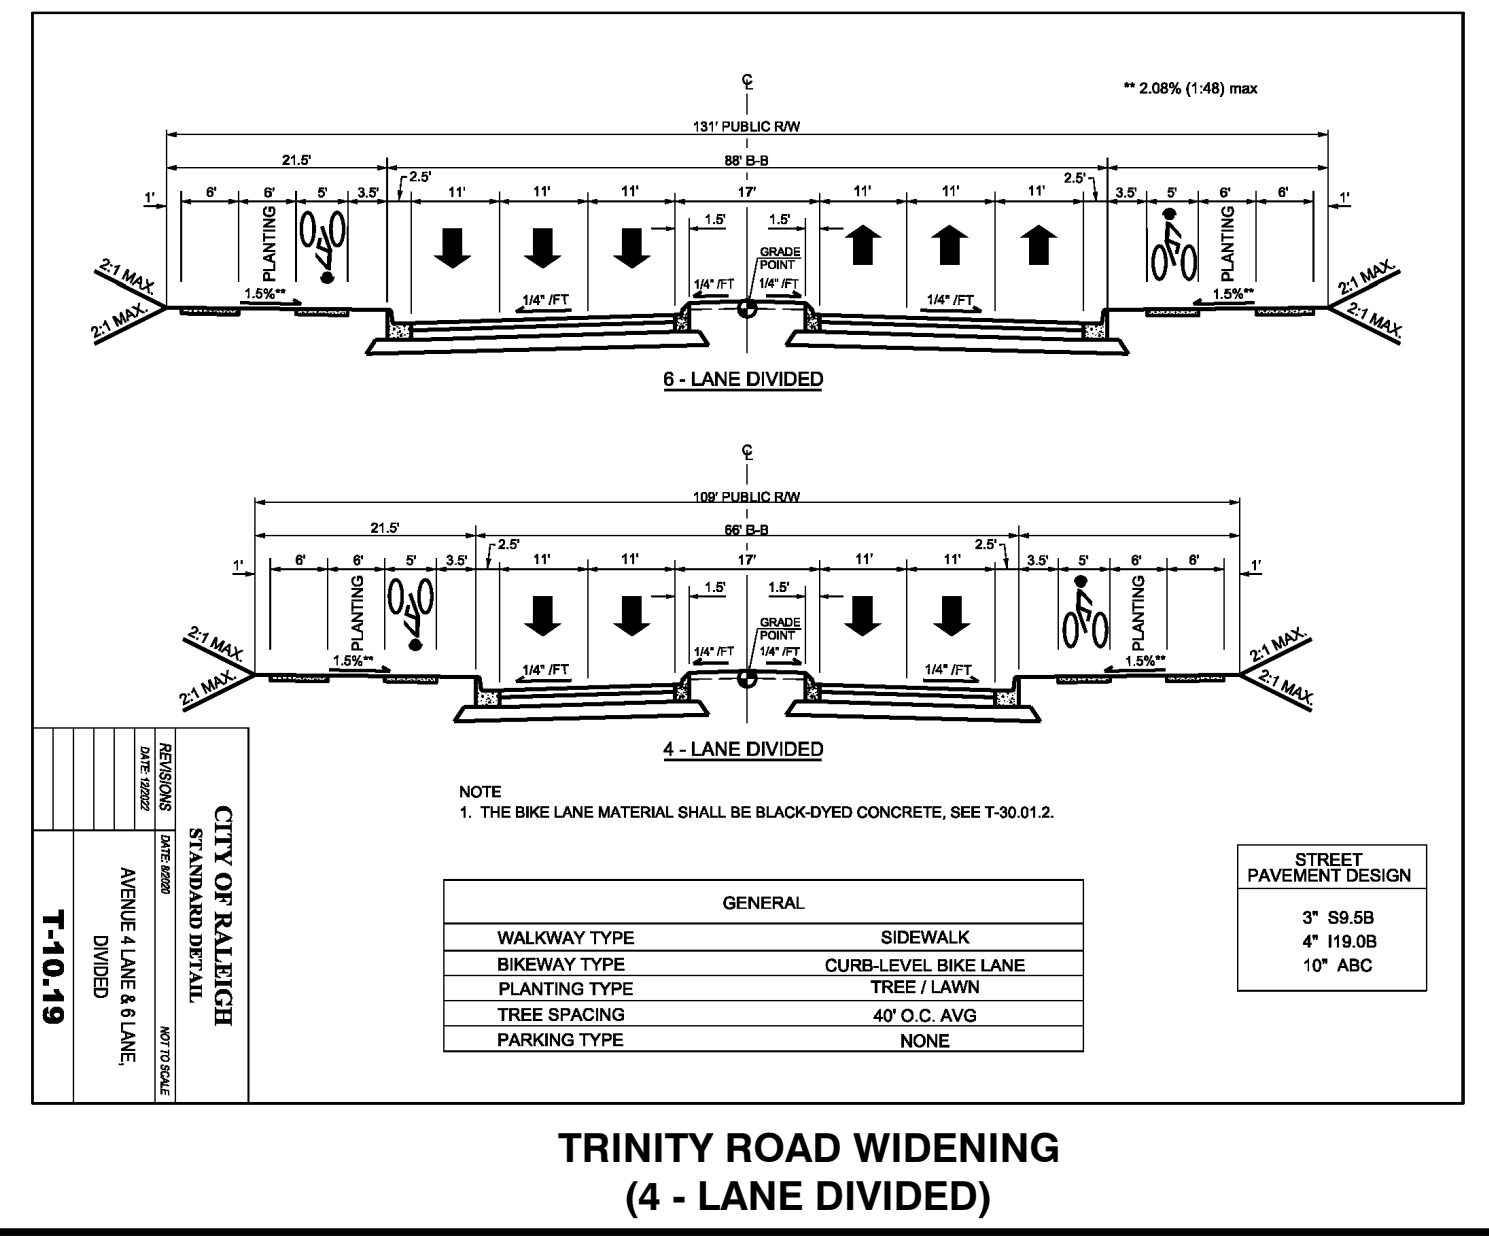

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SEE SHEETS TC1.1 AND TC1.2 FOR TREE CONSERVATION AND AMENITY AREAS

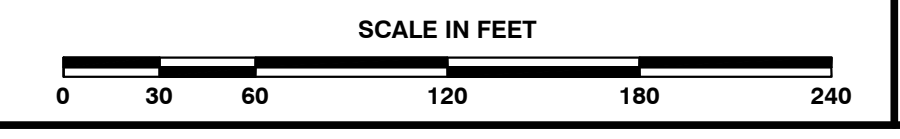





SIGHT DISTANCE CALCULATIONS

$d=1.47vt$
 Where: d =sight distance (ft)
 t =go time (sec) $t_{90}=6.5$ sec
 $t_{180}=7.5$ sec
 v =design speed (mph)
 Site Drive and Play Golf Way: $v=40$ mph (Posted 35 mph)
 Right Turn (Looking Left): $d=1.47(40)(6.5)=382'$
 Left Turn (Looking Right): $d=1.47(40)(7.5)=441'$
 Site Drive and Trinity Road: $v=45$ mph (Posted 40 mph)
 Right Turn (Looking Left): $d=1.47(45)(6.5)=430'$
 Left Turn (Looking Right): $d=1.47(45)(7.5)=496'$

TRAFFIC CONTROL NOTES

- ALL SITE SIGNAGE SHALL BE ACCORDANCE WITH THE MANUAL ON UNIFORM TRAFFIC CONTROL DEVICES (MUTCD) AND NCDOT STANDARDS.
- ALL SIGNS SHALL BE MOUNTED WITH 5-FT MIN. VERTICAL CLEARANCE TO THE BOTTOM OF THE SIGN ON 2LB GALVANIZED STEEL U-CHEMEL POST SET IN 3FT DEEP x 12IN DIA. CONCRETE FOOTING.
- ALL PAVEMENT MARKINGS SHALL BE IN ACCORDANCE WITH THE MUTCD AND NCDOT STANDARDS AND THE PROJECT SPECIFICATIONS.
- ALL PAVEMENT MARKINGS SHALL BE THERMOPLASTIC TYPE EXCEPT FOR PARKING SPACE WHICH MAY BE THERMOPLASTIC OR ALKYD-RESIN TYPE PAINT.

MARKING	NCDOT STD.	SIZE	COLOR
PARKING SPACES	1205.08	4IN	WHITE
DIRECTIONAL ARROWS	1205.07	STD.	WHITE
HIGH-VISIBILITY CROSSWALK	1205.07	STD.	WHITE
STANDARD CROSSWALK	1205.01	STD.	WHITE
STOP BAR	1205.01	4IN	WHITE
EDGE LINES	1205.01	4IN	WHITE
EDGE LINES	1205.01	4IN	YELLOW
DIAGONAL GORE LINE (>45MPH)	1205.09	12IN	WHITE/YELLOW

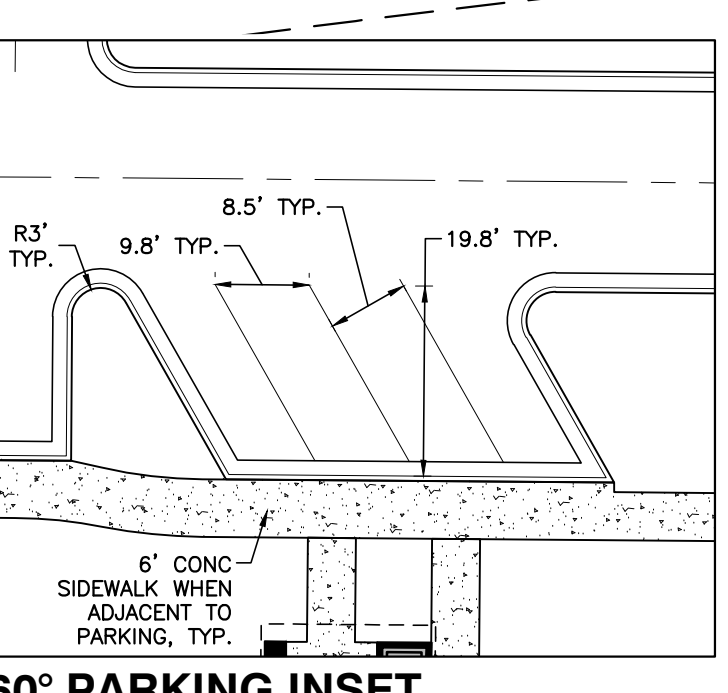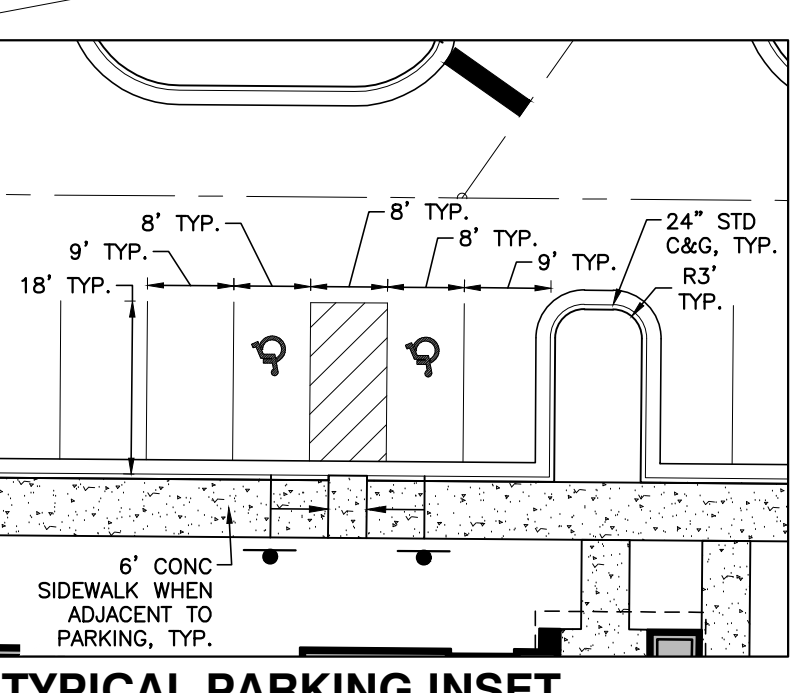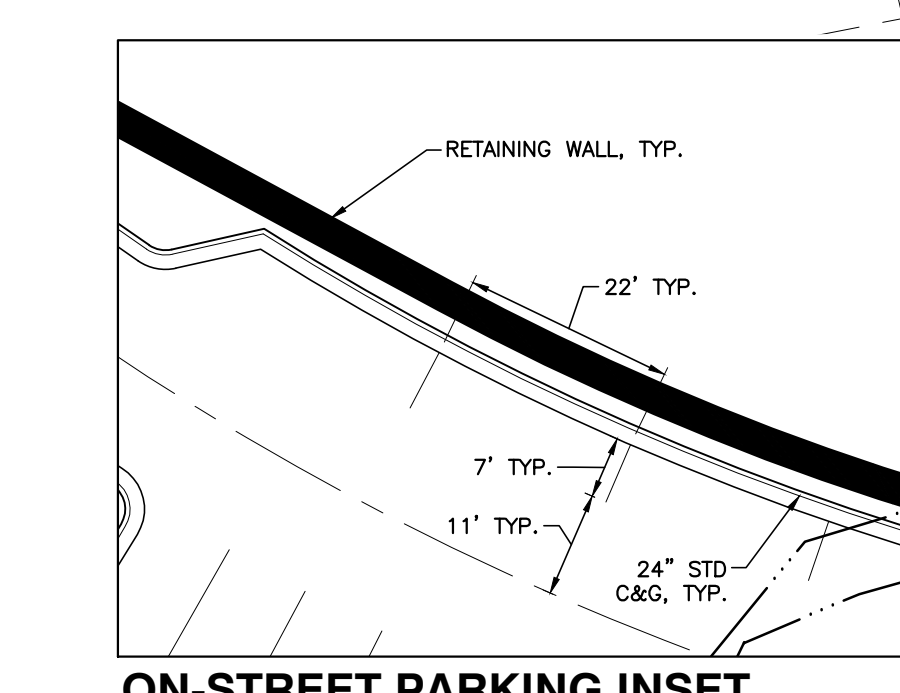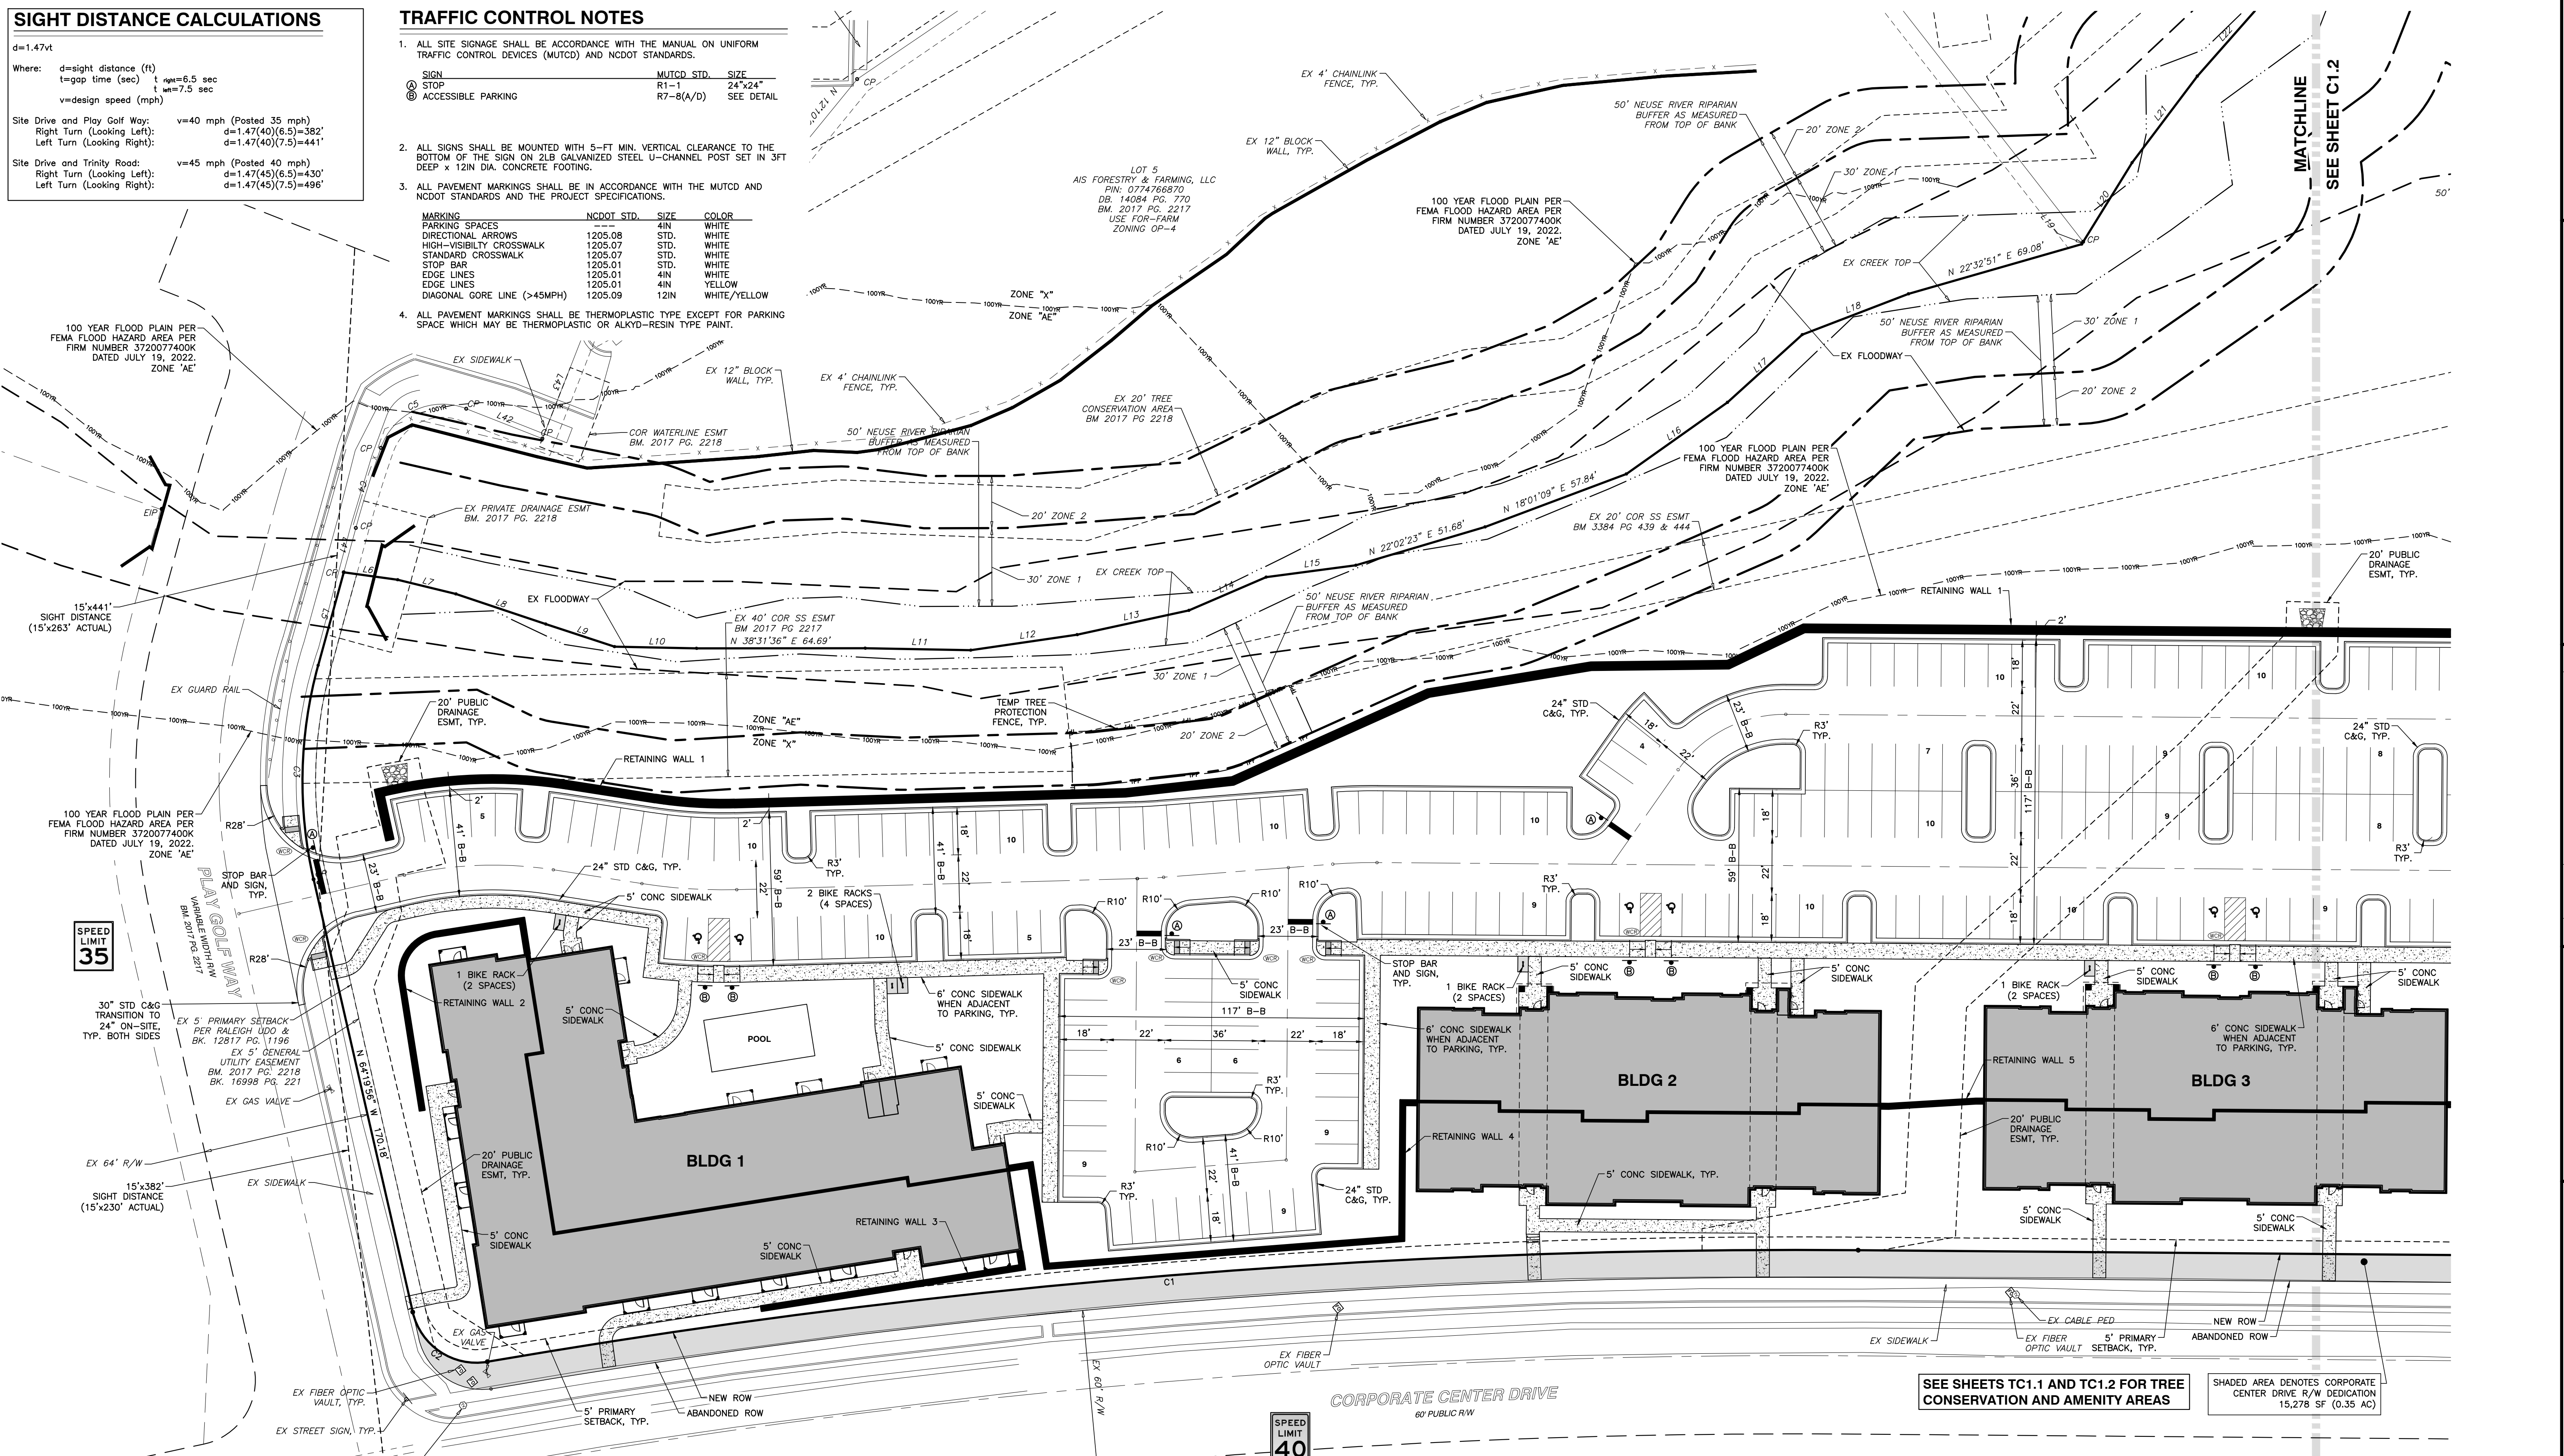

BOUNDARY CURVE TABLE

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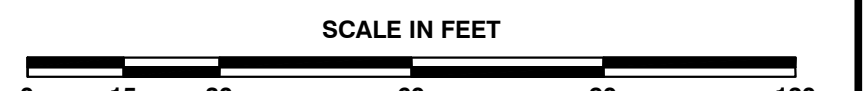
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BOUNDARY LINE TABLE

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L5	N 36°04'26" W	36.98'	L27	N 56°50'15" W	24.49'
L6	N 46°25'25" E	20.86'	L28	N 77°18'05" W	20.91'
L7	N 52°13'32" E	23.02'	L29	N 77°12'16" W	18.05'
L8	N 57°07'58" E	36.31'	L30	N 59°08'11" W	32.18'
L9	N 56°45'35" E	27.74'	L31	S 84°14'13" W	25.93'
L10	N 39°42'13" E	31.46'	L32	N 43°07'51" W	17.26'
L11	N 39°40'12" E	40.41'	L33	N 49°58'27" W	41.66'
L12	N 30°17'16" E	41.23'	L34	N 50°08'48" W	26.06'
L13	N 26°15'51" E	43.63'	L35	N 71°49'50" W	28.21'
L14	N 15°16'40" E	32.24'	L36	N 74°17'32" W	44.67'
L15	N 31°04'07" E	34.68'	L37	N 45°15'05" W	33.38'
L16	N 03°15'06" E	47.48'	L38	N 65°15'04" W	45.37'
L17	N 03°33'59" W	38.67'	L39	N 40°16'31" W	22.28'
L18	N 17°35'46" E	43.64'	L40	N 49°09'27" W	27.37'
L19	N 19°43'31" W	11.07'	L41	N 36°04'26" W	17.66'
L20	N 19°43'31" W	35.68'	L42	N 59°57'16" E	31.38'
L21	N 14°22'47" W	41.50'	L43	N 30°02'44" W	41.87'
L22	N 10°03'35" W	38.39'	L44	N 42°23'43" W	19.05'

LEGEND

- CONCRETE SIDEWALK (4" THICK 3000 PSI CONCRETE)
- CONCRETE PAVING (8" THICK 3000 PSI CONCRETE W/6"x6" 1/4" WWF)
- ASPHALT TRAIL
- WHEELCHAIR RAMP
- TEMP TREE PROTECTION FENCE



BANK
BASS, NIXON & KENNEDY, INC.
 CONSULTING ENGINEERS
 6310 CHAPEL HILL ROAD, SUITE 250, RALEIGH, NC 27607
 TELEPHONE: (919) 861-4422 FAX: (919) 861-8968
 CERTIFICATION NUMBERS: NCBELS (C-0110), NCBOLA (C-0267)

CORPORATE CENTER DRIVE APARTMENTS
 1101 CORPORATE CENTER DRIVE
 CITY OF RALEIGH, WAKE COUNTY, NORTH CAROLINA

ENLARGED SITE PLAN - SOUTH
 SCALE: 1" = 30'

SHEET C1.1

NO.	DATE	DESCRIPTION	BY

RAB: 05-08-2023
 DATE: 05-08-2023
 JOB NO.: 23093
 DRAWN BY: MDB
 CHECKED BY: MDB

NOT RELEASED FOR CONSTRUCTION OR BID SOLICITATION

TRAFFIC CONTROL NOTES

- ALL SITE SIGNAGE SHALL BE ACCORDANCE WITH THE MANUAL ON UNIFORM TRAFFIC CONTROL DEVICES (MUTCD) AND NCDOT STANDARDS.

SIGN	MUTCD STD.	SIZE
STOP	R1-1	24"x24"
ACCESSIBLE PARKING	R7-8(A/D)	SEE DETAIL
- ALL SIGNS SHALL BE MOUNTED WITH 5'-FT MIN. VERTICAL CLEARANCE TO THE BOTTOM OF THE SIGN ON 2LB GALVANIZED STEEL U-CHANNEL POST SET IN 3FT DEEP x 12IN DIA. CONCRETE FOOTING.
- ALL PAVEMENT MARKINGS SHALL BE IN ACCORDANCE WITH THE MUTCD AND NCDOT STANDARDS AND THE PROJECT SPECIFICATIONS.


MARKING SPACES	NCDOT STD.	SIZE	COLOR
PARKING SPACES	1205.08	4IN	WHITE
DIRECTIONAL ARROWS	1205.07	STD.	WHITE
HIGH-VISIBILITY CROSSWALK	1205.07	STD.	WHITE
STANDARD CROSSWALK	1205.01	STD.	WHITE
STOP BAR	1205.01	4IN	WHITE
EDGE LINES	1205.01	4IN	WHITE
EDGE LINES	1205.01	4IN	YELLOW
DIAGONAL GORE LINE (>45MPH)	1205.09	12IN	WHITE/YELLOW
- ALL PAVEMENT MARKINGS SHALL BE THERMOPLASTIC TYPE EXCEPT FOR PARKING SPACE WHICH MAY BE THERMOPLASTIC OR ALKYD-RESIN TYPE PAINT.

SIGHT DISTANCE CALCULATIONS

$d=1.47vt$
 Where: d =sight distance (ft)
 t =gap time (sec) $t_{gap}=6.5$ sec
 v =design speed (mph) $v=7.5$ sec

Site Drive and Play Golf Way:
 Right Turn (Looking Left): $d=1.47(40)(6.5)=382'$
 Left Turn (Looking Right): $d=1.47(40)(7.5)=441'$

Site Drive and Trinity Road:
 Right Turn (Looking Left): $d=1.47(45)(6.5)=430'$
 Left Turn (Looking Right): $d=1.47(45)(7.5)=496'$

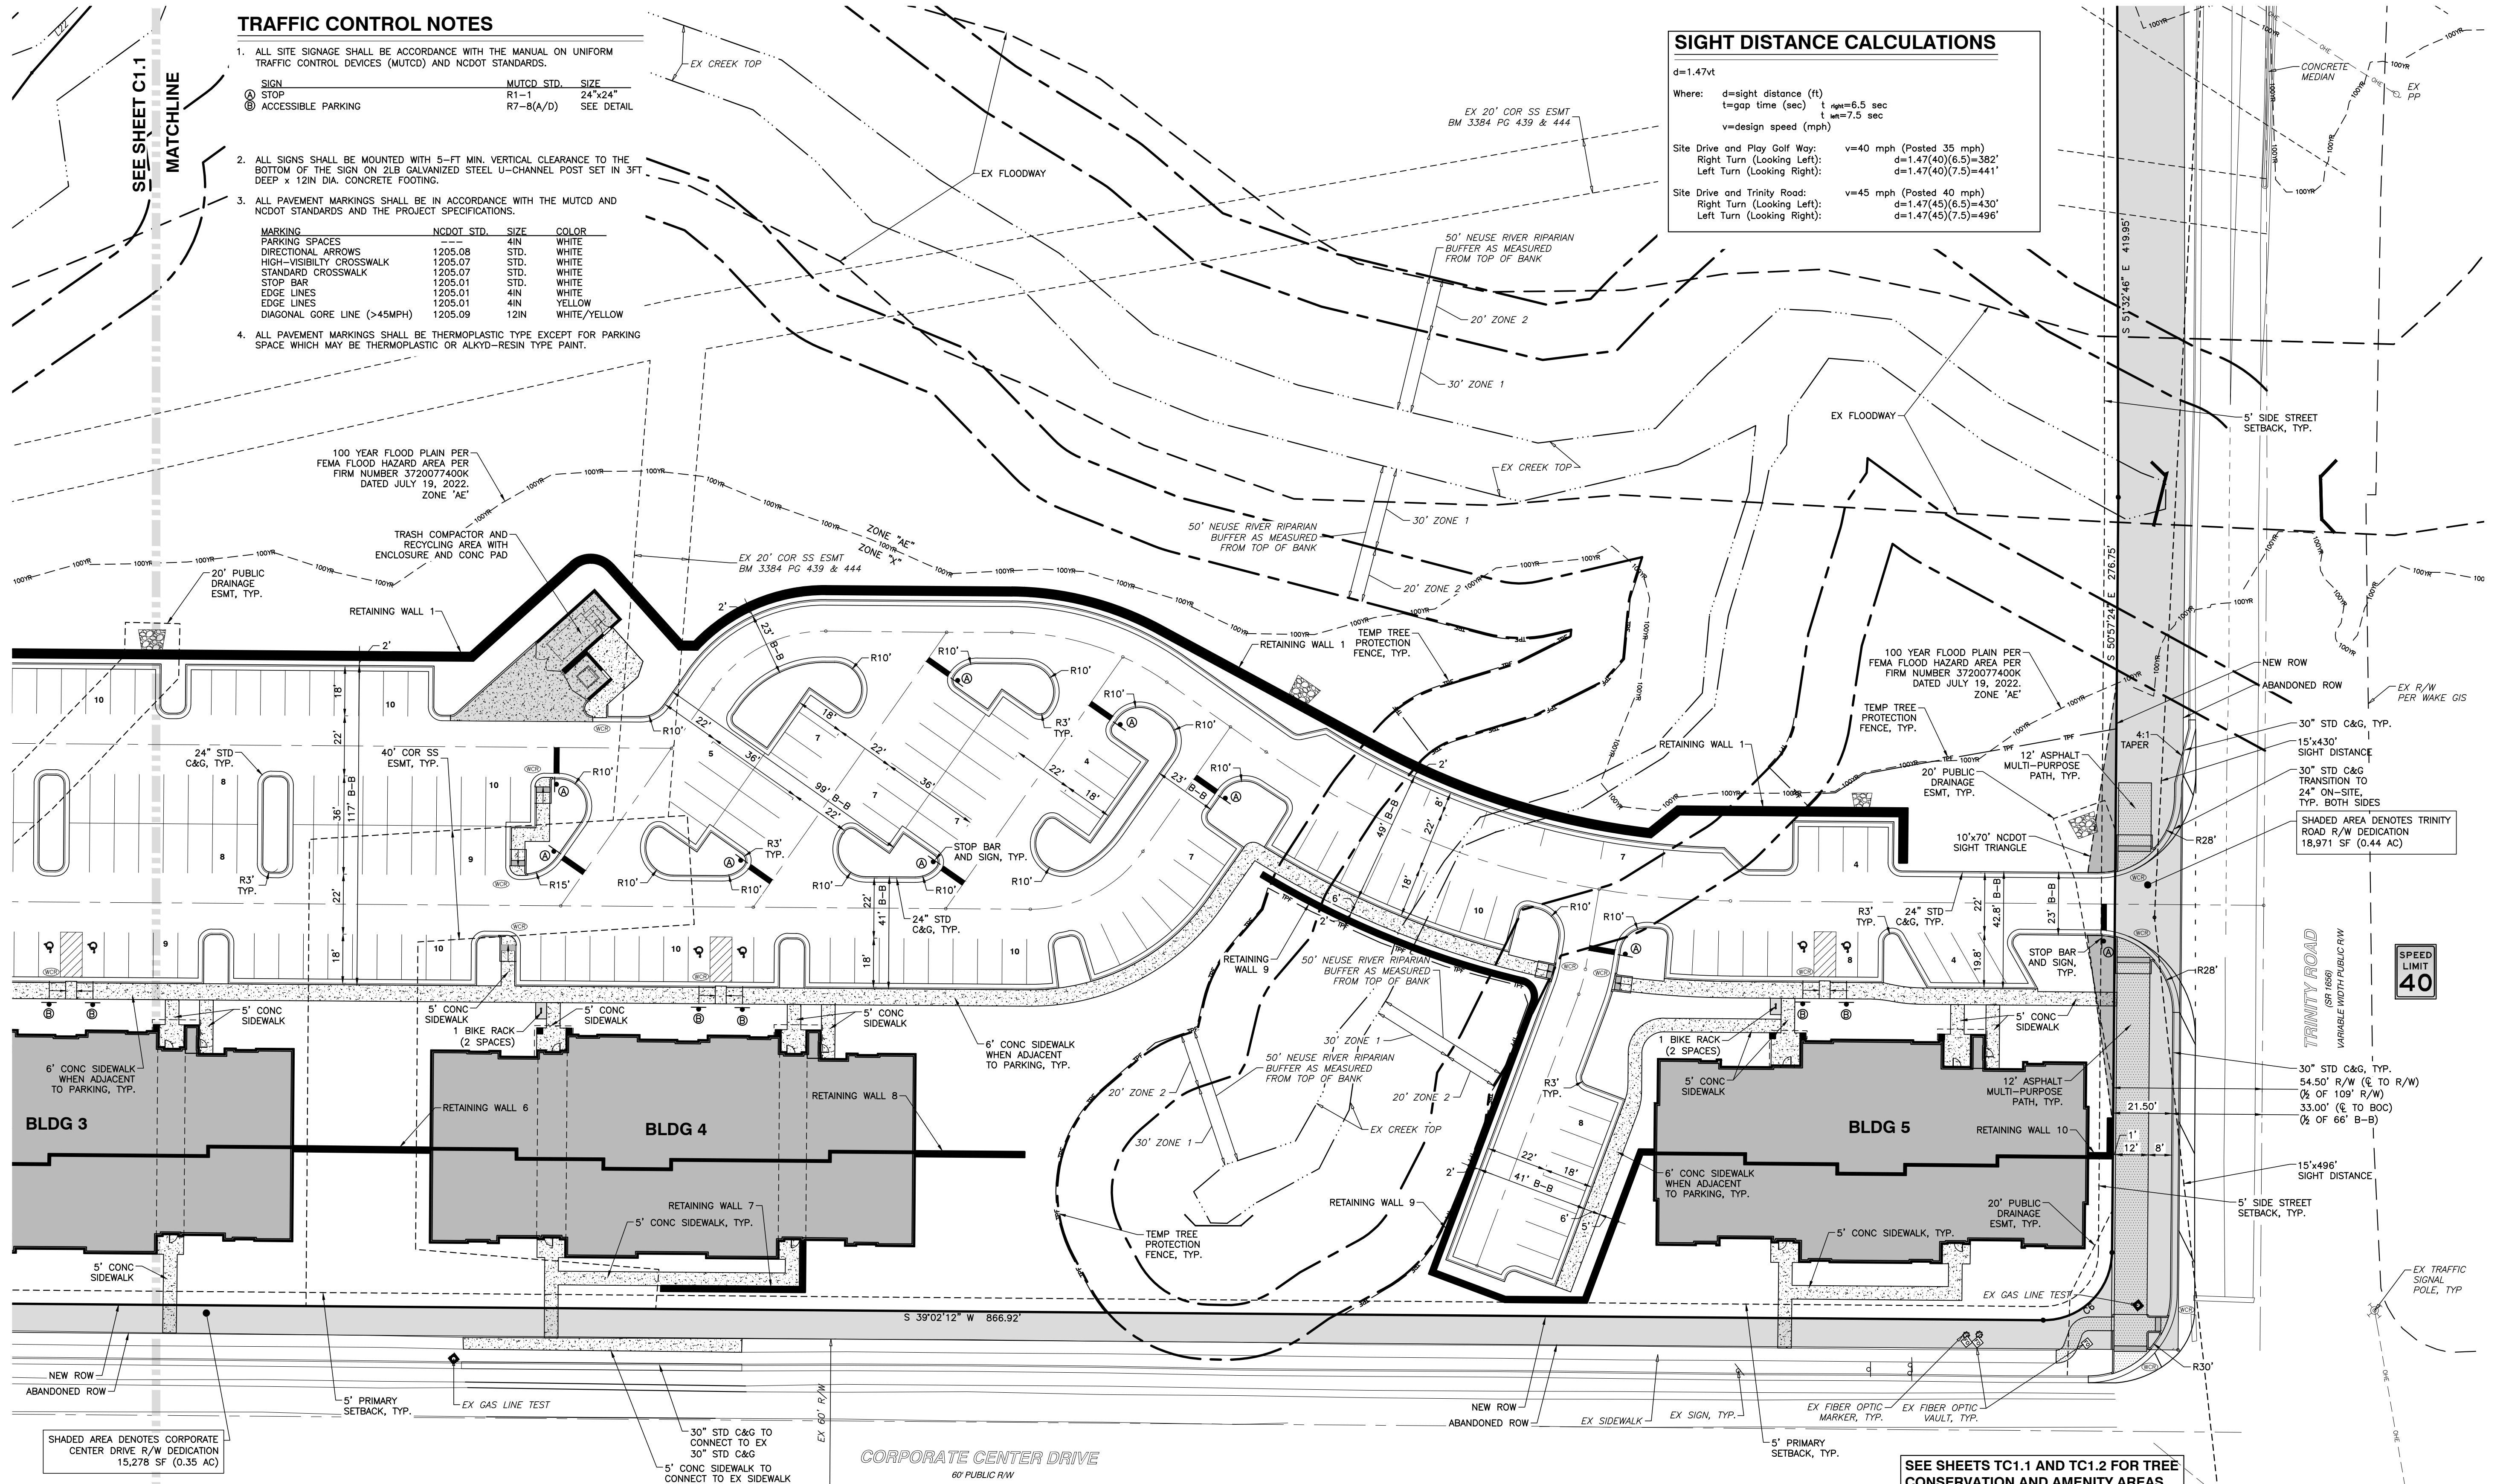

R:\2023\23093 - Corporate Center Drive Apartments\CIVIL\03 Preliminary\002 - 23093_Site.dwg, North, 9/7/2023 4:09:23 PM, robert burgoon






BASS, NIXON & KENNEDY, INC.
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 6310 CHAPEL HILL ROAD, SUITE 250, RALEIGH, NC 27607
 TELEPHONE: (919)961-4422 FAX: (919)961-8968
 CERTIFICATION NUMBERS: NCBELS (C-0110), NCBOLA (C-0267)

NO.	DATE	DESCRIPTION	BY

RAB: MDB
 DATE: 09-08-2023
 DRAWN BY: MDB
 ENLARGED SITE PLAN - NORTH
 SCALE: 1" = 30'

CORPORATE CENTER DRIVE APARTMENTS
 1101 CORPORATE CENTER DRIVE
 CITY OF RALEIGH, WAKE COUNTY, NORTH CAROLINA

NOT RELEASED FOR CONSTRUCTION OR BID SOLICITATION

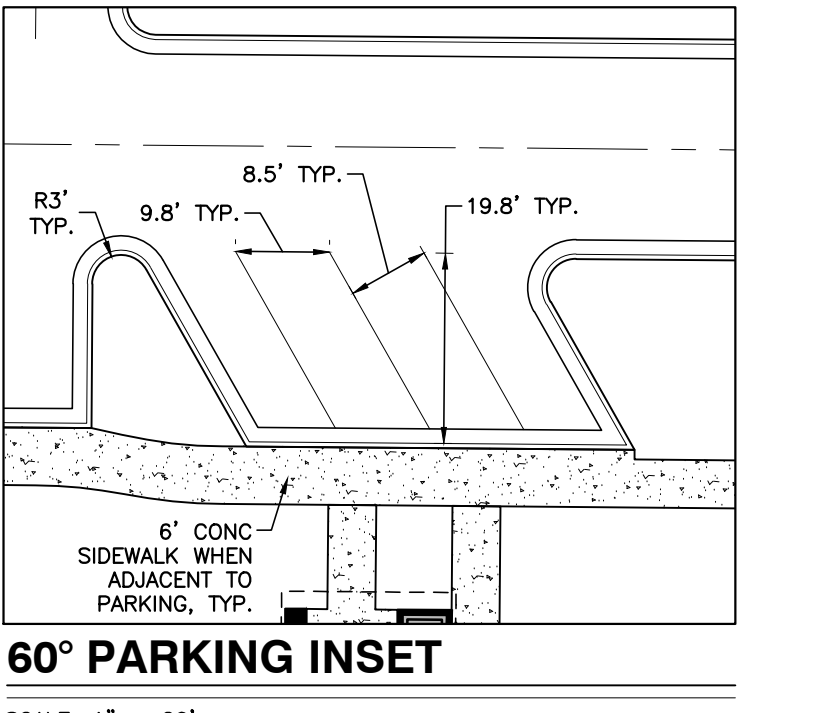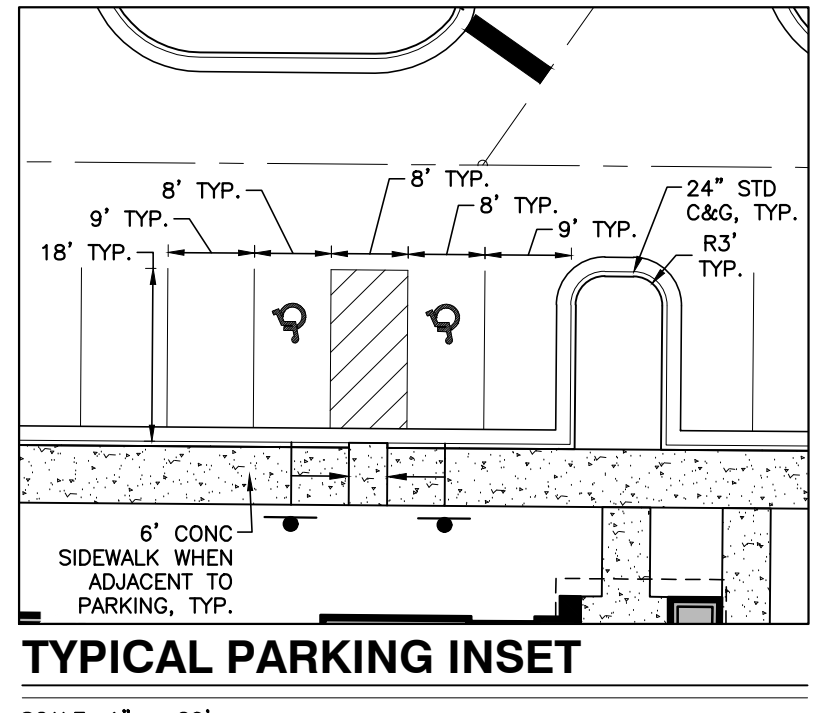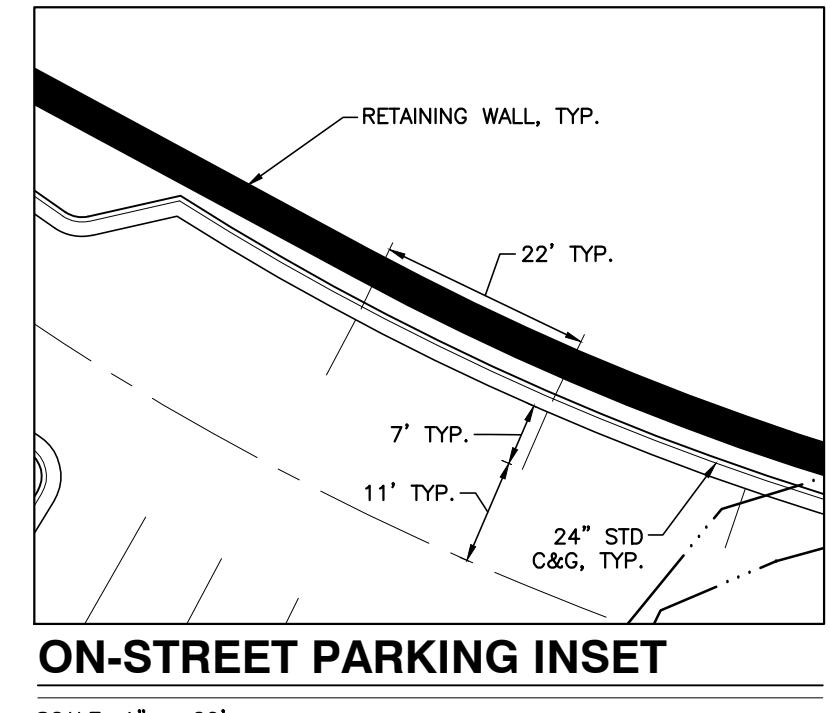

BOUNDARY CURVE TABLE

CURVE	RADIUS	LENGTH	CHORD DIRECTION	CHORD
C1	2,953.54	527.91'	S 33°54'35" W	526.46'
C2	25.00'	37.90'	S 72°13'56" W	34.38'
C3	168.00'	82.86'	N 50°12'11" W	82.02'
C4	468.00'	32.13'	N 34°06'27" W	32.12'
C5	25.00'	40.19'	N 13°54'24" E	36.00'
C6	25.00'	39.27'	S 05°57'36" E	35.35'

BOUNDARY LINE TABLE


LINE	BEARING	DISTANCE	LINE	BEARING	DISTANCE
L1	N 58°11'34" W	28.83'	L23	N 16°55'04" W	39.29'
L2	N 66°36'07" W	25.23'	L24	N 07°29'09" W	32.27'
L3	N 20°16'28" E	18.25'	L25	N 69°48'43" E	49.86'
L4	S 22°17'26" W	36.56'	L26	N 56°08'15" E	19.39'
L5	N 36°04'26" W	36.98'	L27	N 56°50'15" W	24.49'
L6	N 46°25'25" E	20.86'	L28	N 77°18'05" W	20.91'
L7	N 52°13'32" E	23.02'	L29	N 77°12'16" W	18.05'
L8	N 57°07'58" E	36.31'	L30	N 59°08'11" W	32.16'
L9	N 56°45'35" E	27.74'	L31	S 84°14'13" W	26.93'
L10	N 39°42'13" E	31.46'	L32	N 43°07'51" W	17.26'
L11	N 39°40'12" E	40.41'	L33	N 49°58'27" W	41.66'
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L13	N 26°15'51" E	43.83'	L35	N 71°49'50" W	28.21'
L14	N 15°19'40" E	32.24'	L36	N 74°17'32" W	44.67'
L15	N 31°04'07" E	34.68'	L37	N 45°15'05" W	33.38'
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L17	N 03°33'59" W	38.67'	L39	N 40°16'31" W	22.28'
L18	N 17°35'46" E	43.64'	L40	N 49°09'27" W	27.37'
L19	N 19°43'31" W	1.07'	L41	N 36°04'26" W	17.66'
L20	N 19°43'31" W	35.68'	L42	N 59°57'16" E	31.38'
L21	N 14°22'47" W	41.50'	L43	N 30°02'44" W	41.87'
L22	N 10°03'35" W	38.39'	L44	N 42°23'43" W	19.05'


NO WETLANDS EXIST ON-SITE
FLOODPLAINS EXIST ON-SITE

NOTE: ALL CONSTRUCTION ACTIVITY SHALL BE IN ACCORDANCE WITH CITY OF RALEIGH AND NCDOT STANDARDS AND SPECIFICATIONS AS APPLICABLE.

LEGEND

- CONCRETE SIDEWALK (4" THICK 3000 PSI CONCRETE)
- CONCRETE PAVING (8" THICK 3000 PSI CONCRETE W/6"x6" 1% WWF)
- ASPHALT TRAIL
- WHEELCHAIR RAMP
- TEMP TREE PROTECTION FENCE

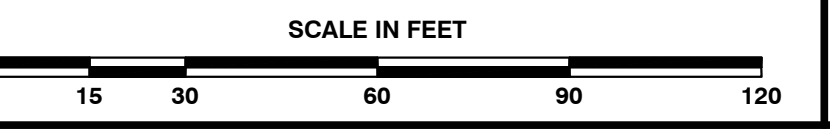

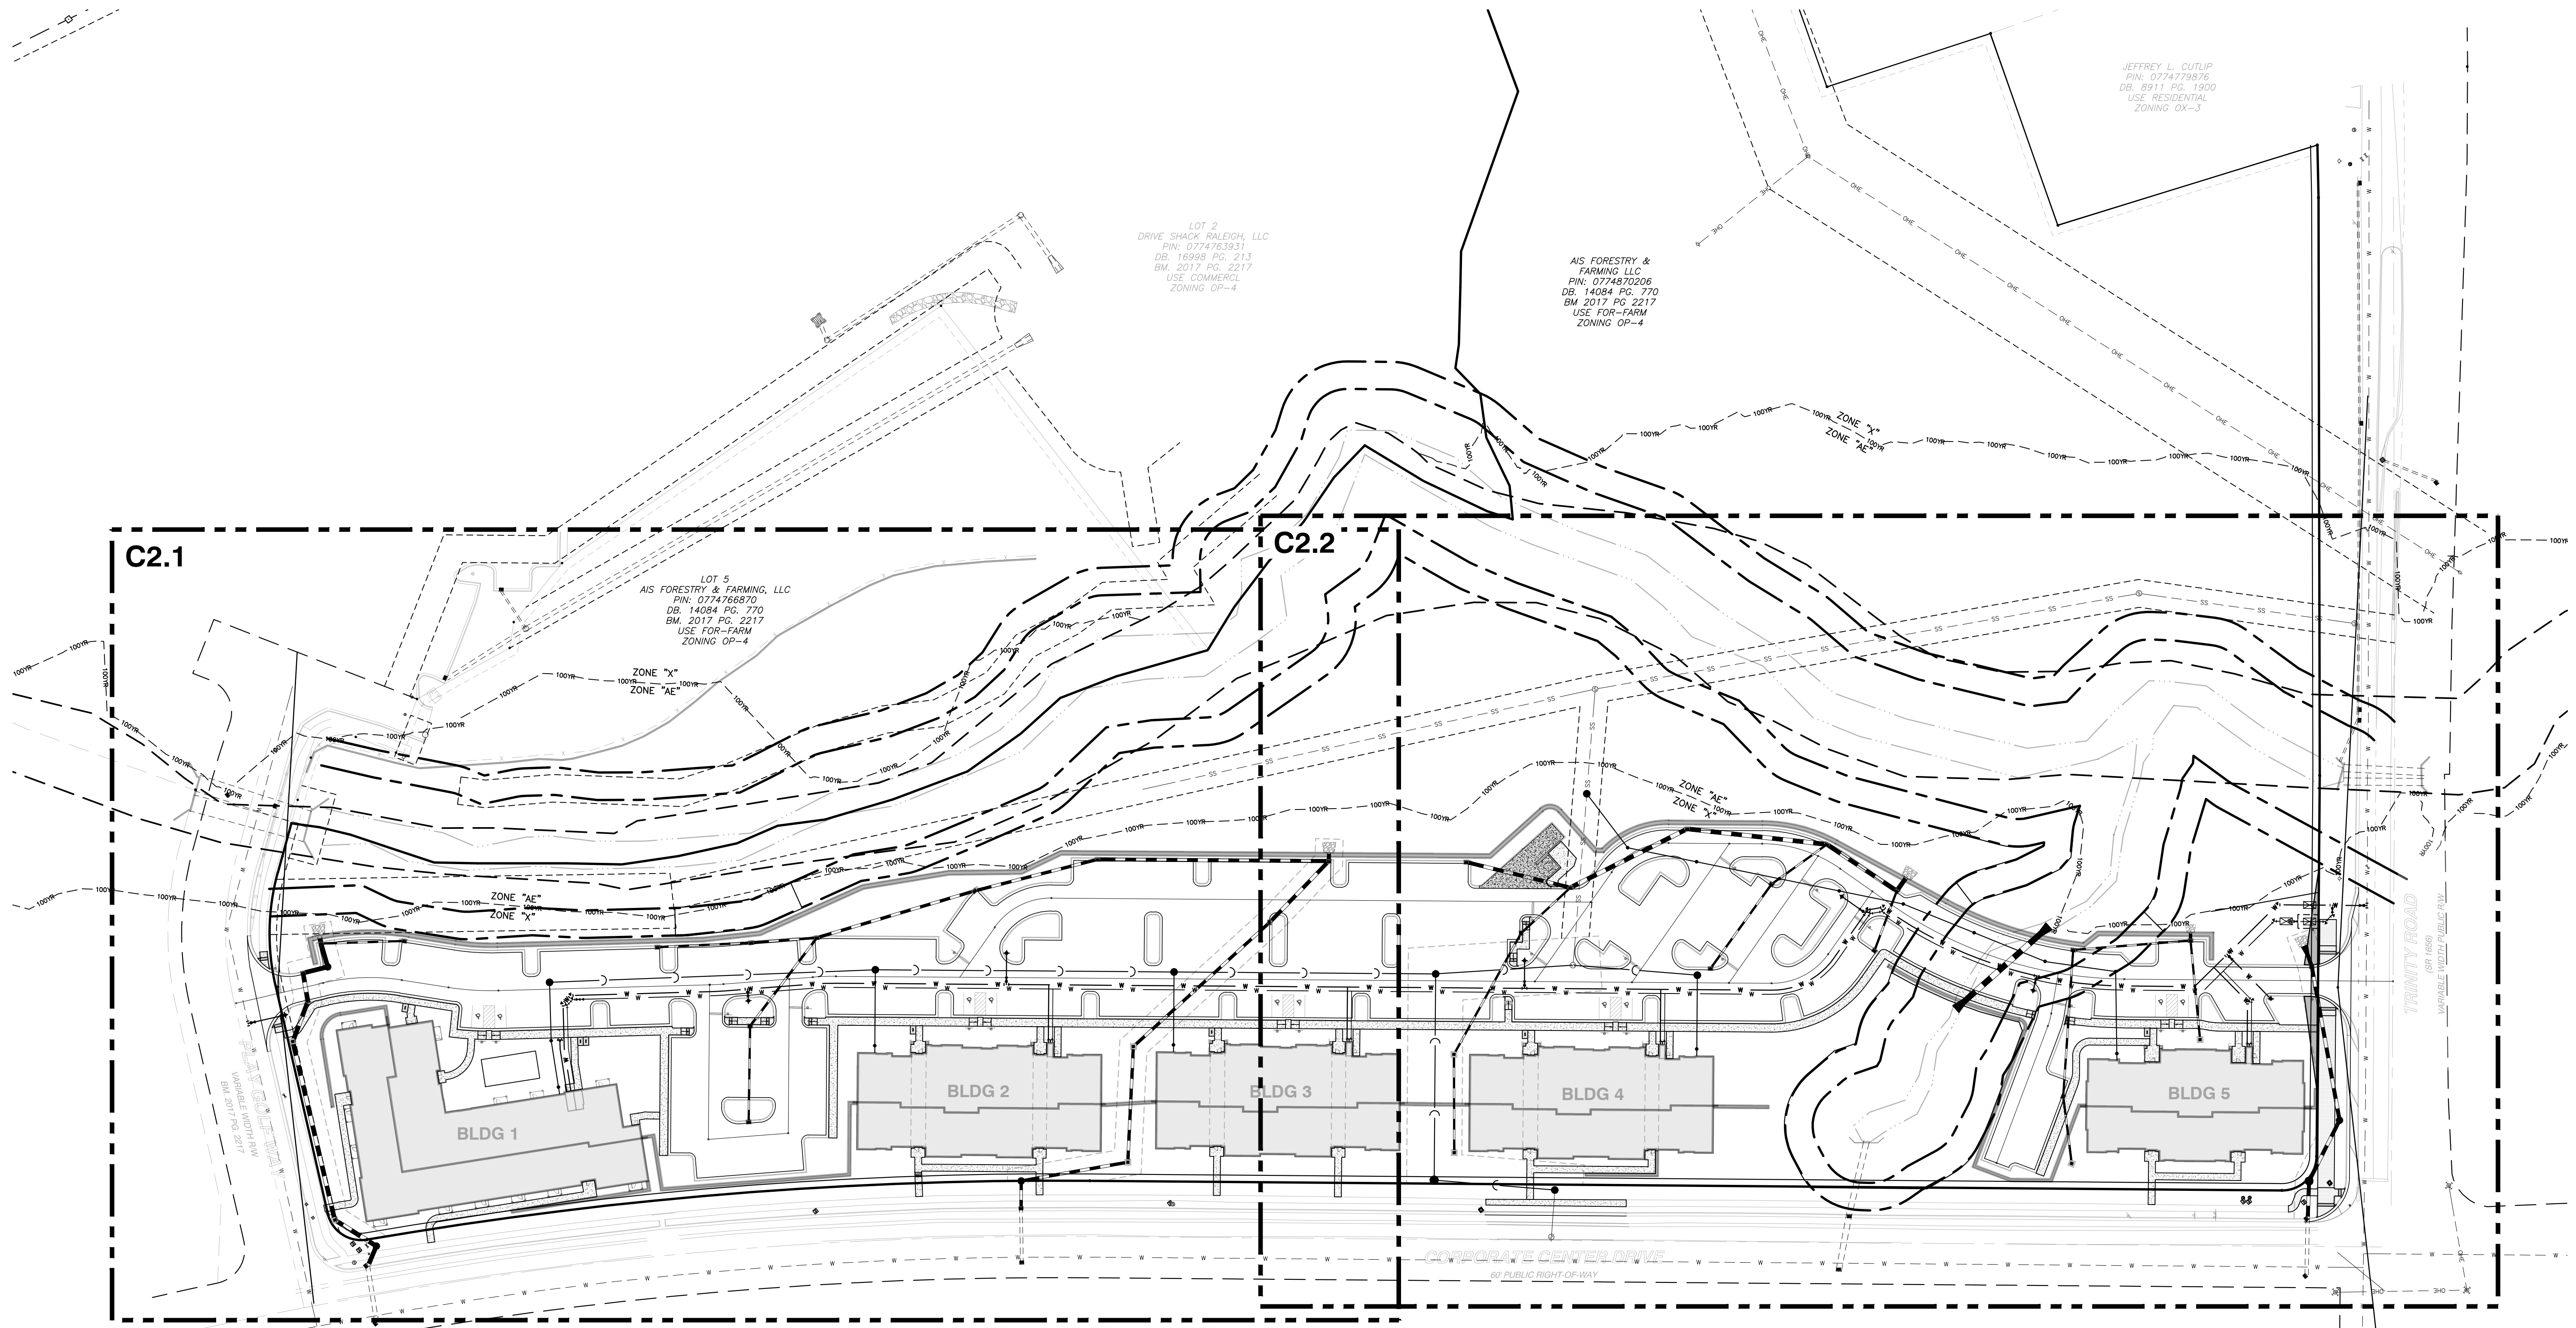

C2.1

C2.2

CITY OF RALEIGH UTILITY NOTES

- ALL MATERIALS & CONSTRUCTION METHODS SHALL BE IN ACCORDANCE WITH CITY OF RALEIGH DESIGN STANDARDS, DETAILS & SPECIFICATIONS (REFERENCE: CORPUD HANDBOOK, CURRENT EDITION).
- UTILITY SEPARATION REQUIREMENTS:
 - A DISTANCE OF 100' SHALL BE MAINTAINED BETWEEN SANITARY SEWER & ANY PRIVATE OR PUBLIC WATER SUPPLY SOURCE SUCH AS AN IMPOUNDED RESERVOIR USED AS A SOURCE OF DRINKING WATER. IF ADEQUATE LATERAL SEPARATION CANNOT BE ACHIEVED, FERROUS SANITARY SEWER PIPE SHALL BE SPECIFIED & INSTALLED TO WATERLINE SPECIFICATIONS. HOWEVER, THE MINIMUM SEPARATION SHALL NOT BE LESS THAN 25' FROM A PRIVATE WELL, OR 50' FROM A PUBLIC WELL.
 - WHEN INSTALLING WATER &/OR SEWER MAINS, THE HORIZONTAL SEPARATION BETWEEN UTILITIES SHALL BE 10'. IF THIS SEPARATION CANNOT BE MAINTAINED DUE TO EXISTING CONDITIONS, THE VARIATION ALLOWED IS THE WATER MAIN IN A SEPARATE TRENCH WITH THE ELEVATION OF THE WATER MAIN AT LEAST 18" ABOVE THE TOP OF THE SEWER & MUST BE APPROVED BY THE PUBLIC UTILITIES DIRECTOR. ALL DISTANCES ARE MEASURED FROM OUTSIDE DIAMETER TO OUTSIDE DIAMETER.
 - WHERE IT IS IMPOSSIBLE TO OBTAIN PROPER SEPARATION, OR ANYTIME A SANITARY SEWER PASSES OVER A WATERMAIN, DIP MATERIALS OR STEEL ENCASEMENT EXTENDED 10" ON EACH SIDE OF CROSSING MUST BE SPECIFIED & INSTALLED TO WATERLINE SPECIFICATIONS.
 - 5.0' MINIMUM HORIZONTAL SEPARATION IS REQUIRED BETWEEN ALL SANITARY SEWER & STORM SEWER FACILITIES, UNLESS DIP MATERIAL IS SPECIFIED FOR SANITARY SEWER.
 - MAINTAIN 18" MIN. VERTICAL SEPARATION AT ALL WATERMAIN & RCP STORM DRAIN CROSSINGS; MAINTAIN 24" MIN. VERTICAL SEPARATION AT ALL SANITARY SEWER & RCP STORM DRAIN CROSSINGS. WHERE ADEQUATE SEPARATIONS CANNOT BE ACHIEVED, SPECIFY DIP MATERIALS & A CONCRETE CRADLE HAVING 6" MIN. CLEARANCE (PER CORPUD DETAILS W-41 & S-49).
 - ALL OTHER UNDERGROUND UTILITIES SHALL CROSS WATER & SEWER FACILITIES WITH 18" MIN. VERTICAL SEPARATION REQUIRED.
- ANY NECESSARY FIELD REVISIONS ARE SUBJECT TO REVIEW & APPROVAL OF AN AMENDED PLAN &/OR PROFILE BY THE CITY OF RALEIGH PUBLIC UTILITIES DEPARTMENT PRIOR TO CONSTRUCTION.
- CONTRACTOR SHALL MAINTAIN CONTINUOUS WATER & SEWER SERVICE TO EXISTING RESIDENCES & BUSINESSES THROUGHOUT CONSTRUCTION OF PROJECT. ANY NECESSARY SERVICE INTERRUPTIONS SHALL BE PRECEDED BY A 24 HOUR ADVANCE NOTICE TO THE CITY OF RALEIGH PUBLIC UTILITIES DEPARTMENT.

ATTENTION CONTRACTORS


The Construction Contractor responsible for the extension of water, sewer, and/or reuse, as approved in these plans, is responsible for contacting the **Public Works Department** at (919) 996-2409, and the **Public Utilities Department** at (919) 996-4540 at least **twenty four hours** prior to beginning any of their construction.

Failure to notify both City Departments in advance of beginning construction, will result in the issuance of **monetary fines**, and require reinstallation of any water or sewer facilities not inspected as a result of this notification failure.

Failure to call for **Inspection, Install a Downstream Plug**, have **Permitted Plans** on the **Jobsite**, or any other **Violation of City of Raleigh Standards** will result in a **Fine and Possible Exclusion** from future work in the **City of Raleigh**.

NO WETLANDS EXIST ON-SITE
FLOODPLAINS EXIST ON-SITE

NOTE: ALL CONSTRUCTION ACTIVITY SHALL BE IN ACCORDANCE WITH CITY OF RALEIGH AND NCDOT STANDARDS AND SPECIFICATIONS AS APPLICABLE.

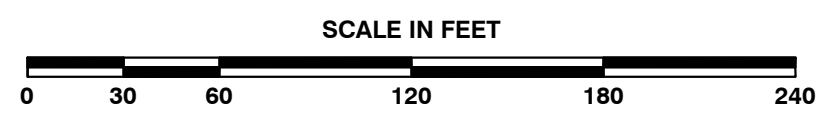

BASS, NIXON & KENNEDY, INC.
CONSULTING ENGINEERS
6310 CHAPEL HILL ROAD, SUITE 250, RALEIGH, NC 27607
TELEPHONE: (919) 961-4422 FAX: (919) 961-8868
CERTIFICATION NUMBERS: NCBELS (C-0110), NCBOLA (C-0267)

NO.	DATE	DESCRIPTION	BY



OVERALL UTILITY PLAN
SCALE: 1" = 60'
CHK BY: MDB

CORPORATE CENTER DRIVE APARTMENTS
1101 CORPORATE CENTER DRIVE
CITY OF RALEIGH, WAKE COUNTY, NORTH CAROLINA

SHEET C2.0

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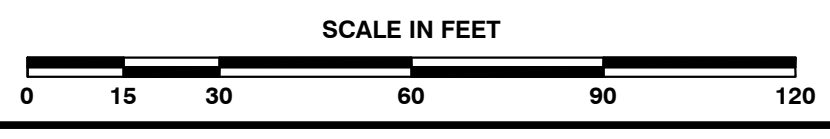
NOT RELEASED FOR CONSTRUCTION OR BID SOLICITATION

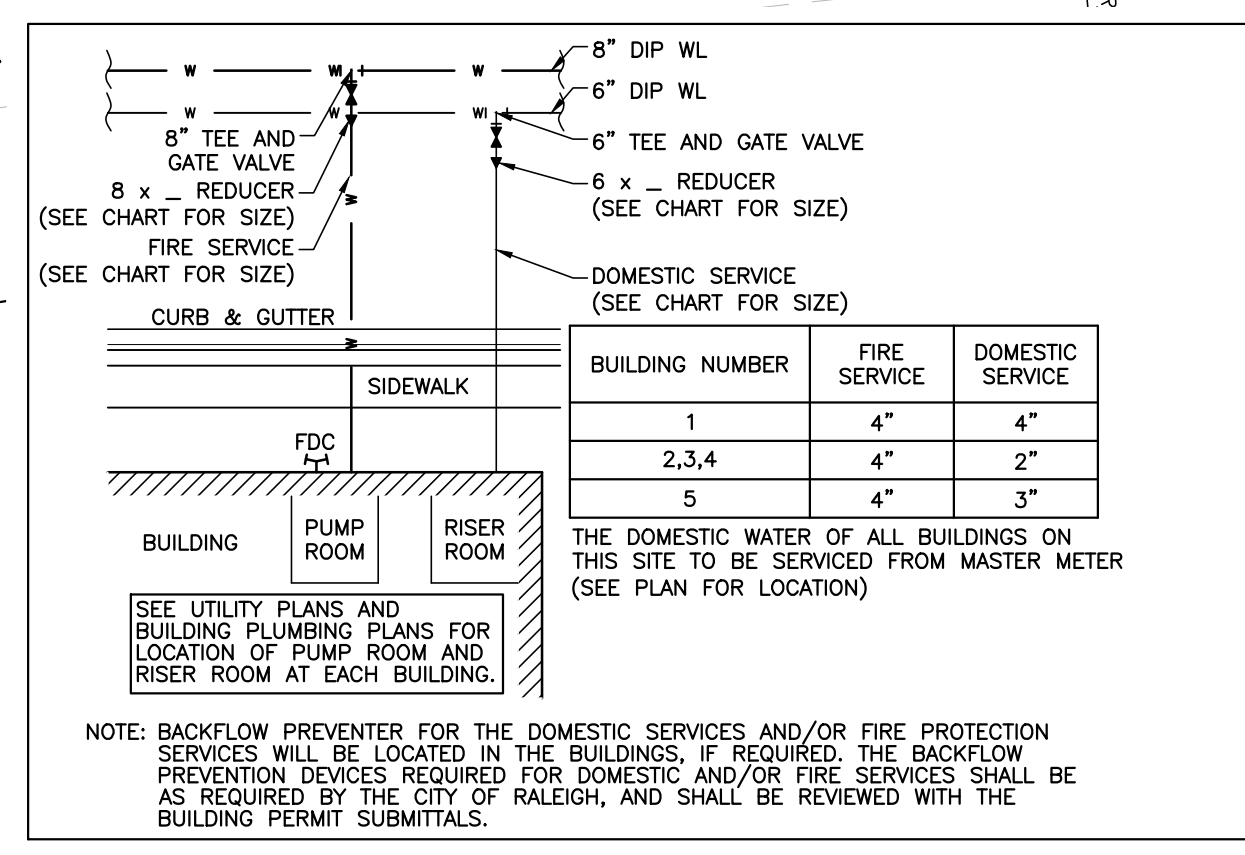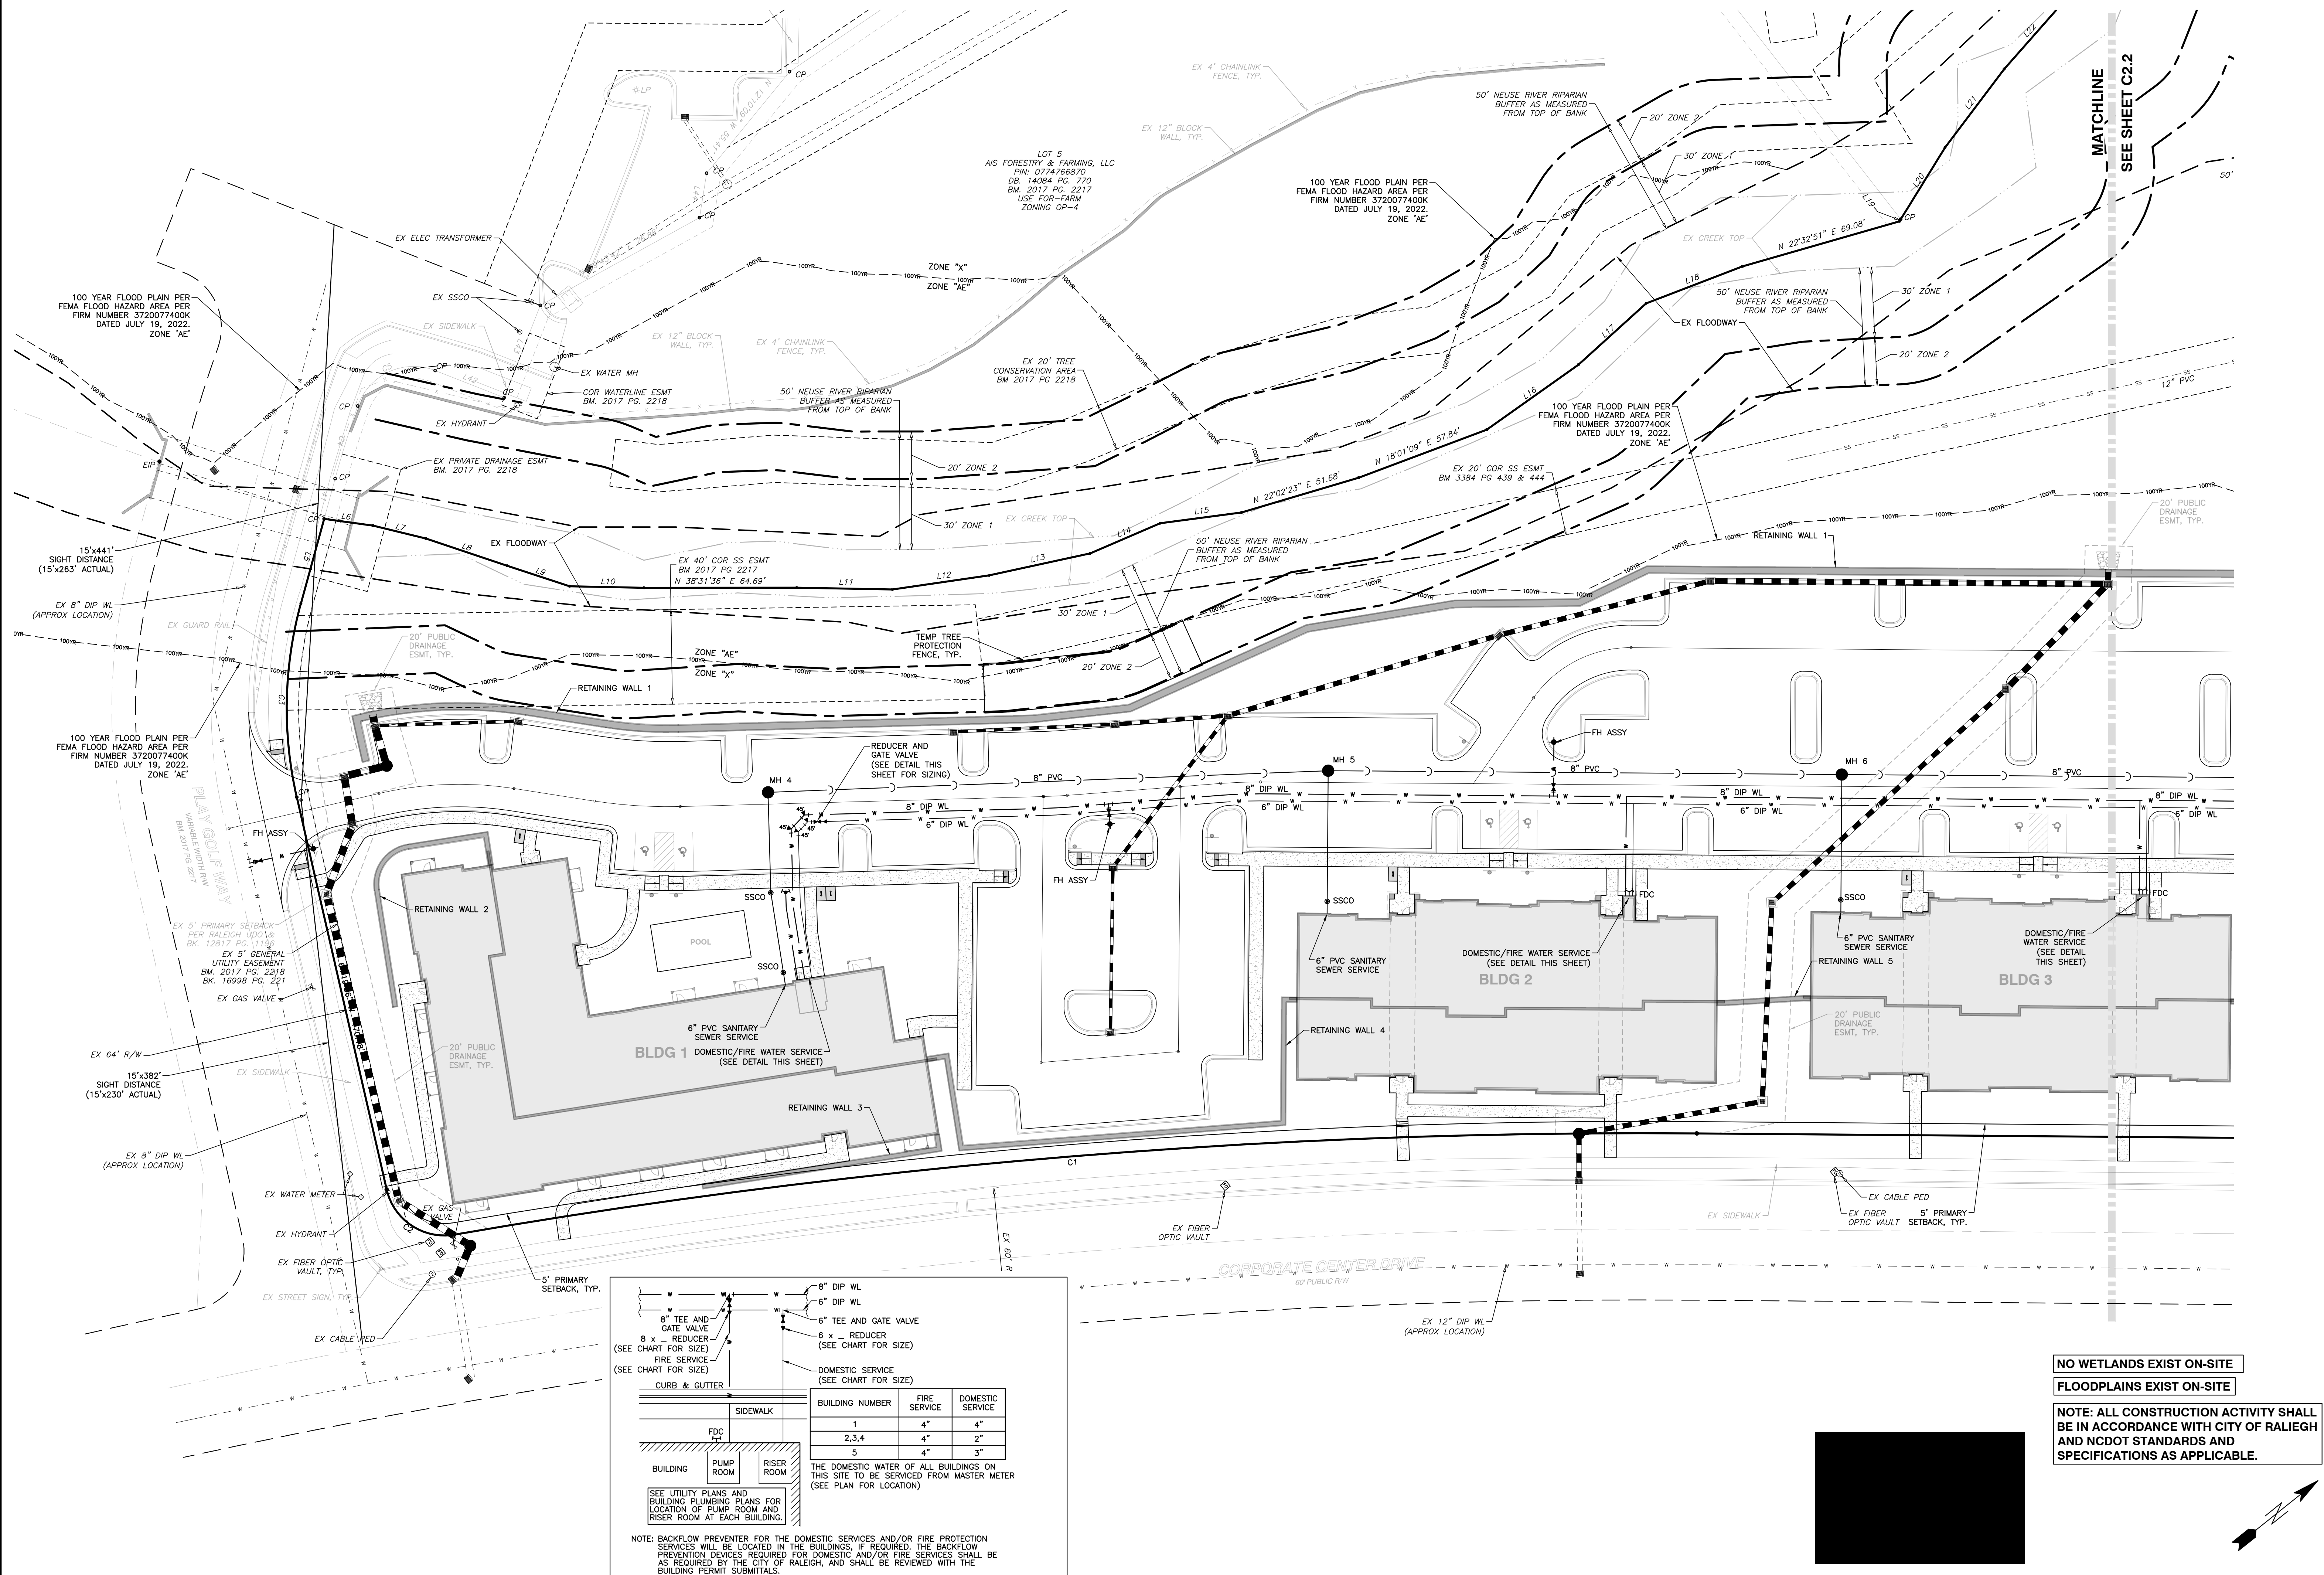

NO WETLANDS EXIST ON-SITE

FLOODPLAINS EXIST ON-SITE

NOTE: ALL CONSTRUCTION ACTIVITY SHALL BE IN ACCORDANCE WITH CITY OF RALEIGH AND NCDOT STANDARDS AND SPECIFICATIONS AS APPLICABLE.





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CONSULTING ENGINEERS
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 TELEPHONE: (919) 861-4422 FAX: (919) 861-8868
 CERTIFICATION NUMBERS: NCBELS (C-0110), NCBOLA (C-0267)

NO.	DATE	DESCRIPTION	BY

RAB: MDB
 DATE: 05-08-2023
 DRAWN BY: MDB
ENLARGED UTILITY PLAN - SOUTH
 SCALE: 1" = 30'
 CHK BY: MDB

CORPORATE CENTER DRIVE APARTMENTS
1101 CORPORATE CENTER DRIVE
 CITY OF RALEIGH, WAKE COUNTY, NORTH CAROLINA

SHEET **C2.1**

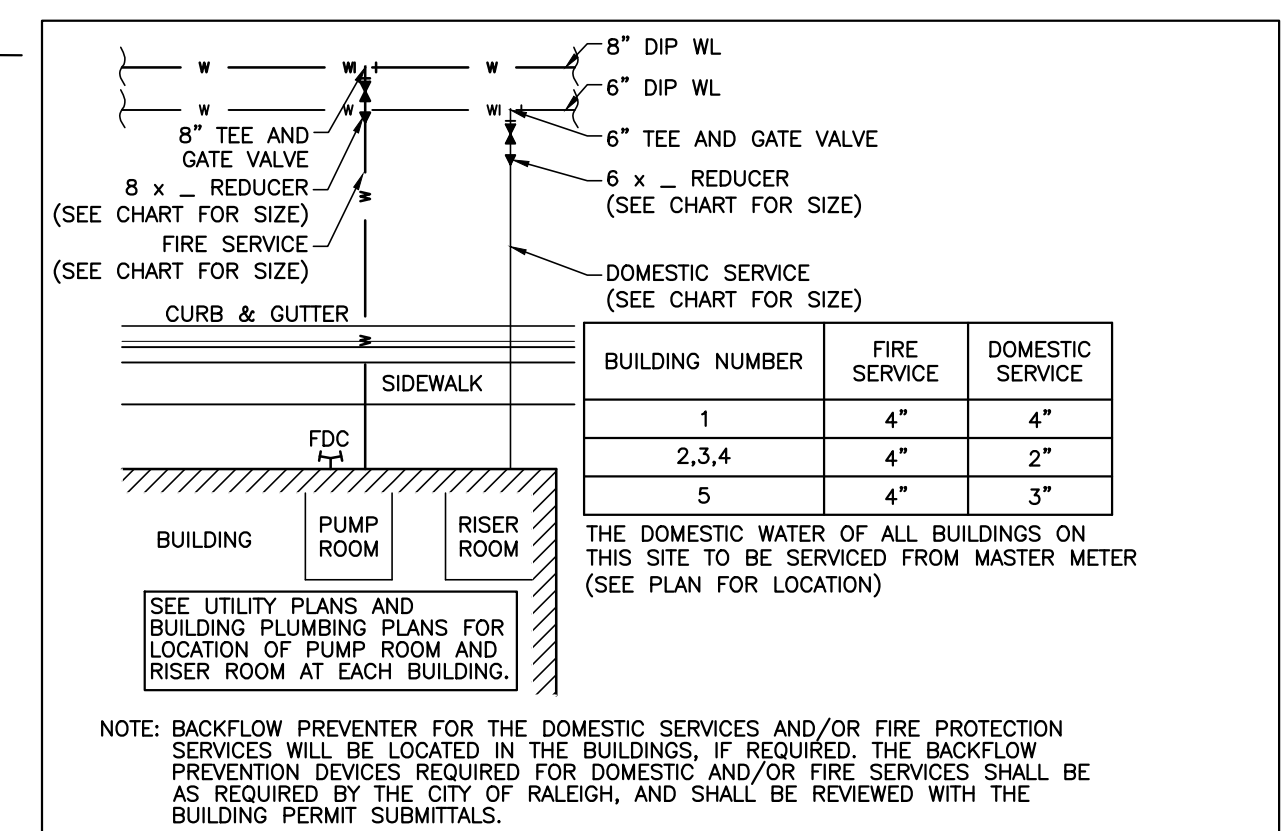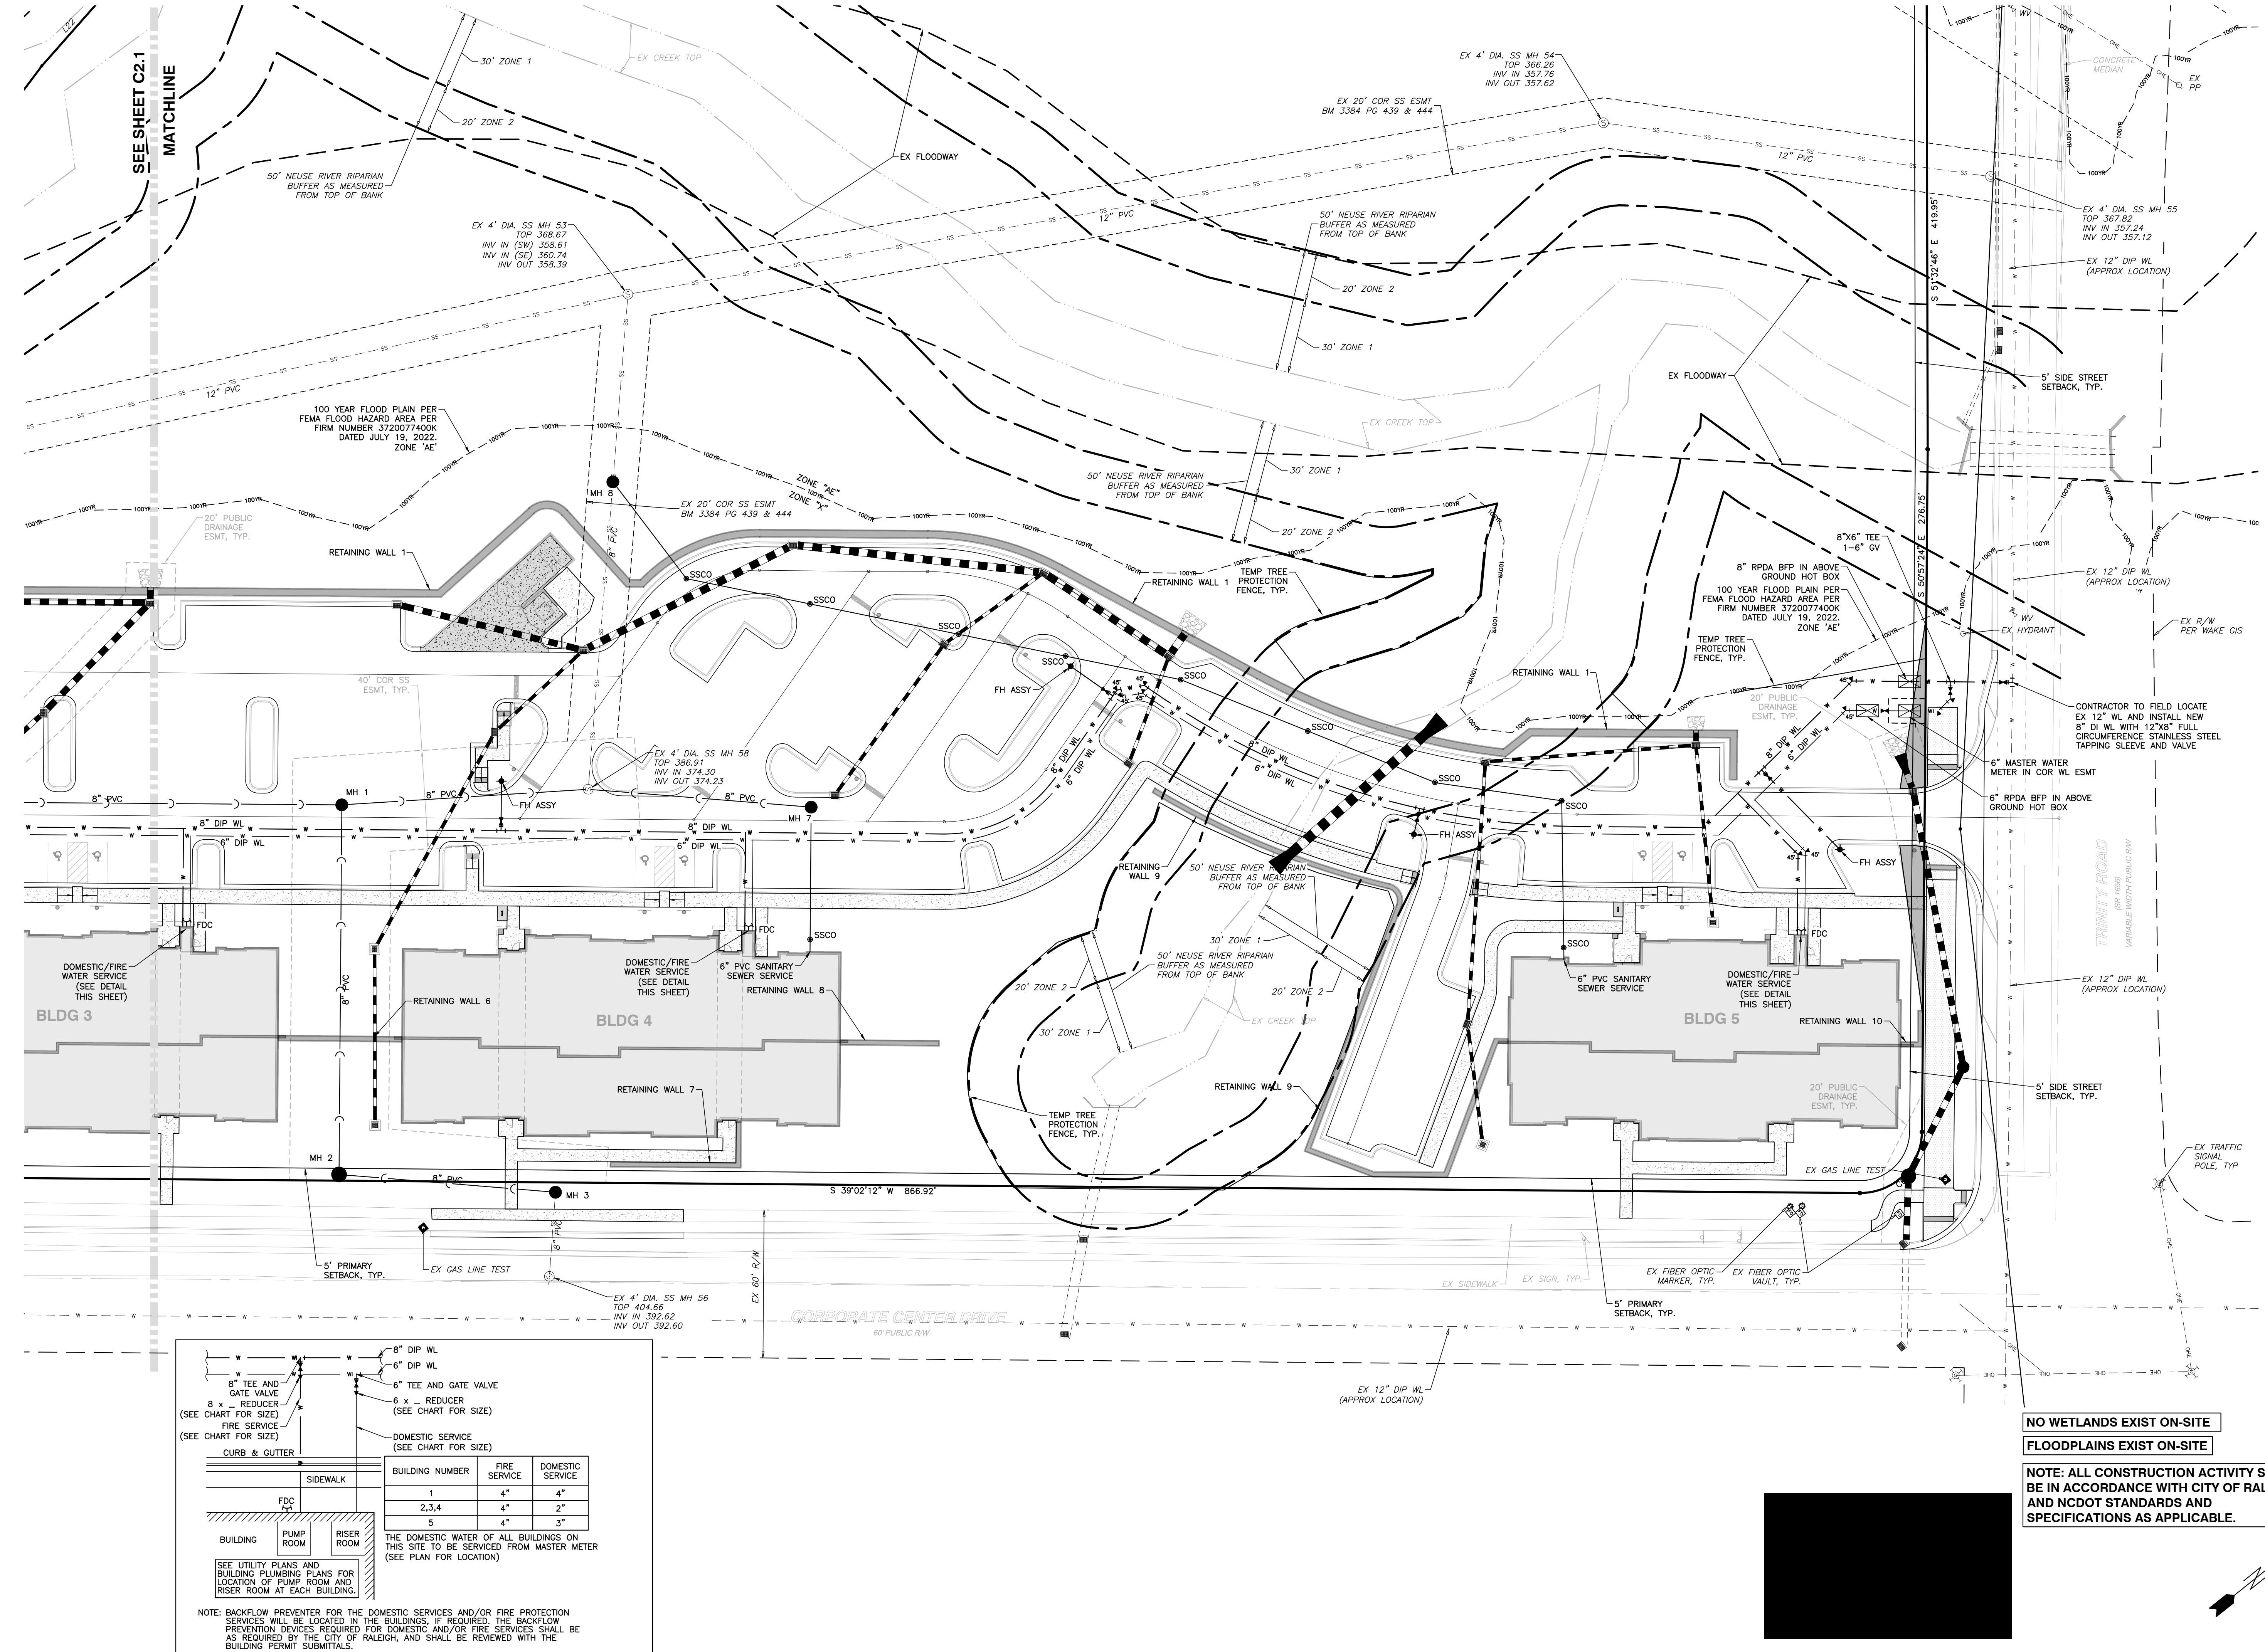


BUILDING NUMBER	FIRE SERVICE	DOMESTIC SERVICE
1	4"	4"
2,3,4	4"	2"
5	4"	3"

NOTE: BACKFLOW PREVENTER FOR THE DOMESTIC SERVICES AND/OR FIRE PROTECTION SERVICES WILL BE LOCATED IN THE BUILDINGS. IF REQUIRED, THE BACKFLOW PREVENTION DEVICES REQUIRED FOR DOMESTIC AND/OR FIRE SERVICES SHALL BE AS REQUIRED BY THE CITY OF RALEIGH, AND SHALL BE REVIEWED WITH THE BUILDING PERMIT SUBMITTALS.

WATER SERVICE DETAIL

SCALE: NTS

NO WETLANDS EXIST ON-SITE
 FLOODPLAINS EXIST ON-SITE
 NOTE: ALL CONSTRUCTION ACTIVITY SHALL BE IN ACCORDANCE WITH CITY OF RALEIGH AND NCDOT STANDARDS AND SPECIFICATIONS AS APPLICABLE.

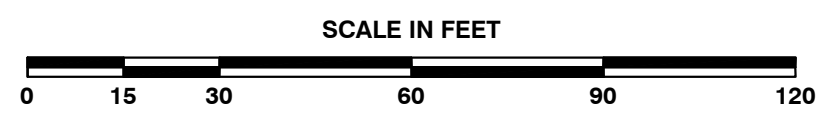


BASS, NIXON & KENNEDY, INC.
 CONSULTING ENGINEERS
 6310 CHAPEL HILL ROAD, SUITE 250, RALEIGH, NC 27607
 TELEPHONE: (919) 861-4422 FAX: (919) 861-8968
 CERTIFICATION NUMBERS: NCBELS (C-0110), NCBOLA (C-0267)

NO.	DATE	DESCRIPTION	BY

03-23093 09-08-2023 RAB
 JOB NO. DATE DRAWN BY
ENLARGED UTILITY PLAN - NORTH
 SCALE: 1" = 30' CHK BY: MDB

CORPORATE CENTER DRIVE APARTMENTS
 1101 CORPORATE CENTER DRIVE
 CITY OF RALEIGH, WAKE COUNTY, NORTH CAROLINA

SHEET **C2.2**

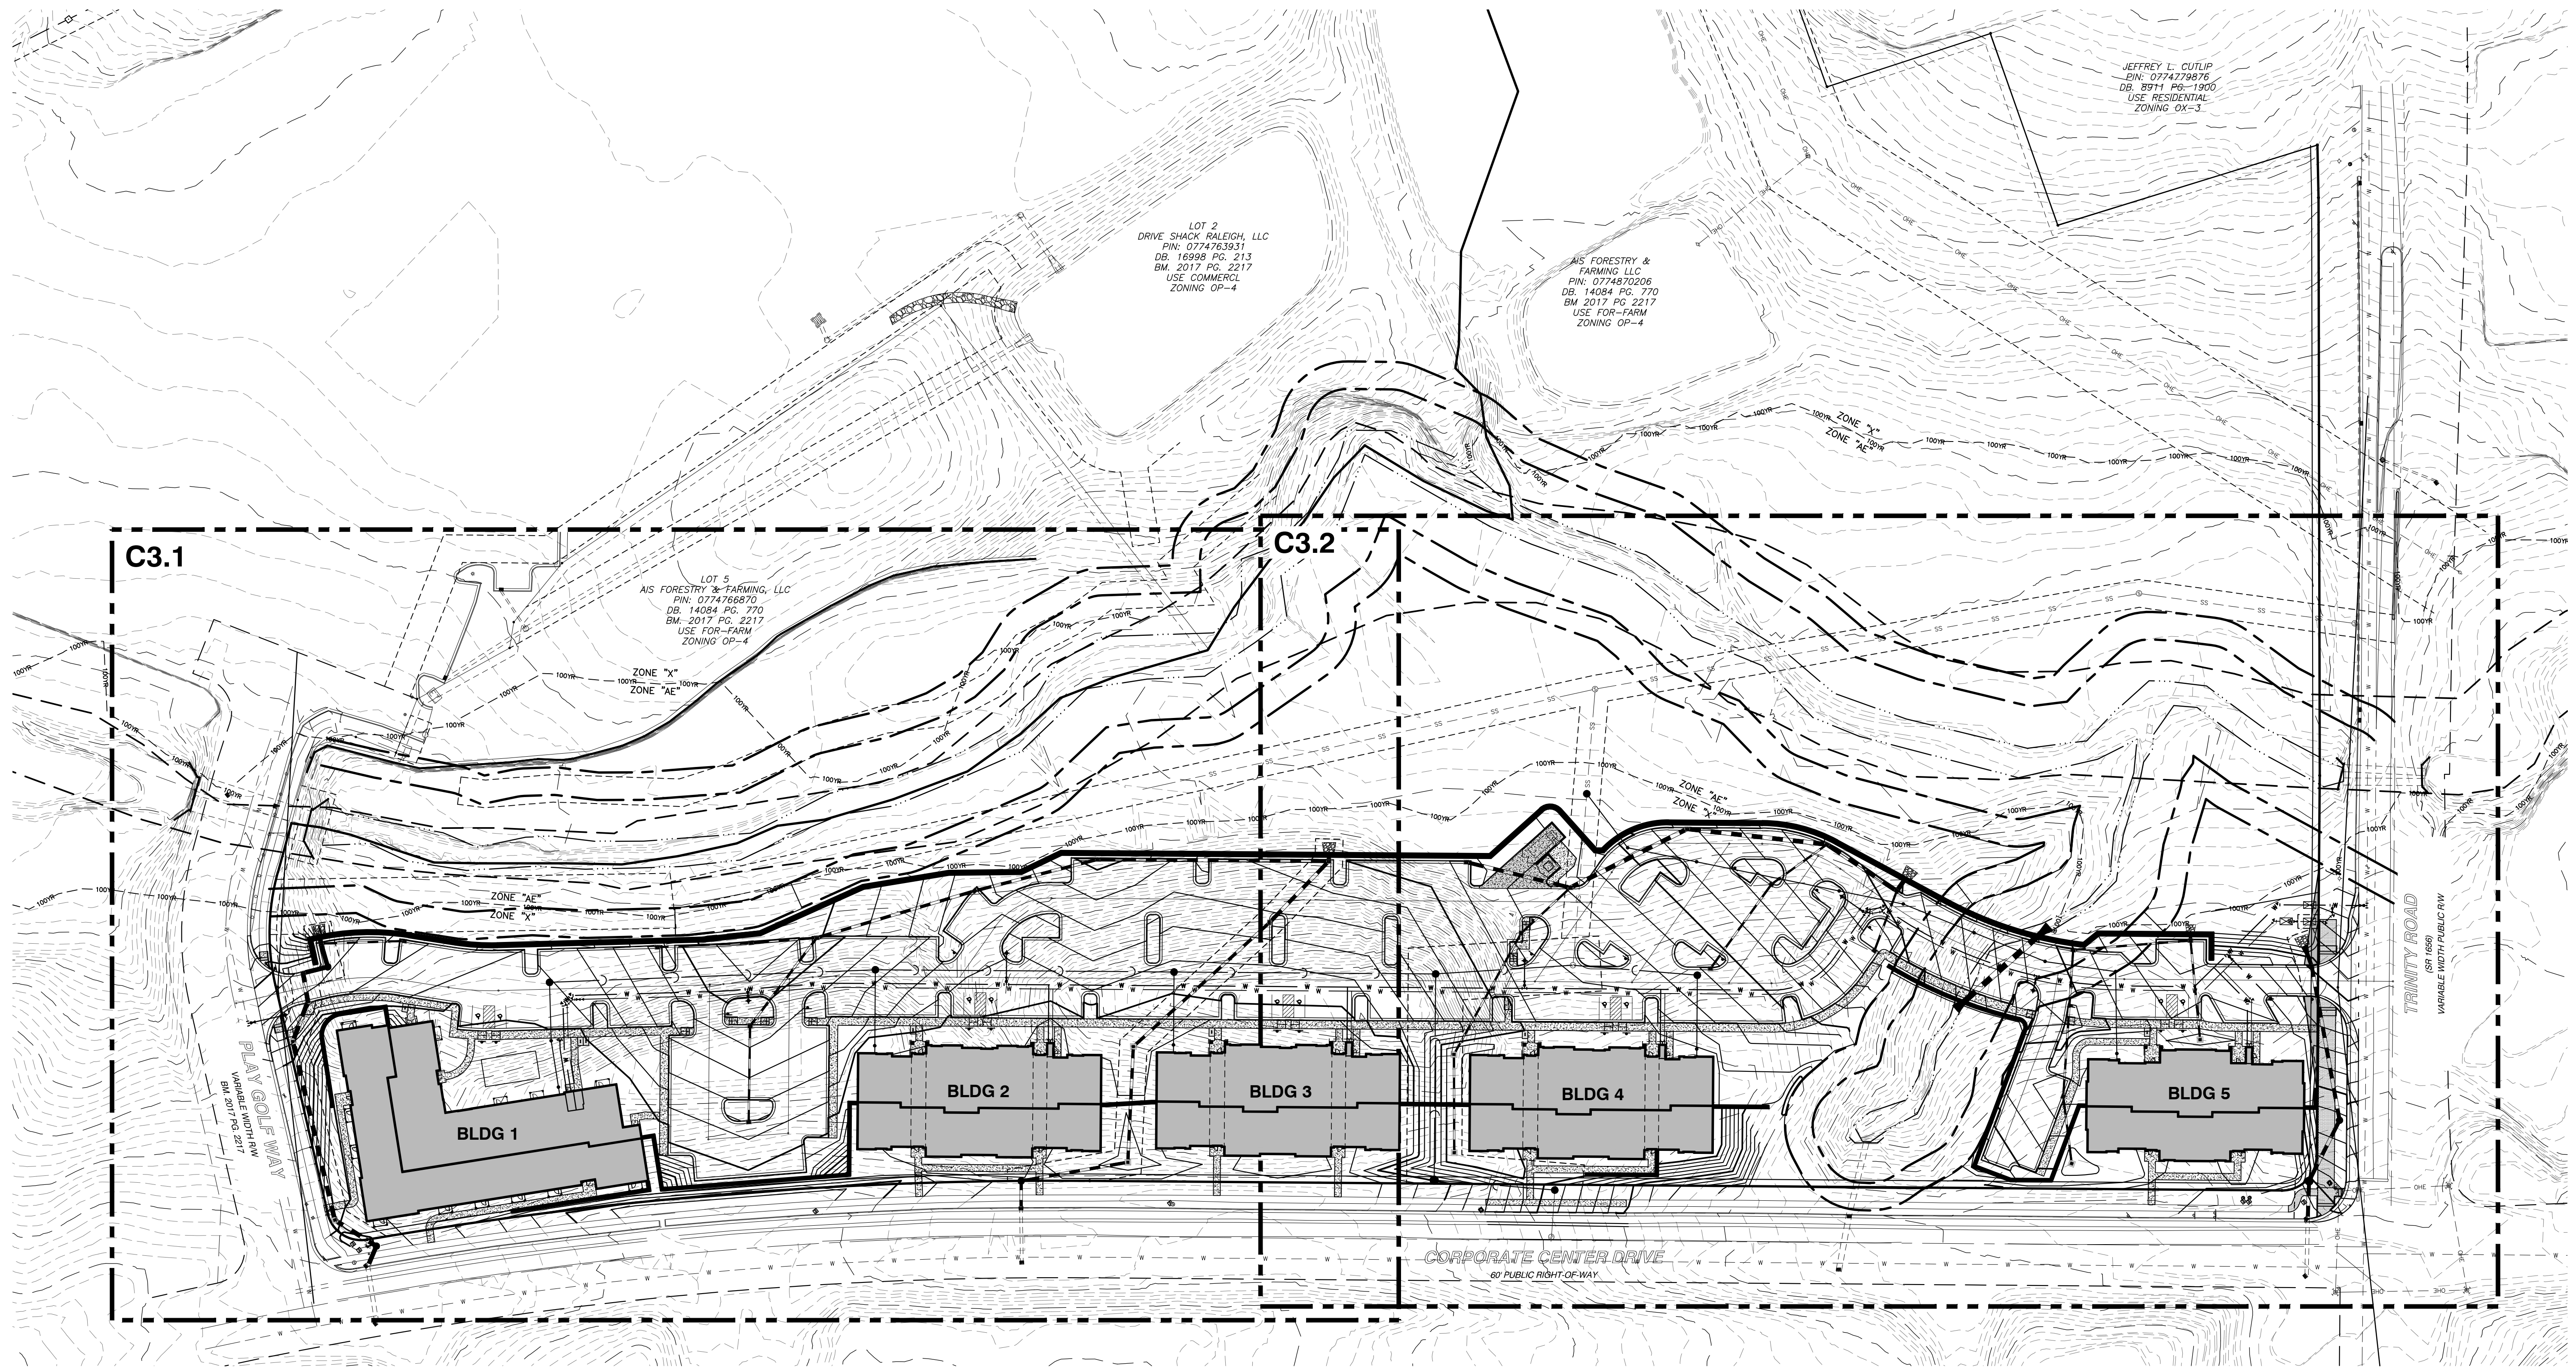

JEFFREY L. CUTLIP
 PIN: 077479876
 DB: 8971 PG: 1900
 USE: RESIDENTIAL
 ZONING OX-3

LOT 2
 DRIVE SHACK RALEIGH, LLC
 PIN: 0774763931
 DB: 16998 PG: 213
 BM: 2017 PG: 2217
 USE: COMMERCIAL
 ZONING OP-4

AIS FORESTRY &
 FARMING LLC
 PIN: 0774870206
 DB: 14084 PG: 770
 BM: 2017 PG: 2217
 USE: FOR-FARM
 ZONING OP-4

LOT 5
 AIS FORESTRY & FARMING, LLC
 PIN: 0774768870
 DB: 14084 PG: 770
 BM: 2017 PG: 2217
 USE: FOR-FARM
 ZONING OP-4

C3.1

C3.2


PLAY GOLF WAY
 (SR 1669)
 VARIABLE WIDTH R/W
 BM: 2017 PG: 2217

TRINITY ROAD
 (SR 1669)
 VARIABLE WIDTH PUBLIC R/W

CORPORATE CENTER DRIVE
 60' PUBLIC RIGHT OF WAY

NO WETLANDS EXIST ON-SITE
 FLOODPLAINS EXIST ON-SITE

NOTE: ALL CONSTRUCTION ACTIVITY SHALL
 BE IN ACCORDANCE WITH CITY OF RALEIGH
 AND NCDOT STANDARDS AND
 SPECIFICATIONS AS APPLICABLE.

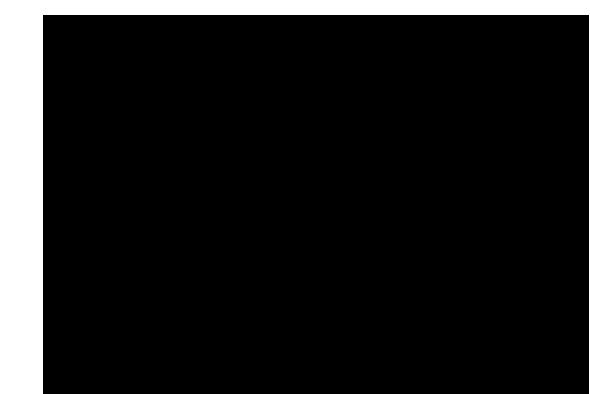

SCALE IN FEET
 0 30 60 120 180 240




BASS, NIXON & KENNEDY, INC.
CONSULTING ENGINEERS
 6310 CHAPEL HILL ROAD, SUITE 250, RALEIGH, NC 27607
 TELEPHONE: (919)861-4422 FAX: (919)861-8868
 CERTIFICATION NUMBERS: NCBELS (C-0110), NCBOLA (C-0267)

NO.	DATE	DESCRIPTION	BY

03-23093	09-08-2023	RAB	
JOB NO.	DATE	DRAWN BY	
OVERALL GRADING & DRAINAGE PLAN			
SCALE: 1" = 60'		CHK BY: MDB	


CORPORATE CENTER DRIVE APARTMENTS
 1101 CORPORATE CENTER DRIVE
 CITY OF RALEIGH, WAKE COUNTY, NORTH CAROLINA

SHEET
C3.0

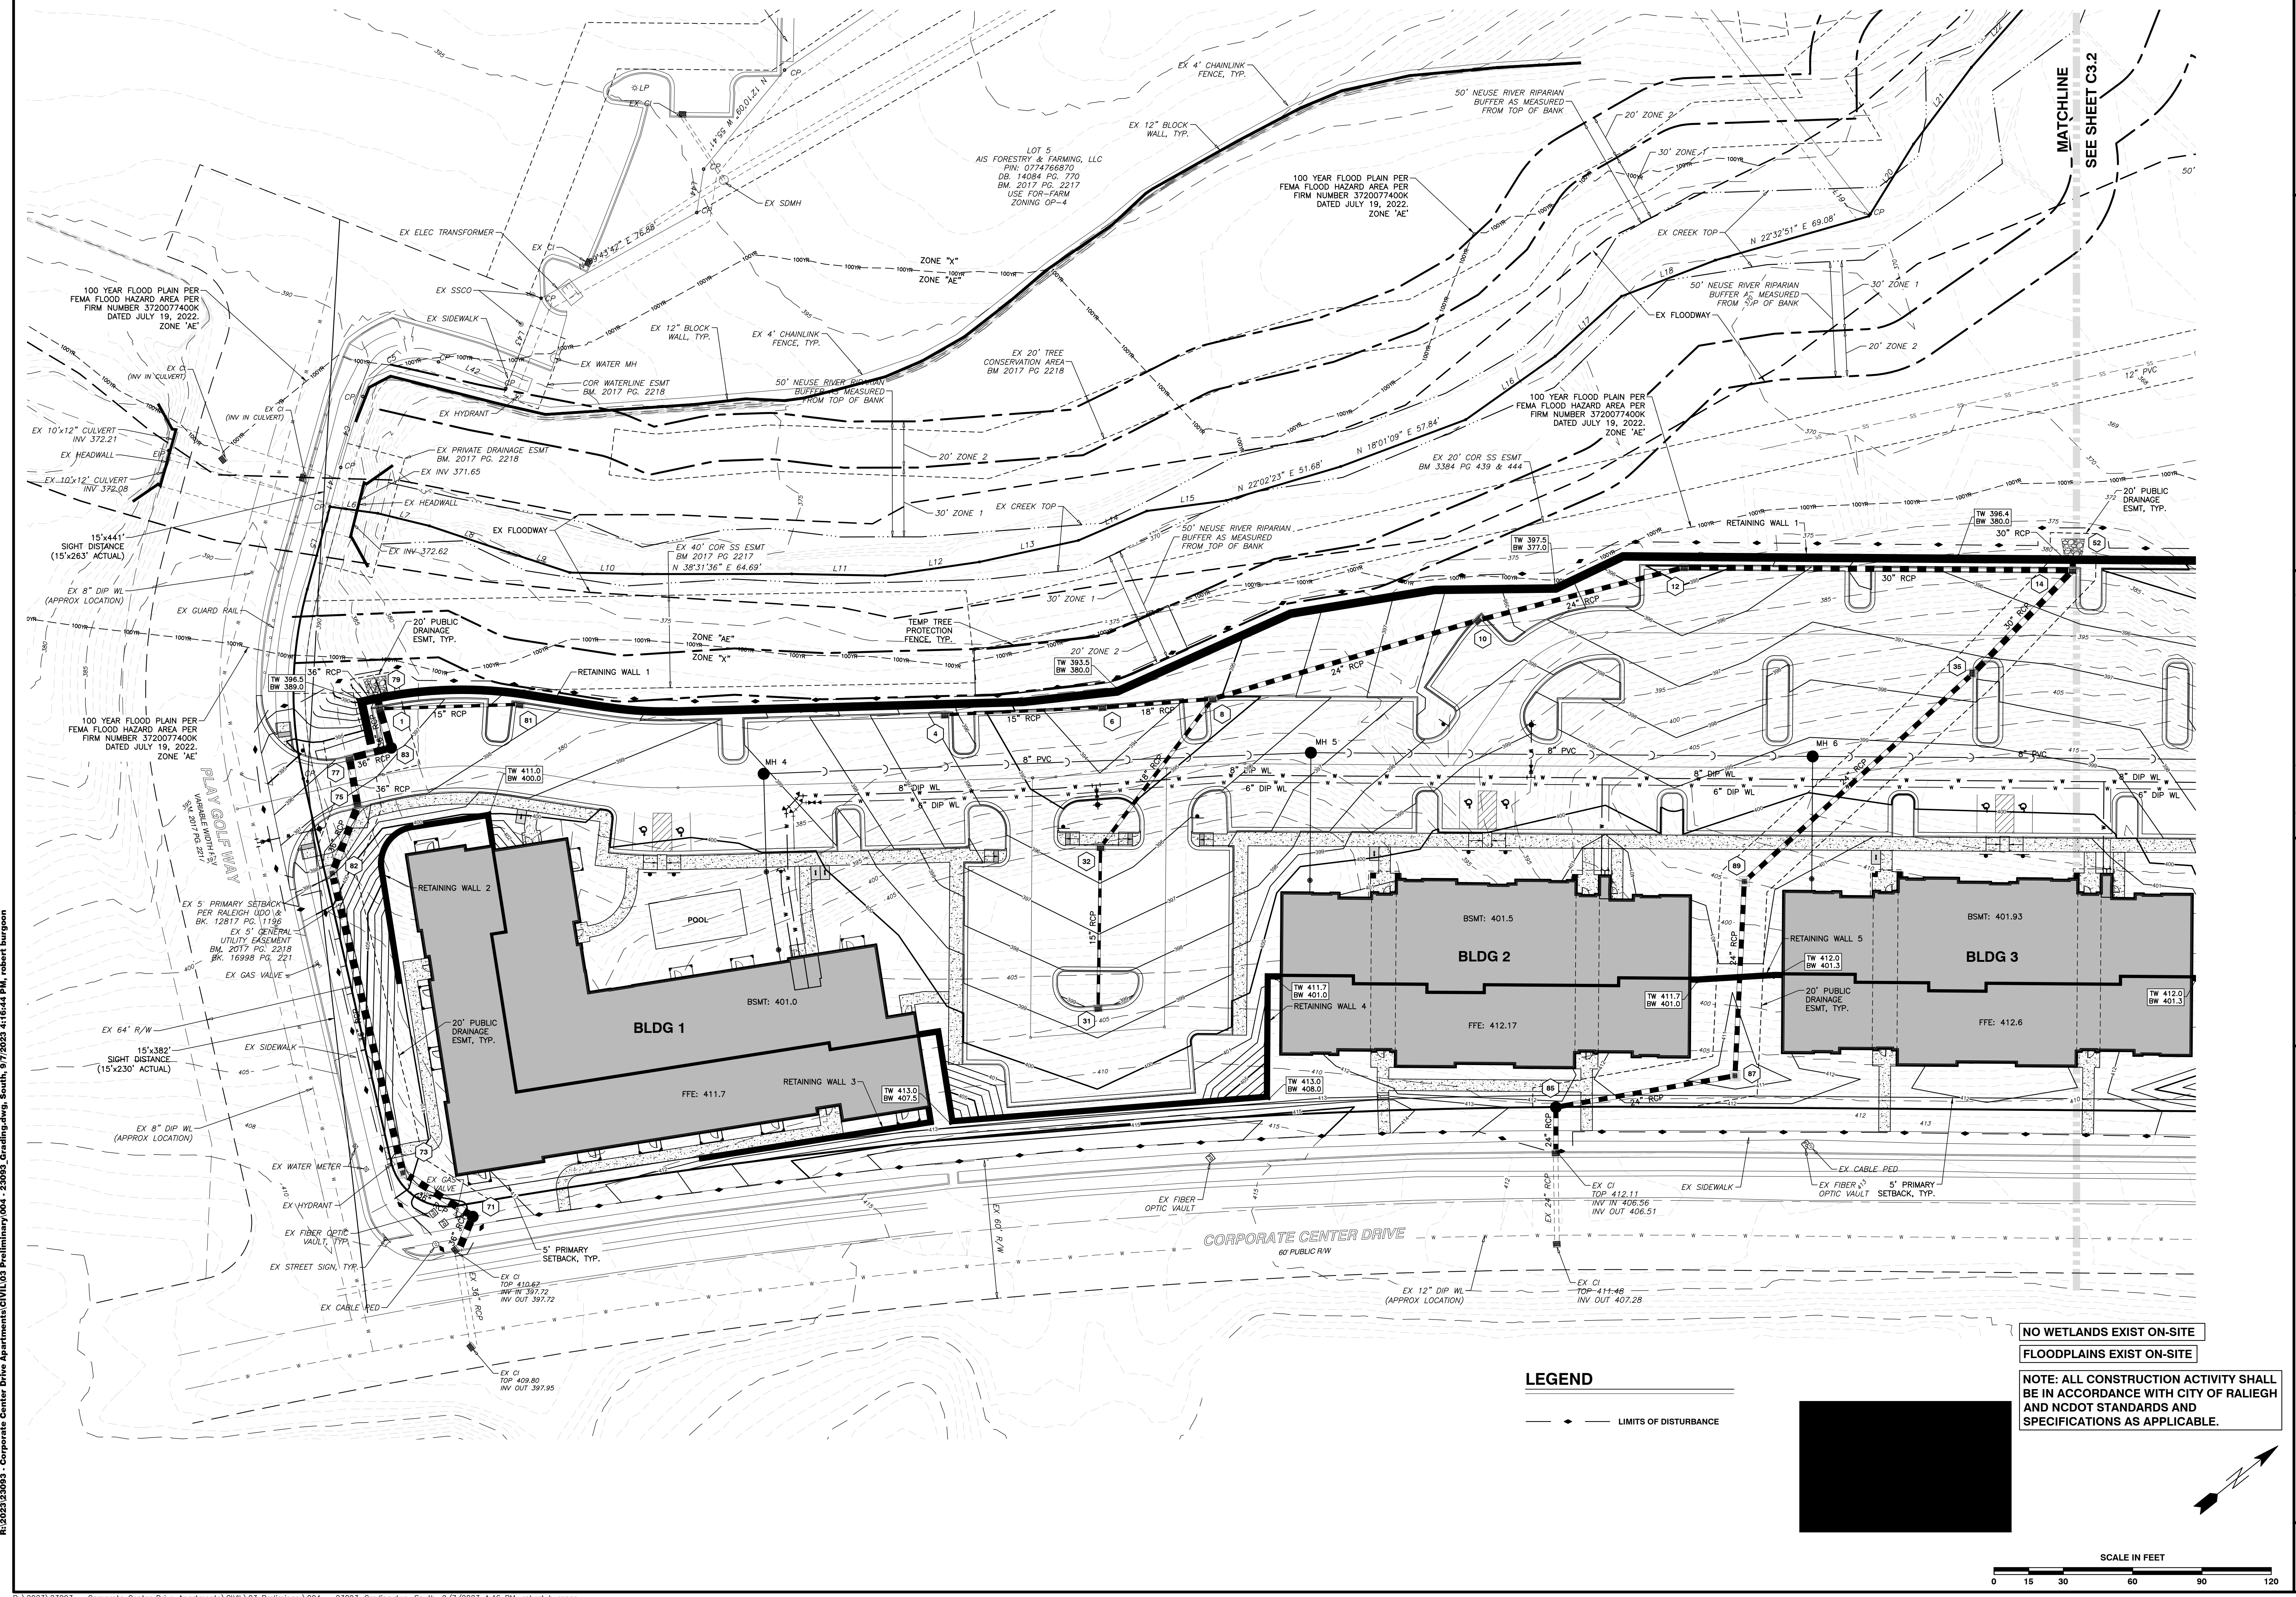

NO WETLANDS EXIST ON-SITE
 FLOODPLAINS EXIST ON-SITE
 NOTE: ALL CONSTRUCTION ACTIVITY SHALL BE IN ACCORDANCE WITH CITY OF RALEIGH AND NCDOT STANDARDS AND SPECIFICATIONS AS APPLICABLE.

LEGEND
 - - - - - LIMITS OF DISTURBANCE

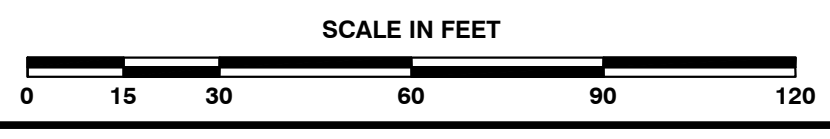

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 TELEPHONE: (919) 861-4422 FAX: (919) 861-8868
 CERTIFICATION NUMBERS: NCBELS (C-010), NCBOLA (C-0267)

NOT RELEASED FOR CONSTRUCTION OR BID SOLICITATION

03-23093 JOB NO. 09-08-2023 DATE 05-08-2023 RAB DRAWN BY

ENLARGED GRADING & DRAINAGE PLAN - SOUTH

SCALE: 1" = 30'

CHK BY: MDB


NO.	DATE	DESCRIPTION	BY

SHEET C3.1

CORPORATE CENTER DRIVE APARTMENTS
 1101 CORPORATE CENTER DRIVE
 CITY OF RALEIGH, WAKE COUNTY, NORTH CAROLINA

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R:\2023\23093 - Corporate Center Drive Apartments\CIVIL\03 Preliminary\04 - 23093_Grading.dwg, South, 9/7/2023 4:16 PM, robert.burgoon

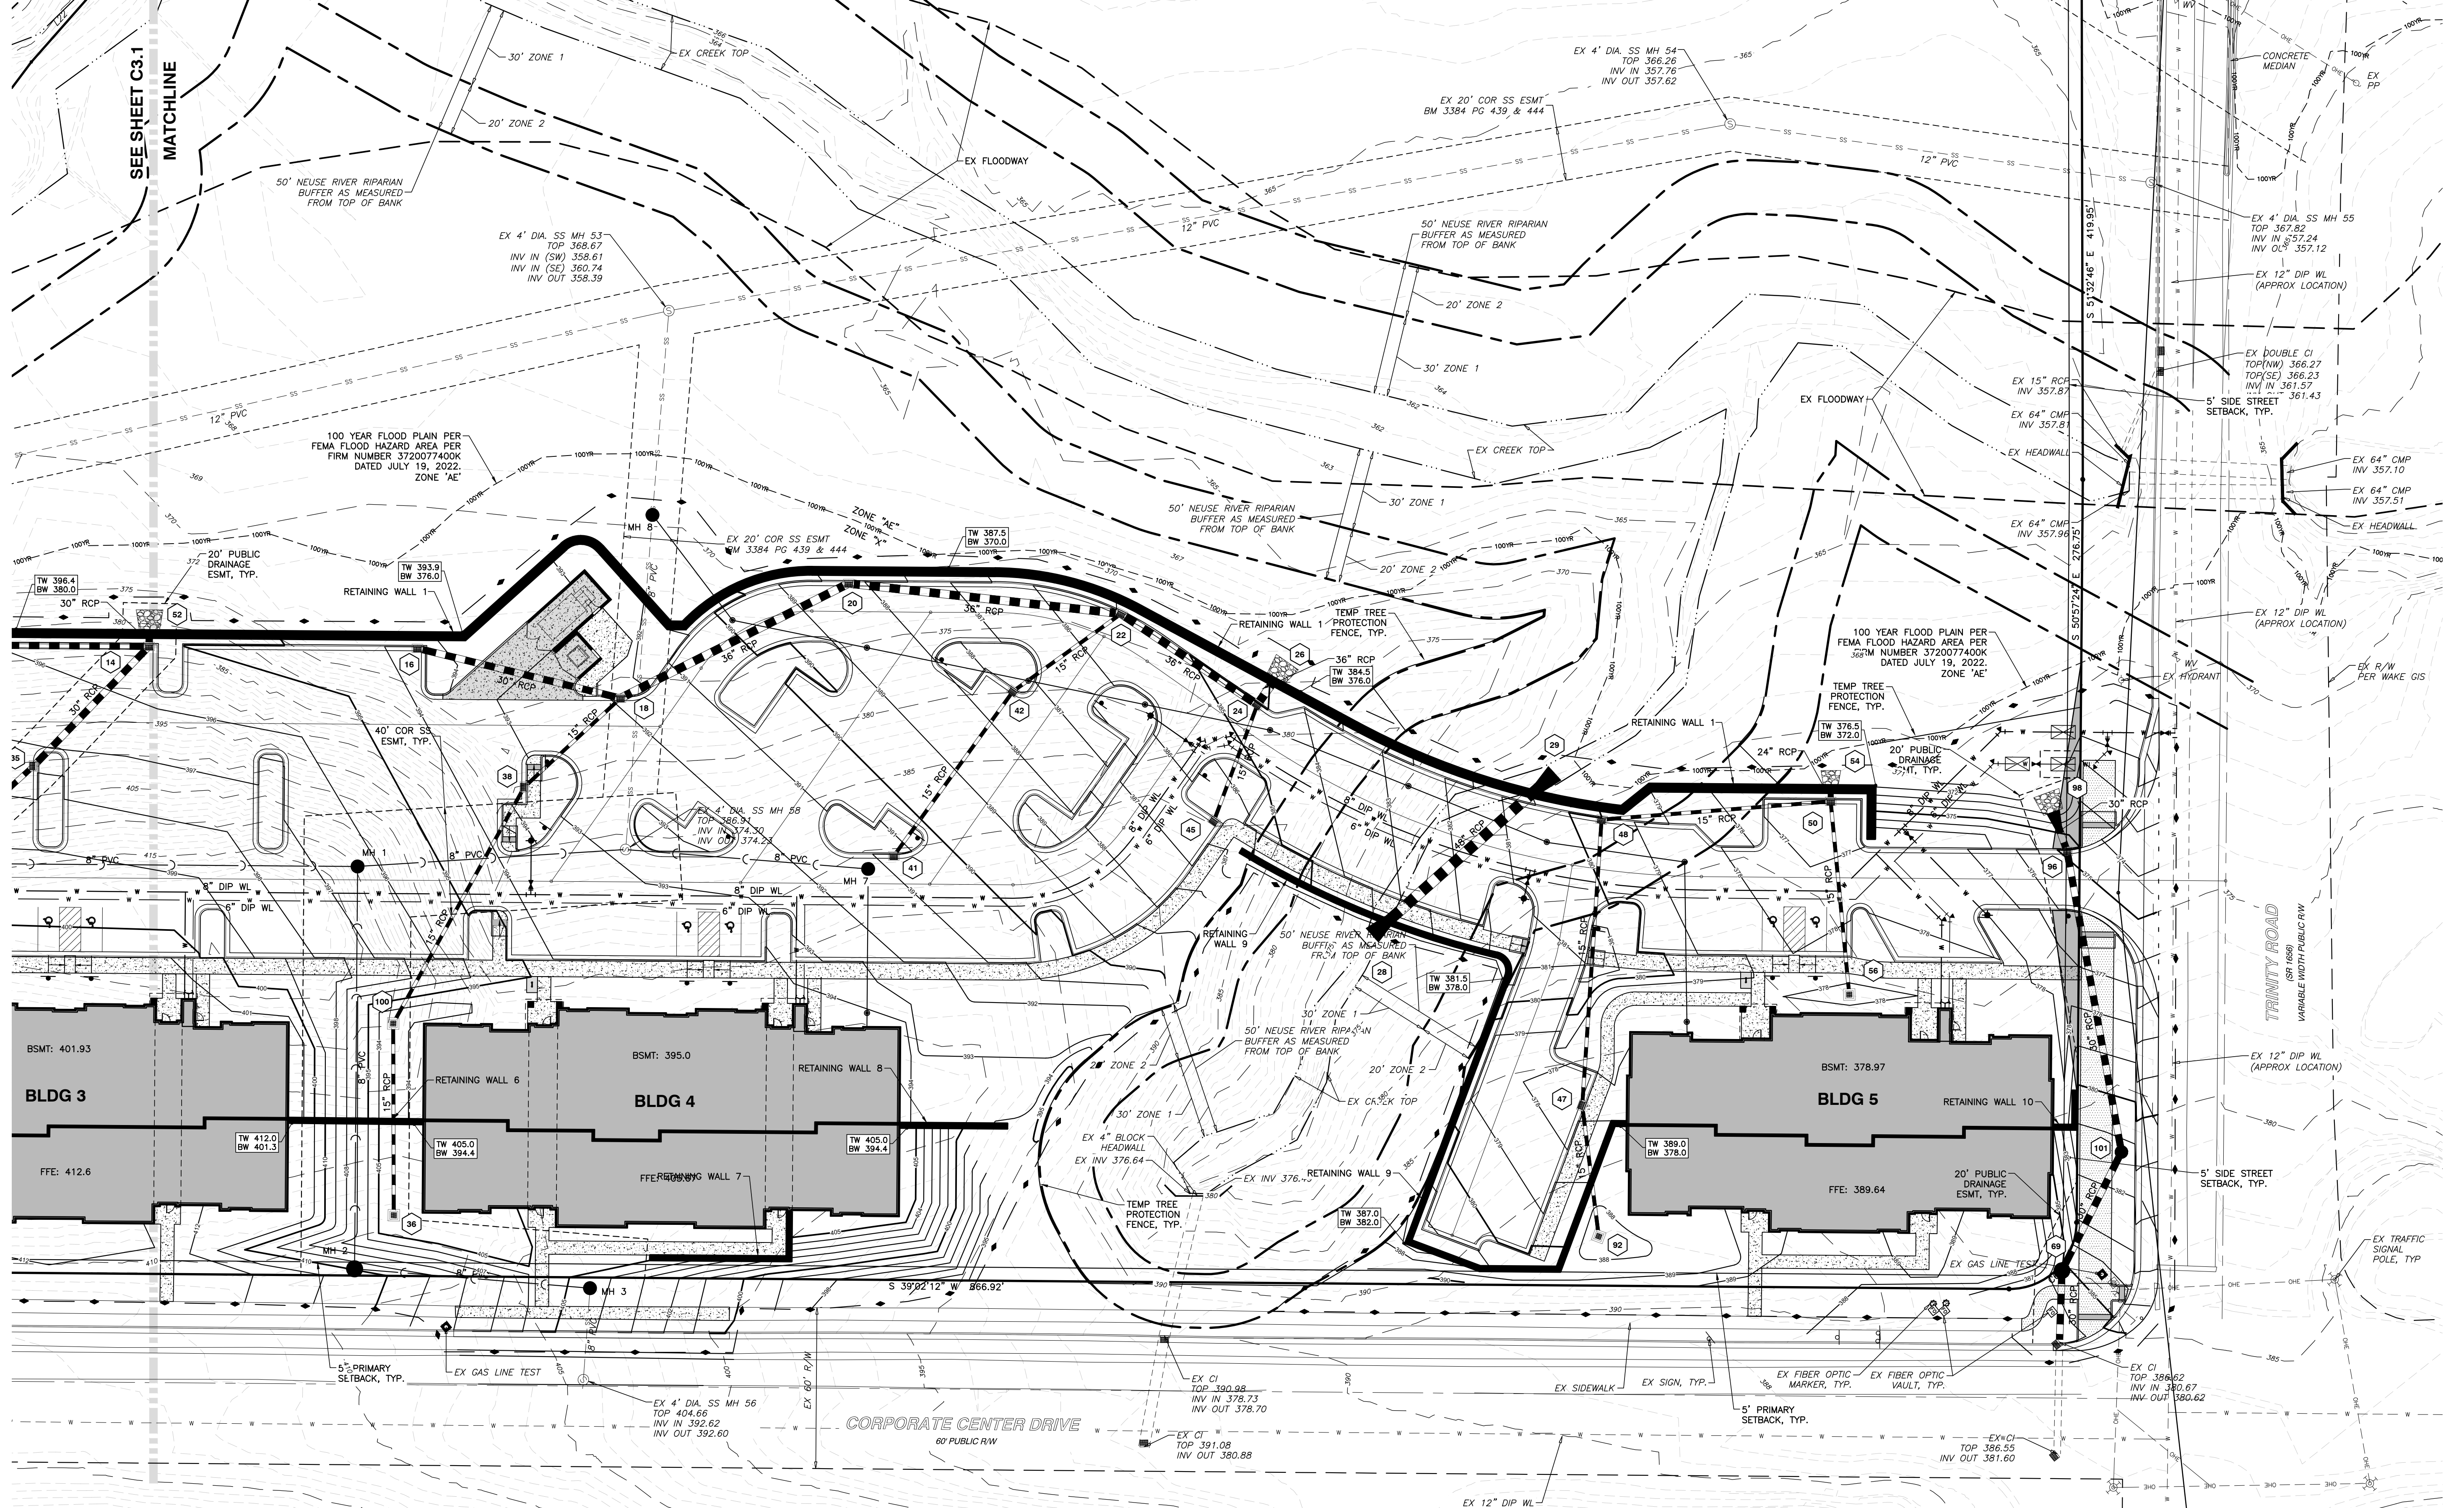

SEE SHEET C3.1
MATCHLINE



100 YEAR FLOOD PLAIN PER FEMA FLOOD HAZARD AREA PER FIRM NUMBER 3720077400K DATED JULY 19, 2022, ZONE 'AE'

100 YEAR FLOOD PLAIN PER FEMA FLOOD HAZARD AREA PER FIRM NUMBER 3720077400K DATED JULY 19, 2022, ZONE 'AE'

NO WETLANDS EXIST ON-SITE
FLOODPLAINS EXIST ON-SITE
NOTE: ALL CONSTRUCTION ACTIVITY SHALL BE IN ACCORDANCE WITH CITY OF RALEIGH AND NCDOT STANDARDS AND SPECIFICATIONS AS APPLICABLE.

LEGEND

— ♦ — LIMITS OF DISTURBANCE

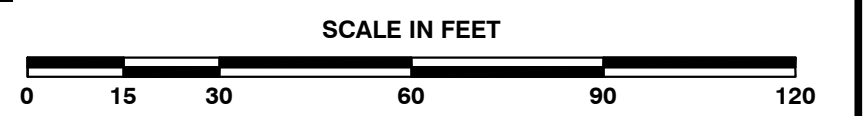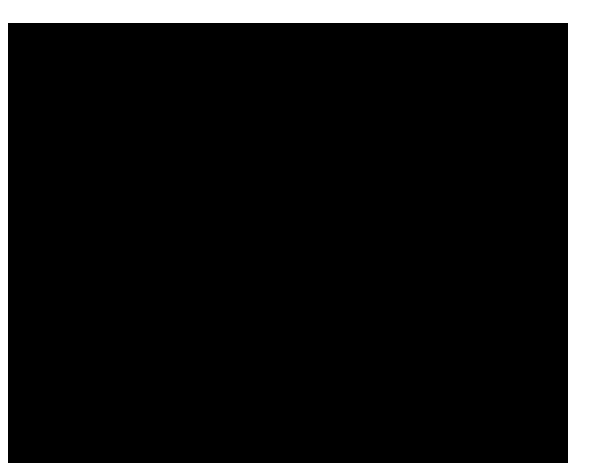


BASS, NIXON & KENNEDY, INC.
CONSULTING ENGINEERS
6310 CHAPEL HILL ROAD, SUITE 250, RALEIGH, NC 27607
TELEPHONE: (919) 861-4422 FAX: (919) 861-8868
CERTIFICATION NUMBERS: NCBELS (C-0110), NCSOLA (C-0267)

NO.	DATE	DESCRIPTION	BY

03-23093 09-08-2023 RAB
JOB NO. DATE DRAWN BY
ENLARGED GRADING & DRAINAGE PLAN - NORTH
SCALE: 1" = 30'
CHK BY: MDB

CORPORATE CENTER DRIVE APARTMENTS
1101 CORPORATE CENTER DRIVE
CITY OF RALEIGH, WAKE COUNTY, NORTH CAROLINA

SHEET
C3.2

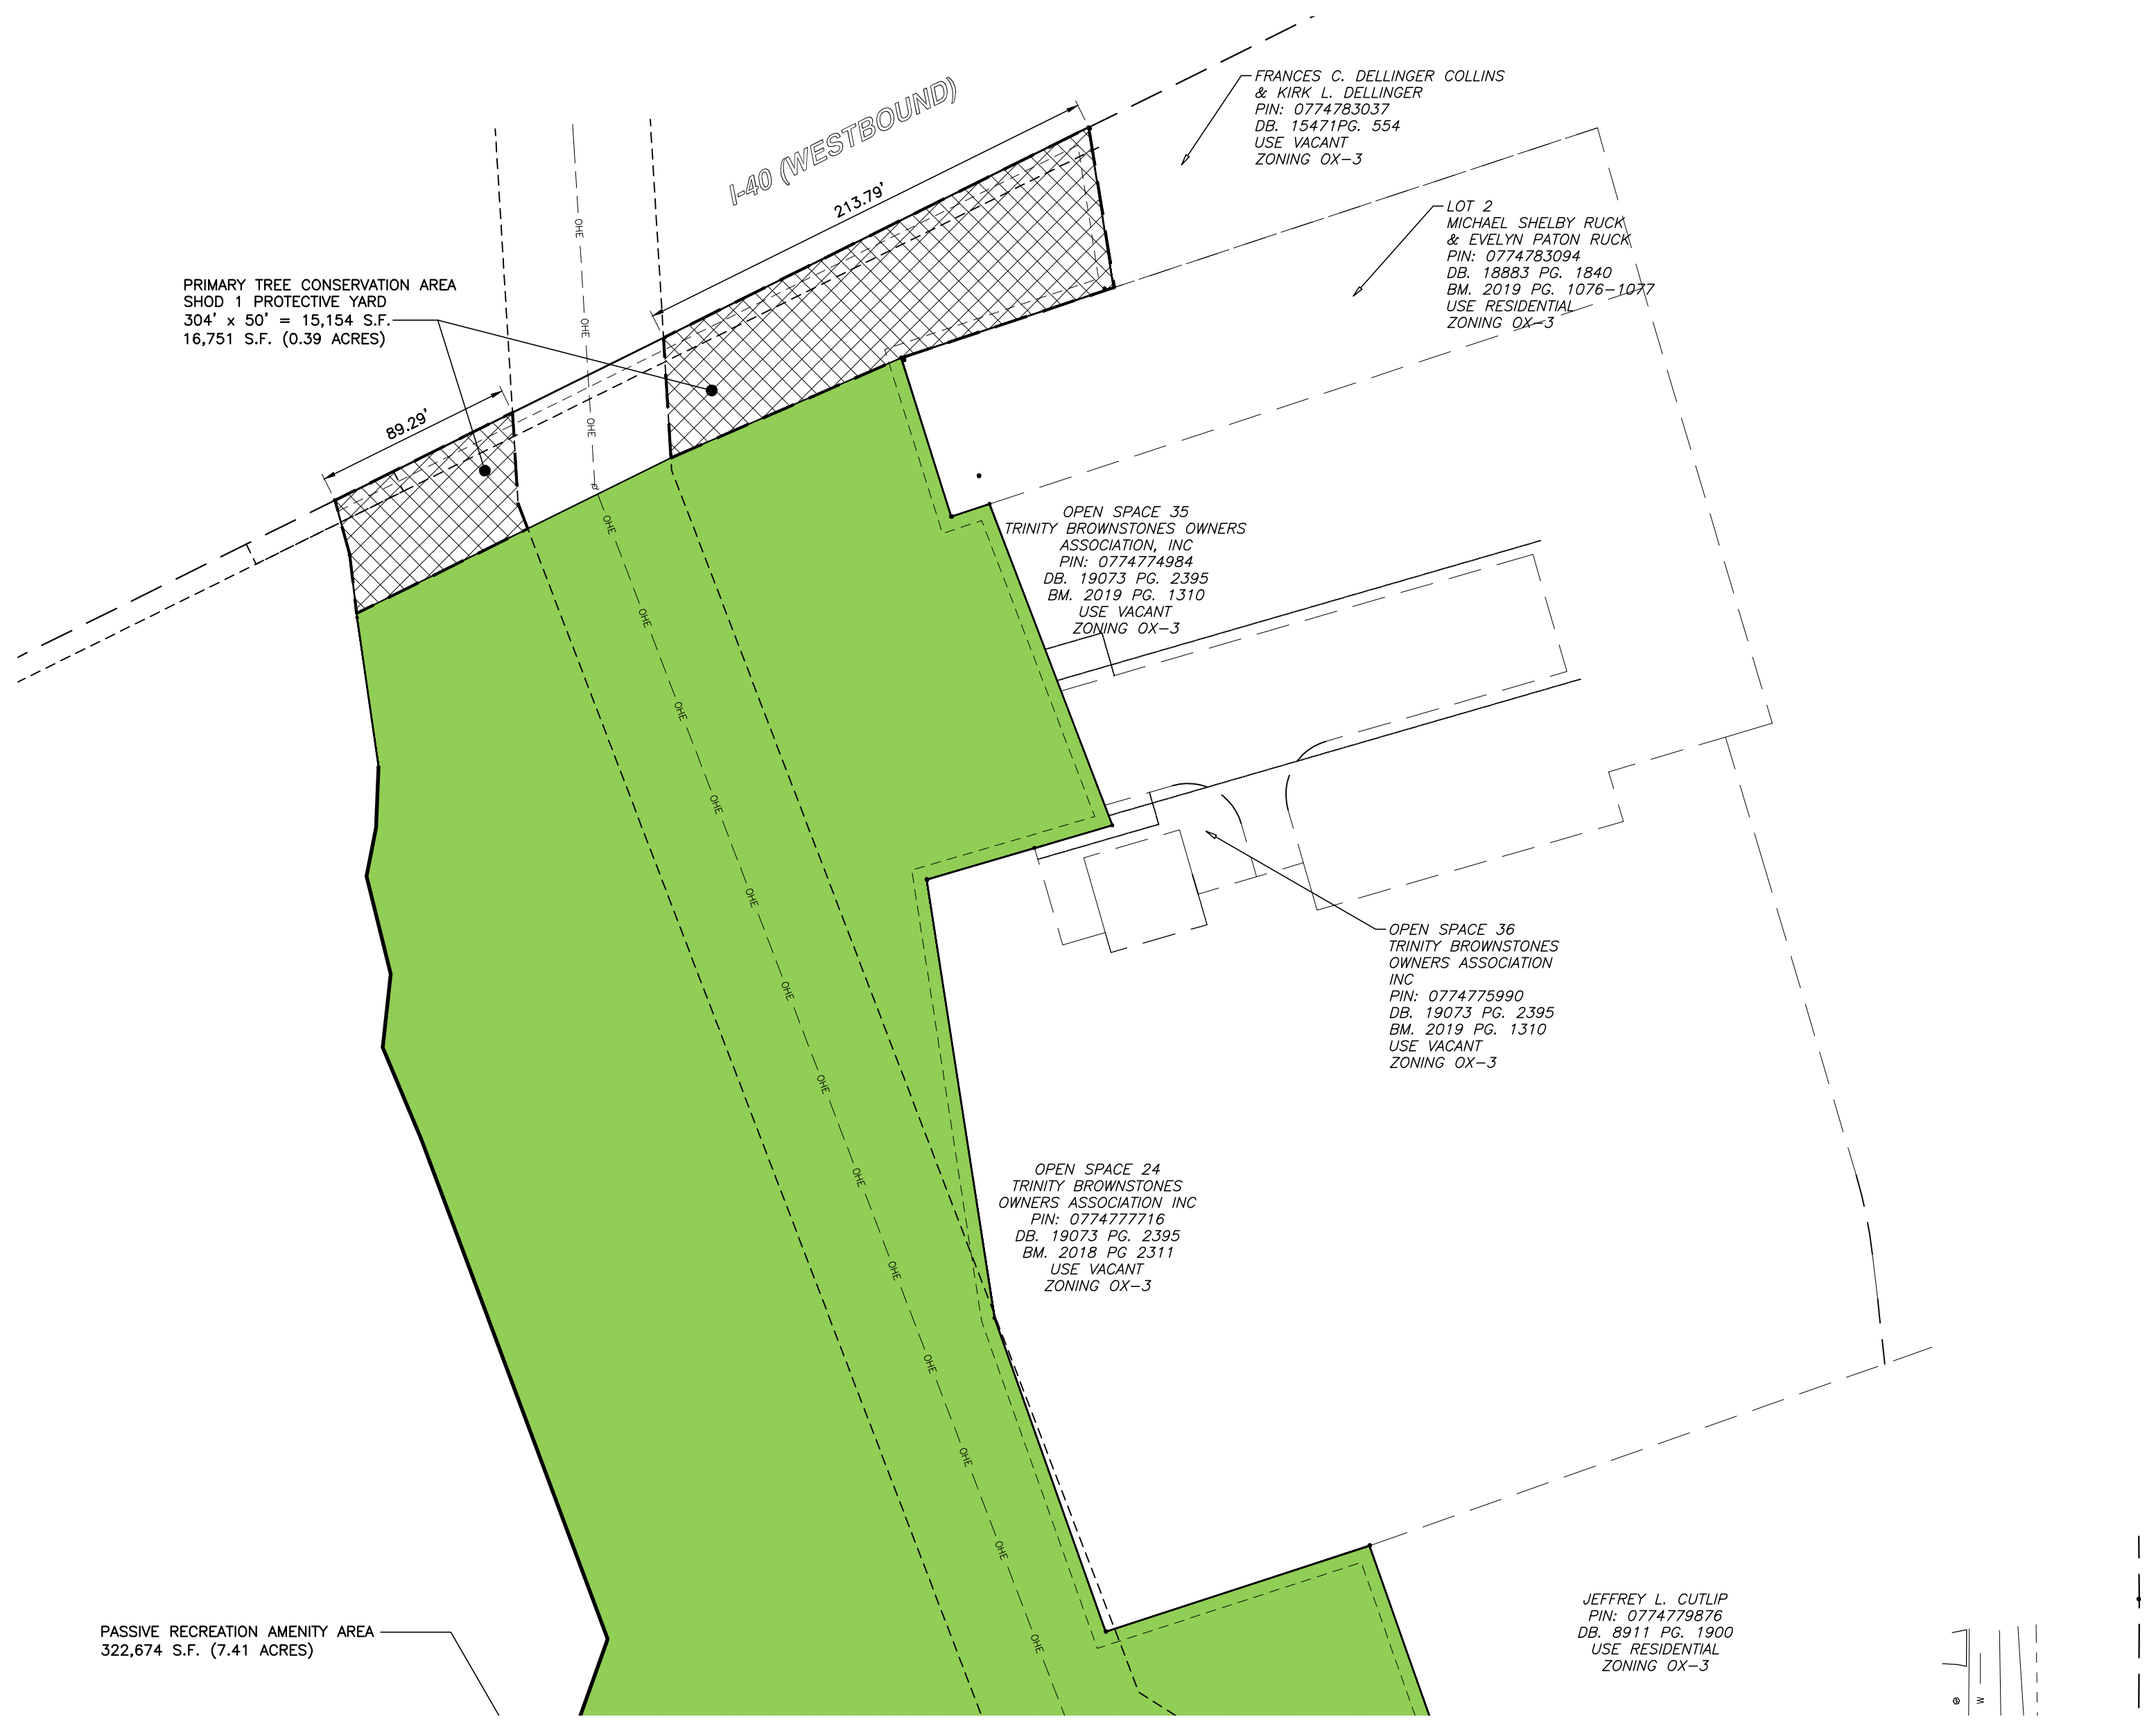


Tree Conservation Plan Data Sheet
UDO Article 9.1 Tree Conservation
(Include applicable information on the plan sheet)

Project Name: Corporate Center Drive Apartments

Gross Site Acres:	21.89	ac
Right-of-way to be dedicated with this project:	1.33	ac
Net Site Acres:	20.56	ac

	Number of Acres	Percent of Tract
UDO 9.1.4.A. Primary Tree Conservation Areas		
1. Primary Tree Conservation Area - SHOD 1	1.18	ac 5.74 %
1. Primary Tree Conservation Area - SHOD 2		ac %
2. Primary Tree Conservation Area - Parkway Frontage		ac %
3. Primary Tree Conservation Area - CM		ac %
4. Primary Tree Conservation Area - MPOD		ac %
5. Primary Tree Conservation Area - Champion Tree XX" dbh species		ac %
6. Primary Tree Conservation Area - Neuse Buffer Zone 2	.91	ac 4.43 %
7. Primary Tree Conservation Area - 45% Slopes		ac %
8. Primary Tree Conservation Area - Thoroughfare		ac %
Subtotal of Primary Tree Conservation Areas:	2.09	ac 10.17 %
UDO 9.1.4.D.2 Tree Conservation Area - Greenway		
		ac %
UDO 9.1.4.B.1.a. & b. Secondary Tree Conservation Areas (Include perimeter buffers and their alternate compliance areas)		
		ac %
UDO 9.1.4.B.1.c. & d. Individual Tree Secondary Tree Conservation Areas (Include individual trees and their alternate compliance areas)		
		ac %
Subtotal of Secondary Tree Conservation Areas:		ac %
TOTAL ALL TREE CONSERVATION AREA PROVIDED:		ac %
UDO 9.1.9. Watershed Protection Overlay Districts		
UWPOD - Wooded Area (preserved)		ac %
UWPOD - Wooded Area (planted)		ac %
FWPOD - Wooded Area (preserved)		ac %
FWPOD - Wooded Area (planted)		ac %
SWPOD - Wooded Area (preserved)		ac %
SWPOD - Wooded Area (planted)		ac %

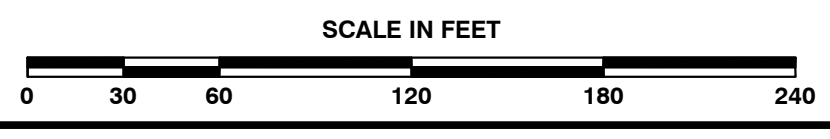


BASS, NIXON & KENNEDY, INC.
CONSULTING ENGINEERS
6310 CHAPEL HILL ROAD, SUITE 250, RALEIGH, NC 27607
TELEPHONE: (919) 861-4422 FAX: (919) 861-8868
CERTIFICATION NUMBERS: NCBELS (C-0110), NCBOLA (C-0267)

NO.	DATE	DESCRIPTION	BY

03-23093 09-08-2023 RAB
JOB NO. DATE DRAWN BY
TREE CONSERVATION
PLAN - NORTH
SCALE: 1" = 60' CHK BY: MDB

CORPORATE CENTER DRIVE APARTMENTS
1101 CORPORATE CENTER DRIVE
CITY OF RALEIGH, WAKE COUNTY, NORTH CAROLINA

SHEET
TC1.1

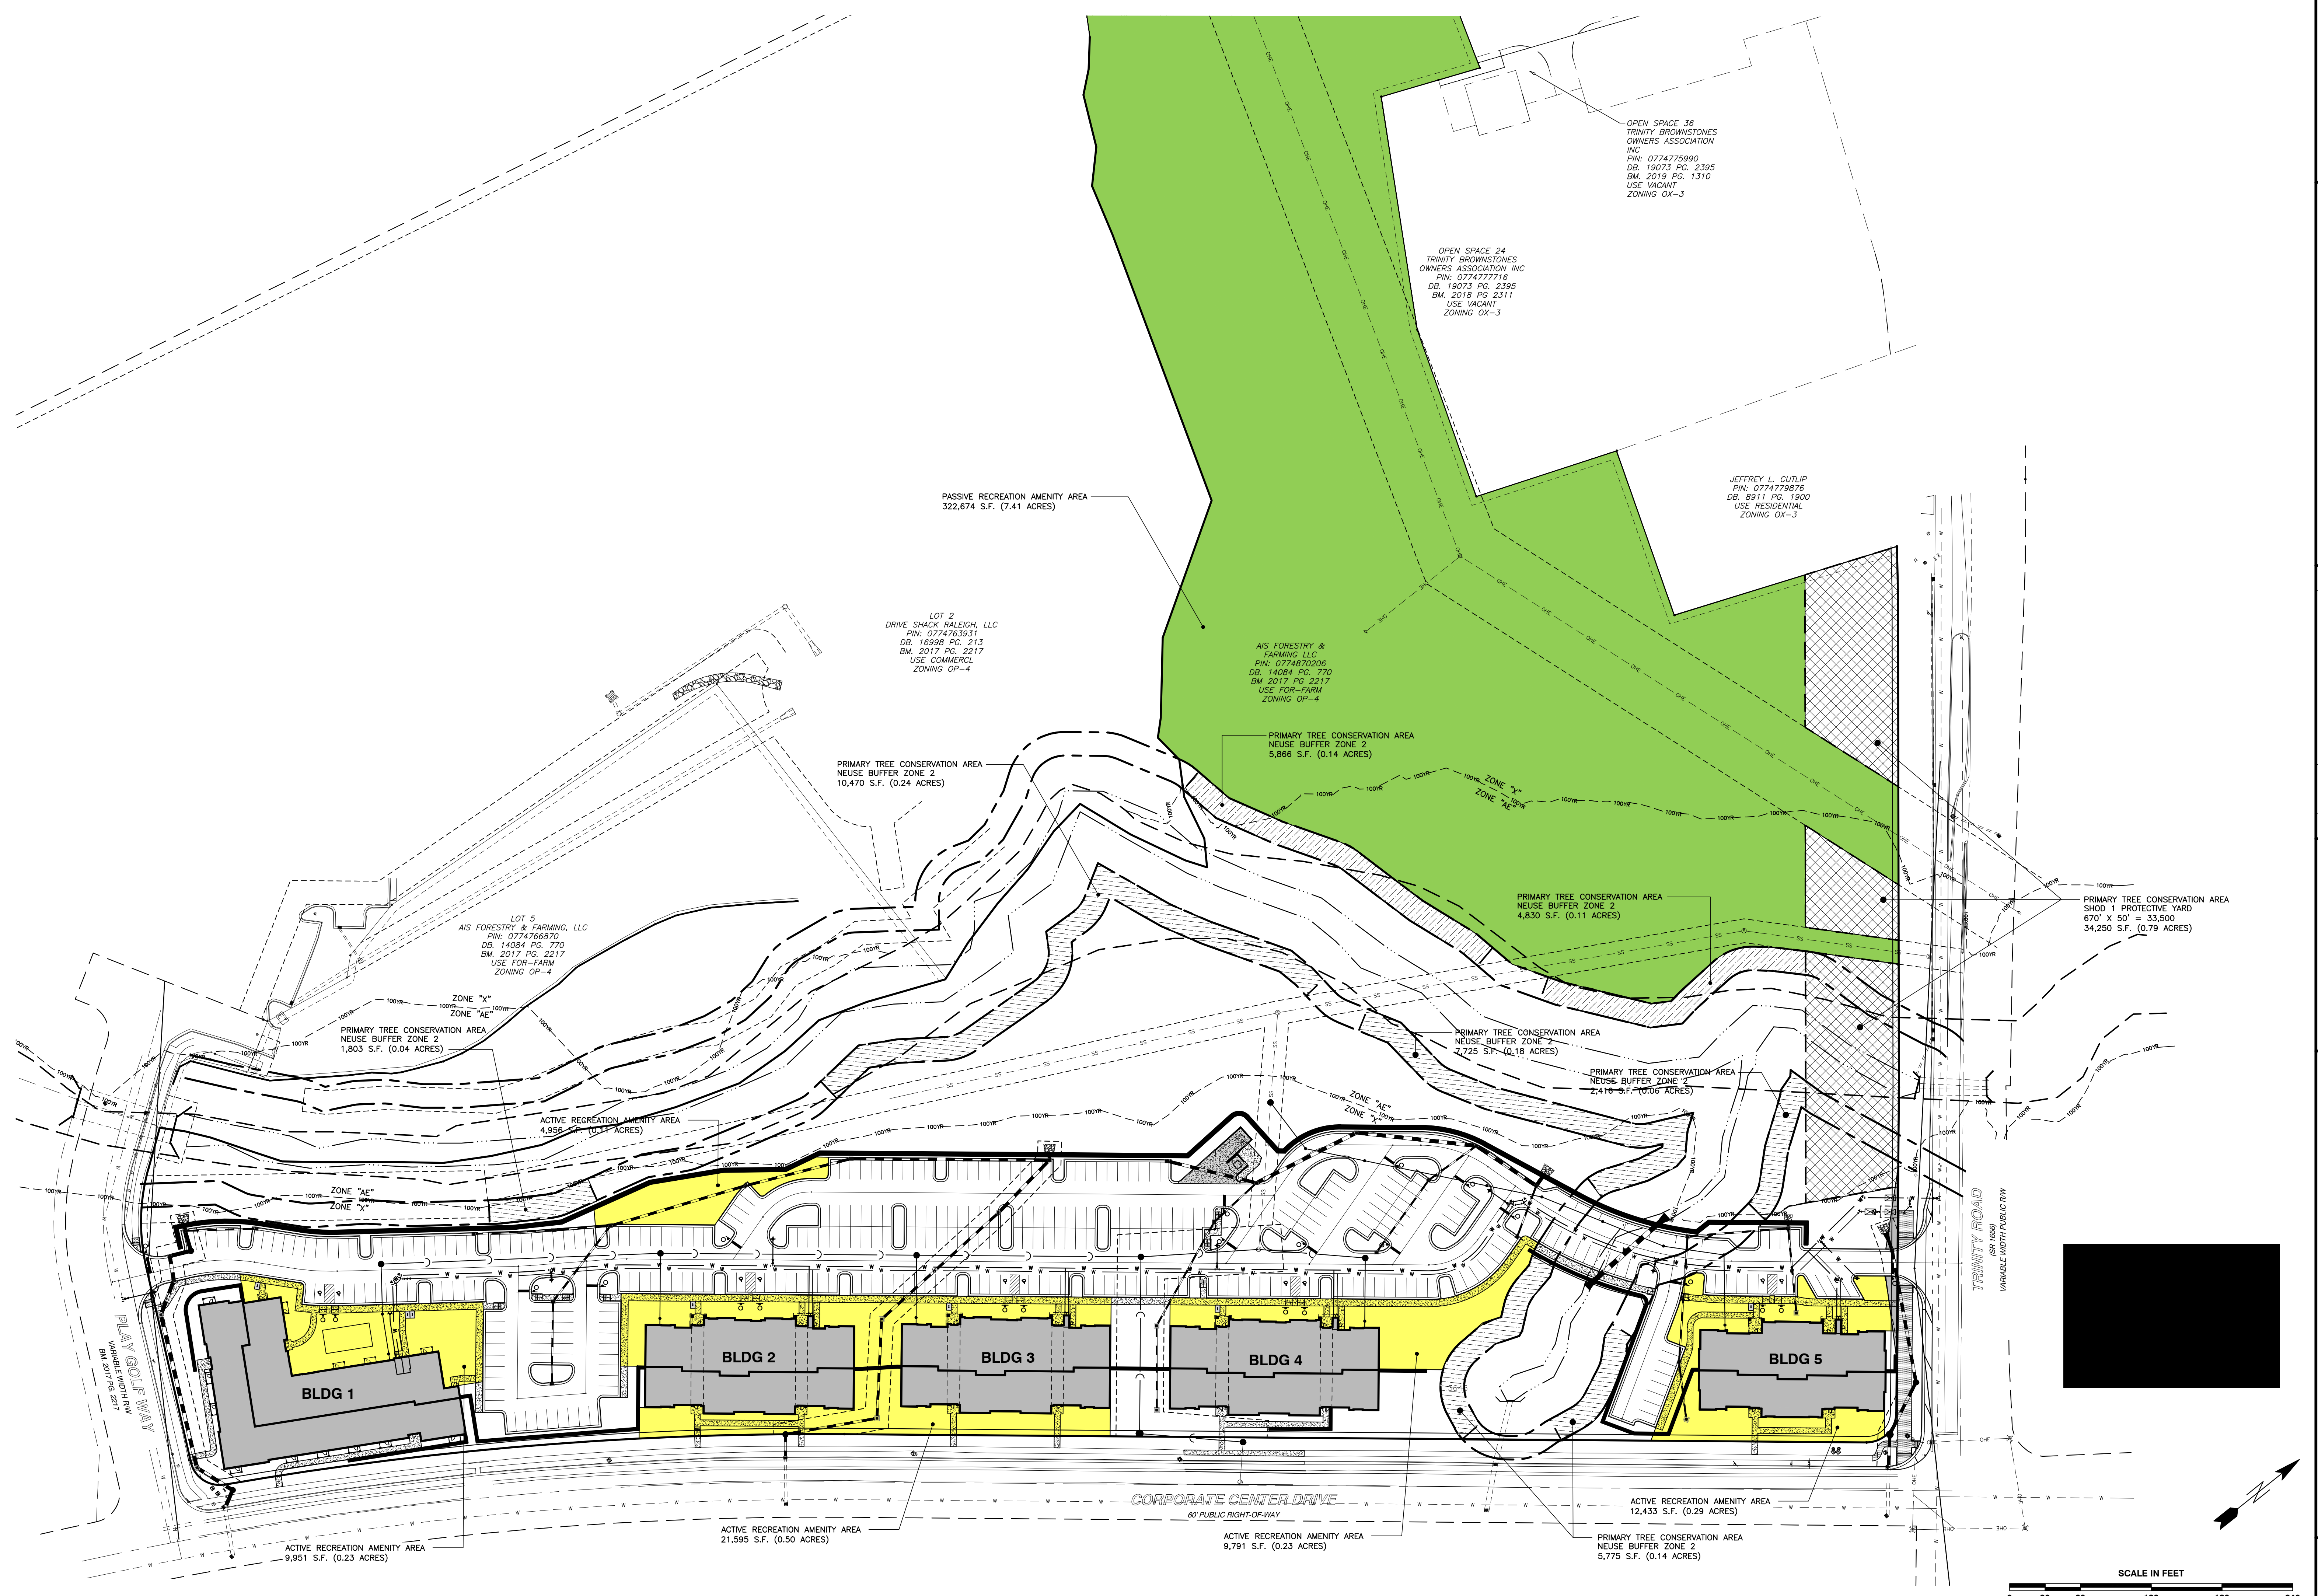

BNK
BASS, NIXON & KENNEDY, INC.
CONSULTING ENGINEERS
 6310 CHAPEL HILL ROAD, SUITE 250, RALEIGH, NC 27607
 TELEPHONE: (919)961-4422 FAX: (919)961-8868
 CERTIFICATION NUMBERS: NCBELS (C-0110), NCBOLA (C-0267)

NO.	DATE	DESCRIPTION	BY

RAB: MDB
 DATE: 09-08-2023
 DRAWN BY: MDB
OVERALL GRADING & DRAINAGE PLAN
 SCALE: 1" = 60'
 CHK BY: MDB

CORPORATE CENTER DRIVE APARTMENTS
1101 CORPORATE CENTER DRIVE
 CITY OF RALEIGH, WAKE COUNTY, NORTH CAROLINA

SHEET TC1.2

SEALS


PRELIMINARY
 NOT FOR CONSTRUCTION

CITY OF RALEIGH, WAKE COUNTY, NORTH CAROLINA
CORPORATE CENTER DRIVE
APARTMENTS
 1101 CORPORATE CENTER DRIVE

REVISION SCHEDULE		
NO.	DESCRIPTION	DATE

SHEET
 DRAWN BY: KBT
 CHECKED BY: PLC
 DATE ISSUED: 8-7-23
 SHEET NAME:
 SIGHT LIGHTING

SHEET NUMBER:
SL-001

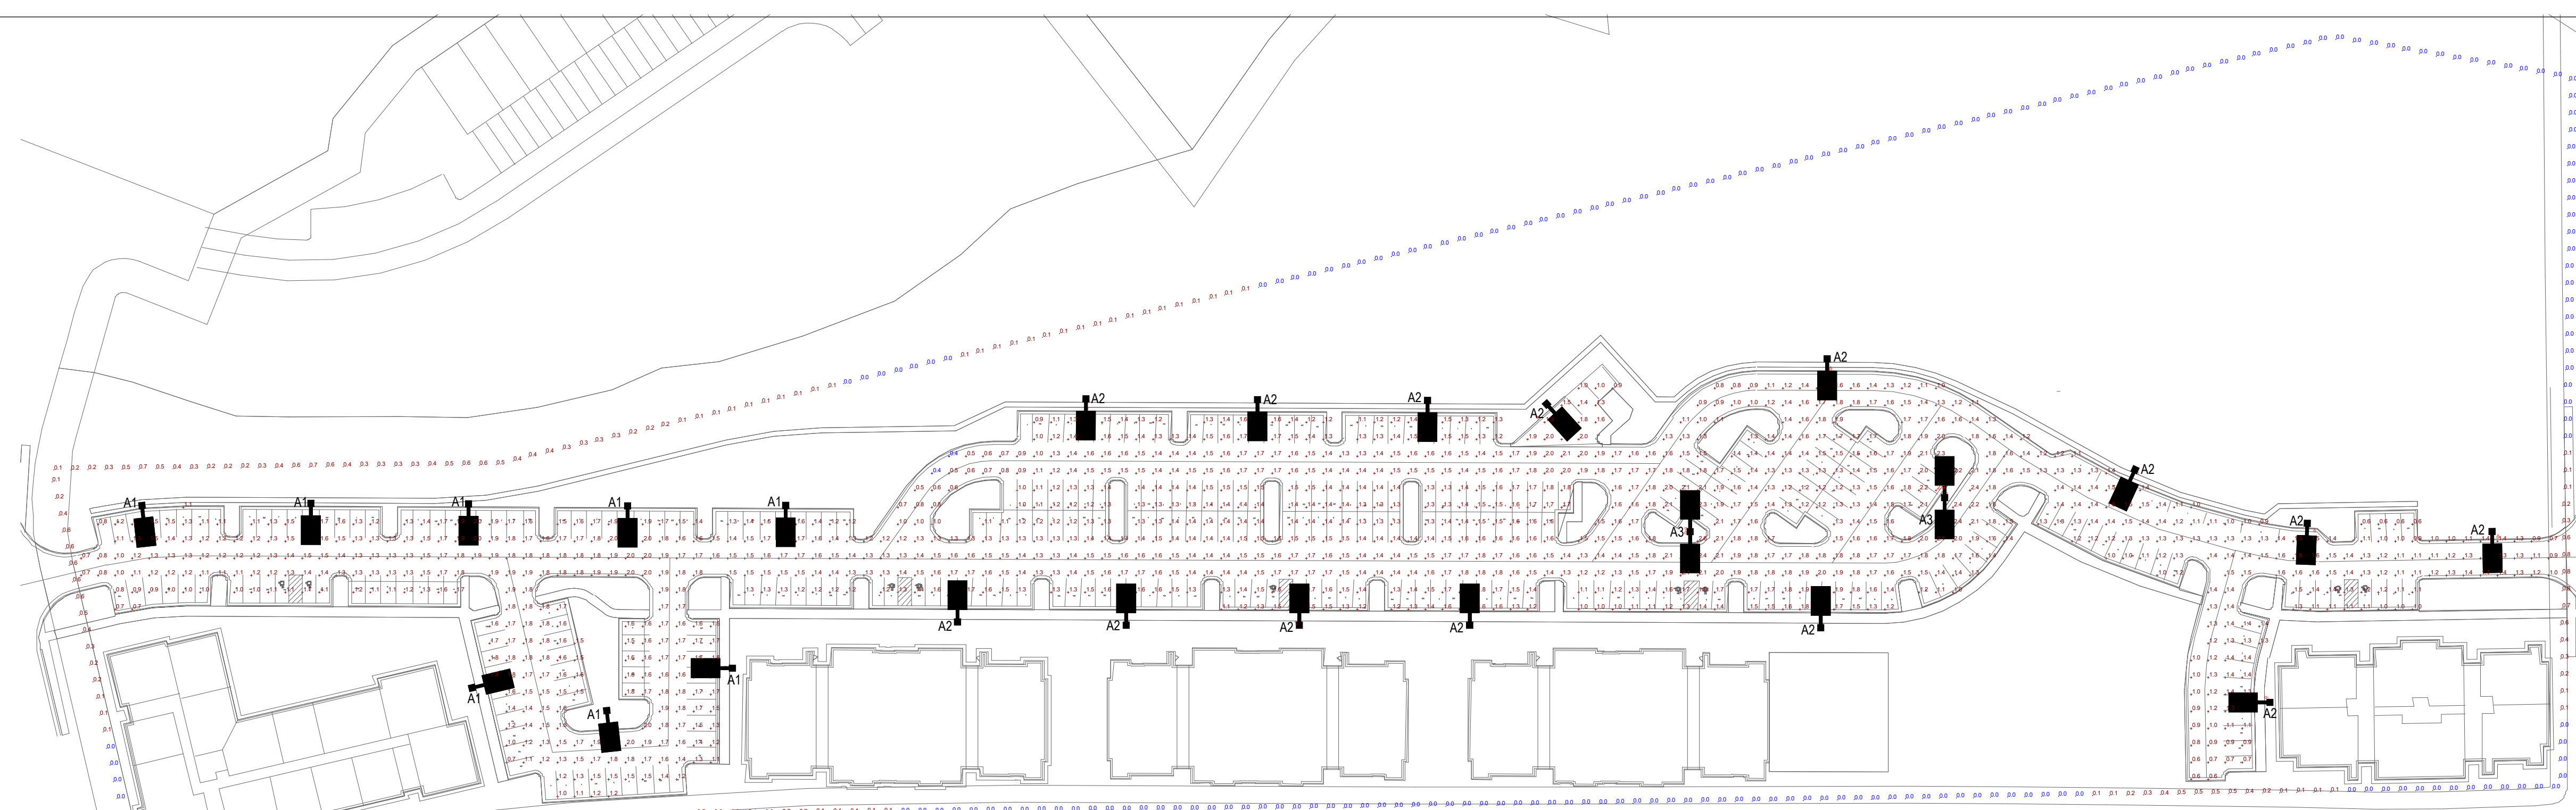

1 SIGHT LIGHTING
 SCALE: 1" = 60'-0"


NOTE:
 1. BUILDING LIGHTING SHALL BE PROVIDED TO ILLUMINATE ENTRANCES AND EXITS TO MEET IES STANDARDS AS PART OF THE BUILDING ELECTRICAL DESIGN AND IS NOT INCLUDED IN THE SCOPE OF THIS SITE LIGHTING LAYOUT.
 2. ALL SITE LIGHTING SHALL BE SHIELDED FROM ADJACENT PUBLIC STREETS USING HOUSE SIDE SHIELDS IF GREATER THAN 2.0 FC AT PROPERTY LINE.
 3. THE INTENT OF THIS DRAWING IS TO SHOW FOOTCANDLE LEVELS BASED ON FIXTURES SHOWN. ACTUAL LEVELS MAY VARY BASED ON ACTUAL FIXTURE INSTALLATION.
 4. THIS DRAWING IS INTENDED FOR PRELIMINARY SITE PLAN APPROVAL OF DESIGNED LIGHTING LEVELS AND IS NOT INTENDED TO BE USED FOR CONSTRUCTION.

ELECTRICAL CONNECTION NOTE:
 THIS IS A SITE LIGHTING CALCULATION PLAN ONLY AND DOES NOT PROVIDE ELECTRICAL CONNECTIONS FOR FIXTURES SHOWN. SITE DEVELOPERS (OWNERS, BUILDERS AND GENERAL CONTRACTORS) ARE RESPONSIBLE FOR COORDINATING WITH BUILDING ELECTRICAL CONTRACTOR OR POWER COMPANY FOR POWER CONNECTIONS FOR ALL FIXTURES.

TYPE MARK	DESCRIPTION	MANUFACTURER	MODEL	MOUNTING HEIGHT	WATTAGE
A1	NEW LED POLE MOUNTED PARKING LOT LIGHTING - TYPE 4 DISTRIBUTION	LITHONIA	DSX1 P3 40K 80CRI T4M MVOLT	30'-0"	102.0 W
A2	NEW LED POLE MOUNTED PARKING LOT LIGHTING - TYPE 3 DISTRIBUTION	LITHONIA	DSX1 P3 40K 80CRI T3M MVOLT	30'-0"	102.0 W
A3	NEW LED POLE MOUNTED PARKING LOT LIGHTING - TYPE 3 DISTRIBUTION	LITHONIA	DSX1 P3 40K 80CRI T3M MVOLT	30'-0"	204.0 W

STATISTIC	VALUE
AVERAGE	1.5 fc
MAXIMUM	2.9 fc
MINIMUM	0.4 fc
MAX/MIN	7.3:1
AVG/MIN	3.8:1

STATISTIC	VALUE
AVERAGE	0.1 fc
MAXIMUM	0.9 fc
MINIMUM	0.0 fc
MAX/MIN	N/A
AVG/MIN	N/A

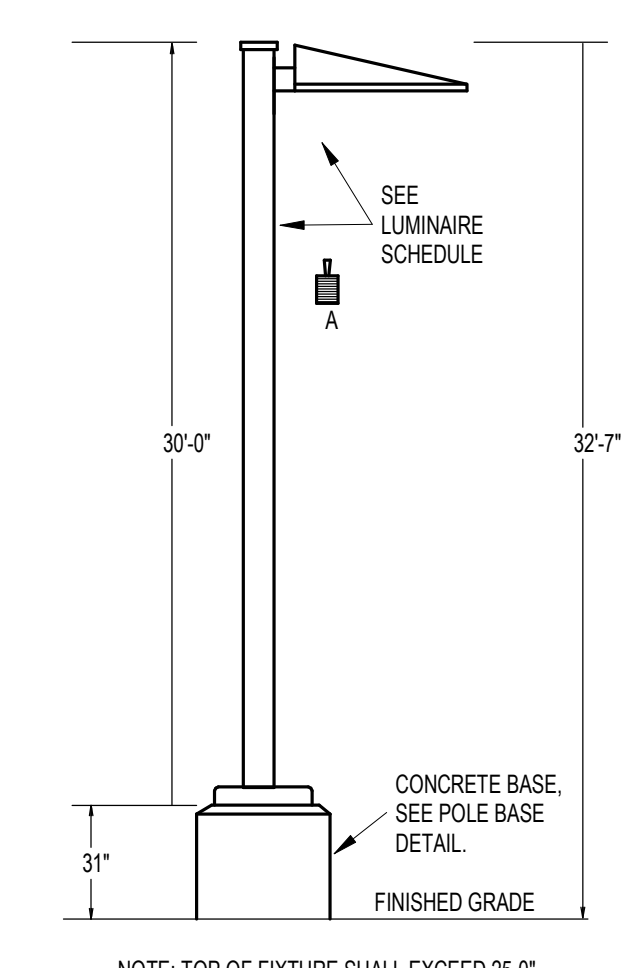

2 FIXTURE "A" DETAIL
 SCALE: NONE

D-Series Size 1 LED Area Luminaire

Specifications
 EPA: 0.69 ft² (0.06 m²)
 Length: 32.71" (831 mm)
 Width: 14.26" (362 mm)
 Height H1: 7.88" (200 mm)
 Height H2: 2.73" (69 mm)
 Weight: 34 lbs (15 kg)

Introduction
 The modern styling of the D-Series features a highly refined aesthetic that blends seamlessly with its environment. The D-Series offers the benefits of the latest in LED technology into a high performance, high efficiency, long-life luminaire.

The photometric performance results in sites with excellent uniformity, greater pole spacing and lower power density. D-Series outstanding photometry aids in reducing the number of poles required in area lighting applications with typical energy savings of 65% and expected service life of over 100,000 hours.

Ordering Information EXAMPLE: DSX1 LED P7 40K 70CRI T3M MVOLT NLA SPART2 PIRHN DBX2

Series	LEDs	Color Temperature	Color Rendering Index	Beam Spread	Mounting
DSX1LED	P7	4000K	70CRI	30°	SPART2
	P8	4000K	70CRI	30°	SPART2
	P9	4000K	70CRI	30°	SPART2
	P10	4000K	70CRI	30°	SPART2
	P11	4000K	70CRI	30°	SPART2

Ordering Information

Accessories

- External Glare Shield (EGSR)
- House Side Shield (HS)
- Drilling
- Handhole Orientation
- Handhole
- Top of Pole

Shield Accessories

Drilling

Handhole Orientation

Handhole


Top of Pole

Tenon Mounting Splitter

Splitter Size	Splitter Length	Splitter Width	Splitter Height	Splitter Weight
2 1/2"	1.50"	1.50"	1.50"	1.50"
3"	1.50"	1.50"	1.50"	1.50"
4"	1.50"	1.50"	1.50"	1.50"
5"	1.50"	1.50"	1.50"	1.50"
6"	1.50"	1.50"	1.50"	1.50"

DSX1 Area Luminaire - EPA

Mounting Type	Height	Spacing	Power	Wattage
DSX1 with NLA	30'	150'	1.50	1.50
DSX1 with NLA, DBX2	30'	150'	1.50	1.50
DSX1 with NLA, DBX2	30'	150'	1.50	1.50
DSX1 with NLA	30'	150'	1.50	1.50

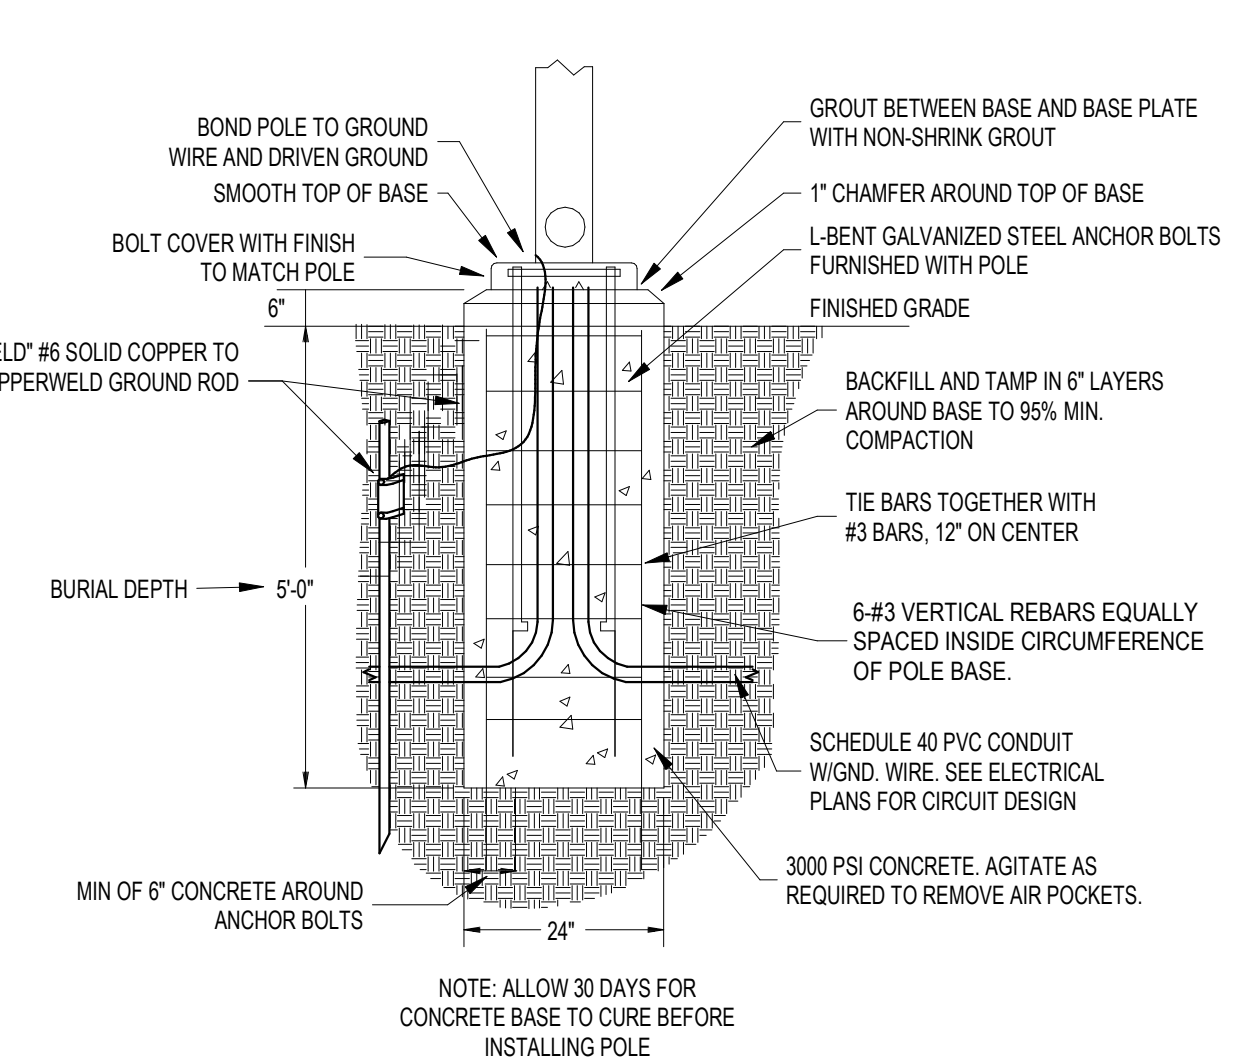


3 SITE LIGHTING POLE BASE DETAIL - 5'(6" AFG)
 SCALE: N.T.S.



ASR - 2023

NOT FOR CONSTRUCTION

ASR

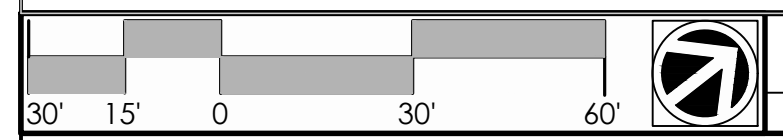

Overall Site Landscape Plan 03
 Scale: 1" = 30'

ASR PLANTING NOTES:

- REFER TO OVERALL & DETAILED SITE PLAN SHEETS FOR ADDITIONAL INFORMATION.
- REFER TO TREE CONSERVATION AREA, UTILITY, AND GRADING PLANS.
- REFER TO PROJECT NOTES ON THE COVER SHEET OF THIS PLAN SET.
- THERE ARE NO REQUIRED/PROPOSED TRANSITIONAL PROTECTIVE OR NEIGHBORHOOD TRANSITION YARDS.
- UNLESS NOTED OTHERWISE THE PROPOSED ONSITE STORMWATER, SANITARY SEWER, AND WATER DISTRIBUTION LINES ARE PRIVATE.
- STREET TREES IN PUBLIC RIGHT-OF-WAY REQUIRED TREE PLANTING/IMPACT PERMIT. REFER TO COR STANDARD DETAIL TPP-03 ON SHEET LP2.00
- REFER TO "RECOMMENDED MINIMUM DISTANCE FROM WALKS, CURBS, AND UTILITIES", PAGE 11/COR TREE MANUAL.
- STREET TREE INSTALLATION IN PUBLIC RIGHT-OF-WAY IS PROHIBITED FROM MAY THROUGH SEPTEMBER.
- WITHIN THE SITE DISTANCE TRIANGLE SHOWN ON THIS PLAN, NO OBSTRUCTION BETWEEN TWO FEET (2') AND 8 FEET (8') IN HEIGHT ABOVE THE CURB LINE ELEVATION SHALL BE LOCATED IN WHOLE OR PART. OBSTRUCTION INCLUDE, BUT NOT LIMITED TO BERM, FOLIAGE, FENCE, WALL, SIGN OR PARKED VEHICLE.

PLANT SCHEDULE							
PARKING LOT TREE	CODE	QTY	BOTANICAL NAME	COMMON NAME	CALIPER	HEIGHT	REMARKS
	QUE PHE	18	QUERCUS PHellos	WILLOW OAK	3" MIN.	12'-14'	FULL, MATCHED
	QUE SHU	22	QUERCUS SHUMARDII	SHUMARD OAK	3" MIN.	12'-14'	FULL, MATCHED
	ULM ALL	20	ULMUS PARVIFOLIA 'ALLEE'	ALLEE® LACEBARK ELM	3" MIN.	12'-14'	FULL, MATCHED
STREET TREES	CODE	QTY	BOTANICAL NAME	COMMON NAME	CALIPER	HEIGHT	REMARKS
	PIS CHI	14	PISTACIA CHINENSIS	CHINESE PISTACHE	3" MIN.	12'-14'	FULL HEAD, MATCHED
	ULM BOS	22	ULMUS PARVIFOLIA 'UPMTP'	BOSQUE® LACEBARK ELM	3" MIN.	12'-14'	FULL, MATCHED
	ZEL GRE	26	ZELKOVA SERRATA 'GREEN VASE'	GREEN VASE JAPANESE ZELKOVA	3" MIN.	12'-14'	FULL, MATCHED
SCREENING SHRUBS	CODE	QTY	BOTANICAL NAME	COMMON NAME	HEIGHT	SPREAD	REMARKS
	ILE BU2	81	ILEX CORNUTA 'BURFORDII'	BURFORD HOLLY	24" MIN.	18-24"	

UNIFIED DEVELOPMENT ORDINANCE

7.1.7 VEHICULAR PARKING LOT LANDSCAPING

- INTERIOR ISLANDS
 - INTERIOR ISLAND & SHADE TREE PER 10 PARKING SPACES
 - ALL ROWS OF PARKING MUST END WITH ISLAND
 - SHALL BE MIN 8' WIDE & 300 SF
- PERIMETER ISLANDS
 - ALONG PRIMARY ACCESS DRIVES
 - 5' MIN WIDTH
 - 30 SHRUBS PER 100 LF
 - MIN 3' HT X 3' SPR AT MATURITY
- TREE COVERAGE
 - 121,880 SF VSA
 - EACH INTERIOR ISLAND SHALL HAVE TREE
 - 1 SHADE TREE PER 2000 SF VSA

REQUIRED SHADE TREES: 60 TREES REQ.
 121,880 SF X (1) TREES/2000 SF
 PROPOSED SHADE TREES: 60 TREES PRO.

7.2.5 SCREENING

- MECHANICAL
- OPAQUE LANDSCAPE SCREEN NO LOWER THAN HIGHEST POINT ON EQUIPMENT

7.2.7 DESIGN AND INSTALLATION

- PLANT MATERIAL
- SHADE TREES- 3" MIN CAL INSTALLED, 35' MIN MATURE HT.
- UNDERSTORY TREES- 1.5" MIN CAL & 6' MIN HT. INSTALLED, 15' MIN MATURE HT.
- PARKING SHRUBS- 18" MIN HT. INSTALLED, 3' MIN MATURE HT.
- PROTECTIVE YARD SHRUBS- 18" MIN HT INSTALLED, 3' X 3' MIN MATURE SIZE
- STREET YARD SHRUBS- CONTINUOUS ROW 5' OC

8.5.2 STREETSCAPES

- STREET TREES
- 40' OC (AVG.)

CORPORATE CENTER DRIVE - (1,423 LF)

REQUIRED TREES: 35.58 TREES REQ.
 1,423 LF X (1) TREE/40 LF
 PROPOSED TREES: 36 TREES PRO.

PLAY GOLF WAY - (369 LF)

REQUIRED TREES: 9.22 TREES REQ.
 369 LF X (1) TREE/40 LF
 PROPOSED TREES: 9 TREES PRO.

TRINITY ROAD - (667 LF)

REQUIRED TREES: 16.67 TREES REQ.
 667 LF X (1) TREE/40 LF
 PROPOSED TREES: 17 TREES PRO.


Overall Code Compliant Plant Schedule 02

Landscape Calculations 01

PROJECT: 023074
 DATE: 09.06.2023
 REVISIONS: DATE

DRAWN BY: TC
 CHECKED BY: JK

Overall Code Compliant
 Landscape Plan

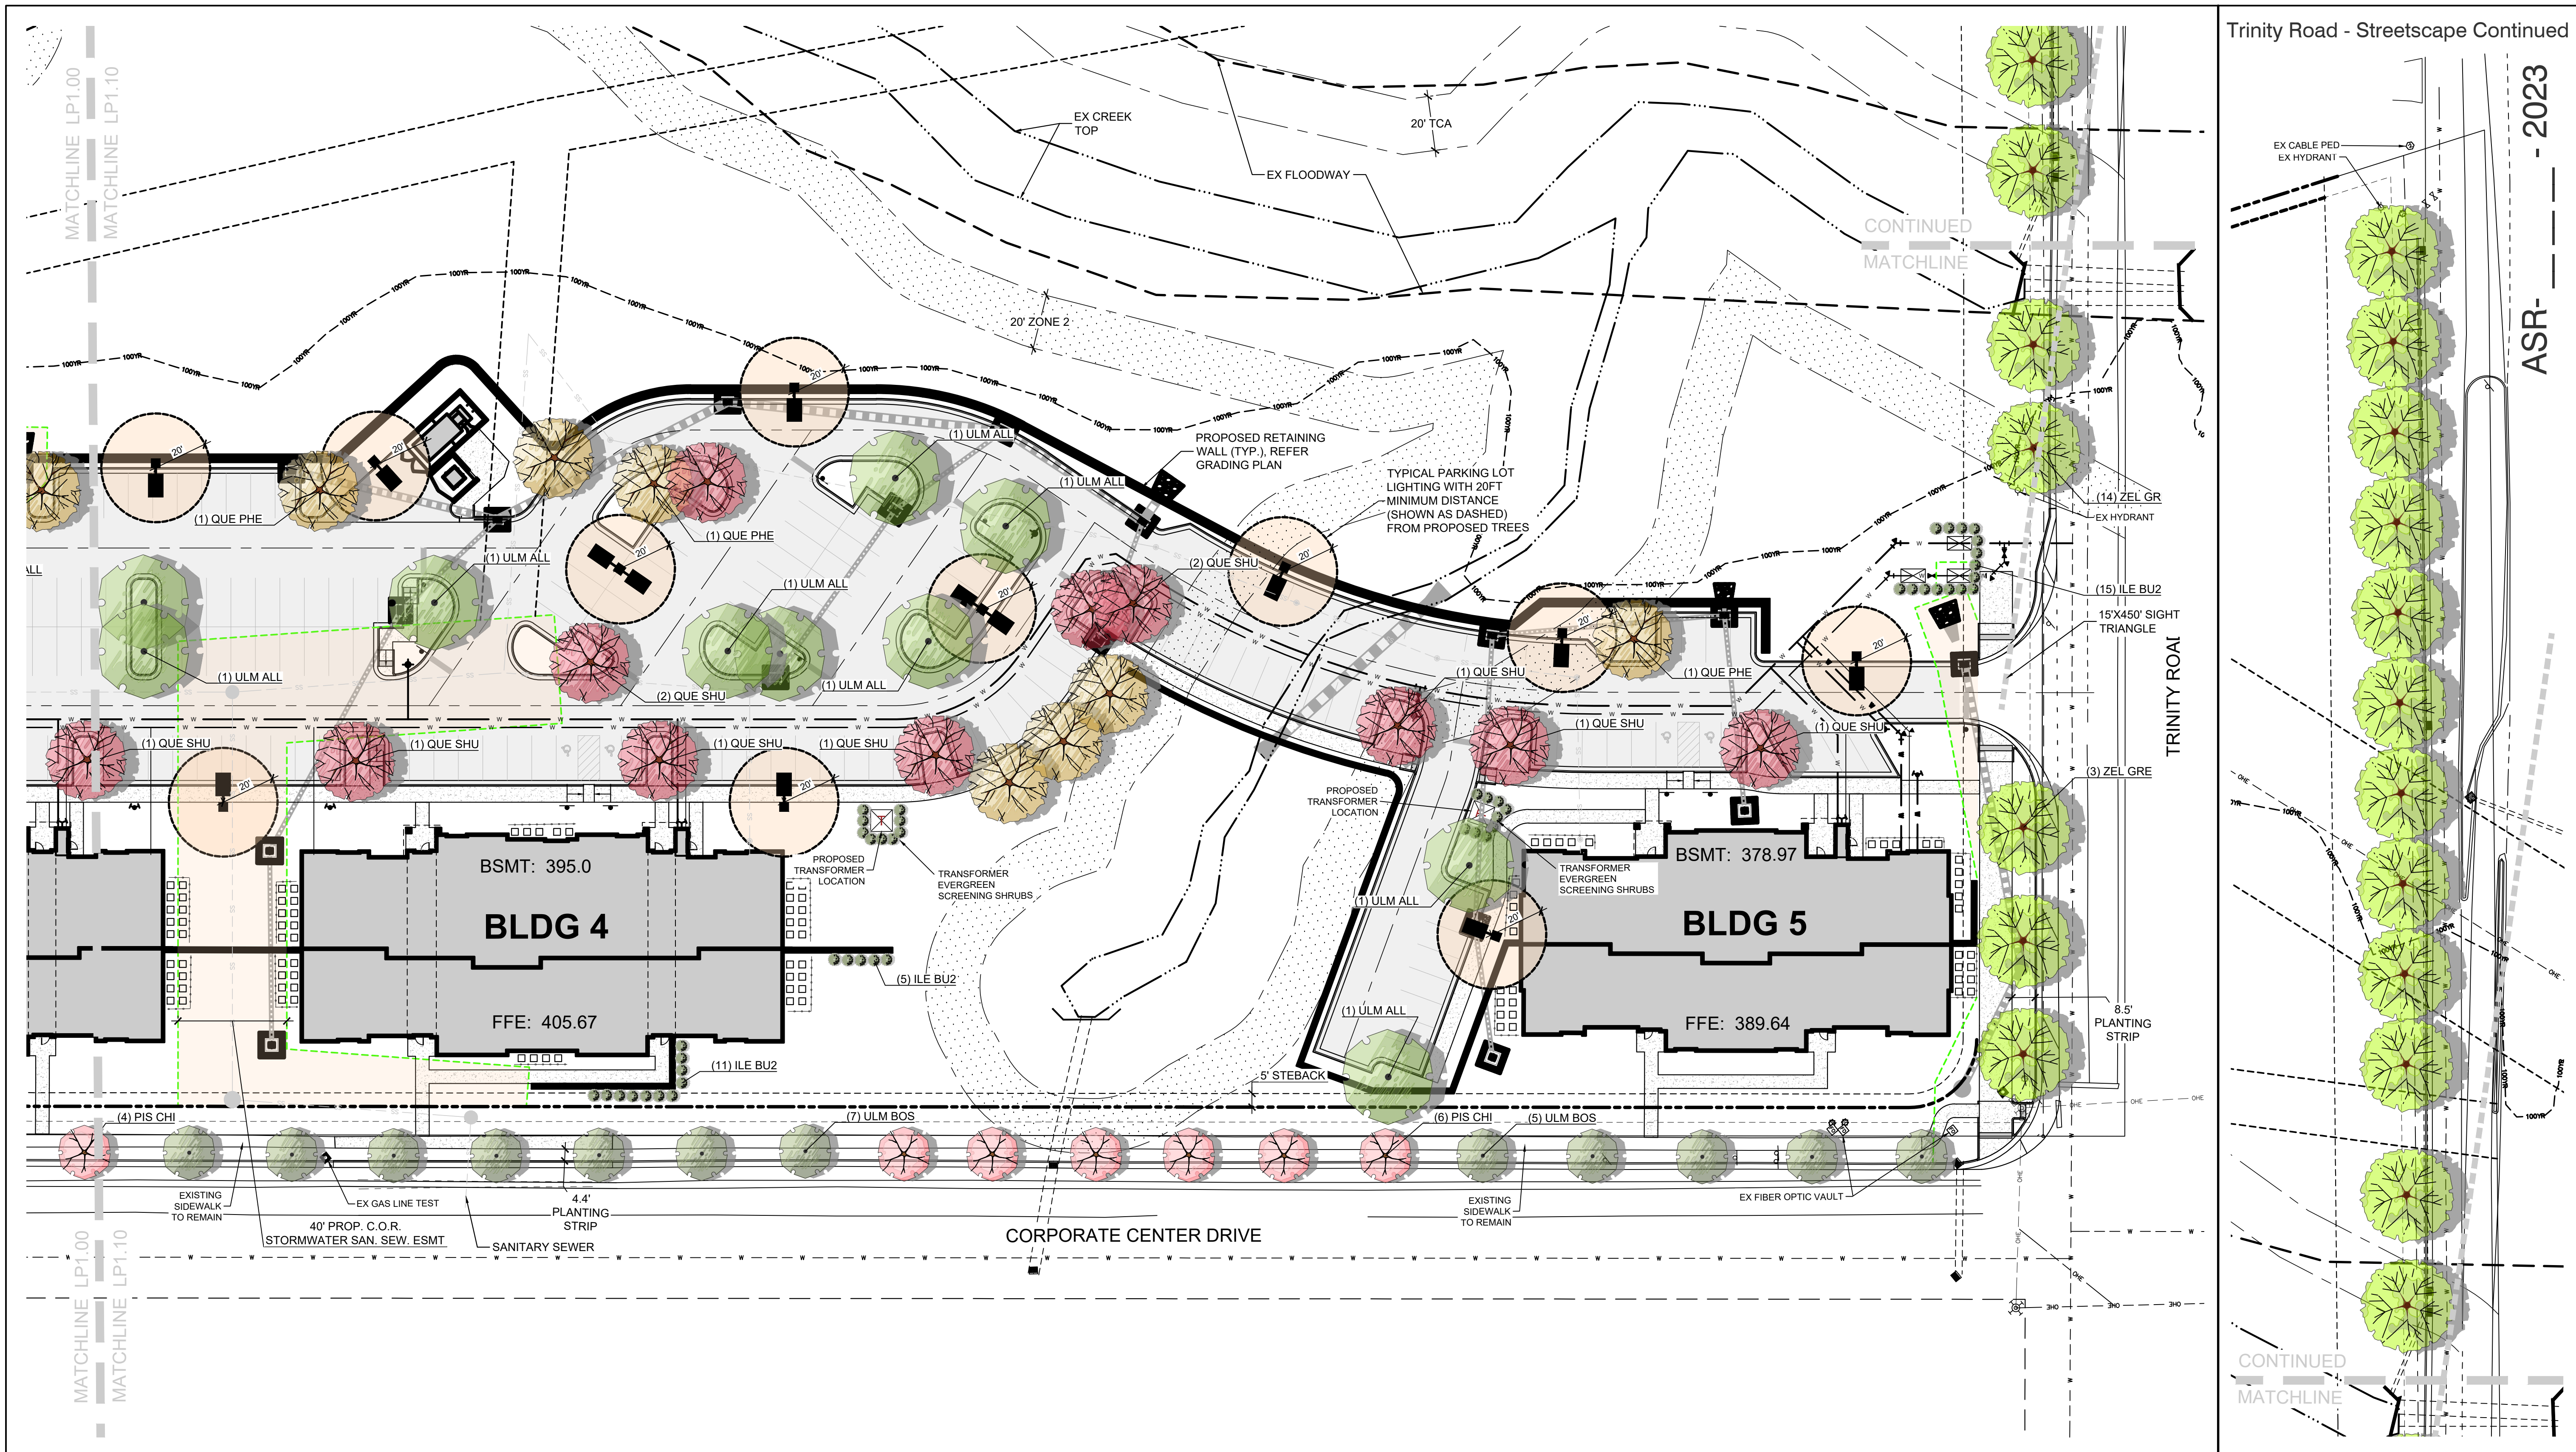

Trinity Road - Streetscape Continued


ASR - 2023

cline

KDM Development
Corporate Center Drive Apts
Raleigh, North Carolina

NOT FOR CONSTRUCTION

ASR

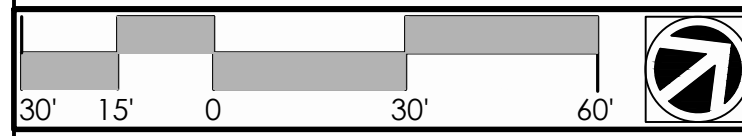

Overall Site Landscape Plan 03
Scale: 1" = 30'

PLANT SCHEDULE

PARKING LOT TREE	CODE	QTY	BOTANICAL NAME	COMMON NAME	CALIPER	HEIGHT	REMARKS
	QUE PHE	18	QUERCUS PHELLOS	WILLOW OAK	3" MIN.	12'-14'	FULL, MATCHED
	QUE SHU	22	QUERCUS SHUMARDII	SHUMARD OAK	3" MIN.	12'-14'	FULL, MATCHED
	ULM ALL	20	ULMUS PARVIFOLIA 'ALLEE'	ALLEE® LACEBARK ELM	3" MIN.	12'-14'	FULL, MATCHED
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	ZEL GRE	26	ZELKOVA SERRATA 'GREEN VASE'	GREEN VASE JAPANESE ZELKOVA	3" MIN.	12'-14'	FULL, MATCHED
SCREENING SHRUBS	CODE	QTY	BOTANICAL NAME	COMMON NAME	HEIGHT	SPREAD	REMARKS
	ILE BU2	81	ILEX CORNUTA 'BURFORDII'	BURFORD HOLLY	24" MIN.	18-24"	

UNIFIED DEVELOPMENT ORDINANCE

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► INTERIOR ISLANDS
- INTERIOR ISLAND & SHADE TREE PER 10 PARKING SPACES
- ALL ROWS OF PARKING MUST END WITH ISLAND
- SHALL BE MIN 8' WIDE & 300 SF

► PERIMETER ISLANDS
- ALONG PRIMARY ACCESS DRIVES
- 5' MIN WIDTH
- 30 SHRUBS PER 100 LF
- MIN 3' HT X 3' SPR AT MATURITY

► TREE COVERAGE
- 121,880 SF VSA
- EACH INTERIOR ISLAND SHALL HAVE TREE
- 1 SHADE TREE PER 2000 SF VSA

REQUIRED SHADE TREES: 60 TREES REQ.
121,880 SF X (1 TREE/2000 SF)
PROPOSED SHADE TREES: 60 TREES PRO.

7.2.5 SCREENING
► MECHANICAL
- OPAQUE LANDSCAPE SCREEN NO LOWER THAN HIGHEST POINT ON EQUIPMENT

7.2.7 DESIGN AND INSTALLATION
► PLANT MATERIAL
- SHADE TREES- 3" MIN CAL INSTALLED, 35' MIN MATURE HT.
- UNDERSTORY TREES- 1.5" MIN CAL & 6' MIN HT. INSTALLED, 15' MIN MATURE HT.
- PARKING SHRUBS- 18" MIN HT. INSTALLED, 3' MIN MATURE HT.
- PROTECTIVE YARD SHRUBS- 18" MIN HT INSTALLED, 3' X 3' MIN MATURE SIZE
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REQUIRED TREES: 35.58 TREES REQ.
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369 LF X (1 TREE/40 LF)
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TRINITY ROAD - (667 LF)
REQUIRED TREES: 16.67 TREES REQ.
667 LF X (1 TREE/40 LF)
PROPOSED TREES: 17 TREES PRO.

Overall Code Compliant Plant Schedule 02

Landscape Calculations 01


PROJECT: 023074
DATE: 09.06.2023
REVISIONS: DATE

DRAWN BY: TC
CHECKED BY: JK

Overall Code Compliant
Landscape Plan


LP1.10

- GENERAL NOTES:**
1. THOROUGHLY TILL IN PLANTING MIXTURE AMENDMENTS TO A MIN. DEPTH OF 12" IN ENTIRE BED AREA.
 2. WORK SOIL TO A LOOSE, UNIFORM TEXTURE.
 3. HAND-TAMP BACKFILL TO REMOVE VOIDS/AIR POCKETS.
 4. WATER IMMEDIATELY AFTER INSTALLATION UNTIL NO MORE WATER IS ABSORBED.
 5. SEE SOIL PREPARATION AND AMENDMENT NOTES

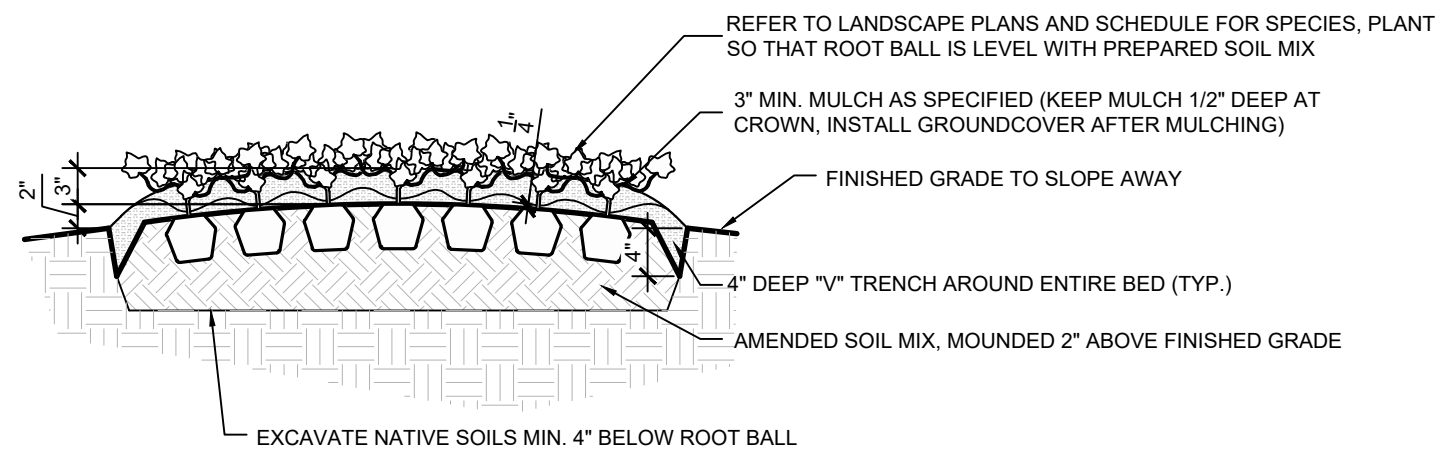


Typical Groundcover Planting 08
Scale: 3/4" = 1'-0"

- GENERAL NOTES:**
1. PLANT SO THAT TOP OF ROOT BALL IS 1" ABOVE FINISH GRADE.
 2. SCARIFY SIDES AND BOTTOM OF PLANTING PIT.
 3. BACKFILL PLANTING PIT WITH SPECIFIED PLANTING SOIL MIXTURE (OR AMENDED SOIL) IN 8" LAYERS, HAND-TAMPED, TO REMOVE VOIDS.
 4. WHEN PLANTING PIT IS 2/3 BACKFILLED, WATER MATERIAL.
 5. AFTER PLACING AND HAND-TAMPING FINAL LAYERS, WATER AGAIN UNTIL NO MORE IS ABSORBED.
 6. ROOTBALL IS TO BE DISTURBED SO THAT ROOTS WILL GROW OUT INTO SOIL MIX
 7. SEE SOIL PREPARATION AND AMENDMENT NOTES

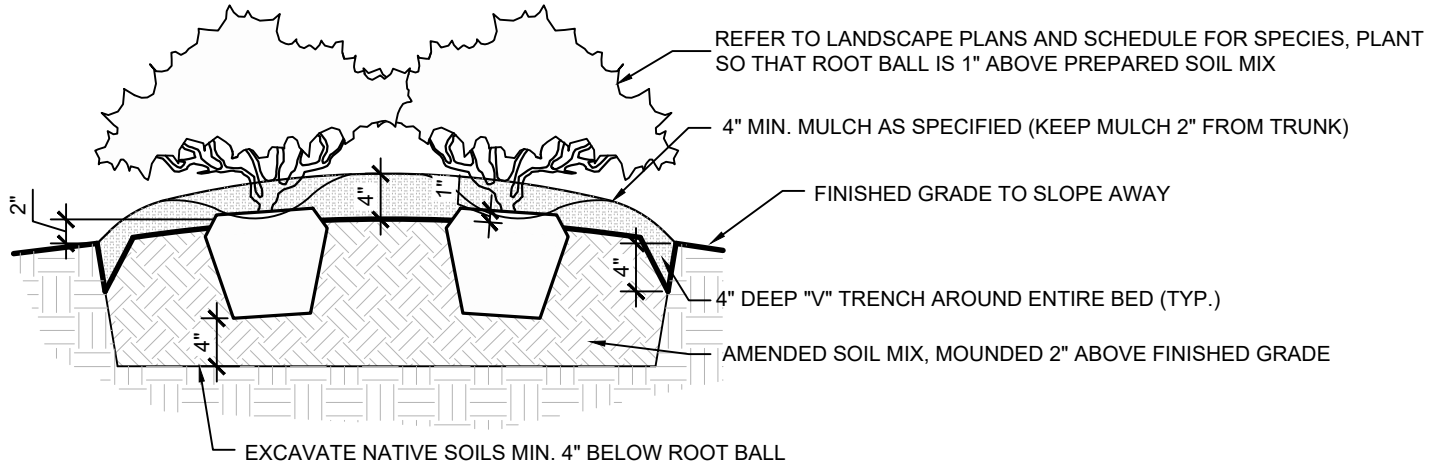

Typical Shrub Planting 07
Scale: 3/4" = 1'-0"

1. PLANT SO THAT HALF OF TOP OF ROOT BALL IS 2" ABOVE FINISH GRADE.
2. SCARIFY SIDES AND BOTTOM OF PLANTING PIT.
3. BACKFILL TREE PIT WITH SPECIFIED PLANTING SOIL MIXTURE (OR AMENDED SOIL) IN 8" LAYERS, HAND-TAMPED, TO REMOVE VOIDS.
4. WHEN PLANTING PIT IS 2/3 BACKFILLED, WATER MATERIAL.
5. AFTER PLACING AND HAND-TAMPING FINAL LAYERS, WATER AGAIN UNTIL NO MORE IS ABSORBED.
6. STAKE AND GUY TREES (3" CALIBER AND LARGER)
7. DO NOT WRAP TREE TRUNKS UNLESS DIRECTED BY LANDSCAPE ARCHITECT.
8. SEE SOIL PREPARATION AND AMENDMENT NOTES.

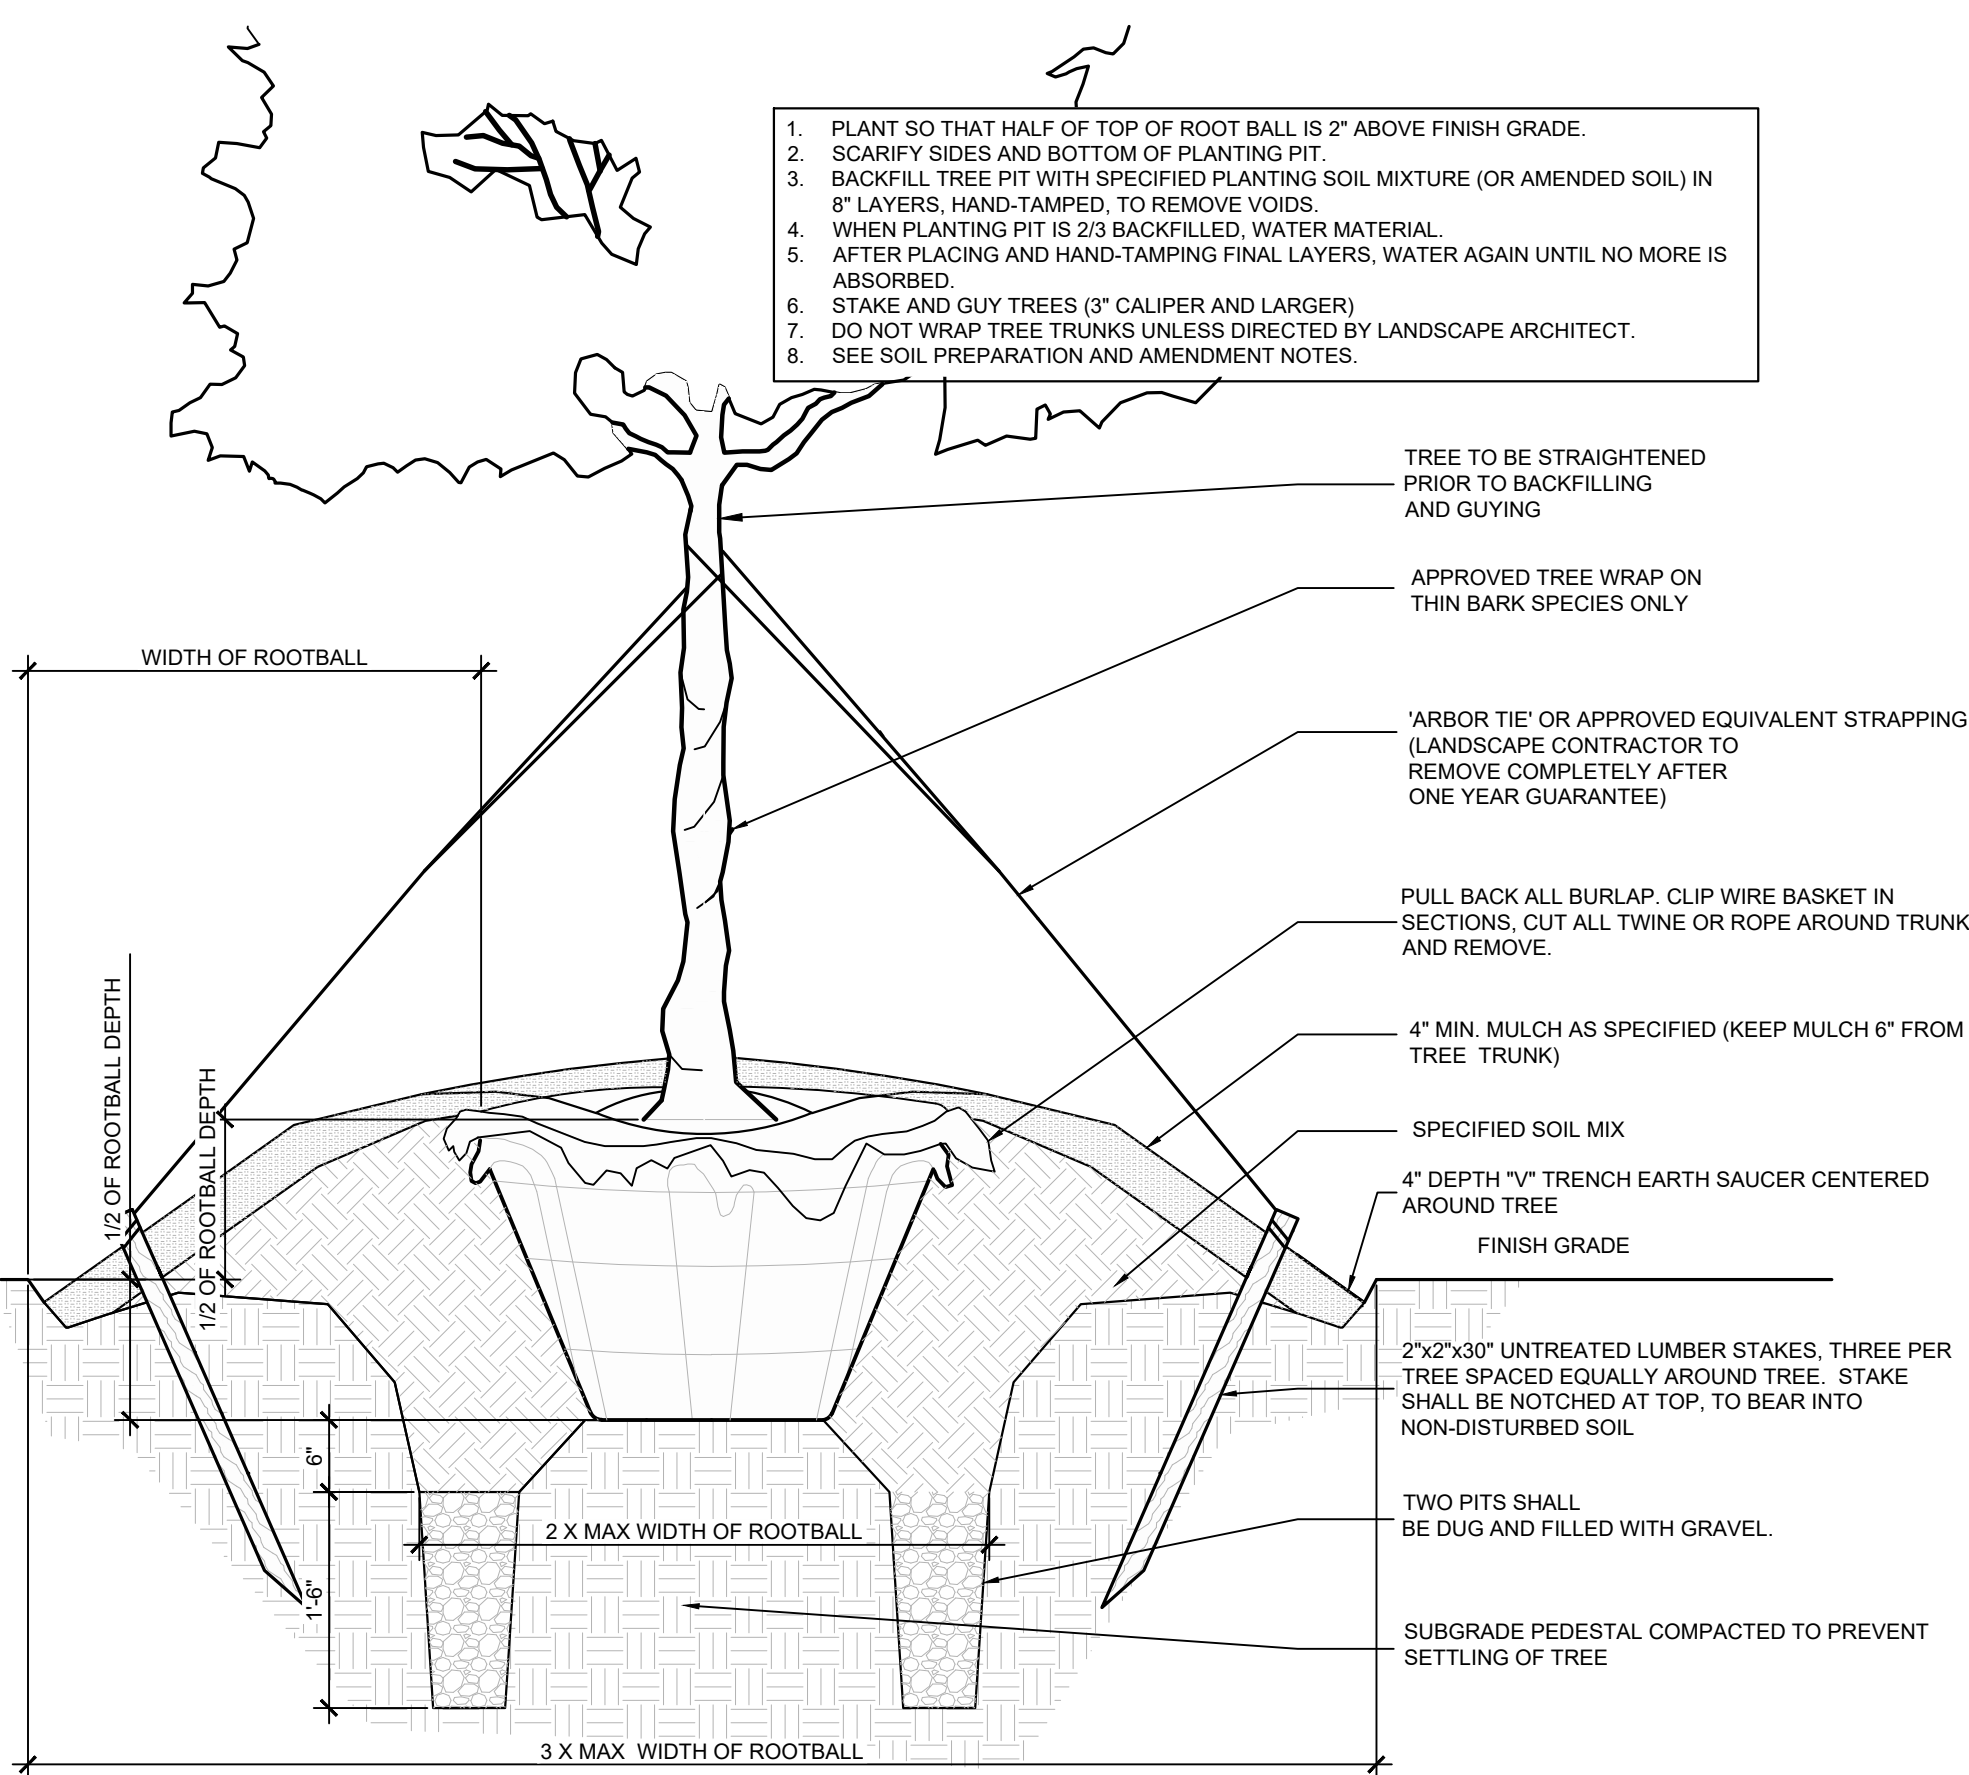

Typical Tree Planting 06
Scale: 3/4" = 1'-0"

Landscape Maintenance Notes

A. Fertilization: Avoid any nitrogen fertilization of cool-season grasses, such as tall fescue, after the February application until September. Fertilize lawns three times per year September 15, October 31, and February 15 according to soil test. Fertilize warm season grasses once during growing season per soil test.

B. Pruning: Purpose of pruning is to improve health and vigor of woody plants, adjustments to the foliage and branching density for visual screens and managing competition, and improving the appearance of trees and shrubs. Pruning shall be limited to removal of dead wood or branches for trees or for sight distance/safety reasons for the first year. The ANSI A300 Tree Care Operations standards SHALL be adhered to. The pruning of shrubs shall be limited to the pruning necessary to maintain the natural shape of the plant except for sheared hedges.

1. Shrubs in buffers allowed to remain full to ground and 6'-8" height.
2. Shrubs in streetscape buffer trimmed to continuous soft hedges below trees.
3. Shrubs in planting islands kept trimmed to 36" maximum height.

C. Pest Control: Pre-emergent weed control for lawns and shrub beds may be applied in February. Chemical treatment for insect infestation and disease may be applied and shall be specific to the problem.

D. Mulching: Mulching shall be maintained at a depth of 2"-3" in plant beds. Mulch shall be reapplied every year.

E. Mowing primary fescue lawns shall be maintained at a height of 3". Secondary turf areas may be maintained higher and less frequently. Warm season grasses shall be mowed as needed during the growing season to maintain the recommended height of the species of turf grass.


F. Plant protection: Avoid excess intrusion into the root zone area of established plantings. Install tree protection fencing as shown during construction.

G. Watering: If any irrigation system is utilized, the system shall be regulated to provide approximately 1" of rainfall per week during the growing season.

H. Maintenance notes for Bioretention Basin plant materials:

1. Visually inspect and repair erosion around bioretention areas on a monthly basis.
2. Inspect mulch cover monthly and replace any void area as needed. additional mulch shall be applied in the spring where needed.
3. Remove and replace all dead or diseased vegetation twice annually. Treat all diseased shrubs and trees as needed to insure proper growth.
4. All plant materials shall be watered by hand for two weeks after installation.
5. Replace any deficient stakes or wires whenever needed.
6. Remove all trash weekly.

Landscape Maintenance Notes 05

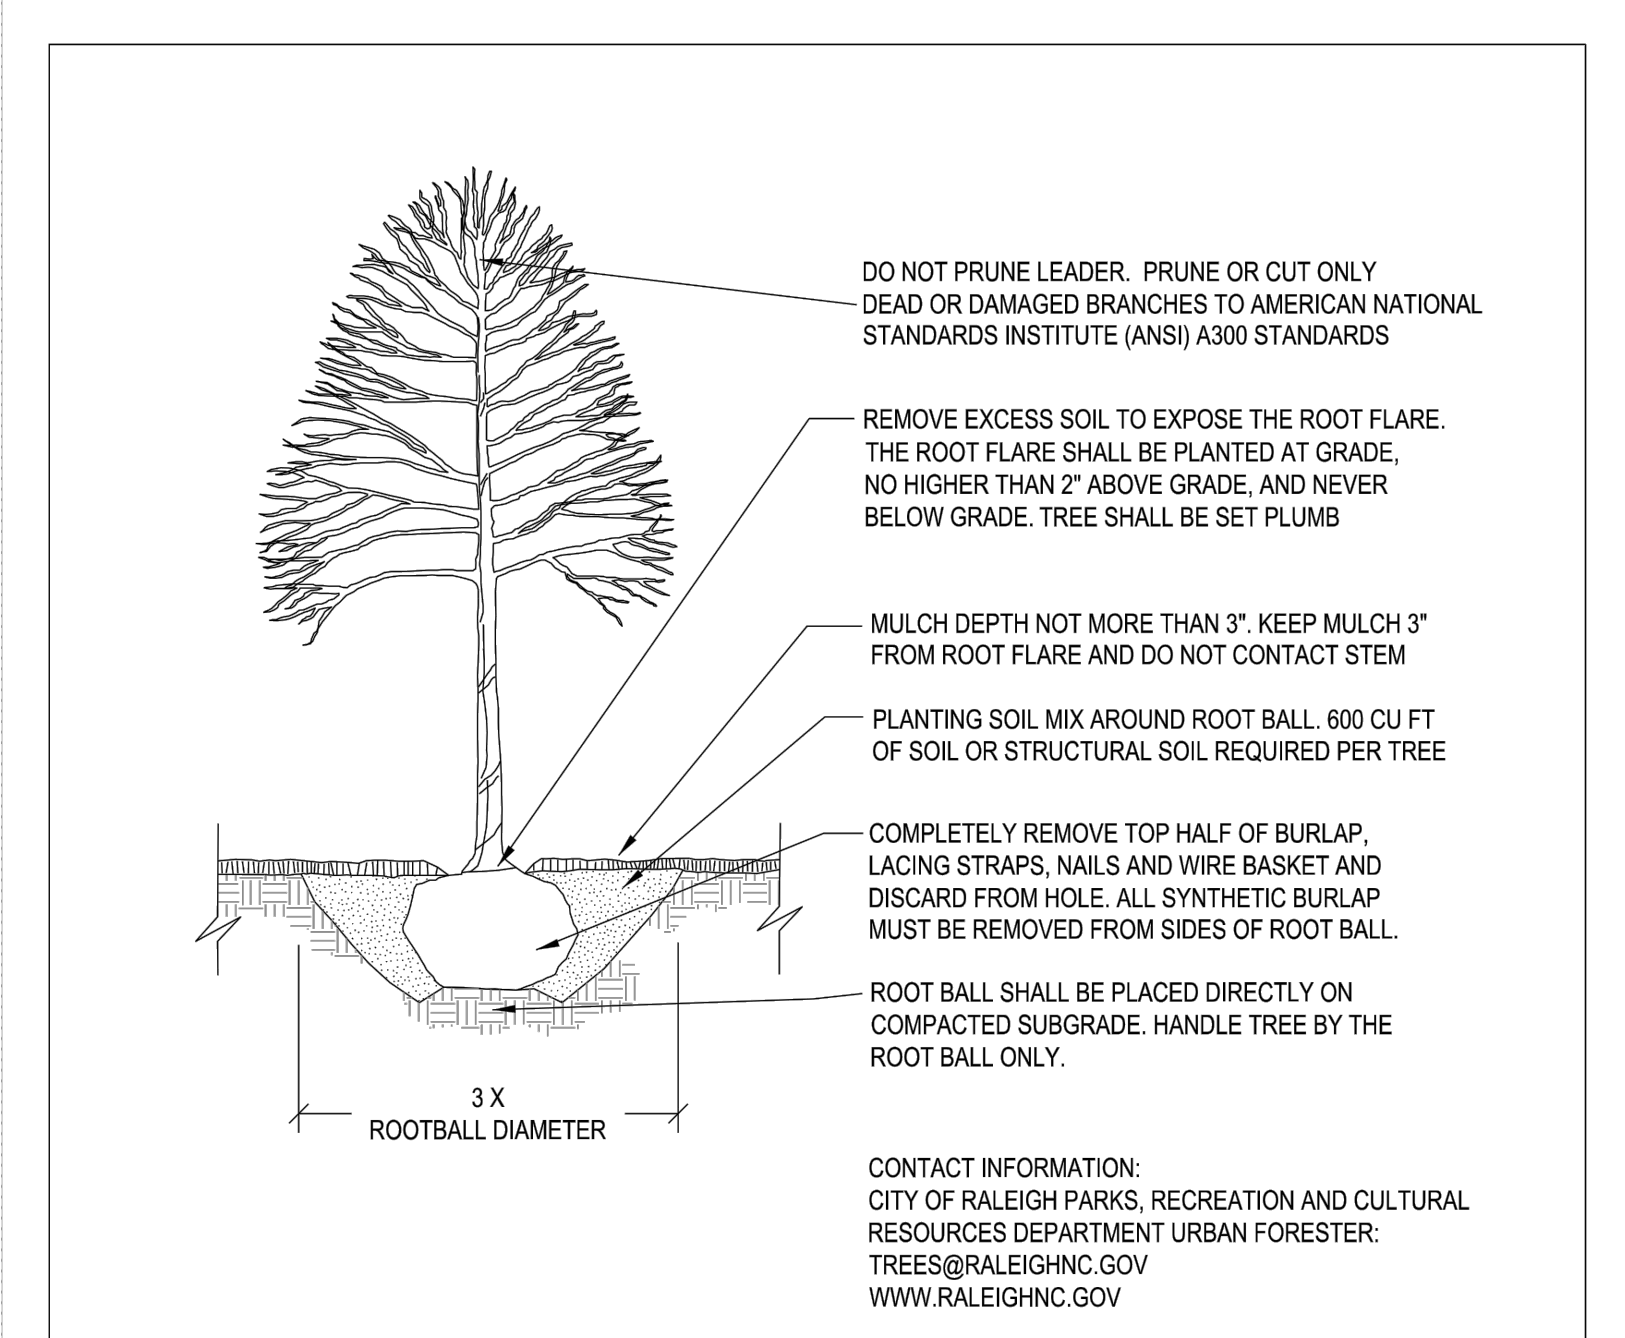

- NOTES:**
1. TREES MUST MEET THE TREE QUALITY STANDARDS IN CH. 2 OF THE CITY TREE MANUAL.
 2. CONTRACTOR IS RESPONSIBLE FOR ADEQUATE DRAINAGE OF ALL PLANTING PITS. (POSITIVE DRAINAGE AWAY FROM PIT)
 3. TREES SHALL BE PLANTED BETWEEN OCTOBER 1ST AND APRIL 30TH.
 4. A TREE IMPACT PERMIT IS REQUIRED.
 5. ELECTRICAL OUTLETS AND OTHER UTILITIES ARE PROHIBITED IN THE PLANTING AREA IMMEDIATELY SURROUNDING THE TREE.
 6. IF STAKING IN ACCORDANCE WITH THE CITY TREE MANUAL, THE STAKING MUST BE REMOVED WITHIN ONE YEAR.
 7. TREES WILL HAVE A MINIMUM 1 YEAR WARRANTY AFTER THE INITIAL PLANTING IS APPROVED BY THE CITY.

CITY OF RALEIGH STANDARD DETAIL

REVISIONS: 10/2019 DATE: 02/20 NOT TO SCALE

TREE PLANTING DETAIL

TPP-03

Raleigh Street Tree Standard Detail 04

Landscape Planting Notes

1. Verification of total landscape material quantities as shown on the landscape plans and in the plant list shall be the responsibility of the landscape contractor. The landscape architect shall be notified of any discrepancies prior to final bidding or installation.

2. All landscape materials shall conform to the most recent American Standards for Nursery Stock established by the American Association of Nurserymen (A.A.N.).

3. Soil analysis shall be obtained by landscape contractor prior to planting. See Soil Preparation and Amendment Notes

4. Shrub bed area preparation is highly preferred to individually dug holes.

5. Trees with root flare covered by more than 1.5" of soil will be rejected prior to installation.

6. Landscape material placed in prepared holes shall be properly backfilled prior to the end of the working day.

7. All saucers shall be soaked with water and mulched immediately following installation.

8. All prepared ground cover and annual bed installations shall be properly soaked and mulched prior to the end of the day.

9. Landscape Architect shall approve any on-site plant storage area for accessibility, shade conditions, healing-in mulch material and temporary watering methods.

10. Lift and set the tree by root ball only. Do not lift using the tree trunk. Do not use tree trunk as a lever.

11. All root balls removed from containers shall be scarified by hand prior to placement and back filling with prepared soils. Hand tools are not to be used to scarify root balls.

12. All rope and wrapping twine shall be cut and removed from around the upper parts of the root ball. Metal basket wires and burlap shall be pulled back and tucked under the edges of the saucer rings on all trees and large shrubs. All synthetic burlap shall be removed from plant balls prior to back filling.

13. All plant beds or raised saucer rings shall be edged with smooth, continuous curves.

14. All plant material shall be planted at heights as illustrated in plant details.

15. Tree guying shall be performed within a week of planting. The landscape contractor shall be responsible for removing all tree guying strapping and stakes after the first full growing season or one year, whichever ever comes first.

16. B & B as listed under "root" in the plant list indicates balled and burlapped.

17. Contractor shall verify locations of underground utilities prior to planting. Any exposed or uncovered lines shall be shown to general contractor prior to backfilling.

18. All plant beds and raised saucer rings shall be graded to provide adequate drainage and shall be mulched as specified.

19. All materials, planting and landscape work shall conform to the current municipal authority's standard specifications and details.

20. All landscape areas that are not planted and mulched or paved shall be seeded or sodded per owner's direction, unless otherwise noted.

21. Tree protection fence shall be installed, inspected and approved prior to the issuance of any grading or other permits.

22. First year pruning of tree crown shall be limited to removal of dead & damaged wood.

23. The owner shall be responsible for the maintenance of all required landscaping by

- keeping lawns mowed
- maintaining plants disease free
- keeping all planting beds groomed and weed free per municipality requirements (except in areas of preserved existing natural vegetation i.e. thickets)
- keeping all planting beds free from trash, debris and other materials, after the first year from planting.

24. The owner shall be responsible for the replacement of any required planting, which is removed or dies after the first year from the date of planting. Such replacement shall occur during the next planting season.

25. Trees within Municipality Right-of-Way to be planted from October 1st to April 30th only.

Soil Preparation and Amendment Notes

1. Soil samples shall be taken and submitted to independent source; results to be sent to Landscape Architect. Per recommendation of soils report, landscape contractor to supplement soil with lime, macronutrients and micronutrients.
2. Contractor to amend soil with organic material and/or sand to yield the final soil ratio:
 - 33.3% Sand/Silt
 - 33.3% Clay
 - 33.3% Organic Material *
3. * Organic material to be Compost made solely from plant-based products. Peat moss is allowed in sandy soils
4. Native soil, Lime, Nutrients and Amendments to be tilled to a minimum width of 3-5 x root ball for trees. Shrub and groundcover planting areas shall be tilled to a minimum 4" below rootball or a minimum 12" deep.

Planting and Soil Notes 03

Recommended Minimum Distance from Walks, Curbs and Utilities

Sidewalk	2'
Back of curb	2'
Driveways	10'
Structures	10'
Manholes and catch basins	10'
Fire hydrants	10'
Water meters and other utility boxes	5'
Traffic signs	10'
Stop signs	30'
Light poles	20'
Other trees	15' or 25' variable depending on species
Water & sewer lines that cross the planting strip	10'
Sewer easements	Planting prohibited
All other services that cross the planting strip	10'

Raleigh Tree Distance Chart 02

PLANT SCHEDULE

PARKING LOT TREE	CODE	QTY	BOTANICAL NAME	COMMON NAME	CALIPER	HEIGHT	REMARKS
	QUE PHE	18	QUERCUS PHELLOS	WILLOW OAK	3" MIN.	12'-14'	FULL MATCHED
	QUE SHU	22	QUERCUS SHUMARDII	SHUMARD OAK	3" MIN.	12'-14'	FULL MATCHED
	ULM ALL	20	ULMUS PARVIFOLIA 'ALLEE'	ALLEE@ LACEBARK ELM	3" MIN.	12'-14'	FULL MATCHED
STREET TREES							
CODE	QTY	BOTANICAL NAME	COMMON NAME	CALIPER	HEIGHT	REMARKS	
	PIS CHI	14	PISTACIA CHINENSIS	CHINESE PISTACHE	3" MIN.	12'-14'	FULL HEAD, MATCHED
	ULM BOS	22	ULMUS PARVIFOLIA 'UPMTF'	BOSQUE@ LACEBARK ELM	3" MIN.	12'-14'	FULL MATCHED
	ZEL GRE	26	ZELKOVA SERRATA 'GREEN VASE'	GREEN VASE JAPANESE ZELKOVA	3" MIN.	12'-14'	FULL MATCHED
SCREENING SHRUBS							
CODE	QTY	BOTANICAL NAME	COMMON NAME	HEIGHT	SPREAD	REMARKS	
	ILE BU2	81	ILEX CORNUTA 'BURFORDII'	BURFORD HOLLY	24" MIN.	18-24"	

Code Compliant Landscape Schedule 01

cline

KDM Development
Corporate Center Drive Apts
Raleigh, North Carolina

NOT FOR CONSTRUCTION

ASR

PROJECT: 023074
DATE: 09.06.2023
REVISIONS: DATE


DRAWN BY: TC
CHECKED BY: JK

Landscape Schedule
Notes and Details

LP2.00

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TRINITY ROAD

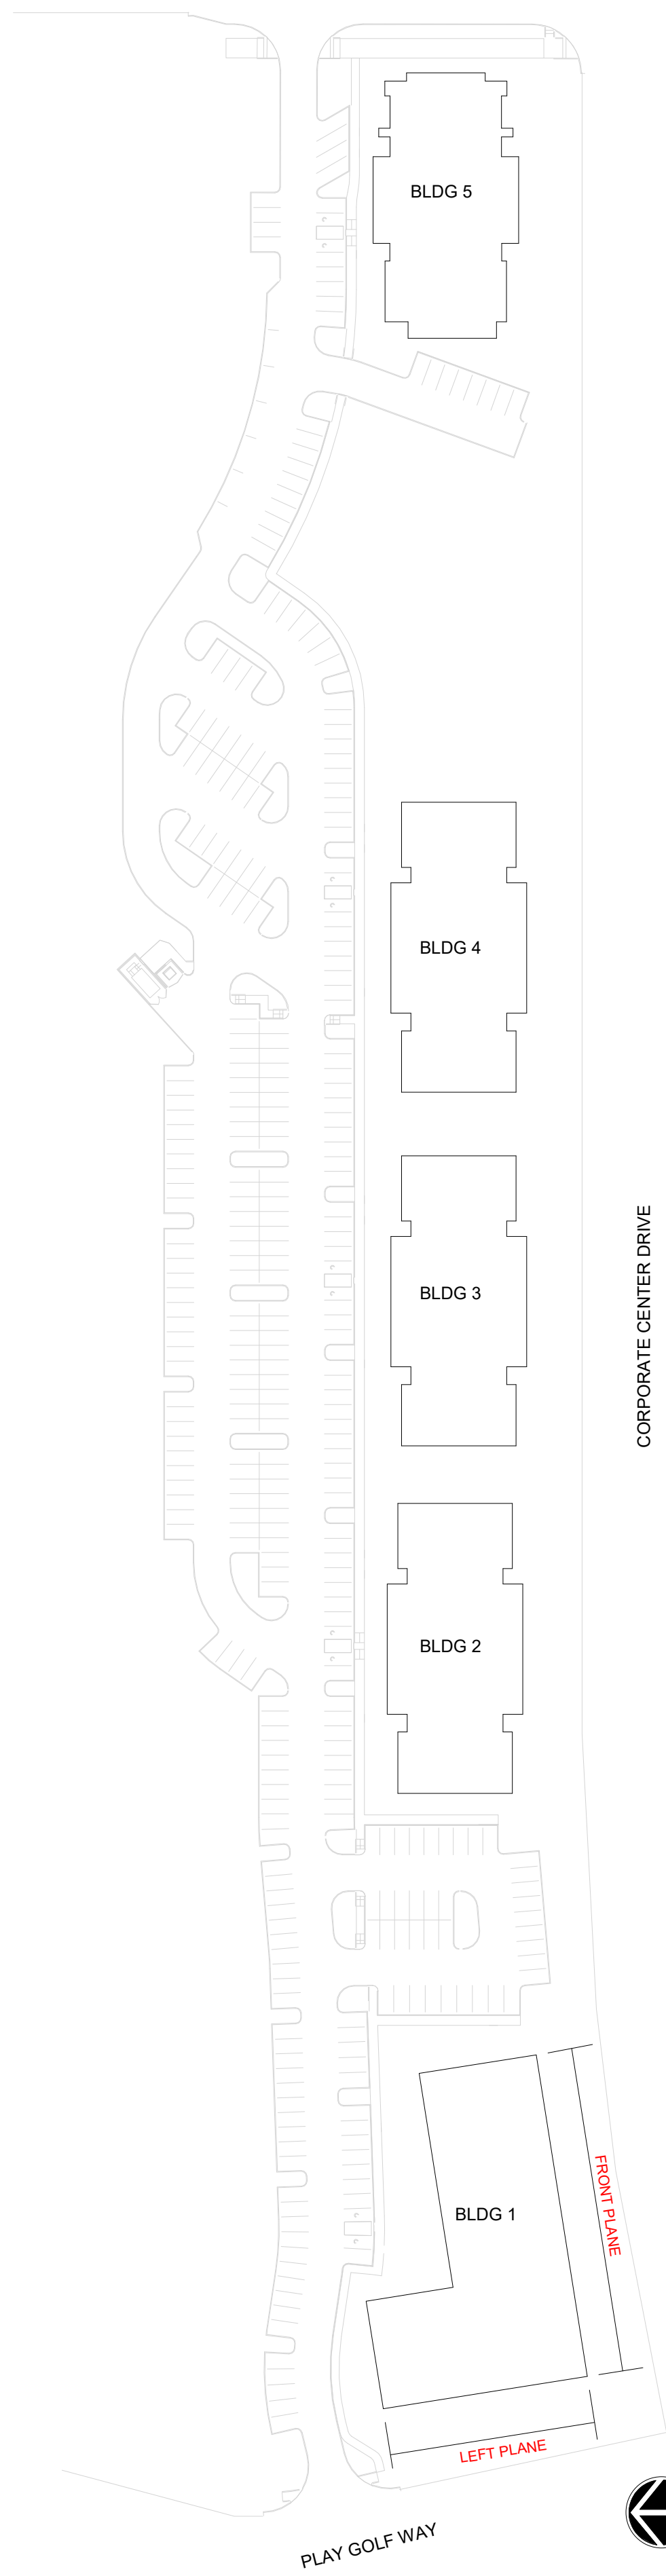

CORPORATE CENTER DRIVE



**BUILDING 1 - SOUTH ELEVATION
PRIMARY STREET**

FRONT PLANE
3/32" = 1' - 0"



**BUILDING 1 - WEST ELEVATION
SECONDARY STREET**

LEFT PLANE
3/32" = 1' - 0"

AVERAGE GRADE CALCULATION

BUILDING 1	POST-DEVELOPMENT GRADES		
	HIGHEST	LOWEST	AVERAGE
FRONT PLANE [1] - PRIMARY STREET	411	410.5	410.75
LEFT PLANE [2] - STREET ELEVATION	410.5	410.5	410.50
RIGHT PLANE [3]	411	400.33	405.67
REAR PLANE [4]	411	400.33	405.67
AVERAGE GRADE			408.15


- PER SECTION 1.5.7, BUILDING HEIGHT IS MEASURED FROM THE AVERAGE GRADE TO THE TOP OF THE HIGHEST POINT OF A PITCHED OR FLAT ROOF, EXCLUDING THE PARAPET.
- AVERAGE GRADE SHALL BE THE POST-DEVELOPMENT GRADE ALONG THE BUILDING ELEVATION MOST PARALLEL AND CLOSEST TO THE PRIMARY STREET FOR EACH BUILDING.
- PER SECTION 1.5.7.A.8, WHERE THE PROPERTY SLOPE INCREASES TO THE REAR, BUILDING HEIGHT IS MEASURED FROM THE AVERAGE POST-DEVELOPMENT GRADE ABOVE SEA LEVEL OF THE FRONT AND REAR WALL PLANE OF THE BUILDING.



CORPORATE CENTER DRIVE APARTMENTS
RALEIGH, NORTH CAROLINA

BUILDING 1 ELEVATIONS A10
3/32" = 1'-0" | 023074 | 09.05.2023

TRINITY ROAD

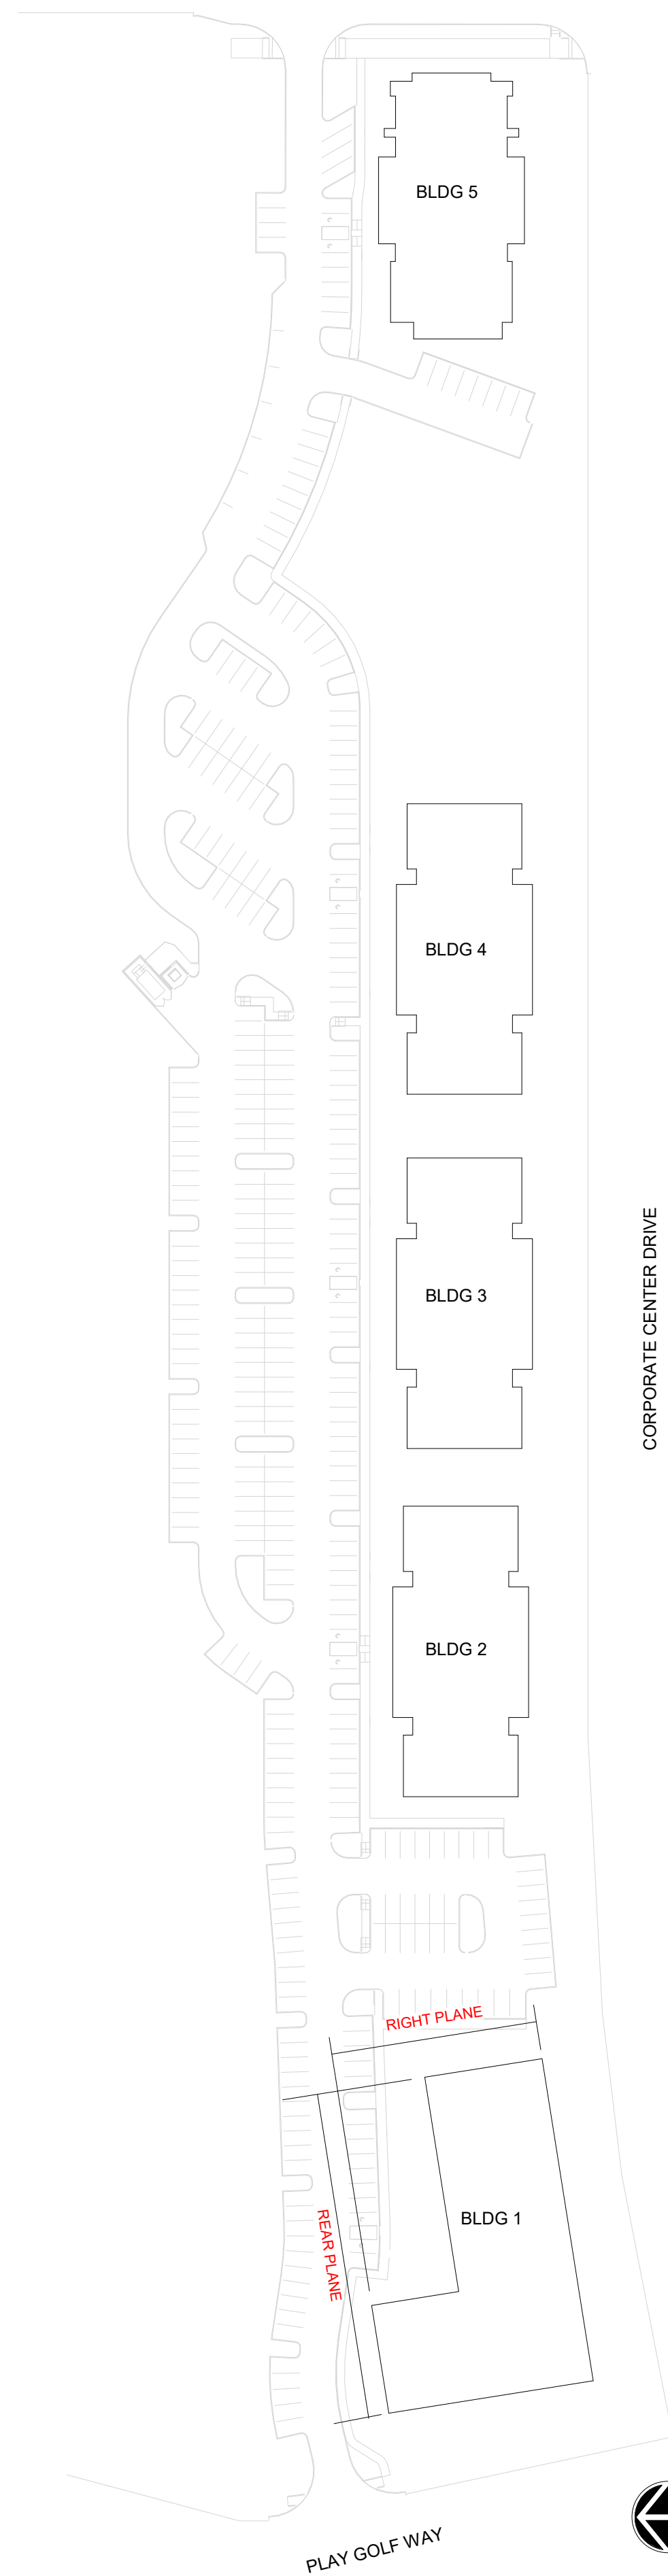

CORPORATE CENTER DRIVE



BUILDING 1 - NORTH ELEVATION
PARKING

REAR PLANE
3/32" = 1' - 0"

AVERAGE GRADE CALCULATION

BUILDING 1	POST-DEVELOPMENT GRADES		
	HIGHEST	LOWEST	AVERAGE
FRONT PLANE [1] - PRIMARY STREET	411	410.5	410.75
LEFT PLANE [2] - STREET ELEVATION	410.5	410.5	410.50
RIGHT PLANE [3]	411	400.33	405.67
REAR PLANE [4]	411	400.33	405.67
AVERAGE GRADE			408.15

- PER SECTION 1.5.7, BUILDING HEIGHT IS MEASURED FROM THE AVERAGE GRADE TO THE TOP OF THE HIGHEST POINT OF A PITCHED OR FLAT ROOF, EXCLUDING THE PARAPET.
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BUILDING 1 - EAST ELEVATION
PARKING


RIGHT PLANE
3/32" = 1' - 0"



CORPORATE CENTER DRIVE APARTMENTS
RALEIGH, NORTH CAROLINA

BUILDING 1 ELEVATIONS A11
3/32" = 1'-0" | 023074 | 09.05.2023

TRINITY ROAD

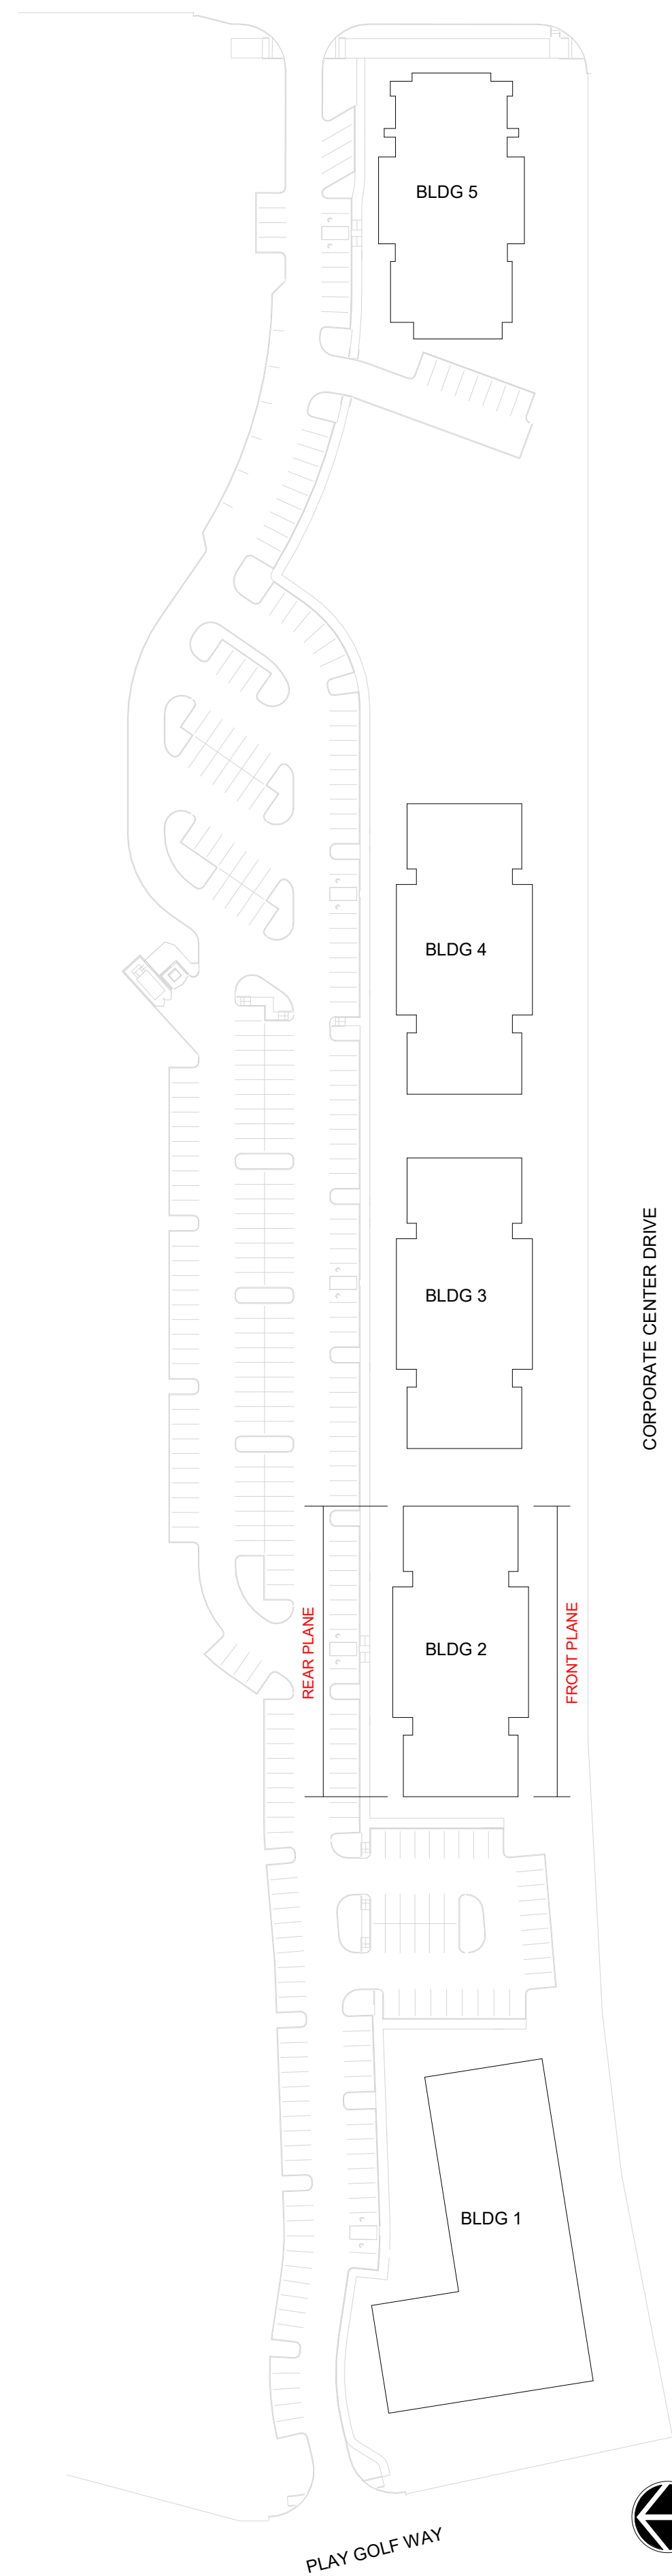

CORPORATE CENTER DRIVE

AVERAGE GRADE CALCULATION

BUILDING 2	POST-DEVELOPMENT GRADES		
	HIGHEST	LOWEST	AVERAGE
FRONT PLANE [1] - PRIMARY STREET	412	411.25	411.63
LEFT PLANE [2]	412	400.04	406.02
RIGHT PLANE [3]	411.25	401	406.13
REAR PLANE [4]	401	400.04	400.52
AVERAGE GRADE			406.07

- PER SECTION 1.5.7, BUILDING HEIGHT IS MEASURED FROM THE AVERAGE GRADE TO THE TOP OF THE HIGHEST POINT OF A PITCHED OR FLAT ROOF, EXCLUDING THE PARAPET.
- AVERAGE GRADE SHALL BE THE POST-DEVELOPMENT GRADE ALONG THE BUILDING ELEVATION MOST PARALLEL AND CLOSEST TO THE PRIMARY STREET FOR EACH BUILDING.
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**BUILDING 2 - NORTH ELEVATION
PARKING**


REAR PLANE
3/32" = 1' - 0"



**BUILDING 2 - SOUTH ELEVATION
PRIMARY STREET**

FRONT PLANE
3/32" = 1' - 0"

TRINITY ROAD

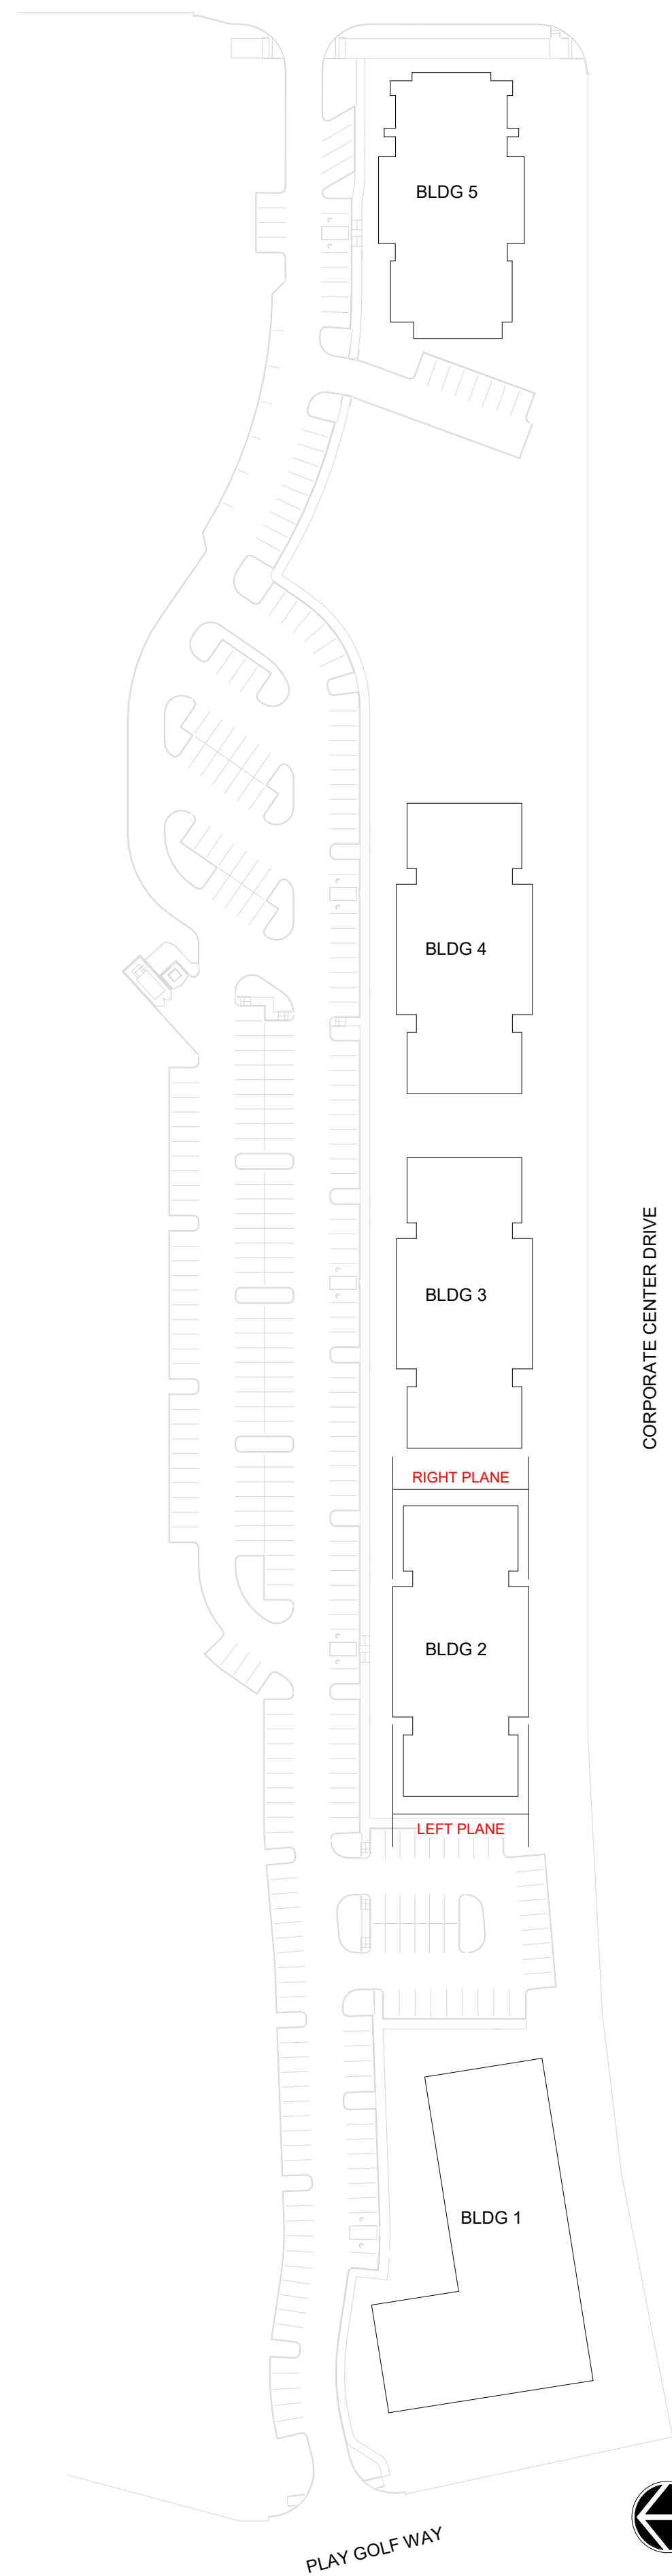

CORPORATE CENTER DRIVE

AVERAGE GRADE CALCULATION

BUILDING 2	POST-DEVELOPMENT GRADES		
	HIGHEST	LOWEST	AVERAGE
FRONT PLANE [1] - PRIMARY STREET	412	411.25	411.63
LEFT PLANE [2]	412	400.04	406.02
RIGHT PLANE [3]	411.25	401	406.13
REAR PLANE [4]	401	400.04	400.52
AVERAGE GRADE			406.07

- PER SECTION 1.5.7, BUILDING HEIGHT IS MEASURED FROM THE AVERAGE GRADE TO THE TOP OF THE HIGHEST POINT OF A PITCHED OR FLAT ROOF, EXCLUDING THE PARAPET.
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BUILDING 2 - EAST ELEVATION


RIGHT PLANE
3/32" = 1' - 0"



BUILDING 2 - WEST ELEVATION

LEFT PLANE
3/32" = 1' - 0"

TRINITY ROAD

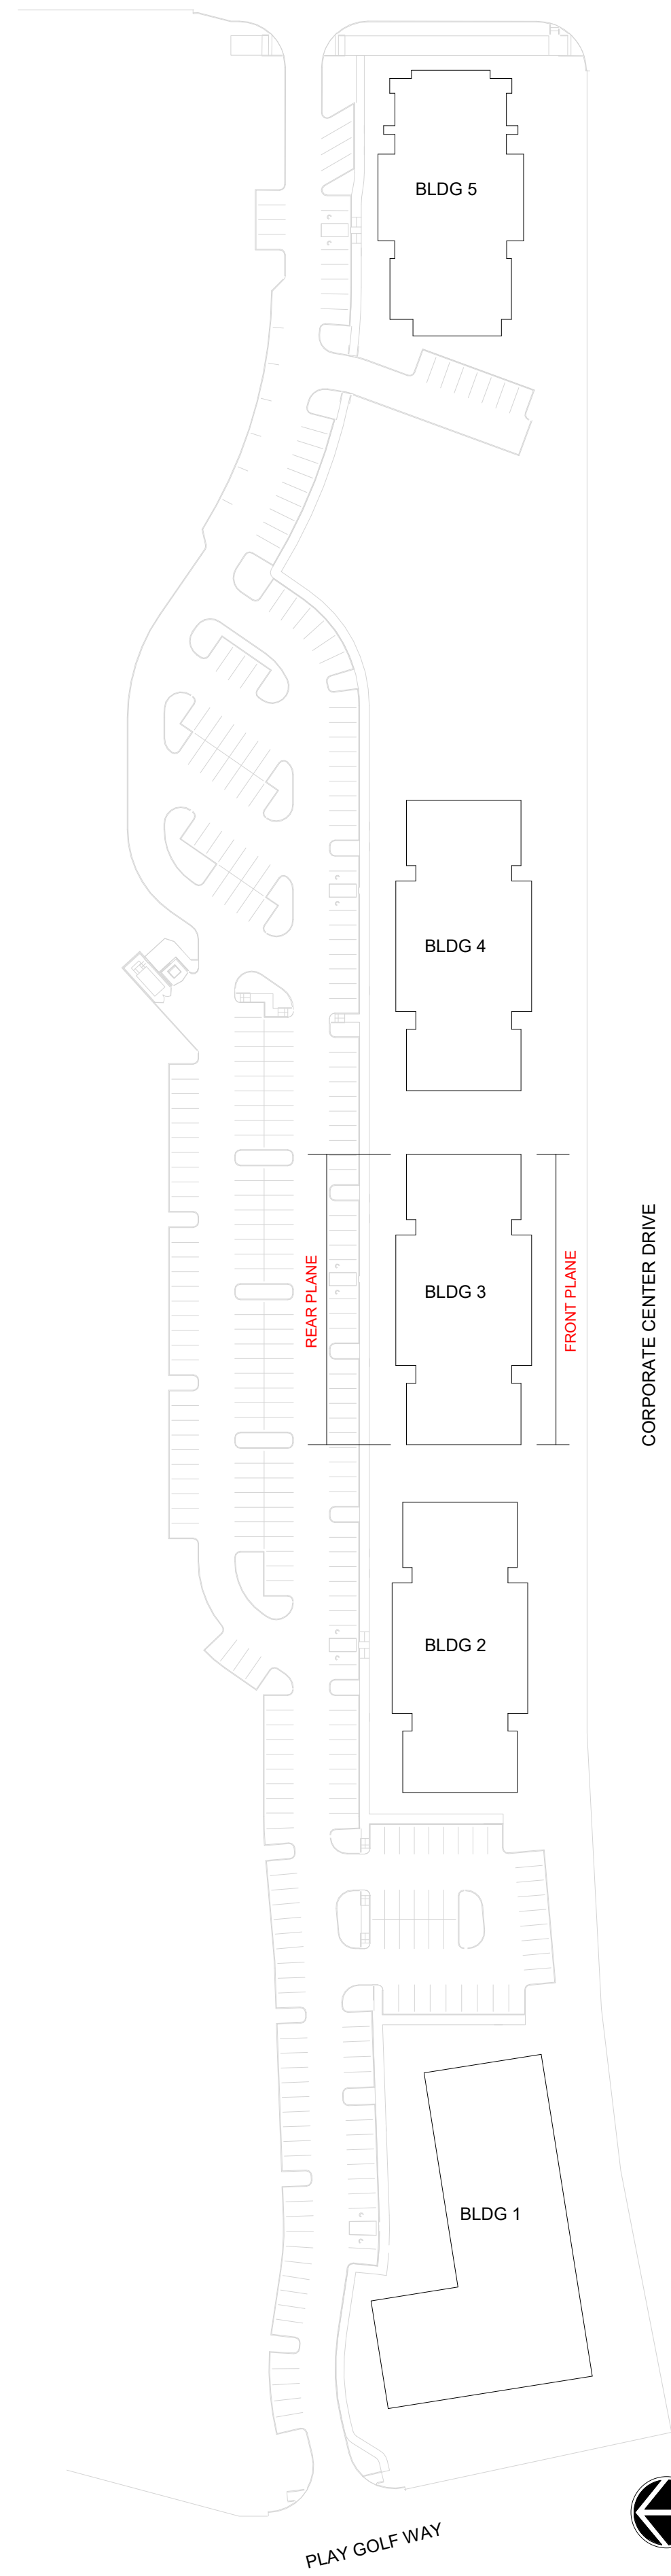

CORPORATE CENTER DRIVE

AVERAGE GRADE CALCULATION

BUILDING 3	POST-DEVELOPMENT GRADES		
	HIGHEST	LOWEST	AVERAGE
FRONT PLANE [1] - PRIMARY STREET	412	411.89	411.95
LEFT PLANE [2]	411.89	401	406.45
RIGHT PLANE [3]	412	401	406.50
REAR PLANE [4]	401	401	401.00
AVERAGE GRADE			406.47

- PER SECTION 1.5.7, BUILDING HEIGHT IS MEASURED FROM THE AVERAGE GRADE TO THE TOP OF THE HIGHEST POINT OF A PITCHED OR FLAT ROOF, EXCLUDING THE PARAPET.
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**BUILDING 3 - NORTH ELEVATION
PARKING**


REAR PLANE
3/32" = 1' - 0"



**BUILDING 3 - SOUTH ELEVATION
PRIMARY STREET**

FRONT PLANE
3/32" = 1' - 0"

TRINITY ROAD

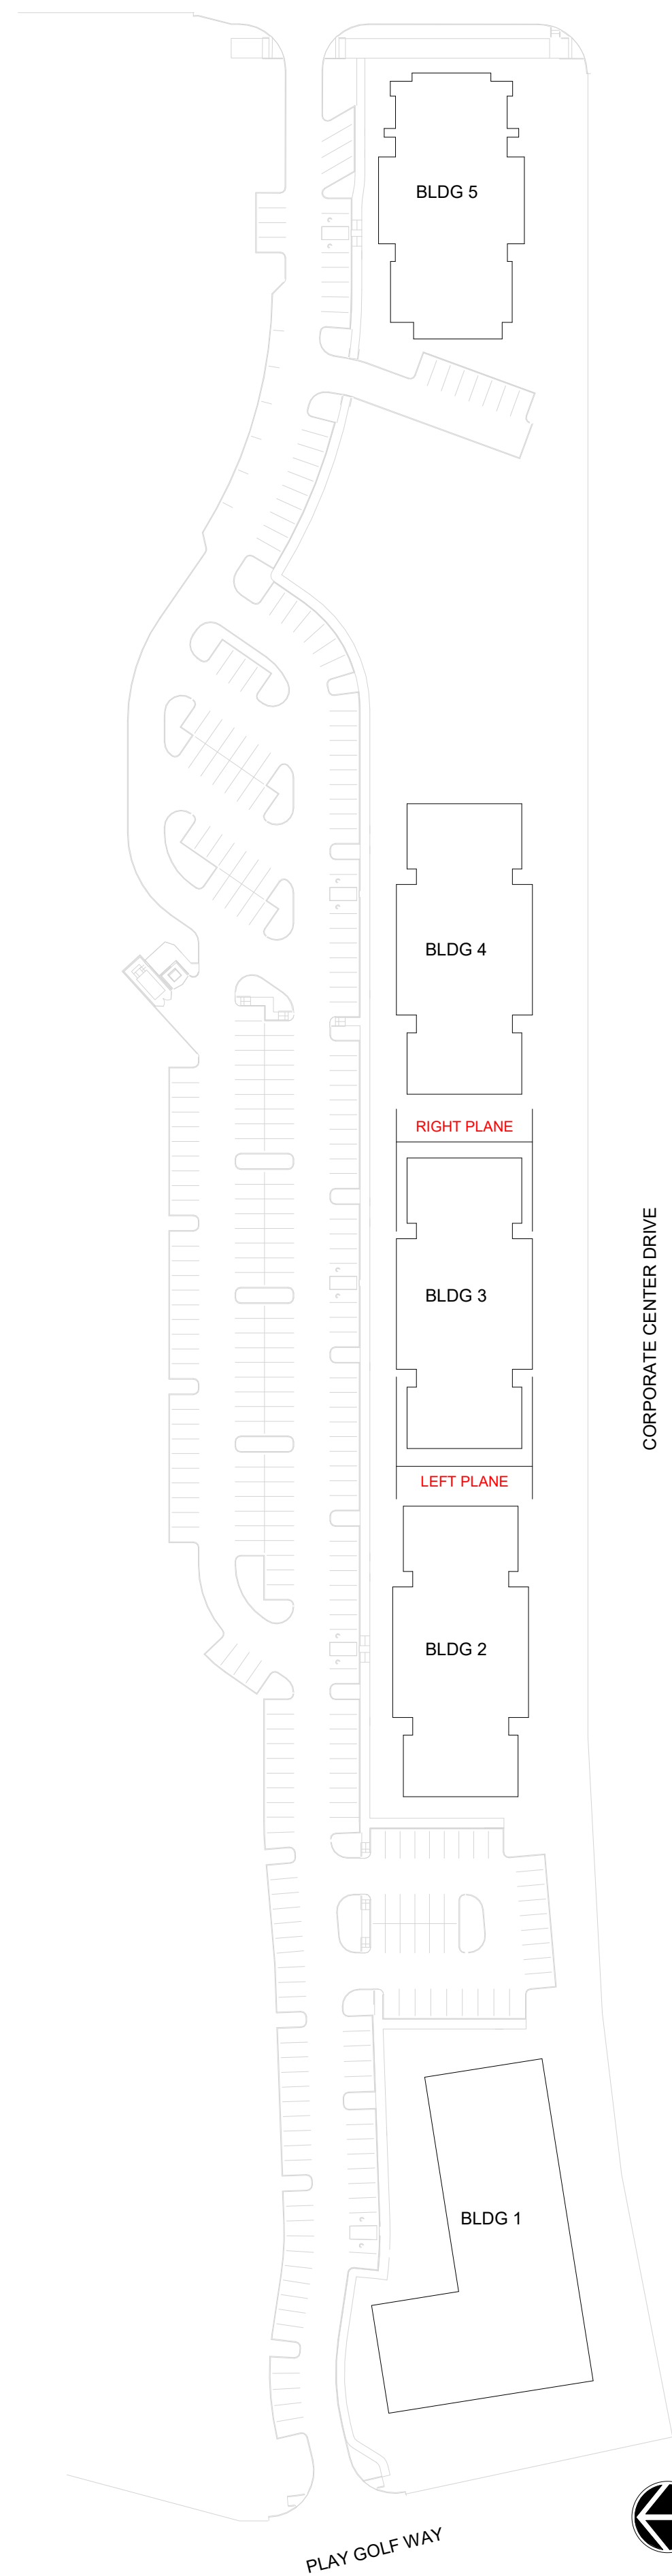

CORPORATE CENTER DRIVE

AVERAGE GRADE CALCULATION

BUILDING 3	POST-DEVELOPMENT GRADES		
	HIGHEST	LOWEST	AVERAGE
FRONT PLANE [1] - PRIMARY STREET	412	411.89	411.95
LEFT PLANE [2]	411.89	401	406.45
RIGHT PLANE [3]	412	401	406.50
REAR PLANE [4]	401	401	401.00
AVERAGE GRADE			406.47

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BUILDING 3 - EAST ELEVATION


RIGHT PLANE
3/32" = 1' - 0"



BUILDING 3 - WEST ELEVATION

LEFT PLANE
3/32" = 1' - 0"


TRINITY ROAD

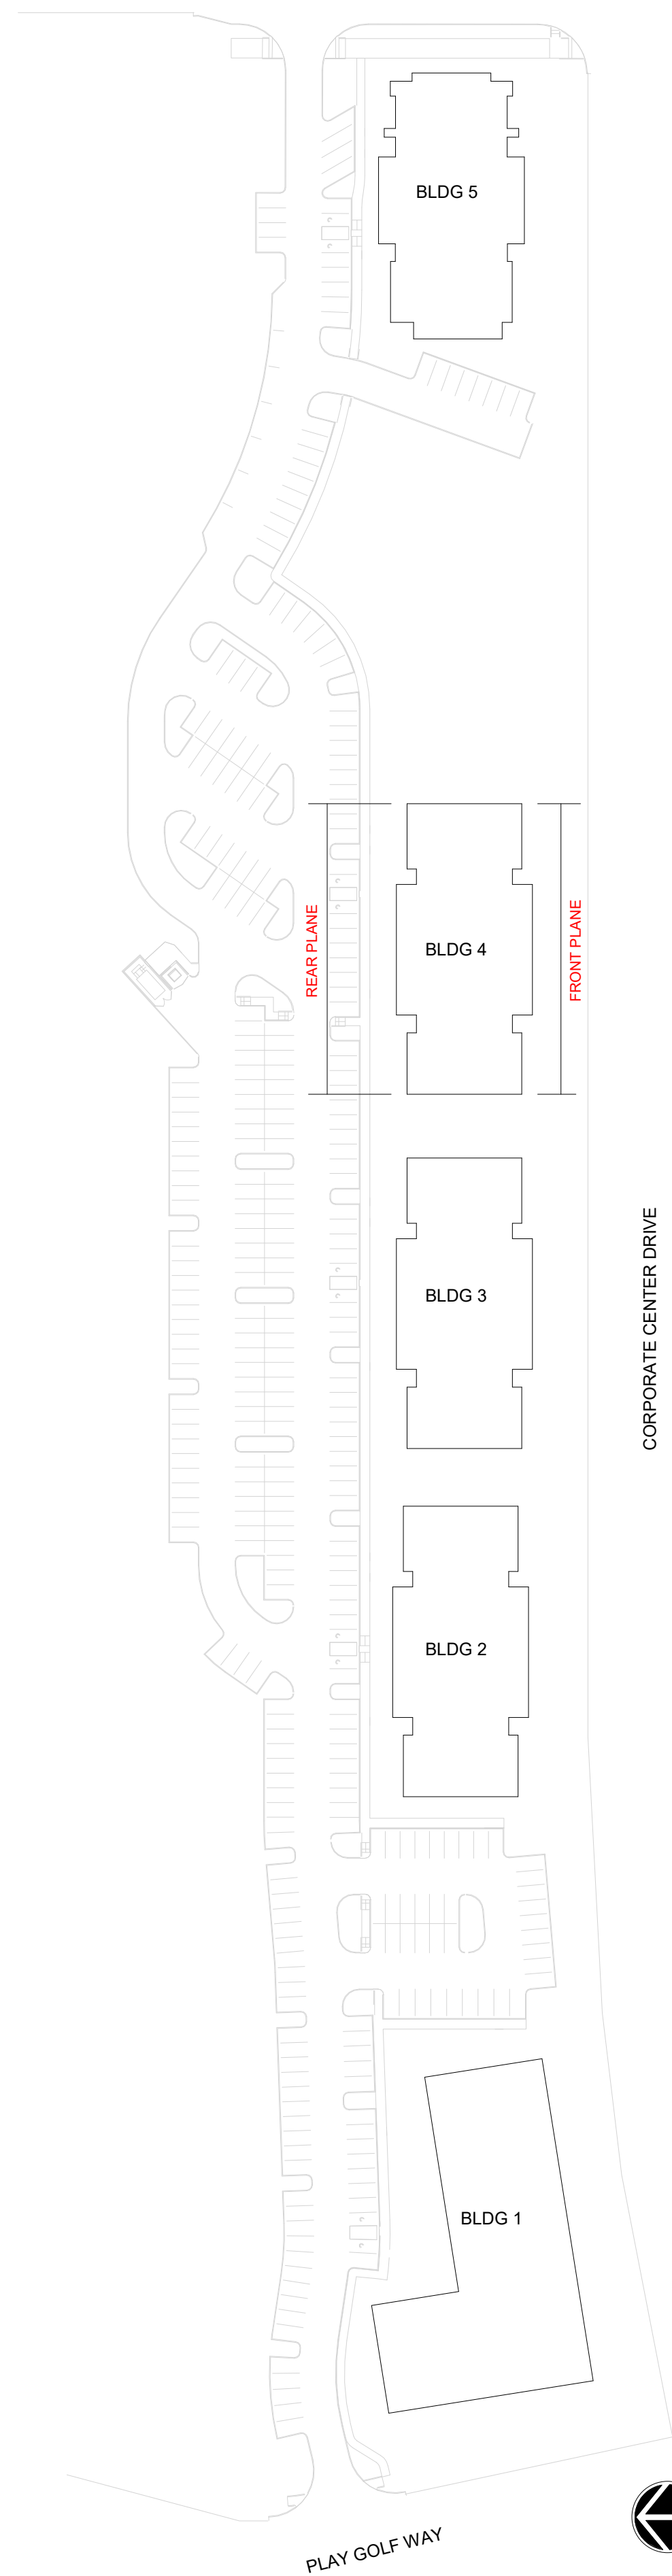

AVERAGE GRADE CALCULATION

BUILDING 4	POST-DEVELOPMENT GRADES		
	HIGHEST	LOWEST	AVERAGE
FRONT PLANE [1] - PRIMARY STREET	405.67	405	405.34
LEFT PLANE [2]	405	394	399.50
RIGHT PLANE [3]	405	394	399.50
REAR PLANE [4]	394	394	394.00
AVERAGE GRADE			399.58

- PER SECTION 1.5.7, BUILDING HEIGHT IS MEASURED FROM THE AVERAGE GRADE TO THE TOP OF THE HIGHEST POINT OF A PITCHED OR FLAT ROOF, EXCLUDING THE PARAPET.
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BUILDING 4 - NORTH ELEVATION
PARKING

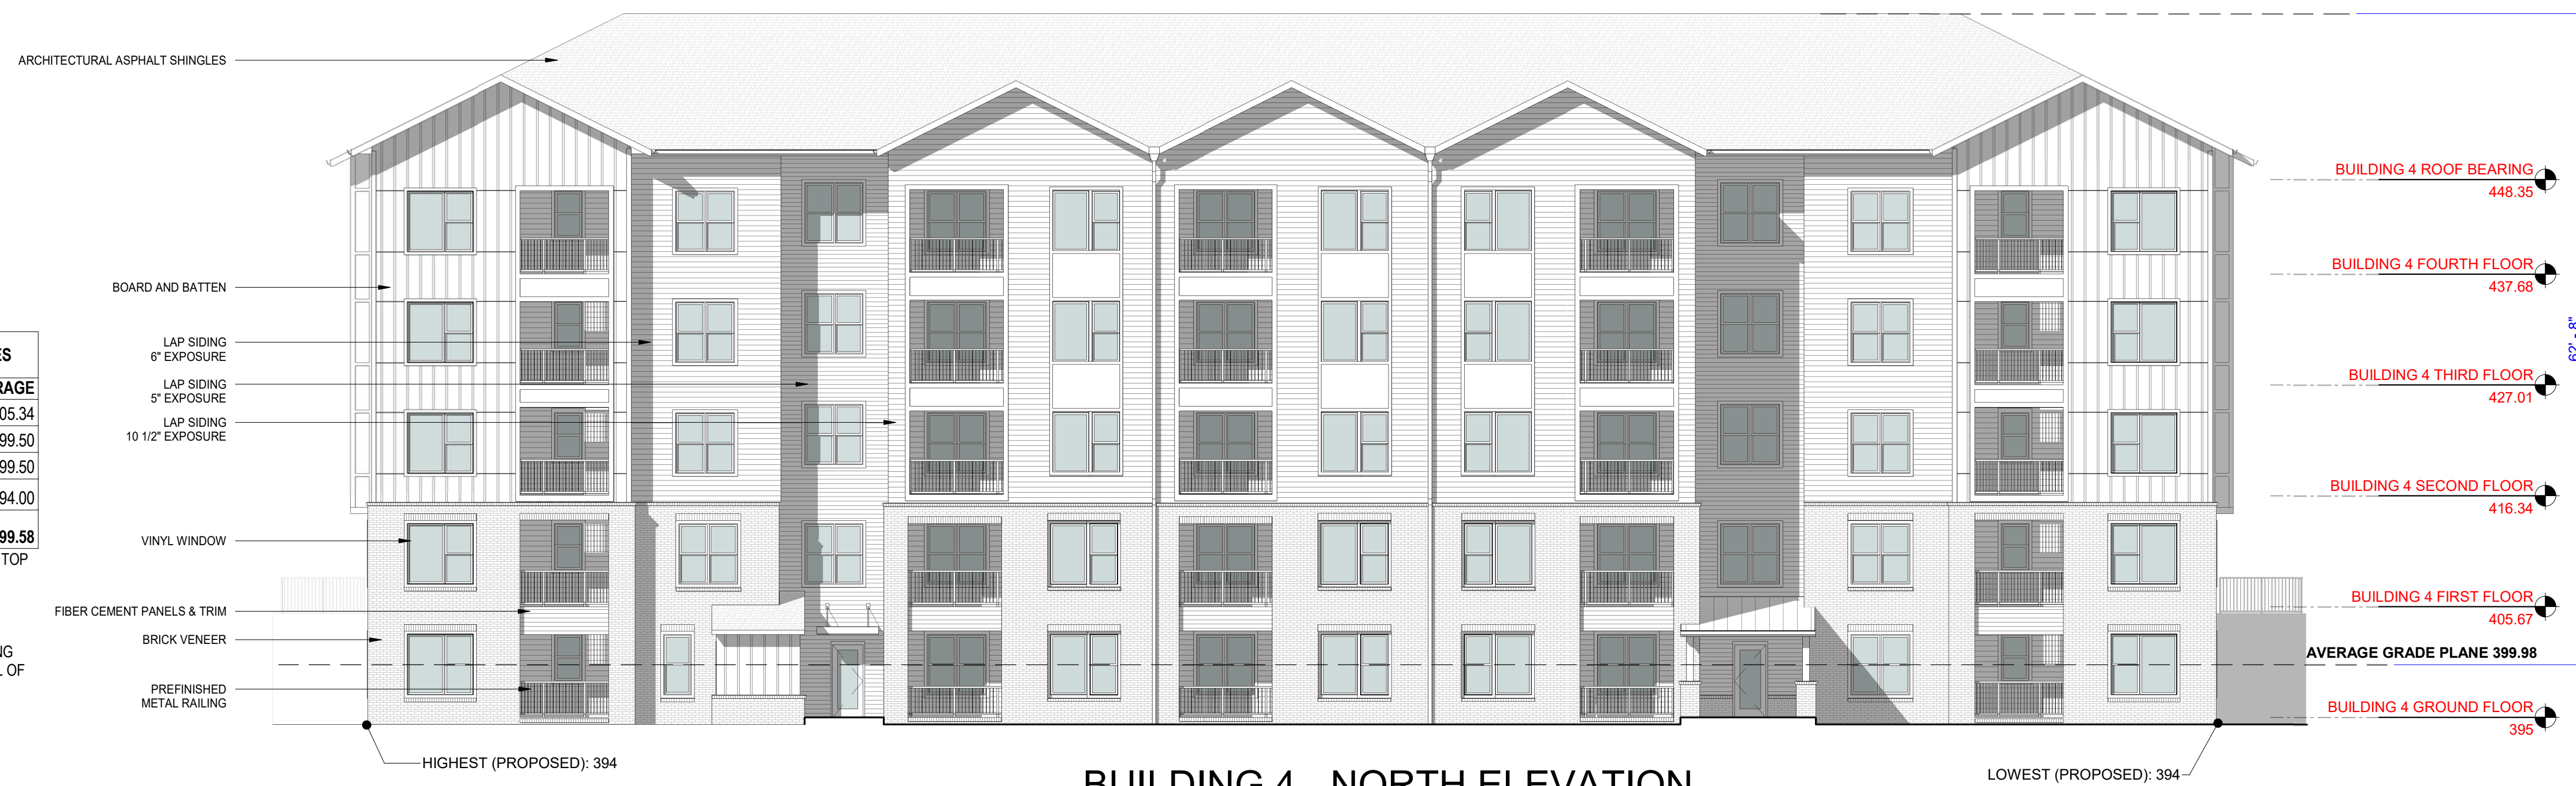
REAR PLANE
3/32" = 1' - 0"



BUILDING 4 - SOUTH ELEVATION
PRIMARY STREET

FRONT PLANE
3/32" = 1' - 0"

TRINITY ROAD

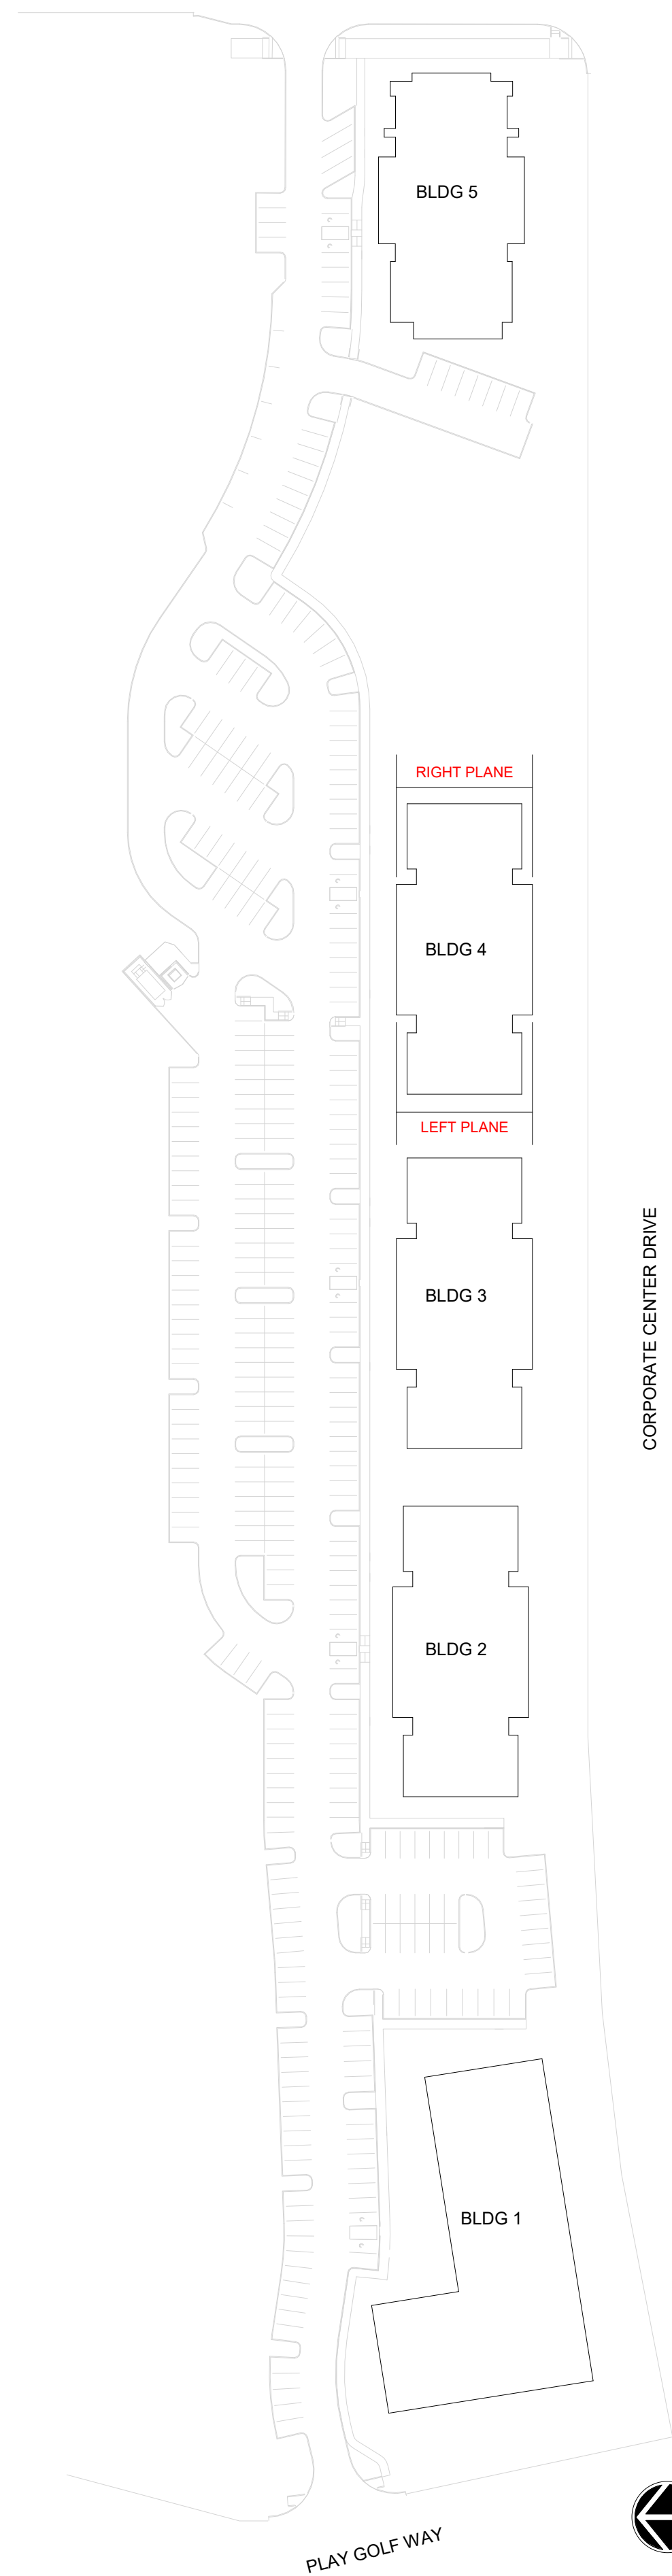

CORPORATE CENTER DRIVE

AVERAGE GRADE CALCULATION

BUILDING 4	POST-DEVELOPMENT GRADES		
	HIGHEST	LOWEST	AVERAGE
FRONT PLANE [1] - PRIMARY STREET	405.67	405	405.34
LEFT PLANE [2]	405	394	399.50
RIGHT PLANE [3]	405	394	399.50
REAR PLANE [4]	394	394	394.00
AVERAGE GRADE			399.58

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BUILDING 4 - EAST ELEVATION


RIGHT PLANE
3/32" = 1' - 0"



BUILDING 4 - WEST ELEVATION

LEFT PLANE
3/32" = 1' - 0"

TRINITY ROAD

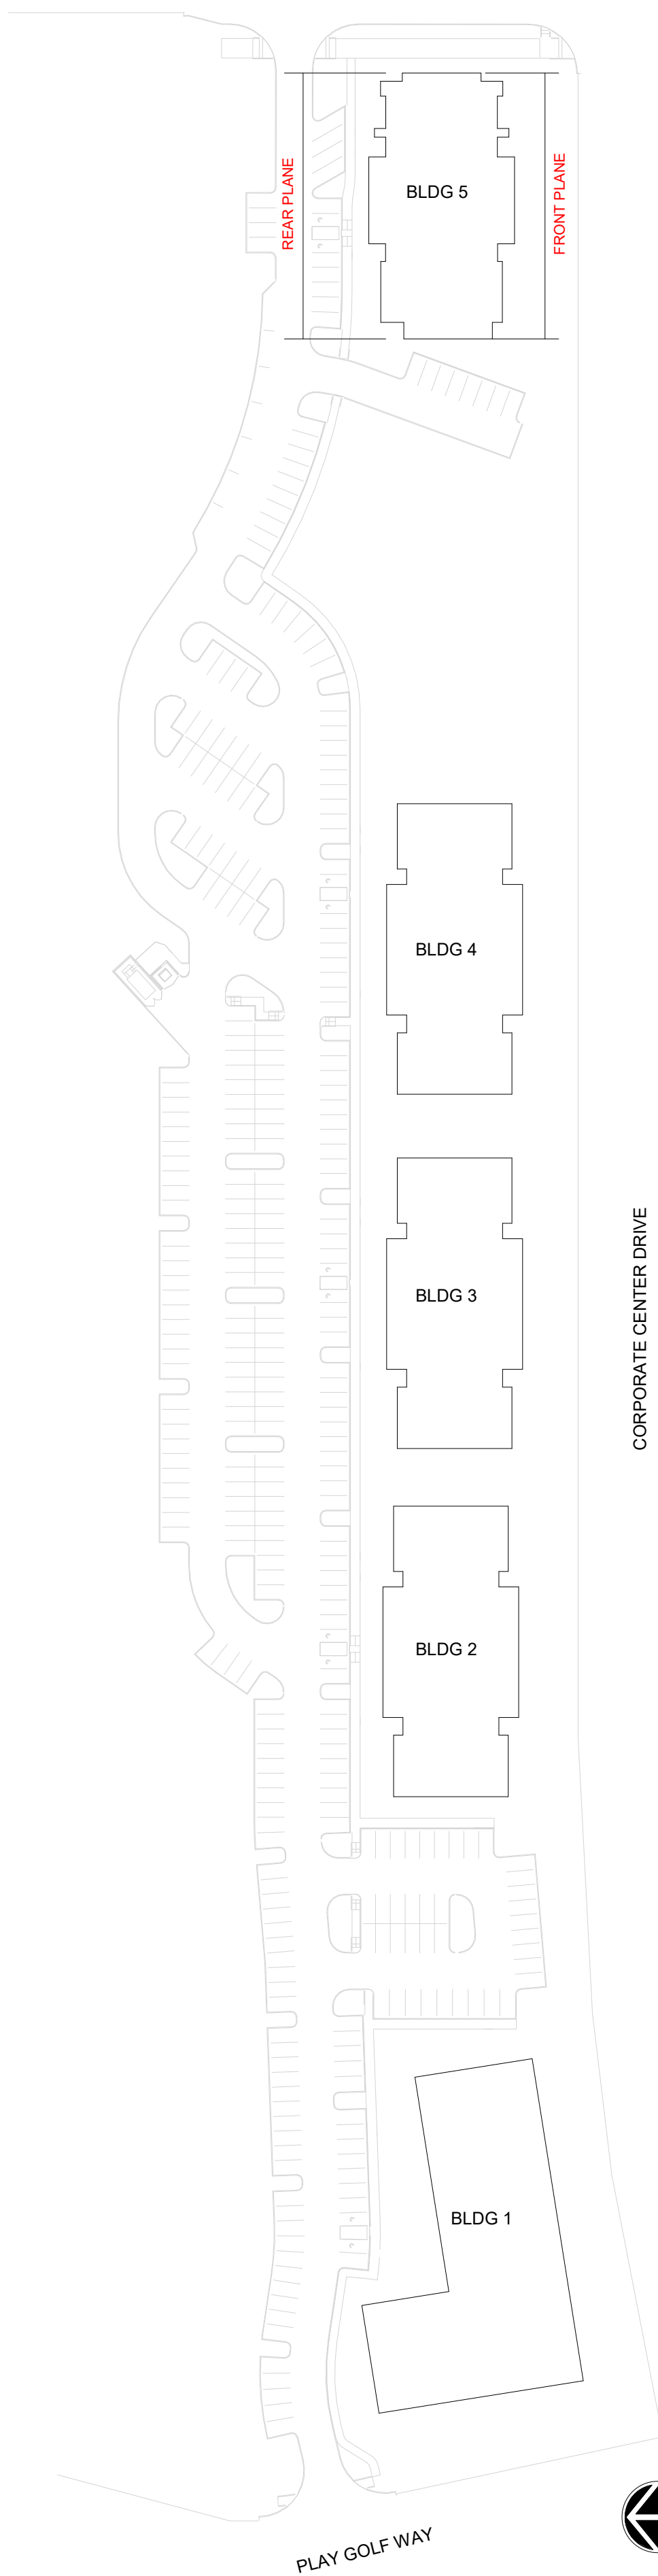

AVERAGE GRADE CALCULATION

BUILDING 5	POST-DEVELOPMENT GRADES		
	HIGHEST	LOWEST	AVERAGE
FRONT PLANE [1] - PRIMARY STREET	389	386	387.50
LEFT PLANE [2]	378.25	388.13	383.19
RIGHT PLANE [3]	386	378.25	382.13
REAR PLANE [4]	378.25	378.25	378.25
AVERAGE GRADE			382.77

- PER SECTION 1.5.7, BUILDING HEIGHT IS MEASURED FROM THE AVERAGE GRADE TO THE TOP OF THE HIGHEST POINT OF A PITCHED OR FLAT ROOF, EXCLUDING THE PARAPET.
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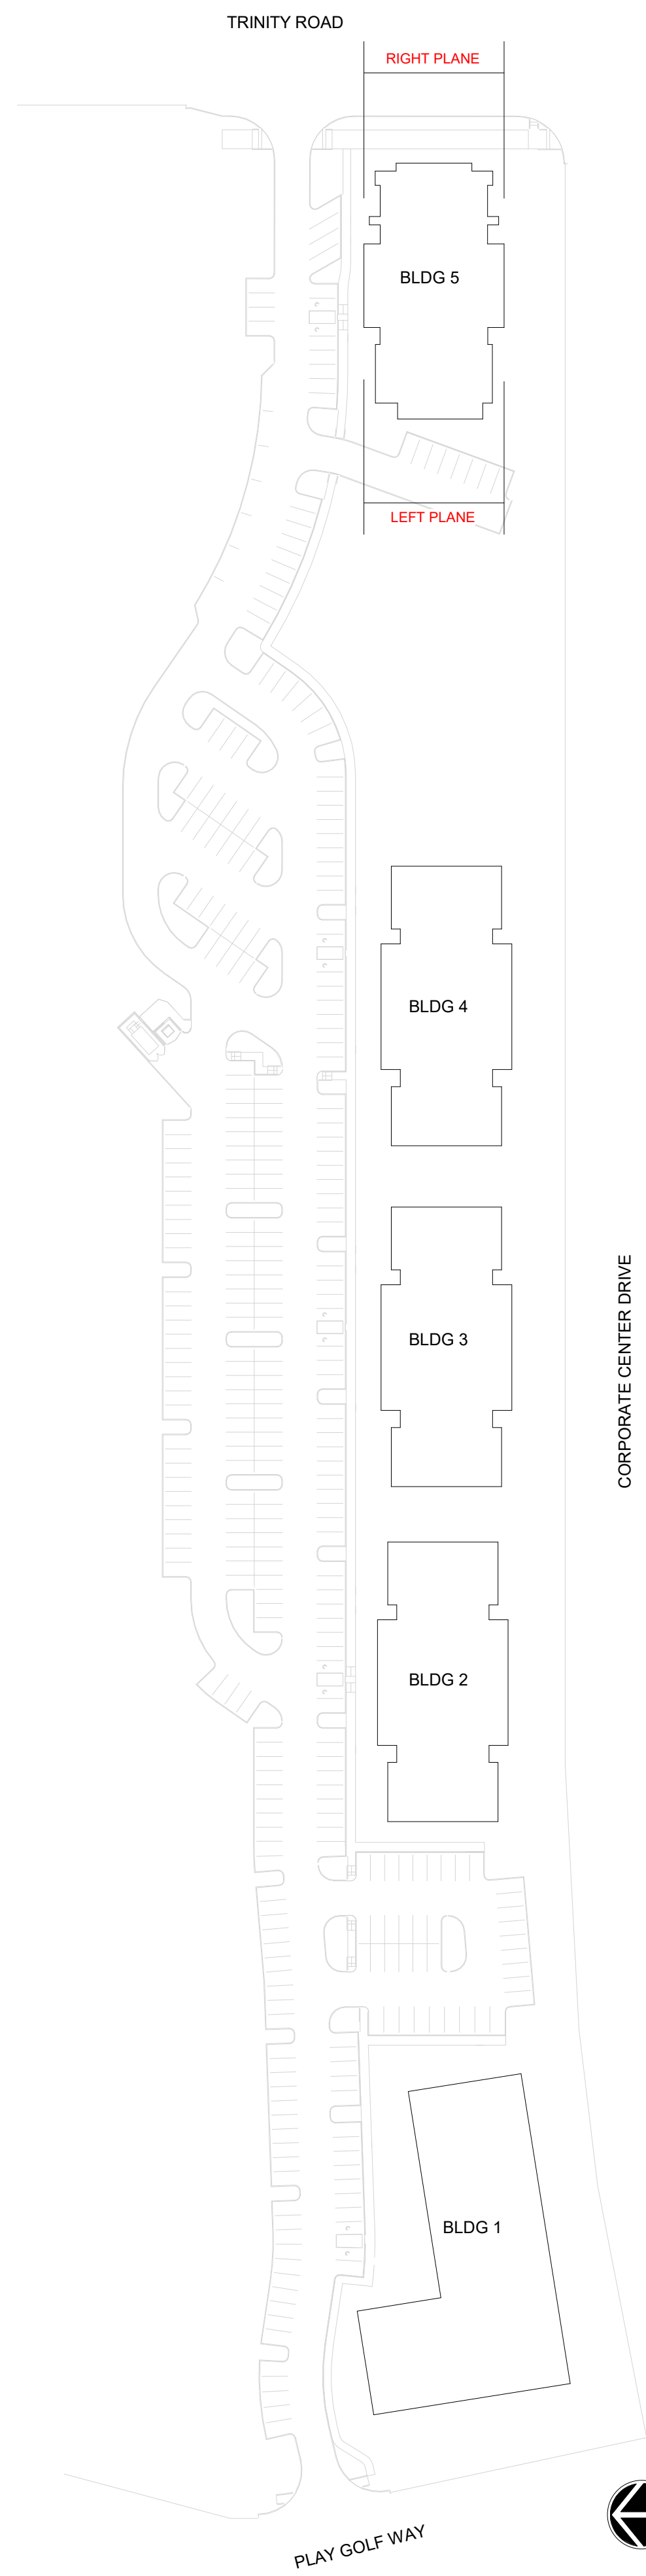
BUILDING 5 - NORTH ELEVATION
PARKING

REAR PLANE
3/32" = 1' - 0"



BUILDING 5 - SOUTH ELEVATION
PRIMARY STREET

FRONT PLANE
3/32" = 1' - 0"



AVERAGE GRADE CALCULATION


BUILDING 5	POST-DEVELOPMENT GRADES		
	HIGHEST	LOWEST	AVERAGE
FRONT PLANE [1] - PRIMARY STREET	389	386	387.50
LEFT PLANE [2]	378.25	388.13	383.19
RIGHT PLANE [3]	386	378.25	382.13
REAR PLANE [4]	378.25	378.25	378.25
AVERAGE GRADE			382.77

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**BUILDING 5 - EAST ELEVATION
PRIMARY STREET**

RIGHT PLANE
3/32" = 1' - 0"



**BUILDING 5 - WEST ELEVATION
PARKING**

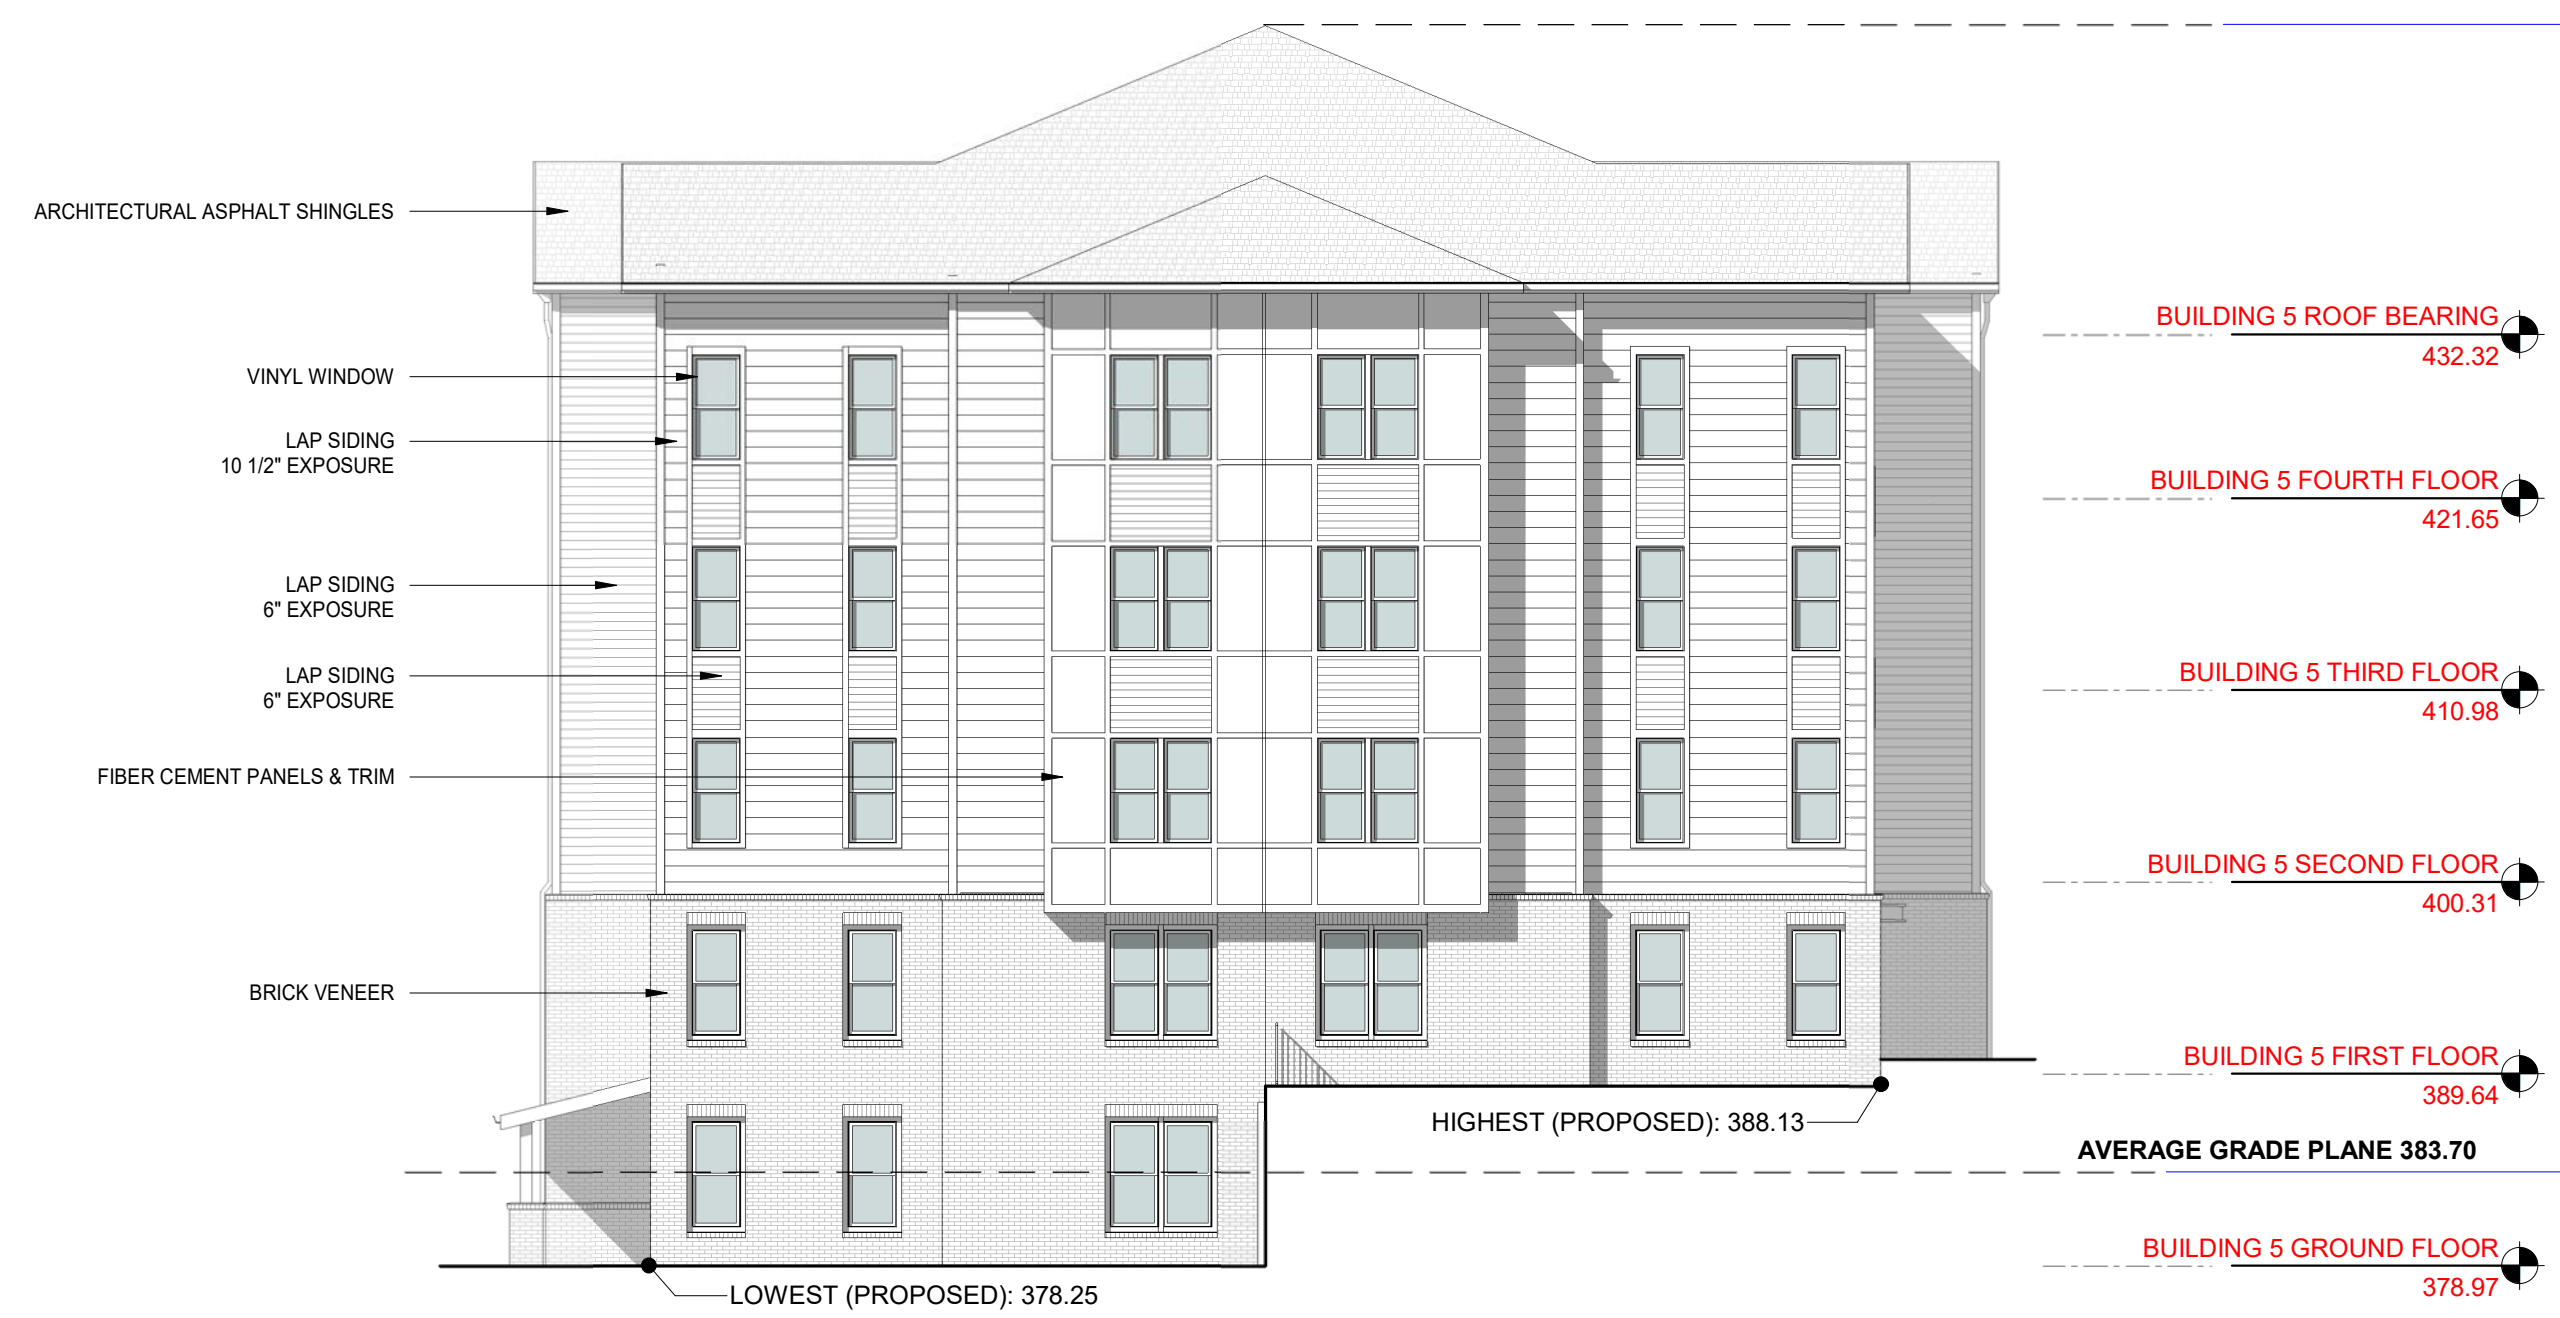LEFT PLANE
3/32" = 1' - 0"