ASR-0055-2019

DEVELOPMENT SERVICES

Administrative Site Review Application



Development Services Customer Service Center • One Exchange Plaza, Suite 400 | Raleigh, NC 27601 | 919-996-2495

This form is required when submitting site plans as referenced in Unified Development Ordinance (UDO) Section 10.2.8. Please check the appropriate building types and include the plan checklist document when submitting.

Office Use Only: Transaction #: Pl				Planning Coordinator: Kyan DOWN		
Building Type				Site Transaction History		
	Detached		General	Subdivision transaction #: S-97-2007		
	Attached		Mixed use	Sketch transaction #: 573748		
				Certificate of Appropriateness #: Board of Adjustment #:		
N N	Apartment	<u></u>	Open lot	Zoning Case #: Z-40-2016		
	Townhouse		Civic	Administrative Alternate #:		
		(SENERAL IN	FORMATION		
Development r	name: Oak Fo	rest Senior Apa	rtments			
Inside City limi	ts? 🔽 Yes	No				
Property addre	ess(es): 570	00 Oak Fo	orest D	rive, Raleigh, NC 27616		
Site P.I.N.(s):	1726380863					
		f work. Include ar	ny additions,	expansions, and change of use.		
Construction	of new seni	or living apartm	ents			
Current Propo	rty Owner/Dev	eloper Contact N	lame:			
NOTE: please	attach purcl	nase agreement	when submi	itting this form.		
	Company: Carolina Project Equities, LLC c/o Mark Tipton Title: Managing Member					
		k Rd, Wake For				
Phone #: 919-		-		tipton@whistlerinvestmentgroup.com		
Applicant Nan		pson				
Company: JD:			Address: 510	S Wilmington Street, Raleigh, NC 27601		
Phone #: 919-835-1500 Email: kent@jdavisarchitects.com				Djdavisarchitects.com		

	E + SITE DATE TABLE ill developments)
SITE DATA	BUILDING DATA
Zoning district (if more than one, please provide the acreage of each): CX-4-PL-CU	Existing gross floor area (not to be demolished): 0 SF Existing gross floor area to be demolished: 0 SF
Gross site acreage: 5,94 ac	New gross floor area: 154,305 SF
# of parking spaces required: 132 SPACES	Total sf gross (to remain and new): 154,305 SF
# of parking spaces proposed: 132 SPACES	Proposed # of buildings: 1
Overlay District (if applicable): N/A	Proposed # of stories for each: 4
Existing use (UDO 6.1.4): Single Family Residential	
Proposed use (UDO 6.1.4): Apartments	
STORMWATE	RINFORMATION
Existing Impervious Surface: Acres:38 AC Square Feet:16,553 SF	Proposed Impervious Surface: Acres: 2.93 AC Square Feet: 127,631 SF
Is this a flood hazard area? Yes No If yes, please provide: Alluvial soils: Flood stu	
FEMA Map Panel #:	Wetlands ☐ Yes ☑ No
TVCusc Titles Ballon La	
RESIDENTIAL I	DEVELOPMENTS
Total # of dwelling units: 120	Total # of hotel units: 0
# of bedroom units: 1br: 48 2br: 72 3br:	4br or more: Is your project a cottage court? Yes No
# of lots: 1	Is your project a cottage court? Yes No
	JRE BLOCK
I hereby designate Ken Thompson this application, to receive and response to administrati represent me in any public meeting regarding this appli	t plan as approved by the City of Raleigh. to serve as my agent regarding ve comments, to resubmit plans on my behalf, and to
with the proposed development use. I acknowledge that submittal policy which states applications will expire af	ter 180 days of inactivity.
Signature: / / Auf The Value	Date: 7/2/20/9

Printed Name: Mark Tipton, Managing Member

REFERENCE: Sketch Plan (TA: 573748)

ASR-SR-XX-19

Administrative Site Review

1st Submittal: July 30, 2019

Oak Forest Senior Apartments

5700 Oak Forest Drive ZONING CONDITIONS Raleigh, North Carolina 27616 Ordinance (2017) 738 ZC 751 **Z-40-16** – **Oak Forest Road,** north side, west of Capital Boulevard, being Wake County PINs 1726380863 and 1726286588. Approximately 7.87 acres rezoned to Commercial Mixed Use-4 stories-Parking Limited-Conditional Use (CX-4-PL-CU). **RESPONSE TO ZONING CONDITIONS:** 1. Prohibiting uses: The following principal uses shall be prohibited: 1. NONE OF THE LISTED USES ARE PROPOSED Telecommunication Towers – all types; outdoor sports or entertainment facilities - all types; vehicle sales/rental; jail, detention center, prison; vehicular repair or car wash; any establishment engaged in the sale of gasoline or diesel fuel; game arcade; tattoo parlor; check cashing establishment; pawn shop; bar, nightclub, 2. NO BUSSINESS ARE PROPOSED, TRASH tavern or lounge, adult establishment, cemetery and major utilities - all types. 2. Hours of Operation: The hours of public access to any business establishment PICK UP HOURS WILL BE RESTRICTED operating on the properly shall be limited to the period from 6:00 am until 11:00 FROM 11 PM UNTIL 6 AM pm. There shall be no deliveries to or shipments from businesses on the property or trash or dumpster pickup between the hours of 11:00 pm to 6:00am. No 24 hour commercial uses shall be permitted on the property. 3. The term "business establishment" shall not include churches and places of NONE OF THESE USES ARE PROPOSED worship and their related uses. Sheet Index

UTILITY PLAN

GRADING & STORMWATER PLAN

LANDSCAPE PLAN (CODE COMPLIANT)

STORMWATER DETAILS

STORMWATER DETAILS

LANDSCAPE DETAILS

Call before you dig. PROP. SECONDARY TREE PROP. OUTDOOR AMENITY AREA SIGHT EASEMENT VEHICLE RATED CONCRETE

EX. LIGHT

EX. FIRE HYDRANT

PROP. FIRE HYDRANT

PROP. 4-BIKE RACK PROP. HANDICAP PARKING

PROP. SIGNAGE

PROP. BUILD TO LINE

Notes

LIGHTING PLAN

SITE DETAILS

SITE PLAN

GENERAL NOTES

TREE CONSERVATION PLAN

EXISTING CONDITIONS AND DEMOLITION PLAN

- 1. ALL CONSTRUCTION SHALL BE IN ACCORDANCE WITH CITY OF RALEIGH AND/OR NCDOT STANDARDS.
- THE CONTRACTOR SHALL CONDUCT THE WORK IN A SAFE MANNER AND WITH A MINIMUM AMOUNT OF INCONVENIENCE TO TRAFFIC PRIOR TO CONSTRUCTION BEGINNING, ALL SIGNAGE AND TRAFFIC CONTROL SHALL BE IN PLACE
- 4. THE CONTRACTOR SHALL REPAIR ALL DAMAGED INFRASTRUCTURE IN THE RIGHT-OF-WAY AND RESTORE IT TO PREVIOUS OR BETTER CONDITION. THE CONTRACTOR SHALL REPAIR ANY DAMAGES TO ADJACENT PROPERTIES AND RESTORE IT TO PREVIOUS OR BETTER CONDITION.

LT1.1

LS1.1

LS2.1

LS3.1

- IF UNFORESEEN CONDITIONS DEVELOP DURING CONSTRUCTION, REFER TO "CITY OF RALEIGH STREET DESIGN MANUAL" AND CONTACT THE DEVELOPMENT
- IF CONSTRUCTION PLANS FOR PUBLIC AND PRIVATE STREETS OR UTILITIES SHOWN ON THIS PLAN ARE REQUIRED, THEY MUST BE APPROVED BY THE PUBLIC WORKS DEPARTMENT AND PUBLIC UTILITIES DEPARTMENT PRIOR TO ISSUANCE OF PERMITS OR RECORDING OF ANY PLAT FOR THIS DEVELOPMENT.
- FIELD ADJUSTMENTS TO THIS PLAN MAY BE REQUIRED BY CITY OF RALEIGH INSPECTOR AS NEEDED DURING CONSTRUCTION. ALL SURVEY INFORMATION PROVIDED TO JDAVIS ARCHITECTS BY JOHN A. EDWARDS AND COMPANY IN RALEIGH, NORTH CAROLINA IN DIGITAL FORMAT IN AUGUST
- 10. WITHIN THE SIGHT TRIANGLES SHOWN ON THIS PLAN, NO OBSTRUCTION BETWEEN 2 FEET AND 8 FEET IN HEIGHT ABOVE THE CURB LINE ELEVATION SHALL BE LOCATED IN WHOLE OR PART. OBSTRUCTIONS INCLUDE BUT ARE NOT LIMITED TO ANY BERM, FOLIAGE, FENCE, WALL, SIGN, OR PARKED VEHICLE.
- UNLESS NOTED, ACCESS ROUTE FOR EMERGENCY VEHICLES SHALL PROVIDE AN INSIDE TURNING RADIUS OF 28' MINIMUM. 12. UNLESS NOTED, ALL DIMENSIONS SHOWN ARE TO BACK OF CURB.
- 13. TRASH AND CARDBOARD DUMPSTER(S) ENCLOSURE SHALL COMPATIBLE WITH MATERIAL AND/OR COLOR OF THE PRINCIPAL BUILDING.
- 1. GROUND-MOUNTED MECHANICAL EQUIPMENT MUST ADHERE TO THE SCREENING REQUIREMENTS OF SEC 7.2.5.D.4 AND IS NOT ONLY LIMITED TO BEING VISIBLE
- . CONTRACTOR TO FIELD LOCATE AND VERIFY ALL EXISTING UTILITIES PRIOR TO CONSTRUCTION AND REPORT ANY DISCREPANCIES TO LANDSCAPE ARCHITECT PRIOR TO ANY CONSTRUCTION ACTIVITIES. CONTACT NC ONE AT 811 FOR FIELD LOCATION OF UNDERGROUND UTILITIES.
- . HANDICAP PARKING SPACE(S) AND HC ACCESS AISLE(S) SHALL BE NO GREATER THAN TWO PERCENT (2%) PITCH IN ANY DIRECTION(S) AS PER ADA STANDARDS.
- . PROVIDE SIGNAGE AND STRIPING OF HANDICAP SPACES AS PER ADA STANDARDS. 18. ALL RETAINING WALLS GREATER THAN 30" IN HEIGHT TO INCLUDE SAFETY RAIL OR FENCE

- 19. THE MINIMUM CORNER CLEARANCE FROM THE CURB LINE OF INTERSECTING STREETS SHALL BE AT LEAST 20 FEET FROM THE POINT OF TANGENCY OF THE CURB. TREE CONSERVATION NOTE
- 20. WC ACCESS RAMPS WILL BE PROVIDED IN ACCORDANCE WITH CITY OF RALEIGH PUBLIC WORKS DEPARTMENT STANDARDS, PROWAG STANDARDS AND ADAAG
- 21. ALL RAMPS AND HANDRAILS SHALL BE CONFORM TO ANSI, NCSBC, AND ICC STANDARDS AND SPECIFICATIONS.
- 22. ALL ABOVE GROUND UTILITY DEVICES (TO INCLUDE BUT NOT LIMITED TO TELEPHONE AND CABLE PEDESTALS, ELECTRICAL TRANSFORMERS, BACKFLOW DEVICE HOTBOX, ETC) SHALL BE SCREENED FROM OFF-SITE VIEW BY EVERGREEN SHRUBS, FENCE, OR WALL.
- 23. GENERAL UTILITY PLACEMENT EASEMENT IS FOR INSTALLATION OF PRIVATE UTILITIES.
- 24. REQUIRED PARKING FOR AN AFFORDABLE HOUSING DEVELOPMENT MAY BE REDUCED TO A RATE OF ONE (1) PARKING SPACE FOR EACH UNIT AS PER UDO SEC
- FIRE DEPARTMENT NOTES
- THE APPARATUS ROAD SURFACE IS REQUIRED TO BE WITHIN 200 FEET (NFPA 13R) OR 250 FEET (NFPA13) TO ALL PORTIONS OF THE EXTERIOR WALL OF THE FIRST FLOOR OF THE BUILDING (NCFC 503.1.1).
- 2. FIRE HYDRANT SHALL BE LOCATED WITHIN 400' AS MEASURED ALONG THE PATH OF APPARATUS ACCESS ROAD (NCFC 507.5.1).
- 3. ALL NEW FIRE HYDRANTS SHALL BE EQUIPPED WITH NST THREADS AND WITH A 5 INCH STORZ CONNECTION. 4. FIRE FLOW ANALYSIS MUST BE PROVED AT TIME OF BUILDING PERMITS PER THE 2012 NCFC, SECTION 507.3.
- SOLID WASTE INSPECTION STATEMENTS
- 1. SOLID WASTE SERVICES ARE TO BE PROVIDED BY PRIVATE VENDOR.
- 2. THE DEVELOPER WILL COMPLY WITH ALL REQUIREMENTS SET FORTH IN THE SOLID WASTE MANUAL. 3. THIS PROJECT HAS DUMPSTERS FOR SOLID WASTE AND SINGLE-STREAM RECYCLING

A3.12

A3.13


A3.14

1. THIS PROJECT SITE IS MORE THAN 2 ACRES. TREE CONSERVATION IS REQUIRED PER UDO SEC. 9.1.2.

RIGHT OF WAY OBSTRUCTION NOTES

- STREET, LANE, AND SIDEWALK CLOSURES OR DETOURS: PRIOR TO ANY WORK THAT IMPACTS THE RIGHT-OF-WAY OR CLOSING OF ANY STREET, LANE, OR
- SIDEWALK, THE CONTRACTOR MUST APPLY FOR A PERMIT WITH RIGHT-OF-WAY SERVICES.
- A PERMIT REQUEST WITH A TRAFFIC CONTROL AND/OR PEDESTRIAN PLAN SHALL BE SUBMITTED TO RIGHTOFWAYSERVICES@RALEIGHNC.GOV AT
- PRIOR TO THE START OF WORK, THE CLIENT SHALL SCHEDULE A PRE-CONSTRUCTION MEETING WITH THE ENGINEERING INSPECTIONS COORDINATOR TO REVIEW THE SPECIFIC COMPONENTS OF THE APPROVED PLAN, AND ENSURE ALL PERMITS ARE ISSUED.
- THE CITY OF RALEIGH REQUIRES AN APPROVED RIGHT-OF-WAY OBSTRUCTION PERMIT FOR WORK ON ANY PUBLIC STREET OR SIDEWALK AND NCDOT ROAD WITHIN
- 5. ALL TRAFFIC CONTROL SIGNAGE AND PRACTICES SHALL ADHERE TO THE MANUAL ON UNIFORM TRAFFIC CONTROL, AND THE LATEST EDITION OF THE NCDOT "STANDARD SPECIFICATION FOR ROADWAY STRUCTURES", NCDOT "ROADWAY STANDARD DRAWING MANUAL", AND THE NCDOT SUPPLEMENT TO THE
- 6. ALL PUBLIC SIDEWALKS MUST BE ACCESSIBLE TO PEDESTRIANS WHO ARE VISUALLY IMPAIRED AND/OR PEOPLE WITH MOBILITY CONCERNS. EXISTING AND
- ALTERNATIVE PEDESTRIAN ROUTES DURING CONSTRUCTION SHALL BE REQUIRED TO BE COMPLIANT WITH THE PUBLIC RIGHTS OF WAY ACCESSIBILITY GUIDELINES (PROWAG), THE ADA STANDARDS FOR ACCESSIBLE DESIGN AND THE MANUAL ON UNIFORM TRAFFIC CONTROL DEVICES (MUTCD).
- ALL PERMITS MUST BE AVAILABLE AND VISIBLE ON SITE DURING THE OPERATION.
- PRIOR TO ANY WORK THAT IMPACTS THE RIGHT-OF-WAY OR CLOSING OF ANY STREET, LANE, OR SIDEWALK, THE CONTRACTOR MUST APPLY FOR A RIGHT-OF-WAY PERMIT. A TRAFFIC CONTROL AND/OR PEDESTRIAN PLAN SHALL BE SUBMITTED TO RIGHTOFWAYSERVICES@RALEIGHNC.GOV ALONG WITH THE APPLICATION.

Application

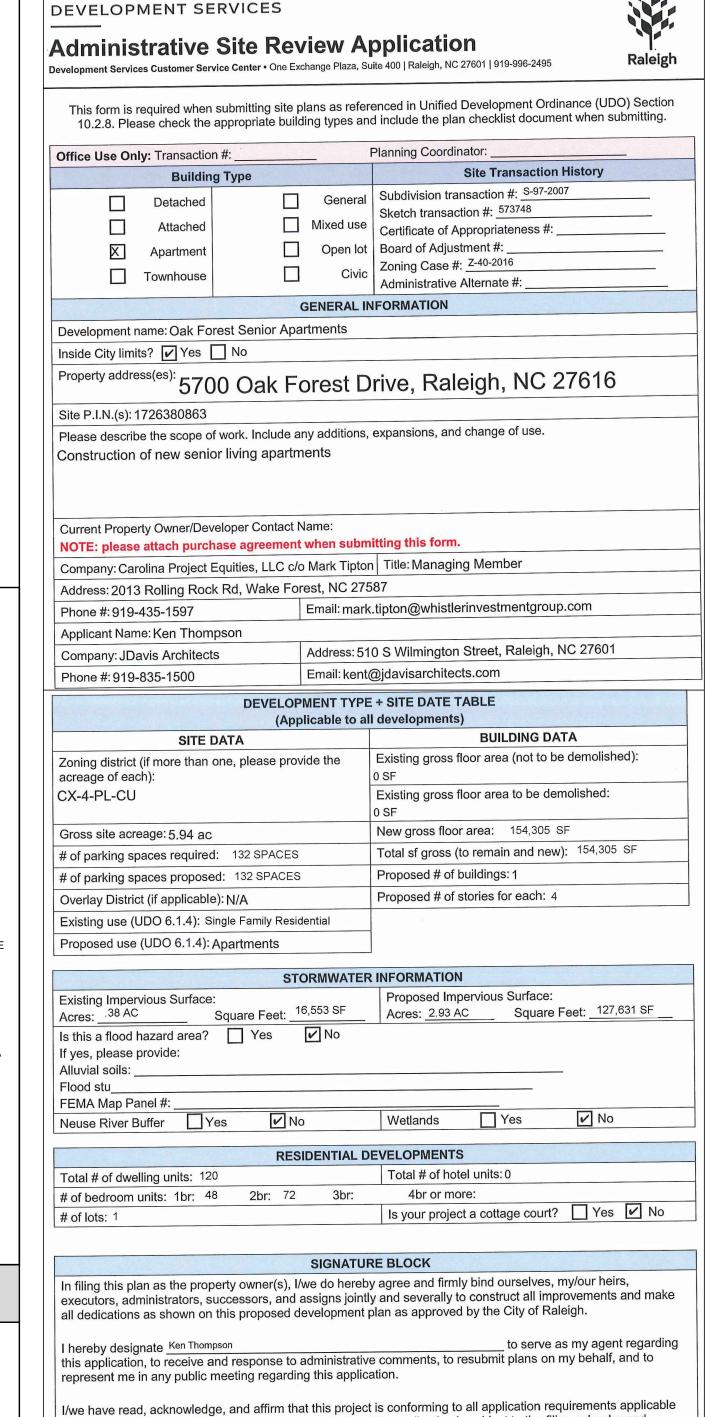

with the proposed development use. I acknowledge that this application is subject to the filing calendar and

submittal policy which states applications will expire after 180 days of inactivity.

Signature: / / Auth The Signature:

Printed Name: Mark Tipton, Managing Member

Project Team

Oak Forest Pointe LP 2013 Rolling Rock Road Wake Forest, North Carolina 27587-6271

mark.tipton@whisterinvestmentgroup.com

DEVELOPER Carolina Project Equities, LLC 2013 Rolling Rock Road

Wake Forest, North Carolina 27587 mark.tipton@whistlerinvestmentgroup.com LANDSCAPE ARCHITECT

JDavis Architects, PLLC 510 S. Wilmington Street Raleigh, North Carolina 27601 919.835.1500 919.835.1510 (fax)

kent@jdavisarchitects.com

ARCHITECT CSBO Architecture P.C. 1589 Skeet Club Rd, Suite 102-172 High Point, North Carolina 27265

carlos.sanchez@csboinc.com

336.617.3079

BUILDING EXTERIOR ELEVATIONS

BUILDING EXTERIOR ELEVATIONS

BUILDING EXTERIOR ELEVATIONS

BUILDING EXTERIOR ELEVATIONS

John A. Edwards & Co. 333 Wade Avenue Raleigh, North Carolina 27605 919.828.4428 919.828.4711 (fax) jon_callahan@jaeco.com

ENGINEER

SURVEYOR John A. Edwards & Co. 333 Wade Avenue Raleigh, North Carolina 27605 919.828.4428 919.828.4711 (fax) chris@JAECO.COM

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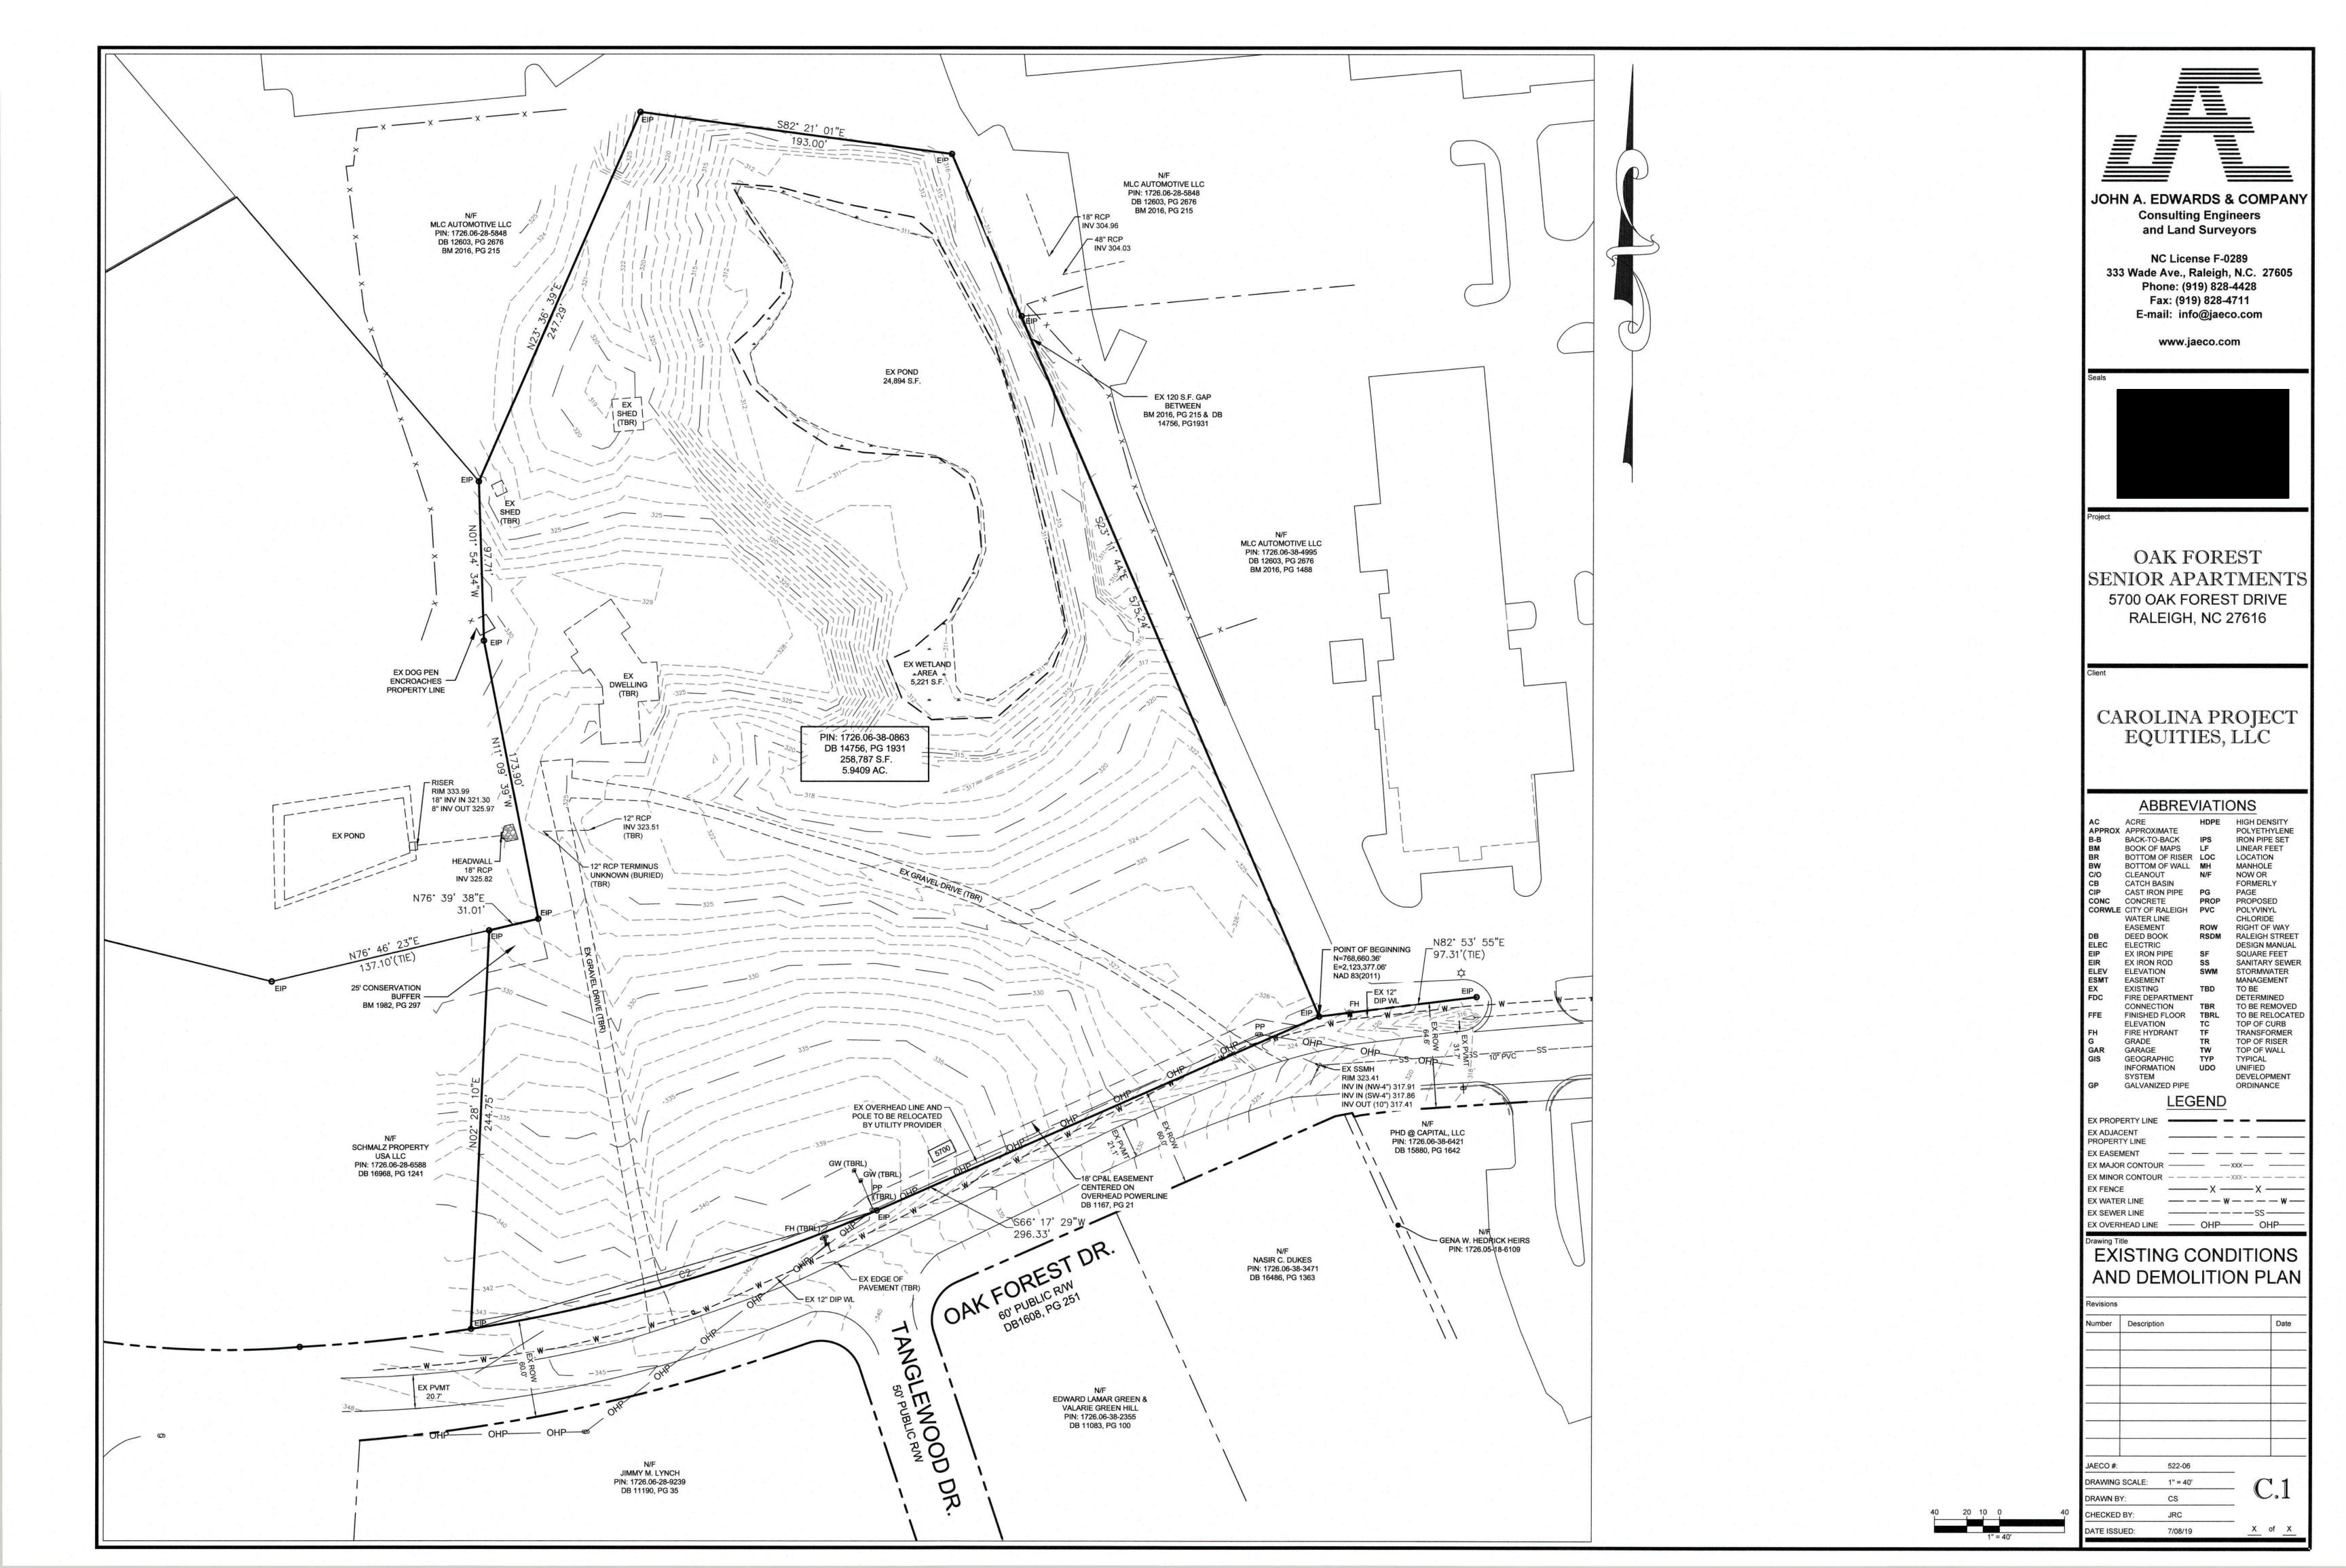
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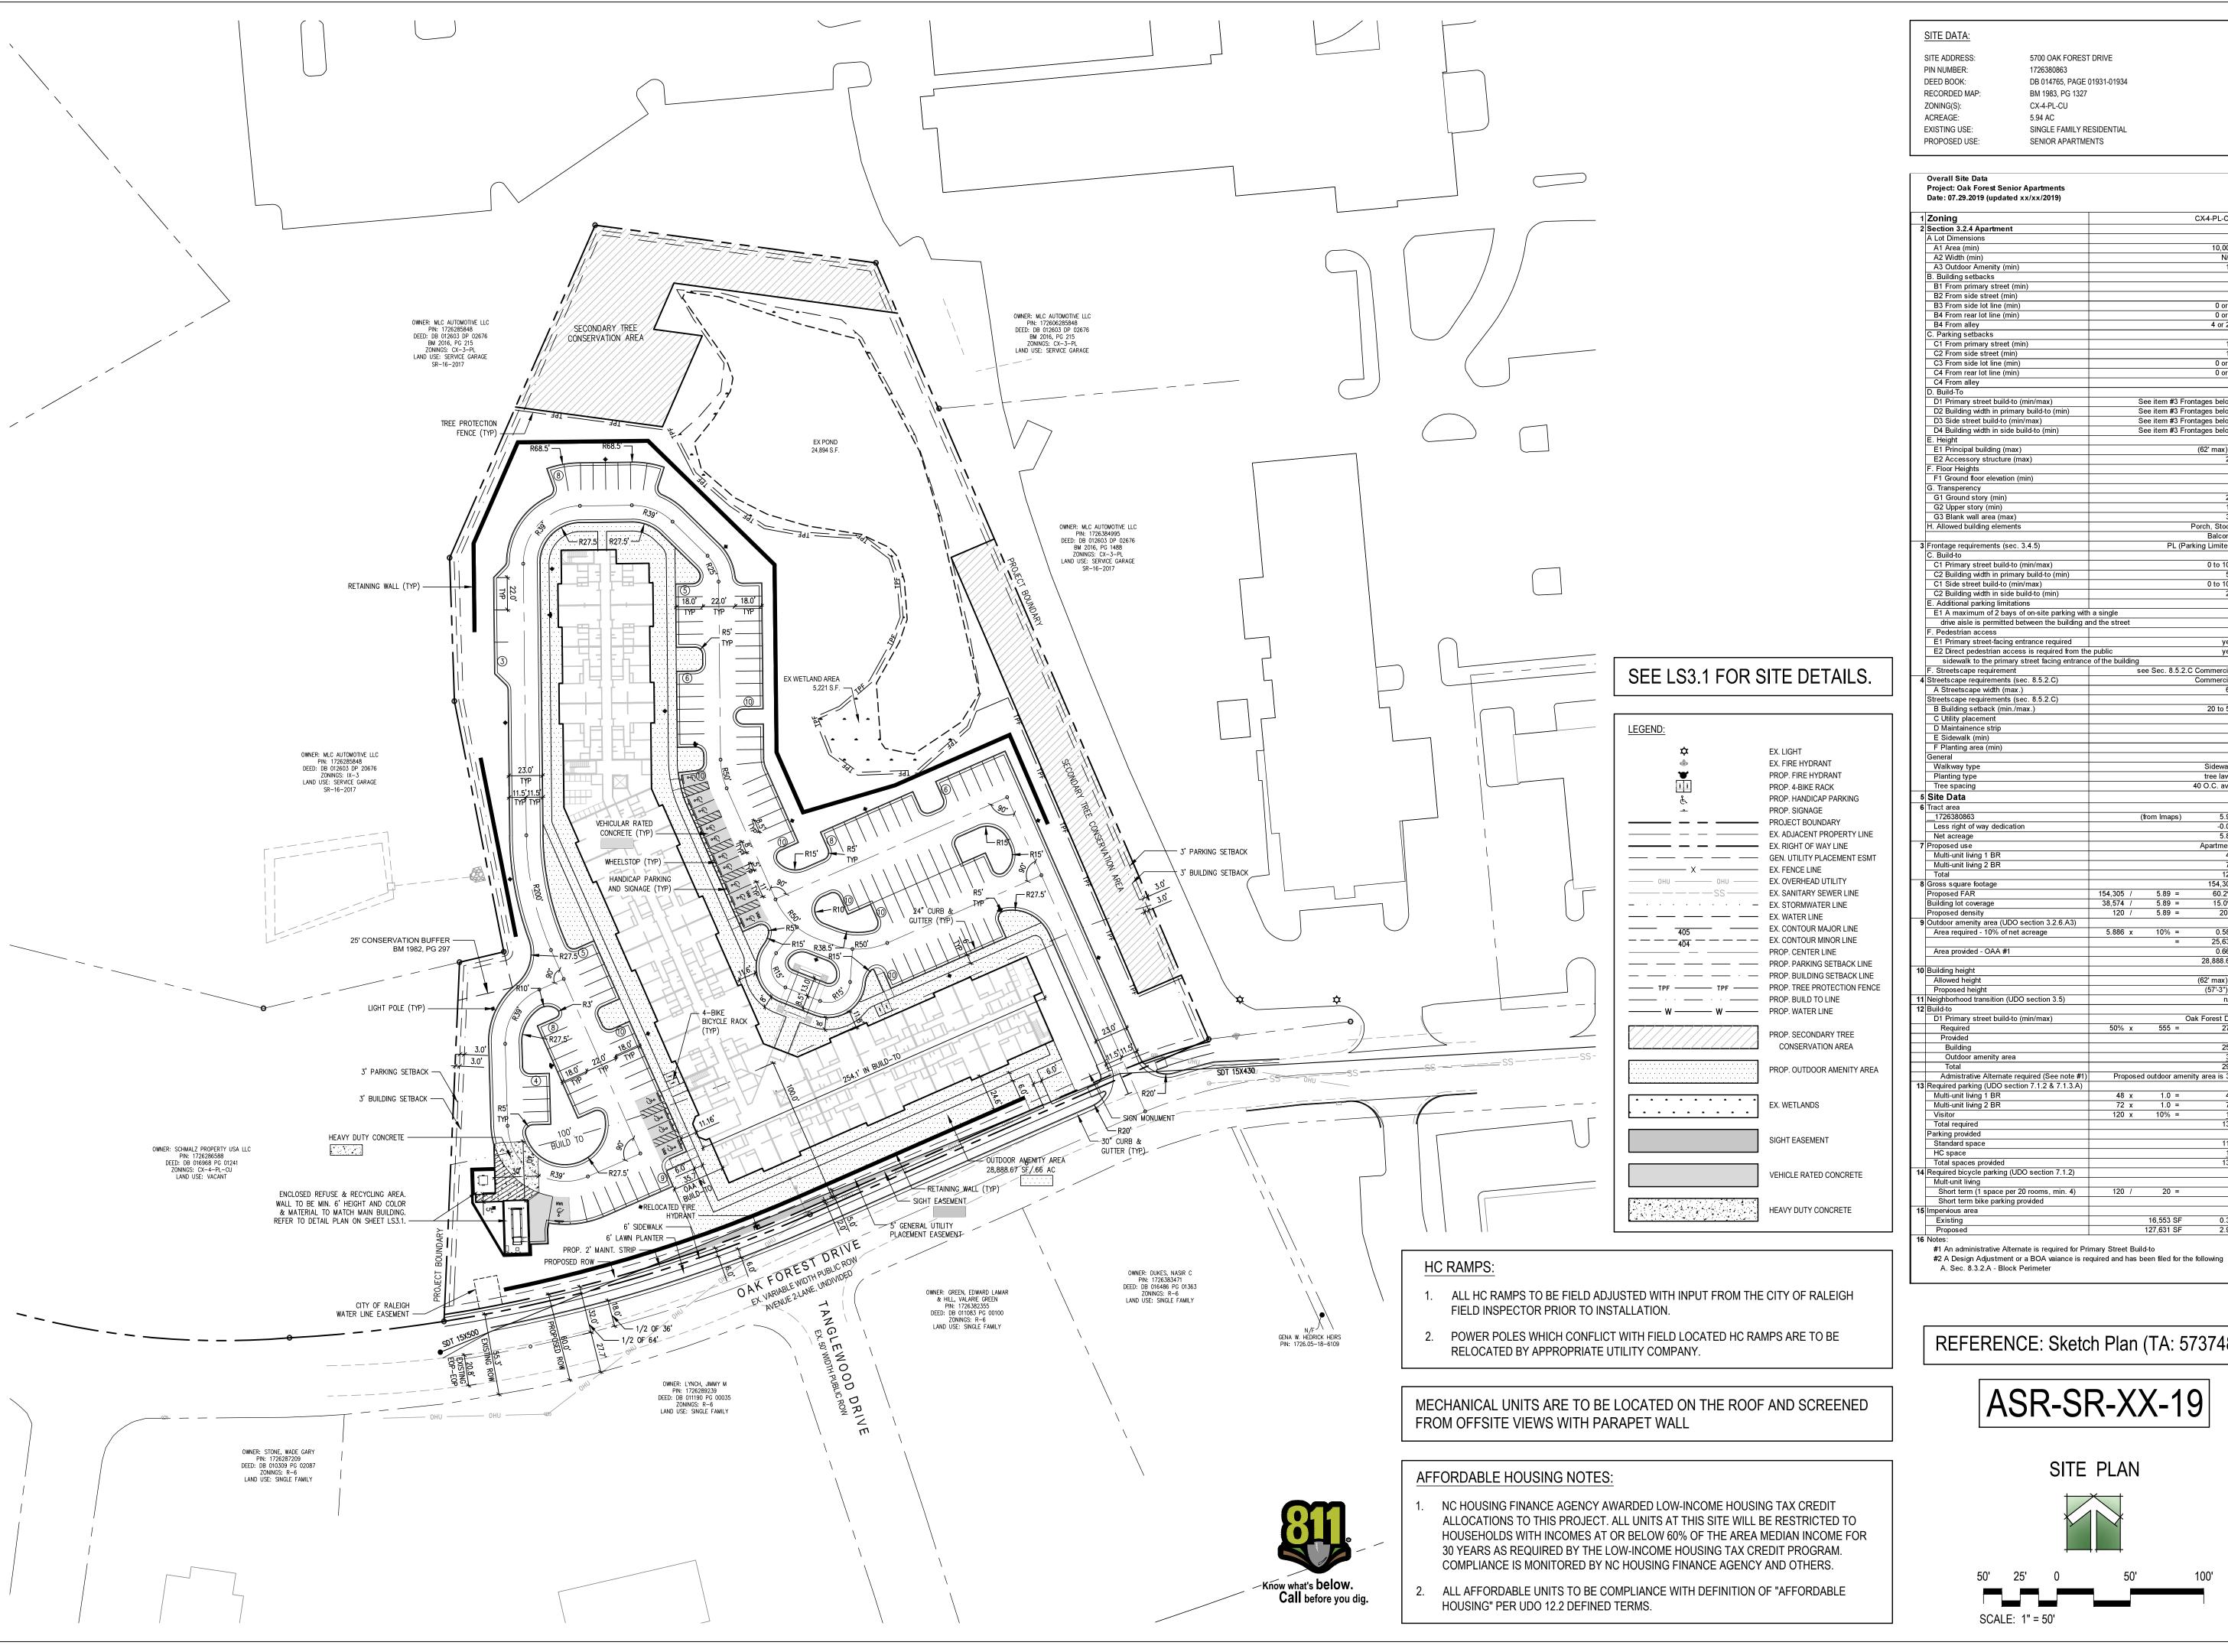
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FOR REVIEW ONLY

DMINS-CONSTRUCTION ISSUE: Adminstrative Site Review 07.30.2019

REVISIONS: DRAWN BY: CHK CHECKED BY: CONTENT: COVER






CX-4-PL-CU 10,000 SF 10 % 4 or 20 FT See item #3 Frontages below See item #3 Frontages below
See item #3 Frontages below PL (Parking Limited) 0 to 100 FT 50 % 0 to 100 FT 25 % E1 A maximum of 2 bays of on-site parking with a single drive aisle is permitted between the building and the stree sidewalk to the primary street facing entrance of the building Sidewalk 120 DU 154,305 SF 5.89 = 5.89 = 5.89 = 0.589 AC 25,638 SF 0.663 AC 28,888.67 SF (62' max) 4 Story (57'-3") 4 Story 278 LF 50% x 555 = Proposed outdoor amenity area is 36 LF 16.553 SF 0.38 AC


REFERENCE: Sketch Plan (TA: 573748)

127,631 SF

2.93 AC

ASR-SR-XX-19

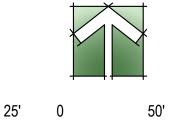

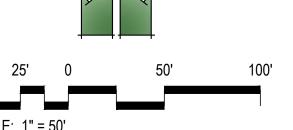


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partments Senior Project Equities, I Forest Ser ore **Oak** 1 5700 C Raleigh,

FOR REVIEW ONLY NOT FOR CONSTRUCTION

PROJECT: JAE-18043 PROJECT DATE ISSUE: Administrative Site Review 07.30.2019 REVISIONS: DRAWN BY: CHK CHECKED BY: CONTENT: SITE PLAN LS1.1

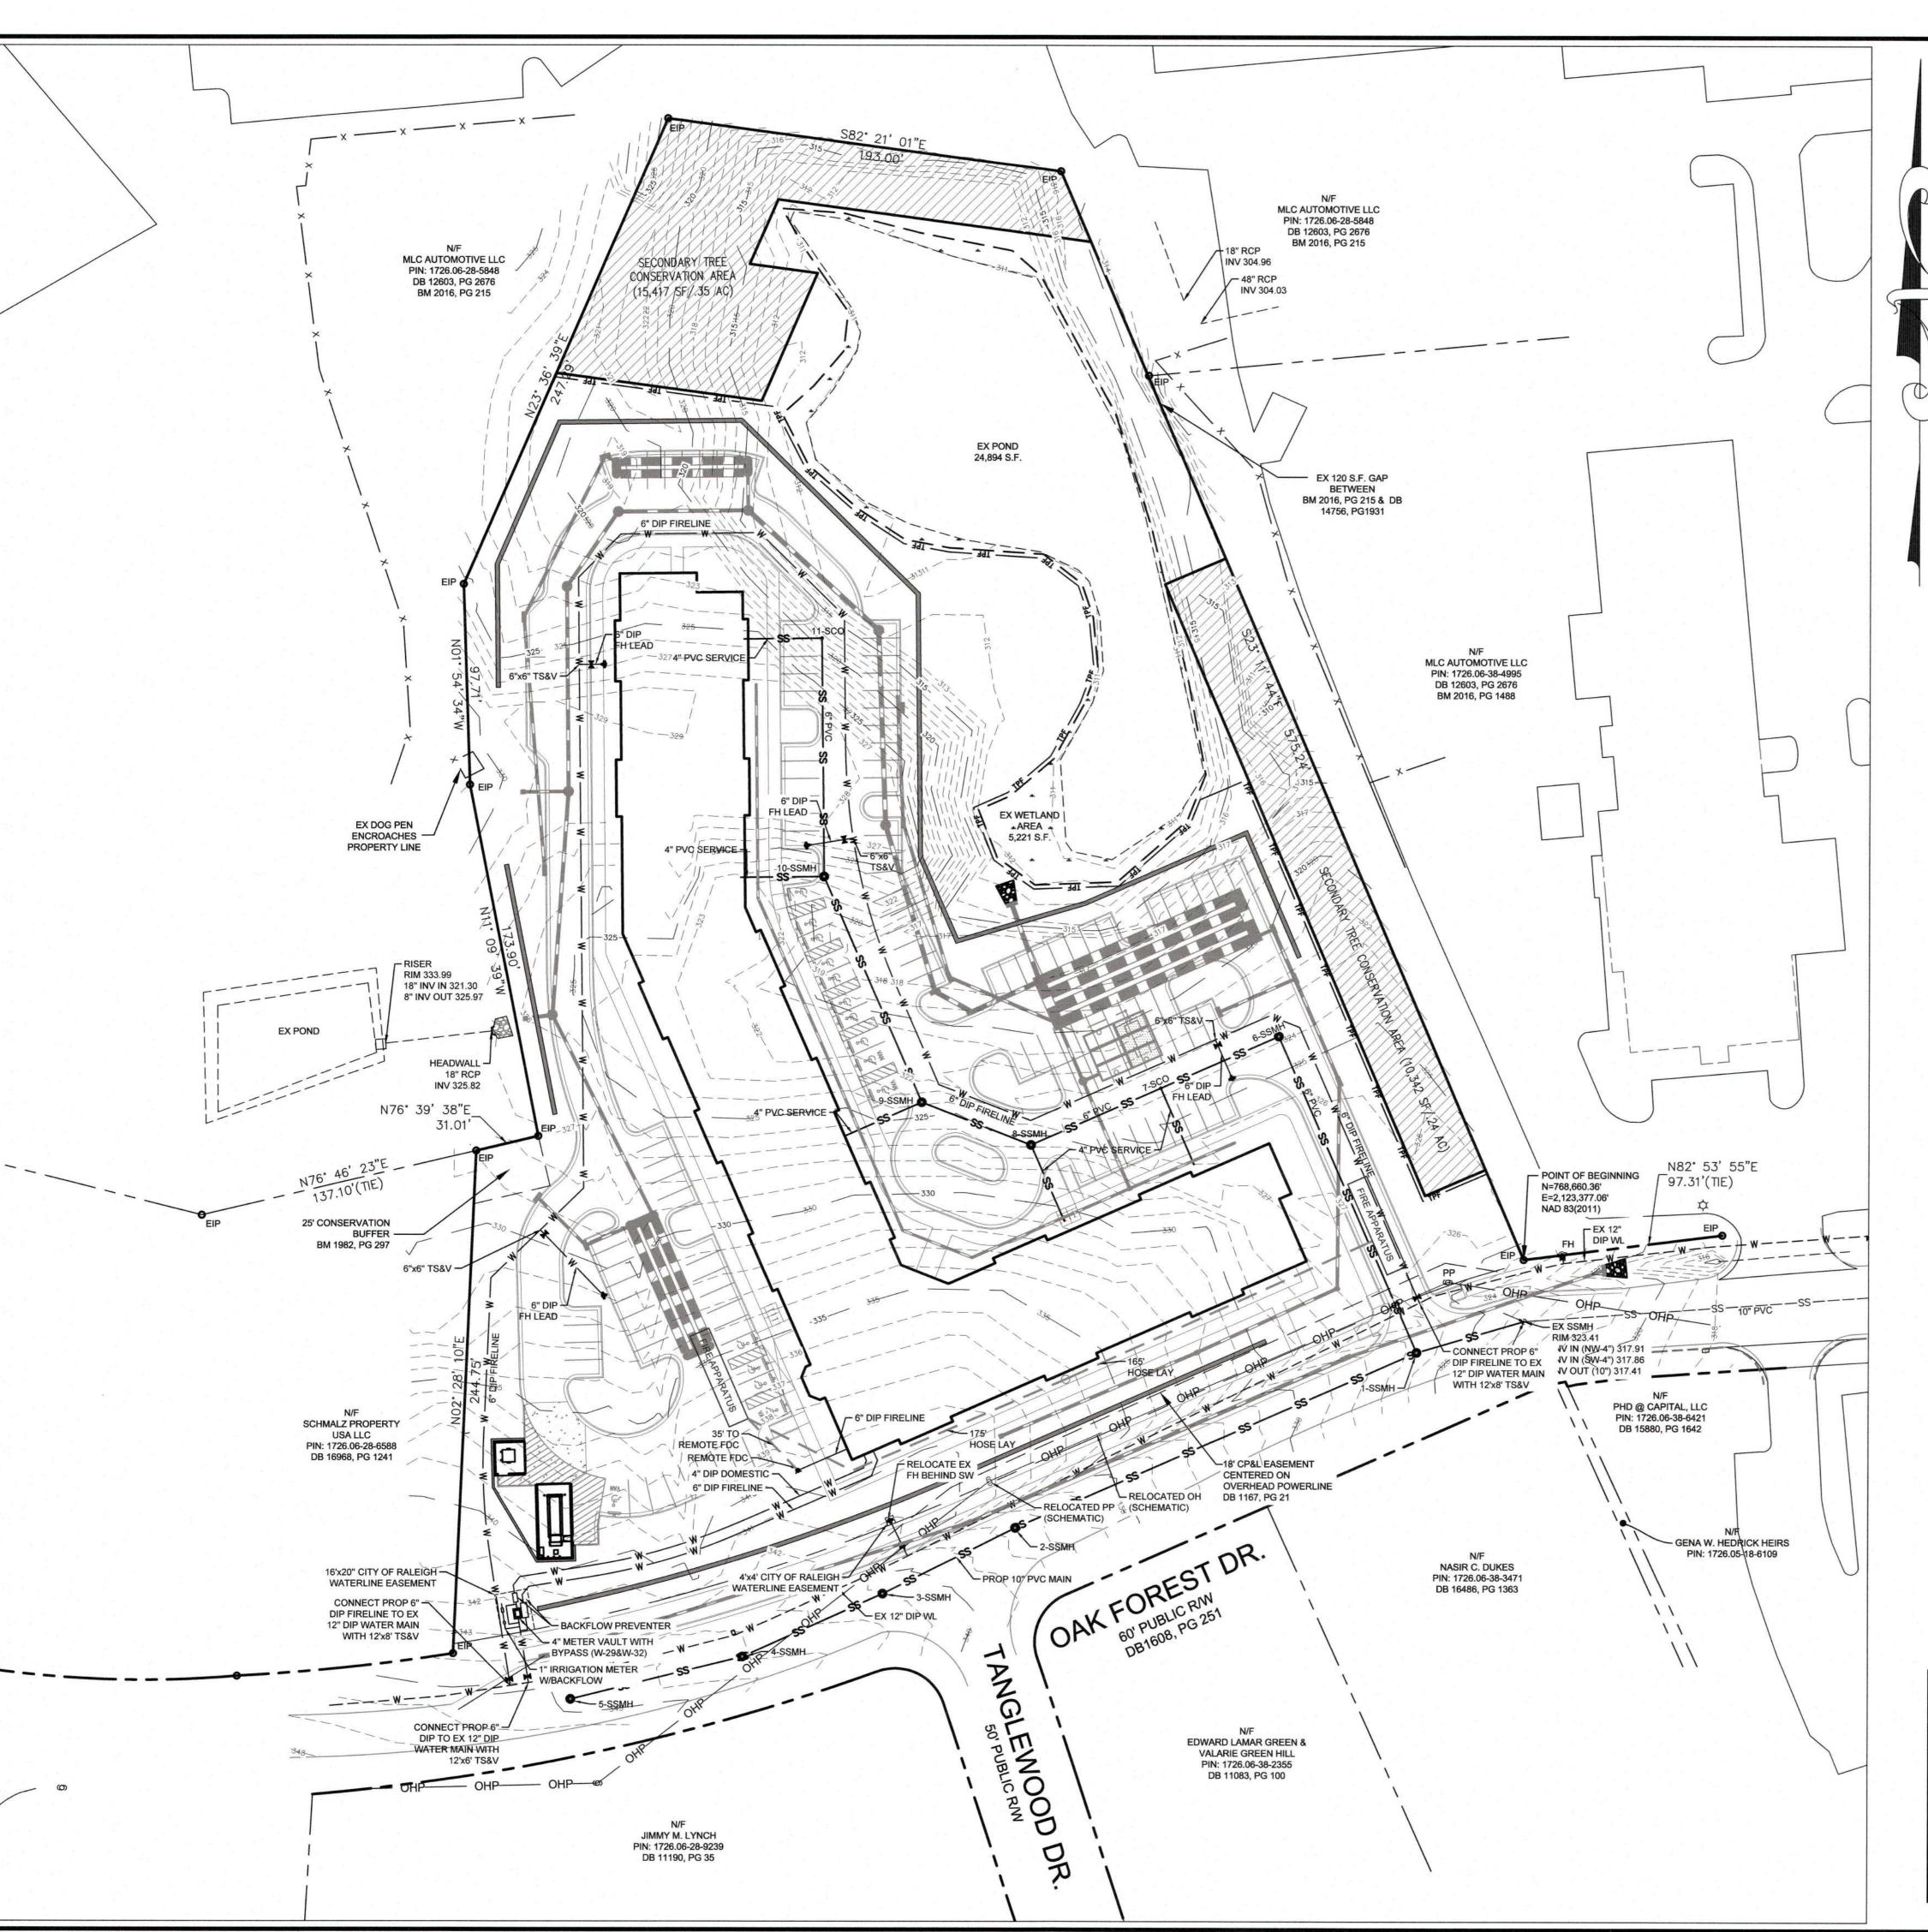

GENERAL NOTES

- 1. CONTRACTOR TO FIELD VERIFY LOCATION & ELEVATION OF ALL EXISTING UTILITIES PRIOR TO
- 2. UTILITY CONSTRUCTION SHALL BE IN ACCORDANCE WITH CITY OF RALEIGH AND / OR NCDOT STANDARDS AND SPECIFICATIONS UNLESS OTHERWISE NOTED.
- 3. UTILITY POLE AND LINE TO BE RELOCATED BY UTILITY PROVIDER. SCHEMATIC LOCATIONS SHOWN, FINAL DESIGN LOCATIONS AND IMPACTS TO BE DETERMINED BY UTILITY PROVIDER.


- STANDARD UTILITY NOTES (as applicable):
 1. All materials & construction methods shall be in accordance with City of Raleigh design standards, details & specifications (reference: CORPUD Handbook, current edition)
- 2. Utility separation requirements: a) A distance of 100' shall be maintained between sanitary sewer & any private or public water supply source such as an impounded reservoir used as a source of drinking water. If adequate lateral separation cannot be achieved,
- ferrous sanitary sewer pipe shall be specified & installed to waterline specifications. However, the minimum separation shall not be less than 25' from a private well or 50' from a public well b) When installing water &/or sewer mains, the horizontal separation between utilities shall be 10'. If this separation cannot be maintained due to existing conditions, the variation
- allowed is the water main in a separate trench with the elevation of the water main at least 18" above the top of the sewer & must be approved by the Public Utilities Director.
- All distances are measured from outside diameter to outside diameter
- c) Where it is impossible to obtain proper separation, or anytime a sanitary sewer passes over a watermain, DIP materials or steel encasement extended 10' on each side of crossing must be specified & installed to waterline
- d) 5.0' minimum horizontal separation is required between all sanitary sewer & storm sewer
- facilities, unless DIP material is specified for sanitary sewer
- e) Maintain 18" min. vertical separation at all watermain & RCP storm drain crossings; maintain 24" min. vertical separation at all sanitary sewer & RCP storm drain crossings. Where adequate separations cannot be achieved, specify DIP materials & a concrete cradle having 6" min. clearance (per CORPUD details W-41 & S-49) f) All other underground utilities shall cross water & sewer facilities with 18" min. vertical separation required
- 3. Any necessary field revisions are subject to review & approval of an amended plan &/or profile by the City of Raleigh Public Utilities Department prior to construction 4. Contractor shall maintain continuous water & sewer service to existing residences & businesses throughout construction
- of project. Any necessary service interruptions shall be preceded by a 24
- hour advance notice to the City of Raleigh Public Utilities Department 5. 3.0' minimum cover is required on all water mains & sewer forcemains. 4.0' minimum cover is required on all reuse
- 6. It is the developer's responsibility to abandon or remove existing water & sewer services not being used in redevelopment of a site unless otherwise directed by the City of Raleigh Public Utilities
- Department. This includes abandoning tap at main & removal of service from ROW or easement per CORPUD Handbook procedure 7. Install 3/4" copper* water services with meters located at ROW or within a 2'x2' Waterline Easement immediately
- adjacent. NOTE: it is the applicant's responsibility to properly size the water service for each connection to provide 8. Install 4" PVC* sewer services @ 1.0% minimum grade with cleanouts located at ROW or easement line & spaced
- every 75 linear feet maximum Pressure reducing valves are required on all water services exceeding 80 psi; backwater valves are required on all sanitary sewer services having building drains lower than 1.0' above the next
- upstream manhole 10. All environmental permits applicable to the project must be obtained from NCDWQ, USACE
- &/or FEMA for any riparian buffer, wetland &/or floodplain impacts (respectively) prior to construction.
- 11. NCDOT / Railroad Encroachment Agreements are required for any utility work (including main extensions & service taps) within state or railroad ROW prior to construction
- 12. Grease Interceptor / Oil Water Separator sizing calculations & installation specifications shall be approved by the CORPUD FOG Program Coordinator prior to issuance of a Building Permit. Contact Tim Beasley at
- (919) 996-2334 or timothy.beasley@raleighnc.gov for more information 13. Cross-connection control protection devices are required based on degree of health hazard involved as listed in
- Appendix-B of the Rules Governing Public Water Systems in North Carolina. These guidelines are the minimum requirements. The devices shall meet American Society of
- Sanitary Engineering (ASSE) standards or be on the University of Southern California approval list. The devices shall be installed and tested (both initial and periodic testing thereafter) in
- accordance with the manufacturer's recommendations or the local cross-connection control program, whichever is more stringent. Contact Joanie Hartley at (919) 996-5923 or
- joanie.hartley@raleighnc.gov for more information



JOHN A. EDWARDS & COMPANY **Consulting Engineers** and Land Surveyors

NC License F-0289 333 Wade Ave., Raleigh, N.C. 27605 Phone: (919) 828-4428 Fax: (919) 828-4711 E-mail: info@jaeco.com

www.jaeco.com

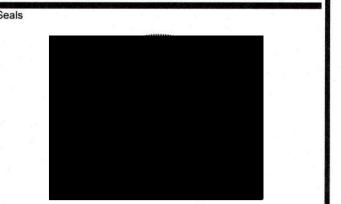

OAK FOREST SENIOR APARTMENTS 5700 OAK FOREST DRIVE RALEIGH, NC 27616

CAROLINA PROJECT EQUITIES, LLC

ABBREVIATIONS ACRE HIGH DENSITY APPROX APPROXIMATE POLYETHYLENE B-B BACK-TO-BACK IPS IRON PIPE SET

вм	BOOK OF MAPS	LF	LINEAR FEET
BR	BOTTOM OF RISER	LOC	LOCATION
BW	BOTTOM OF WALL	MH	MANHOLE
C/O	CLEANOUT	N/F	NOW OR
CB	CATCH BASIN		FORMERLY
CIP	CAST IRON PIPE	PG	PAGE
CONC	CONCRETE	PROP	PROPOSED
CORWLE	CITY OF RALEIGH	PVC	POLYVINYL
	WATER LINE		CHLORIDE
To the state of th	EASEMENT	ROW	RIGHT OF WAY
DB	DEED BOOK	RSDM	RALEIGH STREET
ELEC	ELECTRIC		DESIGN MANUAL
EIP	EX IRON PIPE	SF	SQUARE FEET
EIR	EX IRON ROD	SS	SANITARY SEWER
ELEV	ELEVATION	SWM	STORMWATER
ESMT	EASEMENT		MANAGEMENT
EX	EXISTING	TBD	TO BE
FDC	FIRE DEPARTMENT		DETERMINED
	CONNECTION	TBR	TO BE REMOVED
FFE	FINISHED FLOOR	TBRL	TO BE RELOCATED
	ELEVATION	TC	TOP OF CURB
FH	FIRE HYDRANT	TF	TRANSFORMER
G	GRADE	TR	TOP OF RISER
GAR	GARAGE	TW	TOP OF WALL
GIS	GEOGRAPHIC	TYP	TYPICAL
	INFORMATION	UDO	UNIFIED
	SYSTEM		DEVELOPMENT
GP	GALVANIZED PIPE		ORDINANCE
	LEG	END	

LEGEND

	PROP WATER LINE	
	PROP SEWER LINE	
	EX WATER LINE	
- 1	EX SEWER LINE	SS
	and the second	

HECKED BY: DATE ISSUED:

UTILITY PLAN


Revisions				
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DRAWING S	SCALE:	1" = 40'	(7)
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ATTENTION CONTRACTORS:

The Construction Contractor responsible for the extension of water, sewer, and/or reuse, as approved in these plans, is responsible for contacting the PUBLIC WORKS DEPARTMENT at (919) 996-2409. and the PUBLIC UTILITIES DEPARTMENT at (919)996-4540 at least twenty four hours prior to beginning any of their construction.

FAILURE to notify both City Departments in advance of beginning construction, will result in the issuance of monetary fines, and require reinstallation of any water or sewer facilities not inspected as a result of this notification failure.

FAILURE to call for Inspection, Install a Downstream Plug, have Permitted Plans on the jobsite, or any other Violation of CITY OF RALEIGH STANDARDS will result in a Fine and Possible Exclusion from future work in the CITY OF RALEIGH.

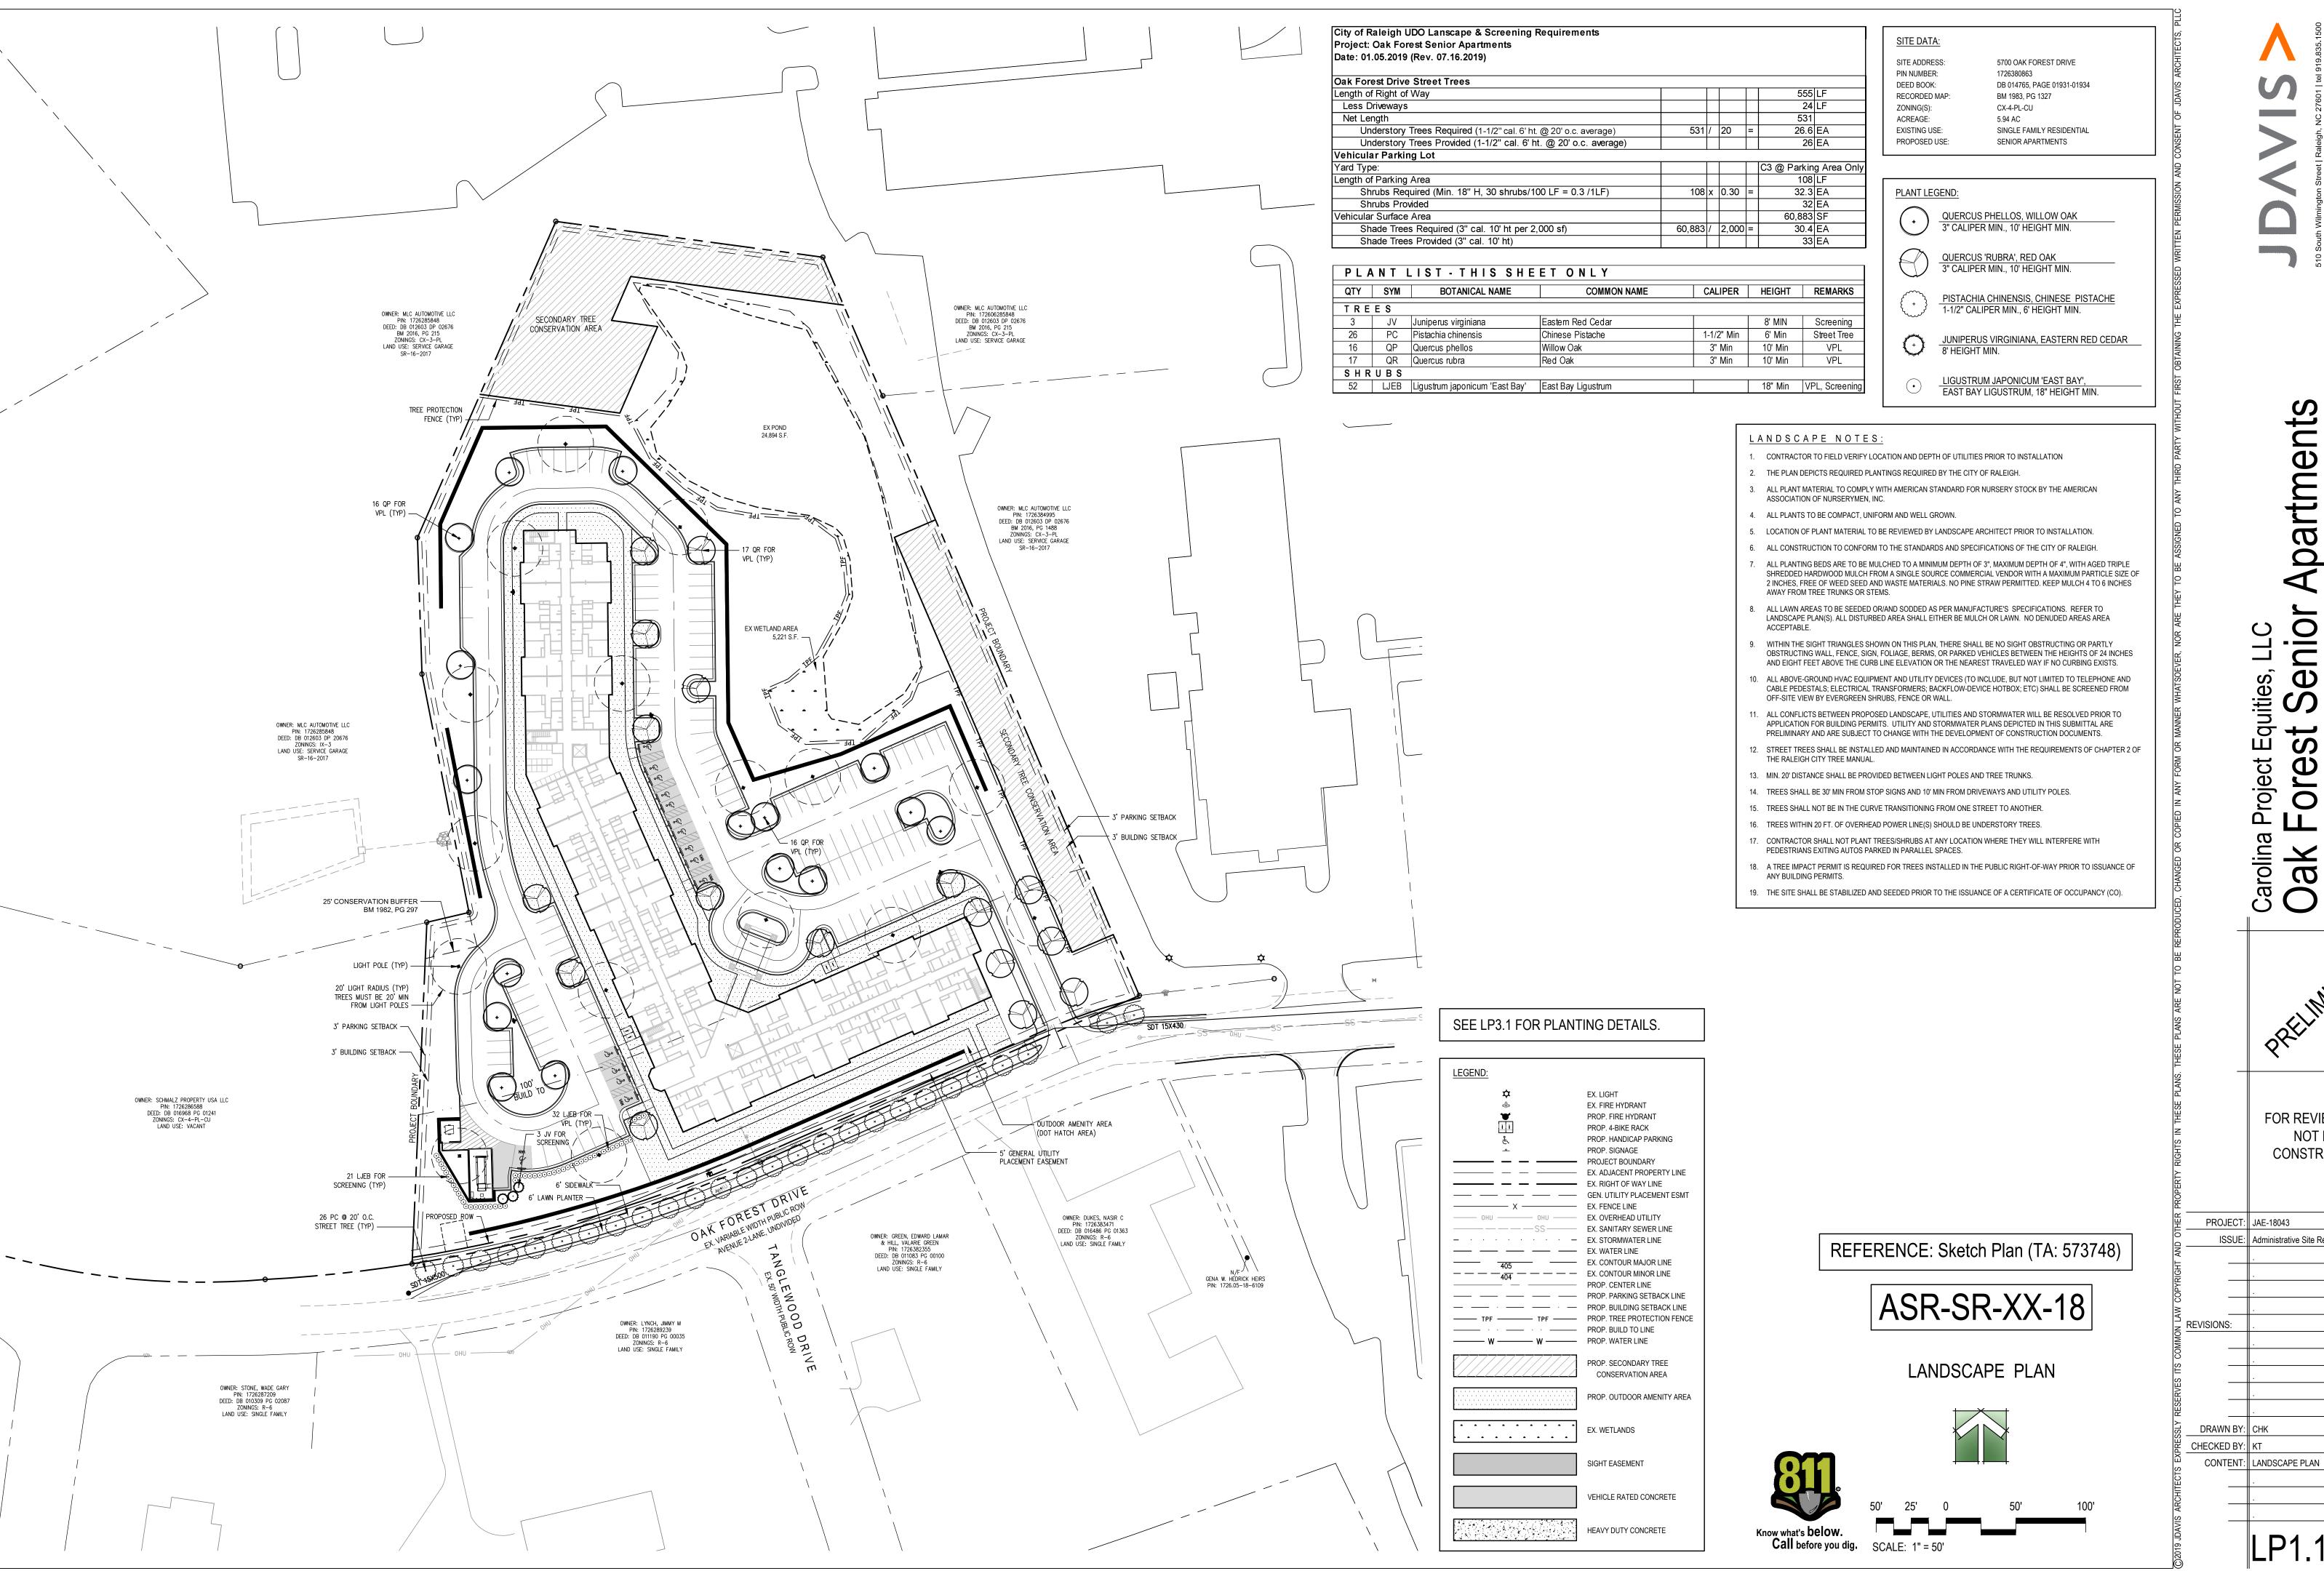


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FOR REVIEW ONLY NOT FOR CONSTRUCTION

PROJECT DATE ISSUE: Administrative Site Review 07.30.2019

ore **Oak** 5700 C Raleigh,



BO architecture P.C.

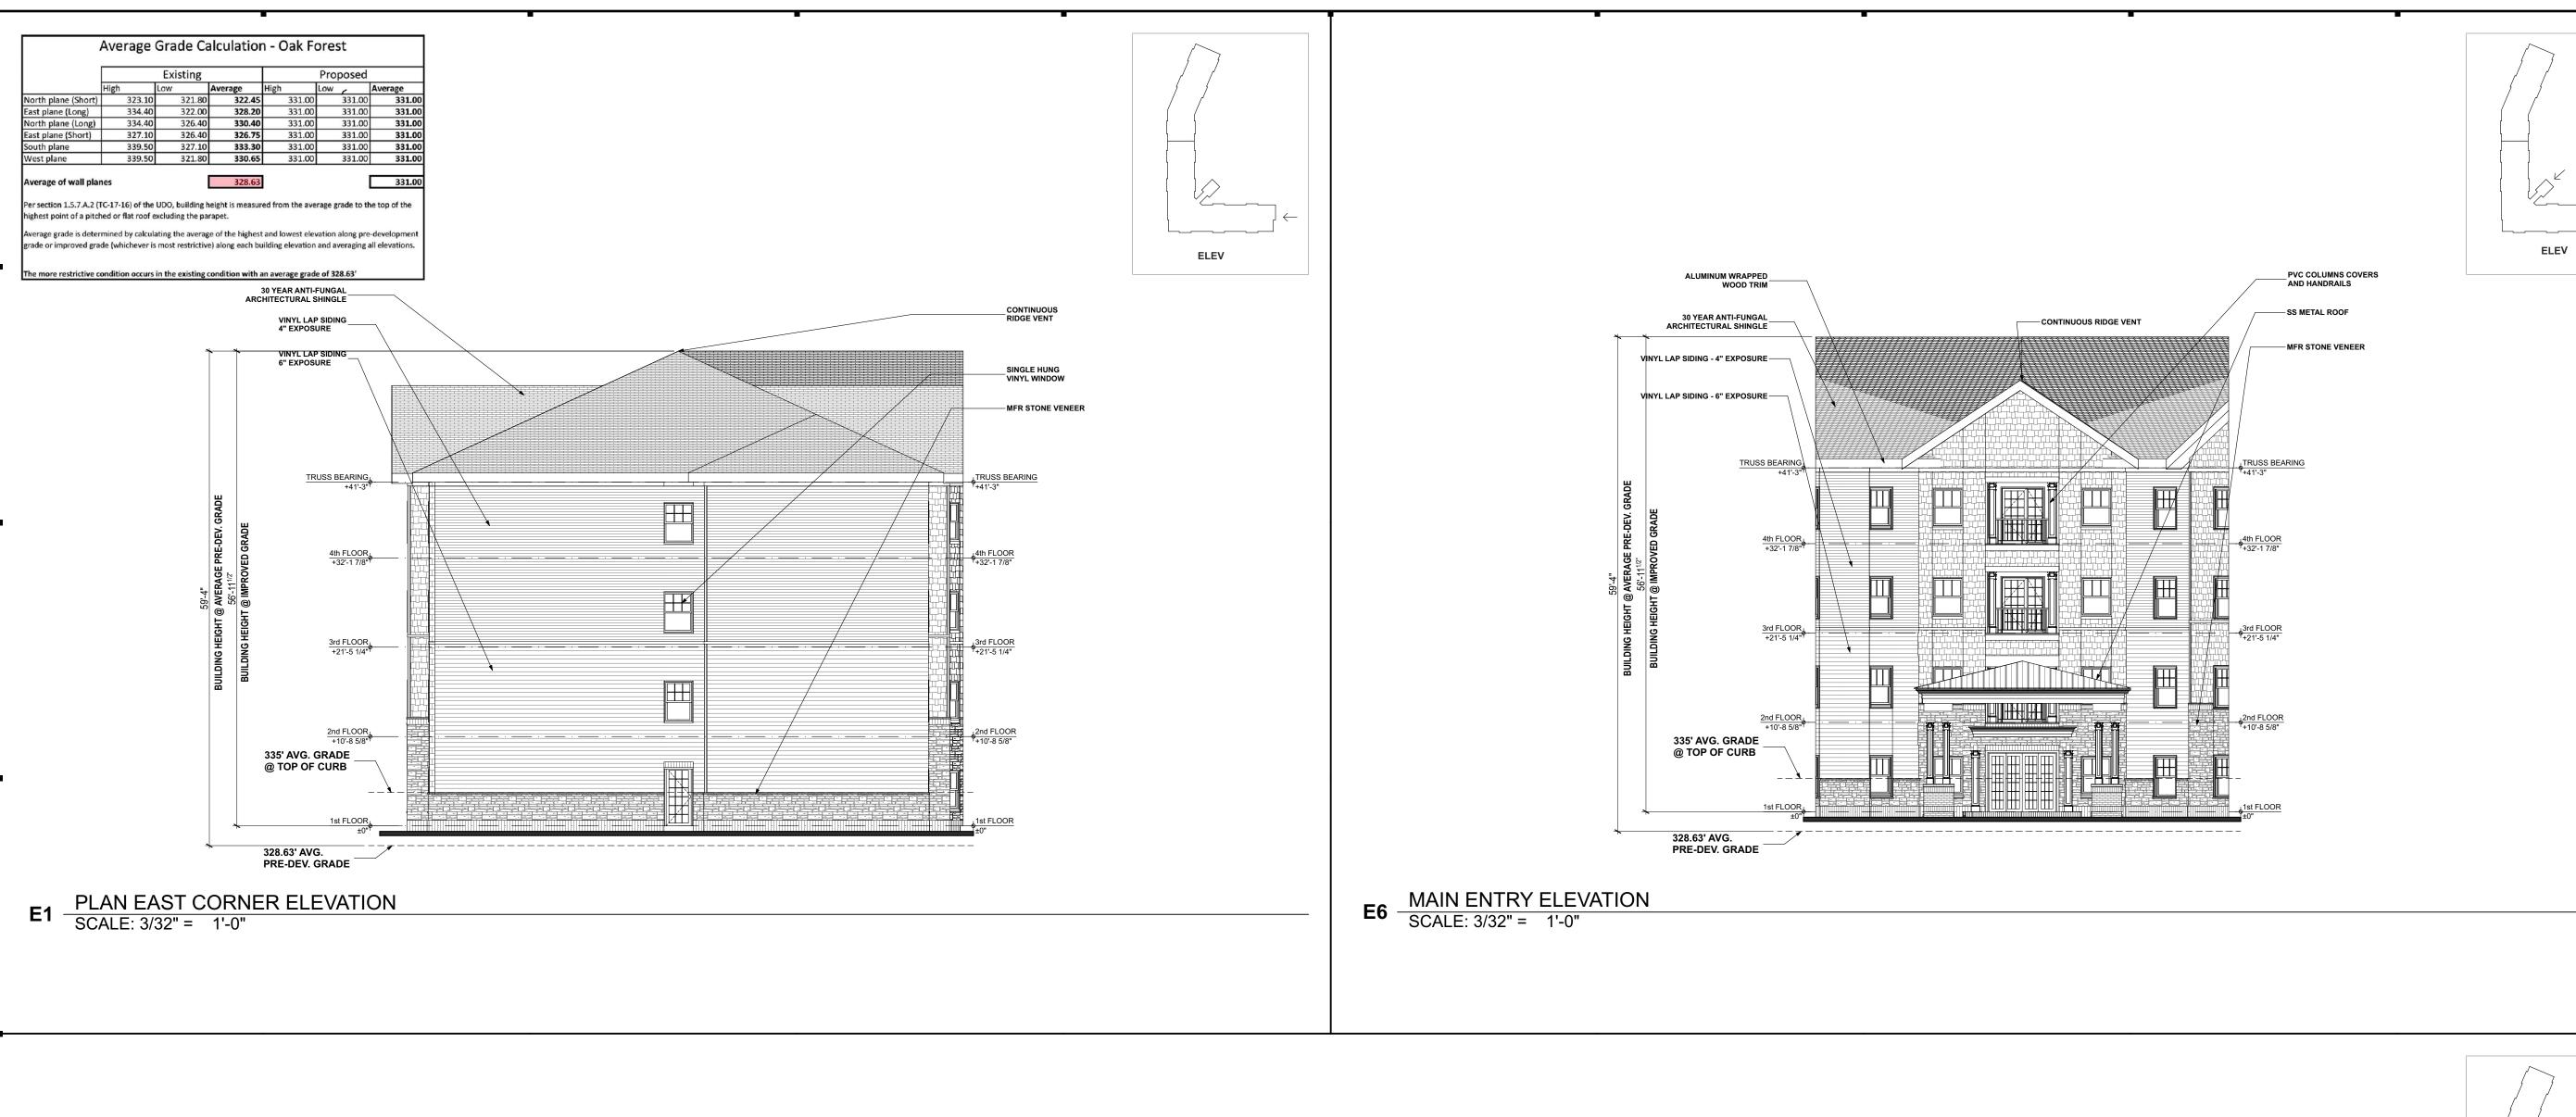CSBO architecture P.C. 1589 Skeet Club Rd. Suite 102-172 Hight Point, NC 27265

ASR Submittal

CAROLINA PROJECT EQUITIES, LLC

2013 Rolling Rock Rd. Wake Forest, NC 27587

SENIOR APARTMENTS
5700 OAK FOREST DRIVE
RAI FIGH NG 27616

REVISIONS:

©2019 CSBO architecture P.C.

DATE:
07-23-19

PROJECT NUMBER:
190150


SHEET TITLE:
BUILDING ELEVATIONS

CHEET

A3.11





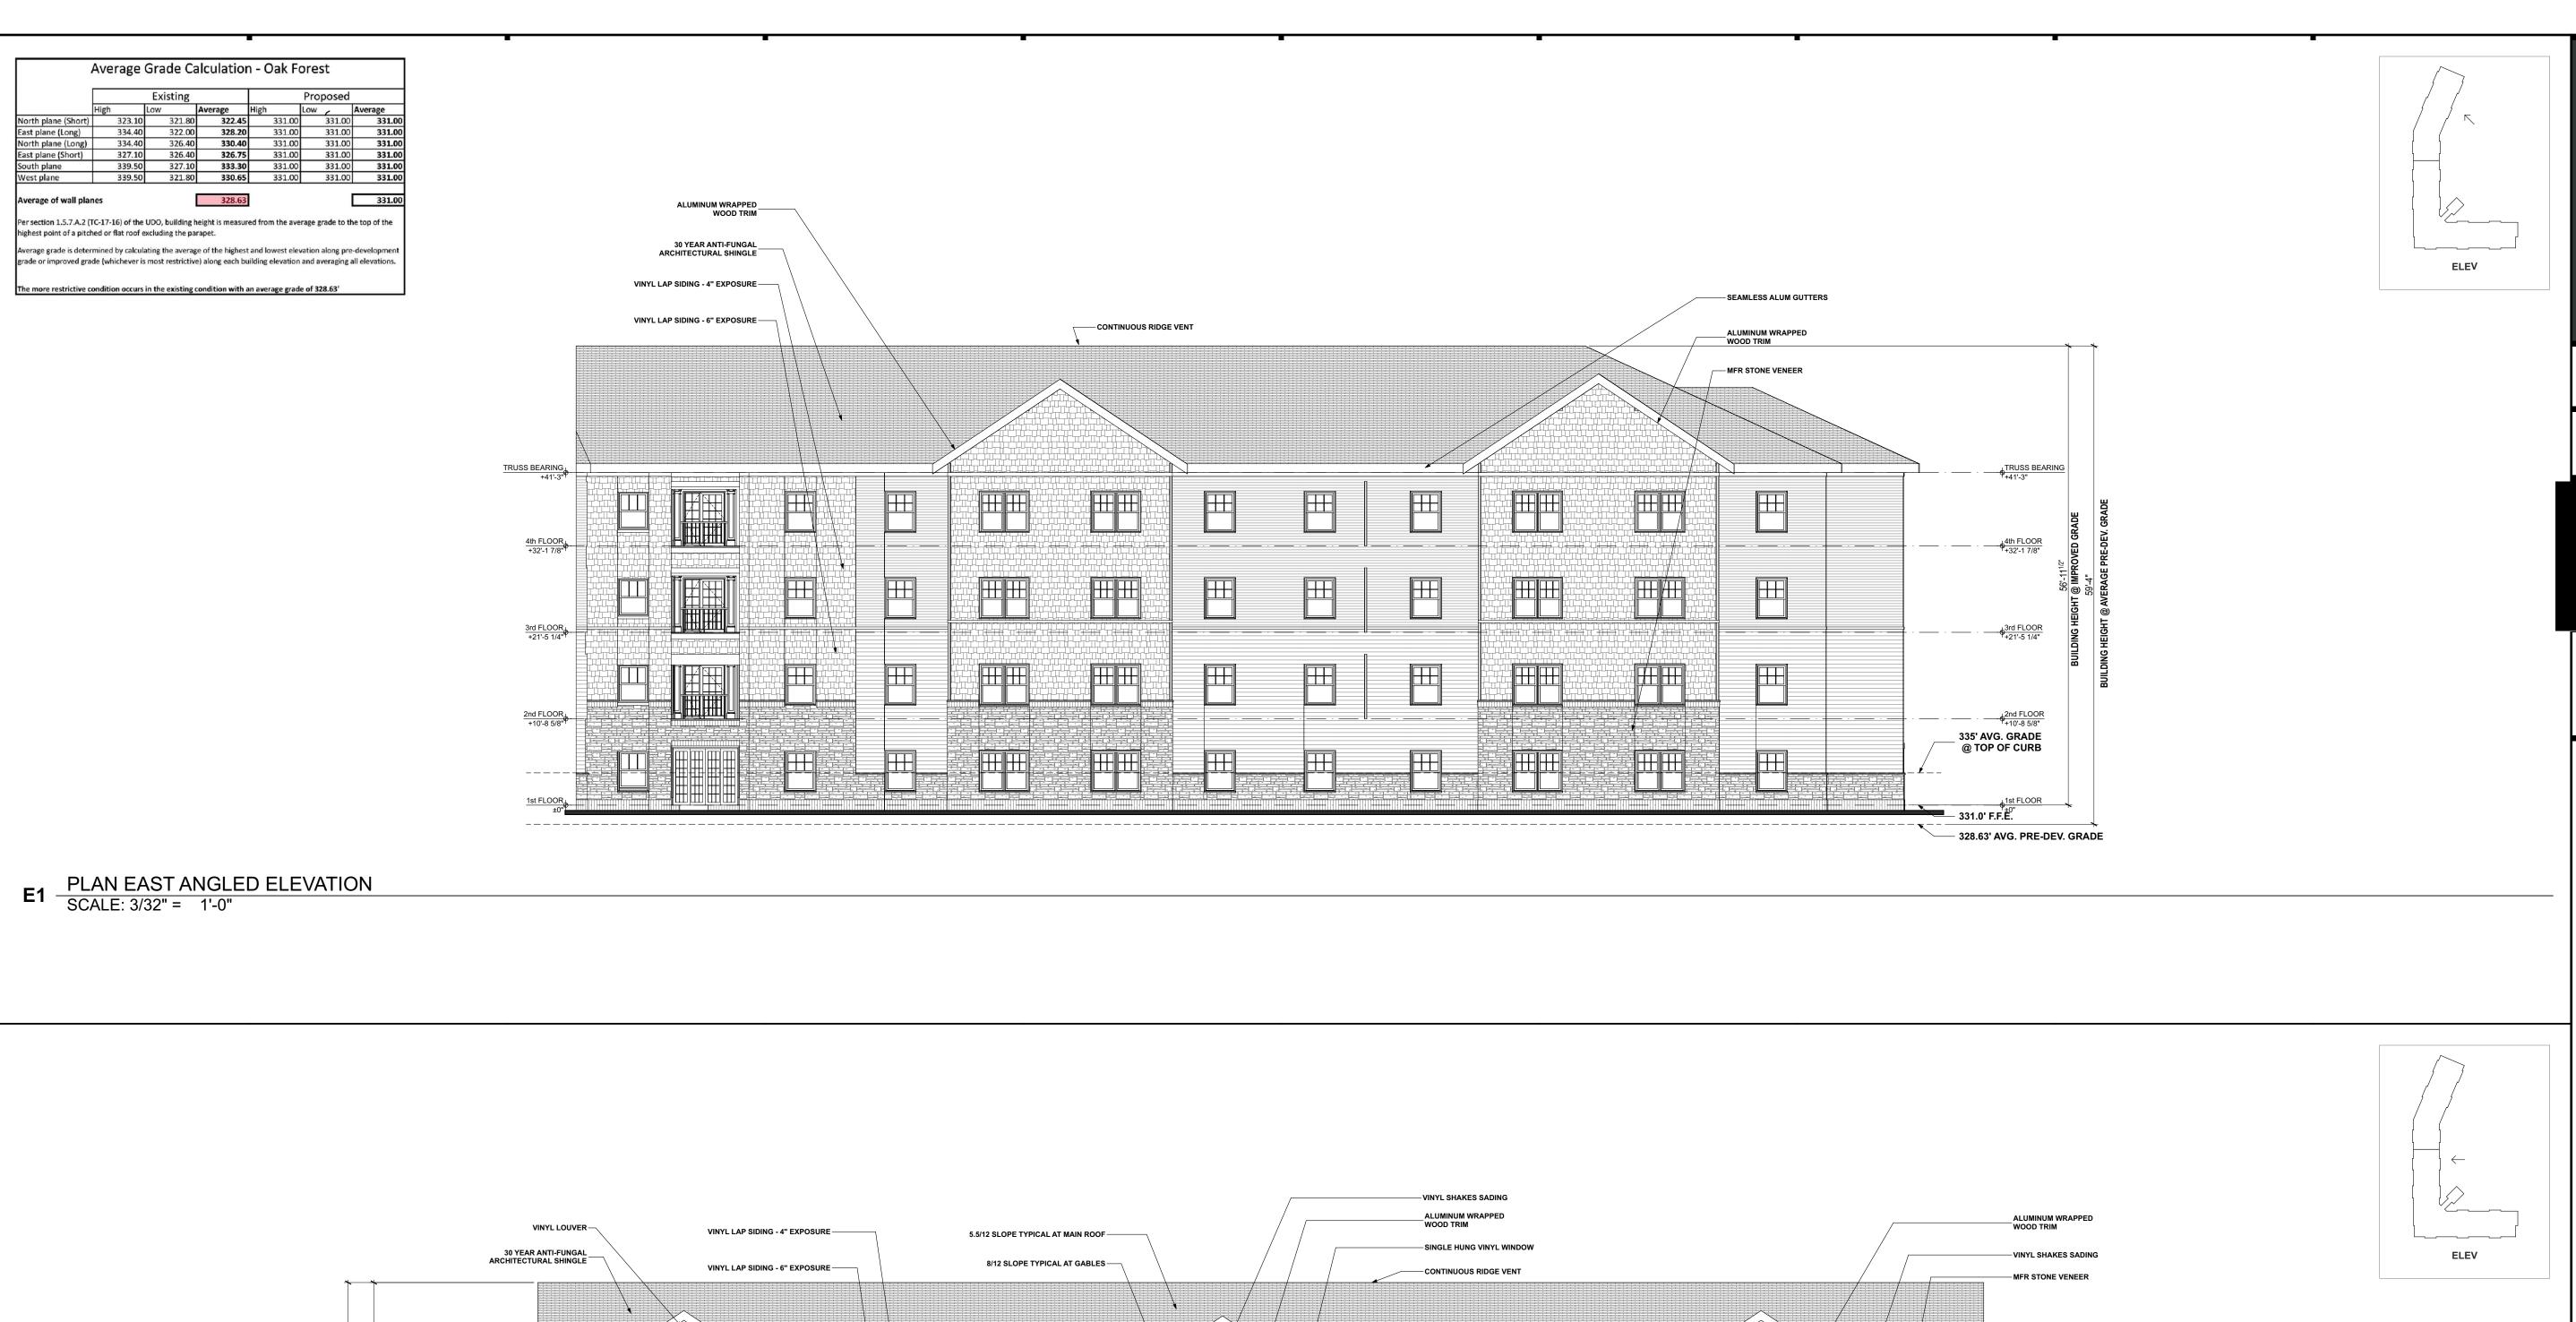



CS+BO architecture P.C.

CSBO architecture P.C. 1589 Skeet Club Rd. Suite 102-172 Hight Point, NC 27265

US:

ASR Submittal

CAROLINA PROJECT EQUITIES, LLC 2013 Rolling Rock Rd

2013 Rolling Rock Rd. Wake Forest, NC 27587

OAK FOREST
NIOR APARTMENTS
5700 OAK FOREST DRIVE
RALEIGH, NC 27616

REVISIONS:

©2019 CSBO architecture P.C.

DATE:
07-23-19

PROJECT NUMBER:
190150

SHEET TITLE:
BUILDING ELEVATIONS

SHEET:


A3.13

A1 PLAN EAST ELEVATION
SCALE: 3/32" = 1'-0"

335' AVG. GRADE @ TOP OF CURB

328.63' AVG. PRE-DEV. GRADE -

	Existing			Proposed		
	High	Low	Average	High	Low _	Average
North plane (Short)	323.10	321.80	322.45	331.00	331.00	331.00
East plane (Long)	334.40	322.00	328.20	331.00	331.00	331.00
North plane (Long)	334.40	326.40	330.40	331.00	331.00	331.00
East plane (Short)	327.10	326.40	326.75	331.00	331.00	331.00
South plane	339.50	327.10	333.30	331.00	331.00	331.00
West plane	339.50	321.80	330.65	331.00	331.00	331.00
Average of wall plan	nes		328.63			331.00
Per section 1.5.7.A.2 (7 highest point of a pitch	and the same of the same			ed from the ave	rage grade to tl	he top of the
Average grade is deter	mined by calcul	ating the averag	ge of the highest	and lowest elev	ation along pre	e-development
				ilding elevation		

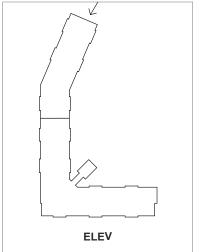

BO architecture P.C.

CSBO architecture P.C. 1589 Skeet Club Rd. Suite 102-172 Hight Point, NC 27265

S: ASR Submittal

CAROLINA PROJECT EQUITIES, LLC

2013 Rolling Rock Rd. Wake Forest, NC 27587

OAK FOREST

STOO OAK FOREST DRIVE

REVISIONS:

ELEV

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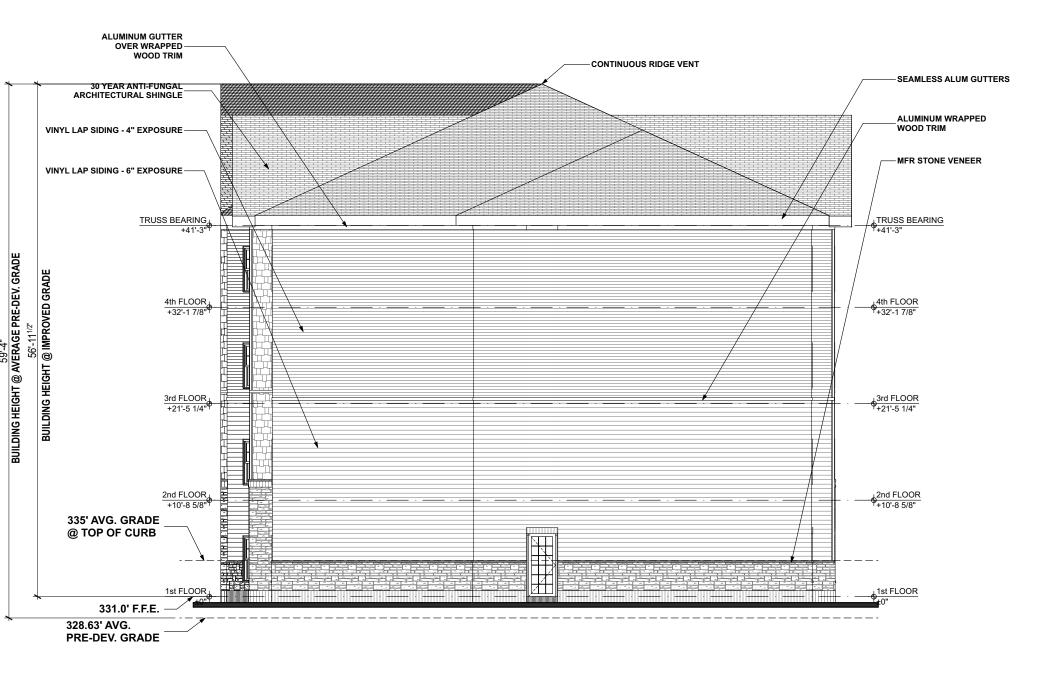
DATE:
07-23-19

PROJECT NUMBER:
190150


SHEET TITLE:
BUILDING ELEVATIONS

PUEET:

A3.14



E6 PLAN NORTH EXTERIOR ELEVATION
SCALE: 3/32" = 1'-0"

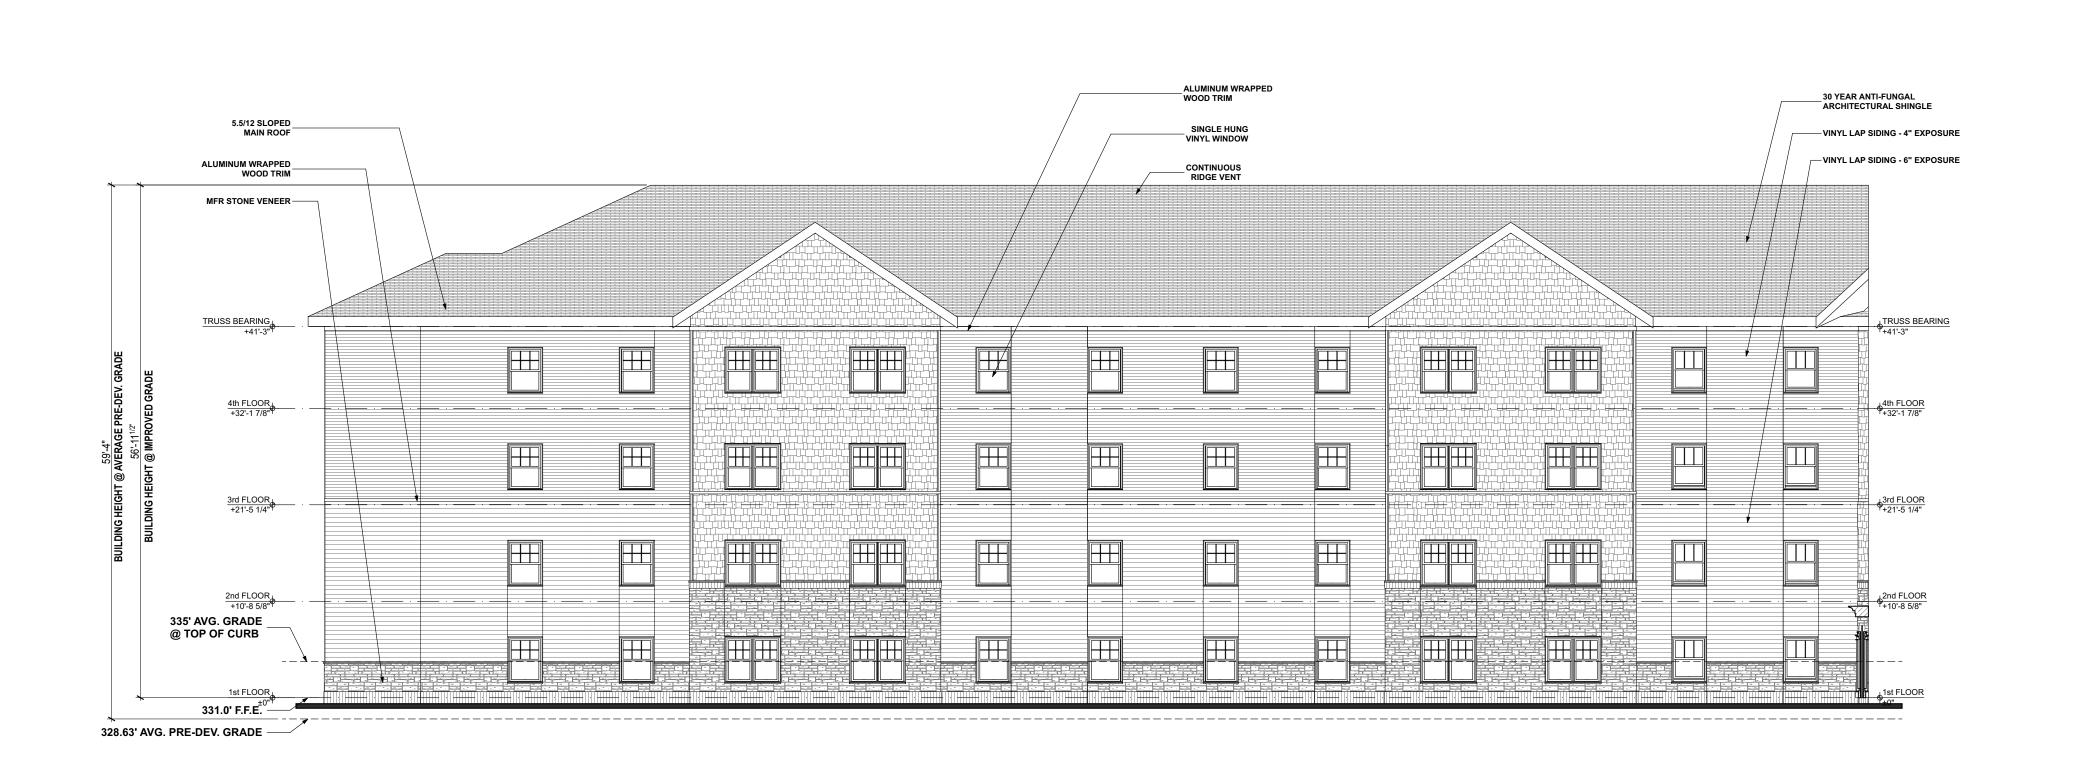

A1 NORTH ELEVATION
SCALE: 3/32" = 1'-0"