

Administrative Approval Action

Case File / Name: ASR-0055-2024 DSLC - NOMAD DEVELOPMENT City of Raleigh
Development Services Department
One Exchange Plaza
Raleigh, NC 27602
(919) 996-2492
currentplanning@raleighnc.gov
www.raleighnc.gov

LOCATION: This 2.36 acre site zoned RX-3 CU (TCZ-5-19) and SHOD-1 is located on

the southeast corner of the intersection of Rock Quarry and Sunnybrook

Roads at 3708 Rock Quarry Road, PIN 1722268336.

REQUEST: This is a proposed cottage court consisting of an existing attached house with two

units (permitted separately- see BLDR-008845-2023), plus 10 tiny house duplexes

(attached houses), a common building, and associated infrastructure.

DESIGN

ADJUSTMENT(S)/

ALTERNATES, ETC: N/A

FINDINGS: City Administration finds that this request, with the below conditions of

approval being met, conforms to the Unified Development Ordinance. This approval is based on a preliminary plan dated December 18, 2024 by The

Site Group.

CONDITIONS OF APPROVAL and NEXT STEPS:

This document must be applied to the second sheet of all future submittals except for final plats. This is a preliminary plan and as such no permits have been issued with this approval. To obtain permits and/or completion of the project, the following steps are required:

☑ <u>SITE PERMITTING REVIEW</u> - For land disturbance of 12,000 square feet or greater, public or private infrastructure, shared stormwater devices, etc. Site Permitting Review may be submitted upon receipt of this signed approval document.

The following items are required prior to approval of Site Permitting Review plans:

General

1. Correction to the Common Building elevation (height) is needed. (Sheet ARCH 1.0) As per code, the common building must be a detached house building type (3.6.1 I 3), with a maximum building height of 30' (3.6.1 H1). Civic building type is not allowable in a mixed use cottage court (see 3.6.1 C)

Stormwater

2. A surety equal to of the cost of clearing, grubbing and reseeding a site, shall be paid to the City (UDO 9.4.4).

Urban Forestry

- 3. Tree protection fence must be inspected by Urban Forestry staff prior to the issuance of a grading permit.
- 4. Submit a final tree conservation plan that includes metes and bounds descriptions of all tree conservation areas and tree protection fencing as required (UDO 9.1.5).



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☑ **RECORDED MAP(S)** - Submit plat to record new property lines, easements, tree conservation areas, etc.). Plats may be submitted for review when the Site Permitting Review plans, if required, have been deemed ready for mylar signature.

The following items must be approved prior to recording the plat:

Public Utilities

1. Site Permit Review plans (SPR) must be approved by the City of Raleigh Public Utilities Department for all public water, public sewer and/or private sewer extensions.

Urban Forestry

2. A tree conservation plat shall be recorded with metes and bounds showing the designated tree conservation areas (UDO 9.1). This development proposes .257 acres of tree conservation area.

☑ <u>BUILDING PERMITS</u> - For buildings and structures shown on the approved plans. Commercial building permit plans must include the signed, approved Site Permitting Review plans attached, if applicable. Permit sets may be reviewed prior to the recordation of required plats, but cannot be approved.

The following items must be approved prior to the issuance of building permits:

General

 Demonstrate compliance with the floor area maximums for each dwelling unit as set forth in UDO Section 3.6.1.

Engineering

 A Traffic Control and Pedestrian (TCPED) Plan must be approved and a right-of-way occupancy permit must be obtained from Right-of-way Services for any construction activities within the right-of-way.

Urban Forestry

- 3. A tree conservation plat shall be recorded with metes and bounds showing the designated tree conservation areas (UDO 9.1).
- 4. Recorded Tree Conservation Areas to be impacted by proposed development will be replaced and recorded prior to issuance of building permits, per UDO 9.1.5.A.2.

The following are required prior to issuance of building occupancy permit:

General



Administrative Approval Action

Case File / Name: ASR-0055-2024 **DSLC - NOMAD DEVELOPMENT**

City of Raleigh **Development Services Department** One Exchange Plaza Raleigh, NC 27602 (919) 996-2492 currentplanning@raleighnc.gov www.raleighnc.gov

Final inspection of all tree conservation areas by Urban Forestry Staff.

Stormwater

2. As-built impervious survey is accepted by the Engineering Services Department prior to final building CO (UDO 9.2).

EXPIRATION DATES: The expiration provisions of UDO Section 10.2.8 E, including the ability to request extensions in the expiration date, apply to this site plan. If significant construction has not taken place on a project after administrative site review approval, that approval may expire and be declared void, requiring re-approval before permits may be issued. To avoid allowing this plan approval to expire the following must take place by the following dates:

3-Year Expiration Date: January 23, 2028

Obtain a valid building permit for the total area of the project, or a phase of the project.

4-Year Completion Date:

Within four years after issuance of the first building permit for the site plan, the construction of the entire site plan must be completed unless an applicant has been granted vested rights. Failure to complete construction within this specified time frame shall automatically void the approved site plan for which no building permits have been issued.

I hereby cer	rtify this administrative decision.		
Signed:	Keegan McDonald	_ Date:	01/23/2025
	Development Services Dir/Designee	_	
Staff Coord	dinator: Michael Walters		

NOMAD DEVELOPMENT

Administrative Site Review Application



This form is required when submitting site plans as referenced in Unified Development Ordinance (UDO) Section 10.2.8. Please check the appropriate building types and include the plan checklist document when submitting.

Please review UDO Section 10.2.8. to determine the site plan tier. If assistance determining a Site Plan Tier is needed a Site Plan Tier Verification request can be submitted online via the Permit and Development Portal. (Note: There is a fee for this verification service.)

Site Plan Tier: Tier Two Site Plan ✓	Tier Three	Site Plan		
Building and Development Type (Check all that apply)		Site Transaction History		
Detached Attached Townhouse Apartment ✓ Tiny house Open lot General Mixed use ✓ Civic ✓ Cottage Cod Frequent Tropovelopment	ansit	Scoping/s Certificate Board of A Zoning Ca	keto of <i>i</i> Adju ase	ase #: ch plan case #: Appropriateness #: stment #: #: ate #:
	GENERAL IN	FORMATION	NC	
Development name: NOMAD DEVELOP	MENT			
Inside City limits? Yes ✓ No				
Property address(es): 3708 ROCK QUAR	RY ROAD, R	ALEIGH N	NC 2	27610
Site P.I.N.(s): 1722-26-8336				
Please describe the scope of work. Include any additions, expansions, and uses (UDO 6.1.4). We are proposing (10) additional tiny house duplexes in addition to the existing, extending the existing gravel access drive, (1) 1.5 story civic building, community amenities, and utility service connections.				
Current Property Owner(s): Zachary Milb	urn			
ompany: NOMAD DEVELOPMENT, INC. Title: Executive Officer/Director		ve Officer/Director		
Address:4308 Graham Newton Road, Raleigh, NC 27606				
Phone #:801-819-6541 Email:zach@nomadliving.io				
Applicant Name (If different from owner. See "who can apply" in instructions): Sam Nye, PE				
Relationship to owner: Lessee or contract purchaser Owner's authorized agent Easement holder				
Company: The Site Group	Address: 11	11 Oberlin	Ro	ad

Phone #: 919-835-4787	Email: bdm@thesitegroup.net		
NOTE: please attach purchase agreement or contract, lease or easement when submitting this form.			
Developer Contact: Zachary Milburn			
Company: Nomad Development, Inc.		Title: Executive Officer/Director	
Address: 4308 Graham Newton Road, F	Address: 4308 Graham Newton Road, Raleigh, NC 27606		
Phone #: 801-819-6541	Email: zach@nomadliving.io		
Applicant Name: Sam Nye, PE			
Company: The Site Group	Address: 1111 Oberlin Road		
Phone #: 919-835-4787	Email: srn@thesitegroup.net		

DEVELOPMENT TYPE + SITE DATE TABLE			
(Applicable t	o all developments)		
SITE DATA	BUILDING DATA		
Zoning district(s) (please provide the acreage of each):	Existing gross floor area (not to be demolished):		
RX-3-CU	1,126 sf		
Gross site acreage:	Existing gross floor area to be demolished:		
2.36 AC	0		
# of parking spaces proposed:	New gross floor area:8,760 sf		
Max # parking permitted (7.1.2.C): No max	Total sf gross (to remain and new):9,886 sf		
Overlay District (if applicable):SHOD-1	Proposed # of buildings:11 (10 dwelling, 1 civic)		
Existing use (UDO 6.1.4): Tiny House Duplex	Proposed # of stories for each: Dwellings 1, Civic 1.5		
Proposed use (UDO 6.1.4): Cottage Court	Proposed # of basement levels (UDO 1.5.7.A.6) 0		

STORMWATER INFORMATION			
Imperious Area on Parcel(s):	Impervious Area for Compliance (includes ROW):		
Existing (sf) 2,776 Proposed total (sf) 29,842			
	Existing (sf) 3,011 Proposed total (sf) 2,776		
RESIDENTIAL & OVERNIGHT	FLODGING DEVELOPMENTS		
Total # of dwelling units:22 total (20 proposed)	Total # of hotel bedrooms: 0		
# of bedroom units: 1br <u>X</u> 2br 3br	4br or more		
# of lots:	Is your project a cottage court? Yes No		

APPLICANT SIGNATURE BLOCK Pursuant to state law (N.C. Gen. Stat. § 160D-403(a)), applications for development approvals may be made by the landowner, a lessee or person holding an option or contract to purchase or lease land, or an authorized agent of the landowner. An easement holder may also apply for development approval for such development

A frequent transit development? Yes No

as is authorized by the easement. Acting as an authorized agent requires written permission from the property owner for the purposes of making this development approval and/or permit application. Written permission from the property owner to act as an authorized agent must be made available to the City of Raleigh upon request.

By submitting this application, the undersigned applicant acknowledges that they are either the property owner or one of the persons authorized by state law (N.C.G.S. 160D-403(a)) to make this application, as specified in the application. The undersigned also acknowledges that the information and statements made in the application are correct and the undersigned understands that development approvals are subject to revocation for false statements or misrepresentations made in securing the development approval, pursuant to N.C. Gen. Stat. § 160D-403(f).


The undersigned indicates that the property owner(s) is aware of this application and that the proposed project described in this application will be maintained in all respects in accordance with the plans and specifications submitted herewith, and in accordance with the provisions and regulations of the City of Raleigh Unified Development Ordinance.

The undersigned hereby acknowledges that, pursuant to state law (N.C.G.S. 143-755(b1), if this permit application is placed on hold at the request of the applicant for a period of six consecutive months or more, or if the applicant fails to respond to comments or provide additional information requested by the City for a period of six consecutive months or more, then the application review is discontinued, and a new application is required to proceed and the development regulations in effect at the time permit processing is resumed shall

apply to the new application.	
ΩM	
Signature: College	Date: July 22nd, 2024
Printed Name. Zachary Michael Milburn	
Signature:	Date:
Printed Name:	

2511 & 2513 SUNNYBROOK ROAD Raleigh, North Carolina

TIER TWO SITE PLANS ASR-0055-2024

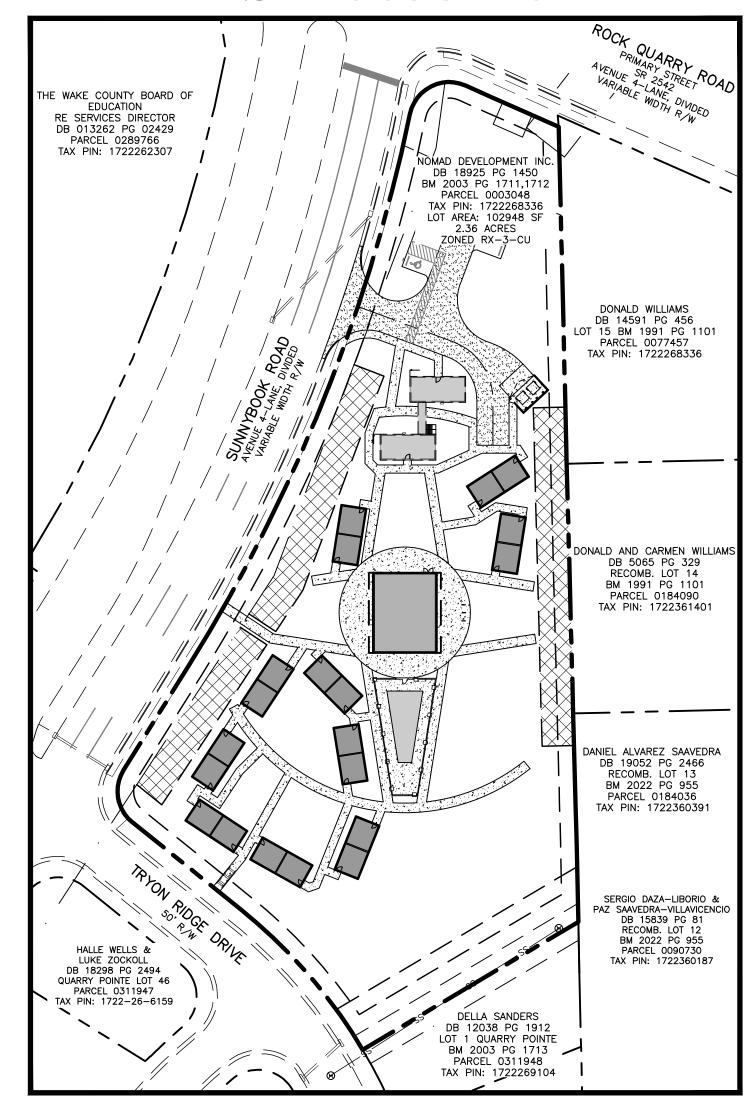

TRAFFIC CONTROL AND PEDESTRIAN PLAN (TCPED) NOTES:

THE CITY OF RALEIGH PERMIT AND DEVELOPMENT PORTAL.

APPROVED PLAN, AND ENSURE ALL PERMITS ARE ISSUED.

MANUAL ON UNIFORM TRAFFIC CONTROL (MUTCD);

AMERICAN DISABILITY ACT (ADA) REQUIREMENTS;

RALEIGH STREET DESIGN MANUAL (RSDM).

ON UNIFORM TRAFFIC CONTROL DEVICES (MUTCD).

STANDARDS, INCLUDING BUT NOT LIMITED TO:

PLEASE DIRECT ANY QUESTIONS TO RIGHTOFWAYSERVICES@RALEIGHNC.GOV.

STREET OR SIDEWALK AND NCDOT ROAD WITHIN RALEIGH'S JURISDICTION.

PUBLIC RIGHTS-OF-WAY ACCESSIBILITY GUIDELINES (PROWAG);

PRIOR TO ANY WORK THAT IMPACTS THE RIGHT-OF-WAY, CLOSING OR DETOURING OF ANY STREET,

LANE, OR SIDEWALK, THE CONTRACTOR MUST APPLY FOR A PERMIT WITH RIGHT-OF-WAY SERVICES.

THE CITY OF RALEIGH REQUIRES AN APPROVED RIGHT-OF-WAY PERMIT FOR WORK ON ANY PUBLIC

A PERMIT REQUEST WITH A TCPED PLAN SHALL BE SUBMITTED TO RIGHT-OF-WAY SERVICES THROUGH

PRIOR TO THE START OF WORK, THE CLIENT SHALL SCHEDULE A PRE-CONSTRUCTION MEETING WITH

ALL PUBLIC SIDEWALKS MUST BE ACCESSIBLE TO PEDESTRIANS WHO ARE VISUALLY IMPAIRED AND/OR

ACCESSIBILITY GUIDELINES (PROWAG), THE ADA STANDARDS FOR ACCESSIBLE DESIGN AND THE MANUAL

THE ENGINEERING INSPECTIONS COORDINATOR TO REVIEW THE SPECIFIC COMPONENTS OF THE

ALL TCPED PLANS SHALL COMPLY WITH ALL LOCAL, STATE, AND FEDERAL REQUIREMENTS AND

PEOPLE WITH MOBILITY CONCERNS. EXISTING AND ALTERNATIVE PEDESTRIAN ROUTES DURING

CONSTRUCTION SHALL BE REQUIRED TO BE COMPLIANT WITH THE PUBLIC RIGHTS OF WAY

ALL PERMITS MUST BE AVAILABLE AND VISIBLE ON SITE DURING THE OPERATION.

SHEET INDEX: COVER SHEET EXISTING CONDITIONS PLAN SITE LAYOUT PLAN FUTURE RIGHT OF WAY EXHIBIT FIRE ACCESS PLAN GRADING PLAN SITE 400 UTILITY PLAN LIGHTING PLAN TREE CONSERVATION & LANDSCAPE PLAN SITE DETAILS ARCHITECTURAL ELEVATIONS ARCHITECTURAL ELEVATIONS

SOLID WASTE NOTE:

THE INITIAL DEVELOPMENT OF THE EXISTING DUPLEXES ON THIS SITE WAS APPROVED FOR ROLL-OUT CARTS BY MARION STALEY ON MAY 25, 2024 FOR BLDR-008845-2023. FOR THIS PROJECT WE ARE PROPOSING A COMMUNITY DUMPSTER WITH A 20' WIDE HD PAVED ACCESS DRIVE FOR SERVICE

FLOODPLAIN NOTE:

THIS PROPERTY IS LOCATED OUTSIDE THE WAKE COUNTY 100 YEAR FUTURE CONDITIONS FLOODPLAIN (1% FUTURE CONDITIONS FLOODPLAIN").

FEMA REFERENCE DATA: FEMA FIRM PANEL No.: EFFECTIVE DATE: FEMA STREAM NAME: FEMA FLOOD ZONE:

Shade Zone X(0.2% annual chance flood

FOR SITES WITHOUT FLOODPLAIN: THIS SITE IS NOT IN ANY SPECIAL FLOOD HAZARD AREAS OR FUTURE CONDITIONS FLOOD HAZARD AREAS, AS SHOWN ON FIRM PANEL 3720172200K DATED 07/19/2022

TCZ-5-19 3708 ROCK QUARRY RD - AMENDS THE CONDITIONS ASSOCIATED WITH ZONING CASE Z-19-17 APPROVED IN ORDINANCE NO. (2018) 794 ZC 757 AND EFFECTIVE CONDITIONS REVISED AND DATED: OCTOBER 21, 2019

THE PROPERTY SHALL BE RESTRICTED TO RESIDENTIAL USES AND MINOR UTILITIES, AS DEFINED BY CHAPTER 6 OF THE UDO THE PROPOSED USE OF THIS PROPERTY IS RESIDENTIAL.

THE MAXIMUM DENSITY FOR THE PROPERTY SHALL BE LIMITED TO 29 DWELLING UNITS PER THE PROPOSED DENSITY FOR THIS PROPERTY IS 9.3 UNITS PER ACRE.

PRIOR TO ISSUANCE OF A BUILDING PERMIT FOR NEW DEVELOPMENT OR RECORDING A SUBDIVISION PLAT, WHICHEVER OCCURS FORST, A TRANSIT EASEMENT SHALL BE DEEDED TO THE CITY AND RECORDED IN THE WAKE COUNTY REGISTRY. PRIOR TO RECORDATION OF THE TRANSIT EASEMENT, THE DIMENSIONS (NOT TO EXCEED 15' IN DEPTH AND 20' IN WIDTH) AND LOCATION OF THE EASEMENT SHALL BE ESTABLISHED DURING THE SITE PLAN OR SUBDIVISION REVIEW, AND THE EASEMENT DEED APPROVED AS TO FORM BY CITY

A 15' x 20' C.O.R. TRANSIT EASEMENT HAS BEEN RECORDED AND PROVIDED WITH THESE PLANS. THE RECORDED EASEMENT CAN BE FOUND AT BM: 2023, PG: 01183.

CONTACT:

SAMUEL NYE, PE

THE SITE GROUP, PLLC

1111 OBERLIN ROAD

RALEIGH, NC 27605

FAX: (919) 839-2255

DEVELOPER/OWNER:

EMAIL: srn@thesitegroup.net

NOMAD DEVELOPMENT, INC.

4308 GRAHAM NEWTON ROAD

ATTN: ZACH MILBURN

RALEIGH, NC. 27606

PHONE: (801)819-6541

EMAIL: zach@nomadliving.io

SITE DATA SUMMARY

PROJECT NAME:	NOMAD DEVELOPMENT
SITE ADDRESS:	3708 ROCK QUARRY ROAD (PRIMARY)
JURISDICTION:	CITY OF RALEIGH
PARCEL ID:	1722-26-8336
EXISTING ZONING:	RX-3-CU
PROPOSED ZONING:	RX-3-CU
OVERLAY DISTRICT:	SHOD-1
EXISTING SITE AREA:	2.36 AC.
CURRENT USE:	DUPLEX
PROPOSED USE:	COTTAGE COURT
MIN. NET SITE AREA:	13,000 SF.
MIN. SITE AREA PER TINY HOUSE UNIT:	1,800 SF. x 18 UNITS = 32,400 SF.
TOTAL SITE AREA REQUIRED:	45,400 SF.
MIN. INTERNAL COURTYARD AREA REQUIRED: 1	,600 SF. + (200 SF. x 18 UNITS) = 5,200 SF.
INTERNAL COURTYARD AREA PROVIDED:	11,800 SF.
MAX. BUILDING HEIGHT:	50'/3 STORIES
PROPOSED COMMUNITY BUILDING HEIGHT:	50'-0"/1.5 STORY
TINY HOUSE BUILDING HEIGHT (MAX.):	26'
EXISTING NODE BLDG HEIGHT:	14'-6"
PROPOSED ECHO BLDG HEIGHT:	14'-6"
EXISTING BUILDING AREA:	TWO NODE BLDGS-563 SF. EACH (1,126)
PROPOSED BUILDING AREA:	COMMUNITY BLDG-3,000 SF. 10 ECHO BLDGS-576 SF. EACH (5,760)
TOTAL BUILDING AREA:	9,886 SF.
BUILDING SETBACKS	
PRIMARY STREET:	10'
SIDE STREET:	10'
SIDE LOT LINE:	10'
REAR LOT LINE:	20'
MIN. BUILDING SEPARATION:	6'
PARKING SETBACKS:	
PRIMARY STREET (W/ C3 YARD):	50'
SIDE STREET:	10'
SIDE LOT LINE:	5'
REAR LOT LINE:	5'
EXISTING IMPERVIOUS AREA:	0.13 AC. (INCL. ROW + EX. UNITS)
PROPOSED IMPERVIOUS AREA:	0.76 AC. (INCL. ROW + ALL UNITS)
MAX. ALLOWED IMPERVIOUS AREA:	1.77 AC.*
*MAX. ALLOWED IMPERVIOUS PER ORIGINAL APP	PROVED SUBDIVISION PLANS (S-93-01)
TOTAL IMPERVIOUS AREA PROPOSED:	33,175 SF. / 0.76 AC (32.2%)

I-440/RALEIGH BELTLINE

33,175 SF. / 0.76 AC (32.2%) TOTAL IMPERVIOUS AREA PROPOSED: 0.59 AC. (25%)* PRESERVED OPEN SPACE REQUIRED: *MIN. REQUIRED OPEN SPACE PER ORIGINAL APPROVED SUBDIVISION PLANS (S-93-01) PRESERVED OPEN SPACE PROVIDED:

26,958 SF./0.62 AC. (26.1%) TOTAL OPEN SPACE PROVIDED: 0.23 AC. (10.0%) BM. 2020 PG. 11 EXISTING TREE CONSERVATION AREA: 200 SF./.004 AC EX. TREE CONSERVATION AREA REMOVED: 0.472 AC. (20%) TOTAL TCA REQUIRED (INCLUDES EXISTING): 0.256 AC. (10.8%) PROPOSED TREE CONSERVATION AREA: TOTAL TCA PROVIDED: 0.488 AC. (20.6%) PARKING REQUIRED: NO MAXIMUM

10 SPACES (INCLUDES 1 ADA SPACE) PARKING PROVIDED: SHORT-TERM BIKE PARKING PROVIDED:

6 SPACES (3 RACKS) DISTURBED AREA:

PHONE: (919) 835-4787

MANAGED OPEN SPACE PROVIDED:





SCALE: 1" = 60'



DISTURBED AREA=57,114 SF.

0 LF

PUBLIC IMPROVEMENT QUANTITIES

PHASE NUMBER

NUMBER OF LOTS

NUMBER OF UNITS

LIVABLE BUILDINGS

PUBLIC WATER (LF)

PUBLIC STREET (LF)

PUBLIC CURB & GUTTER

PUBLIC SIDEWALK (LF)


WATER SERVICE STUBS

SEWER SERVICE STUBS

LOT NUMBERS BY PHASE

PUBLIC GRAVITY SEWER (LF)



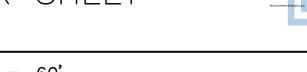



TIER ONE SITE PLAN

COVER

SHEET


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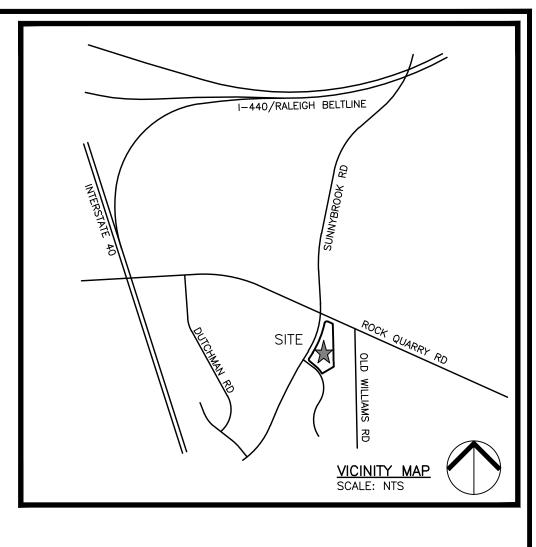
07 AUG 2024

1\25 OCT 2024

<u>∕2</u>\18 DEC 2024

Dwg No.



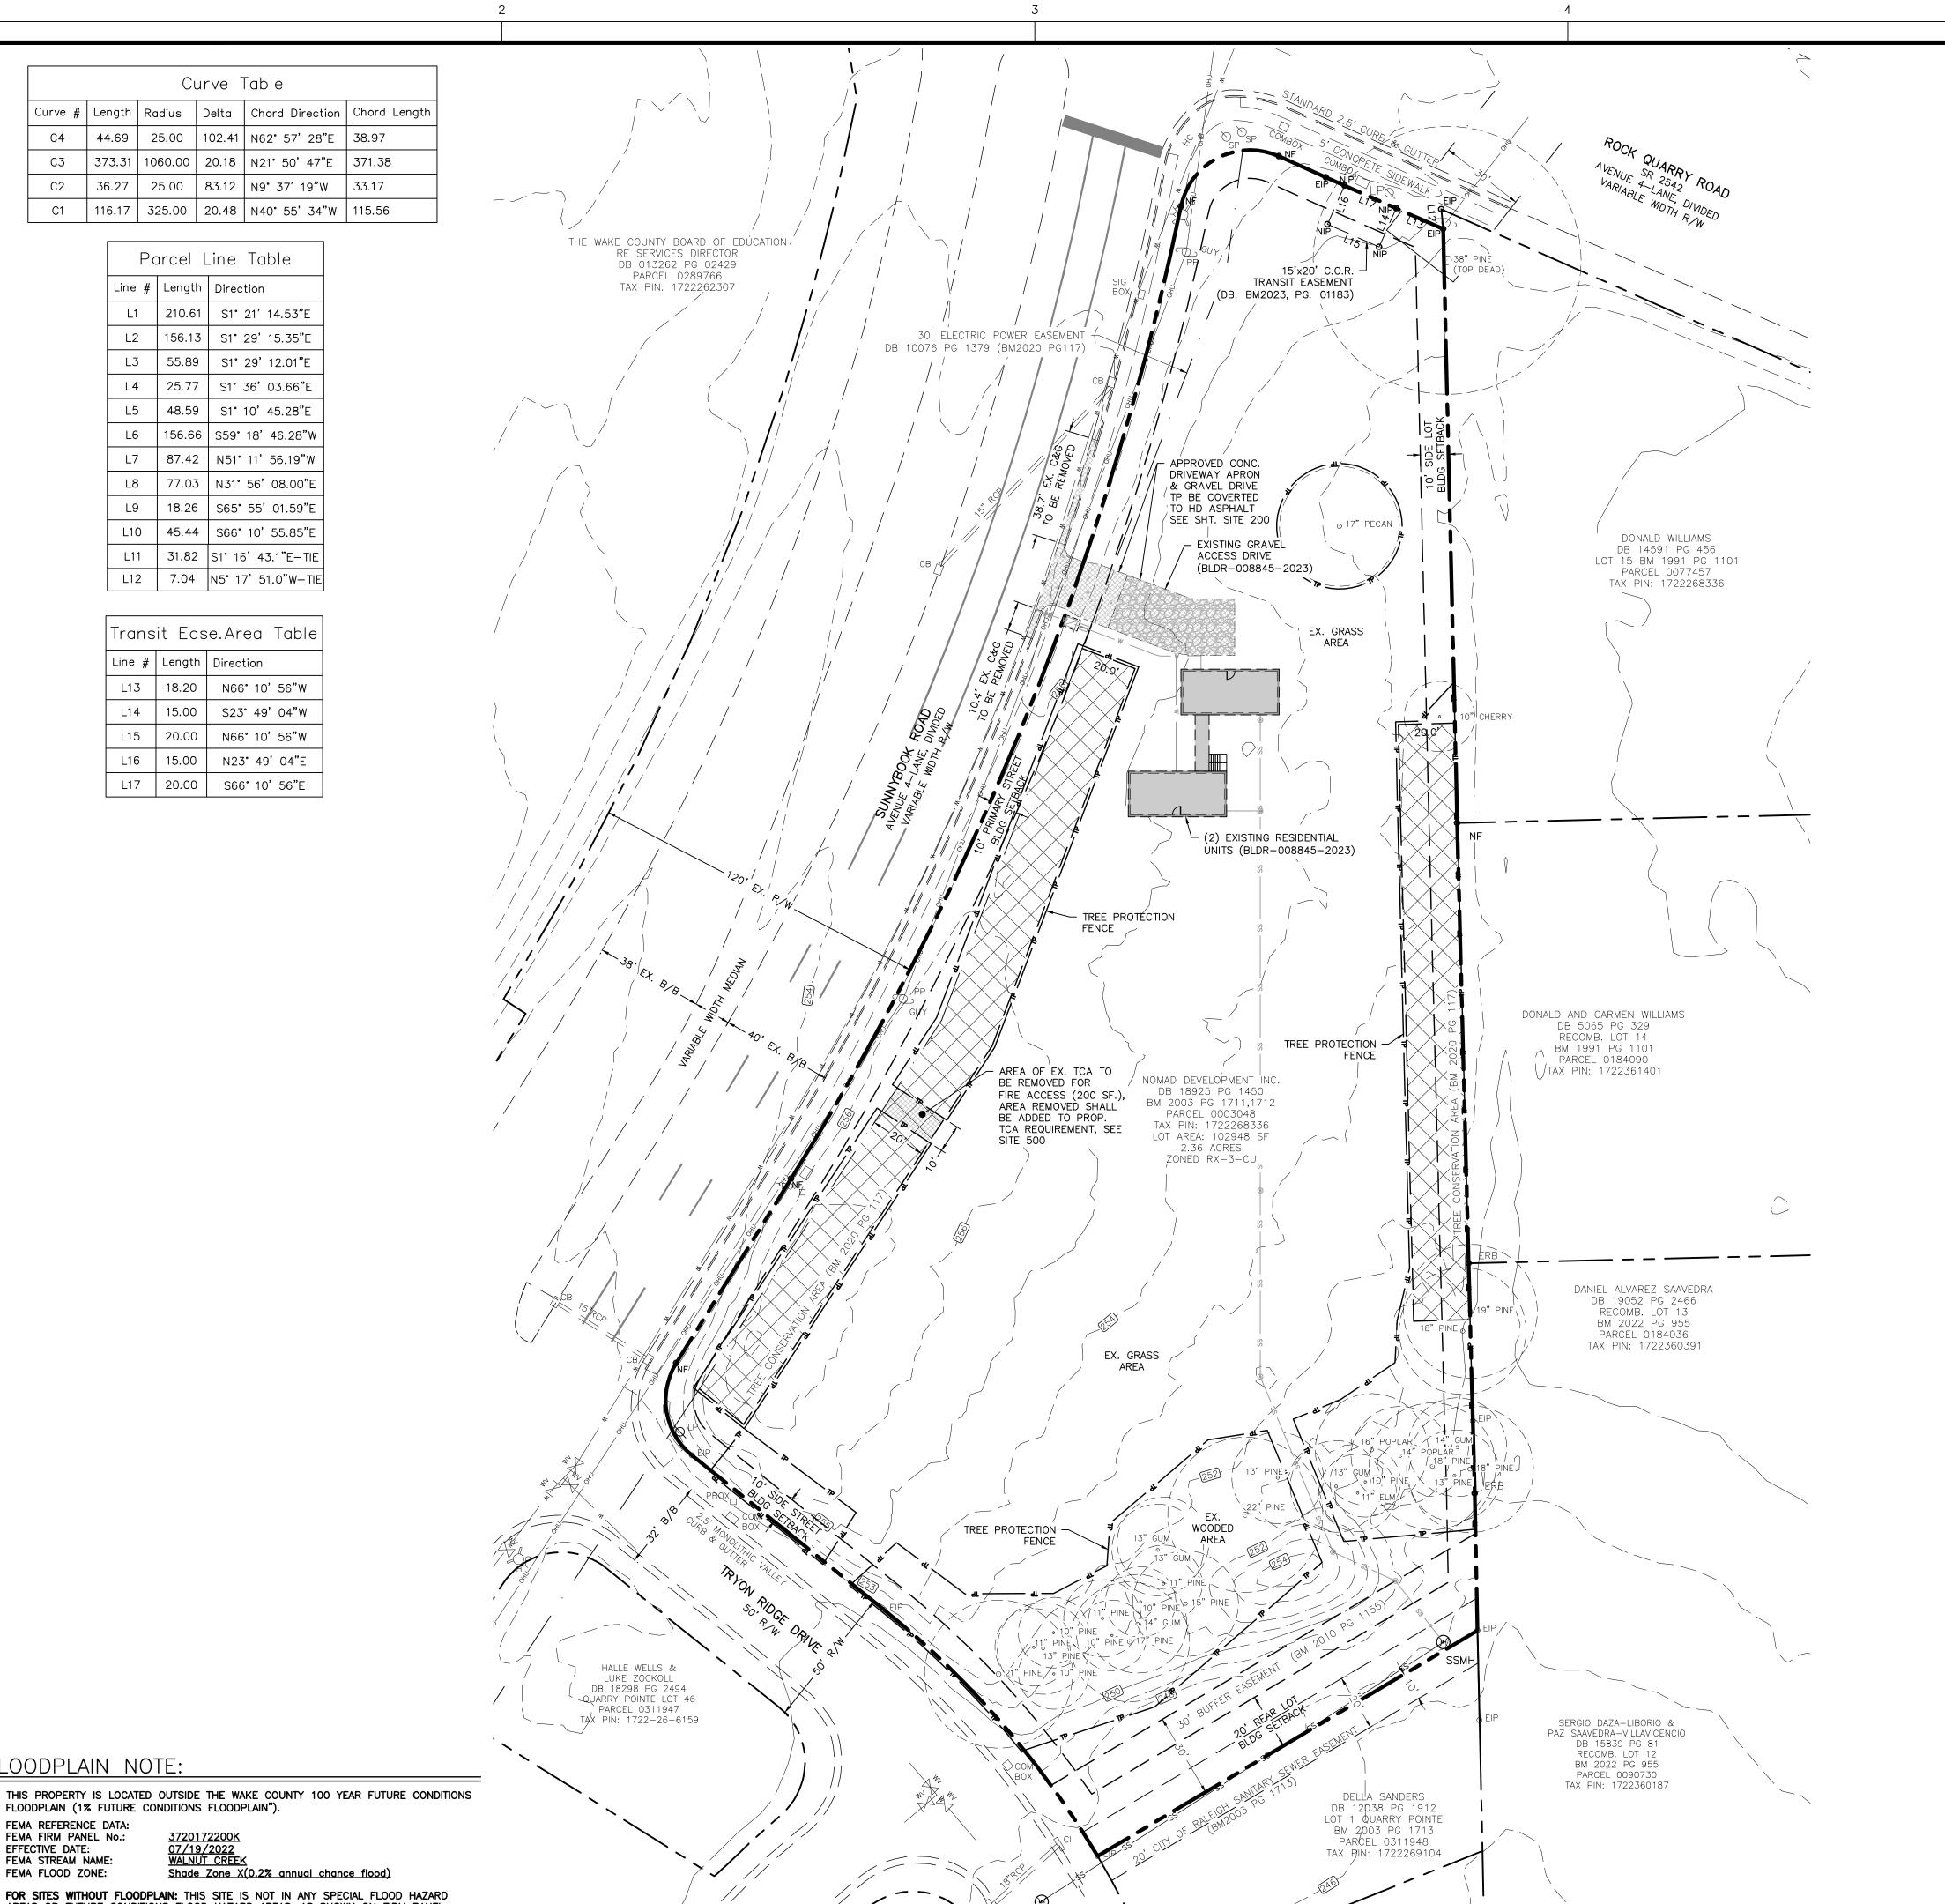

GENERAL NOTES

- 1. ALL MATERIALS AND METHODS OF CONSTRUCTION SHALL BE IN ACCORDANCE WITH THE CITY OF RALEIGH AND THE STATE OF NORTH CAROLINA STANDARDS AND SPECIFICATIONS.
- 2. CONTRACTOR SHALL HAVE NORTH CAROLINA ONE CALL (811) LOCATE ALL EXISTING UTILITIES PRIOR TO BEGINNING CONSTRUCTION.
- 3. CONTRACTOR SHALL VERIFY THE LOCATION AND DEPTH OF ALL EXISTING UTILITIES AND NOTIFY THE ENGINEER OF ANY DISCREPANCIES OR CONFLICTS PRIOR TO BEGINNING CONSTRUCTION.
- 4. BOUNDARY AND SURVEY INFORMATION IS TAKEN FROM A SURVEY BY DONALD T. ISREAL, PLS, DATED JUNE 27. 2022. TOPOGRAPHY AND SPOTS SHOTS ARE TAKEN FROM WAKE COUNTY GIS. ADDITIONAL SITE INFORMATION TAKEN FROM CITY OF RALEIGH AND WAKE COUNTY GIS.
- 5. ALL CONSTRUCTION SHALL CONFORM TO A.D.A. STANDARDS.

LEGEND

• ERB	EXISTING REBAR	o NIP	NEW IRON PIPE
EIP	EXISTING IRON PIPE	⊡ CM	CONCRETE MONUMENT
wv	WATER VALVE		EP EDGE OF PAVEMENT
\bowtie	or METER (WM)	$\times \times \times$	FENCE LINE
Q	UTILITY POLE	LP	LIGHT POLE
□ PB	TRANSFORMER	MH	MANHOLE
PHONE	TELEPHONE BOX	CATV	CABLE TV BOX
		 PROPERTY LIN 	NE NOT SURVEYED
OU	OUO	VERHEAD UTILITY	(ELECTRIC AND COMMS)
——— O E —	——OE ———OE —	OVERHEAD EL	ECTRIC LINES
——— ss———	— ss——— ss———	UNDERGROUND SA	ANITARY SEWER
———w —	w	UNDERGROUND W	ATER LINES

ABBREVIATIONS: UNDERGROUND TRAFFIC SIGNAL JUNCTION BOX COM BOX UNDERGROUND COMMUNICATIONS OR FIBER OPTIC BOX CATCH BASIN FOR STORM SEWER- GRATED CURB INLET FOR STORM SEWER- NOT GRATED DROP or YARD INLET FOR STORM SEWER- GRATED DI or YI RCP REINFORCED CONCRETE PIPE- STORM SEWER TRAFFIC SIGNAL POLE

> Drawn Checked

ordin Road NC 27605-11 919.835.4787 919.839.2255 SRN@thesiteard

07 AUG 2024 REVISED:

> <u>∕1</u>\25 OCT 2024 2\18 DEC 2024

TIER ONE SITE PLANS

EXISTING CONDITIONS

PLAN

NLRQR

Dwg No. SITE

NORTH EXISTING CONDITIONS PLAN SCALE: 1" = 30'(DRAWING SCALED FOR 24x36 INCH PLOTS)


FLOODPLAIN NOTE:

THIS PROPERTY IS LOCATED OUTSIDE THE WAKE COUNTY 100 YEAR FUTURE CONDITIONS FLOODPLAIN (1% FUTURE CONDITIONS FLOODPLAIN").


FEMA REFERENCE DATA: FEMA FIRM PANEL No.: EFFECTIVE DATE: FEMA STREAM NAME:

FOR SITES WITHOUT FLOODPLAIN: THIS SITE IS NOT IN ANY SPECIAL FLOOD HAZARD AREAS OR FUTURE CONDITIONS FLOOD HAZARD AREAS, AS SHOWN ON FIRM PANEL

3720172200K DATED 07/19/2022

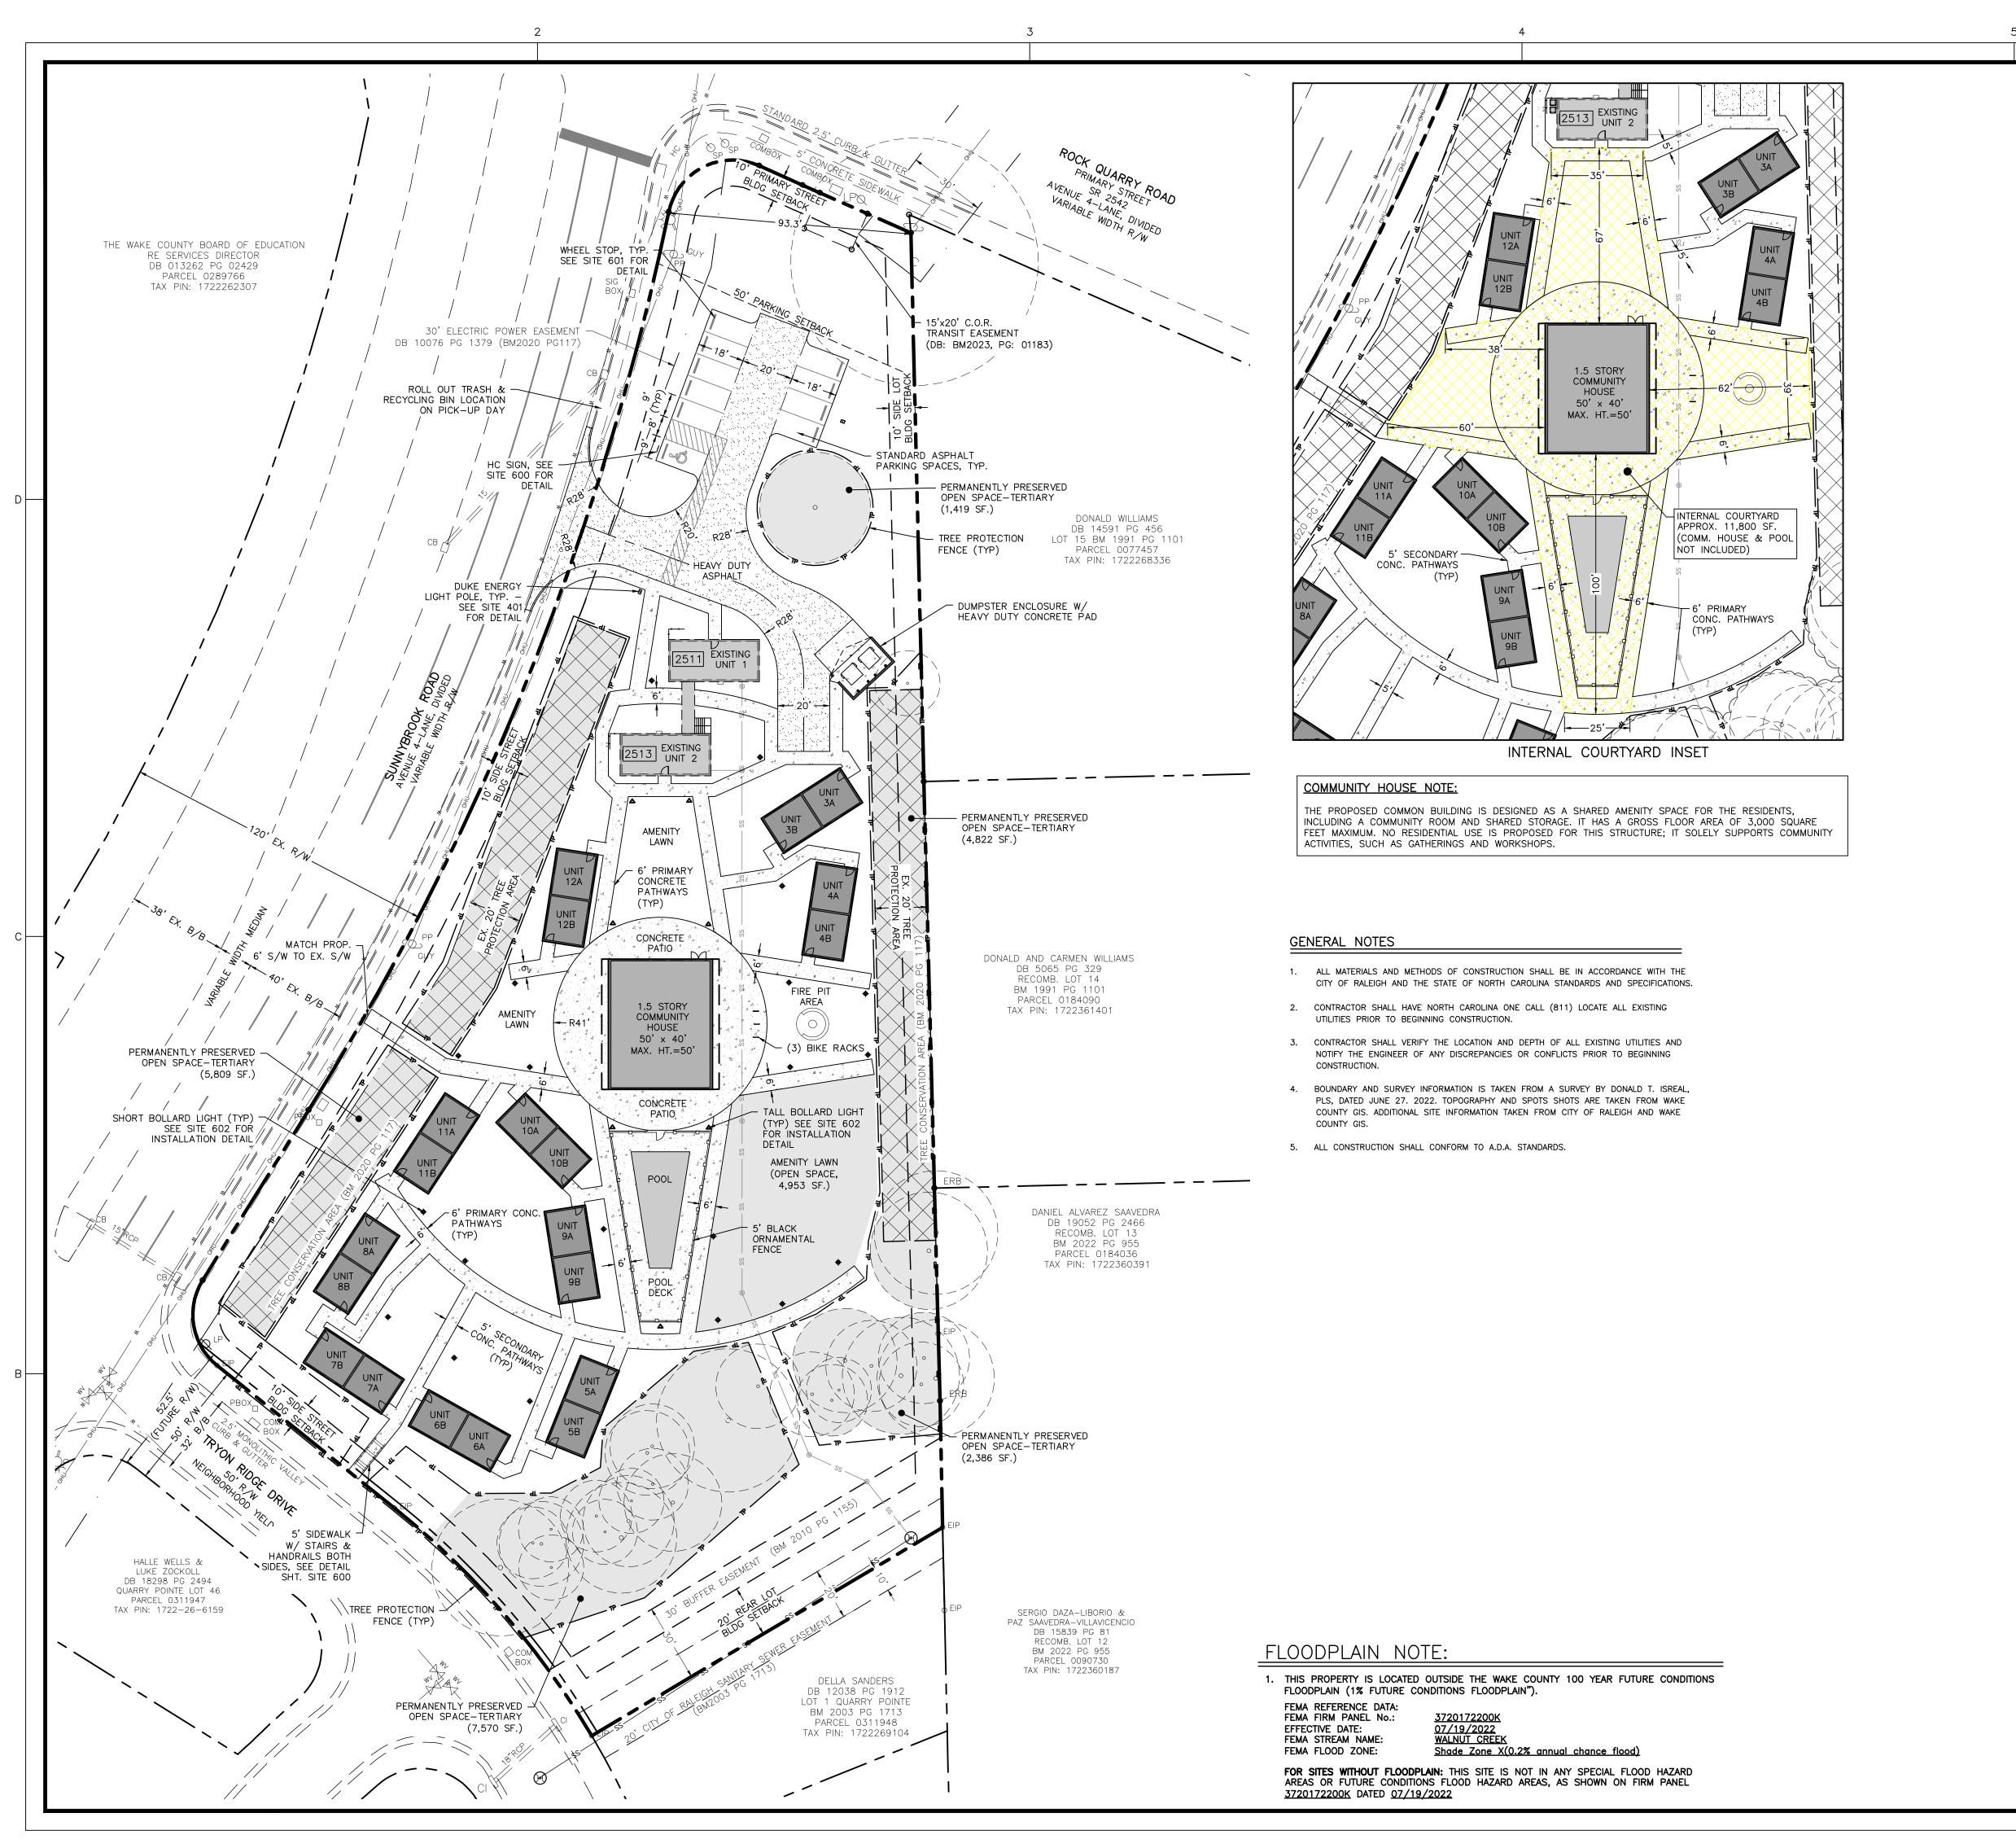

SITE DATA SUMMARY PROJECT NAME: NOMAD DEVELOPMENT 3708 ROCK QUARRY ROAD (PRIMARY SITE ADDRESS: JURISDICTION: CITY OF RALEIGH PARCEL ID: 1722-26-8336 **EXISTING ZONING:** RX-3-CL RX-3-CU PROPOSED ZONING: OVERLAY DISTRICT: SHOD-1 EXISTING SITE AREA: 2.36 AC CURRENT USE: DUPLEX PROPOSED USE: COTTAGE COURT 13,000 SI MIN. NET SITE AREA: $1,800 \text{ SF. } \times 18 \text{ UNITS} = 32,400 \text{ SI}$ MIN. SITE AREA PER TINY HOUSE UNIT: TOTAL SITE AREA REQUIRED: 45,400 SF MIN. INTERNAL COURTYARD AREA REQUIRED: 1,600 SF. + (200 SF. x 18 UNITS) = 5,200 SF 11,800 SI INTERNAL COURTYARD AREA PROVIDED: MAX. BUILDING HEIGHT: 50'/3 STORIES PROPOSED COMMUNITY BUILDING HEIGHT: 50'-0"/1.5 STOR TINY HOUSE BUILDING HEIGHT (MAX.): EXISTING NODE BLDG HEIGHT: 14'-6 PROPOSED ECHO BLDG HEIGHT: TWO NODE BLDGS-563 SF. EACH (1,126 EXISTING BUILDING AREA: COMMUNITY BLDG-3,000 SI PROPOSED BUILDING AREA: 10 ECHO BLDGS-576 SF. EACH (5,760 9,886 SI TOTAL BUILDING AREA: BUILDING SETBACKS PRIMARY STREET: SIDE STREET: SIDE LOT LINE: REAR LOT LINE: MIN. BUILDING SEPARATION: PARKING SETBACKS: PRIMARY STREET (W/ C3 YARD): SIDE STREET: SIDE LOT LINE: REAR LOT LINE: EXISTING IMPERVIOUS AREA: 0.13 AC. (INCL. ROW + EX. UNITS) 0.76 AC. (INCL. ROW + ALL UNITS PROPOSED IMPERVIOUS AREA: MAX. ALLOWED IMPERVIOUS AREA: 1.77 AC. *MAX. ALLOWED IMPERVIOUS PER ORIGINAL APPROVED SUBDIVISION PLANS (S-93-01) 33,175 SF. / 0.76 AC (32.2%) TOTAL IMPERVIOUS AREA PROPOSED: PRESERVED OPEN SPACE REQUIRED: 0.59 AC. (25%) *MIN. REQUIRED OPEN SPACE PER ORIGINAL APPROVED SUBDIVISION PLANS (S-93-01) PRESERVED OPEN SPACE PROVIDED: 22,005 MANAGED OPEN SPACE PROVIDED: 4,953 SI TOTAL OPEN SPACE PROVIDED: 26,958 SF./0.62 AC. (26.1%) 0.23 AC. (10.0%) BM. 2020 PG. 117 EXISTING TREE CONSERVATION AREA: 200 SF./.004 AC EX. TREE CONSERVATION AREA REMOVED: TOTAL TCA REQUIRED (INCLUDES EXISTING): 0.472 AC. (20%) PROPOSED TREE CONSERVATION AREA: 0.256 AC. (10.8%) TOTAL TCA PROVIDED: 0.488 AC. (20.6%) PARKING REQUIRED: NO MAXIMUM PARKING PROVIDED: 10 SPACES (INCLUDES 1 ADA SPACE) SHORT-TERM BIKE PARKING PROVIDED: 6 SPACES (3 RACKS 57,114 SI DISTURBED AREA:

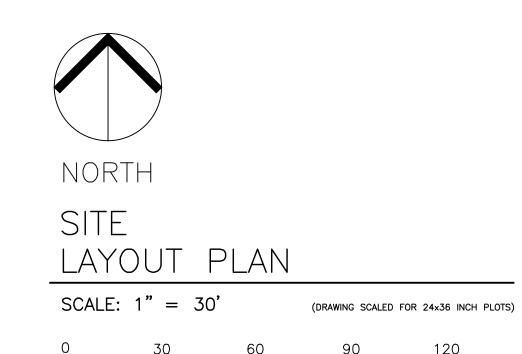

TIER TWO SITE PLANS

Drawn

Checked

07 AUG 2024 REVISED:


<u>∕1</u>\25 OCT 2024

2\18 DEC 2024

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LAYOUT PLAN b NLRQR

SITE 200

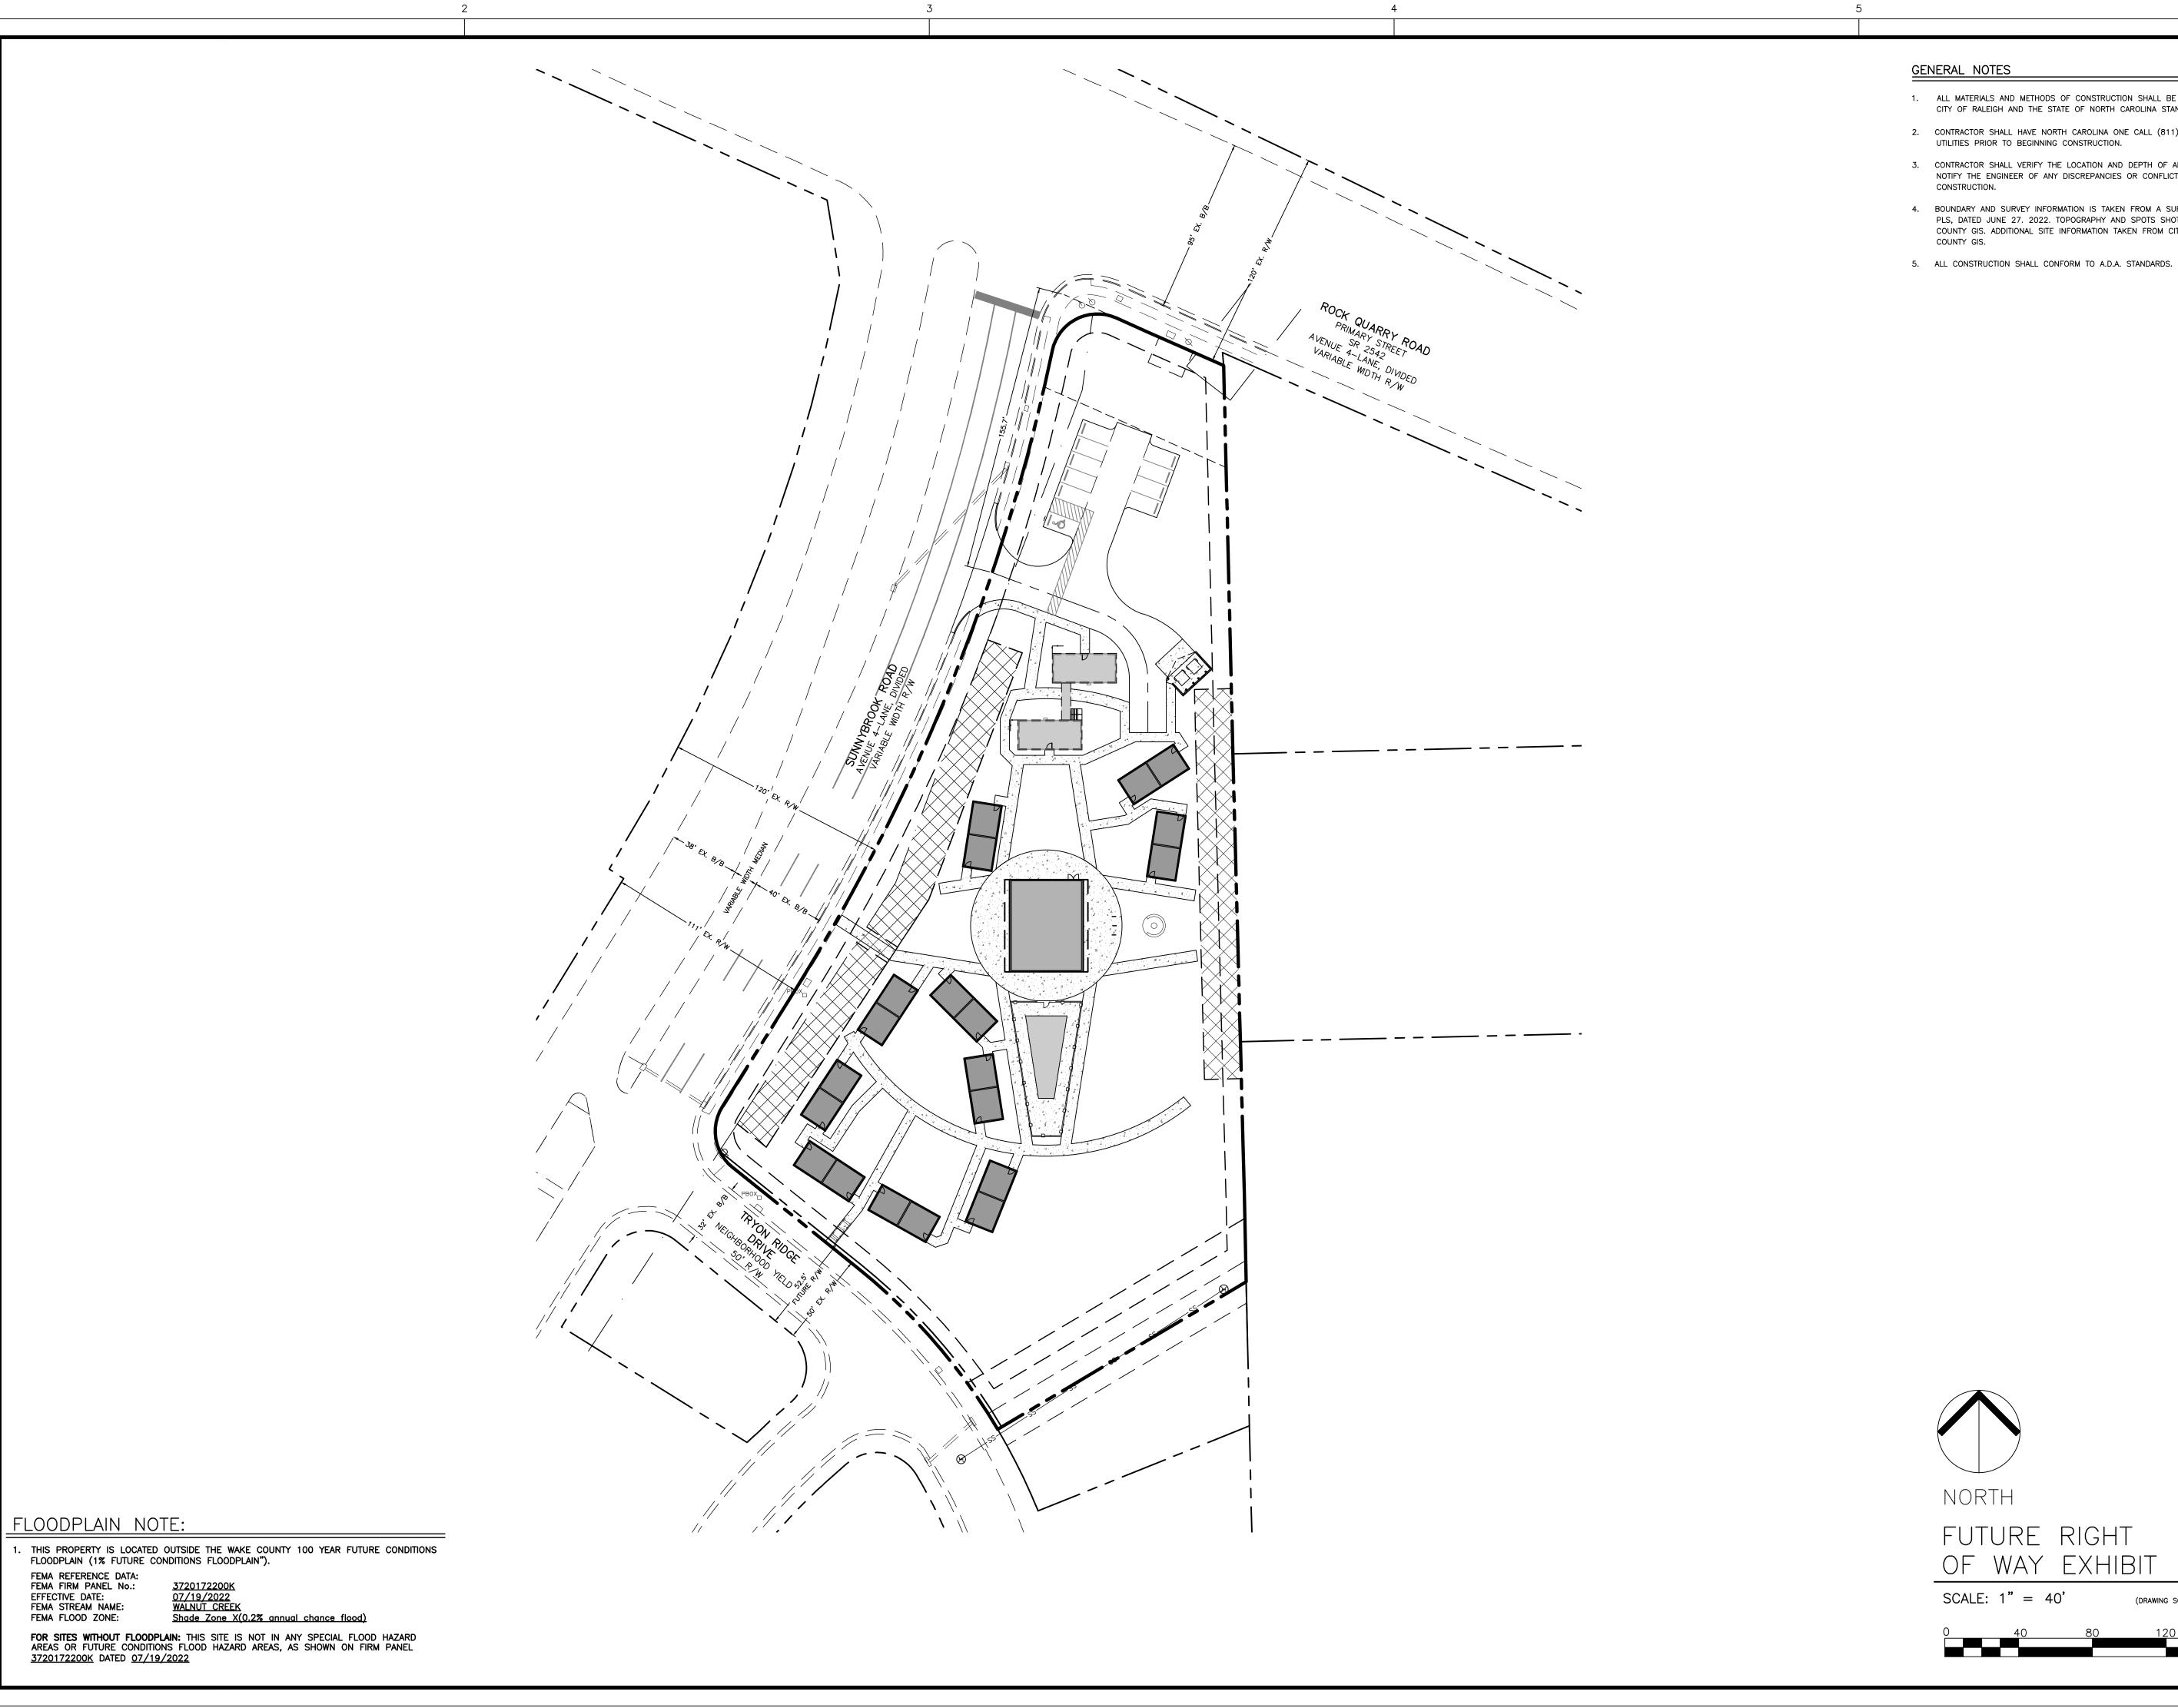

- 1. ALL MATERIALS AND METHODS OF CONSTRUCTION SHALL BE IN ACCORDANCE WITH THE CITY OF RALEIGH AND THE STATE OF NORTH CAROLINA STANDARDS AND SPECIFICATIONS.
- 2. CONTRACTOR SHALL HAVE NORTH CAROLINA ONE CALL (811) LOCATE ALL EXISTING UTILITIES PRIOR TO BEGINNING CONSTRUCTION.
- 3. CONTRACTOR SHALL VERIFY THE LOCATION AND DEPTH OF ALL EXISTING UTILITIES AND NOTIFY THE ENGINEER OF ANY DISCREPANCIES OR CONFLICTS PRIOR TO BEGINNING
- 4. BOUNDARY AND SURVEY INFORMATION IS TAKEN FROM A SURVEY BY DONALD T. ISREAL, PLS, DATED JUNE 27. 2022. TOPOGRAPHY AND SPOTS SHOTS ARE TAKEN FROM WAKE COUNTY GIS. ADDITIONAL SITE INFORMATION TAKEN FROM CITY OF RALEIGH AND WAKE



07 AUG 2024


1 25 OCT 2024 18 DEC 2024

TIER TWO SITE PLANS

FUTURE RIGHT OF WAY **EXHIBIT**

(DRAWING SCALED FOR 24x36 INCH PLOTS)

Dwg No. SITE

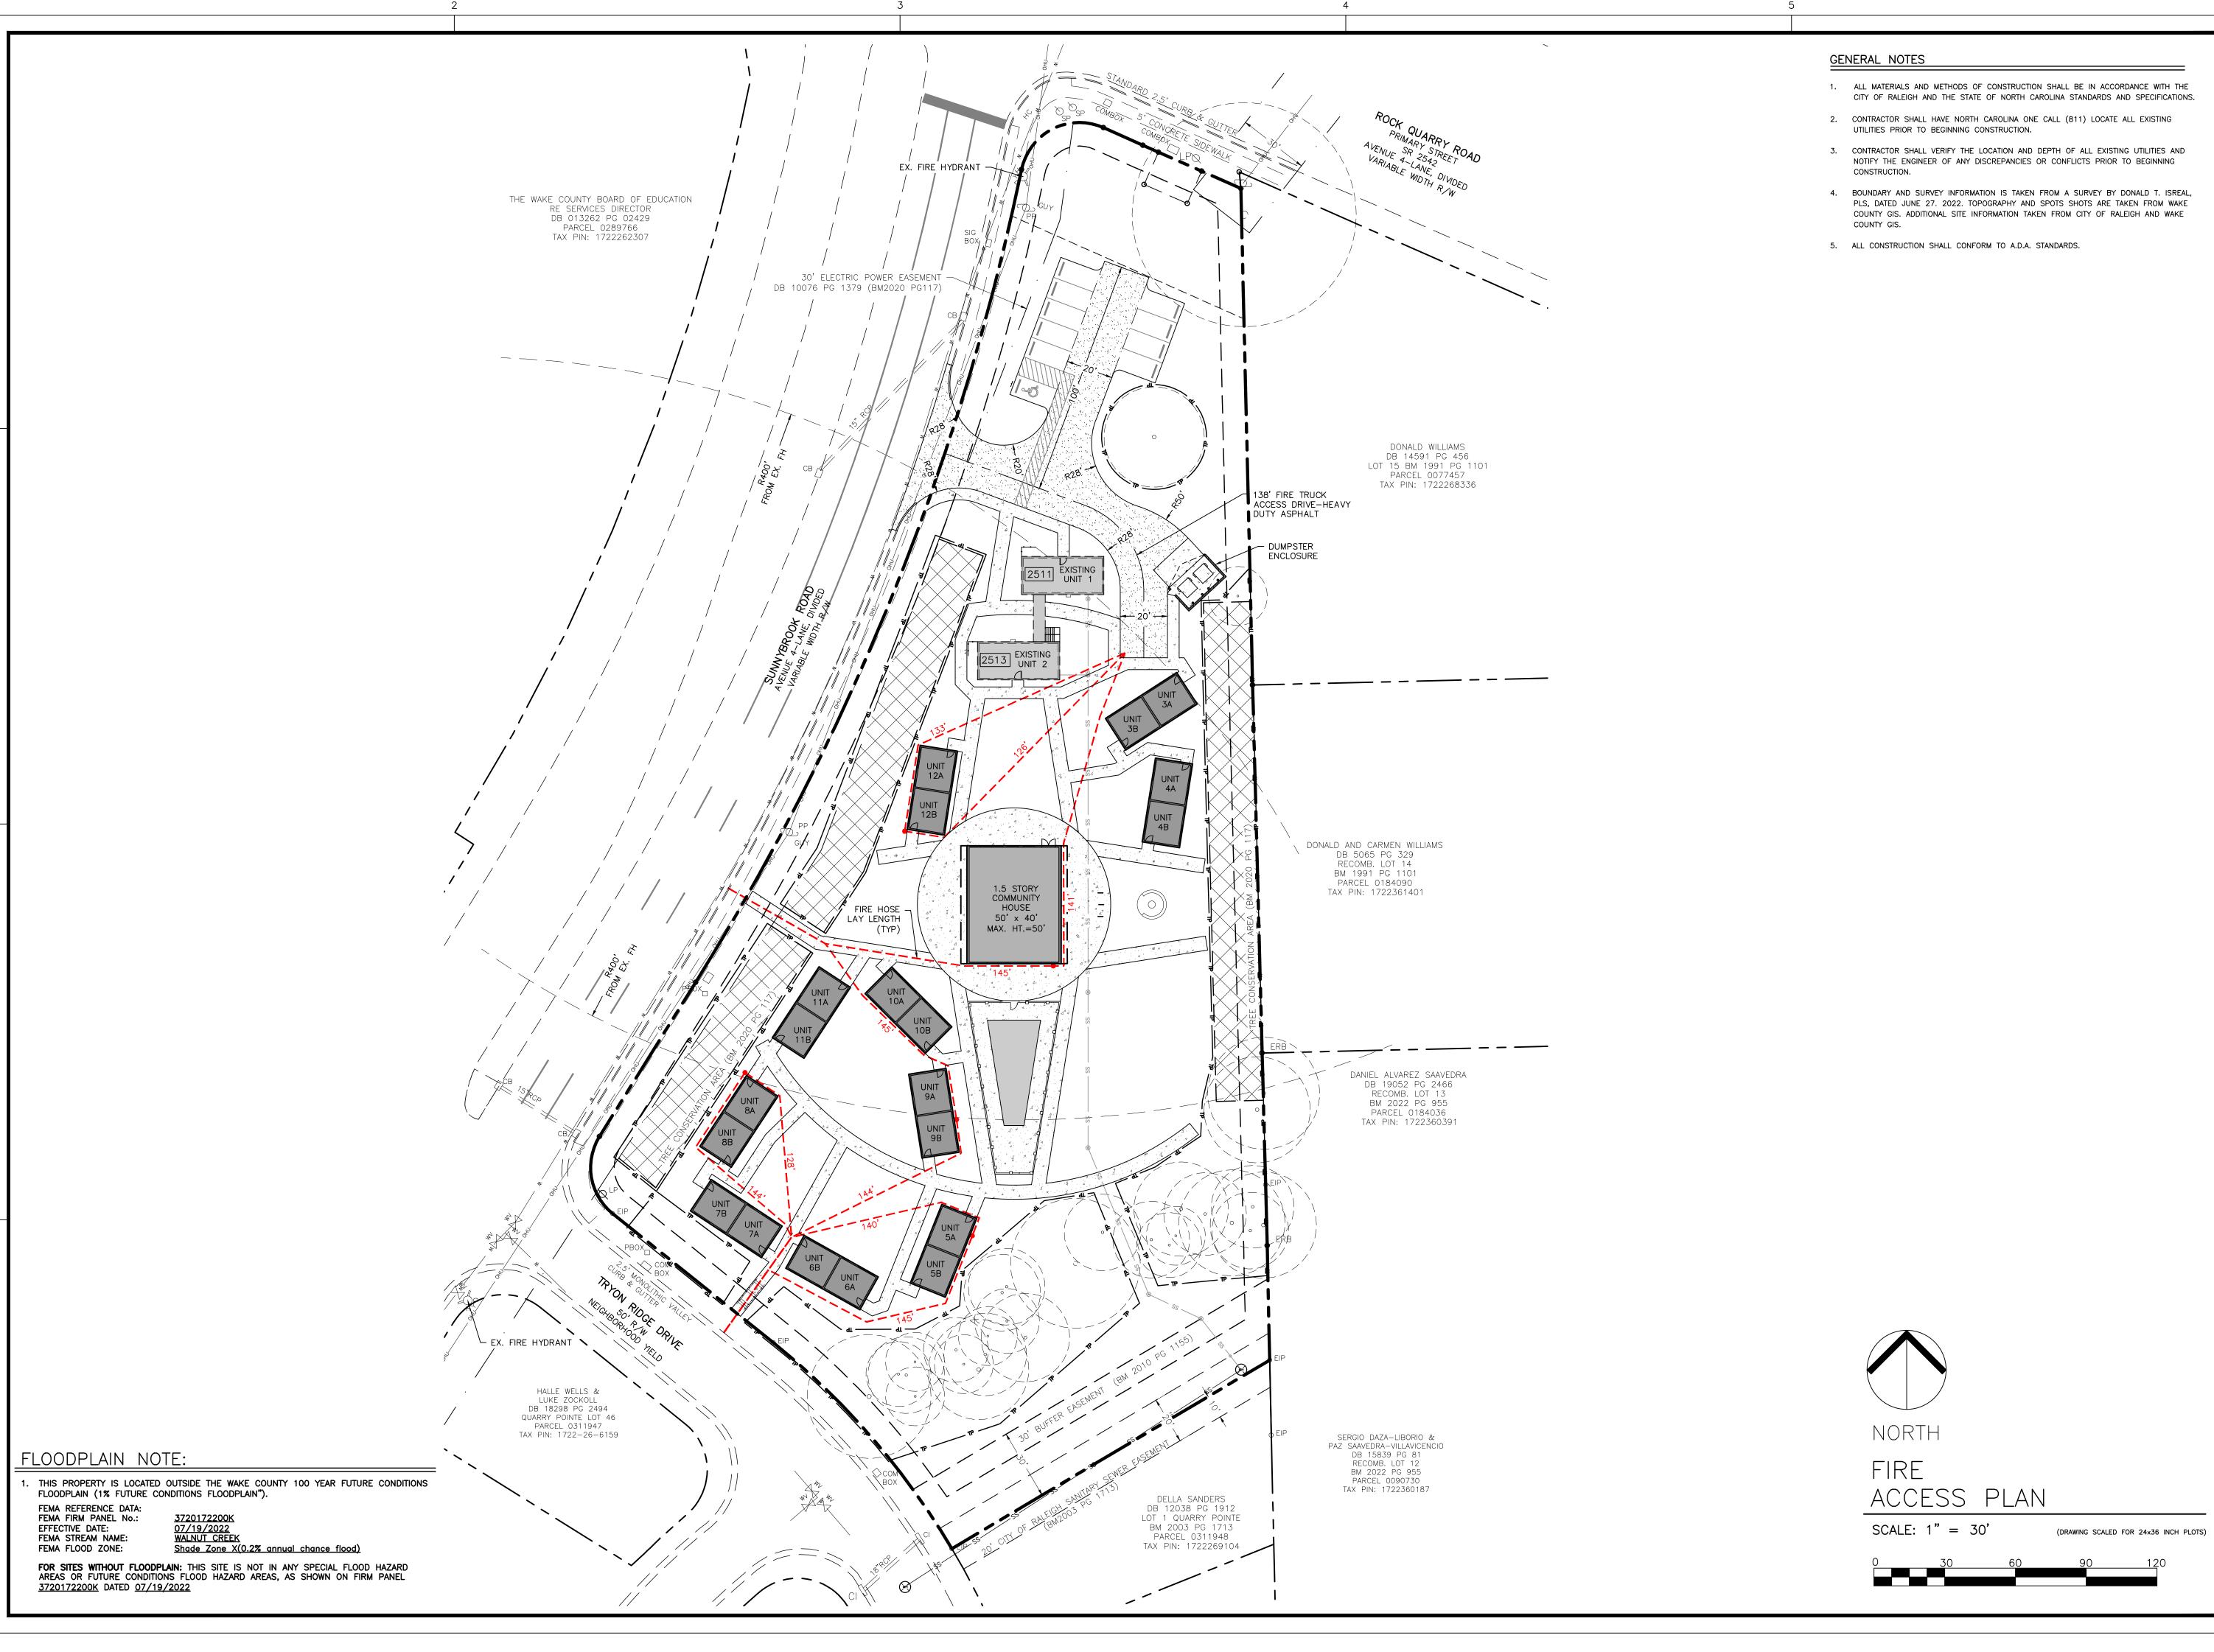

- 1. ALL MATERIALS AND METHODS OF CONSTRUCTION SHALL BE IN ACCORDANCE WITH THE
- NOTIFY THE ENGINEER OF ANY DISCREPANCIES OR CONFLICTS PRIOR TO BEGINNING
- PLS, DATED JUNE 27. 2022. TOPOGRAPHY AND SPOTS SHOTS ARE TAKEN FROM WAKE COUNTY GIS. ADDITIONAL SITE INFORMATION TAKEN FROM CITY OF RALEIGH AND WAKE

PLANS (

Drawn Checked

07 AUG 2024 REVISED:

1 25 OCT 2024 2 18 DEC 2024


TIER TWO SITE PLANS


ACCESS PLAN


NLRQR

Dwg No.

SITE 201

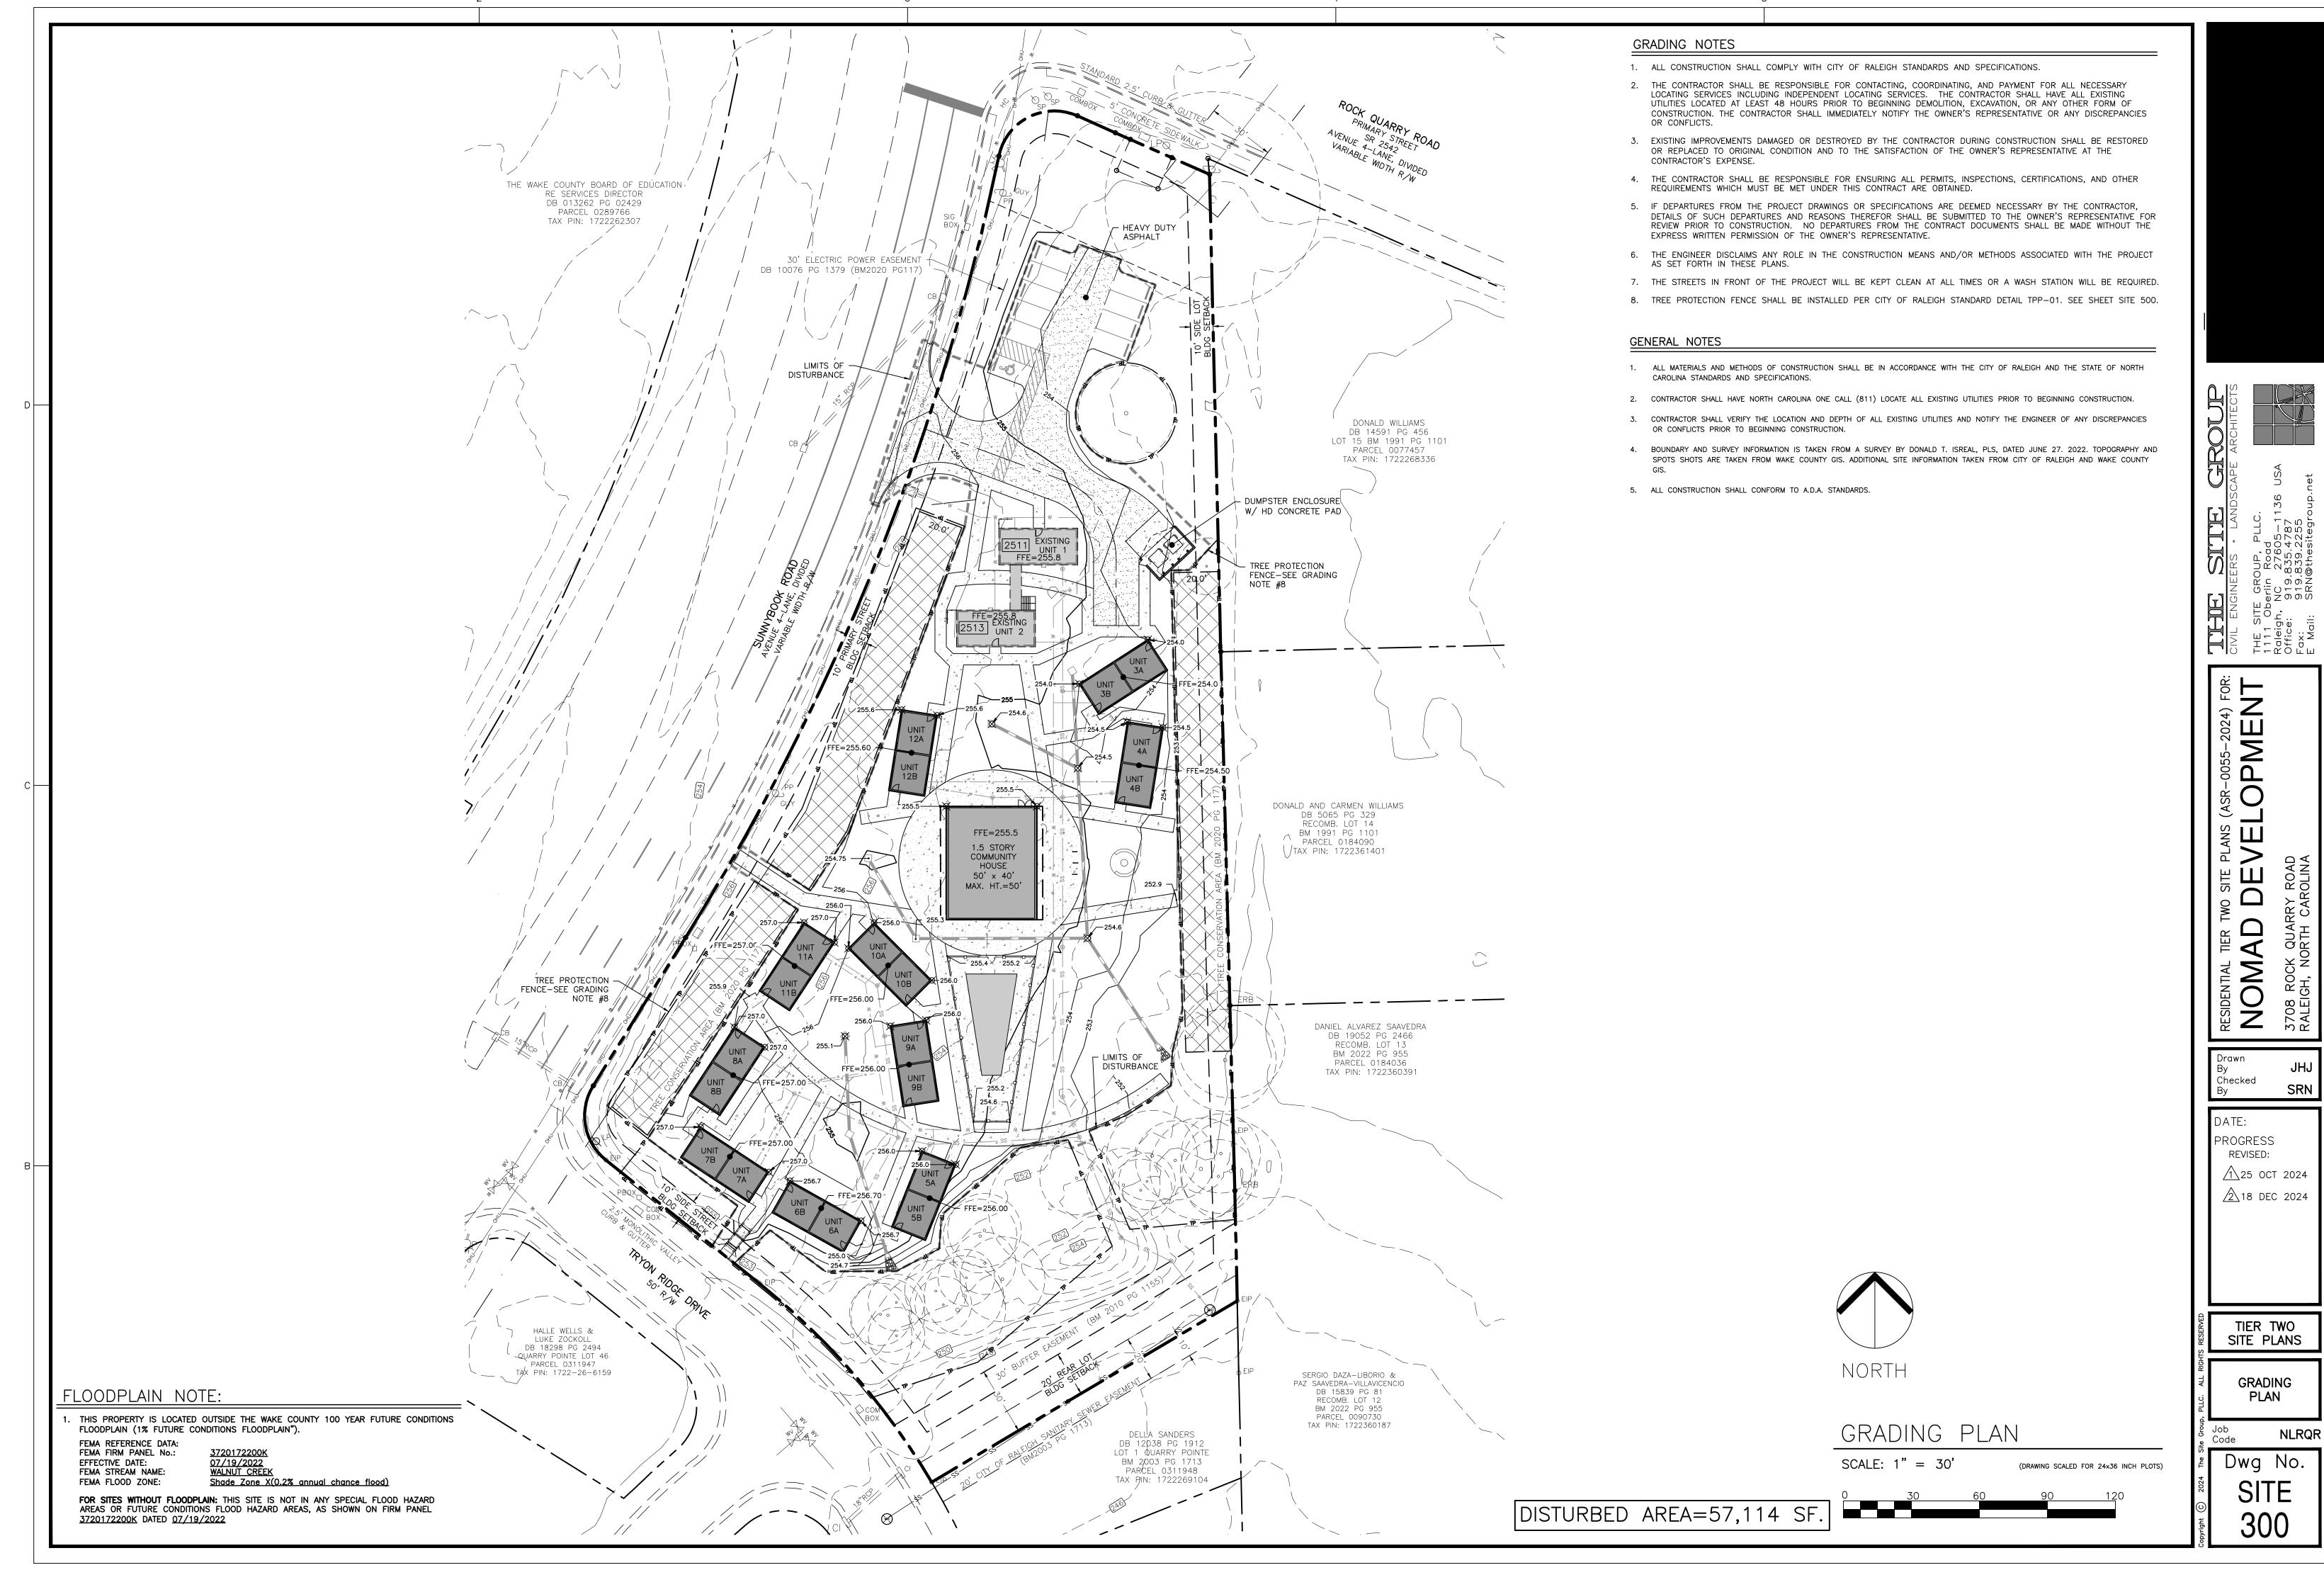

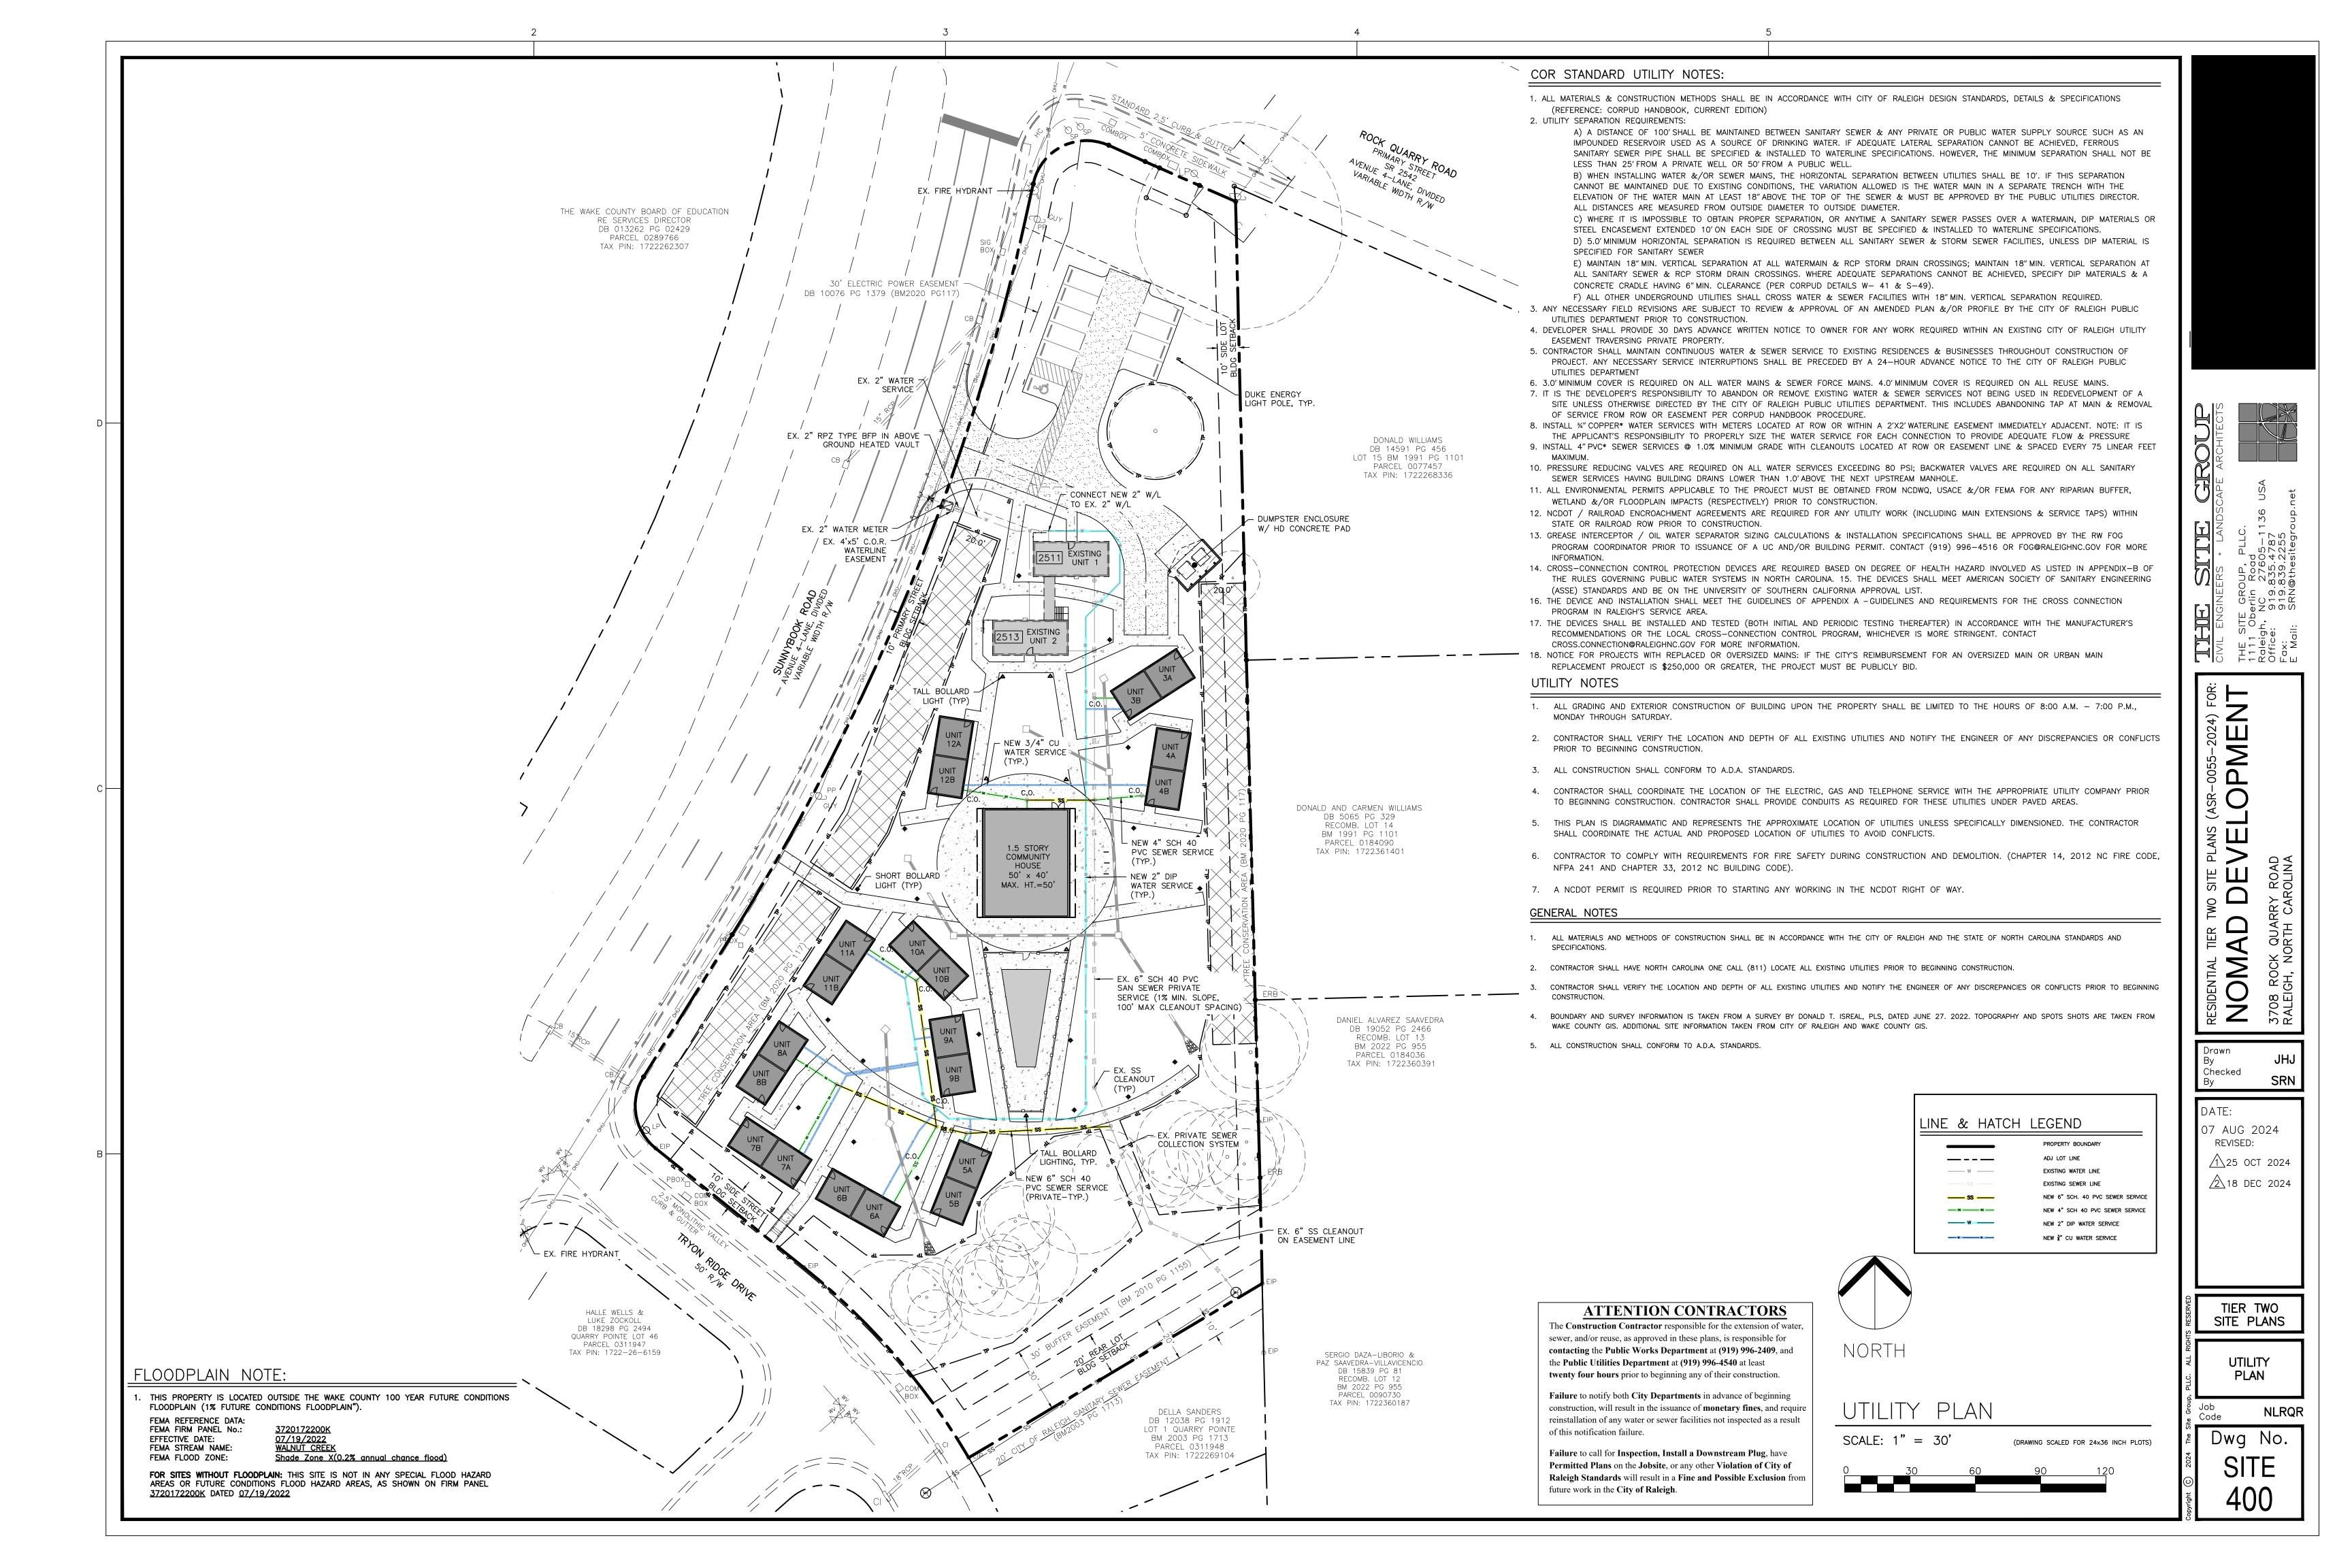

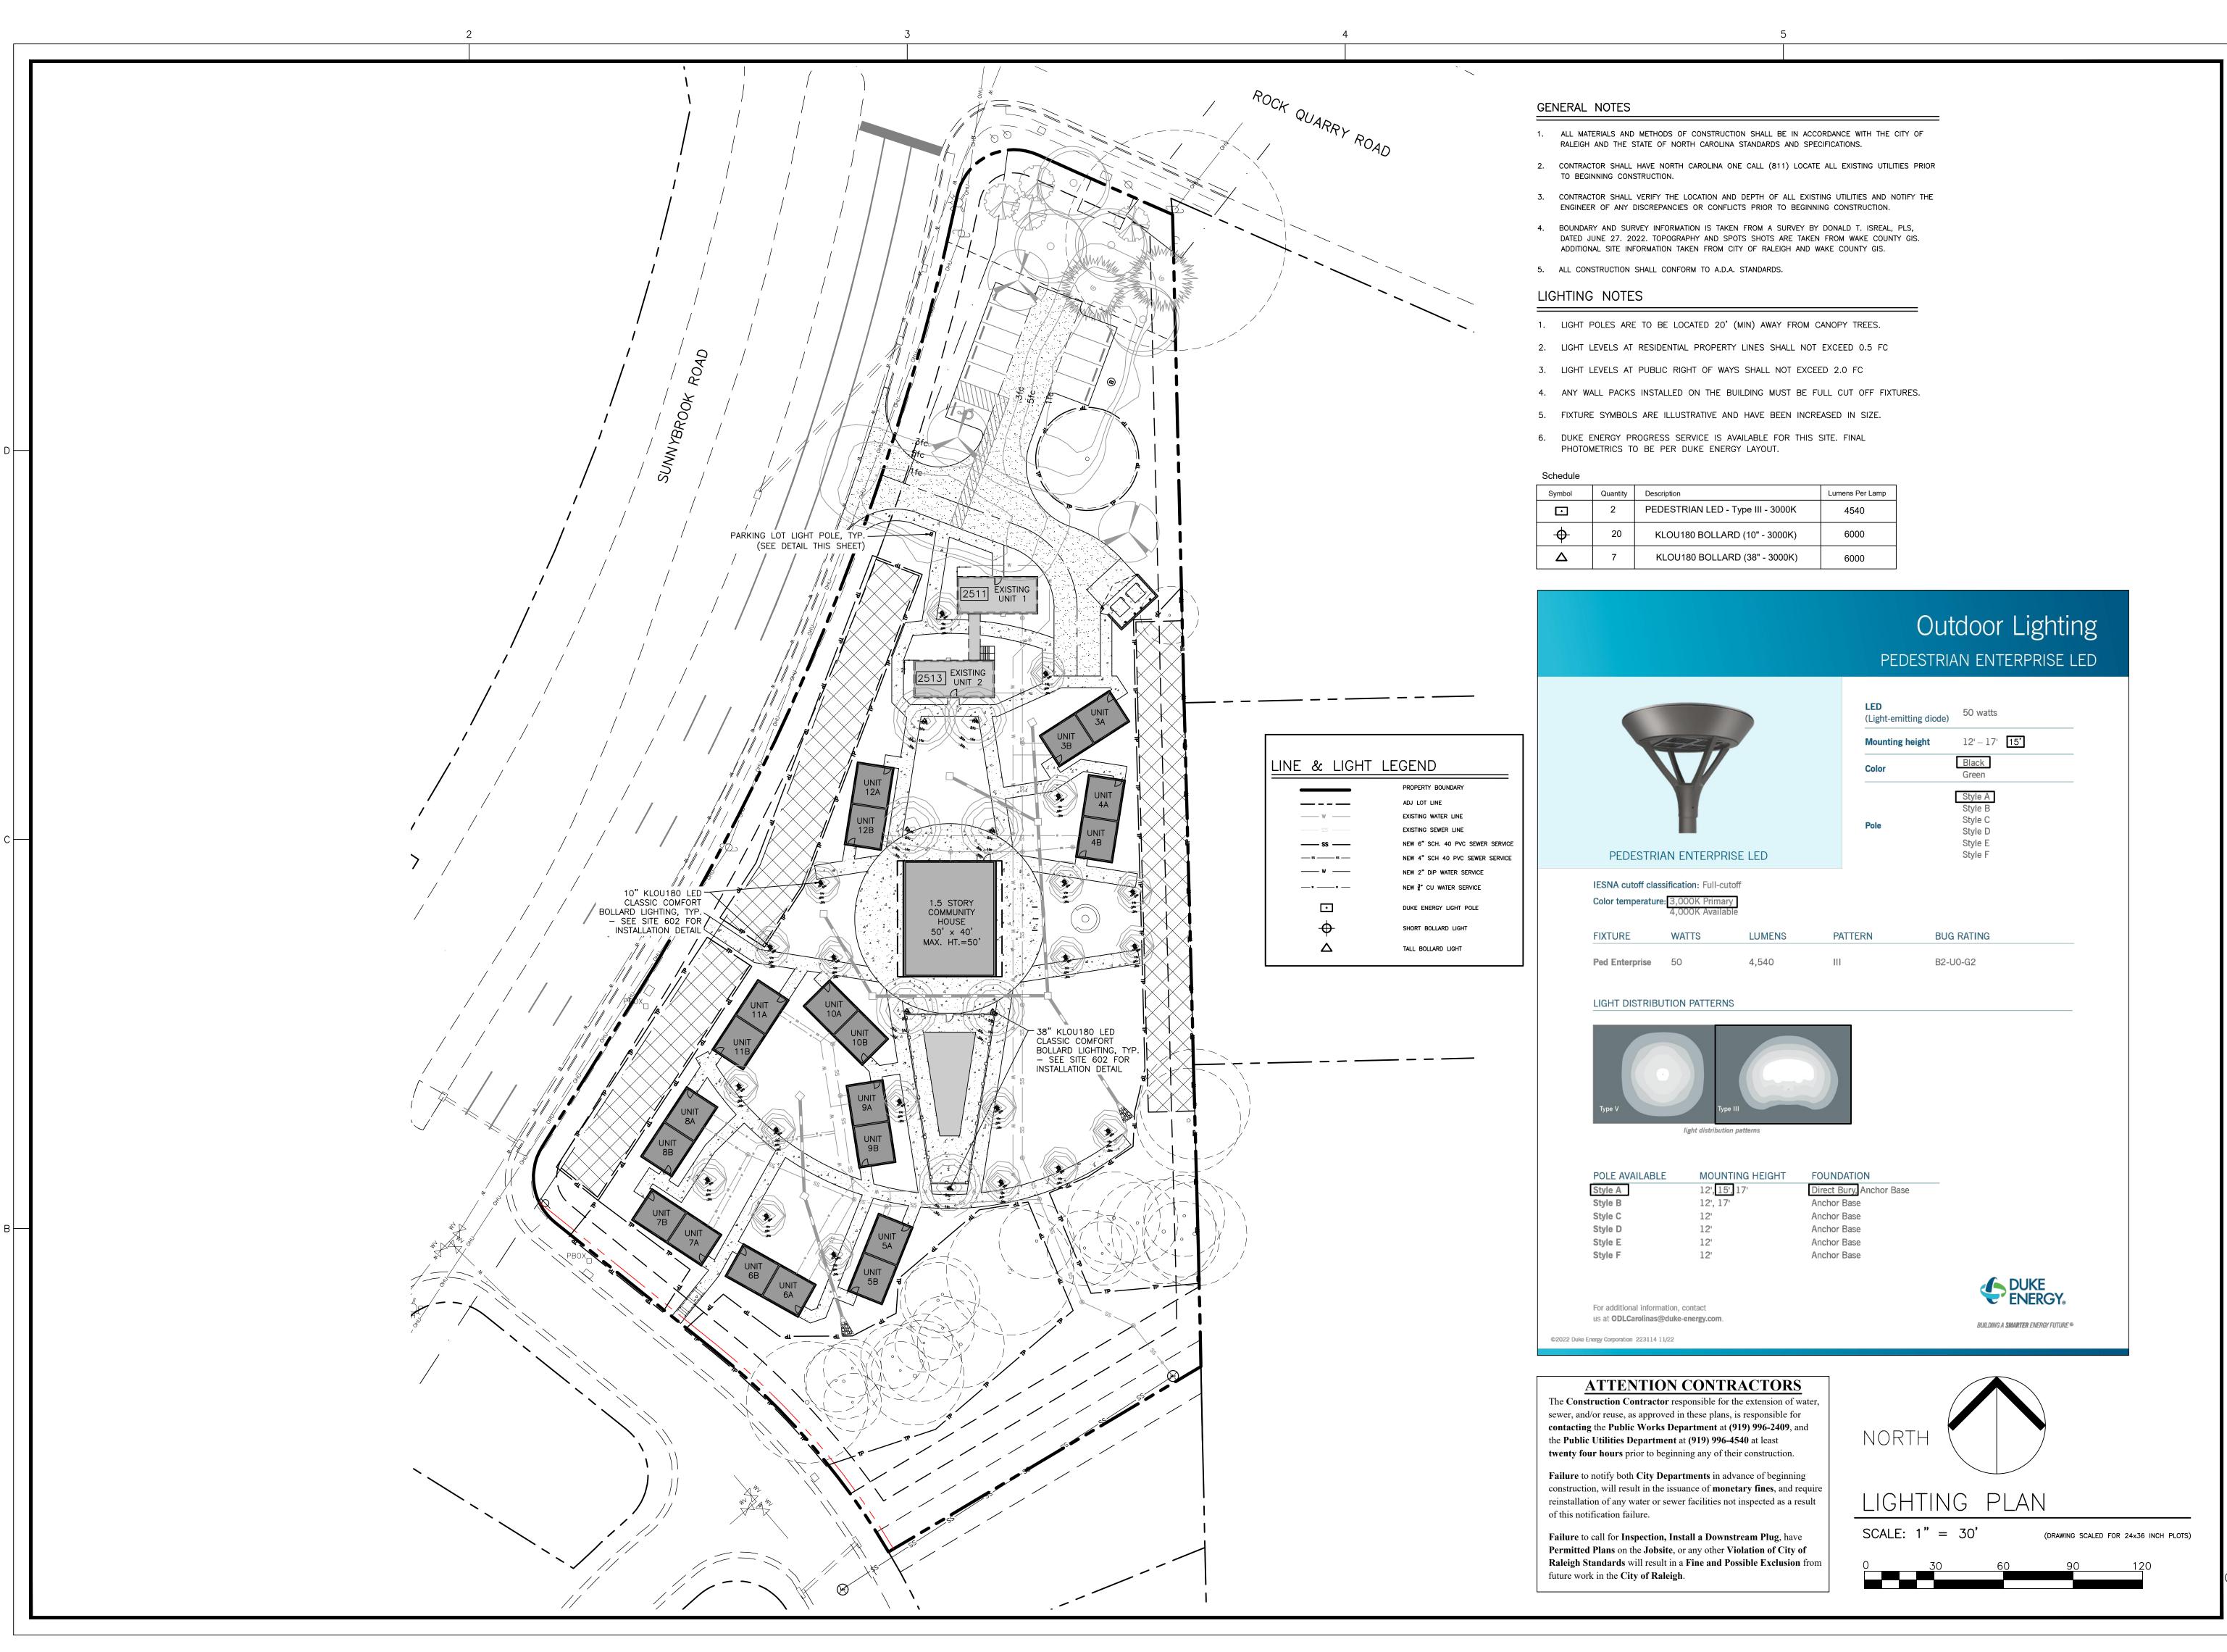

HITECTS HITECTS

LC.
1136 USA

E SITE GROUP, PLLC.
11 Oberlin Road
eigh, NC 27605-113
ice: 919.835.4787
:: 919.839.2255

ELOPMENT

FERMINE

FOR:

| Continuous contin

NAL DEVE Rock Quarry Road

Drawn
By
Checked
By
SRN

DATE: 25 OCT 2024 REVISED:


18 DEC 2024


TIER TWO SITE PLANS

LIGHTING PLAN

Dwg No.

SITE 401

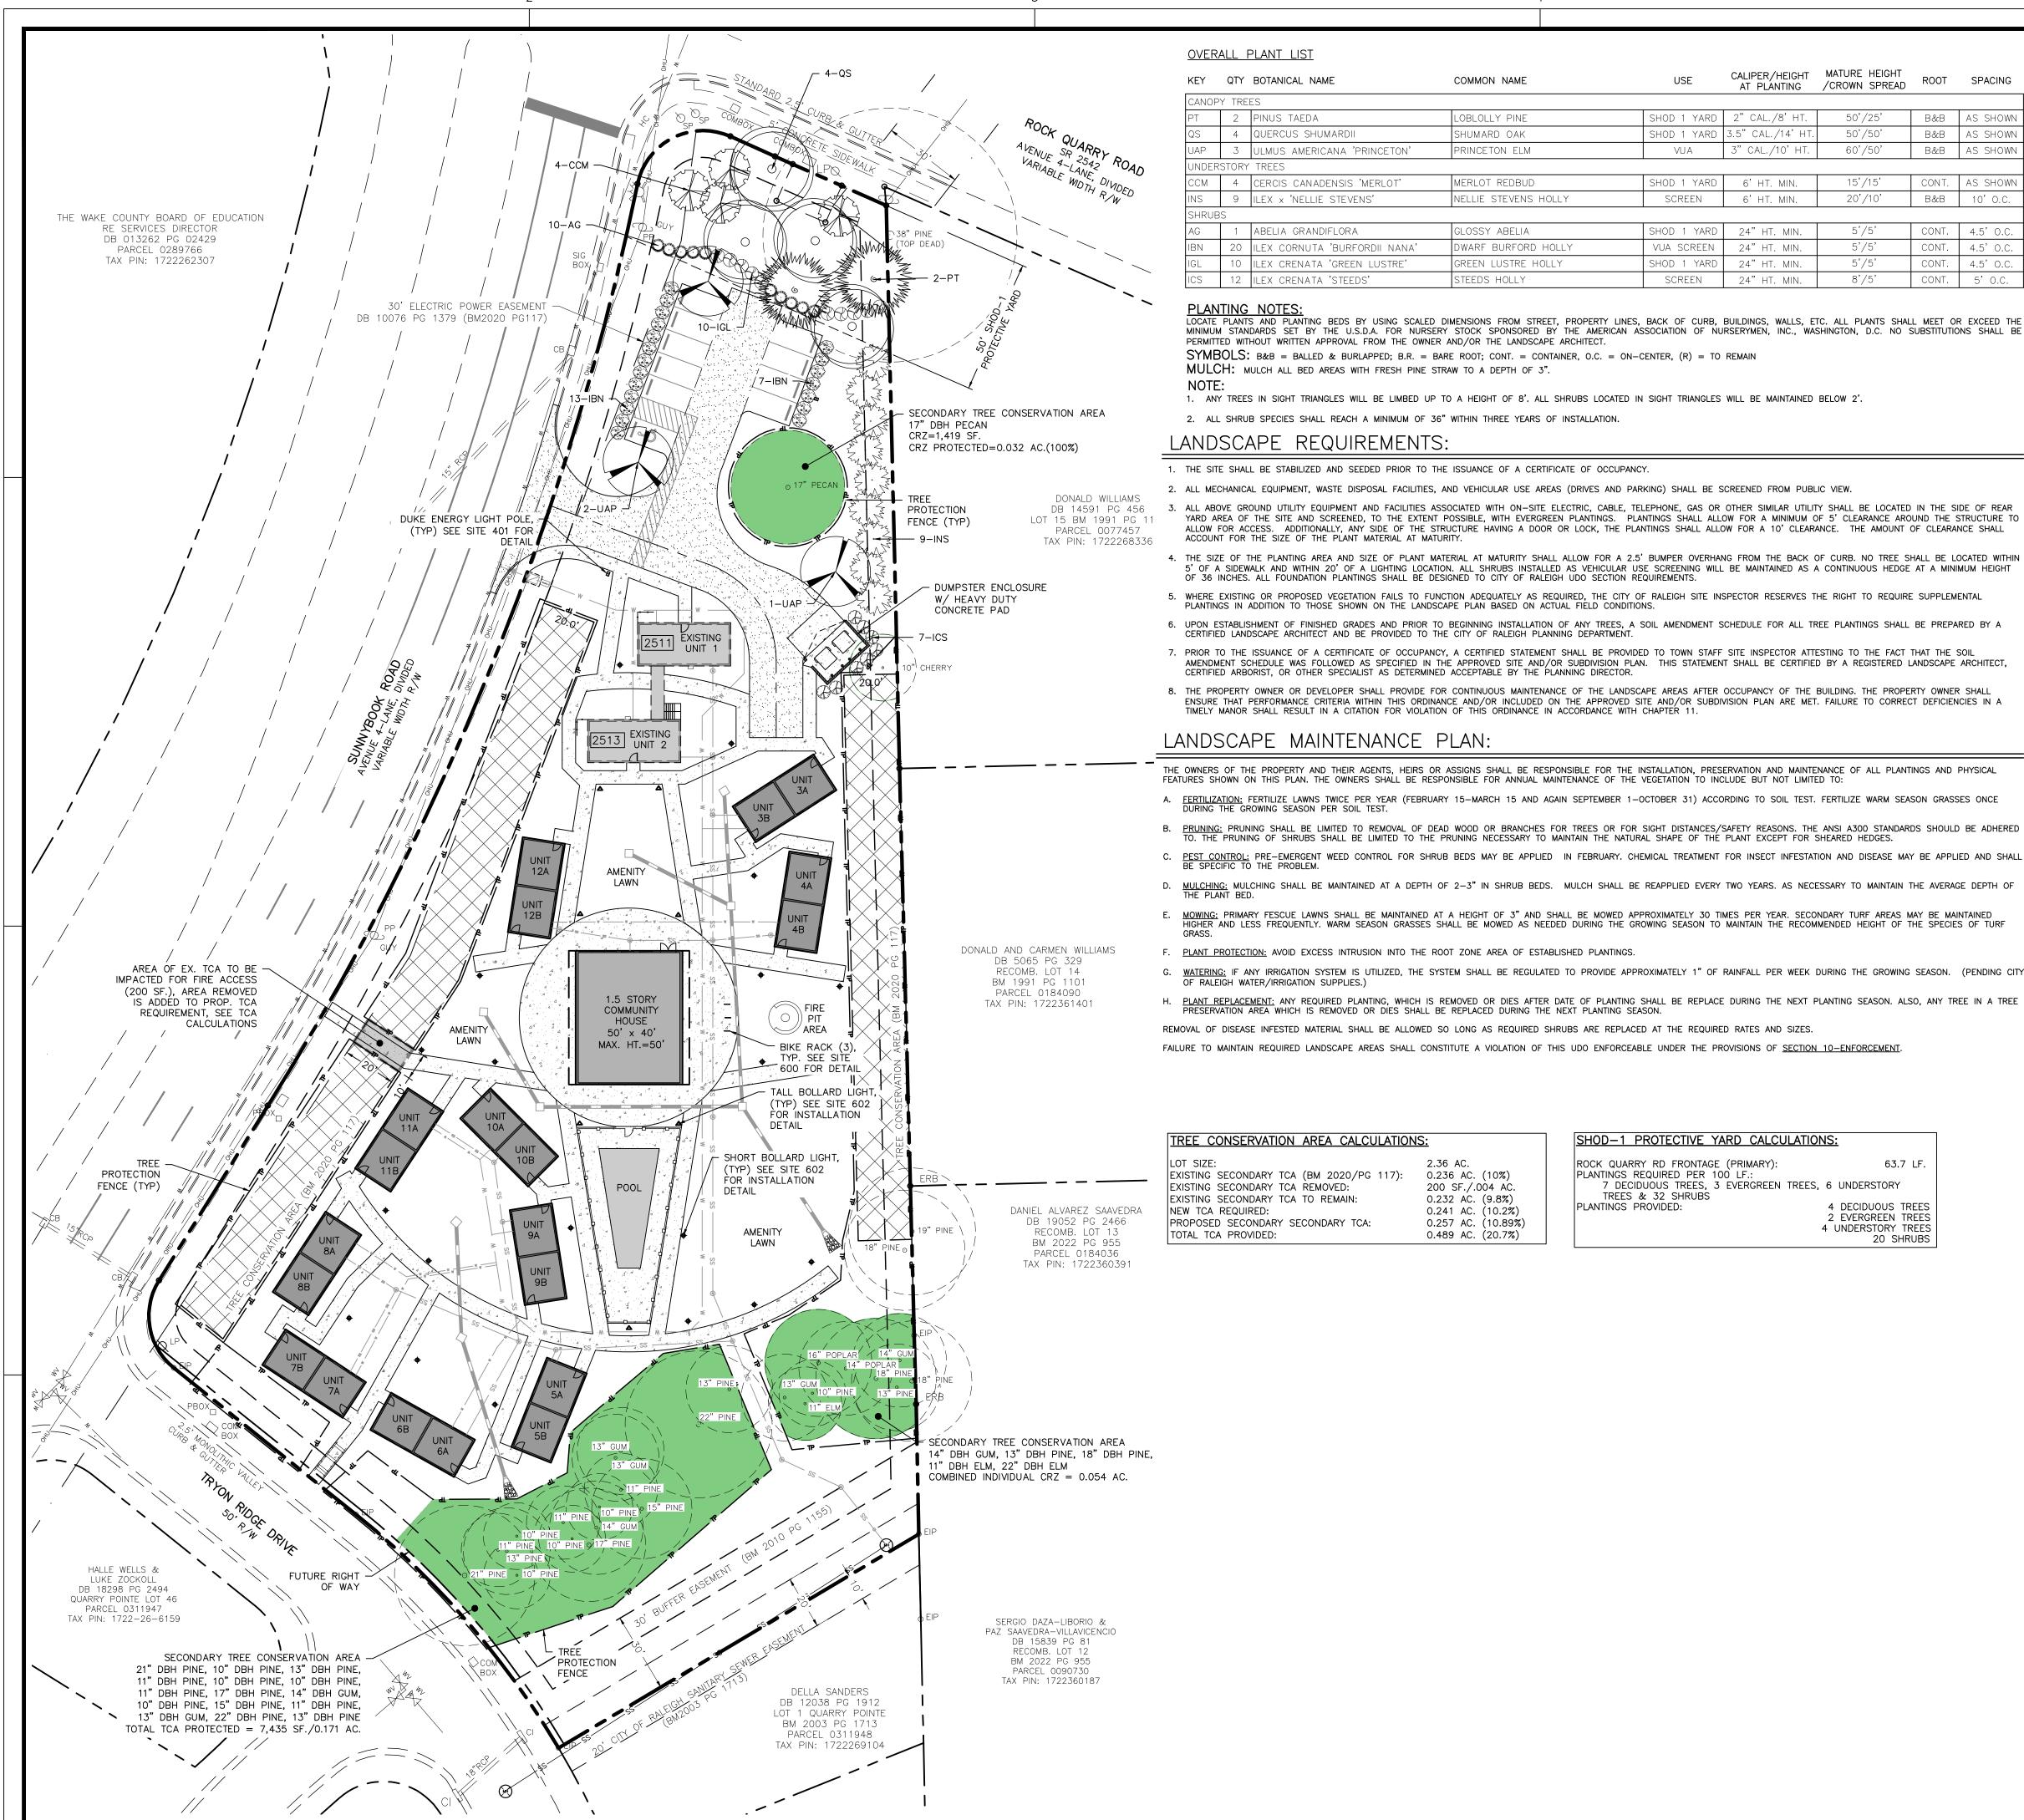

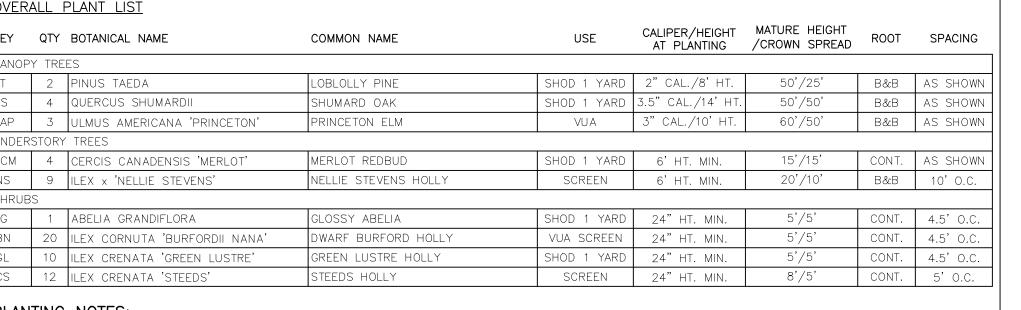

LOCATE PLANTS AND PLANTING BEDS BY USING SCALED DIMENSIONS FROM STREET, PROPERTY LINES, BACK OF CURB, BUILDINGS, WALLS, ETC. ALL PLANTS SHALL MEET OR EXCEED THE MINIMUM STANDARDS SET BY THE U.S.D.A. FOR NURSERY STOCK SPONSORED BY THE AMERICAN ASSOCIATION OF NURSERYMEN, INC., WASHINGTON, D.C. NO SUBSTITUTIONS SHALL BE PERMITTED WITHOUT WRITTEN APPROVAL FROM THE OWNER AND/OR THE LANDSCAPE ARCHITECT.

SYMBOLS: B&B = BALLED & BURLAPPED; B.R. = BARE ROOT; CONT. = CONTAINER, O.C. = ON-CENTER, (R) = TO REMAIN MULCH: MULCH ALL BED AREAS WITH FRESH PINE STRAW TO A DEPTH OF 3".

1. ANY TREES IN SIGHT TRIANGLES WILL BE LIMBED UP TO A HEIGHT OF 8'. ALL SHRUBS LOCATED IN SIGHT TRIANGLES WILL BE MAINTAINED BELOW 2'.

2. ALL SHRUB SPECIES SHALL REACH A MINIMUM OF 36" WITHIN THREE YEARS OF INSTALLATION.

1. THE SITE SHALL BE STABILIZED AND SEEDED PRIOR TO THE ISSUANCE OF A CERTIFICATE OF OCCUPANCY

2. ALL MECHANICAL EQUIPMENT, WASTE DISPOSAL FACILITIES, AND VEHICULAR USE AREAS (DRIVES AND PARKING) SHALL BE SCREENED FROM PUBLIC VIEW.

3. ALL ABOVE GROUND UTILITY EQUIPMENT AND FACILITIES ASSOCIATED WITH ON-SITE ELECTRIC, CABLE, TELEPHONE, GAS OR OTHER SIMILAR UTILITY SHALL BE LOCATED IN THE SIDE OF REAR YARD AREA OF THE SITE AND SCREENED, TO THE EXTENT POSSIBLE, WITH EVERGREEN PLANTINGS. PLANTINGS SHALL ALLOW FOR A MINIMUM OF 5' CLEARANCE AROUND THE STRUCTURE TO ALLOW FOR ACCESS. ADDITIONALLY, ANY SIDE OF THE STRUCTURE HAVING A DOOR OR LOCK, THE PLANTINGS SHALL ALLOW FOR A 10' CLEARANCE. THE AMOUNT OF CLEARANCE SHALL ACCOUNT FOR THE SIZE OF THE PLANT MATERIAL AT MATURITY.

5' OF A SIDEWALK AND WITHIN 20' OF A LIGHTING LOCATION. ALL SHRUBS INSTALLED AS VEHICULAR USE SCREENING WILL BE MAINTAINED AS A CONTINUOUS HEDGE AT A MINIMUM HEIGHT OF 36 INCHES. ALL FOUNDATION PLANTINGS SHALL BE DESIGNED TO CITY OF RALEIGH UDO SECTION REQUIREMENTS.

5. WHERE EXISTING OR PROPOSED VEGETATION FAILS TO FUNCTION ADEQUATELY AS REQUIRED, THE CITY OF RALEIGH SITE INSPECTOR RESERVES THE RIGHT TO REQUIRE SUPPLEMENTAL PLANTINGS IN ADDITION TO THOSE SHOWN ON THE LANDSCAPE PLAN BASED ON ACTUAL FIELD CONDITIONS.

6. UPON ESTABLISHMENT OF FINISHED GRADES AND PRIOR TO BEGINNING INSTALLATION OF ANY TREES, A SOIL AMENDMENT SCHEDULE FOR ALL TREE PLANTINGS SHALL BE PREPARED BY A CERTIFIED LANDSCAPE ARCHITECT AND BE PROVIDED TO THE CITY OF RALEIGH PLANNING DEPARTMENT.

7. PRIOR TO THE ISSUANCE OF A CERTIFICATE OF OCCUPANCY, A CERTIFIED STATEMENT SHALL BE PROVIDED TO TOWN STAFF SITE INSPECTOR ATTESTING TO THE FACT THAT THE SOIL AMENDMENT SCHEDULE WAS FOLLOWED AS SPECIFIED IN THE APPROVED SITE AND/OR SUBDIVISION PLAN. THIS STATEMENT SHALL BE CERTIFIED BY A REGISTERED LANDSCAPE ARCHITECT,

8. THE PROPERTY OWNER OR DEVELOPER SHALL PROVIDE FOR CONTINUOUS MAINTENANCE OF THE LANDSCAPE AREAS AFTER OCCUPANCY OF THE BUILDING. THE PROPERTY OWNER SHALL ENSURE THAT PERFORMANCE CRITERIA WITHIN THIS ORDINANCE AND/OR INCLUDED ON THE APPROVED SITE AND/OR SUBDIVISION PLAN ARE MET. FAILURE TO CORRECT DEFICIENCIES IN A TIMELY MANOR SHALL RESULT IN A CITATION FOR VIOLATION OF THIS ORDINANCE IN ACCORDANCE WITH CHAPTER 11.

LANDSCAPE MAINTENANCE PLAN:

THE OWNERS OF THE PROPERTY AND THEIR AGENTS, HEIRS OR ASSIGNS SHALL BE RESPONSIBLE FOR THE INSTALLATION, PRESERVATION AND MAINTENANCE OF ALL PLANTINGS AND PHYSICAL FEATURES SHOWN ON THIS PLAN. THE OWNERS SHALL BE RESPONSIBLE FOR ANNUAL MAINTENANCE OF THE VEGETATION TO INCLUDE BUT NOT LIMITED TO:

A. <u>FERTILIZATION:</u> FERTILIZE LAWNS TWICE PER YEAR (FEBRUARY 15-MARCH 15 AND AGAIN SEPTEMBER 1-OCTOBER 31) ACCORDING TO SOIL TEST. FERTILIZE WARM SEASON GRASSES ONCE DURING THE GROWING SEASON PER SOIL TEST.

B. <u>PRUNING:</u> PRUNING SHALL BE LIMITED TO REMOVAL OF DEAD WOOD OR BRANCHES FOR TREES OR FOR SIGHT DISTANCES/SAFETY REASONS. THE ANSI A300 STANDARDS SHOULD BE ADHERED TO. THE PRUNING OF SHRUBS SHALL BE LIMITED TO THE PRUNING NECESSARY TO MAINTAIN THE NATURAL SHAPE OF THE PLANT EXCEPT FOR SHEARED HEDGES.

C. <u>PEST CONTROL:</u> PRE-EMERGENT WEED CONTROL FOR SHRUB BEDS MAY BE APPLIED IN FEBRUARY. CHEMICAL TREATMENT FOR INSECT INFESTATION AND DISEASE MAY BE APPLIED AND SHALL BE SPECIFIC TO THE PROBLEM.

D. MULCHING: MULCHING SHALL BE MAINTAINED AT A DEPTH OF 2-3" IN SHRUB BEDS. MULCH SHALL BE REAPPLIED EVERY TWO YEARS. AS NECESSARY TO MAINTAIN THE AVERAGE DEPTH OF THE PLANT BED.

E. MOWING: PRIMARY FESCUE LAWNS SHALL BE MAINTAINED AT A HEIGHT OF 3" AND SHALL BE MOWED APPROXIMATELY 30 TIMES PER YEAR. SECONDARY TURF AREAS MAY BE MAINTAINED HIGHER AND LESS FREQUENTLY. WARM SEASON GRASSES SHALL BE MOWED AS NEEDED DURING THE GROWING SEASON TO MAINTAIN THE RECOMMENDED HEIGHT OF THE SPECIES OF TURF

F. PLANT PROTECTION: AVOID EXCESS INTRUSION INTO THE ROOT ZONE AREA OF ESTABLISHED PLANTINGS.

G. WATERING: IF ANY IRRIGATION SYSTEM IS UTILIZED, THE SYSTEM SHALL BE REGULATED TO PROVIDE APPROXIMATELY 1" OF RAINFALL PER WEEK DURING THE GROWING SEASON. (PENDING CITY

H. <u>PLANT REPLACEMENT:</u> ANY REQUIRED PLANTING, WHICH IS REMOVED OR DIES AFTER DATE OF PLANTING SHALL BE REPLACE DURING THE NEXT PLANTING SEASON. ALSO, ANY TREE IN A TREE PRESERVATION AREA WHICH IS REMOVED OR DIES SHALL BE REPLACED DURING THE NEXT PLANTING SEASON.

REMOVAL OF DISEASE INFESTED MATERIAL SHALL BE ALLOWED SO LONG AS REQUIRED SHRUBS ARE REPLACED AT THE REQUIRED RATES AND SIZES.

FAILURE TO MAINTAIN REQUIRED LANDSCAPE AREAS SHALL CONSTITUTE A VIOLATION OF THIS UDO ENFORCEABLE UNDER THE PROVISIONS OF SECTION 10-ENFORCEMENT.


TREE CONSERVATION AREA CALCULATIONS: 2.36 AC. 0.236 AC. (10%)

200 SF./.004 AC. 0.232 AC. (9.8%) 0.241 AC. (10.2%) 0.257 AC. (10.89%) 0.489 AC. (20.7%)

SHOD-1 PROTECTIVE YARD CALCULATIONS: ROCK QUARRY RD FRONTAGE (PRIMARY): 63.7 LF. PLANTINGS REQUIRED PER 100 LF.: 7 DECIDUOUS TREES, 3 EVERGREEN TREES, 6 UNDERSTORY TREES & 32 SHRUBS PLANTINGS PROVIDED: 4 DECIDUOUS TREES 2 EVERGREEN TREES

4 UNDERSTORY TREES

20 SHRUBS

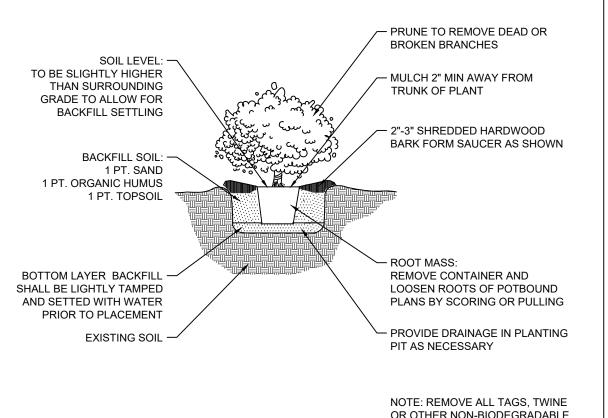

1. TO PROMOTE AERATION AND PERCOLATION IN HEAVY SOIL, PLANT ROOTBALL ABOVE EXISTING GRADE AS SHOWN.

2. PROVIDE AN EARTH SAUCER FOR WATER RETENTION.

3. BACKFILL WITH 80% PARENT MATERIAL AND 20% DECOMPOSED ORGANIC MATERIAL BY VOLUME WELL MIXED AS APPROVED BY THE ARCHITECT.


OF ROOTBALL TO PROMOTE RAPID REESTABLISHMENT.

4. PROVIDE 6" MINIMUM OF BACKFILL ON EACH SIDE

5. PROVIDE MINIMUM 4" THICK PINE STRAW IN 5' WIDE PLANTING BED OR AS DIRECTED ON PLANS.

6. SHRUBS WILL HAVE A MINIMUM 1 YEAR WARRANTY FROM DATE OF INSTALLATION.

OR OTHER NON-BIODEGRADABLE MATERIALS ATTACHED TO PLANT OR ROOT MASS SHRUB PLANTING DETAIL SPD-01

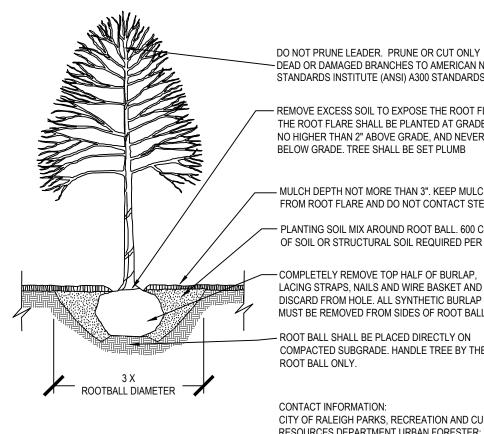

- DEAD OR DAMAGED BRANCHES TO AMERICAN NATIONAL STANDARDS INSTITUTE (ANSI) A300 STANDARDS - REMOVE EXCESS SOIL TO EXPOSE THE ROOT FLARE. THE ROOT FLARE SHALL BE PLANTED AT GRADE, NO HIGHER THAN 2" ABOVE GRADE, AND NEVER BELOW GRADE. TREE SHALL BE SET PLUMB

– MULCH DEPTH NOT MORE THAN 3". KEEP MULCH 3" FROM ROOT FLARE AND DO NOT CONTACT STEM - PLANTING SOIL MIX AROUND ROOT BALL. 600 CU FT OF SOIL OR STRUCTURAL SOIL REQUIRED PER TREE - COMPLETELY REMOVE TOP HALF OF BURLAP. LACING STRAPS NAILS AND WIRE BASKET AND

DISCARD FROM HOLE. ALL SYNTHETIC BURLAP MUST BE REMOVED FROM SIDES OF ROOT BALL. ROOT BALL SHALL BE PLACED DIRECTLY ON COMPACTED SUBGRADE. HANDLE TREE BY THE ROOT BALL ONLY.

CONTACT INFORMATION: CITY OF RALEIGH PARKS, RECREATION AND CULTURAL RESOURCES DEPARTMENT URBAN FORESTER: TREES@RALEIGHNC.GOV WWW.RALEIGHNC.GOV

CITY OF RALEIGH

1. TREES MUST MEET THE TREE QUALITY STANDARDS

IN CH. 2 OF THE CITY TREE MANUAL 2. CONTRACTOR IS RESPONSIBLE FOR ADEQUATE DRAINAGE OF ALL PLANTING PITS.

(POSITIVE DRAINAGE AWAY FROM PIT)

3. TREES SHALL BE PLANTED BETWEEN OCTOBER 1ST AND APRIL 30TH.

4. A TREE IMPACT PERMIT IS REQUIRED. 5. ELECTRICAL OUTLETS AND OTHER UTILITIES

ARE PROHIBITED IN THE PLANTING AREA


IMMEDIATELY SURROUNDING THE TREE. 6. IF STAKING IN ACCORDANCE WITH THE CITY

STANDARD DETAIL TREE MANUAL, THE STAKING MUST BE REMOVED WITHIN ONE YEAR. TREE PLANTING DETAIL 7. TREES WILL HAVE A MINIMUM 1 YEAR WARRANTY AFTER THE INITIAL PLANTING IS APPROVED BY THE CITY. TPP-03



TREE CONSERVATION

& LANDSCAPE PLAN SCALE: 1" = 30'

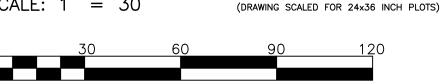

TIER TWO SITE PLANS

Drawn

Checked

DATE:

77 AUG 2024

<u>∕1</u>\25 OCT 2024

2\18 DEC 2024

REVISED:


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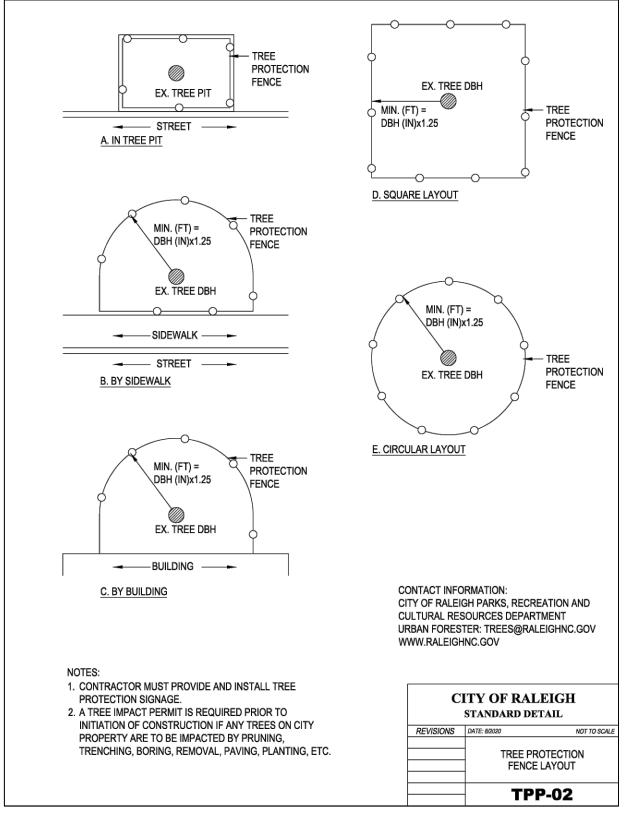
TREE CONSERVATION & LANDSCAPE PLAN

NLRQR Code

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Dwg No. SITE




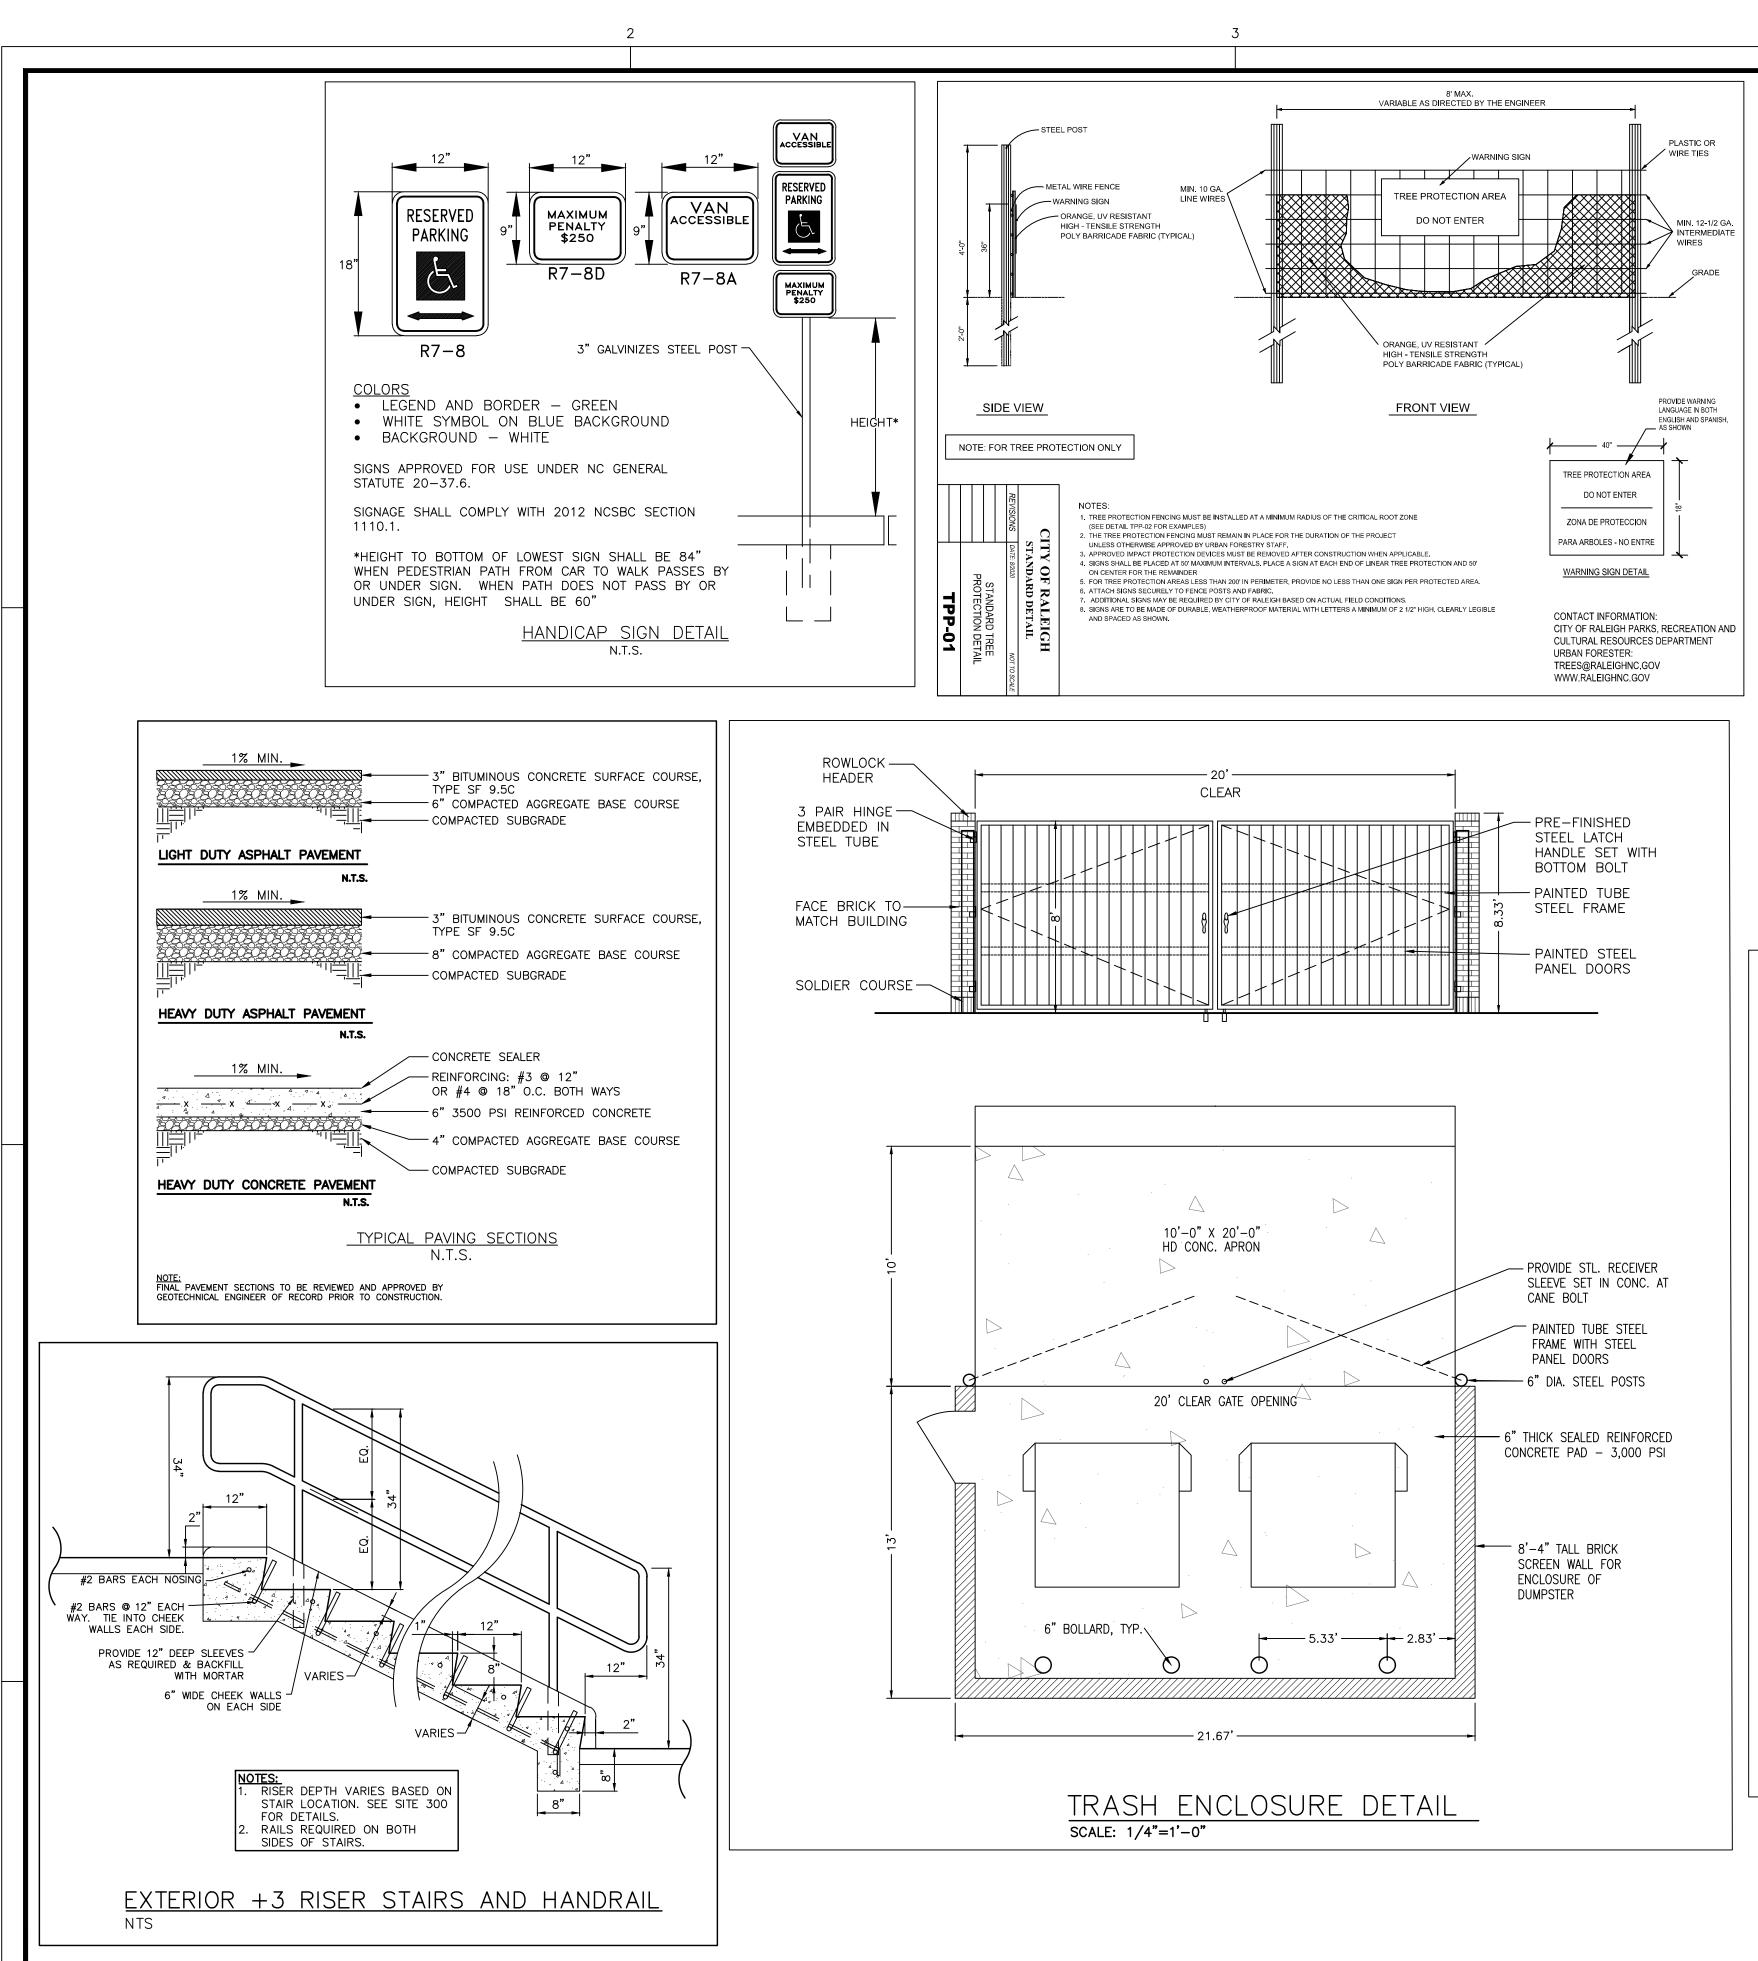

IN-GROUND MOUNT

33-36"

STANDARD BIKE RACK

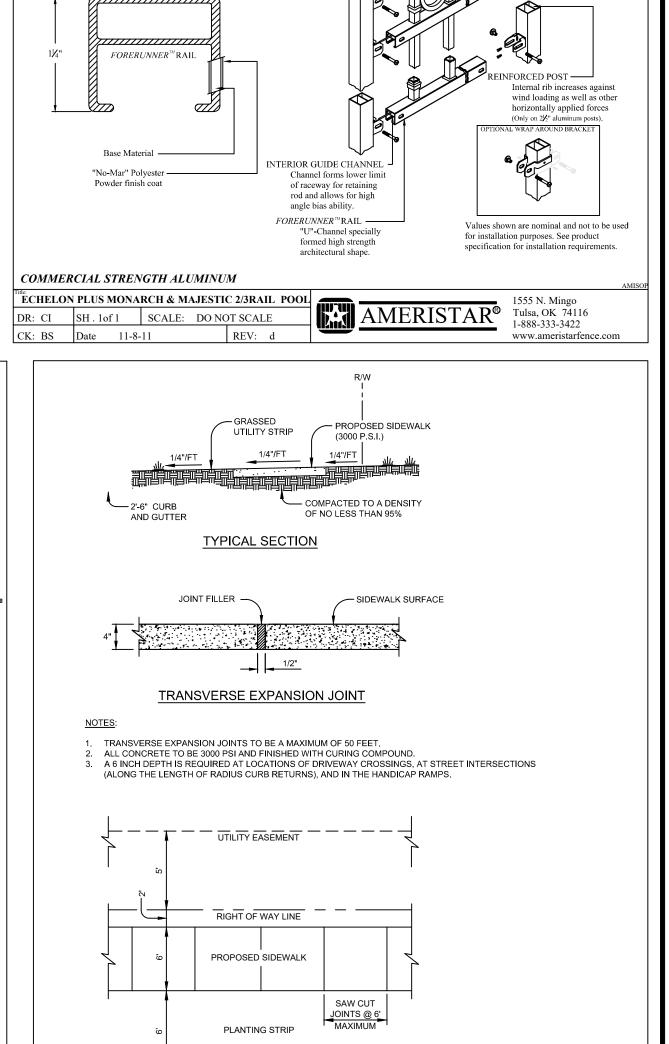

Standard Height

Standard Height

Footing depth

Held in place with upper and lower

INTERNAL RETAINING ROD

Variable pitch connection system for ease of installation, high angle

bias ability and elimination of

unsightly external fasteners.

internal retaining rods to eliminate

unsightly external fasteners.

RING OPTION

SURFACE MOUNT

BIKE RACK INSTALLATION:

ENSURE VERTICAL PLACEMENT.

SURFACE MOUNT - WHEN INSTALLED ON CONCRETE SURFACE, USE 3/8" ANCHORS TO PLATE MOUNT. SHIM AS NECESSARY TO

IN-GROUND MOUNT - WHEN INSTALLED ON

EMBED INTO BASE. CORE HOLES NO LESS

THAN 3" IN DIAMETER AND 10" DEEP.

PAVERS OR OTHER NON-STABLE SURFACES,

CITY OF RALEIGH

STANDARD DETAIL

BIKE RACK DETAILS

B-20.03

→ 3¹¾₆"TYPICAL

1.) Post size depends on fence height and wind loads.

PANEL BRACKET —

Specially designed two


fixity of rail ends for

See ECHELON Plus ™ post sizing chart. 2.) Panels also available for 6' on center post spacing3.) Monarch is 2 rail, and Majestic is 3 rail style. Ring Option - Majestic only

Post size varies with Height

Bracket Options

1½" x 1½6" FORERUNNER^{CM} Rail (See Cross- Section Reform)

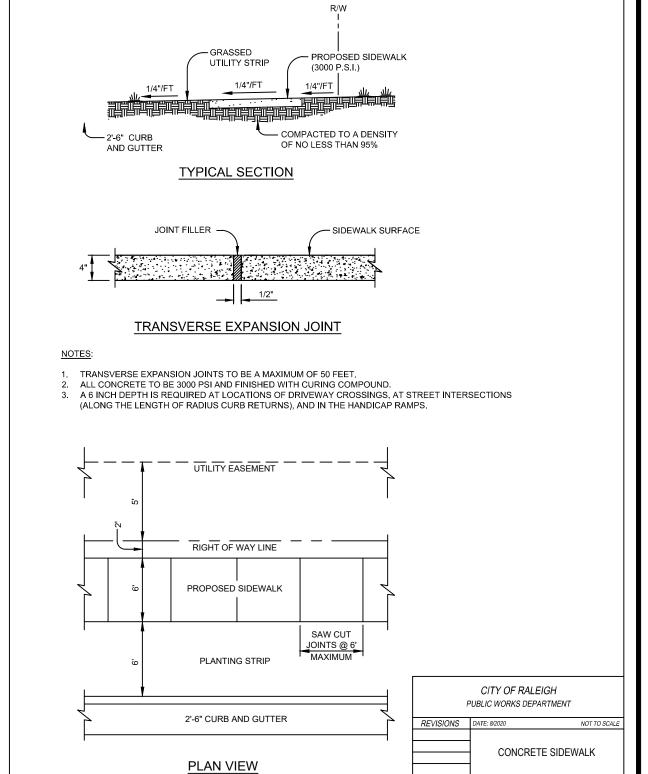

SITE DETAILS

Drawn

Checked

07 AUG 2024

125 OCT 2024

2 18 DEC 2024

TIER TWO

SITE PLANS

REVISED:


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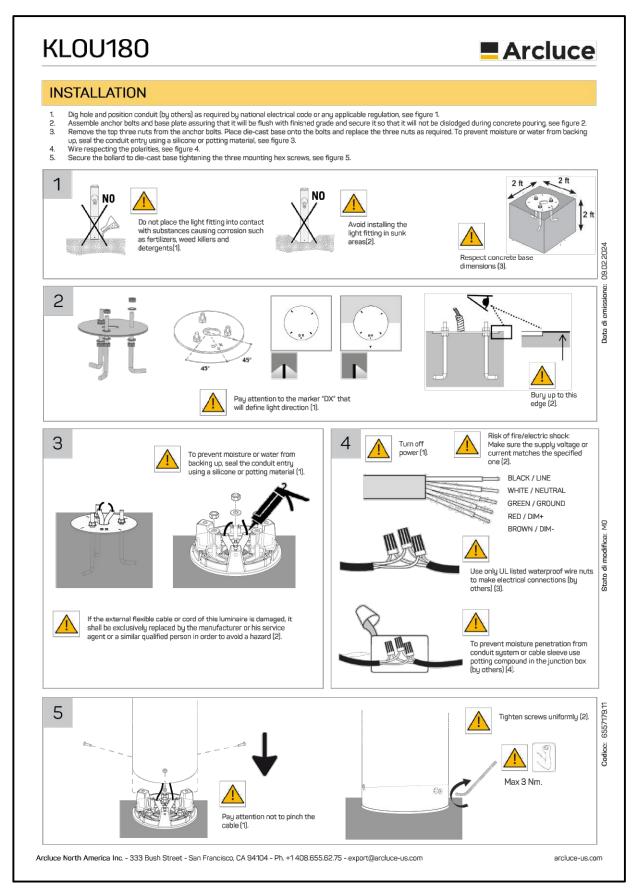
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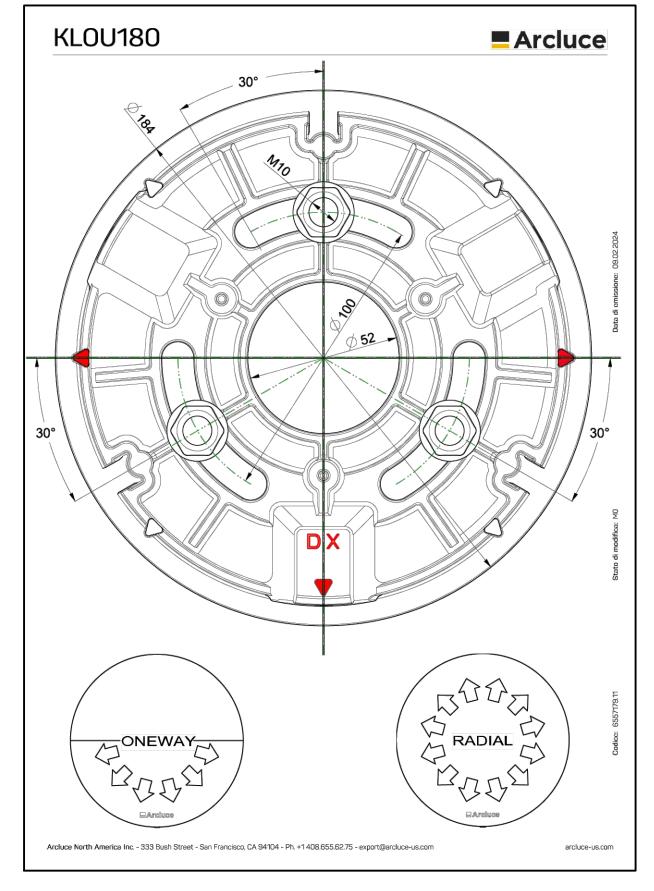
ALL CONSTRUCTION SHALL BE IN ACCORDANCE WITH CITY OF RALEIGH STANDARDS AND SPECIFICATIONS.


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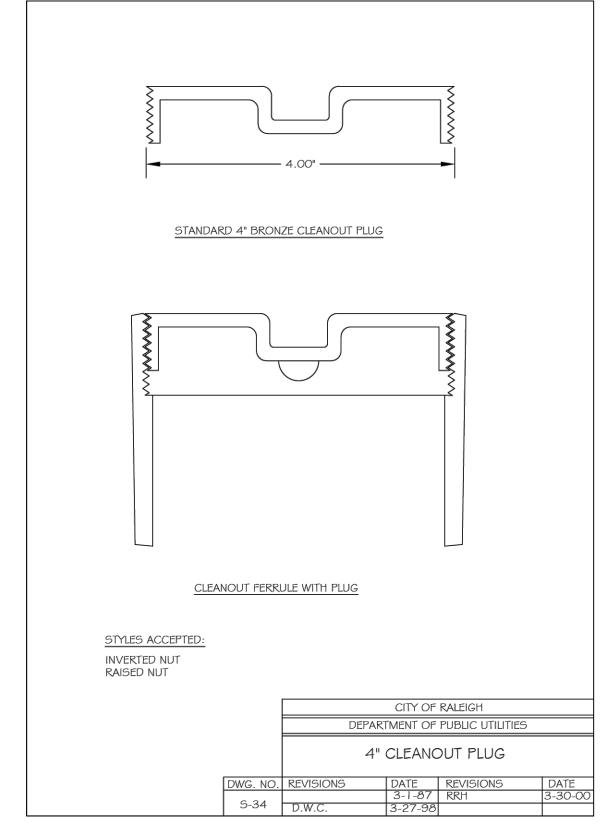









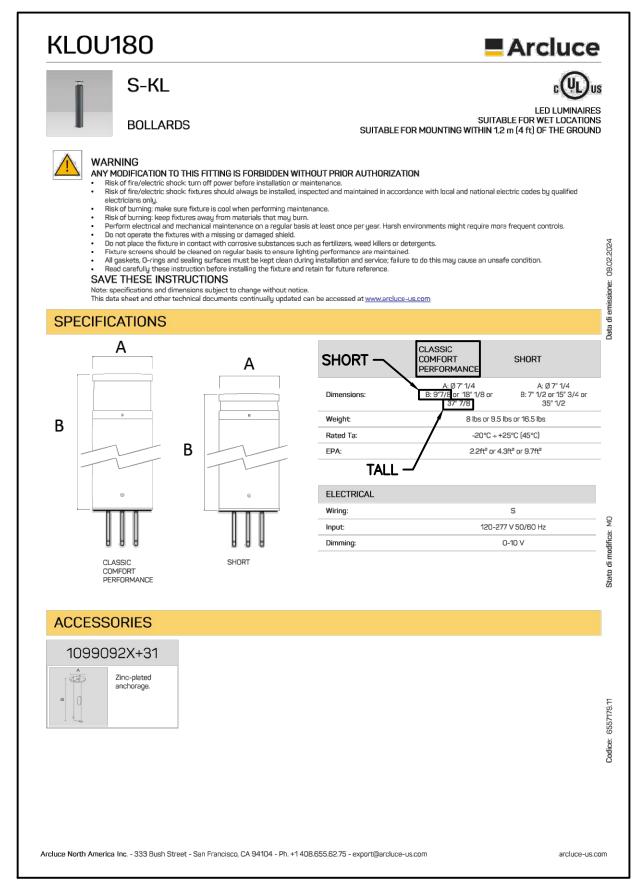

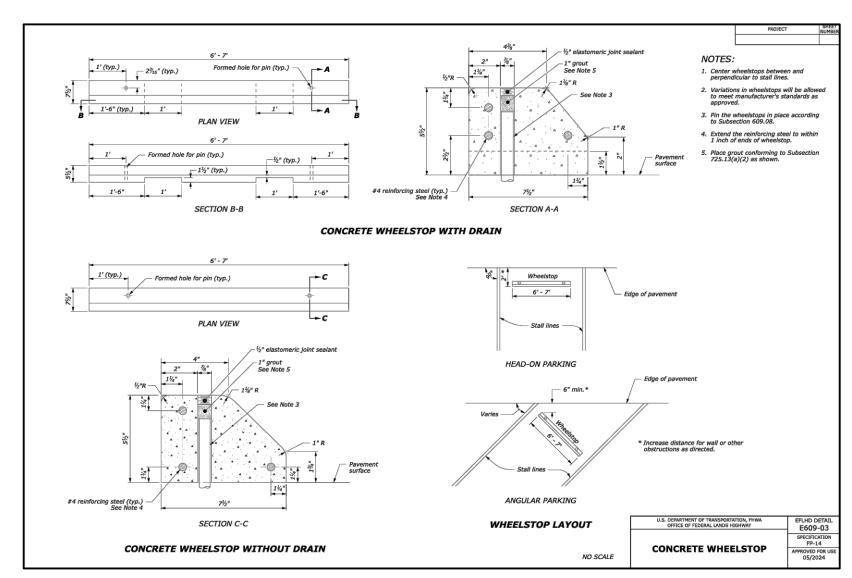

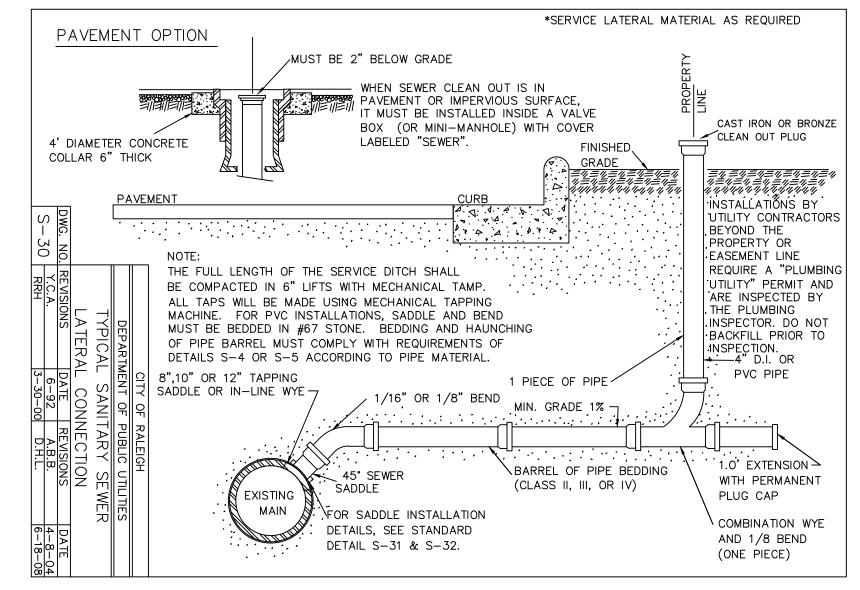



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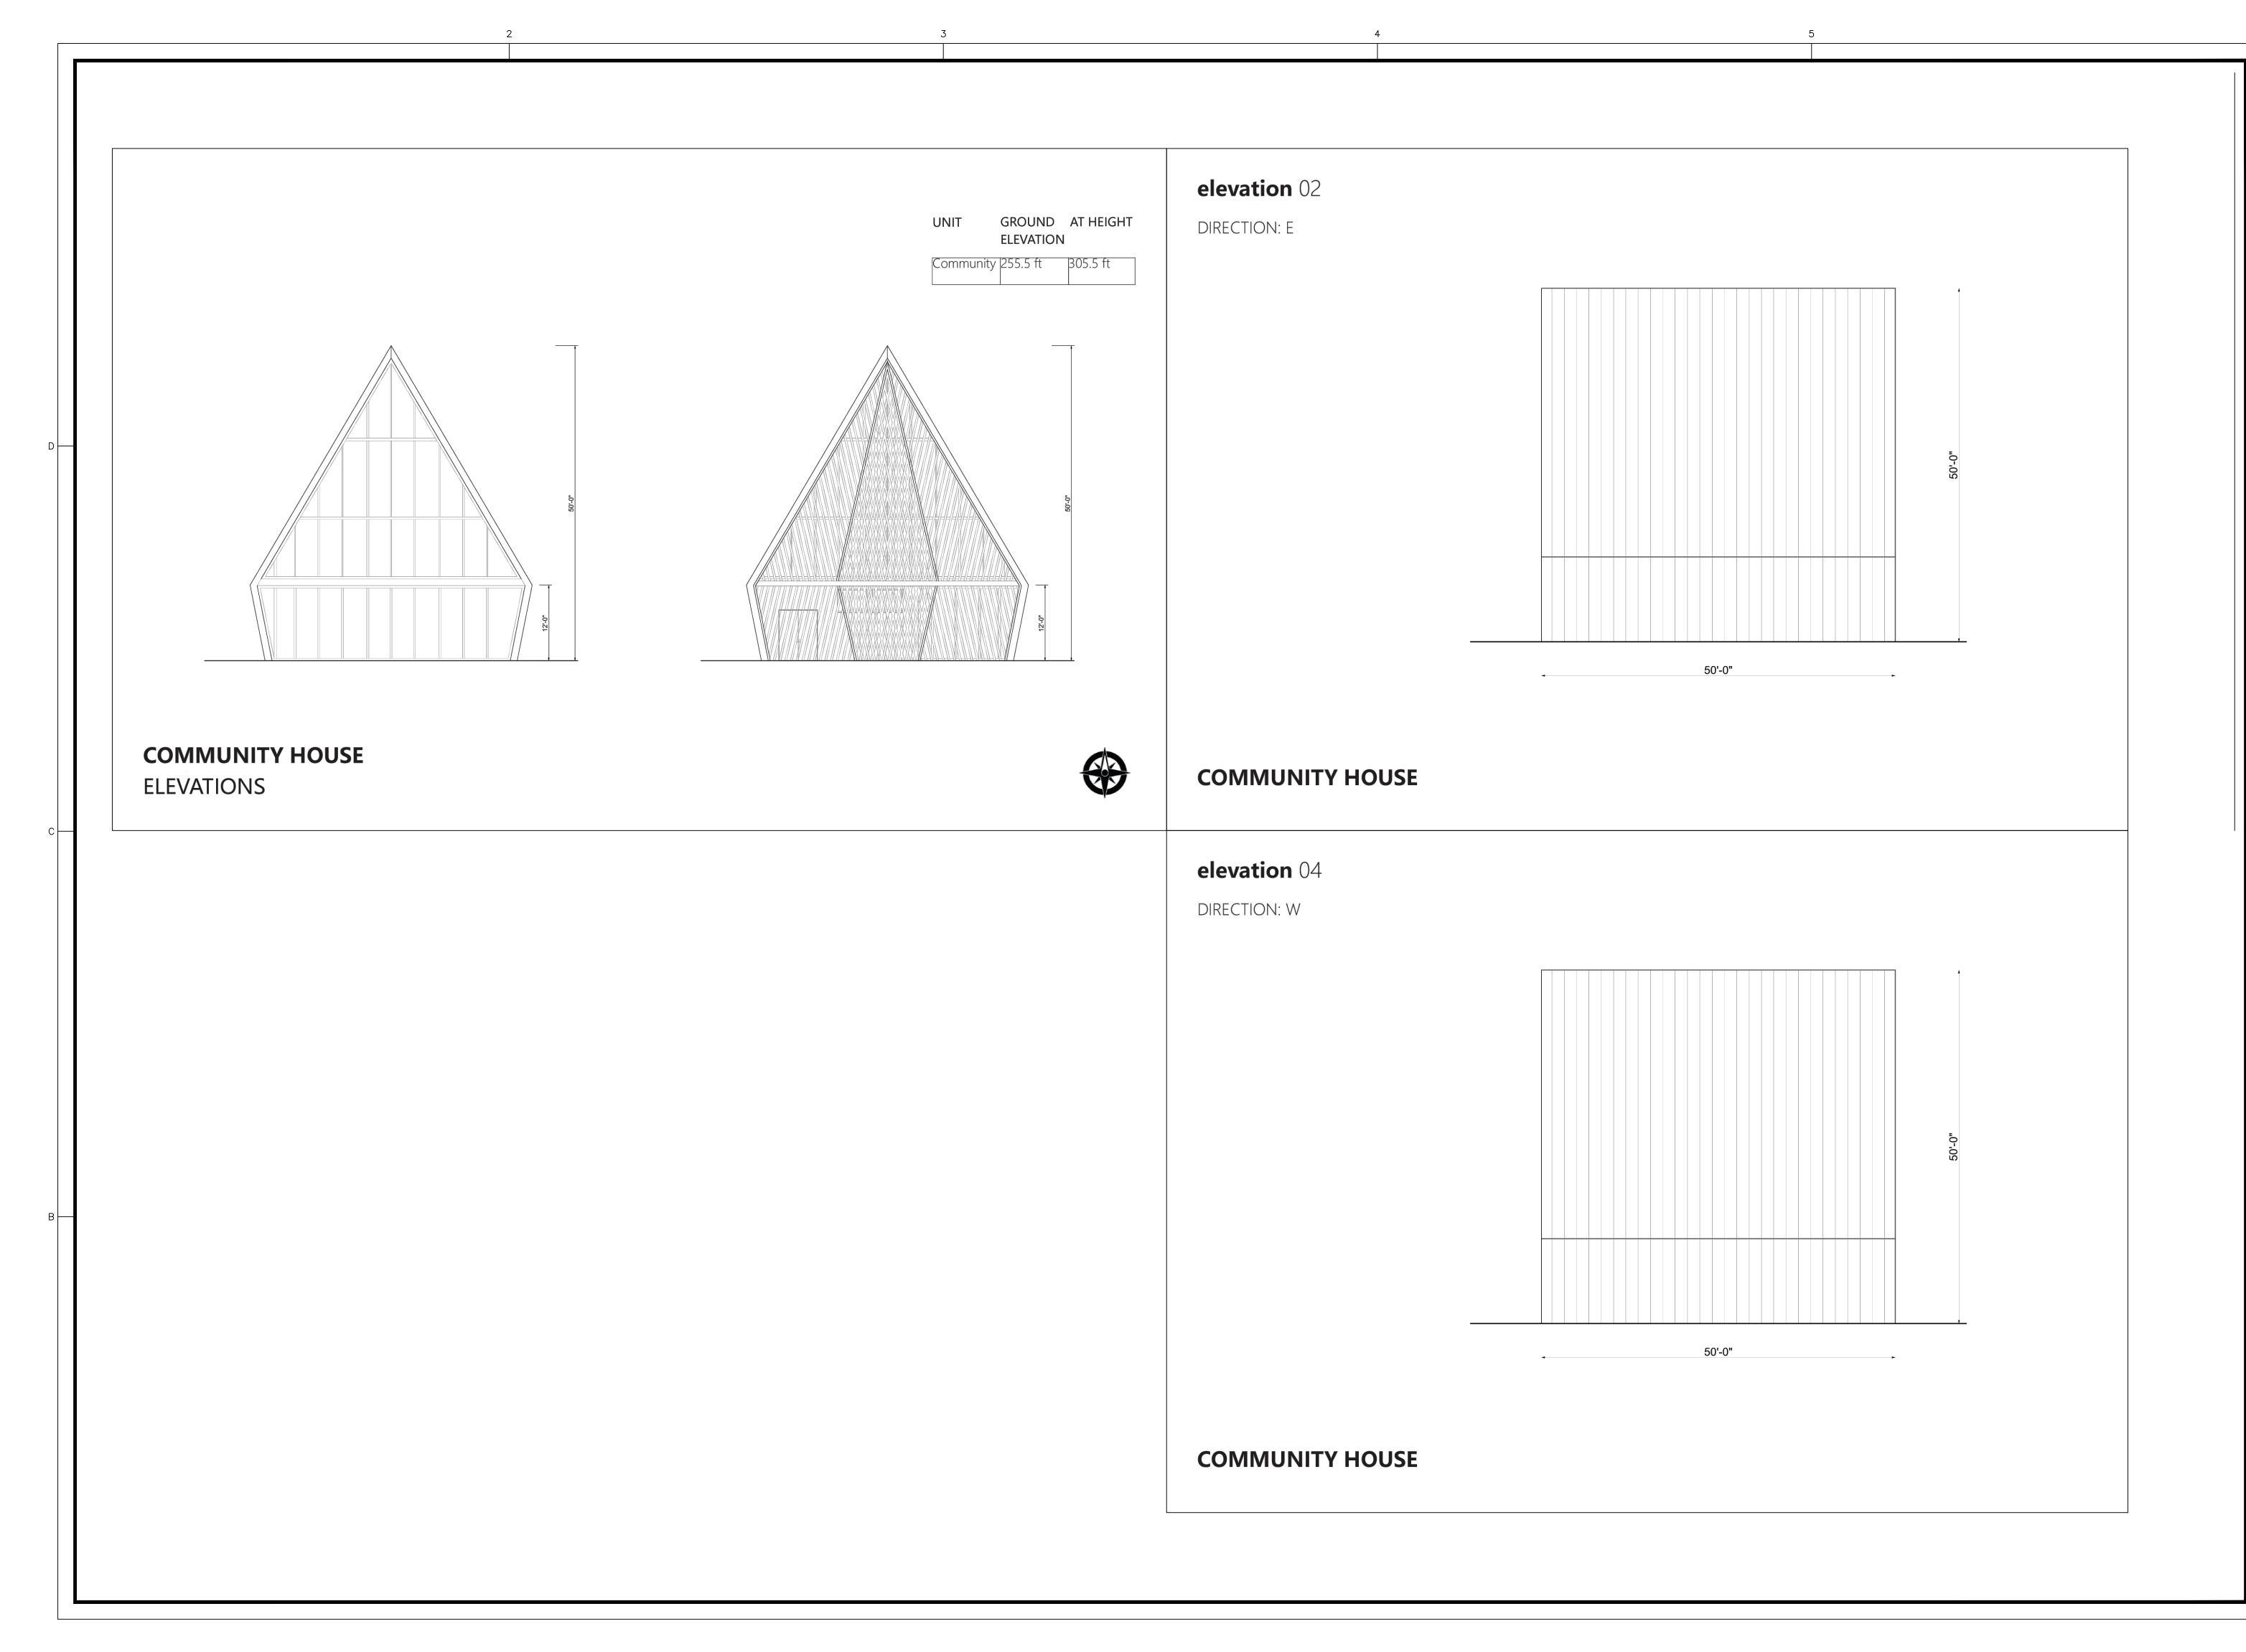
25 OCT 2025 REVISED: 18 DEC 2024

TIER TWO SITE PLANS

SITE DETAILS

Dwg No.
SITE

ALL CONSTRUCTION SHALL BE IN ACCORDANCE WITH CITY OF RALEIGH STANDARDS AND SPECIFICATIONS.



RESIDENTIAL TIER TWO SITE PLANS (ASR-0055-2024) FOR NOMAD DEVELOPMENT

07 AUG 2024 REVISED:


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TIER ONE SITE PLANS

ARCHITECTURAL ELEVATIONS

Dwg No.


ARCH

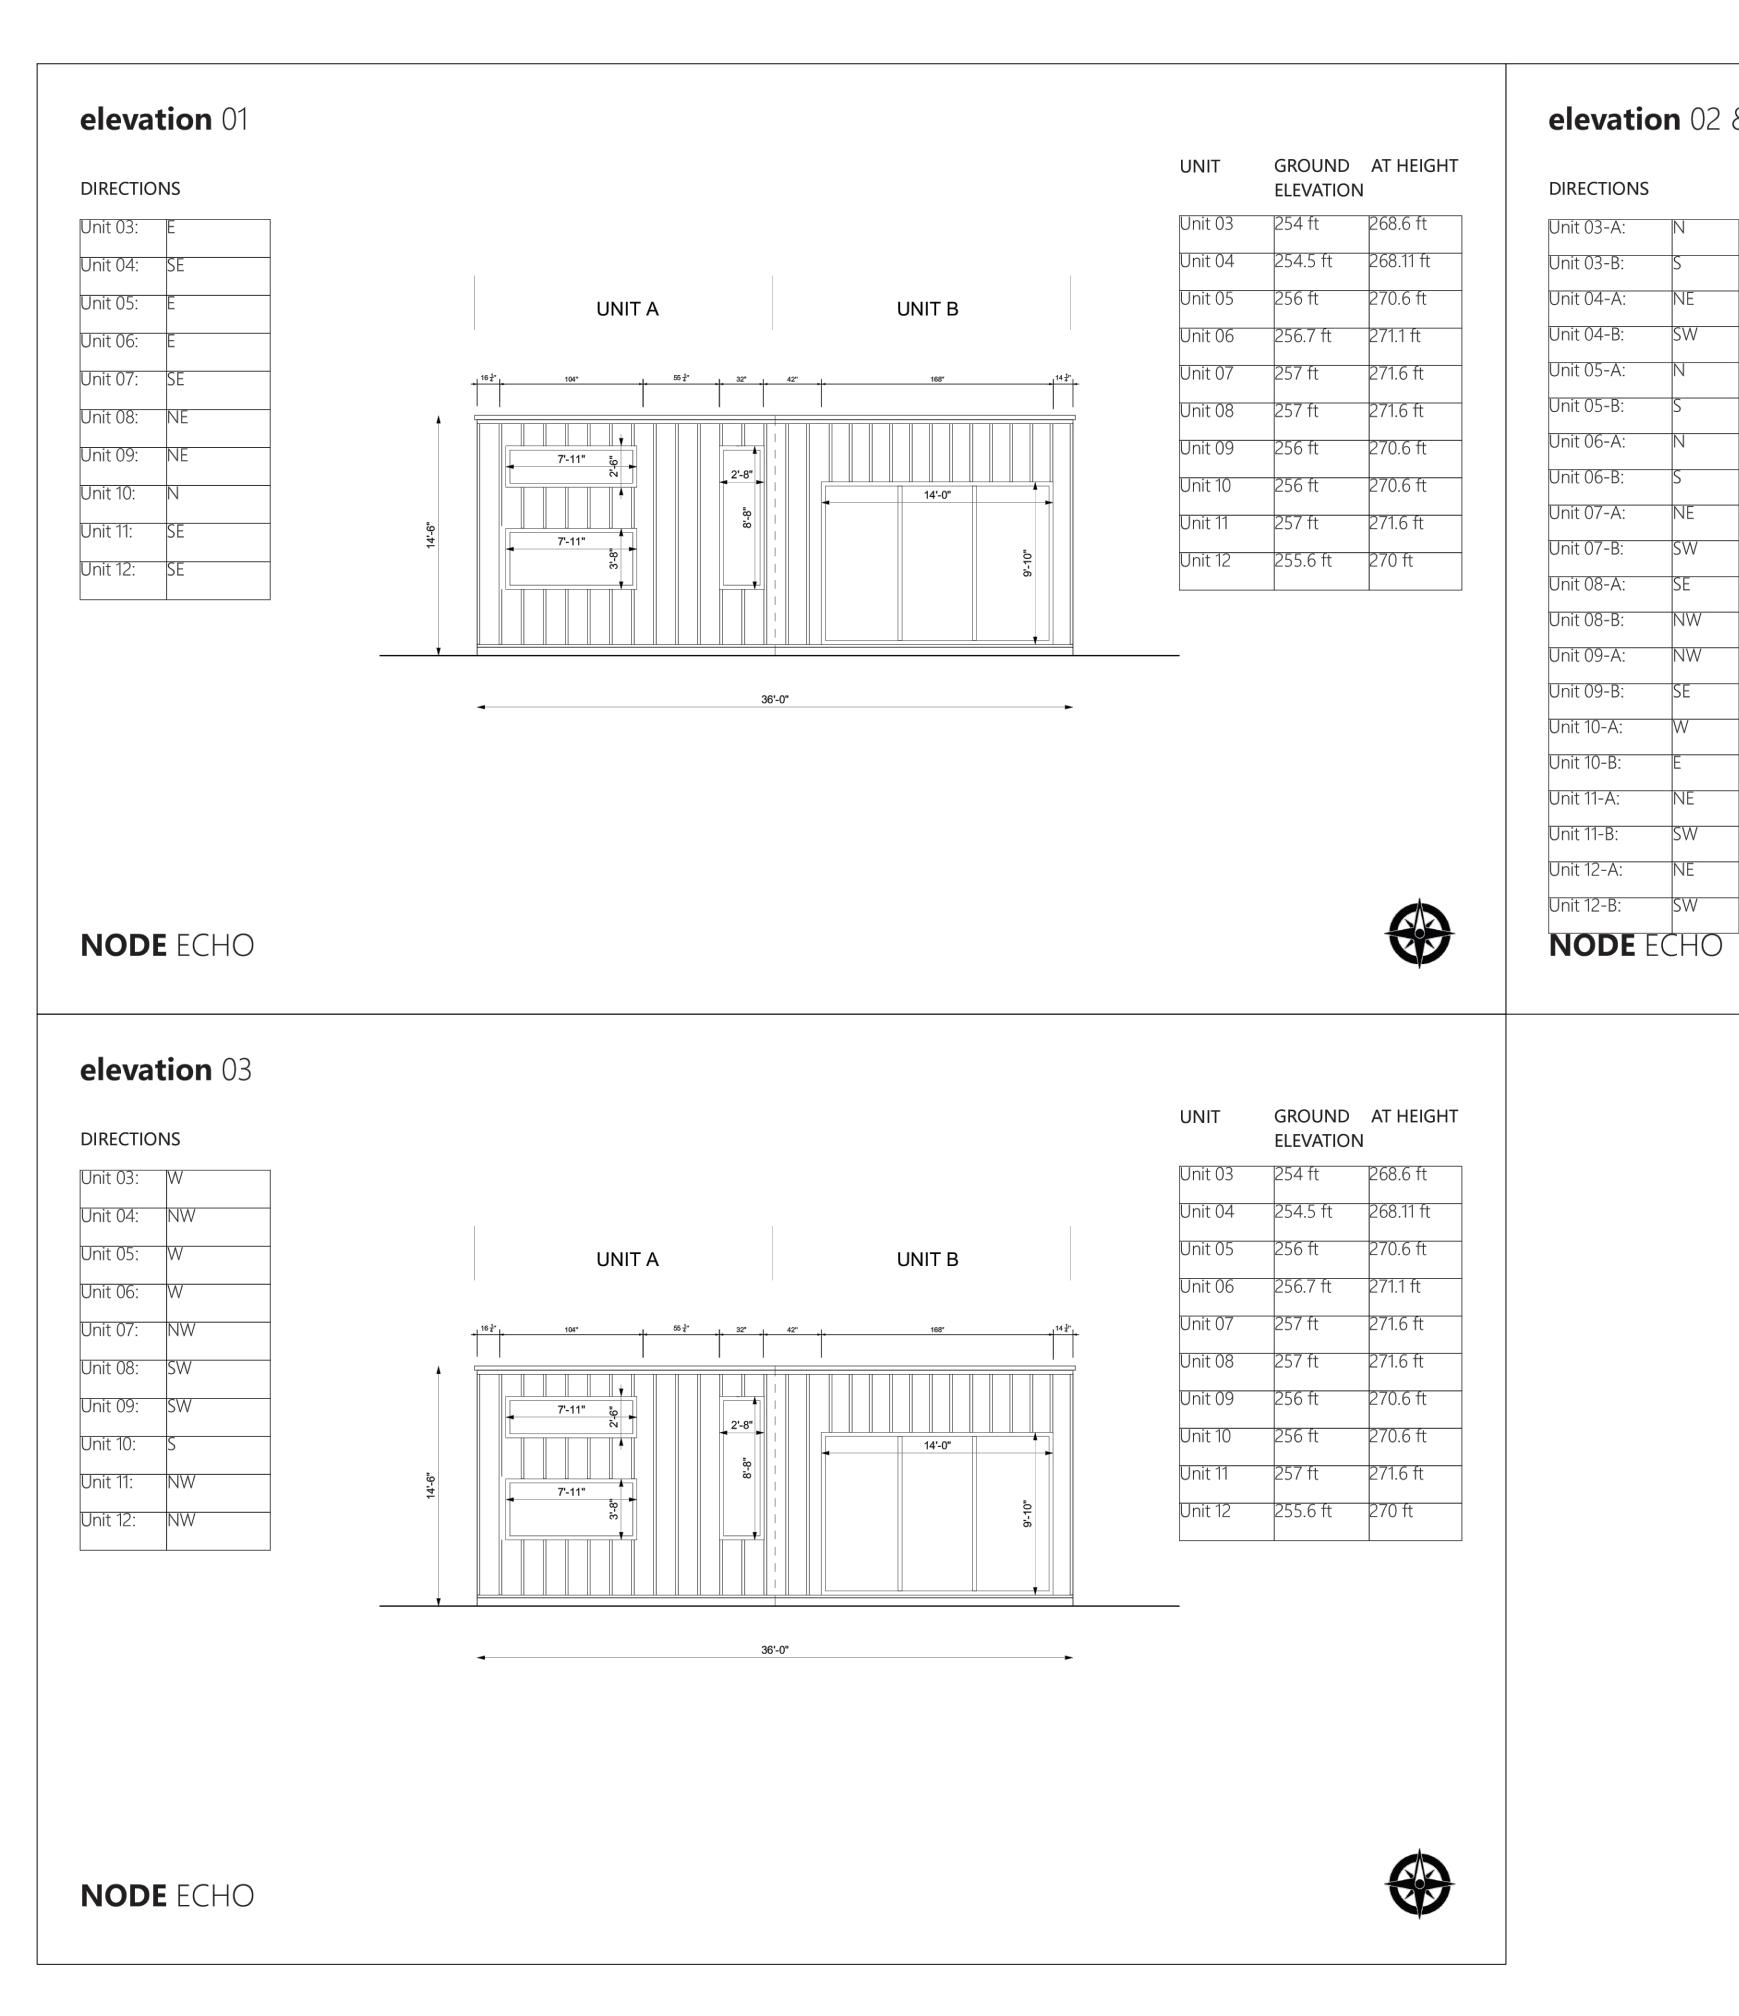

elevation 02 & 04

DIRECTIONS

DIRECTIONS	
Unit 03-A:	N
Unit 03-B:	S
Unit 04-A:	NE
Unit 04-B:	SW
Unit 05-A:	N
Unit 05-B:	S
Unit 06-A:	N
Unit 06-B:	S
Unit 07-A:	NE
Unit 07-B:	SW
Unit 08-A:	SE
Unit 08-B:	NW
Unit 09-A:	NW
Unit 09-B:	SE
Unit 10-A:	W
Unit 10-B:	E
Unit 11-A:	NE
Unit 11-B:	SW
Unit 12-A:	NE
Unit 12-R·	S\M/

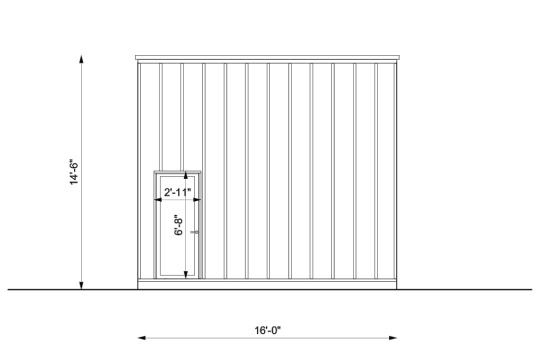

	ELEVATION		
Unit 03	254 ft	268.6 ft	
Unit 04	254.5 ft	268.11 ft	
Unit 05	256 ft	270.6 ft	
Unit 06	256.7 ft	271.1 ft	
Unit 07	257 ft	271.6 ft	
Unit 08	257 ft	271.6 ft	
Unit 09	256 ft	270.6 ft	
Unit 10	256 ft	270.6 ft	
Unit 11	257 ft	271.6 ft	
Unit 12	255.6 ft	270 ft	

GROUND AT HEIGHT





RESIDENTIAL TIER TW NOMAD

(ASR-0055-2024) FOR:
OPMENT

PLANS (

Drawn Checked

07 AUG 2024 REVISED:

1 25 OCT 2024 18 DEC 2024

TIER ONE SITE PLANS

ARCHITECTURAL ELEVATIONS

Dwg No.

ARCH