Administrative Site Review Application



Planning and Development Customer Service Center • One Exchange Plaza, Suite 400 | Raleigh, NC 27601 | 919-996-2500

This form is required when submitting site plans as referenced in Unified Development Ordinance (UDO) Section 10.2.8. Please check the appropriate building types and include the plan checklist document when submitting. Office Use Only: Case #: Planner (print): Please review UDO Section 10.2.8. to determine the site plan tier. If assistance determining a Site Plan Tier is needed a Site Plan Tier Verification request can be submitted online via the Permit and Development Portal. (Note: There is a fee for this verification service.) Site Plan Tier: Tier Two Site Plan Tier Three Site Plan **Building and Development Type Site Transaction History** (Check all that apply) Detached General Subdivision case #: Scoping/sketch plan case #: Attached Mixed use Certificate of Appropriateness #: Townhouse Civic Board of Adjustment #: Apartment **Cottage Court** Zoning Case #: _____ Tiny house Frequent Transit Design Alternate #: _____ **Development Option** Open lot **GENERAL INFORMATION** Development name: Inside City limits? Yes No Property address(es): Site P.I.N.(s): Please describe the scope of work. Include any additions, expansions, and uses (UDO 6.1.4). **Current Property Owner(s):** Title: Company: Address: Phone #: Email: Applicant Name (If different from owner. See "who can apply" in instructions): Relationship to owner: Lessee or contract purchaser Owner's authorized agent Easement holder Company: Address:

Phone #: Email:				
NOTE: please attach purchase agreement	or contrac	t, lease or easement when submitting this form.		
Developer Contact:				
Company:		Title:		
Address:				
Phone #:	Email:			
Applicant Name:				
Company:	Address:			
Phone #:	Email:			
		(DE : 0175 DATE TABLE		
DEVELOPMENT TYPE + SITE DATE TABLE (Applicable to all developments)				
SITE DATA	ppiioabio	BUILDING DATA		
		xisting gross floor area (not to be demolished):		
Gross site acreage:		Existing gross floor area to be demolished:		
# of parking spaces proposed:		New gross floor area:		
		Total sf gross (to remain and new):		
Overlay District (if applicable):		Proposed # of buildings:		
Existing use (UDO 6.1.4):		roposed # of stories for each:		
Proposed use (UDO 6.1.4):		roposed # of basement levels (UDO 1.5.7.A.6)		
s	TORMWAT	ER INFORMATION		
Imperious Area on Parcel(s): Existing (sf) Proposed total (sf)		Impervious Area for Compliance (includes ROW):		
		Existing (sf) Proposed total (sf)		
DECIDENTIAL	0/5040	HIT LODGING DEVELORMENTS		
	& OVERNIG	Total # of hatal hadrooms:		
Total # of dwelling units:	2hr	Total # of hotel bedrooms:		
# of bedroom units: 1br 2br # of lots:	_ 301 _	4br or more Is your project a cottage court? Yes No		
π οι ιοιο.		is your project a cottage court: Tes Ties		

Continue to Applicant Signature Block on Page 4.

A frequent transit development?

) No

) Yes

APPLICANT SIGNATURE BLOCK

Pursuant to state law (N.C. Gen. Stat. § 160D-403(a)), applications for development approvals may be made by the landowner, a lessee or person holding an option or contract to purchase or lease land, or an authorized agent of the landowner. An easement holder may also apply for development approval for such development as is authorized by the easement.

Acting as an authorized agent requires written permission from the property owner for the purposes of making this development approval and/or permit application. Written permission from the property owner to act as an authorized agent must be made available to the City of Raleigh upon request.

By submitting this application, the undersigned applicant acknowledges that they are either the property owner or one of the persons authorized by state law (N.C.G.S. 160D-403(a)) to make this application, as specified in the application. The undersigned also acknowledges that the information and statements made in the application are correct and the undersigned understands that development approvals are subject to revocation for false statements or misrepresentations made in securing the development approval, pursuant to N.C. Gen. Stat. § 160D-403(f).

The undersigned indicates that the property owner(s) is aware of this application and that the proposed project described in this application will be maintained in all respects in accordance with the plans and specifications submitted herewith, and in accordance with the provisions and regulations of the City of Raleigh Unified Development Ordinance.

The undersigned hereby acknowledges that, pursuant to state law (N.C.G.S. 143-755(b1), if this permit application is placed on hold at the request of the applicant for a period of six consecutive months or more, or if the applicant fails to respond to comments or provide additional information requested by the City for a period of six consecutive months or more, then the application review is discontinued, and a new application is required to proceed and the development regulations in effect at the time permit processing is resumed shall apply to the new application.

Signature:	FRM	Date:
Printed Name:		
Signature:		Date:
Printed Name:		

ABBOTTSWOOD AT STONEHENGE

ı. Raleigh

Administrative Site Review Application

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10.2.8. Please check the appropriate building types and include the plan checklist document when submitting.

Office Use Only: Case #: _______ Planner (print): ______

Please review UDO Section 10.2.8. to determine the site plan tier. If assistance determining a Site Plan Tier is needed a Site Plan Tier Verification request can be submitted online via the Permit and Development Portal. (Note: There is a

This form is required when submitting site plans as referenced in Unified Development Ordinance (UDO) Section

e for this verification service.)				
Site Plan Tier: Tier Two	Site Plan Tier Three	e Site Plan 🗸		
	Development Type all that apply)	Site Transaction History		
Detached Attached Townhouse Apartment Tiny house Open lot	General Mixed use Civic Cottage Court Frequent Transit Development Option	Subdivision case #: Scoping/sketch plan case #: Certificate of Appropriateness #: Board of Adjustment #: Zoning Case #: Z-9-2022 Design Alternate #:		
Abbo		NFORMATION		
<u> </u>	ttswood at Stonehenge			
Property address(es): 7900 Creedmoor Road Site P.I.N.(s): 0798409936 Please describe the scope of work. Include any additions, expansions, and uses (UDO 6.1.4).				
ddition of residential congregate care building, supporting surface parking, and utilities.				
Current Property Owner(s	s): KISO SENIOR LIVING			
Company: KISCO SENIOR LIVING Title: OWNER				
Address: 5790 FLEET S	TREET			
Phone #: 760-804-7096 Email:				
Applicant Name (If different from owner. See "who can apply" in instructions): Jonathan Balderson				
Relationship to owner: Lessee or contract purchaser Owner's authorized agent Easement holder				

Revision 03.01.24

		raleighnc.g
Phone #:	Email:	
NOTE: please attach purchase agreemen	t or contract, l	ease or easement when submitting this form.
Developer Contact: GABE LEGASPI		
Company: KISO SENIOR LIVING		Title: OWNER
Address: 5790 FLEET STREET		
Phone #: 760-804-7096	Email:	
Applicant Name: Jonathan Balderson		
Company: McAdams Address: 621 Hillsborough St, Suite 500, Raleigh NC 276		1 Hillsborough St, Suite 500, Raleigh NC 27603
Phone #: 919.287.0815 Email: balderson@mcadamsco.com		

Company: McAdams

Address: 621 Hillsborough St, Suite 500, Raleigh NC 27603

DEVELOPMENT TYPE + SITE DATE TABLE				
(Applicable to all developments)				
SITE DATA BUILDING DATA				
Zoning district(s) (please provide the acreage of each): R-10-CU	Existing gross floor area (not to be demolished): 0			
Gross site acreage: 10.28	Existing gross floor area to be demolished: 0			
# of parking spaces proposed: 58	New gross floor area: 47,160			
Max # parking permitted (7.1.2.C): No Max	Total sf gross (to remain and new): 47,160			
Overlay District (if applicable): n/a	Proposed # of buildings: 1			
Existing use (UDO 6.1.4): Congregate Care Retire	Proposed # of stories for each: 3			
Proposed use (UDO 6.1.4): Congregate Care Retire	Proposed # of basement levels (UDO 1.5.7.A.6) 0			

STORMWATER INFORMATION				
Imperious Area on Parcel(s):	Impervious Area for Compliance (includes ROW):			
Existing (sf) 151395 Proposed total (sf) 199440	Existing (sf) 153367 Proposed total (sf) 201396			
RESIDENTIAL & OVERNIGHT LODGING DEVELOPMENTS				
Total # of dwelling units: 49	Total # of hotel bedrooms: 0			
# of bedroom units: 1br 49 2br 3br	4br or more			
# of lots:	la vour project a cottage court? Voc No			

A frequent transit development? () Yes () N

APPLICANT SIGNATURE BLOCK

Pursuant to state law (N.C. Gen. Stat. § 160D-403(a)), applications for development approvals may be made by the landowner, a lessee or person holding an option or contract to purchase or lease land, or an authorized agent of the landowner. An easement holder may also apply for development approval for such development as is authorized by the easement.

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Signature: FRM	Date: 08/05/2024		
Printed Name: Jonathan Balderson			
Signature:	Date:		
Printed Name:			

7900 CREEDMOOR ROAD RALEIGH, NORTH CAROLINA **ADMINISTRATIVE SITE REVIEW**

CITY OF RALEIGH CASE #: ASR-XXXX-2024 PROJECT NUMBER: KDC-20000 DATE: AUGUST 5, 2024

SITE ADDRESS:	7900 CREEDMOOR ROAD
PARCEL PIN NUMBER:	0798409936
SITE AREA:	GROSS SITE AREA: 10.28 AC (448,010 SF) NET SITE AREA: 9.92 AC (431,982 SF)
EXISTING ZONING:	R-10 CU
OVERLAY DISTRICT:	NONE APPLICABLE
WATERSHED:	CRABTREE CREEK
RIVER BASIN:	NEUSE
FLOODPLAIN/FIRM PANEL:	ZONE X: PANEL 3720079800K
EXISTING USE:	CONGREGATE CARE
PROPOSED USE:	CONGREGATE CARE TOTAL NUMBER OF UNITS = 49 GROSS NEW BUILDING AREA = 47,160 SF
BUILDING HEIGHT:	MAX ALLOWABLE: 3 STORIES/ 45' IN HEIGHT MAX PROVIDED: 3 STORIES/ 44'-3" IN HEIGHT
VEHICULAR PARKING:	MAX ALLOWABLE: PROVIDED: EXISTING SPACES TO REMAIN = 43 SPACES EXISTING ADA SPACES TO REMAIN = 2 SPACES PROPOSED SPACES = 52 SPACES PROPOSED ADA SPACES = 6 SPACES TOTAL SPACES PROVIDED = 103 SPACES
ACCESSIBLE PARKING:	REQUIRED: 4 TOTAL SPACES; 1 VAN SPACES PROVIDED: 8 TOTAL SPACES; 5 VAN SPACES
BIKE PARKING:	SHORT TERM REQUIRED: N/A SHORT TERM PROVIDED: N/A LONG TERM REQUIRED: N/A
BUILDING & PARKING SETBACKS (CIVIC):	LONG TERM PROVIDED: N/A BUILDING SETBACK - PRIMARY/SIDE STREET: 10' BUILDING SETBACK - SIDE LOT LINE: 10' BUILDING SETBACK - REAR LOT LINE: 20' PARKING SETBACK - PRIMARY/SIDE STREET: 10' PARKING SETBACK - SIDE/REAR LOT LINE: 6'
IMPERVIOUS AREA:	EXISTING ON-SITE IMPERVIOUS: 3.48 AC EXISTING OFFSITE IMPERVIOUS: 0.05 AC PROPOSED ON-SITE IMPERVIOUS: 4.58 AC PROPOSED OFFSITE IMPERVIOUS: 0.04 AC
BLOCK PERIMETER:	MAXIMUM: 2,500 LF PROVIDED: 4,832 LF EXEMPT PER UDO 8.3.2.A.1.b.ii AND 8.3.2.A.1.b.iv - SEE EXHIBIT ON SHEET C0.00
TREE CONSERVATION AREA:	OVERALL REQUIRED: 0.99 AC (10.0%) OVERALL PROVIDED: 1.53 AC (15.4%)
OUTDOOR AMENITY AREA:	OVERALL REQUIRED: 0.99 AC (10.0%) OVERALL PROVIDED: 1.06 AC (10.8%)



CONTRACTOR SHALL NOTIFY "NC811" (811) OR (1-800-632-4949) AT LEAST 3 FULL BUSINESS DAYS PRIOR TO BEGINNING CONSTRUCTION OR EXCAVATION TO HAVE EXISTING UTILITIES LOCATED. CONTRACTOR SHALL CONTACT ANY LOCAL UTILITIES THAT PROVIDE THEIR OWN LOCATOR SERVICES INDEPENDENT OF "NC811". REPORT ANY DISCREPANCIES TO THE ENGINEER IMMEDIATELY.

SOLID WASTE INSPECTION STATEMENT:

THE DEVELOPER ACKNOWLEDGES THAT THEY HAVE REVIEWED AND ARE IN COMPLIANCE WITH THE REQUIREMENTS SET FORTH IN THE SOLID WASTE DESIGN MANUAL.

THE SOLID WASTE REMOVAL FOR THIS PROJECT WILL BE HANDLED BY PRIVATE SERVICES. THE CITY OF RALEIGH SOLID WASTE SERVICES (SWS) WILL NOT SERVICE THIS DESIGN.

OTES

THE MINIMUM CORNER CLEARANCE FOR A DRIVEWAY FROM THE CURB LINE OF INTERSECTING STREETS SHALL BE AT LEAST 20 FEET FROM THE POINT OF TANGENCY OF THE CURB. NO DRIVEWAYS SHALL ENCROACH ON THIS MINIMUM CORNER CLEARANCE. RSDM SECTION 6.5.2.D.

2. WITHIN THE AREA OF A DEFINED SIGHT TRIANGLE, THERE SHALL BE NO SIGHT OBSTRUCTING OR PARTLY OBSTRUCTING WALL, FENCE, SIGN, FOLIAGE, BERMING OR PARKED VEHICLES BETWEEN THE HEIGHTS OF TWENTY-FOUR (24) INCHES AND EIGHT (8) FEET ABOVE THE CURB ELEVATION OR THE NEAREST TRAVELED WAY, IF NO CURBING EXISTS.

SHEET INDEX

	
C0.00	PROJECT NOTES
C1.00	EXISTING CONDITIONS PLAN
C1.01	DEMOLITION PLAN
C2.00	OVERALL SITE PLAN
C2.01	DETAILED SITE PLAN - AREA A
C2.02	DETAILED SITE PLAN - AREA B
C3.00	OVERALL GRADING AND STORM DRAINAGE PLAN
C3.01	DETAILED GRADING PLAN - AREA A
C3.02	DETAILED GRADING PLAN - AREA B
C4.00	OVERALL UTILITY PLAN
C4.01	DETAILED UTILITY PLAN - AREA A
C8.00	SITE DETAILS
C8.01	SITE DETAILS
C8.02	WATER DETAILS
C8.03	WATER DETAILS
C8.04	STORM DRAINAGE DETAILS
C8.05	SANITARY SEWER DETAILS
C9.00	SCM "A" PLAN VIEW AND DETAILS
C9.01	SCM DETAILS
L5.00	OVERALL LANDSCAPE PLAN
L5.01	DETAILED LANDSCAPE PLAN
L5.02	DETAILED LANDSCAPE PLAN
L5.03	LANDSCAPE NOTES AND DETAILS
L8.00	TREE CONSERVATION PLAN
L8.01	TREE CONSERVATION CALCULATIONS

FROM OTHERS

A200	BUILDING PERSPECTIVES
A201	BUILDING ELEVATIONS
A202	BUILDING ELEVATIONS



VICINITY MAP

N.T.S.

ATTENTION CONTRACTORS

The Construction Contractor responsible for the extension of water, sewer, and/or reuse, as approved in these plans, is responsible for contacting the Public Works Department at (919) 996—2409, and the Public Utilities Department at (919) 996—4540 at least twenty four hours prior to beginning any of their construction.

Failure to notify both City Departments in advance of beginning construction, will result in the issuance of monetary fines, and require reinstallation of any water or sewer facilities not inspected as a result of this notification failure.

Failure to call for Inspection, Install a Downstream Plug, have Permitted Plans on the Jobsite, or any other Violation of City of Raleigh Standards will result in a <u>Fine and Possible Exclusion</u> from future work in the City of Raleigh.

ALL CONSTRUCTION SHALL CONFORM WITH THE LATEST VERSION OF THE CITY OF RALEIGH AND NCDOT STANDARDS, SPECIFICATIONS AND DETAILS.

PRELIMINARY DRAWING - NOT RELEASED FOR CONSTRUCTION



MCADAMS

621 Hillsborough Street Suite 500 Raleigh, NC 27603 phone 919. 361. 5000

www.mcadamsco.com

fax 919. 361. 2269

license number: C-0293, C-187

CONTACT

JONATHAN BALDERSON McADAMS balderson@mcadamsco.com PHONE: 919. 287. 0815

CLIENT

KISCO SENIOR LIVING GABE LEGASPI 5790 FLEET STREET SUITE 300 CARLSBAD, CA 92008 760-804-7096

PROJECT DIRECTORY



NO. DATE

ADMINISTRATIVE SITE REVIEW FOR:

ABBOTTSWOOD AT STONEHENGE RALEIGH, NORTH CAROLINA PROJECT NUMBER: KDC-20000

SITE PLAN NOTES

- 1. NON-ALLEY LOADED DRIVEWAYS MAY INTERSECT A STREET NO CLOSER THAN 20 FEET FROM THE INTERSECTION OF TWO STREET RIGHT-OF-WAYS. THE MINIMUM CORNER CLEARANCE FROM CURB LINE OR EDGE OF PAVEMENT OF INTERSECTING STREETS SHALL BE AT LEAST 20 FEET FROM THE POINT OF TANGENCY OF THE RADIUS OF CURVATURE, OR 20 FEET FROM THE INTERSECTION OF RIGHT-OF-WAY LINES, WHICH EVER IS GREATER. THE RADIUS OF THE DRIVEWAY SHALL NOT ENCROACH ON THE MINIMUM CORNER CLEARANCE. REFER TO SECTION 6.5 OF THE LATEST VERSION OF THE RALEIGH STREET DESIGN MANUAL FOR ADDITIONAL DETAILS.
- RIGHT-OF-WAY SHALL BE CLEARED AND GRUBBED WITHIN 50' OF ALL MINOR RESIDENTIAL, RESIDENTIAL, AND RESIDENTIAL
 COLLECTOR INTERSECTIONS. THE FULL LENGTH OF THE RIGHT-OF-WAY SHALL BE CLEARED AND GRADED ALONG ALL MAJOR,
 MINOR, & SENSITIVE AREA THOROUGHFARES.
- 3. WITHIN THE AREA DEFINED SIGHT TRIANGLES SHOWN ON THESE PLANS, THERE SHALL BE NO SIGHT OBSTRUCTING OR PARTLY OBSTRUCTING WALL, FENCE, SIGN, FOLIAGE BERMS, OR PARKED VEHICLES BETWEEN THE HEIGHTS OF 24 INCHES AND 8 FEET ABOVE THE CURB LINE ELEVATION OR THE NEAREST TRAVEL WAY IF NO CURB LINE EXISTS. REFER TO SECTION 6.12 OF THE LATEST VERSION OF THE RALEIGH STREET DESIGN MANUAL FOR ADDITIONAL DETAILS.
- 4. MULTIWAY STOP CONTROL WILL NOT BE USED AT ANY PUBLIC STREET INTERSECTION WITHOUT AN ENGINEERING STUDY TO PROVIDE DATA TO CITY OF RALEIGH TRANSPORTATION DIVISION THAT THE MULTIWAY STOP INSTALLATION WARRANTS CAN BE MET AND ORDINANCED BY CITY COUNCIL APPROVAL.
- 5. ALL CONSTRUCTION SHALL CONFORM TO THE LATEST CITY OF RALEIGH AND/OR NCDOT STANDARDS AND SPECIFICATIONS AS
- 6. ALL DIMENSIONS SHOWN ON SITE PLAN ARE MEASURED TO FACE OF CURB UNLESS OTHERWISE NOTED.

ANY REQUIRED RELOCATIONS (I.E. POWER POLES, TELEPHONE PEDESTALS, WATER METERS, ETC.).

- 7. CONTRACTOR SHALL MAINTAIN AN "AS-BUILT" SET OF DRAWINGS TO RECORD THE EXACT LOCATION OF ALL PIPING PRIOR TO CONCEALMENT. DRAWINGS SHALL BE GIVEN TO THE ENGINEER UPON COMPLETION OF THE PROJECT WITH A COPY OF THE TRANSMITTAL LETTER TO THE OWNER.
- 8. EXISTING IMPROVEMENTS DAMAGED DURING CONSTRUCTION SHALL BE REPLACED/RESTORED TO THEIR ORIGINAL CONDITION AND TO THE SATISFACTION OF THE OWNER, BY THE CONTRACTOR RESPONSIBLE FOR THE DAMAGE.
- 9. THE CONTRACTOR SHALL NOTE THAT THE DRAWINGS MAY NOT SHOW EVERY OFFSET, TRANSITION, FITTING, ETC. THAT MAY BE REQUIRED. THE CONTRACTOR SHALL INSTALL SUCH STANDARD APPURTENANCES AS REQUIRED TO CLOSELY FOLLOW THE GRADES AND ALIGNMENTS DEPICTED ON THE PLANS.
- 10. CONTRACTOR SHALL NOTIFY "NC811" (811) OR (1-800-632-4949) AT LEAST 3 FULL BUSINESS DAYS PRIOR TO BEGINNING CONSTRUCTION OR EXCAVATION TO HAVE EXISTING UTILITIES LOCATED. CONTRACTOR SHALL CONTACT ANY LOCAL UTILITIES THAT PROVIDE THEIR OWN LOCATOR SERVICES INDEPENDENT OF "NC811". REPORT ANY DISCREPANCIES TO THE ENGINEER
- 11. CONTRACTOR IS RESPONSIBLE FOR COORDINATING CONSTRUCTION ACTIVITIES WITH THE APPROPRIATE UTILITY COMPANIES FOR
- 12. PRIOR TO BEGINNING CONSTRUCTION BEYOND EROSION CONTROL MEASURES, THE GENERAL CONTRACTOR SHALL SCHEDULE AND ATTEND A PRE-CONSTRUCTION CONFERENCE WITH THE CITY OF RALEIGH PUBLIC WORKS DEPARTMENT (919) 996-2409, AND A REPRESENTATIVE OF THE ENGINEER AND OWNER. THE PURPOSE OF THIS MEETING IS TO REVIEW THE SPECIFIC COMPONENTS OF THE PLAN AND OPERATION OF THE FACILITIES DURING CONSTRUCTION.
- 13. ALL DIMENSIONS AND GRADES SHOWN ON THE PLANS SHALL BE FIELD VERIFIED BY THE CONTRACTOR PRIOR TO CONSTRUCTION. CONTRACTOR SHALL NOTIFY THE ENGINEER IF ANY DISCREPANCIES EXIST PRIOR TO PROCEEDING WITH CONSTRUCTION, FOR NECESSARY PLAN OR GRADE CHANGES. NO EXTRA COMPENSATION SHALL BE PAID TO CONTRACTOR FOR ANY WORK DONE DUE TO DIMENSIONS OR GRADES SHOWN INCORRECTLY ON THESE PLANS IF SUCH NOTIFICATION HAS NOT BEEN GIVEN.
- 14. ACCESSIBLE RAMPS SHALL BE CONSTRUCTED IN ACCORDANCE WITH THE CITY OF RALEIGH UNIFIED DEVELOPMENT ORDINANCE (UDO) DETAILS.
- 15. ALL SIDEWALKS THAT CONNECT TO THE PUBLIC RIGHT-OF-WAY MUST BE ACCESSIBLE TO PERSONS WHO ARE BLIND, HAVE LOW VISION AND PEOPLE WITH MOBILITY DISABILITIES. PEDESTRIAN EXISTING ROUTES AND ALTERNATE PEDESTRIAN ROUTES DURING CONSTRUCTION WILL BE REQUIRED TO BE COMPLIANT WITH THE PUBLIC RIGHTS OF WAY ACCESSIBILITY GUIDELINES (PROWAG), 2010 ADA STANDARDS FOR ACCESSIBLE DESIGN AND THE MANUAL ON UNIFORM TRAFFIC CONTROL DEVICES (MUTCD).
- 16. TYPICAL PAVEMENT SECTION DETAILS ARE SHOWN WITHIN THIS SET AND INTENDED TO BE A MINIMUM PAVEMENT SECTION REQUIREMENT. THE CURRENT GEOTECHNICAL REPORT SHALL OVER-RIDE ALL TYPICAL PAVEMENT SECTIONS SHOWN, IF THE GEOTECHNICAL ENGINEER DEEMS A HEAVIER SECTION IS REQUIRED.
- 17. EQUIPMENT AND PRODUCTS OTHER THAN THOSE SPECIFIED MAY BE USED PROVIDED APPROVAL HAS BEEN OBTAINED FROM THE OWNER IN WRITING PRIOR TO ORDERING OR INSTALLATION. THE CONTRACTOR SHALL WAIVE ANY CLAIM FOR ADDITIONAL COST RELATED TO SUBSTITUTION OF ALTERNATE EQUIPMENT.
- 18. IF UNFORESEEN CONDITIONS DEVELOP DURING CONSTRUCTION, REFER TO THE LATEST VERSION OF THE RALEIGH STREET DESIGN MANUAL AND CONTACT PUBLIC WORKS STAFF FOR FURTHER GUIDANCE.
- 19. ALL SIGNAGE ASSOCIATED WITH THE PUBLIC STREET SYSTEM SHALL ADHERE TO MUTCD STANDARDS AND SPECIFICATIONS.
- 20. ANY TRANSIT STOP LOCATIONS SHOWN ARE PRELIMINARY ONLY. FINAL LOCATION SHALL BE DETERMINED ONCE THE CITY OF RALEIGH TRANSIT ROUTE HAS BEEN FINALIZED. ALL TRANSIT STOPS SHALL HAVE A 10'x20'x6" (3000 PSI) CONCRETE PAD.

DEMOLITION NOTES

- 1. ALL MATERIAL TO BE DEMOLISHED SHALL BE REMOVED FROM THE SITE AND DISPOSED OF AT A PERMITTED SITE IN ACCORDANCE WITH ALL LOCAL STATE AND FEDERAL LAWS
- 2. COMPLY WITH REQUIREMENTS FOR FIRE SAFETY DURING CONSTRUCTION AND DEMOLITION (CHAPTER 14, 2018 NC FIRE CODE, NFPA 241 AND CHAPTER 33, 2018 NC BUILDING CODE).

RETAINING WALL NOTES

- THE RETAINING WALL ALIGNMENT SHOWN ON THESE PLANS DEPICTS THE LOCATION OF THE FRONT FACE OF THE RETAINING WALL AT THE BOTTOM OF THE WALL. THE CONTRACTOR IS RESPONSIBLE FOR ENSURING RETAINING WALLS ARE NOT LOCATED IN ANY STREAM BUFFERS, AND THEIR CONSTRUCTION DOES NOT ENCROACH INTO ANY ADJACENT PROPERTIES DUE TO ANY BATTER INCORPORATED IN THE DESIGN OF THE WALLS.
- 2. RETAINING WALLS ARE TO BE DESIGN-BUILD PROJECTS BY THE CONTRACTOR. IT SHALL BE THE CONTRACTOR'S RESPONSIBILITY TO OBTAIN FINAL CONSTRUCTION DRAWINGS FROM A REGISTERED ENGINEER AND GAIN ALL REQUIRED PERMITS NECESSARY FOR THE CONSTRUCTION OF THE RETAINING WALLS.
- RETAINING WALLS SHALL BE ASSUMED TO BE BACKFILLED WITH OFF-SITE BORROW MATERIAL OR PROCESSED FILL, UNLESS THE CONTRACTOR CAN PROVIDE TO THE OWNER WITH CONFIRMATION FROM THE GEOTECHNICAL ENGINEER AND THE RETAINING WALL DESIGNER, THAT READILY AVAILABLE ON-SITE SOILS CAN BE USED.
- THE TOP AND BOTTOM OF WALL ELEVATIONS SHOWN ON THESE PLANS IDENTIFY FINISHED GRADE ELEVATIONS ONLY. THE EXTENT THAT THE RETAINING WALL WILL BE EXTENDED BELOW GRADE TO THE FOOTING OR ABOVE GRADE TO THE TOP OF THE CAP BLOCK COURSE SHALL BE IDENTIFIED ON THE RETAINING WALL CONSTRUCTION DRAWINGS.
- 5. ALL RETAINING WALLS OVER 30" HIGH SHALL HAVE A SAFETY FENCE (DESIGN BY OTHERS).
- 6. ANY PART OF ANY RETAINING WALL THAT EXTENDS INTO THE RIGHT-OF-WAY WILL REQUIRE AN ENCROACHMENT AGREEMENT. ENCROACHMENT AGREEMENTS FOR RETAINING WALLS SHALL BE APPROVED PRIOR TO CONSTRUCTION DRAWING APPROVAL.
- 7. ANY TIEBACK SYSTEMS FOR THE RETAINING WALLS SHALL NOT BE ALLOWED WITHIN PUBLIC RIGHT-OF-WAY.
- STORMWATER RUN-OFF SHALL BE DIRECTED AWAY FROM RETAINING WALLS. ANY RUN-OFF FLOWING TO AND OVER A RETAINING WALL SHALL BE KEPT TO AN ABSOLUTE MINIMUM AND BROUGHT TO THE ATTENTION OF THE WALL DESIGNER PRIOR

GRADING NOTES


- 1. ALL DIMENSIONS AND GRADES SHOWN ON THE PLANS SHALL BE FIELD VERIFIED BY THE CONTRACTOR PRIOR TO CONSTRUCTION. CONTRACTOR SHALL NOTIFY THE ENGINEER IF ANY DISCREPANCIES EXIST PRIOR TO PROCEEDING WITH CONSTRUCTION, FOR NECESSARY PLAN OR GRADE CHANGES. NO EXTRA COMPENSATION SHALL BE PAID TO THE CONTRACTOR FOR ANY WORK DONE DUE TO DIMENSIONS OR GRADES SHOWN INCORRECTLY ON THESE PLANS IF SUCH NOTIFICATION HAS NOT BEEN GIVEN.
- 2. OCCUPATIONAL SAFETY AND HEALTH ADMINISTRATION (OSHA) STANDARDS FOR EXCAVATIONS; FINAL RULE 29CFR PART 1926, SUBPART "P" APPLIES TO ALL EXCAVATIONS EXCEEDING FIVE (5) FEET IN DEPTH. EXCAVATION EXCEEDING TWENTY (20) FEET IN DEPTH REQUIRES THE DESIGN OF A TRENCH SAFETY SYSTEM BY A REGISTERED PROFESSIONAL ENGINEER, PROVIDED BY CONTRACTOR RESPONSIBLE FOR EXCAVATION.
- 3. ALL CONSTRUCTION SHALL BE IN ACCORDANCE WITH THE CITY OF RALEIGH AND/OR NCDOT STANDARDS AND SPECIFICATIONS AS
- 4. CONTRACTOR SHALL NOTIFY "NC811" (811) OR (1-800-632-4949) AT LEAST 3 FULL BUSINESS DAYS PRIOR TO BEGINNING CONSTRUCTION OR EXCAVATION TO HAVE EXISTING UTILITIES LOCATED. CONTRACTOR SHALL CONTACT ANY LOCAL UTILITIES THAT PROVIDE THEIR OWN LOCATOR SERVICES INDEPENDENT OF "NC811". REPORT ANY DISCREPANCIES TO THE ENGINEER INMEDIATELY
- 5. PRIOR TO BEGINNING CONSTRUCTION, THE GENERAL CONTRACTOR SHALL SCHEDULE AND ATTEND A PRE-CONSTRUCTION CONFERENCE WITH THE CITY OF RALEIGH STORMWATER AND EROSION CONTROL DEPARTMENT, THE ENGINEER AND A REPRESENTATIVE OF THE OWNER.
- 6. CONSTRUCTION, MAINTENANCE AND REMOVAL OF ALL EROSION CONTROL DEVICES ARE THE RESPONSIBILITY OF THE GENERAL CONTRACTOR. TIMING OF REMOVAL SHALL BE COORDINATED WITH THE EROSION CONTROL INSPECTOR.
- 7. EXISTING UTILITIES AND STRUCTURES SHOWN, BOTH UNDERGROUND AND ABOVE GROUND, ARE BASED ON A FIELD SURVEY AND THE BEST AVAILABLE RECORD DRAWINGS. THE CONTRACTOR SHALL VERIFY FIELD CONDITIONS PRIOR TO BEGINNING RELATED CONSTRUCTION. ANY DISCREPANCIES SHALL BE REPORTED TO THE ENGINEER IMMEDIATELY.
- 8. SOIL UNDER BUILDINGS, PAVED AREAS AND WITHIN SLOPES GREATER THAN 3:1 (H:V) SHALL BE APPROVED, PLACED AND COMPACTED AS RECOMMENDED BY THE GEOTECHNICAL ENGINEER.


CITY OF RALEIGH PUBLIC UTILITIES STANDARD UTILITY NOTES (AS APPLICABLE)

- 1. ALL MATERIALS & CONSTRUCTION METHODS SHALL BE IN ACCORDANCE WITH CITY OF RALEIGH DESIGN STANDARDS, DETAILS & SPECIFICATIONS (REFERENCE: CORPUD HANDBOOK, CURRENT EDITION).
- 2. UTILITY SEPARATION REQUIREMENTS:
 - a) A DISTANCE OF 100' SHALL BE MAINTAINED BETWEEN SANITARY SEWER & ANY PRIVATE OR PUBLIC WATER SUPPLY SOURCE SUCH AS AN IMPOUNDED RESERVOIR USED AS A SOURCE OF DRINKING WATER. IF ADEQUATE LATERAL SEPARATION CANNOT BE ACHIEVED, FERROUS SANITARY SEWER PIPE SHALL BE SPECIFIED & INSTALLED TO WATERLINE SPECIFICATIONS. HOWEVER, THE MINIMUM SEPARATION SHALL NOT BE LESS THAN 25' FROM A PRIVATE WELL OR 50' FROM A PUBLIC WELL.
 - b) WHEN INSTALLING WATER &/OR SEWER MAINS, THE HORIZONTAL SEPARATION BETWEEN UTILITIES SHALL BE 10'. IF THIS SEPARATION CANNOT BE MAINTAINED DUE TO EXISTING CONDITIONS, THE VARIATION ALLOWED IS THE WATER MAIN IN A SEPARATE TRENCH WITH THE ELEVATION OF THE WATER MAIN AT LEAST 18" ABOVE THE TOP OF THE SEWER & MUST BE APPROVED BY THE PUBLIC UTILITIES DIRECTOR. ALL DISTANCES ARE MEASURED FROM OUTSIDE DIAMETER.
- c) WHERE IT IS IMPOSSIBLE TO OBTAIN PROPER SEPARATION, OR ANYTIME A SANITARY SEWER PASSES OVER A WATERMAIN, DIP MATERIALS OR STEEL ENCASEMENT EXTENDED 10' ON EACH SIDE OF CROSSING MUST BE SPECIFIED & INSTALLED TO
- d) 5.0' MINIMUM HORIZONTAL SEPARATION IS REQUIRED BETWEEN ALL SANITARY SEWER & STORM SEWER FACILITIES, UNLESS DIP MATERIAL IS SPECIFIED FOR SANITARY SEWER.
- e) MAINTAIN 18" MIN. VERTICAL SEPARATION AT ALL WATERMAIN & RCP STORM DRAIN CROSSINGS; MAINTAIN 18" MIN. VERTICAL SEPARATION AT ALL SANITARY SEWER & RCP STORM DRAIN CROSSINGS. WHERE ADEQUATE SEPARATIONS CANNOT BE ACHIEVED, SPECIFY DIP MATERIALS & A CONCRETE CRADLE HAVING 6" MIN. CLEARANCE (PER CORPUD DETAILS W-41 & S-49).
- f) ALL OTHER UNDERGROUND UTILITIES SHALL CROSS WATER & SEWER FACILITIES WITH 18" MIN. VERTICAL SEPARATION REQUIRED.
- 3. ANY NECESSARY FIELD REVISIONS ARE SUBJECT TO REVIEW & APPROVAL OF AN AMENDED PLAN &/OR PROFILE BY THE CITY OF RALEIGH PUBLIC UTILITIES DEPARTMENT PRIOR TO CONSTRUCTION.
- 4. CONTRACTOR SHALL MAINTAIN CONTINUOUS WATER & SEWER SERVICE TO EXISTING RESIDENCES & BUSINESSES THROUGHOUT CONSTRUCTION OF PROJECT. ANY NECESSARY SERVICE INTERRUPTIONS SHALL BE PRECEDED BY A 24 HOUR ADVANCE NOTICE TO THE CITY OF RALEIGH PUBLIC UTILITIES DEPARTMENT.
- 5. 3.0' MINIMUM COVER IS REQUIRED ON ALL WATER MAINS & SEWER FORCEMAINS. 4.0' MINIMUM COVER IS REQUIRED ON ALL REUSE MAINS.
- 6. IT IS THE DEVELOPER'S RESPONSIBILITY TO ABANDON OR REMOVE EXISTING WATER & SEWER SERVICES NOT BEING USED IN REDEVELOPMENT OF A SITE UNLESS OTHERWISE DIRECTED BY THE CITY OF RALEIGH PUBLIC UTILITIES DEPARTMENT. THIS INCLUDES ABANDONING TAP AT MAIN & REMOVAL OF SERVICE FROM ROW OR EASEMENT PER CORPUD HANDBOOK PROCEDURE.
- 7. INSTALL 3/4" COPPER* WATER SERVICES WITH METERS LOCATED AT ROW OR WITHIN A 2'X2' WATERLINE EASEMENT IMMEDIATELY ADJACENT. NOTE: IT IS THE APPLICANT'S RESPONSIBILITY TO PROPERLY SIZE THE WATER SERVICE FOR EACH CONNECTION TO
- 8. INSTALL 4" PVC* SEWER SERVICES @ 1.0% MINIMUM GRADE WITH CLEANOUTS LOCATED AT ROW OR EASEMENT LINE & SPACED EVERY 75 LINEAR FEET MAXIMUM.
- 9. PRESSURE REDUCING VALVES ARE REQUIRED ON ALL WATER SERVICES EXCEEDING 80 PSI. WHERE SANITARY SERVICES ARE SERVING A BUILDING INSTALLED ON A FLOOR WITH A FINISHED FLOOR ELEVATION BELOW THE ELEVATION OF THE MANHOLE COVER OF THE NEXT UPSTREAM MANHOLE IN THE PUBLIC SEWER, SUCH FIXTURES SHALL BE PROTECTED BY A BACKWATER VALVE INSTALLED IN THE SERVICE LINE. SANITARY SERVICES SERVING A BUILDING WITH A FINISHED FLOOR ELEVATION ABOVE THE ELEVATION OF THE MANHOLE COVER OF THE NEXT UPSTREAM MANHOLE IN THE PUBLIC SEWER SHALL NOT DISCHARGE THROUGH A BACKWATER VALVE
- 10. ALL ENVIRONMENTAL PERMITS APPLICABLE TO THE PROJECT MUST BE OBTAINED FROM NCDWQ, USACE &/OR FEMA FOR ANY RIPARIAN BUFFER, WETLAND &/OR FLOODPLAIN IMPACTS (RESPECTIVELY) PRIOR TO CONSTRUCTION.
- 11. NCDOT / RAILROAD ENCROACHMENT AGREEMENTS ARE REQUIRED FOR ANY UTILITY WORK (INCLUDING MAIN EXTENSIONS & SERVICE TAPS) WITHIN STATE OR RAILROAD ROW PRIOR TO CONSTRUCTION.
- 12. GREASE INTERCEPTOR / OIL WATER SEPARATOR SIZING CALCULATIONS & INSTALLATION SPECIFICATIONS SHALL BE APPROVED BY THE CORPUD FOG PROGRAM COORDINATOR PRIOR TO ISSUANCE OF A BUILDING PERMIT. CONTACT STEPHEN CALVERLEY AT (919) 296-2334 OR STEPHEN.CALVERLEY@RALEIGHNC.GOV FOR MORE INFORMATION.
- 13. CROSS-CONNECTION CONTROL PROTECTION DEVICES ARE REQUIRED BASED ON DEGREE OF HEALTH HAZARD INVOLVED AS LISTED IN APPENDIX-B OF THE RULES GOVERNING PUBLIC WATER SYSTEMS IN NORTH CAROLINA. THESE GUIDELINES ARE THE MINIMUM REQUIREMENTS. THE DEVICES SHALL MEET AMERICAN SOCIETY OF SANITARY ENGINEERING (ASSE) STANDARDS OR BE ON THE UNIVERSITY OF SOUTHERN CALIFORNIA APPROVAL LIST. THE DEVICES SHALL BE INSTALLED AND TESTED (BOTH INITIAL AND PERIODIC TESTING THEREAFTER) IN ACCORDANCE WITH THE MANUFACTURER'S RECOMMENDATIONS OR THE LOCAL CROSS-CONNECTION CONTROL PROGRAM, WHICHEVER IS MORE STRINGENT. CONTACT JOANIE HARTLEY AT (919) 996-5923 OR JOANIE.HARTLEY@RALEIGHNC.GOV FOR MORE INFORMATION.


ADDITIONAL UTILITY NOTES

- 1. ALL WATER MAINS, SERVICES AND FIRE SERVICES GREATER THAN 2" DIAMETER ARE TO BE DUCTILE IRON PIPE. 2" & SMALLER DOMESTIC SERVICES MUST BE TYPE K SOFT COPPER (WITHOUT FITTINGS) TO THE WATER METER.
- 2. ALL SEWER MAINS SHALL BE EITHER PVC OR DUCTILE IRON PIPE AS SHOWN ON THE PLANS. ALL PIPE MATERIAL SHALL MEET CITY OF RALEIGH STANDARDS AND SPECIFICATIONS AS DEFINED IN THE LATEST ISSUE OF THE PUBLIC UTILITIES HANDBOOK AND/OR UNIFIED DEVELOPMENT ORDINANCE (UDO).
- 3. ALL FIRE HYDRANTS ALONG PUBLIC R/W LINES SHALL HAVE A 5'Wx5'L CITY OF RALEIGH WATERLINE EASEMENT ONTO ADJACENT PROPERTY.
- 4. ALL SANITARY SEWER INTERCEPTOR LINES (12" AND LARGER), AS WELL AS MANHOLES AND FITTINGS ASSOCIATED WITH THE INTERCEPTOR LINE, SHALL BE INTERNALLY LINED WITH PROTECTO 401 OR APPROVED EQUAL TO PREVENT HYDROGEN SULFIDE CORROSION. SEE THE CURRENT CITY OF RALEIGH PUBLIC UTILITIES DEPARTMENT HANDBOOK FOR APPROVED COATINGS AND APPLICATION METHODS.
- 5. IN ACCORDANCE WITH GENERAL STATUTE 87-121(G), ALL UNDERGROUND UTILITIES INSTALLED AFTER OCTOBER 1, 2014 SHALL BE ELECTRONICALLY LOCATABLE. CONTRACTOR SHALL COORDINATE DIRECTLY WITH THE CITY OF RALEIGH PUBLIC UTILITIES DEPARTMENT FOR DETAILS AND SPECIFICATIONS FOR MEETING THESE REQUIREMENTS.
- 6. EXISTING UTILITIES SHOWN ARE BASED ON FIELD SURVEYS AND THE BEST AVAILABLE RECORD DRAWINGS. THE CONTRACTOR SHALL VERIFY CONDITIONS PRIOR TO BEGINNING CONSTRUCTION. ANY DISCREPANCIES BETWEEN ACTUAL FIELD CONDITIONS AND THE PLANS SHALL BE REPORTED TO THE ENGINEER IMMEDIATELY.
- 7. ALL WATER AND SEWER MAINS WITHIN PUBLIC EASEMENTS OR RIGHTS-OF-WAY TO BE OWNED, OPERATED, AND MAINTAINED BY THE CITY OF RALEIGH.
- 8. ALL WATER AND SEWER MAINS NOT WITHIN PUBLIC EASEMENTS OR RIGHTS-OF-WAY TO BE PRIVATELY OWNED, OPERATED, AND MAINTAINED BY THE PROPERTY OWNER.
- 9. CONTRACTOR SHALL NOTIFY "NC811" (811) OR (1-800-632-4949) AT LEAST 3 FULL BUSINESS DAYS PRIOR TO BEGINNING CONSTRUCTION OR EXCAVATION TO HAVE EXISTING UTILITIES LOCATED. CONTRACTOR SHALL CONTACT ANY LOCAL UTILITIES THAT PROVIDE THEIR OWN LOCATOR SERVICES INDEPENDENT OF "NC811". REPORT ANY DISCREPANCIES TO THE ENGINEER IMMEDIATELY.
- 10. ALL UTILITY SLEEVES SHALL BE SCHEDULE 40 PVC AND INSTALLED WITH 2' MINIMUM COVER. BOTH ENDS SHALL BE CAPPED AND MARKED.

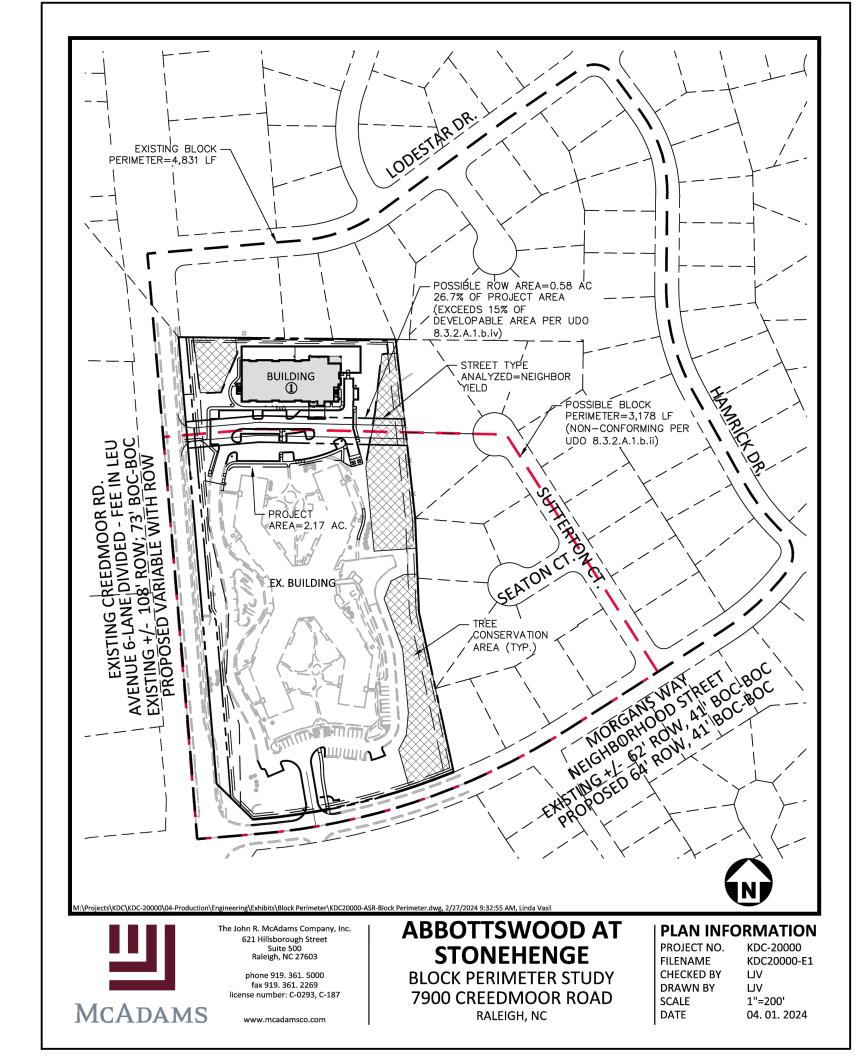

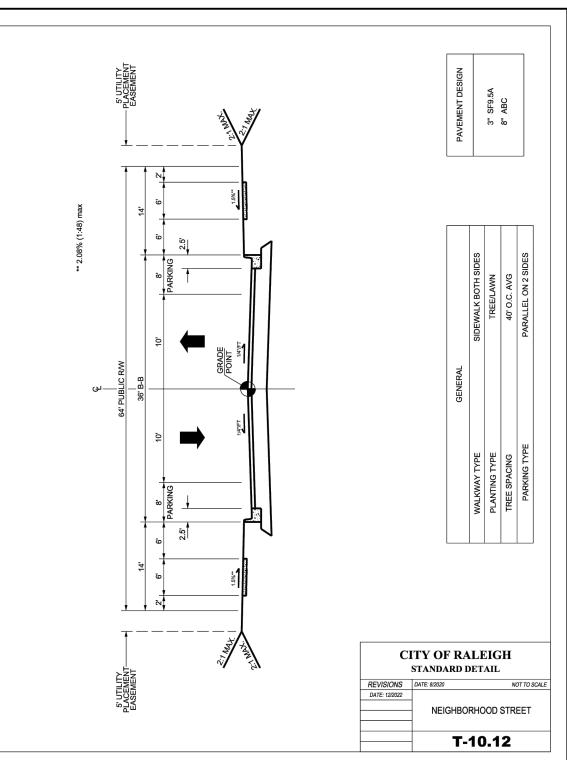

THIS PROJECT IS REQUESTING A VARIANCE TO INSTALL STREETSCAPE PER UDO SECTION 8.4.1.H.6.b. THIS PROJECT WILL DEDICATE ROW AS DETERMINE BY THE APPROPRIATE STREET SECTION

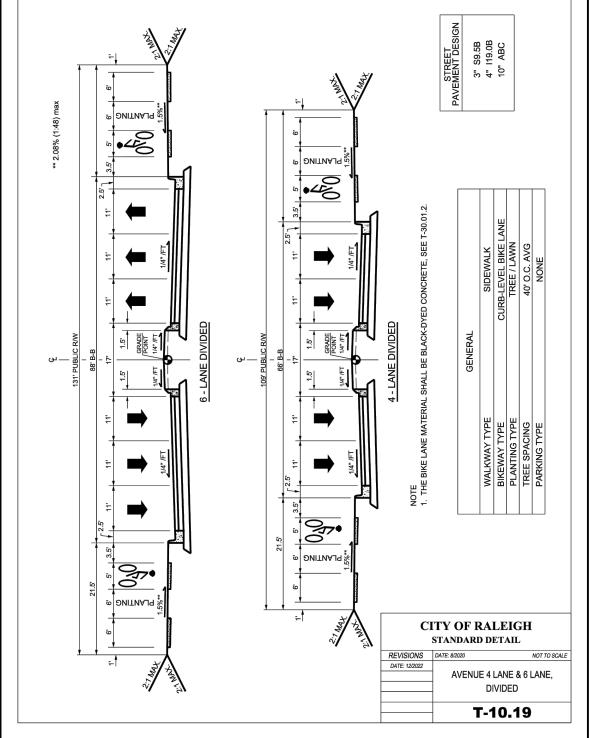

CREEDMOOR ROAD

THIS PROJECT IS REQUESTING A VARIANCE TO INSTALL STREETSCAPE PER UDO SECTION 8.4.1.H.6.b. THIS PROJECT WILL DEDICATE ROW AS DETERMINE BY THE APPROPRIATE STREET SECTION

ALL CONSTRUCTION SHALL CONFORM WITH THE LATEST VERSION OF THE CITY OF RALEIGH AND NCDOT STANDARDS, SPECIFICATIONS AND DETAILS.

PRELIMINARY DRAWING - NOT RELEASED FOR CONSTRUCTION



McAdams

The John R. McAdams Company,

Durham, NC 27713 phone 919. 361. 5000

fax 919. 361. 2269

license number: C-0293, C-187

2905 Meridian Parkway

www.mcadamsco.com

CLIENT

MR. JOE WHITEHOUSE KISCO SENIOR LIVING 5790 FLEET STREET, SUITE 300 CARLSBAD, CALIFORNIA 92008

ABBOTTSWOOD AT STONEHENGE



REVISIONS

NO. DATE

SHEET

PLAN INFORMATION

PROJECT NO. KDC-20000
FILENAME KDC20000-ASR-N1.DWG

CHECKED BY LJV


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SCALE NTS

DATE 08.05.2024

PROJECT NOTES

CO.00



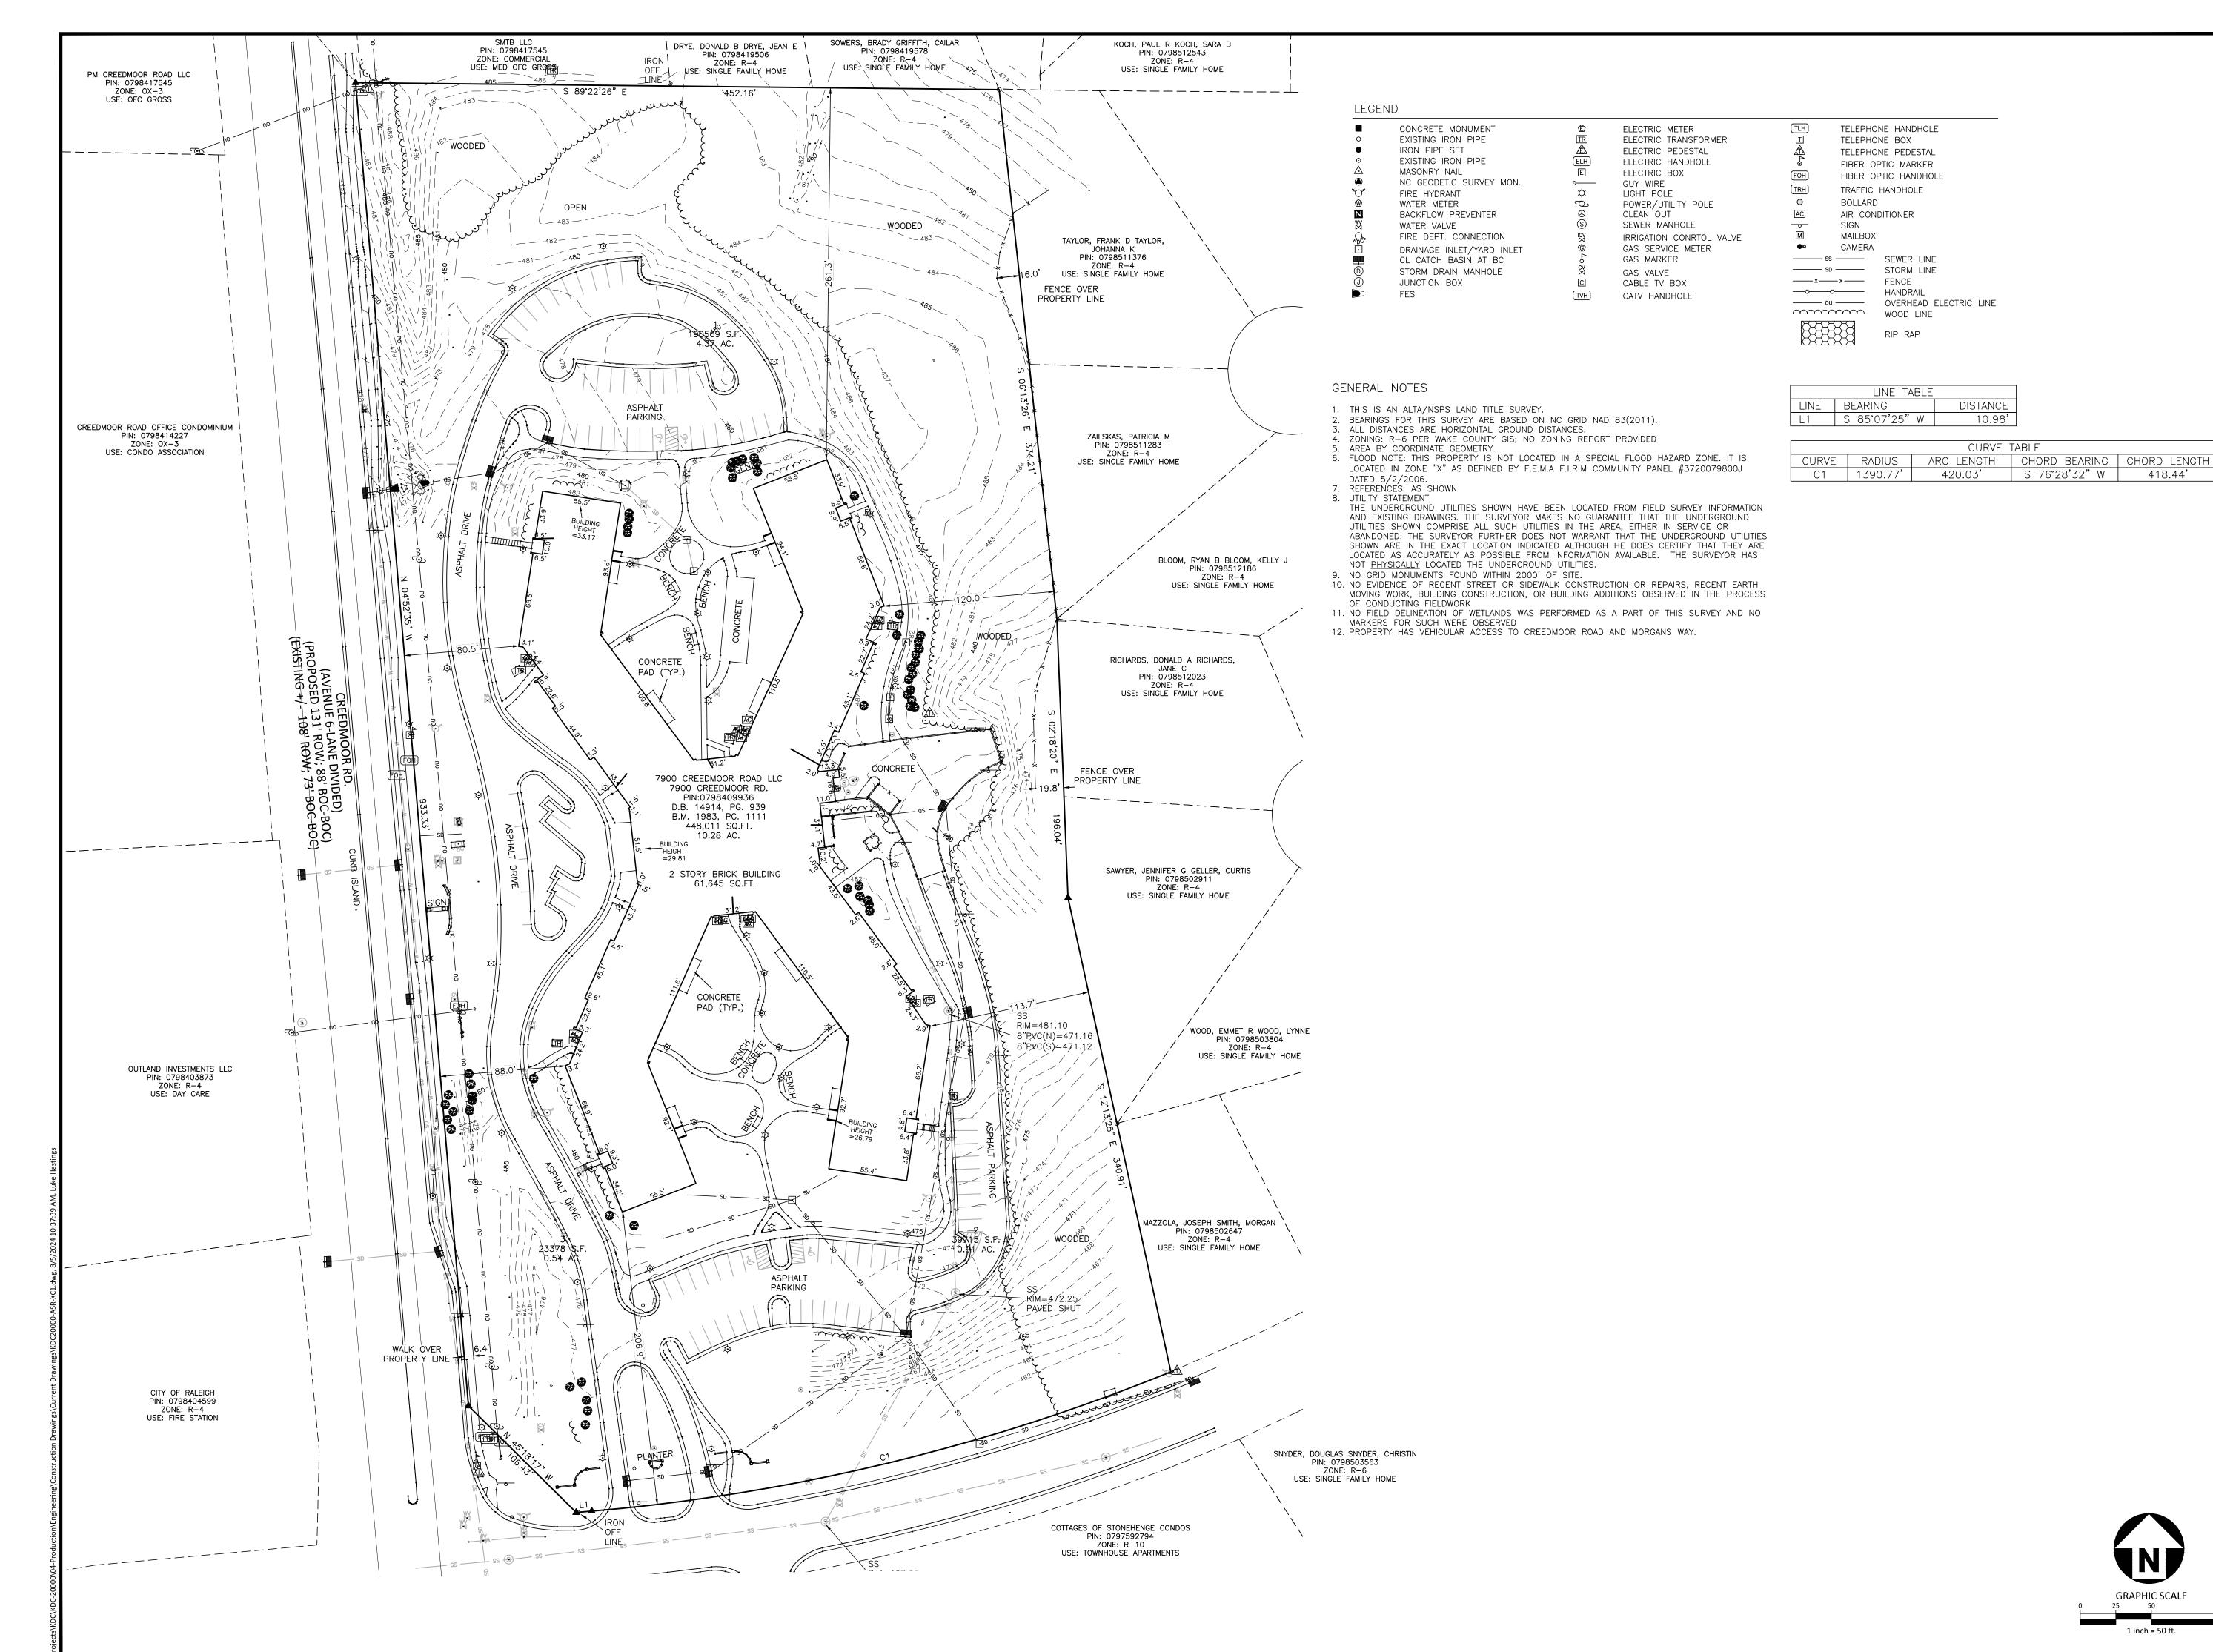

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> Raleigh, NC 27603 phone 919. 823. 4300 fax 919. 361. 2269

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license number: C-0293, C-187

CLIENT

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HEN **ONEI** AGE

REVISIONS

NO. DATE

PLAN INFORMATION

PROJECT NO. KDC20000 FILENAME KDC20000-ASR-XC1.DWG CHECKED BY

DRAWN BY 1"=50'

SCALE DATE 08.05. 2024 SHEET

EXISTING CONDITIONS PLAN



DEMOLITION LEGEND

XTREE

UNDERGROUND UTILITY TO BE REMOVED

(SIDEWALK, CURB AND GUTTER, STRUCTURES, ASPHALT, CONCRETE NOTE: SEE PLAN FOR DETAILED DEMOLITION PROCEDURES, SEQUENCING AND SPECIFICATIONS.

AREA TO BE REMOVED

TREE OR OTHER VEGETATION TO BE REMOVED

SECONDARY TREE CONSERVATION AREA

CLIENT

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2905 Meridian Parkway Durham, NC 27713

phone 919. 361. 5000 fax 919. 361. 2269

license number: C-0293, C-187

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REVISIONS

NO. DATE

PLAN INFORMATION

PROJECT NO. KDC-20000 FILENAME KDC20000-ASR-DM1

CHECKED BY DRAWN BY SCALE DATE 08.05.2024

SHEET


DEMOLITION PLAN

SEE SHEET CO.00 FOR ALL PROJECT NOTES.

SPECIFICATIONS AND DETAILS.

ALL CONSTRUCTION SHALL CONFORM WITH THE LATEST

VERSION OF THE CITY OF RALEIGH AND NCDOT STANDARDS

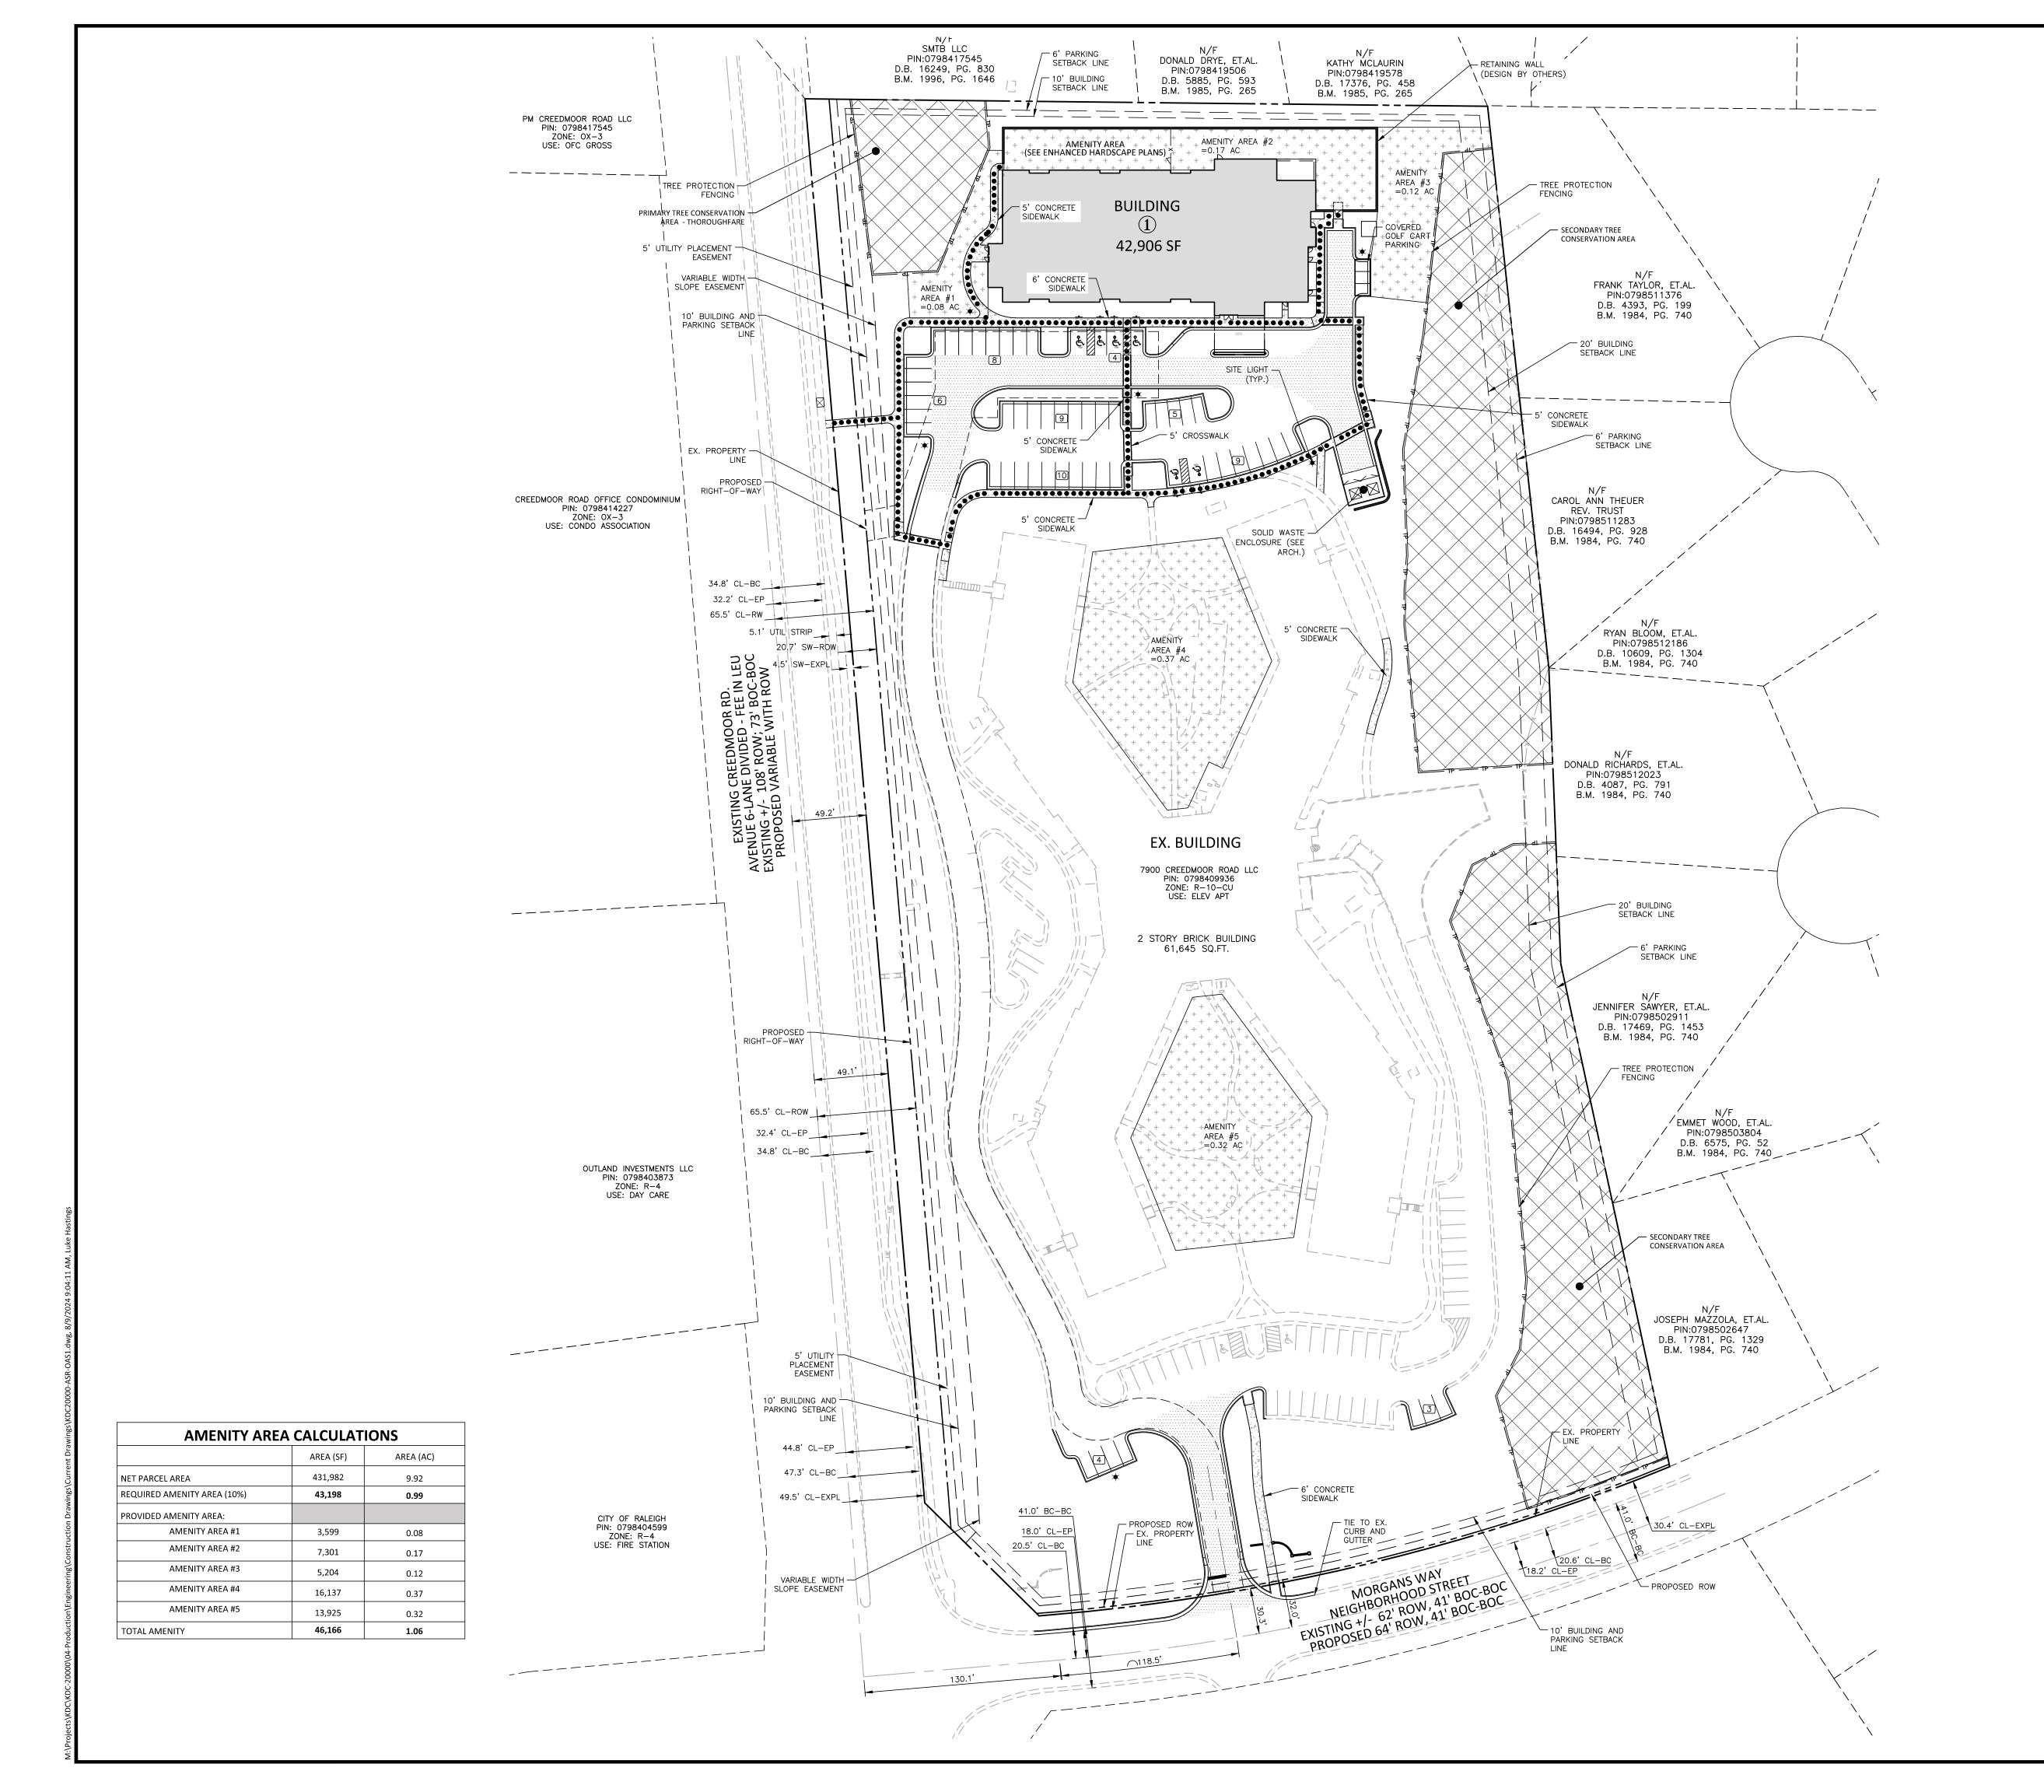





SIGNAGE YARD LIGHTS LIGHT POLE POWER POLE

••••••

SECONDARY TREE CONSERVATION AREA

LIGHT DUTY CONCRETE SIDEWALK

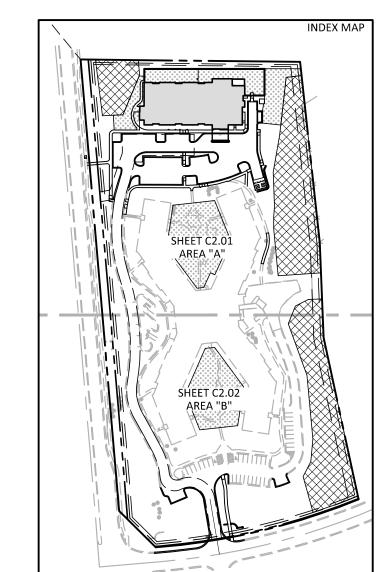

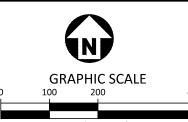

SEE SHEET CO.00 FOR ALL PROJECT NOTES.

ALL CONSTRUCTION SHALL CONFORM WITH THE LATEST VERSION OF THE CITY OF RALEIGH AND NCDOT STANDARDS SPECIFICATIONS AND DETAILS.



PRELIMINARY DRAWING - NOT RELEASED FOR CONSTRUCTION

SITE LEGEND

TRAFFIC DIRECTIONAL ARROW

ACCESSIBLE RAMPS

TYPE (A) TYPE (B) TYPE ©


PROPERTY LINE RIGHT-OF-WAY LINE LOT LINE

> CENTERLINE TREE PROTECTION FENCING ACCESSIBLE ROUTE

> > HEAVY DUTY ASPHALT

EASEMENT LINE

AMENITY AREA

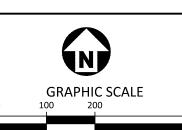

NO. DATE

PLAN INFORMATION

PROJECT NO. KDC-20000 FILENAME KDC20000-ASR-OAS1

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CLIENT

MR. JOE WHITEHOUSE

KISCO SENIOR LIVING


5790 FLEET STREET, SUITE 300

CARLSBAD, CALIFORNIA 92008

CHECKED BY DRAWN BY SCALE 1"=50'

DATE 08.05.2024 SHEET

OVERALL SITE PLAN

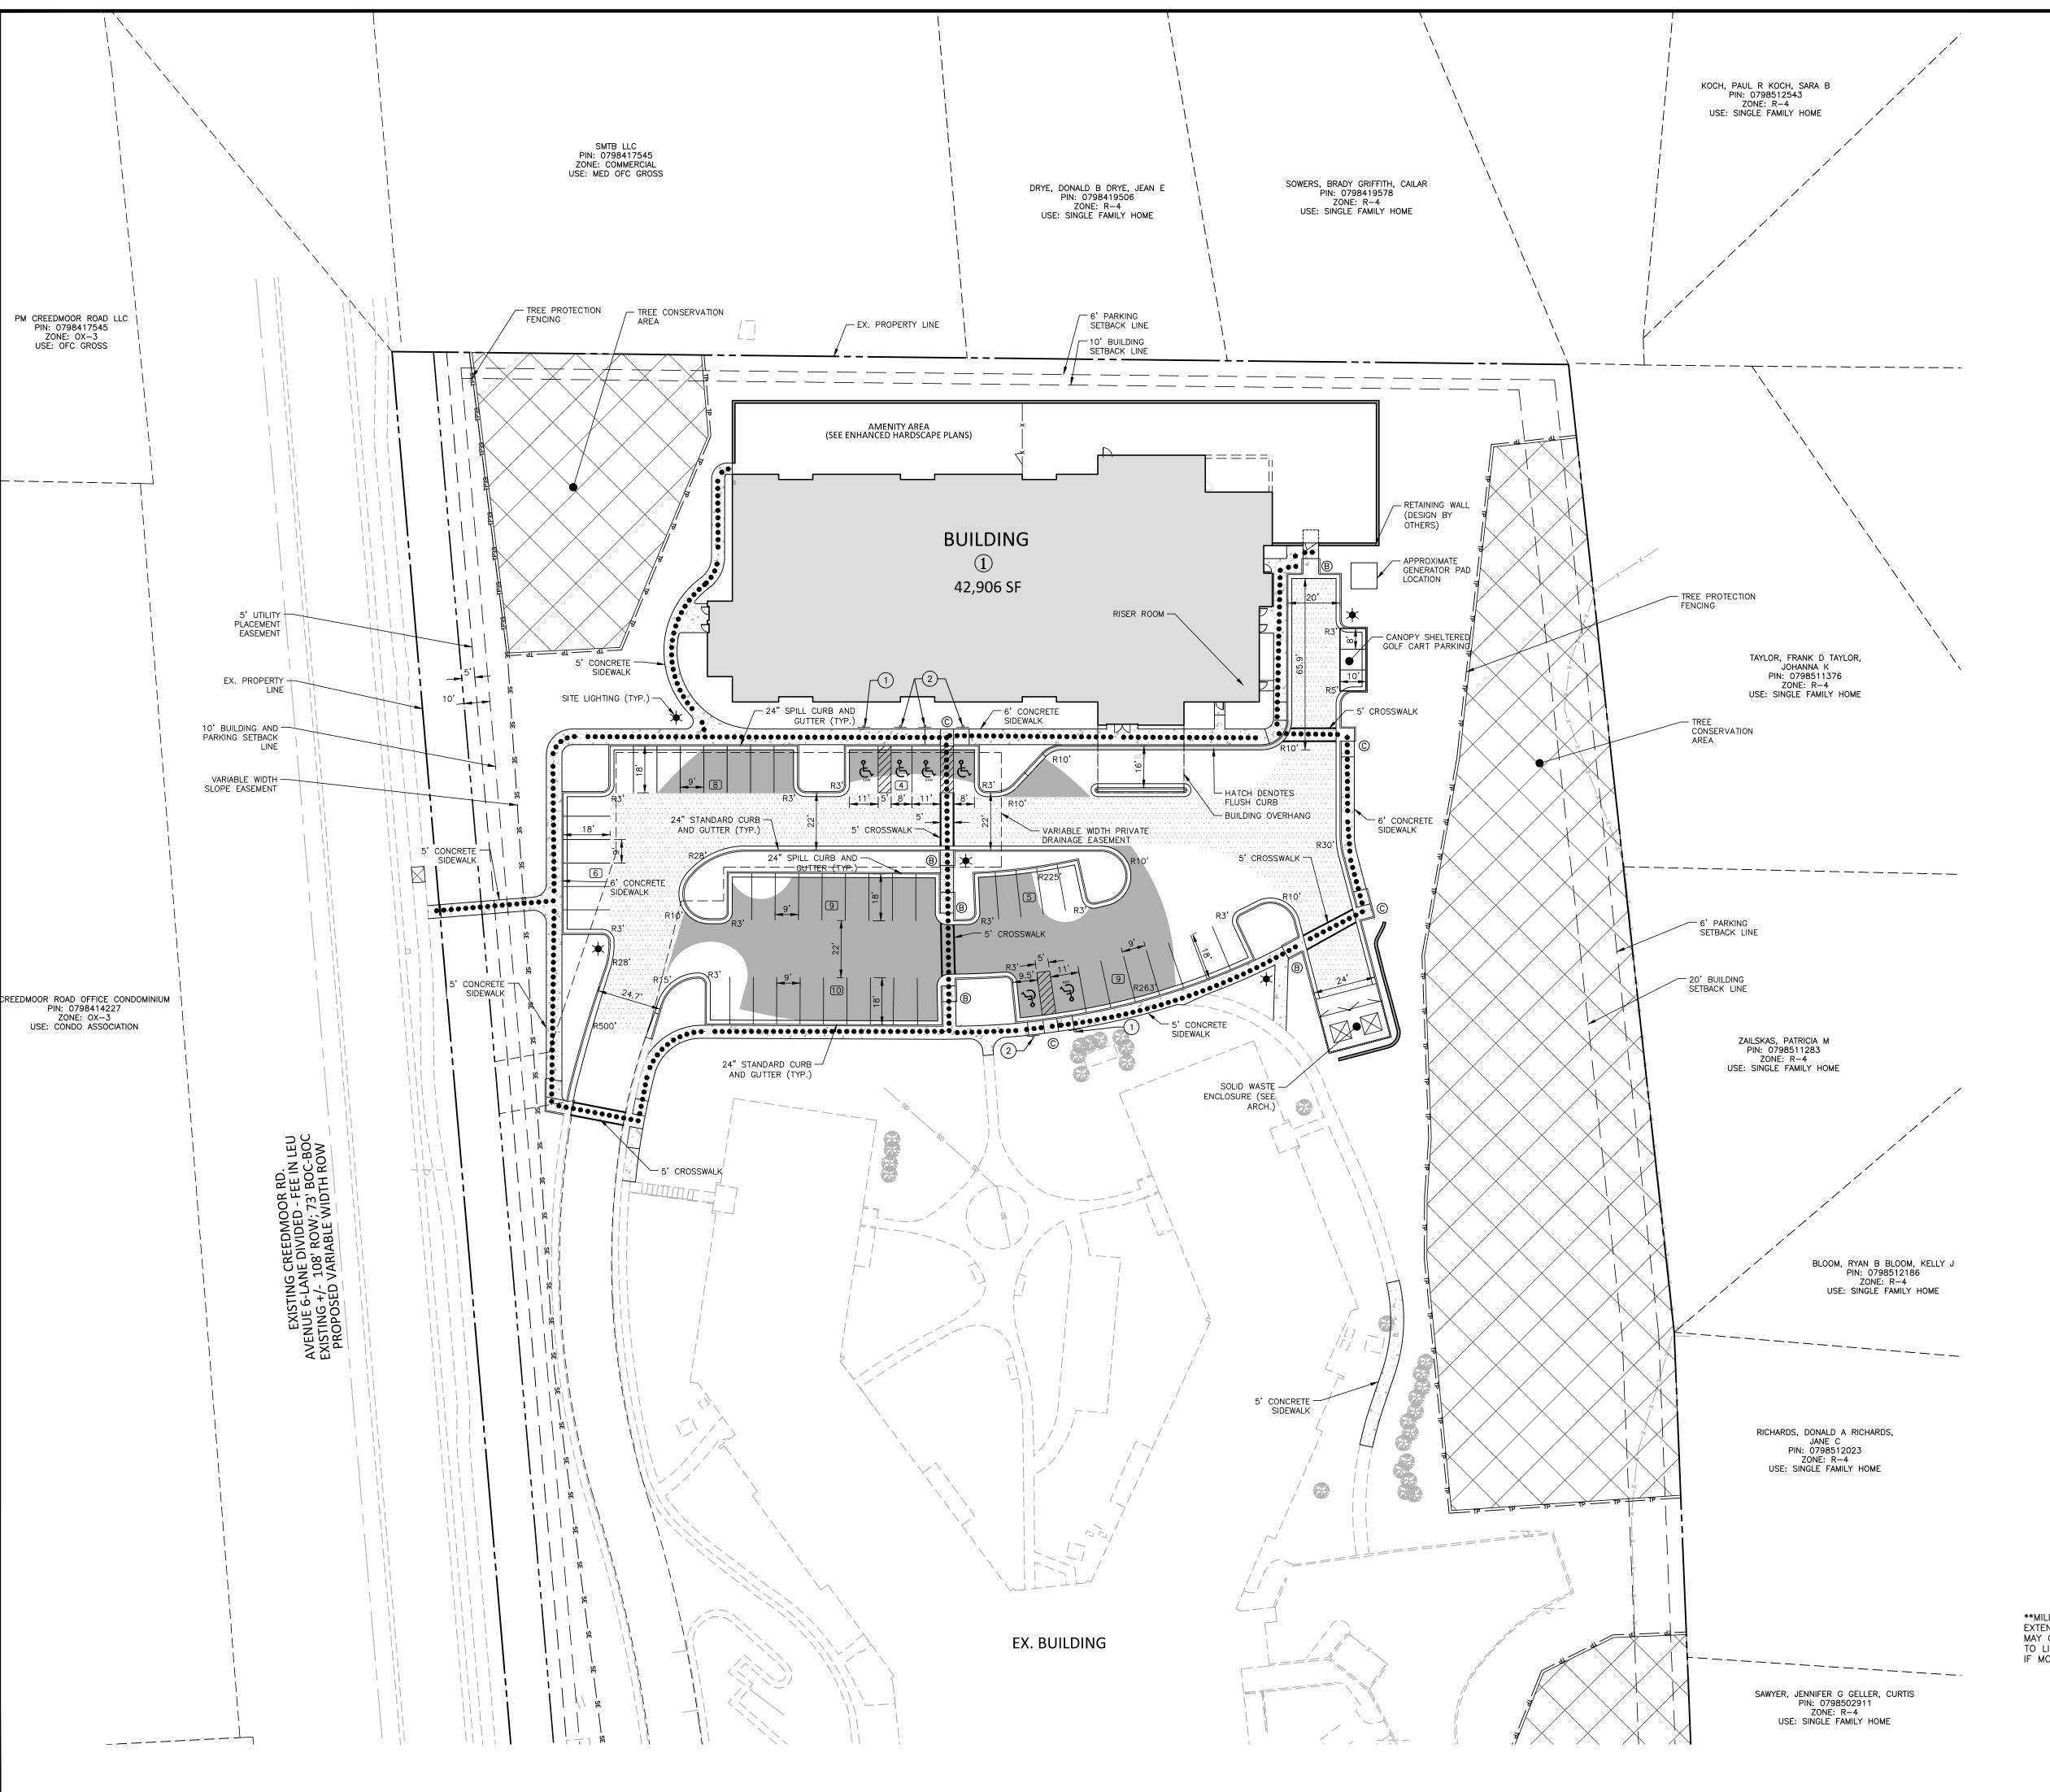



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LIGHT DUTY CONCRETE SIDEWALK

MILL AND OVERLAY LIMITS**

SIGNAGE LEGEND

SITE LEGEND

SIGNAGE

YARD LIGHTS

LIGHT POLE

POWER POLE

ACCESSIBLE RAMPS

RIGHT-OF-WAY LINE

TREE PROTECTION FENCING

SECONDARY TREE CONSERVATION AREA

HEAVY DUTY ASPHALT

LOT LINE

CENTERLINE

● ● ● ● ● ● ● ● ● ACCESSIBLE ROUTE

EASEMENT LINE

TRAFFIC DIRECTIONAL ARROW



MUTCD R7-8

12"X18" MUTCD R7-8P 18"X9" MUTCD R7-8D








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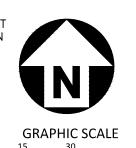




SEE SHEET CO.00 FOR ALL PROJECT NOTES.

ALL CONSTRUCTION SHALL CONFORM WITH THE LATEST VERSION OF THE CITY OF RALEIGH AND NCDOT STANDARDS SPECIFICATIONS AND DETAILS.

**MILL AND OVERLAY LIMITS SHOW THE EXTENT OF EXISTING ASPHALT. CONTRACTOR MAY CHOOSE TO REPLACE EXISTING ASPHALT TO LIGHT DUTY ASPHALT PAVEMENT SECTION IF MORE COST EFFECTIVE

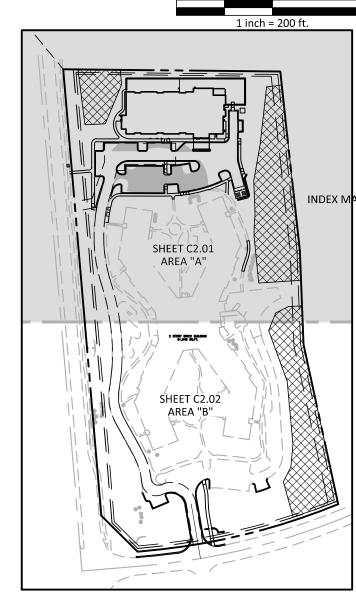

PRELIMINARY DRAWING - NOT RELEASED FOR CONSTRUCTION



REVISIONS

NO. DATE

PLAN INFORMATION

PROJECT NO. KDC-20000 FILENAME KDC20000-ASR-S1.DWG CHECKED BY

DRAWN BY SCALE 1"=30' DATE 08.05.2024

SHEET

DETAILED SITE PLAN AREA "A"





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VIINIS⁷900 C

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MR. JOE WHITEHOUSE KISCO SENIOR LIVING 5790 FLEET STREET, SUITE 300 CARLSBAD, CALIFORNIA 92008

SIGNAGE LEGEND











SIGNAGE

YARD LIGHTS

LIGHT POLE

POWER POLE

ACCESSIBLE RAMPS

RIGHT-OF-WAY LINE

TREE PROTECTION FENCING

ACCESSIBLE ROUTE

SECONDARY TREE CONSERVATION AREA


HEAVY DUTY ASPHALT

MILL AND OVERLAY LIMITS

LIGHT DUTY CONCRETE SIDEWALK

CENTERLINE

TRAFFIC DIRECTIONAL ARROW

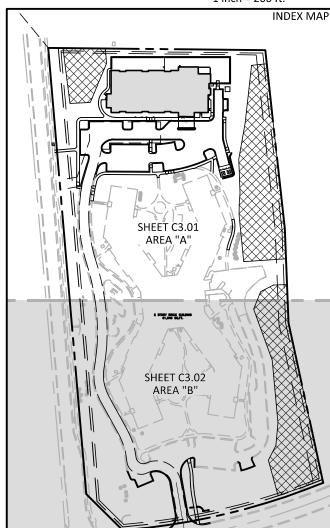


NO. DATE

REVISIONS

SEE SHEET CO.00 FOR ALL PROJECT NOTES.

ALL CONSTRUCTION SHALL CONFORM WITH THE LATEST VERSION OF THE CITY OF RALEIGH AND NCDOT STANDARDS SPECIFICATIONS AND DETAILS.

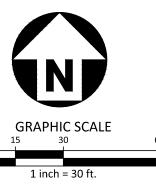


PLAN INFORMATION

PROJECT NO. KDC-20000 KDC20000-ASR-S1.DWG FILENAME CHECKED BY

DRAWN BY SCALE 1"=30' DATE 08.05.2024

SHEET DETAILED SITE PLAN AREA "B"

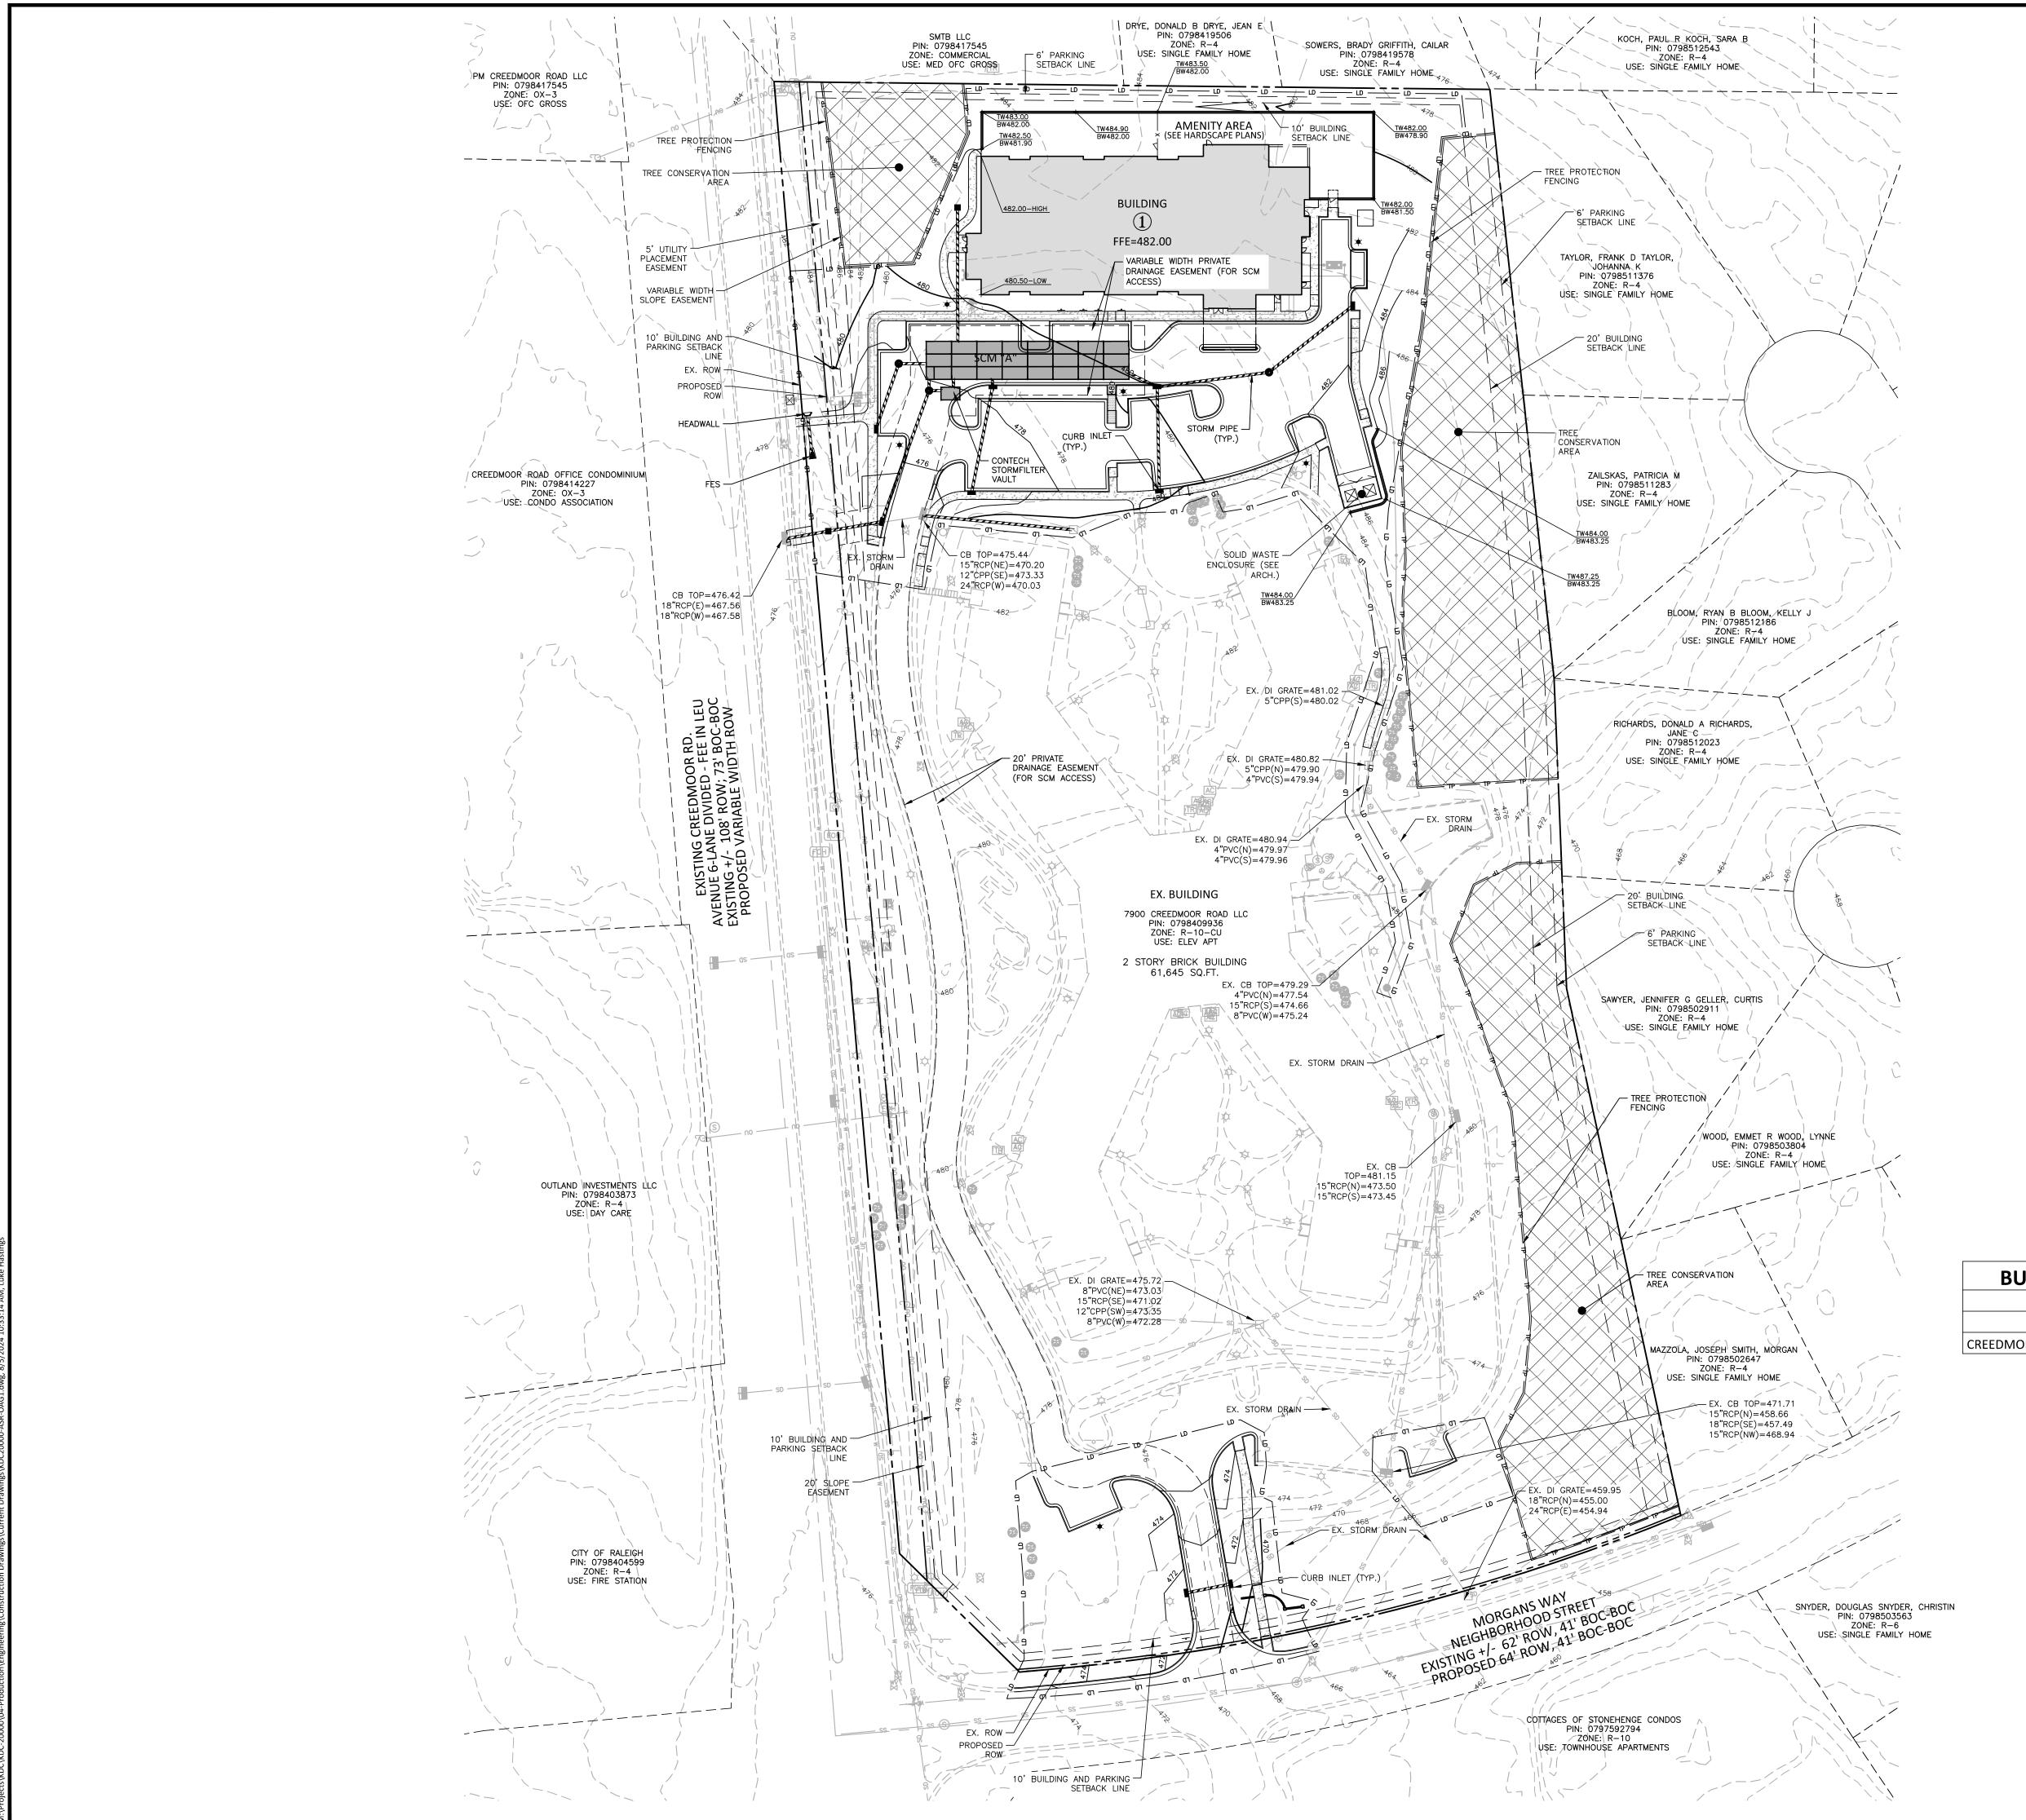

GRADING LEGEND

FLARED END SECTION

ENDWALL SECTION CATCH BASIN

DROP INLET AREA DRAIN

STORM SERVICE CLEAN OUT JUNCTION BOX DRAINAGE FLOW ARROW

LINE BREAK SYMBOL TOP & BOTTOM CURB ELEVATIONS

TW=223.00 — TOP OF WALL ELEVATION
BW=213.00 — BOTTOM OF WALL ELEVATION — BOTTOM OF WALL ELEVATION (NOTE: BOTTOM OF WALL IS GROUND

ELEVATION NOT WALL FOUNDATION) SPOT ELEVATION + 250.60 STORM DRAINAGE


---- STORM SERVICE LINE — TP — TP — TP — TREE PROTECTION FENCE

WOODED AREA MAJOR CONTOUR ____ MINOR CONTOUR EXISTING MAJOR CONTOUR _____252____ EXISTING MINOR CONTOUR — — — EASEMENT LINE

> ACCESSIBLE PARKING AREA (2% MAX. SLOPE IN ALL DIRECTIONS)


SECONDARY TREE CONSERVATION AREA

6' LIGHT DUTY CONCRETE SIDEWALK

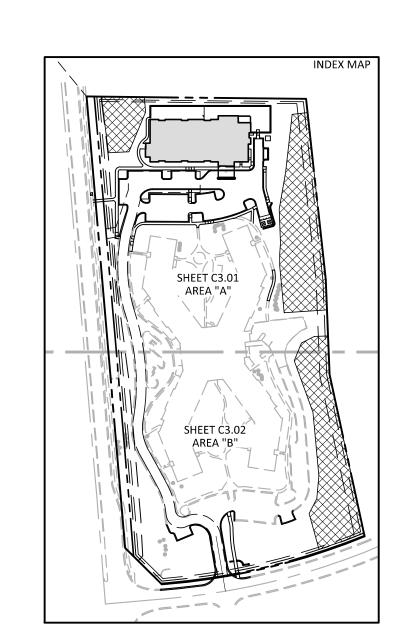

BUILDING #1 AVERAGE GRADE PLANE				
	PROPOSED			
	HIGH LOW AVERAGE			
CREEDMORE ROAD	482.00	480.50	481.25	



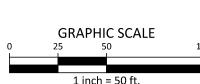

SEE SHEET CO.00 FOR ALL PROJECT NOTES.

ALL CONSTRUCTION SHALL CONFORM WITH THE LATEST VERSION OF THE CITY OF RALEIGH AND NCDOT STANDARDS SPECIFICATIONS AND DETAILS.

CHECKED BY

1"=50' 08.05.2024

OVERALL GRADING PLAN

PRELIMINARY DRAWING - NOT RELEASED FOR CONSTRUCTION



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REVISIONS


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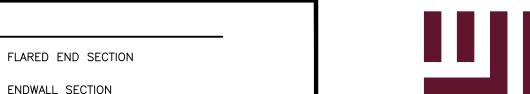
PLAN INFORMATION

PROJECT NO. KDC-20000 KDC20000-ASR-OAG1 FILENAME

DRAWN BY SCALE DATE

SHEET



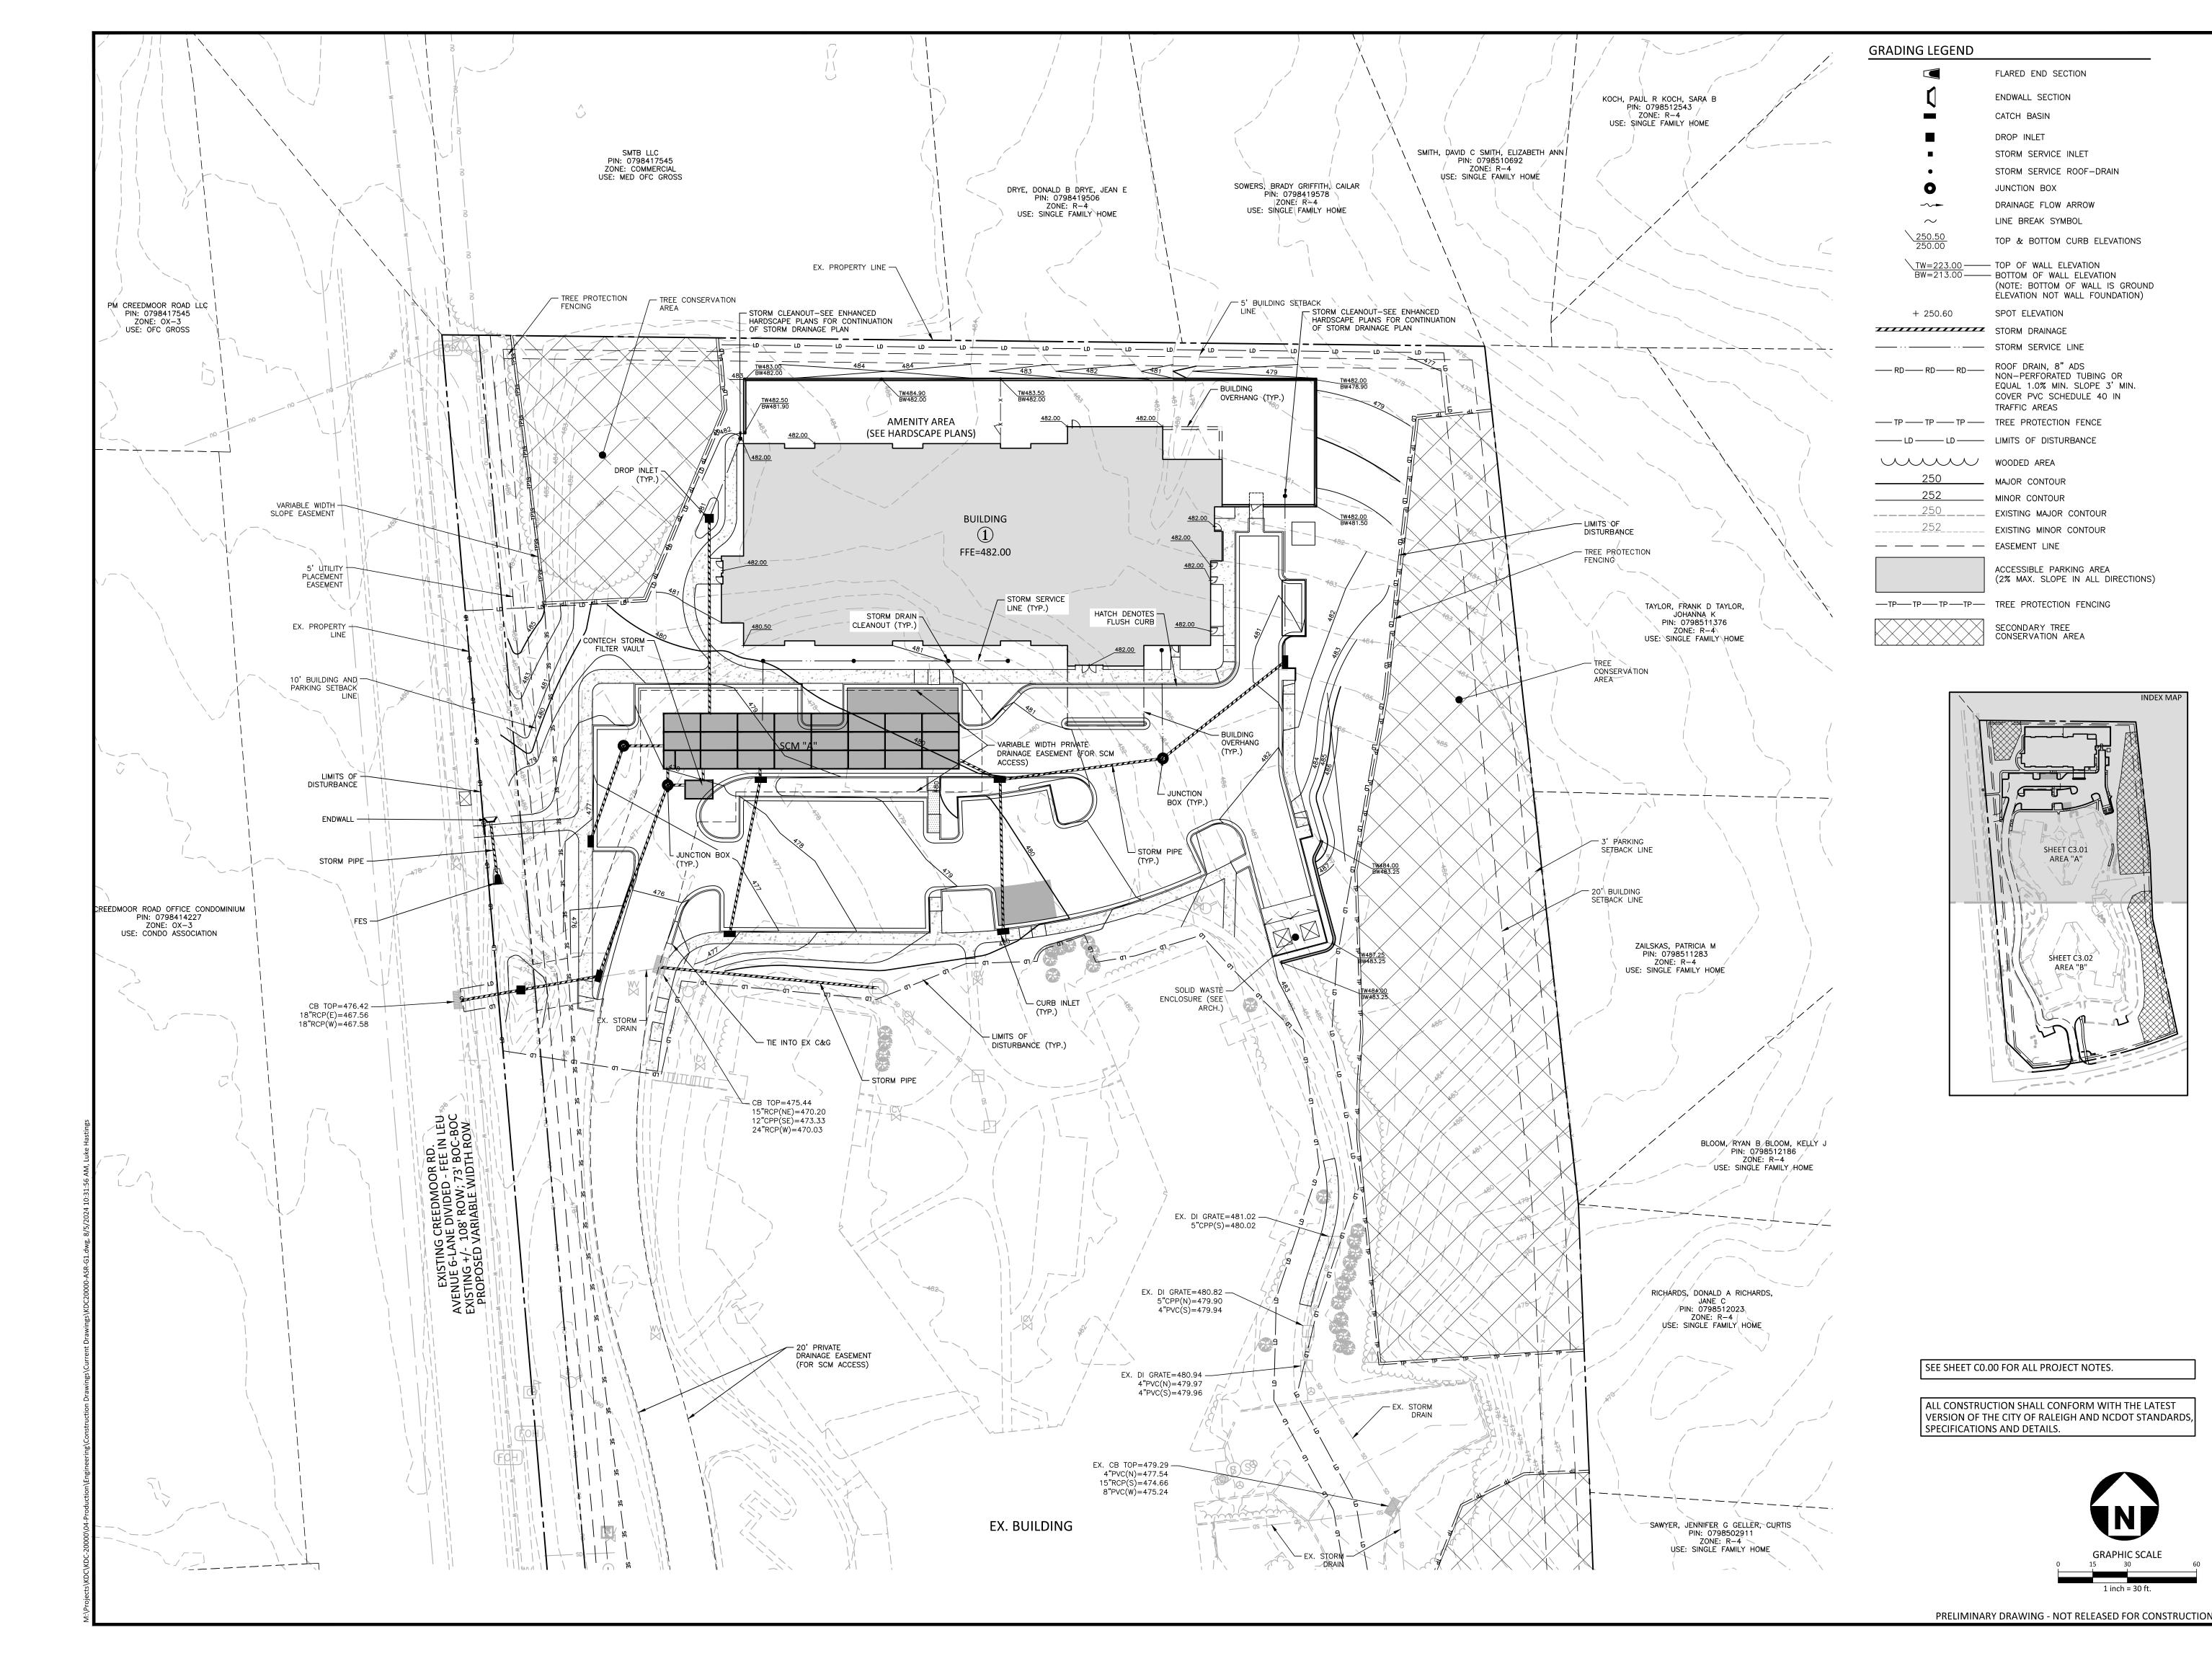


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REVISIONS

SHEET C3.01

AREA "B"

AREA "A"

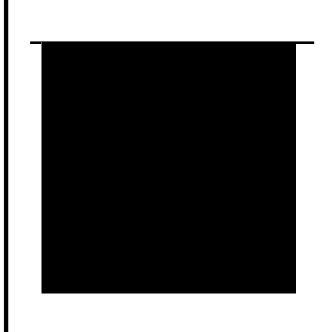NO. DATE


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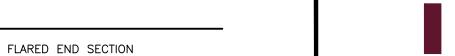
PROJECT NO. KDC-20000 KDC20000-ASR-G1.DWG FILENAME CHECKED BY

DRAWN BY SCALE 1"=30' DATE 08.05.2024

SHEET

DETAILED GRADING PLAN AREA "A"



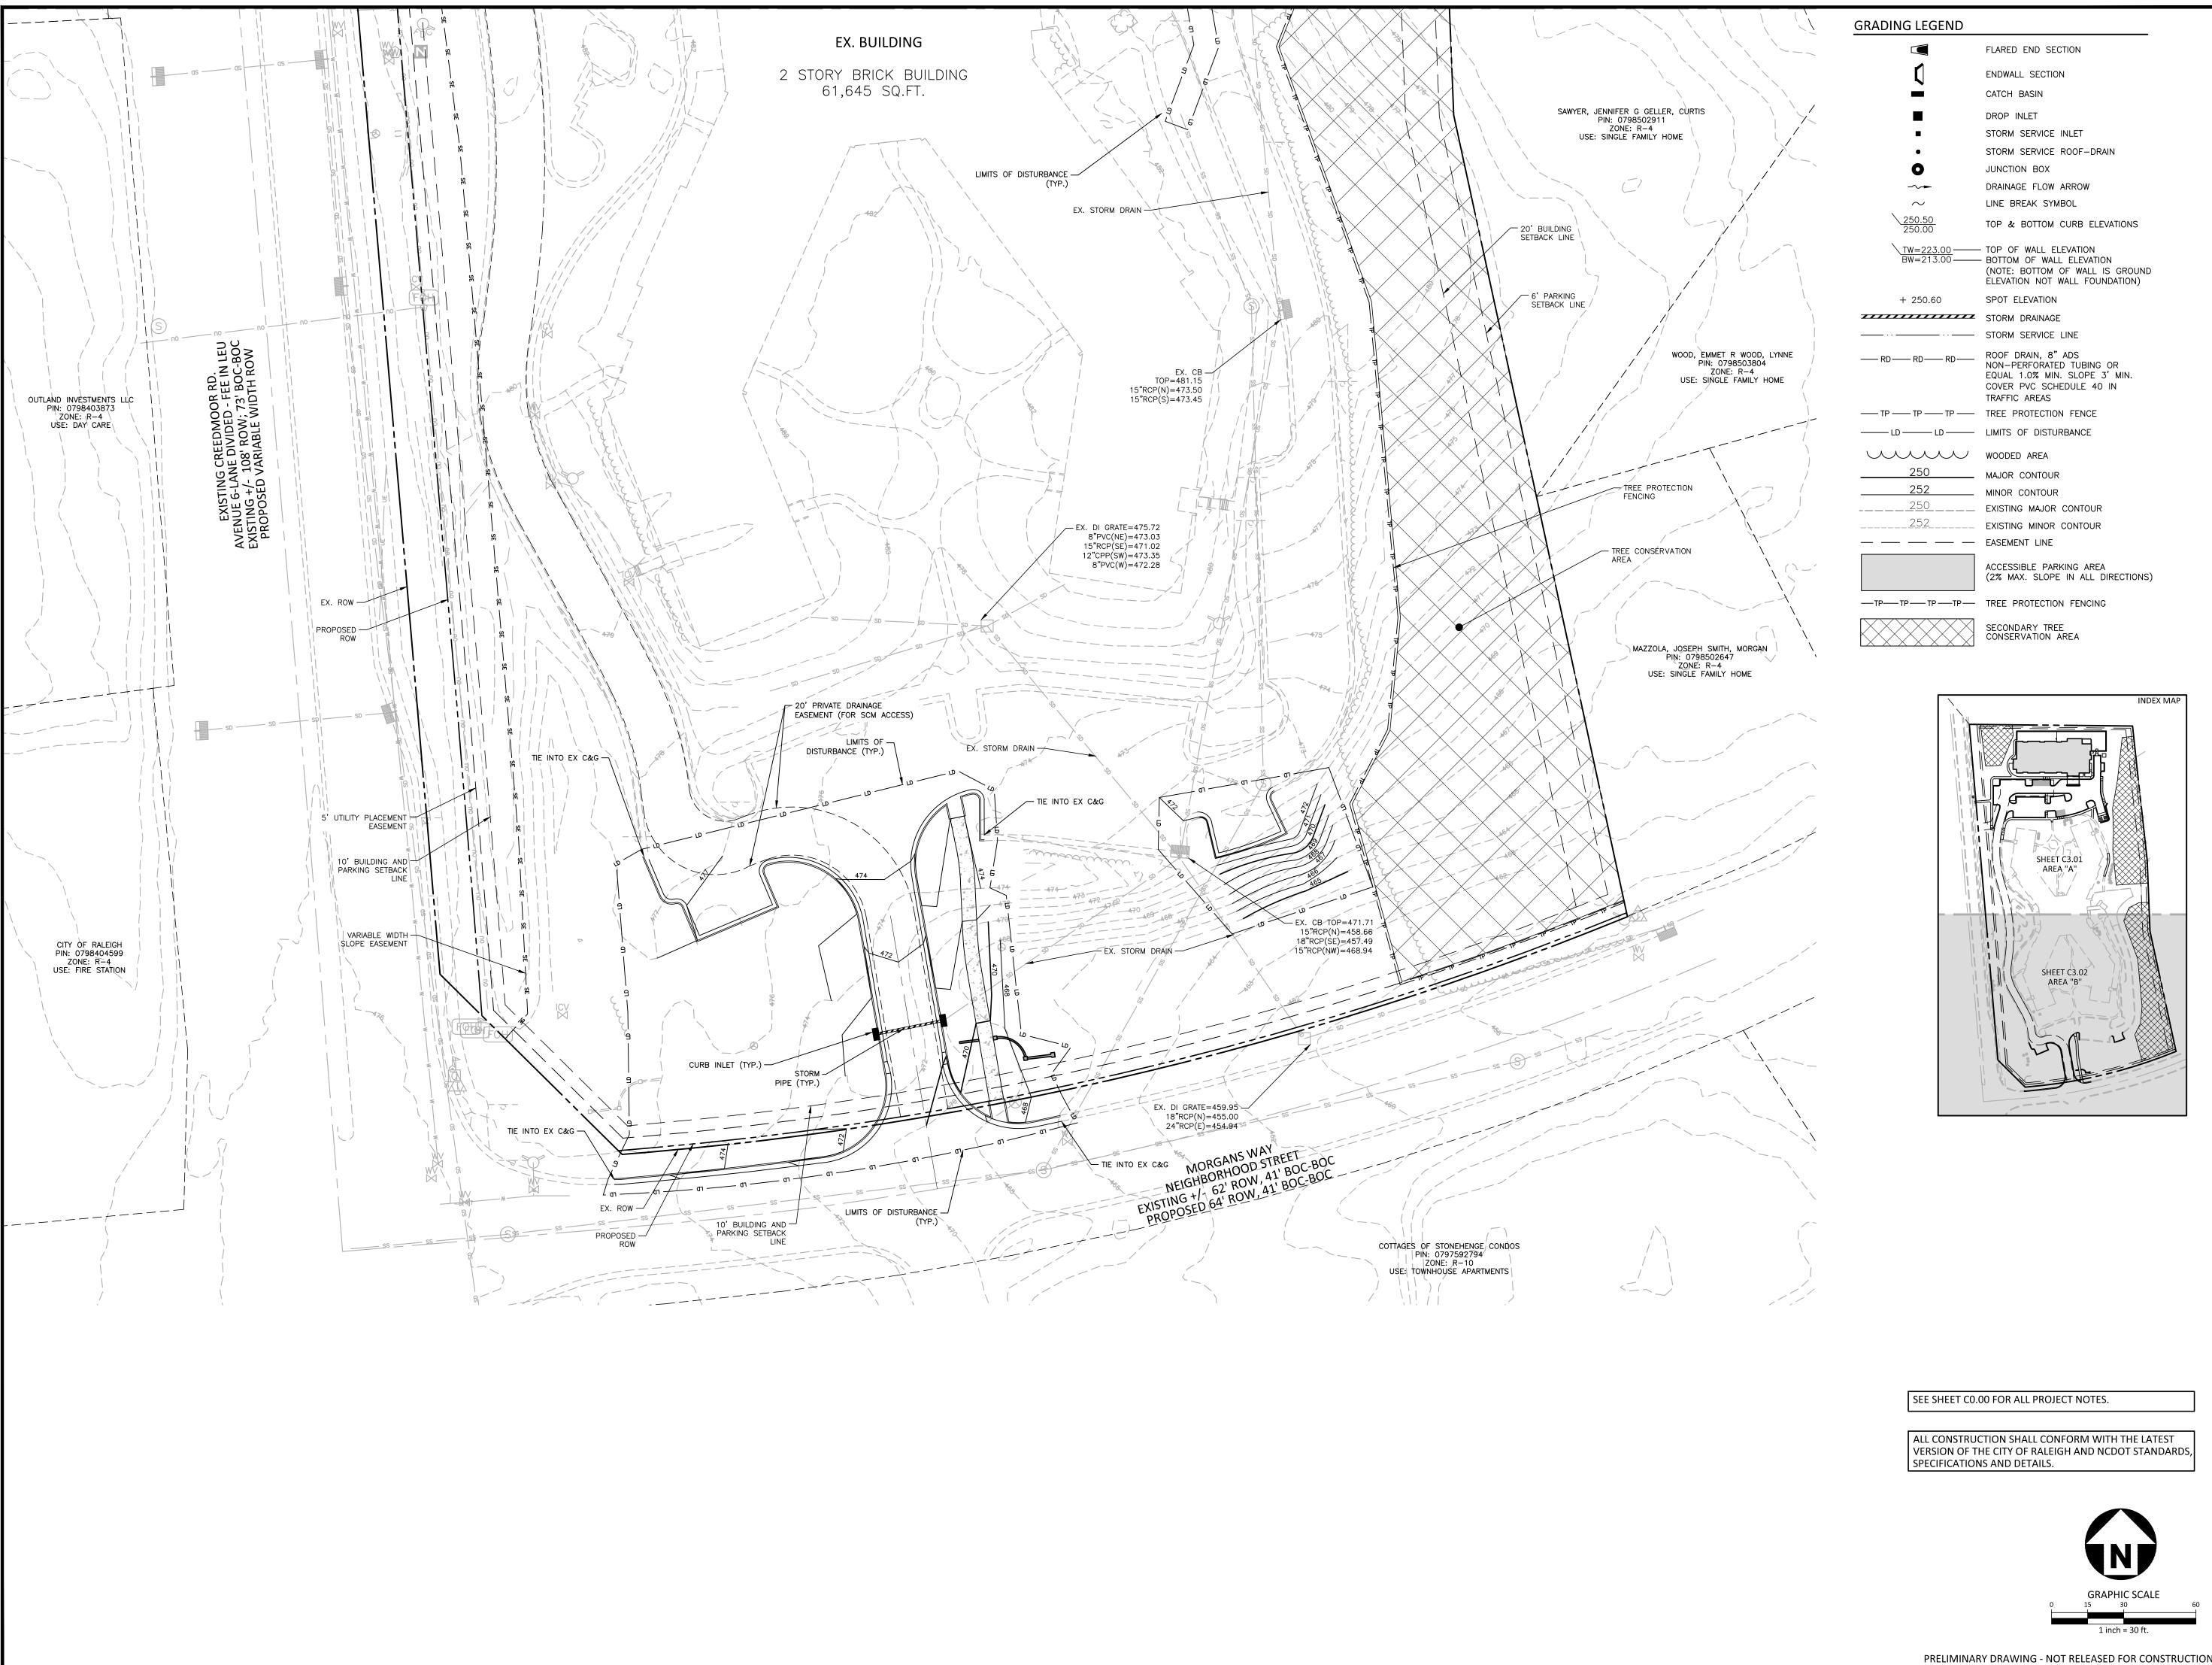

ENDWALL SECTION

STORM SERVICE INLET

DRAINAGE FLOW ARROW

LINE BREAK SYMBOL

STORM SERVICE ROOF-DRAIN

TOP & BOTTOM CURB ELEVATIONS

(NOTE: BOTTOM OF WALL IS GROUND

ELEVATION NOT WALL FOUNDATION)

NON-PERFORATED TUBING OR EQUAL 1.0% MIN. SLOPE 3' MIN.

COVER PVC SCHEDULE 40 IN

ACCESSIBLE PARKING AREA

SECONDARY TREE CONSERVATION AREA

(2% MAX. SLOPE IN ALL DIRECTIONS)

SHEET C3.01

AREA "A"

SHEET C3.02 AREA "B"

- BOTTOM OF WALL ELEVATION

CATCH BASIN

JUNCTION BOX

SPOT ELEVATION

TRAFFIC AREAS

ROOF DRAIN, 8" ADS

DROP INLET

The John R. McAdams Company, Inc. 2905 Meridian Parkway Durham, NC 27713

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CLIENT

MR. JOE WHITEHOUSE

KISCO SENIOR LIVING

5790 FLEET STREET, SUITE 300 CARLSBAD, CALIFORNIA 92008



PLAN INFORMATION

PROJECT NO. KDC-20000

1"=30'

08.05.2024

DETAILED GRADING PLAN AREA "B"

KDC20000-ASR-G1.DWG

NO. DATE

FILENAME

CHECKED BY DRAWN BY


SCALE


DATE

SHEET


SEE SHEET CO.00 FOR ALL PROJECT NOTES.

ALL CONSTRUCTION SHALL CONFORM WITH THE LATEST VERSION OF THE CITY OF RALEIGH AND NCDOT STANDARDS SPECIFICATIONS AND DETAILS.

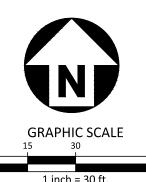

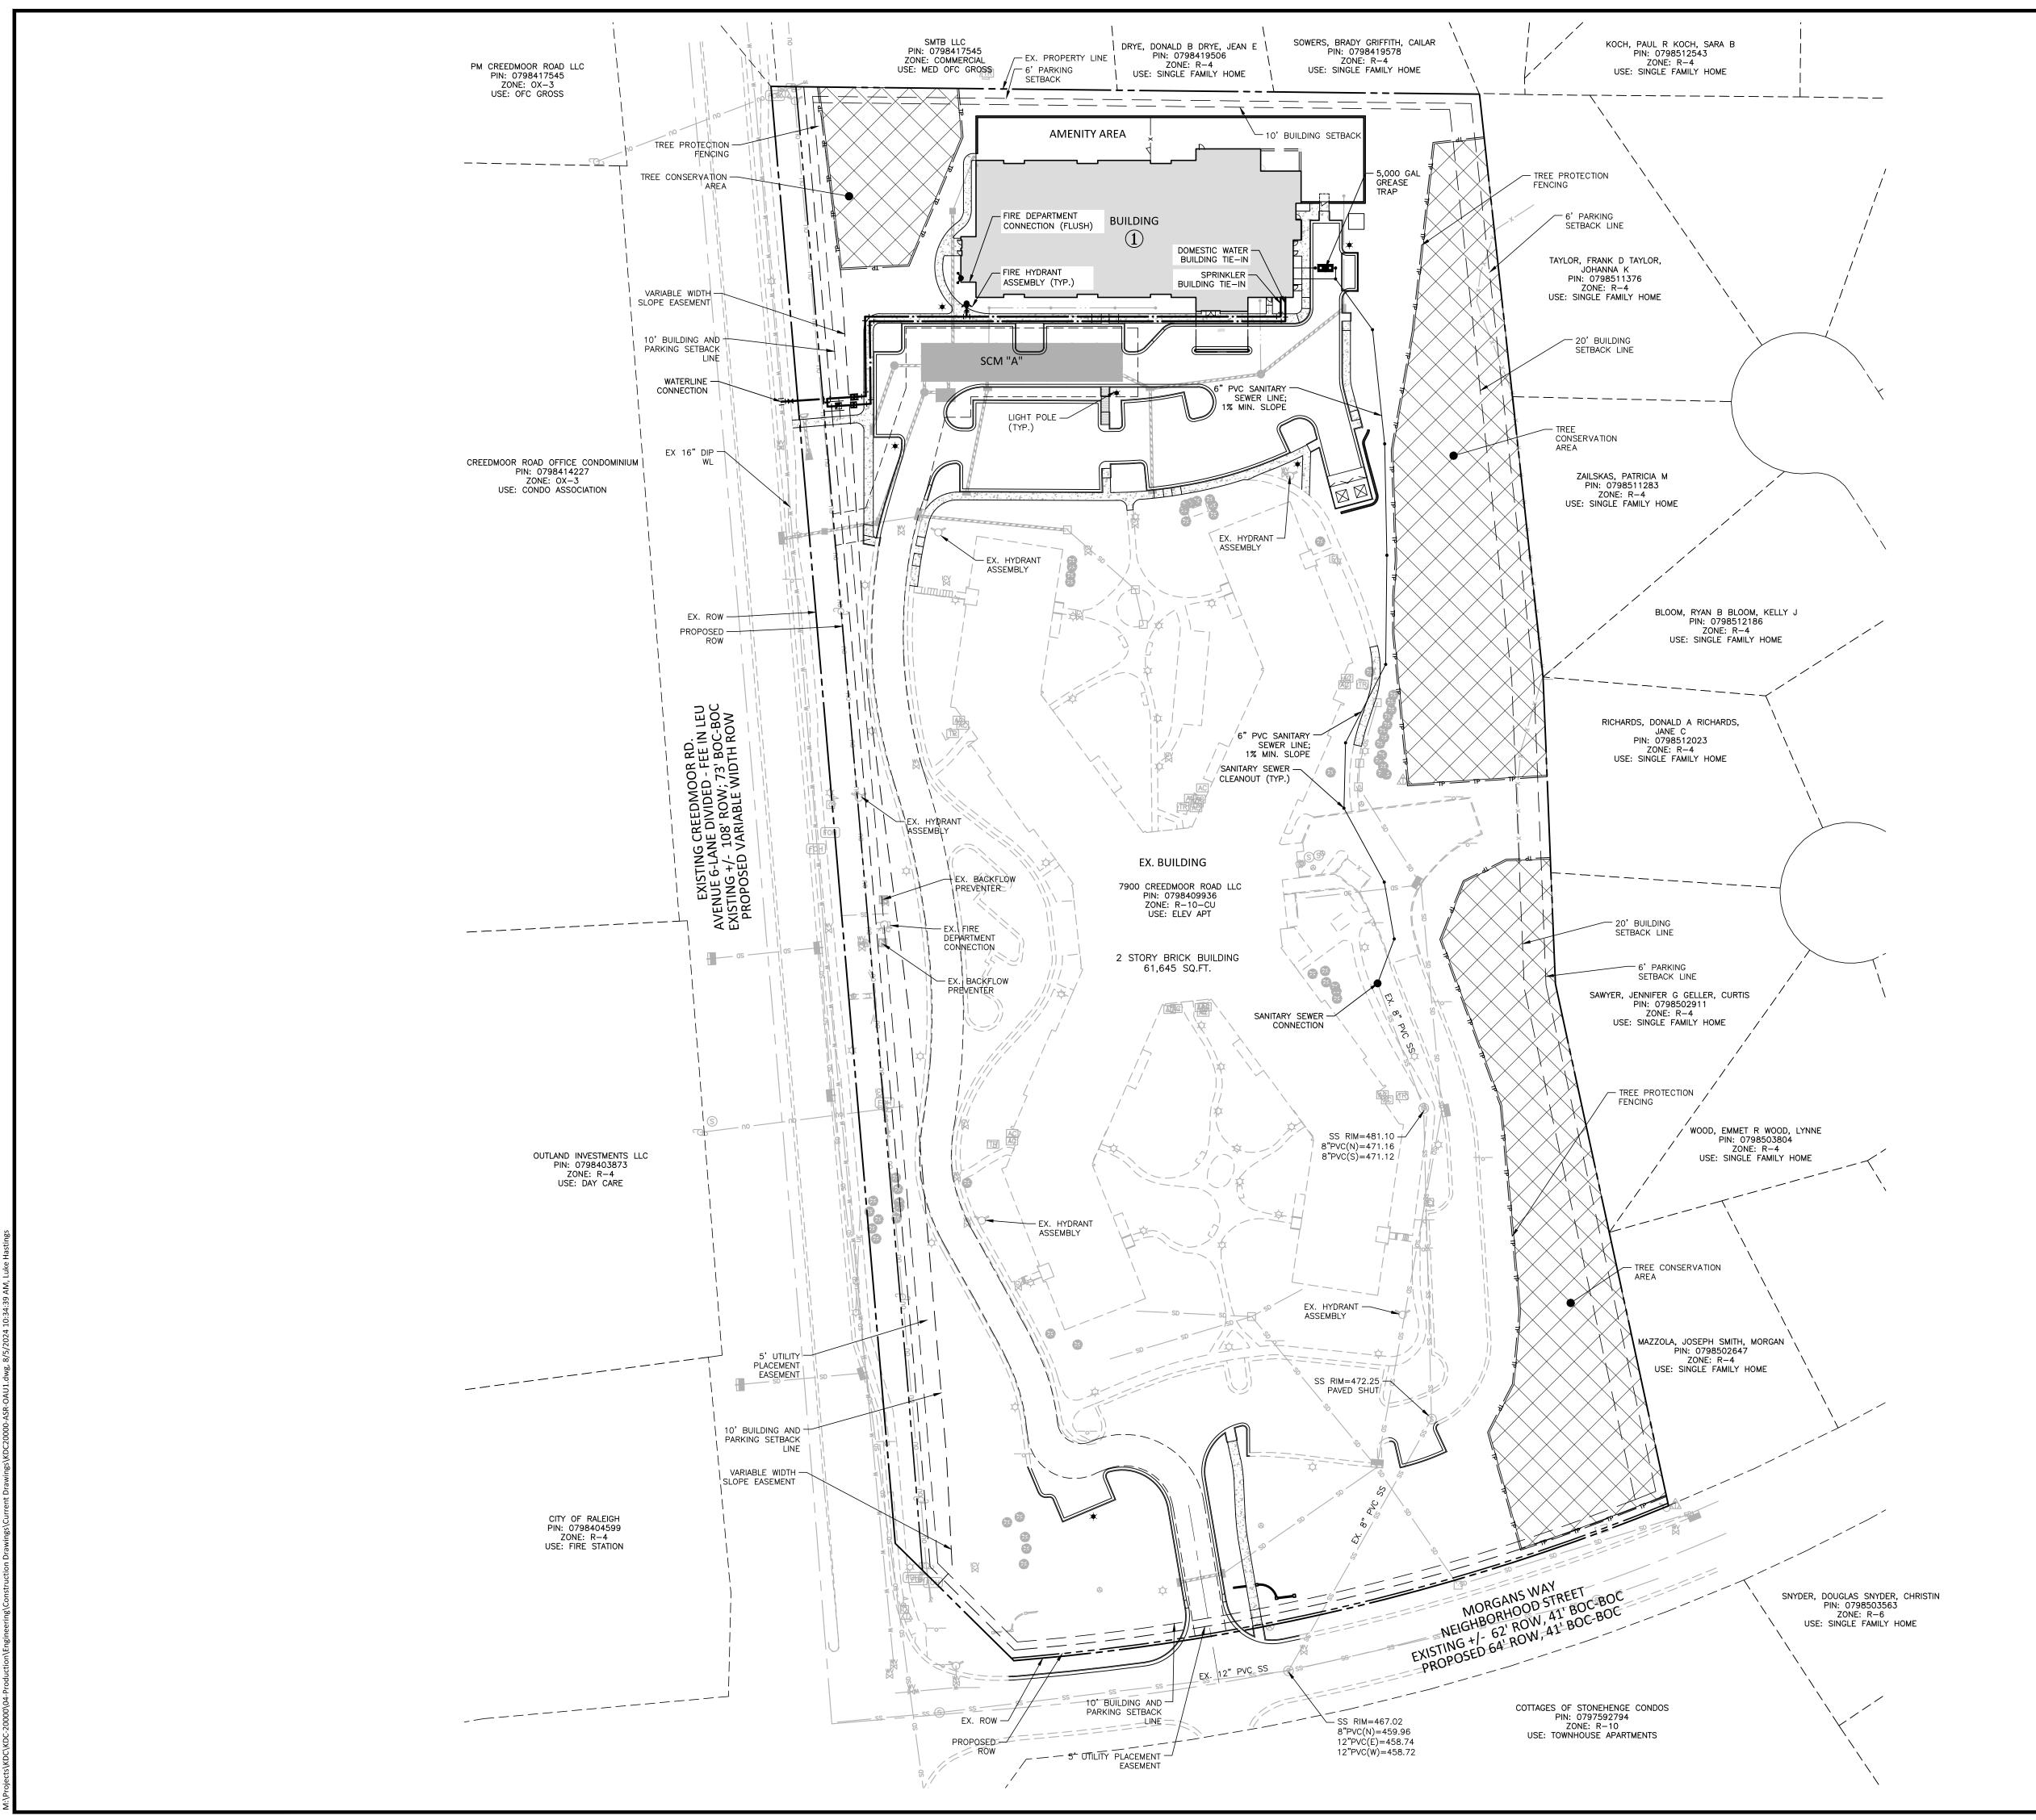

UTILITY LEGEND FIRE HYDRANT ASSEMBLY FIRE DEPARTMENT CONNECTION (FDC) WATER METER WATER VALVE POST INDICATOR VALVE VALVE IN MANHOLE METER & VAULT BACKFLOW PREVENTER REDUCER PLUG BLOW-OFF ASSEMBLY SANITARY SEWER MANHOLE SEWER CLEAN-OUT GREASE TRAP SEWER FLOW DIRECTION ARROW YARD LIGHTS LIGHT POLE POWER POLE LINE BREAK SYMBOL ----- WATERLINE THE CONTRACT OF THE CONTRACT O SANITARY SEWER ----- SEWER SERVICE LINE -----FM-FM-SEWER FORCE MAIN ——G——G——G—— GAS LINE OVERHEAD UTILITY —— UE—— UE— UNDERGROUND ELECTRIC —__T—__T—_T—__T TELEPHONE — — — EASEMENT LINE —TP—TP—TP—TP— TREE PROTECTION FENCING

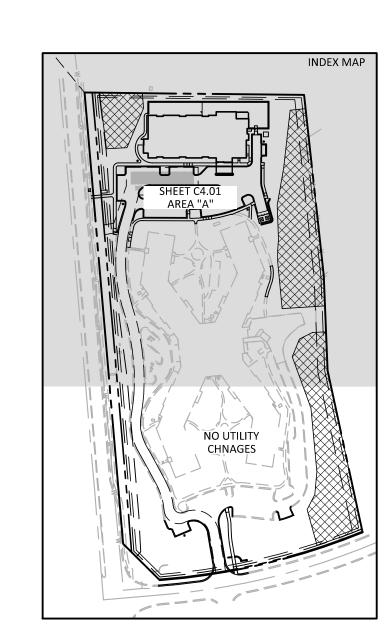

SECONDARY TREE

CONSERVATION AREA

ALL CONSTRUCTION SHALL CONFORM WITH THE LATEST VERSION OF THE CITY OF RALEIGH AND NCDOT STANDARDS SPECIFICATIONS AND DETAILS.

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1 inch = 50 ft.

PRELIMINARY DRAWING - NOT RELEASED FOR CONSTRUCTION



MCADAMS

The John R. McAdams Company, Inc. 2905 Meridian Parkway Durham, NC 27713

phone 919. 361. 5000 fax 919. 361. 2269 license number: C-0293, C-187

www.mcadamsco.com

CLIENT

MR. JOE WHITEHOUSE KISCO SENIOR LIVING 5790 FLEET STREET, SUITE 300 CARLSBAD, CALIFORNIA 92008

BBOTTSWOOD AT STONEHENGE MINISTRATIVE SITE REVIEW '900 CREEDMOOR ROAD RALEIGH, NORTH CAROLINA, 27613



REVISIONS

NO. DATE

PLAN INFORMATION

PROJECT NO. KDC-20000

FILENAME KDC20000-ASR-OAS1

CHECKED BY LJV

 DRAWN BY
 JTB


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 1"=50'

 DATE
 08.05.2024

SHEET

OVERALL UTILITY PLAN

C4.00

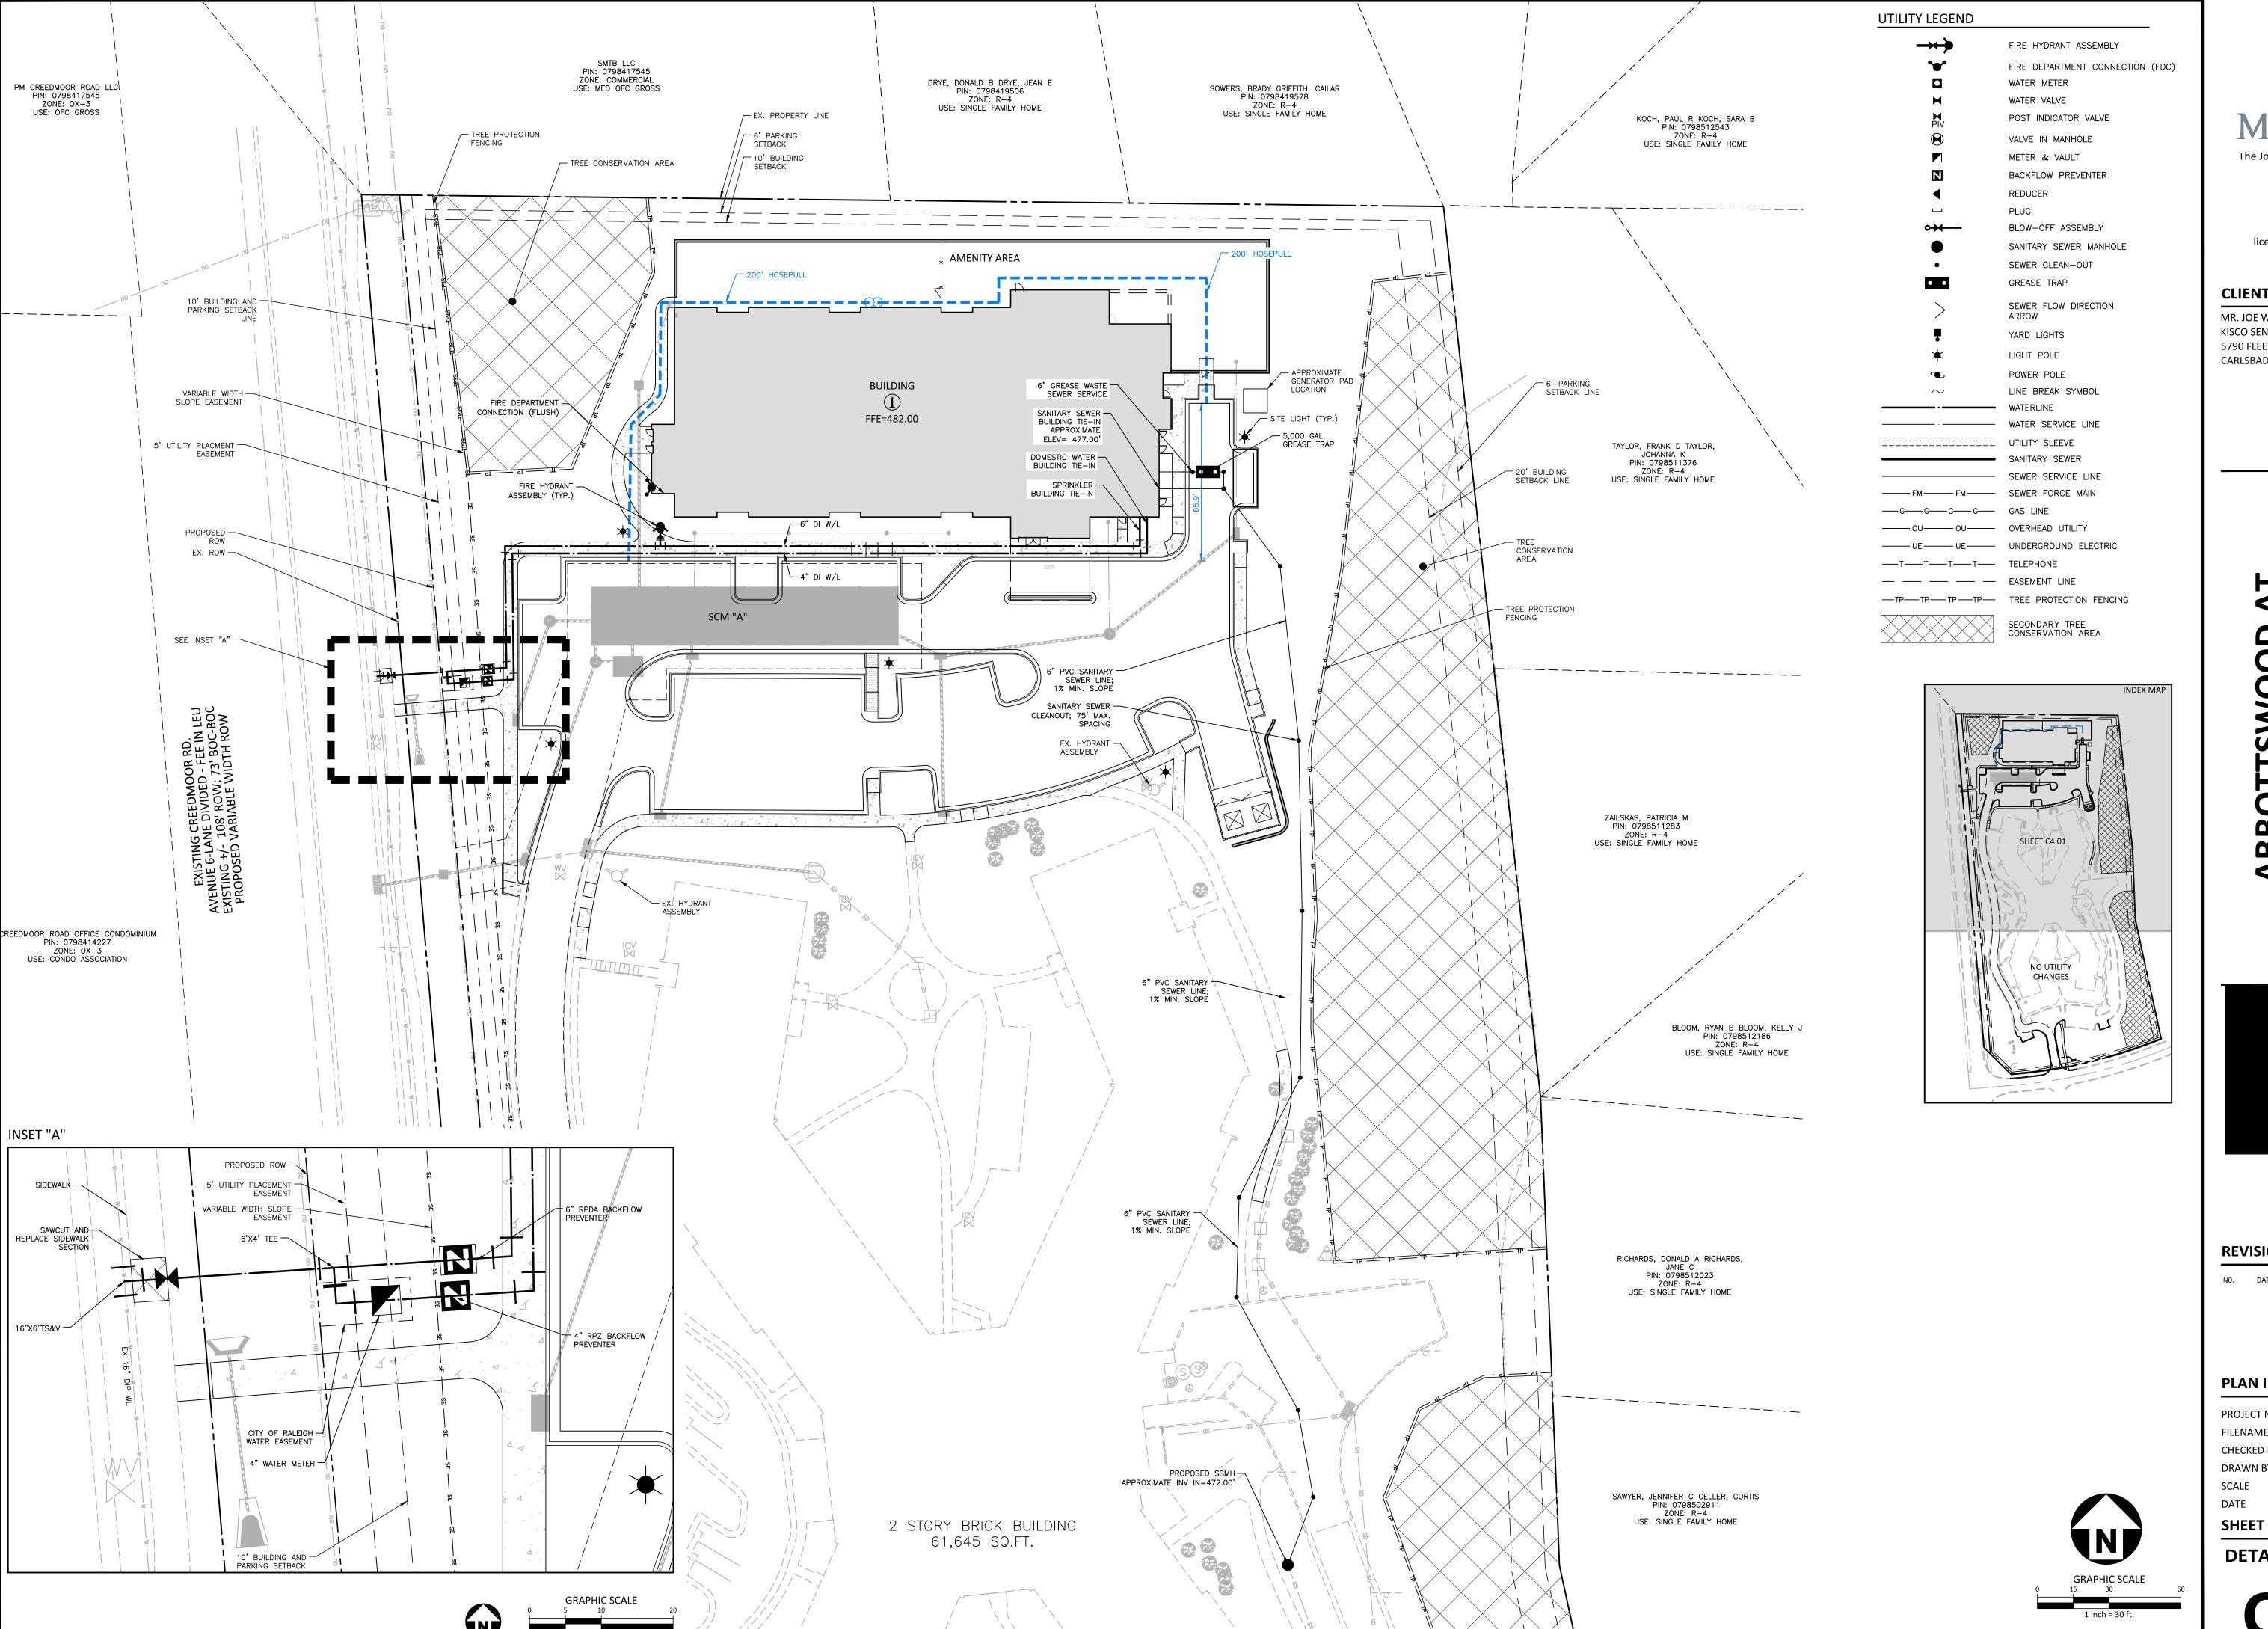




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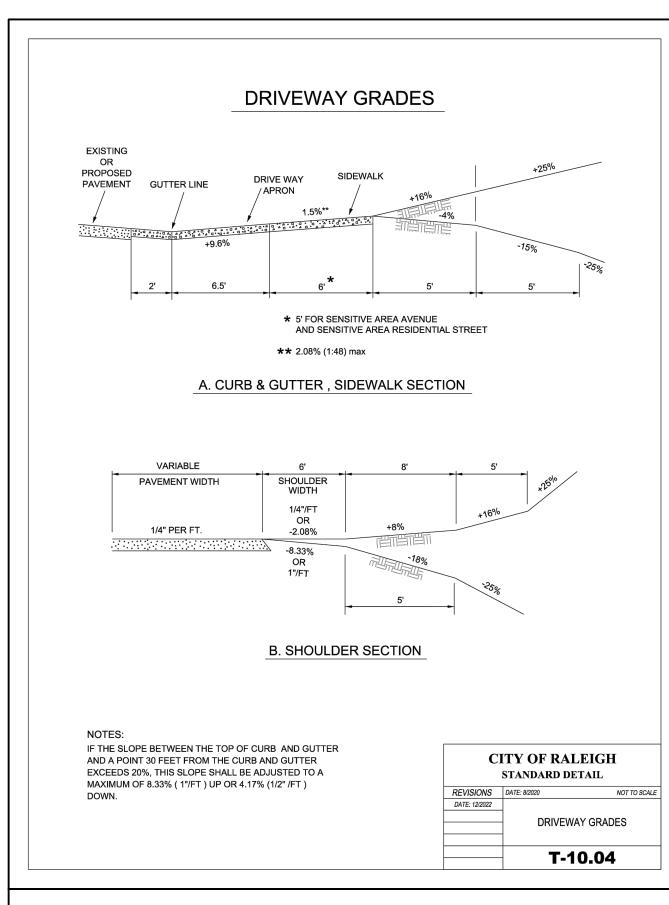
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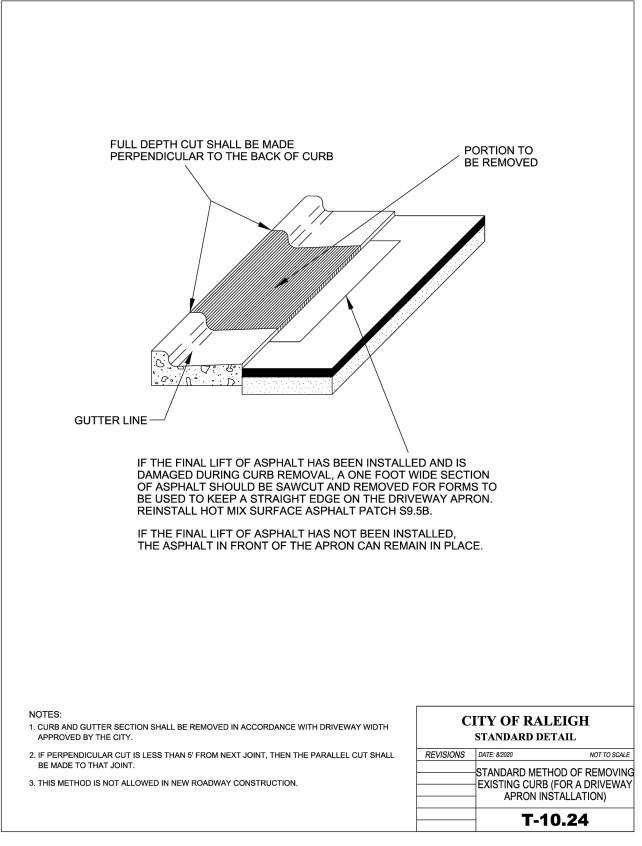
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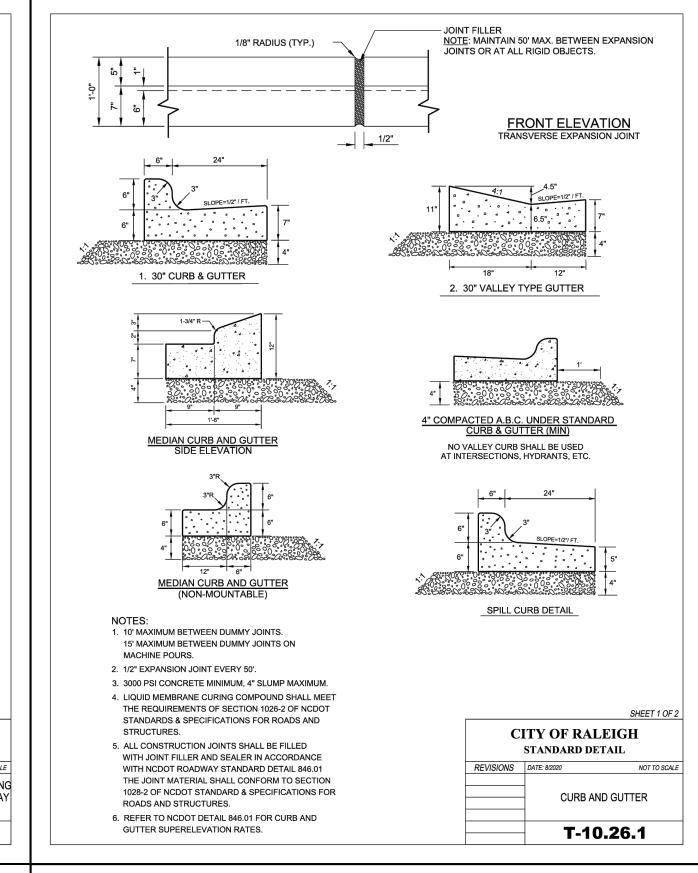
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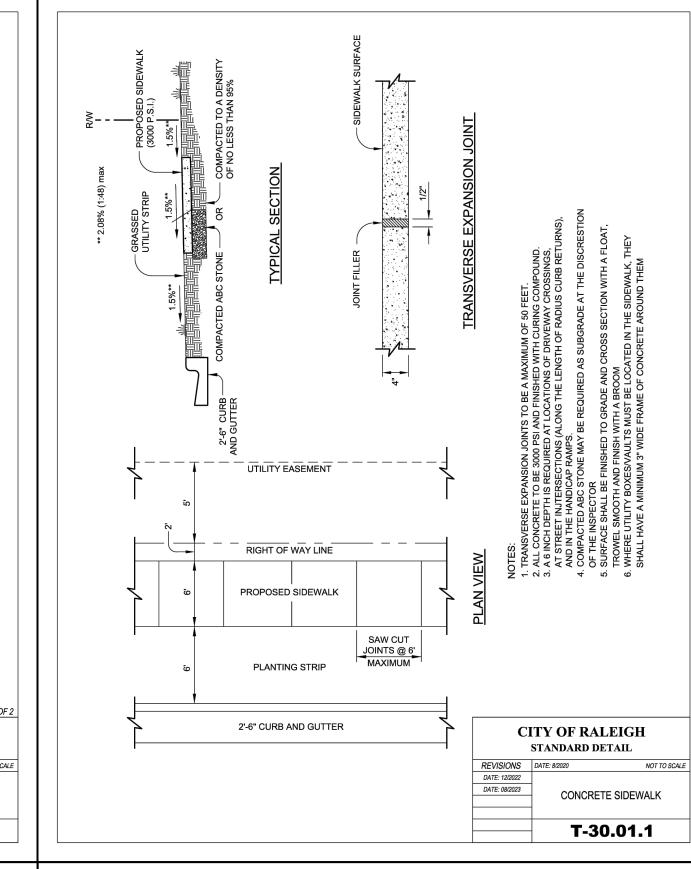
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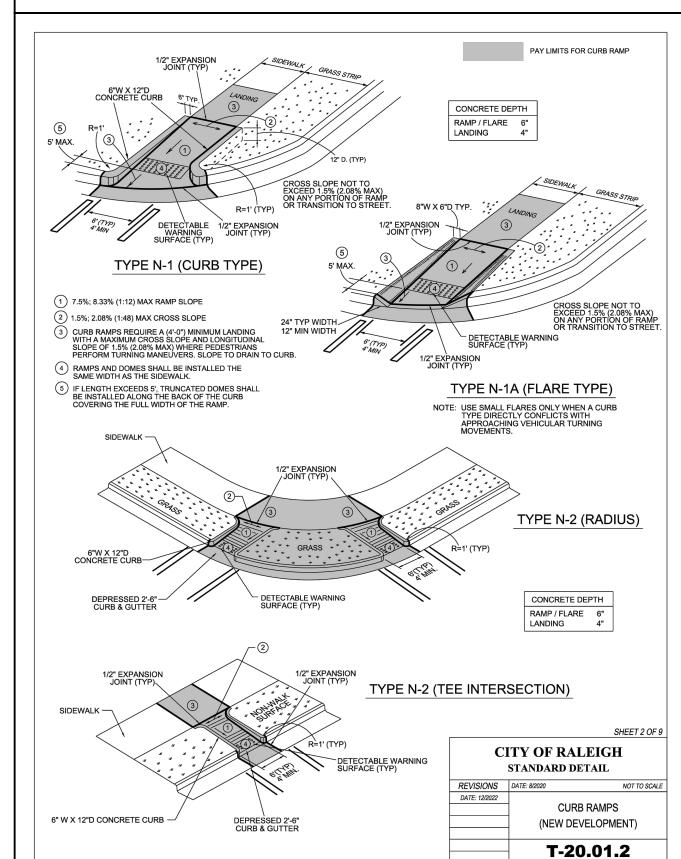
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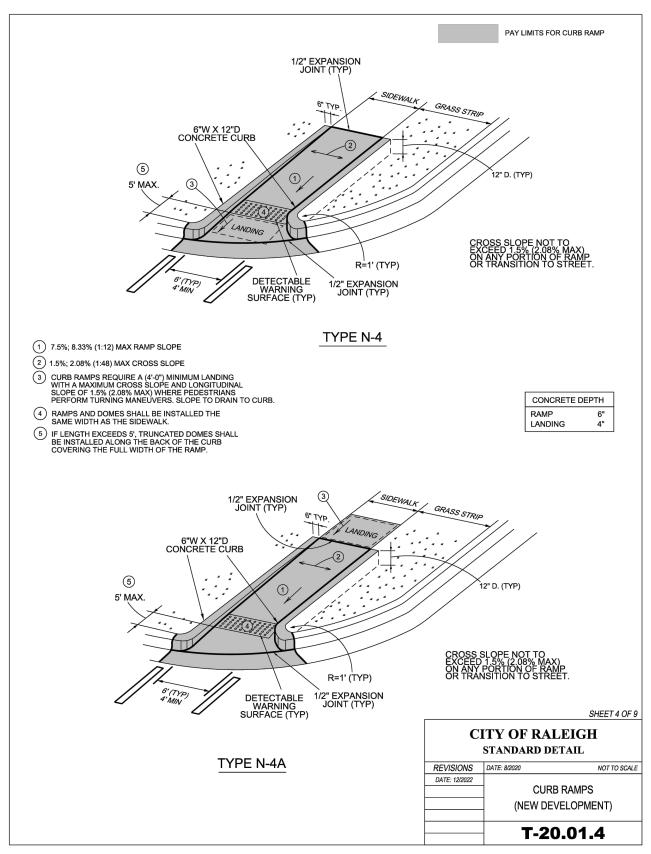












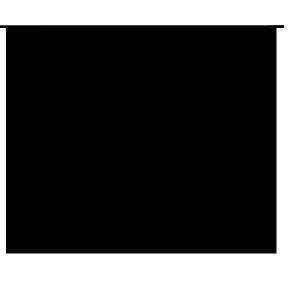

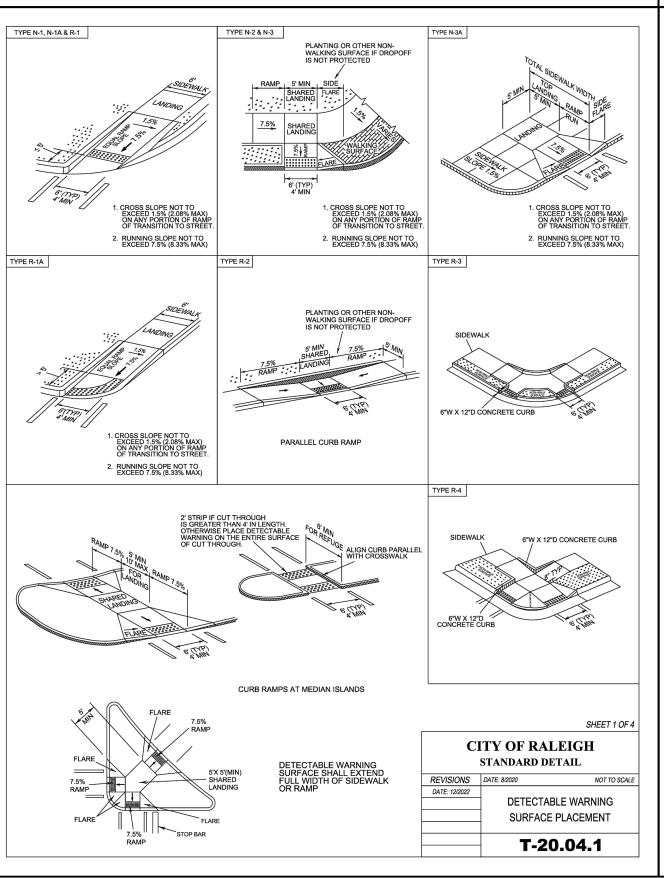

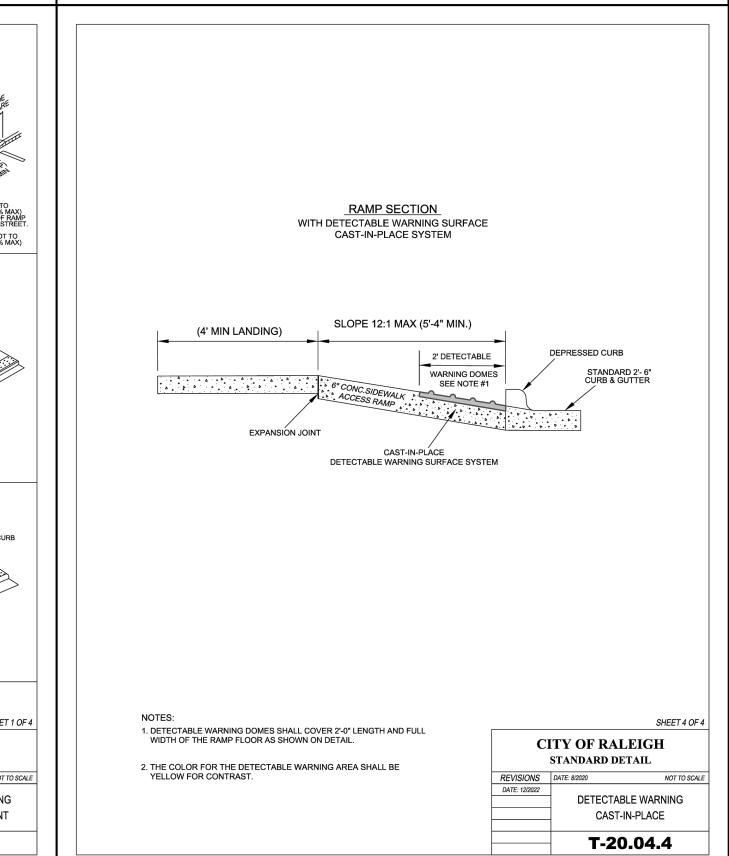



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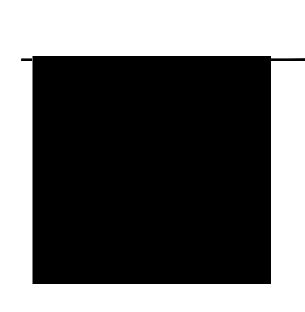
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ABBOILSWOOD AI
STONEHENGE
DMINISTRATIVE SITE REVIEW
7900 CREEDMOOR ROAD



REVISIONS

NO. DATE

PLAN INFORMATION

PROJECT NO. KDC-20000

FILENAME KDC20000-ASR-DI.DWG


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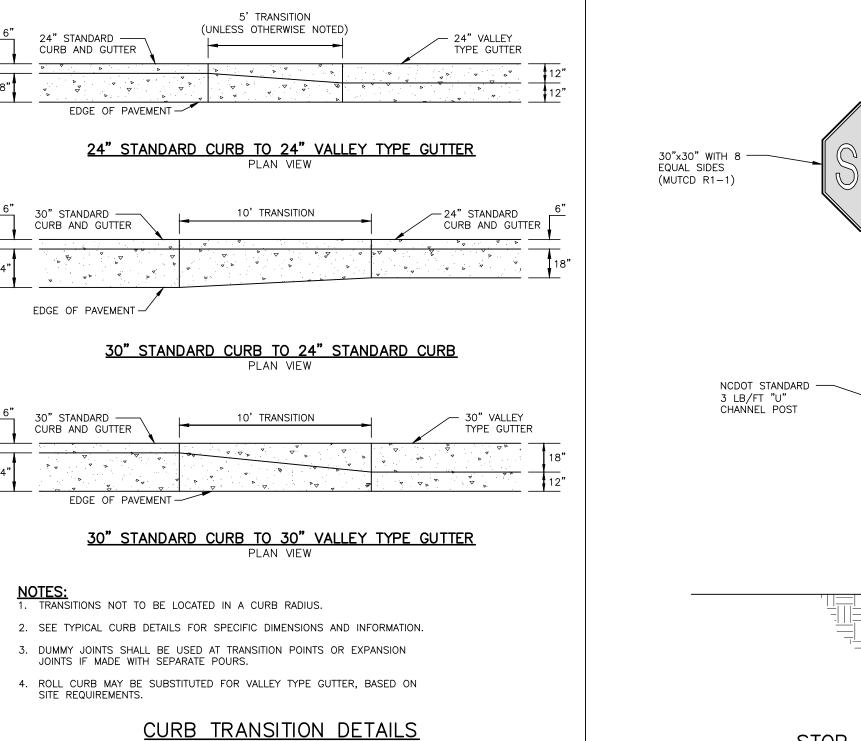
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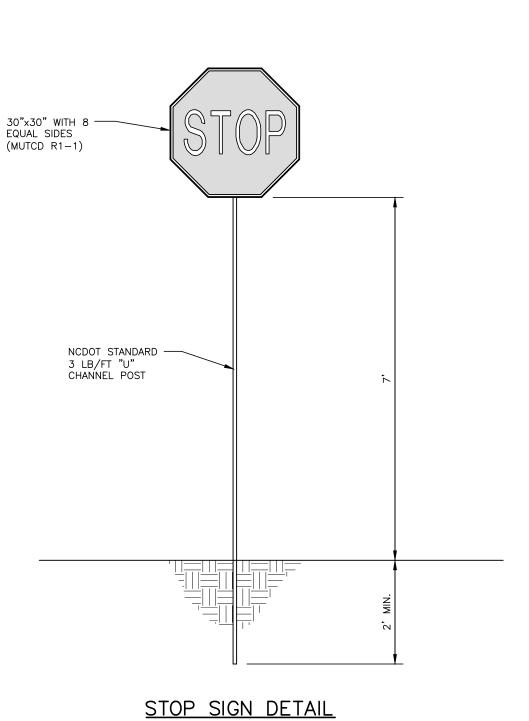
SCALE
NTS
DATE
08.05.2024

SHEET

SITE DETAILS





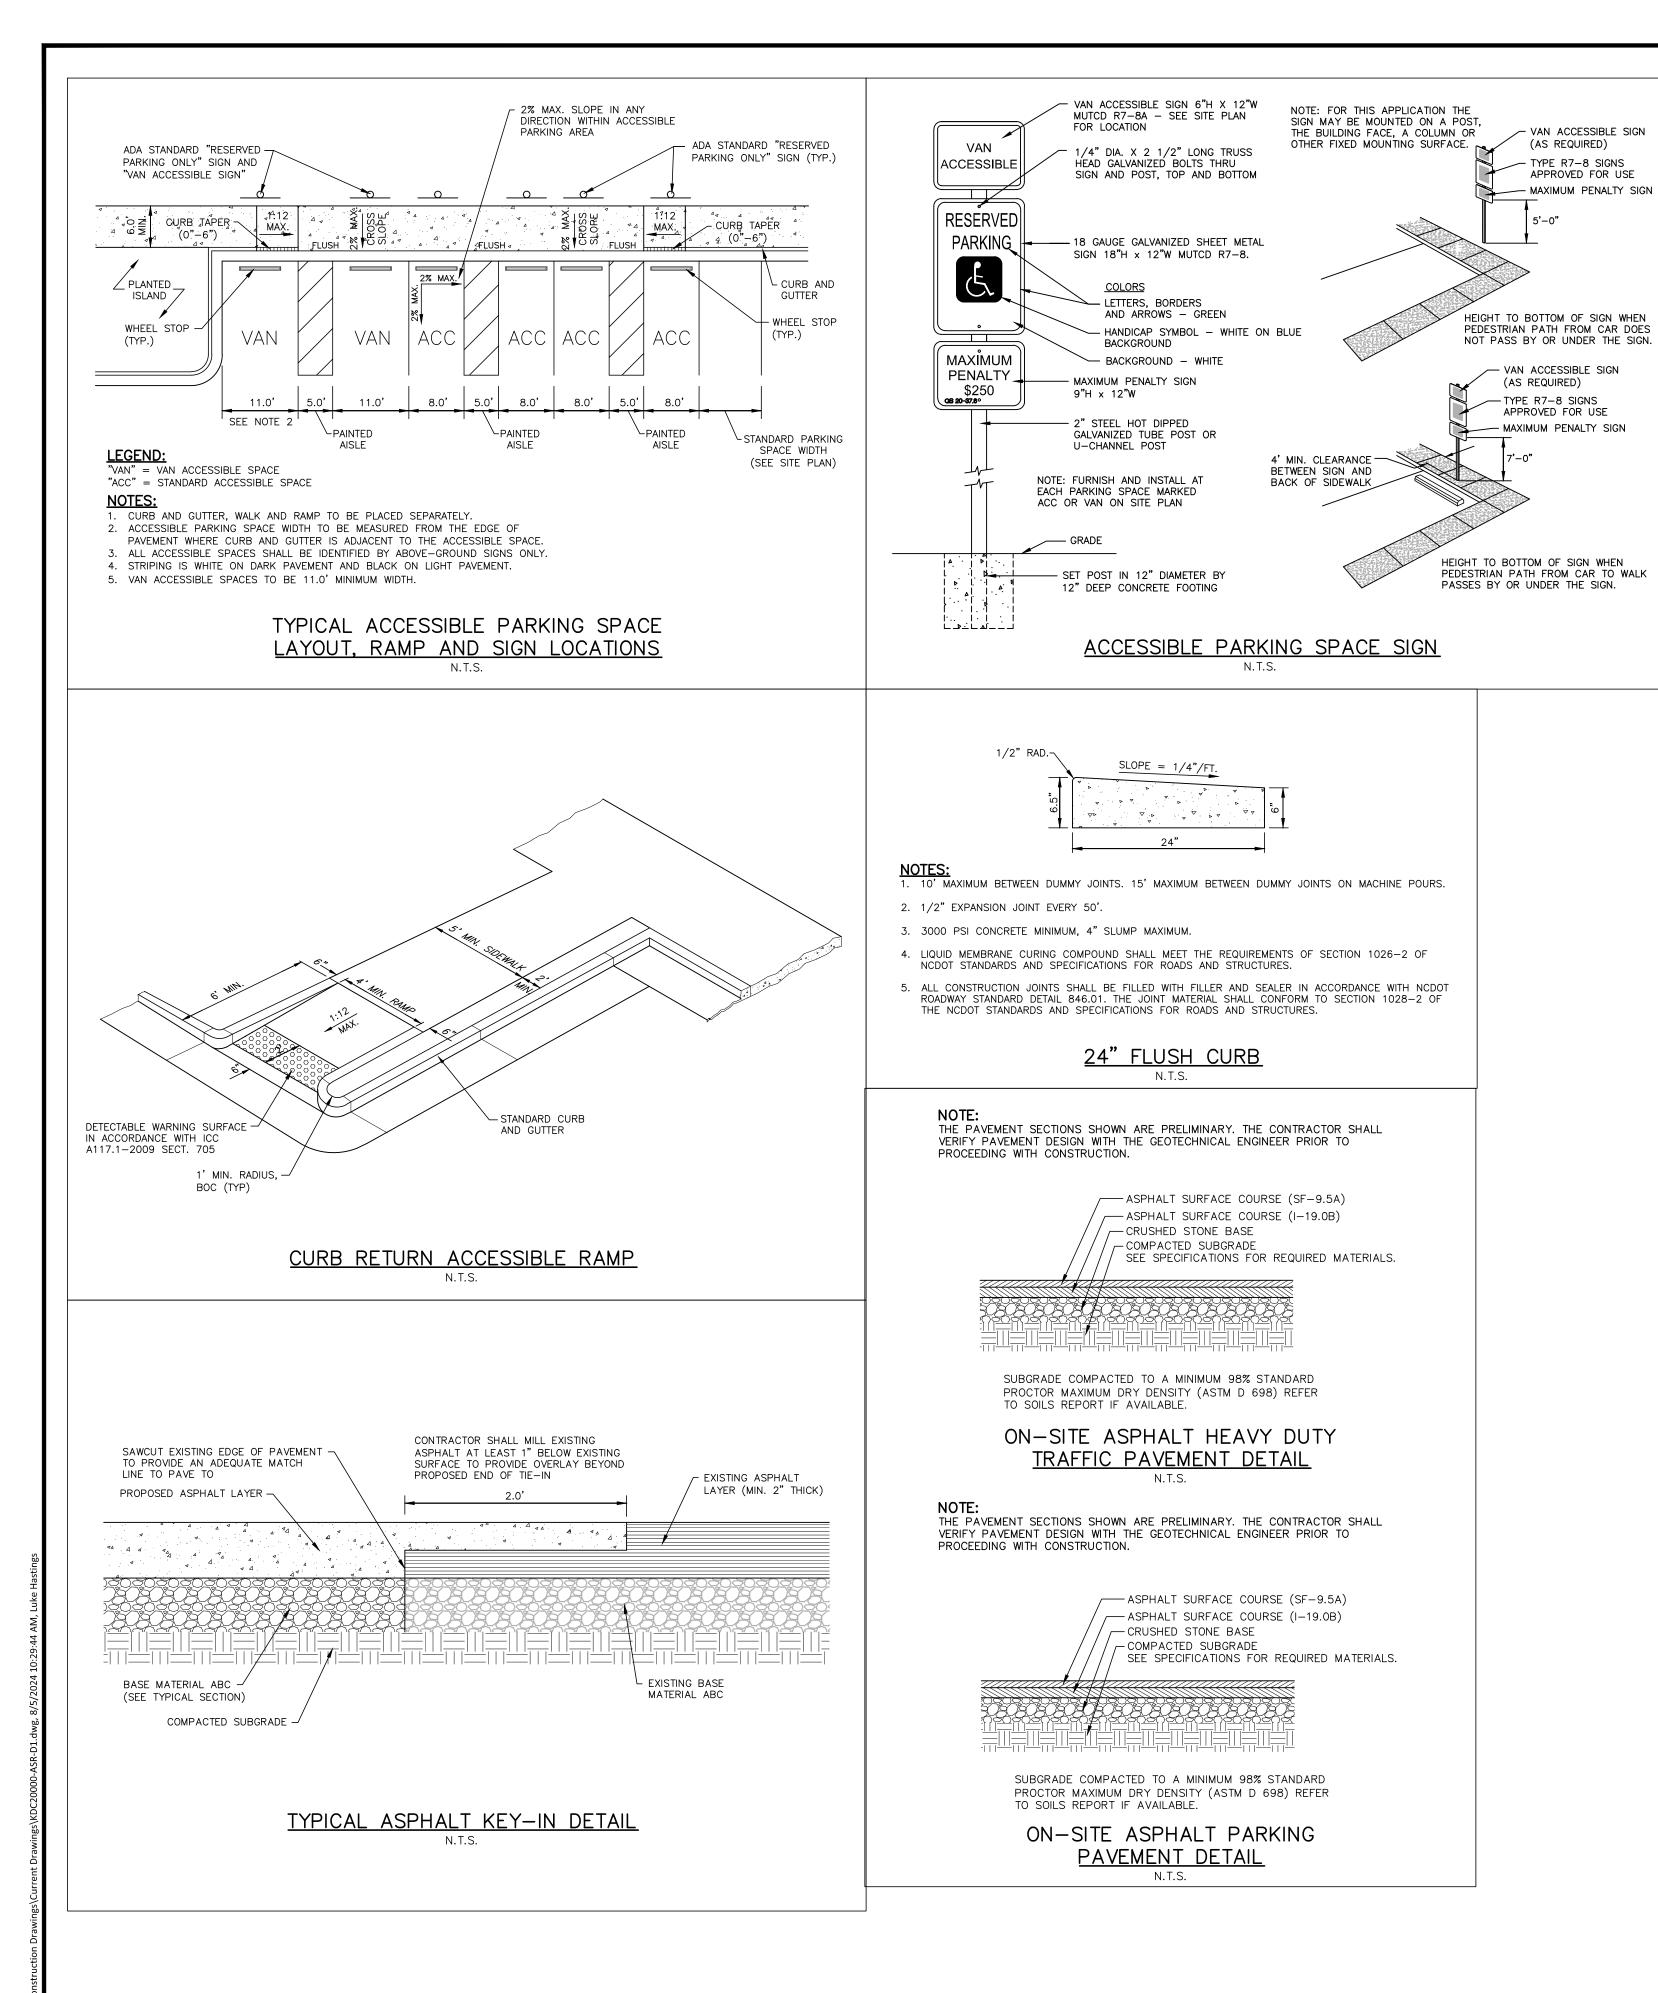



McAdam

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ABBOI ISWOOD AI STONEHENGE DMINISTRATIVE SITE REVIEW 7900 CREEDMOOR ROAD RALEIGH, NORTH CAROLINA, 27613



REVISIONS

NO. DATE

SHEET

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PROJECT NO. KDC-20000


FILENAME KDC20000-ASR-D1.DWG

CHECKED BY LJV

DRAWN BY LJV

DRAWN BY LJV
SCALE NTS
DATE 08.05.2024

SITE DETAILS

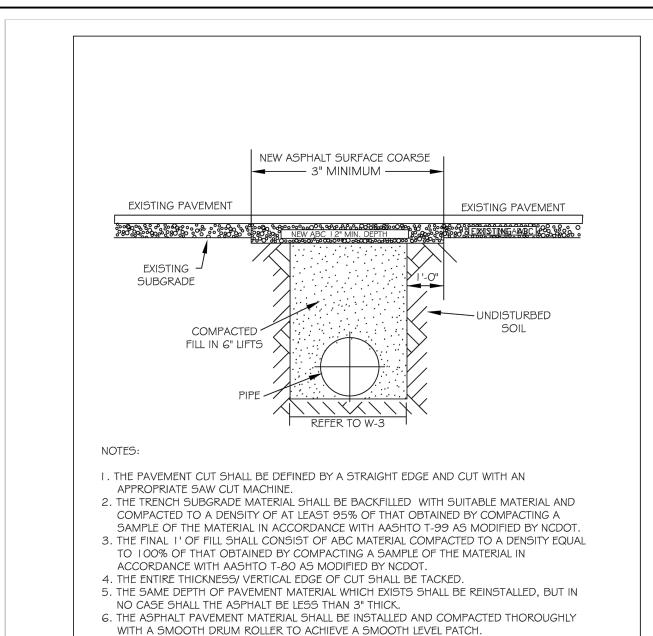

7. REFER TO CITY OF RALEIGH STANDARDS FOR TRENCHES AND PIPE BEDDING, W-3. FOR

9. PAVEMENT CUTS WITHIN NCDOT ROW SHALL CONFORM TO THE APPROVED ON SITE

CITY OF RALEIGH
DEPARTMENT OF PUBLIC UTILITIES


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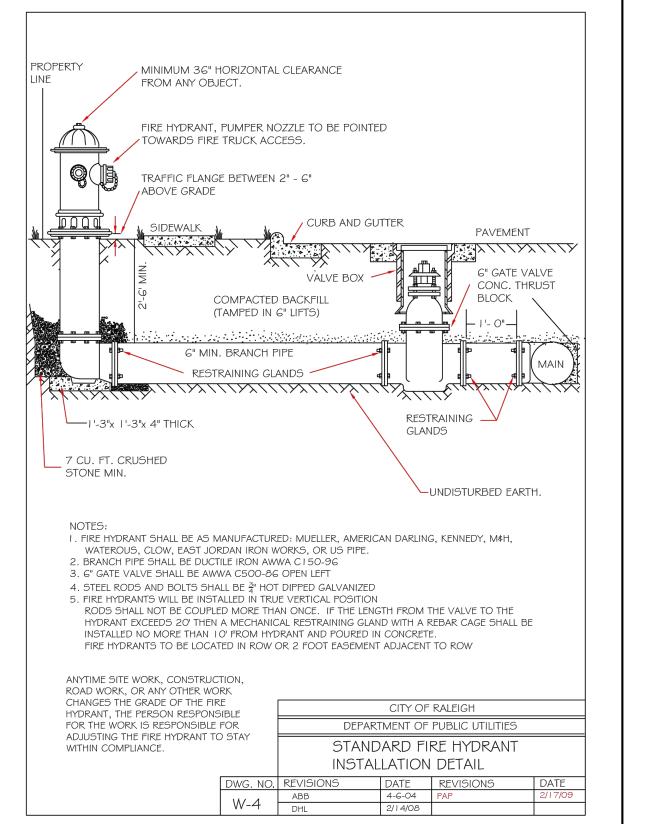
PAVEMENT PATCH DETAIL


ADDITIONAL DETAILS.


ENCROACHMENT PERMIT.


8. NO HAND PATCHING ALLOWED.




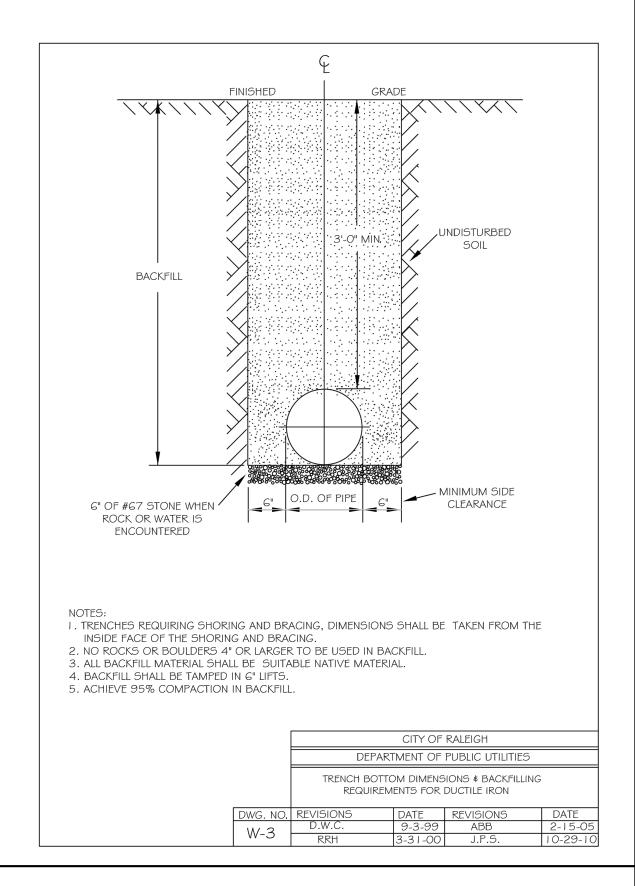


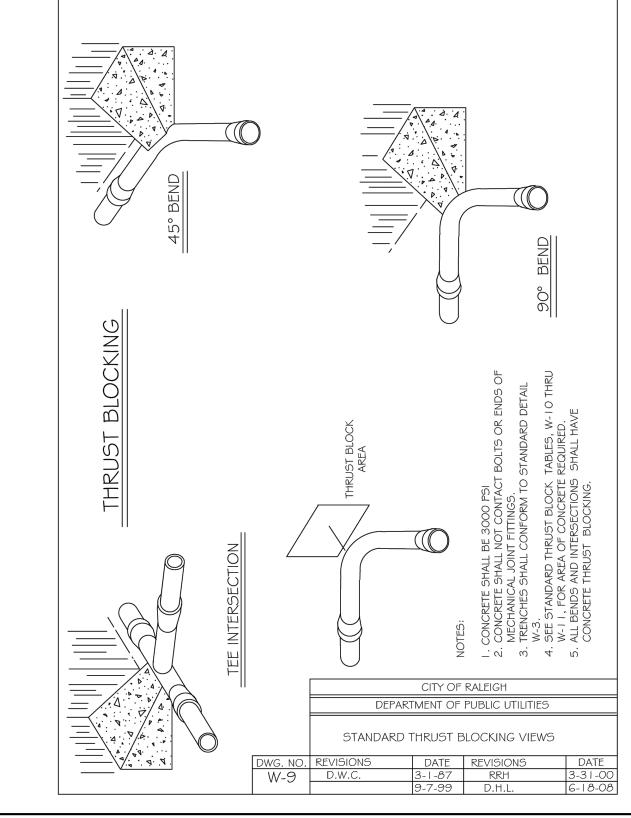

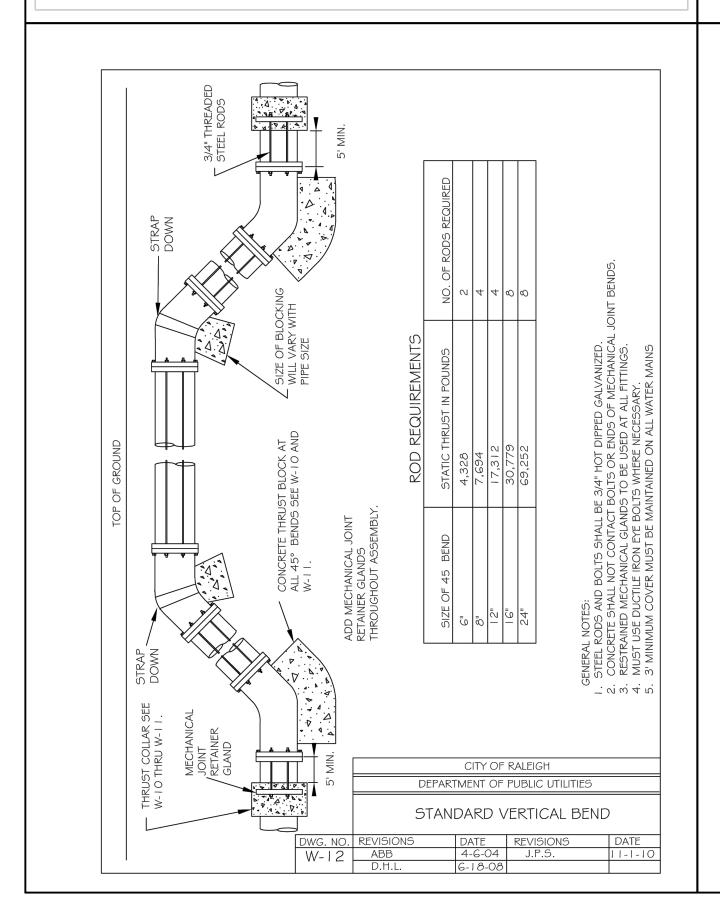

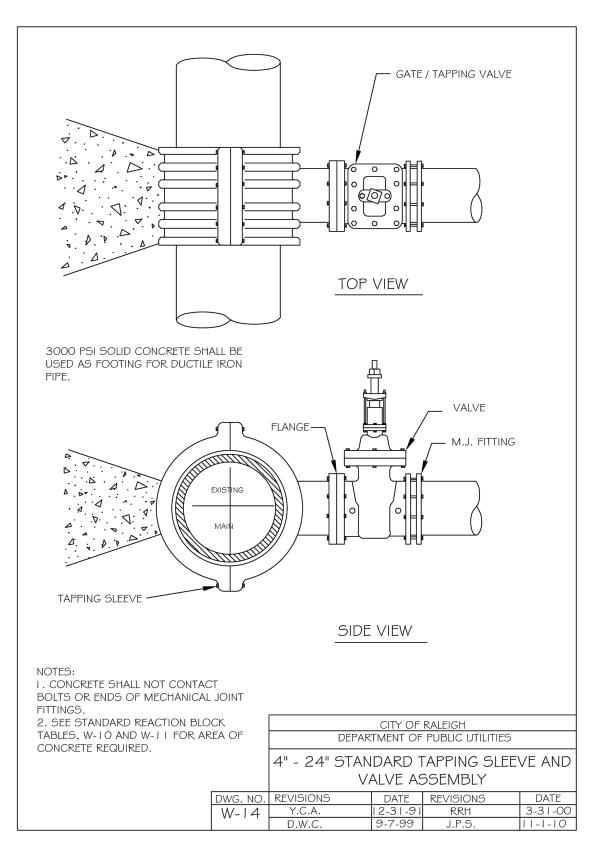

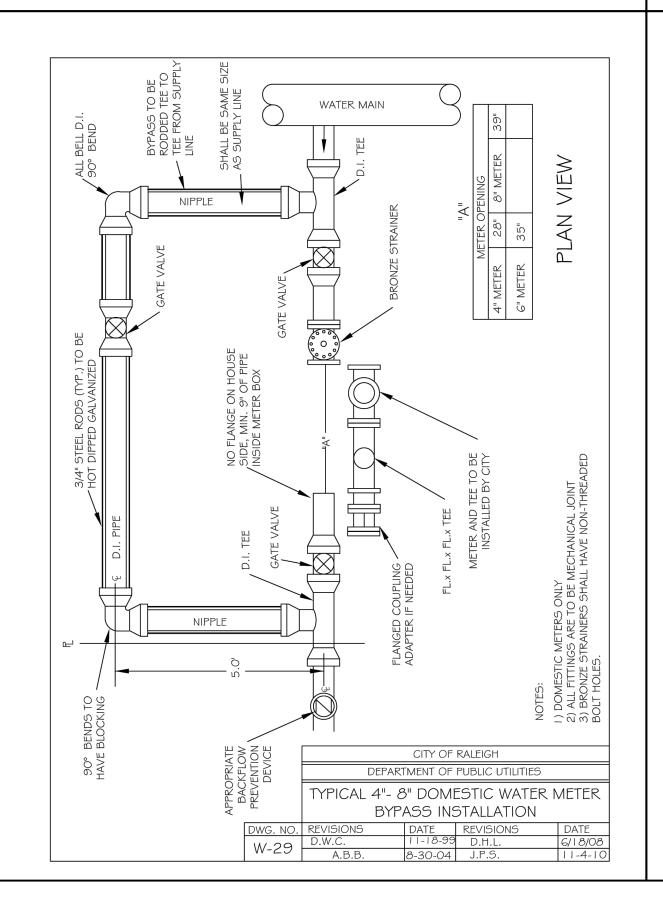

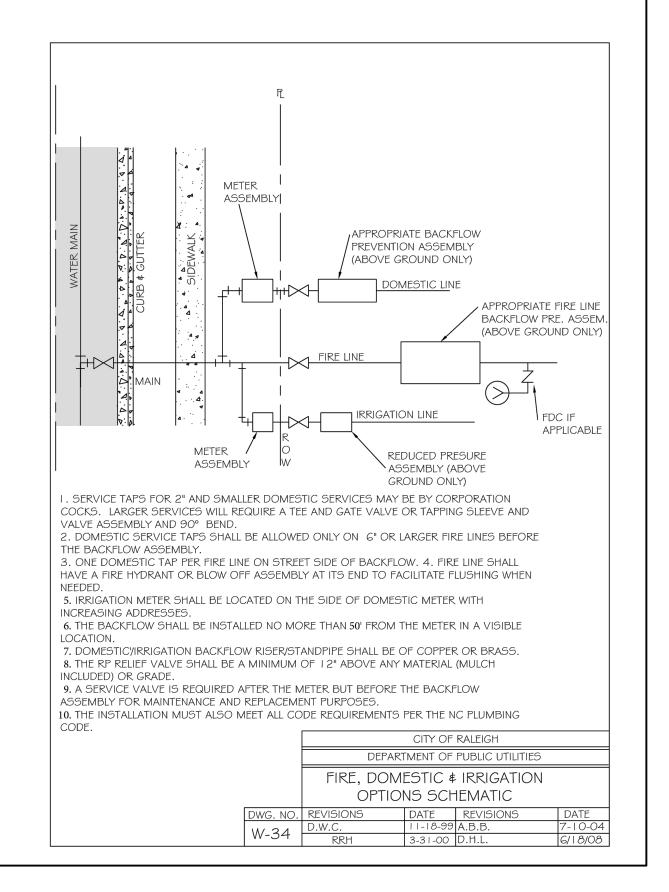



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ABBOTTSWOOD AT STONEHENGE MINISTRATIVE SITE REVIEV 7900 CREEDMOOR ROAD



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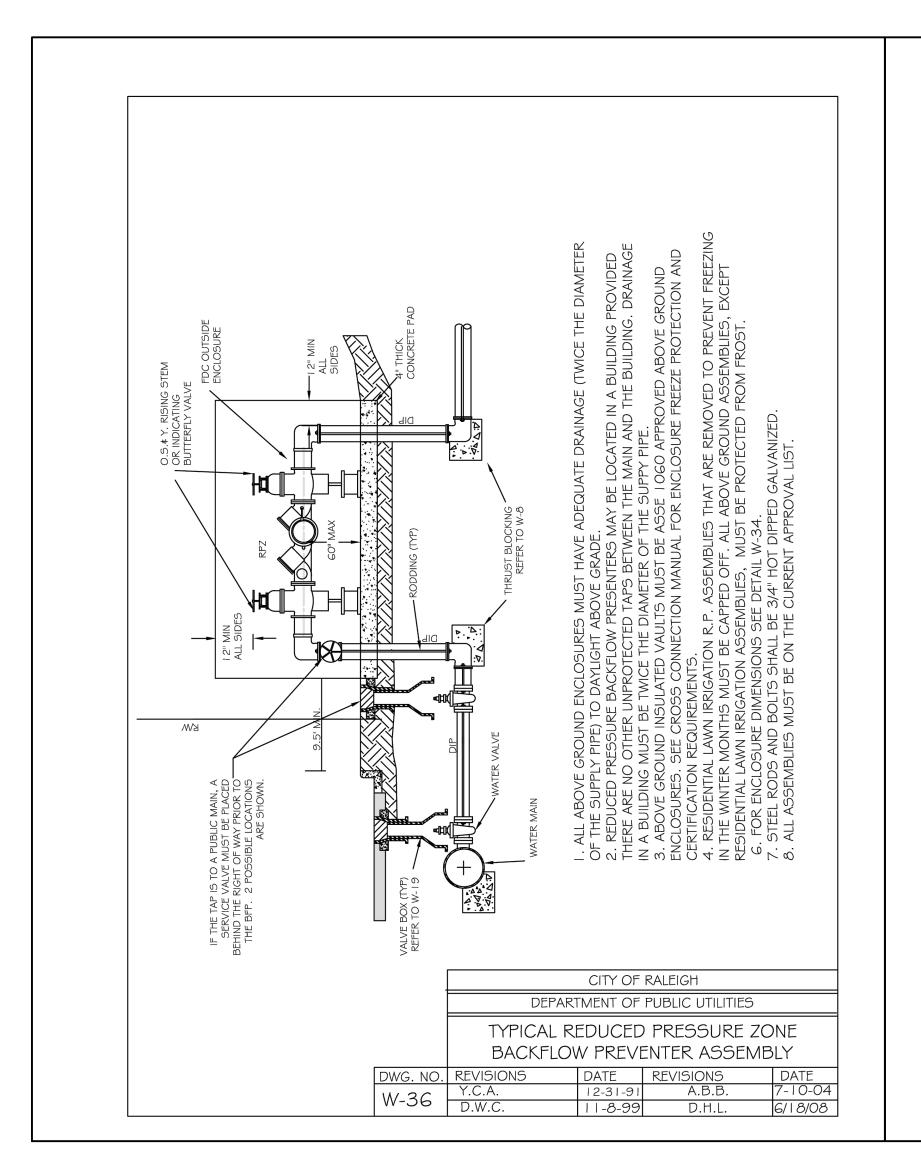
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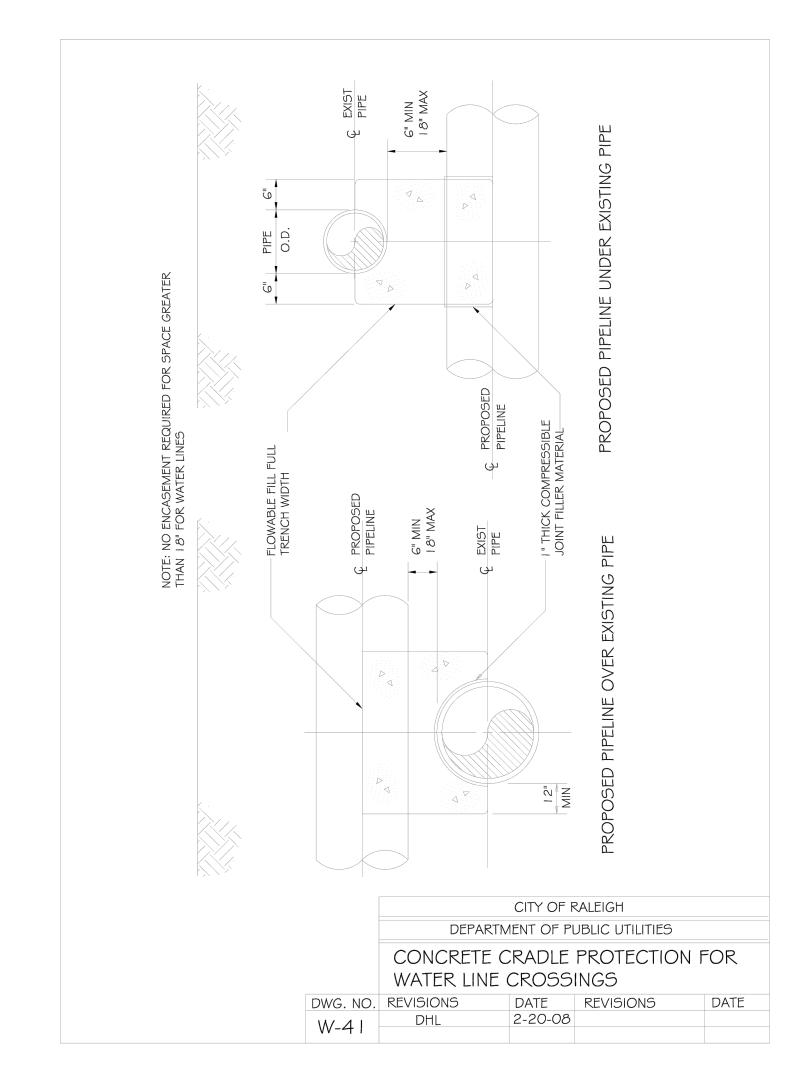
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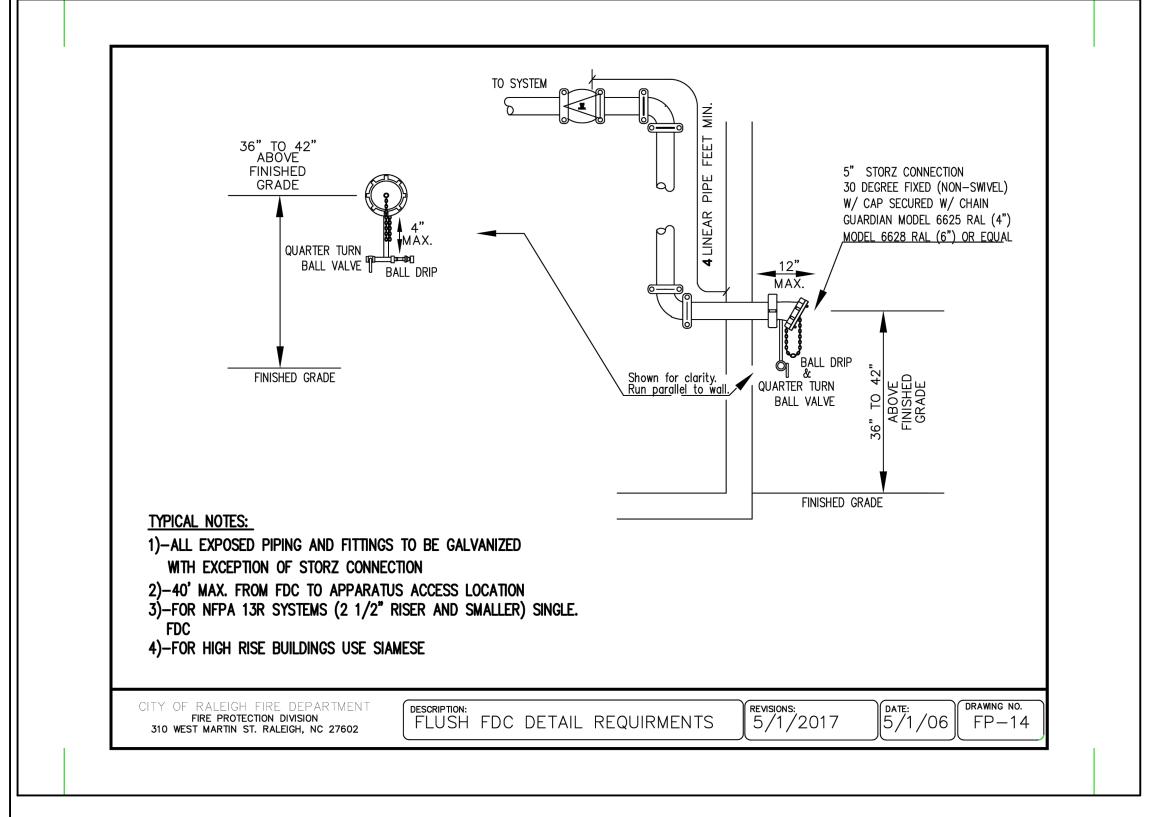
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SCALE NTS
DATE 08.05.2024
SHEET

WATER DETAILS









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Durham, NC 27713 phone 919. 361. 5000


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ABBOI ISWOOD AI STONEHENGE ADMINISTRATIVE SITE REVIEW 7900 CREEDMOOR ROAD



REVISIONS

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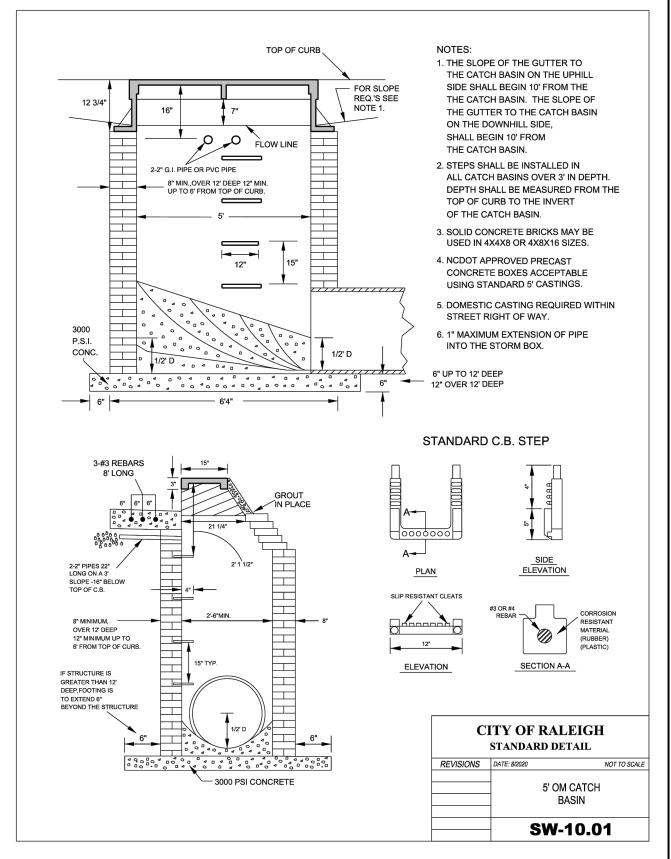
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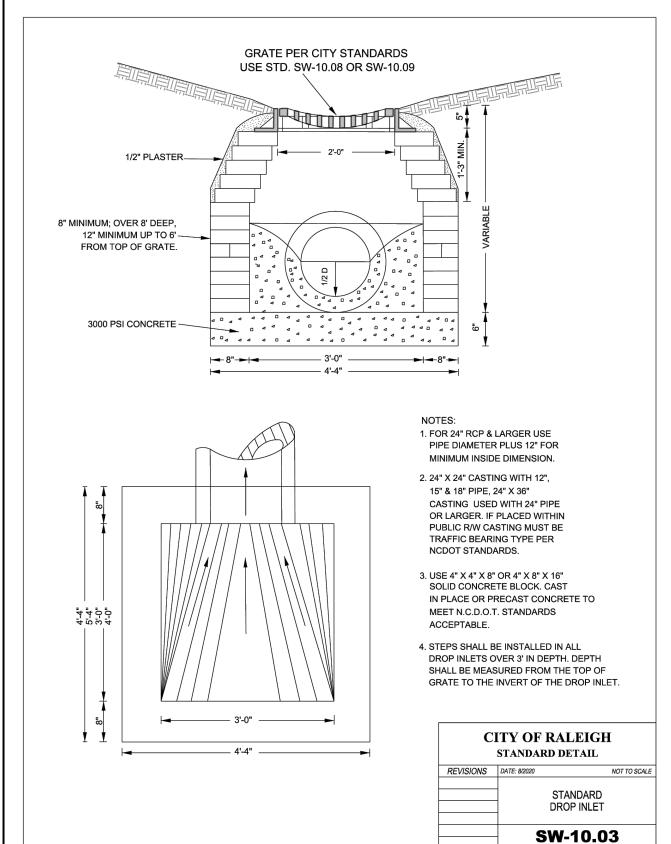
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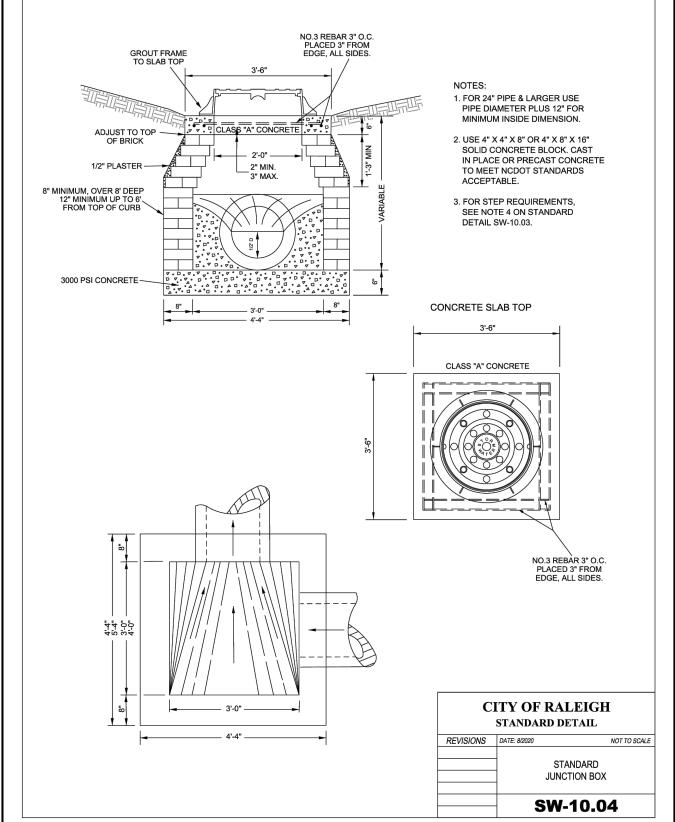
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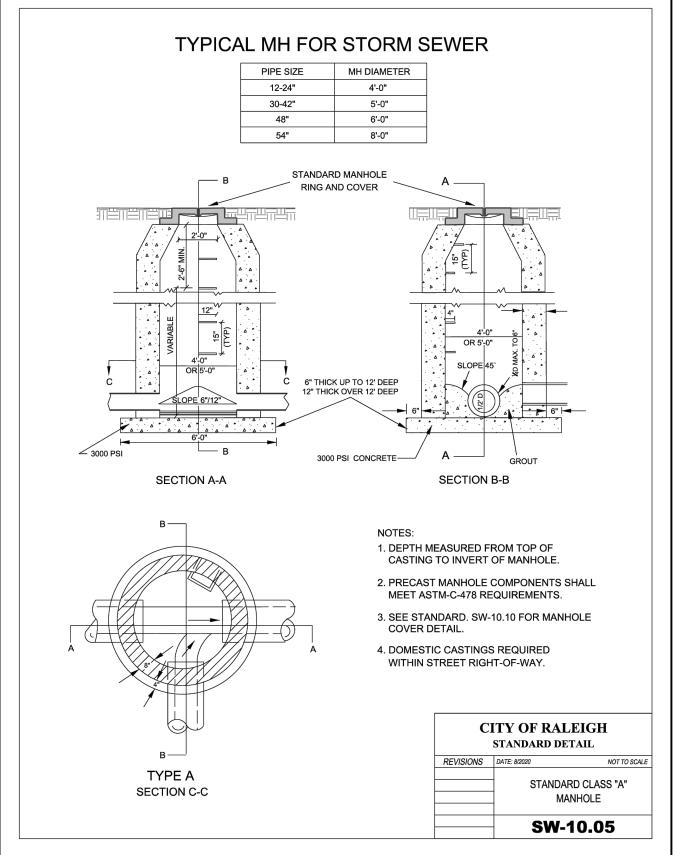
WATER DETAILS


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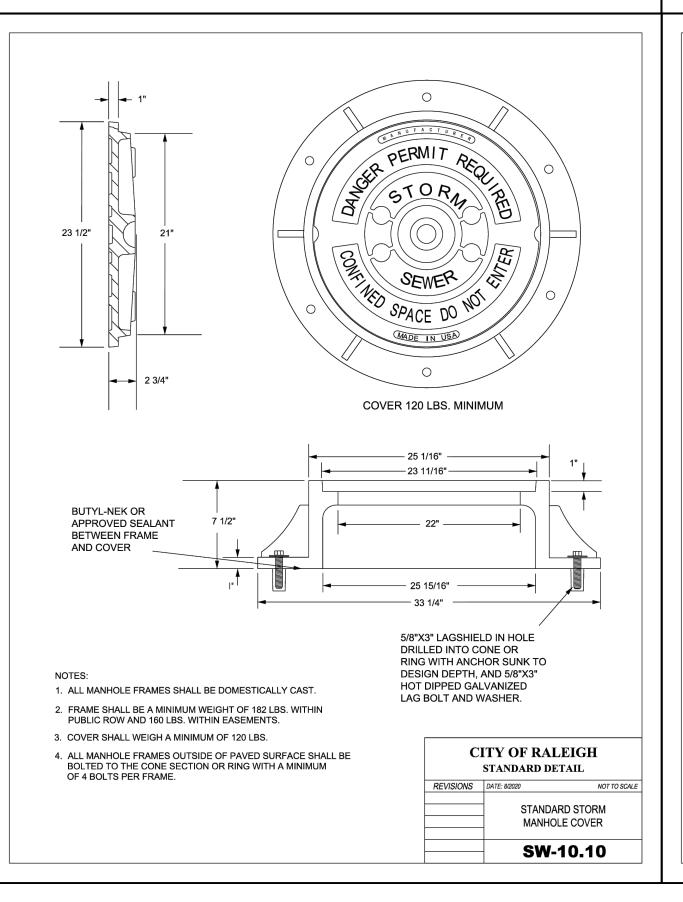


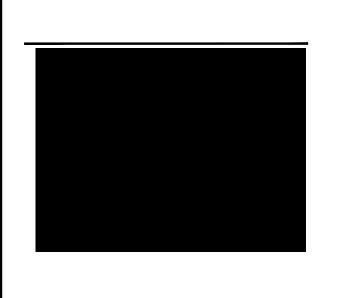








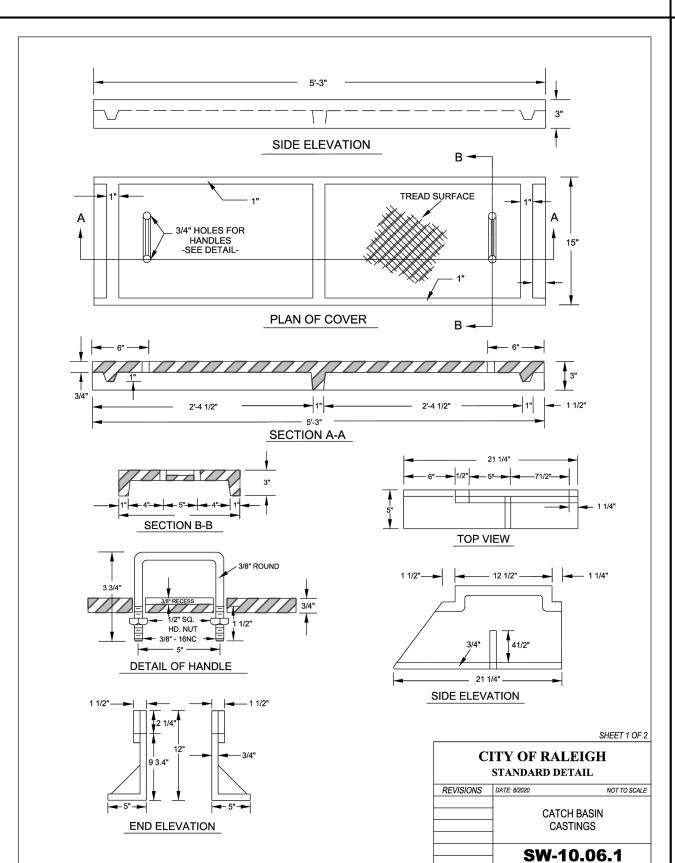

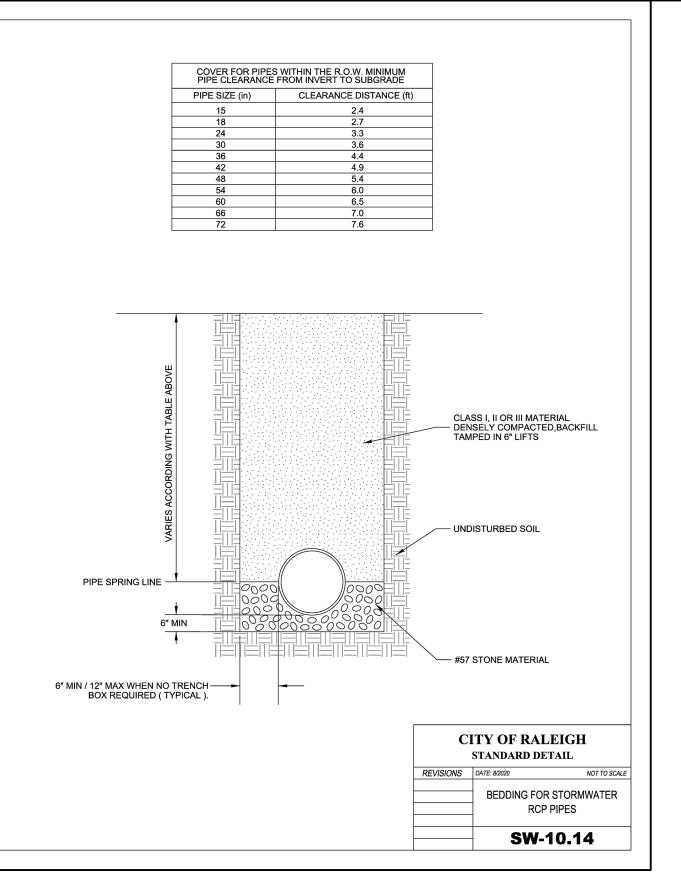



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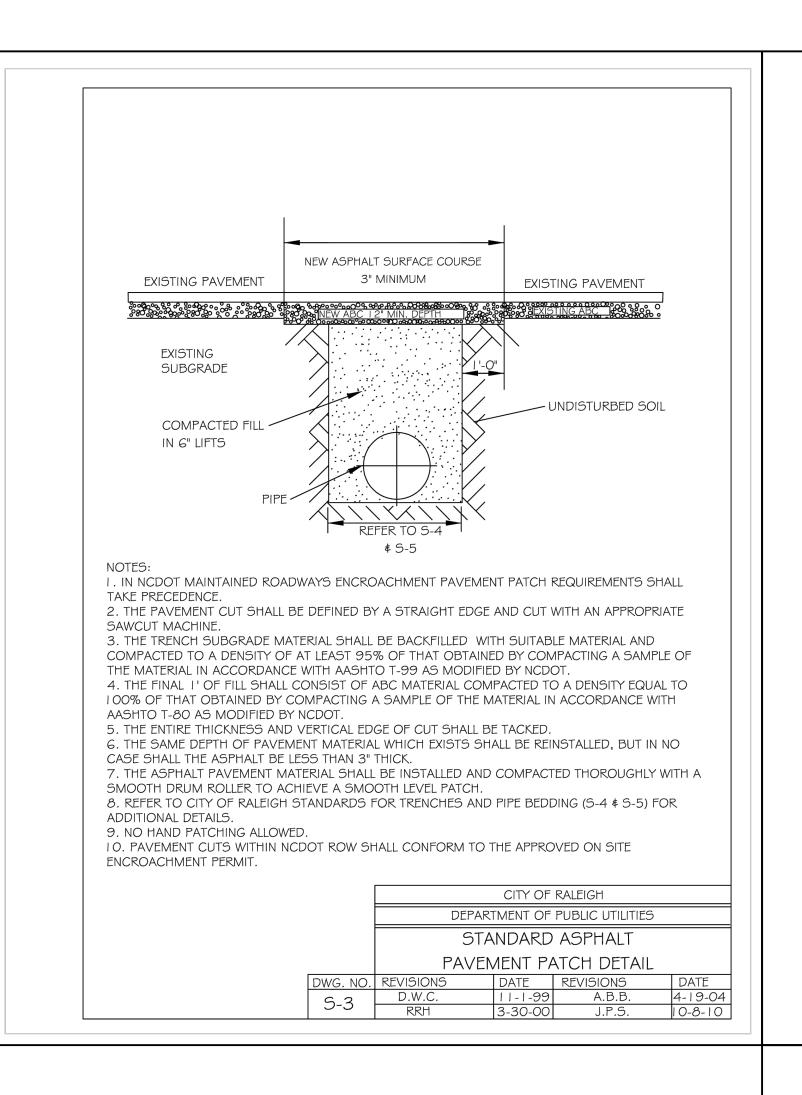
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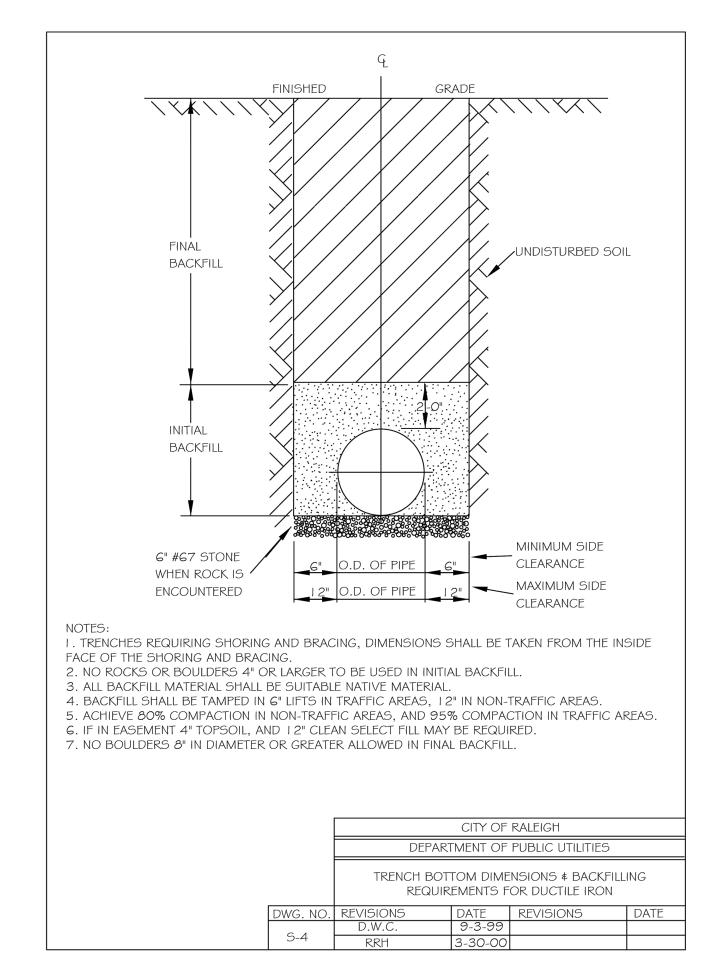
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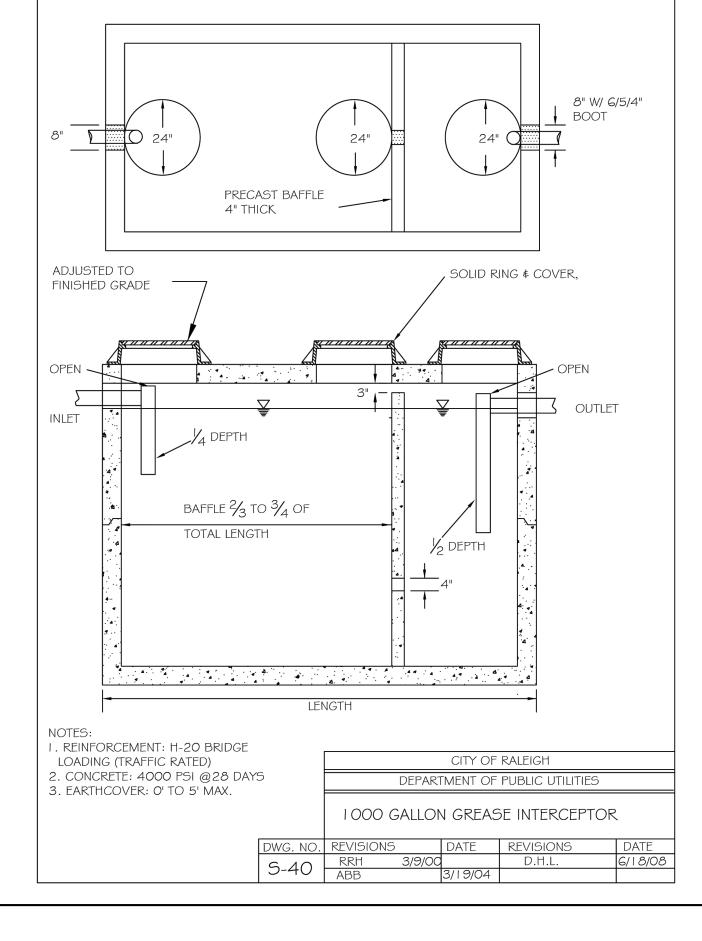
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DATE 08.05.2024


SHEET

STORM DRAINAGE
DETAILS







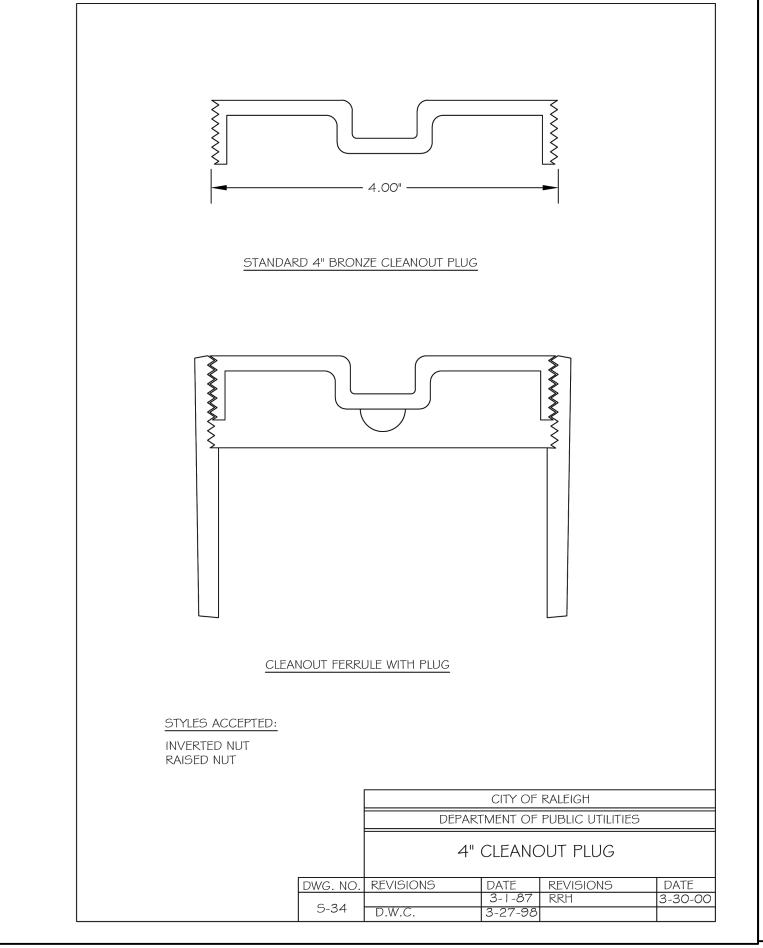

	LOCALLY AV	AILABLE SIZES		
	INTERCEPTORS	SEPARATORS	-	
	CAPACITY (GAL.)	CAPACITY (GAL.)		
	300	1000		
	550	1200		
	750	1600	_	
	1000			
	1500			
	2000		1	
	2500		7	
	3000			
	4000			
	5000		\bot	
	6000		4	
	8000		4	
SEPARATOR AS SHOW 2. EACH INTERCEPTOR IN SHALL EXTEND 50% IN LIQUID DEPTH. INLET A SAMPLE. 3. ACESS OPENINGS O BE 24 INCHES IN DIAN	TED AT A DISTANCE APPROXIMA WN ON DETAIL S-40.01. OR SEPARATOR SHALL HAVE IN NTO THE LIQUID DEPTH. THE INLAND OUTLET TEES MUST BE OP OVER EACH COMPARTMENT WITH METER AND CONTAIN PICK HOLD UIVALENT TRAFFIC BEARING MARCH	ET TEE SHALL EXTEND 25% EN TO ALLOW THE COLLECT HIN THE INTERCEPTOR OR S ES. ALL COVERS SHALL BE	OUTLET TEE INTO THE ION OF F.O.G. EPARATOR SHALL CONSTRUCTED	
SEPARATOR AS SHOW 2. EACH INTERCEPTOR SHALL EXTEND 50% IN LIQUID DEPTH. INLET A SAMPLE. 3. ACESS OPENINGS O BE 24 INCHES IN DIAN OF CAST IRON OR EQ TO FINISH GRADE AND INTERCEPTOR OR SEP 4. FULL SIZE DUAL SWE OF THE INTERCEPTOR 5. INTERCEPTORS AND PLUMBING CODE. 6. CONCRETE: 4000 PS 7. DESIGN: ACI 318 BL ASTM C1613-00	WN ON DETAIL 9-40.01. OR SEPARATOR SHALL HAVE IN NTO THE LIQUID DEPTH. THE INI AND OUTLET TEES MUST BE OP OVER EACH COMPARTMENT WITH METER AND CONTAIN PICK HOLD BE INSTALLED TO EXCLUDE THE PARATOR. SEP CLEANOUTS SHALL BE INST. OR SEPARATOR. SEPARATORS MUST BE VENTEIN SI @ 28 DAYS. JILDING CODE 6 FOR GREASE INTERCEPTORS FOR WATER AND WASTEWATER	ILET AND OUTLET TEES. THE LET TEE SHALL EXTEND 25% EN TO ALLOW THE COLLECT HIN THE INTERCEPTOR OR S ES. ALL COVERS SHALL BE ATTERIAL. MANHOLE COVERS HE ENTRANCE OF STORMWA ALLED ON THE INLET AND CO D IN ACCORDANCE WITH THE	OUTLET TEE INTO THE ION OF F.O.G. EPARATOR SHALL CONSTRUCTED MUST EXTEND ITER INTO THE UTLET SIDES	
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CLIENT

MR. JOE WHITEHOUSE KISCO SENIOR LIVING 5790 FLEET STREET, SUITE 300 CARLSBAD, CALIFORNIA 92008

ABBOTTSWOOD AT STONEHENGE



REVISIONS

NO. DATE

PLAN INFORMATION

PROJECT NO. KDC-20000

FILENAME KDC20000-ASR-D1.DWG

CHECKED BY LJV

DRAWN BY LJV

DATE
SHEET

SCALE

SANITARY SEWER DETAILS

08.05.2024

GENERAL NOTES


- 1. PRIOR TO CONSTRUCTION, ANY DISCREPANCIES IN THE PLANS AND NOTES SHALL BE BROUGHT TO THE ENGINEER'S ATTENTION.
- PRIOR TO ANY CONSTRUCTION OR PLACEMENT OF ANY BACKFILL, THE ONSITE GEOTECHNICAL ENGINEER SHALL INSPECT THE EXCAVATION AREA FOR THE UNDERGROUND SCM WITHIN THIS AREA TO ASSESS WHETHER SUITABLE SOILS EXIST AT THE SUBGRADE LEVEL. IF THE CONTRACTOR CONSTRUCTS AND COVERS UP THE UNDERGROUND SCM PRIOR TO INSPECTION, THEN THIS AREA SHALL BE UNCOVERED AND TESTED (TO THE ENGINEER'S AND OWNER'S APPROVAL) AT THE CONTRACTOR'S EXPENSE.
- 3. THE FACILITY SHALL NOT BE USED AS A TEMPORARY EROSION CONTROL DEVICE (I.E. SEDIMENT TRAP OR SEDIMENT BASIN) DURING CONSTRUCTION.
- PRIOR TO PLACING STORMFILTER CARTRIDGES WITHIN THE UNDERGROUND SYSTEM, THE CONTRACTOR SHALL REQUEST AN ONSITE MEETING WITH THE DESIGN ENGINEER AND THE EROSION CONTROL INSPECTOR TO ENSURE THE UPSTREAM DRAINAGE AREA IS COMPLETELY STABILIZED (I.E. GOOD VEGETATIVE COVER). IF THE CONTRACTOR DECIDES TO PLACE THE STORMFILTER CARTRIDGES PRIOR TO APPROVAL FROM THE DESIGN ENGINEER AND THE EROSION CONTROL INSPECTOR, THEN THE CONTRACTOR SHALL EXCAVATE/REPLACE, AS NECESSARY, THE COMPONENTS NEEDED FOR THE SYSTEM TO FUNCTION PROPERLY AT HIS / HER EXPENSE SHOULD THE STORMFILTER CARTRIDGES NOT FUNCTION PROPERLY (I.E. WILL NOT DRAIN DUE TO SEDIMENT DEPOSITION) DUE TO AN UNSTABILIZED UPSTREAM DRAINAGE AREA.
- 5. ONCE CONSTRUCTED, THE STORMFILTER CARTRIDGES SHALL NOT RECEIVE STORMWATER RUNOFF UNTIL THE ENTIRE CONTRIBUTING DRAINAGE AREA
 TO THE UNDERGROUND SYSTEM HAS BEEN COMPLETELY STABILIZED AND SITE CONSTRUCTION IS COMPLETE.
- ALL COMPONENTS OF THE UNDERGROUND SCM SYSTEM (JOINT / RISER CONNECTIONS, ENDCAPS, ACCESS MANHOLES, ETC.) SHALL BE DESIGNED BY OTHERS. ANY VARIATIONS OR CHANGES MADE FROM THESE SPECIFICATIONS AND DRAWINGS DURING THE ORDERING AND/ OR INSTALLATION OF ALL COMPONENTS MUST BE APPROVED BY THE DESIGN ENGINEER. THE STRUCTURAL DESIGN OF THE UNDERGROUND SCM, ALONG WITH ITS ASSUMPTIONS, IS ALSO BY OTHERS. THE JOHN R. McADAMS COMPANY, INC. AND ITS EMPLOYEES ASSUME NO LIABILITY WITH RESPECT TO ANY ASPECT OF THE STRUCTURAL DESIGN FOR THE UNDERGROUND SCM SYSTEM.
- 7. ALL PIPE/RISER CONNECTIONS AND JOINTS ASSOCIATED WITH THE STORM FILTER SYSTEM AND UNDERGROUND DETENTION PIPE SHALL BE WATER TIGHT. THE MECHANISM FOR ACHIEVING THIS SHALL BE SUBMITTED TO THE DESIGN ENGINEER FOR REVIEW.
- 8. THE CONTRACTOR SHALL FURNISH, INSTALL, OPERATE, AND MAINTAIN ANY PUMPING EQUIPMENT, ETC. NEEDED FOR REMOVAL OF WATER FROM VARIOUS PARTS OF THE SAND FILTER SYSTEM SITE. IT IS ANTICIPATED THAT PUMPING WILL BE NECESSARY IN THE EXCAVATION AREAS. DURING PLACEMENT OF FILL WITHIN THIS AREA (OR OTHER AREAS AS NECESSARY), THE CONTRACTOR SHALL KEEP THE WATER LEVEL BELOW THE BOTTOM OF THE EXCAVATION. THE MANNER IN WHICH THE WATER IS REMOVED SHALL BE SUCH THAT THE EXCAVATION BOTTOM AND SIDE SLOPES ARE STABLE.
-). IT SHALL BE THE RESPONSIBILITY OF THE CONTRACTOR TO ADHERE TO ALL CURRENT OSHA REGULATIONS FOR CONFINED SPACE ENTRY AND PROVIDE SUCH DURING ENGINEER WALK-THROUGH/INSPECTION.
- LO. ALL PIPE PENETRATIONS THROUGH A CONCRETE OR CMP STRUCTURE (I.E. STORMFILTER CARTRIDGE / DETENTION SYSTEM, STORM DRAINAGE MANHOLES, ETC.) SHALL BE MADE WATERTIGHT USING NON-SHRINK CEMENTIOUS GROUT.
- ACCESS MANHOLES SHALL INCLUDE LADDERS OR MANHOLE STEPS. IF, AT ANY ACCESS POINT, MANHOLE STEPS WOULD RESULT IN A 3" OR GREATER OFFSET, A LADDER SHALL BE PROVIDED. AS SUCH, A LADDER SHALL BE REQUIRED AT ALL MANHOLE ACCESS POINTS TO THE STORMFILTER VAULT. ALL LADDERS SHALL INCLUDE AN EXTENDING AND RETRACTING SECTION THAT ALLOWS THE LADDER TO BE EXTENDED ABOVE THE ACCESS LID TO FACILITATE SAFE INGRESS AND EGRESS TO/FROM A STANDING POSITION.


FOUNDATION NOTES

- ONCE THE EXCAVATION IS COMPLETE AND PRIOR TO INSTALLATION OF THE UNDERGROUND SCM SYSTEM, THE ONSITE GEOTECHNICAL ENGINEER SHALL VERIFY THE BEARING CAPACITY OF THE UNDERLYING SOILS TO SERVE AS A FOUNDATION FOR THE UNDERGROUND SCM SYSTEM. IF THE ONSITE GEOTECHNICAL ENGINEER DEEMS THE FOUNDATION SOILS AS UNSUITABLE, THEN THE UNSUITABLE MATERIAL SHOULD BE REMOVED DOWN TO A SUITABLE DEPTH AND THEN BUILT BACK UP TO THE CORRECT ELEVATION WITH A COMPACTED BACKFILL MATERIAL THAT IS APPROVED BY THE ONSITE GEOTECHNICAL ENGINEER. THE APPROVED BACKFILL MATERIAL SHOULD HAVE A GRADATION THAT WILL NOT ALLOW THE MIGRATION OF FINES, WHICH COULD CAUSE SETTLEMENT OF THE UNDERGROUND SCM SYSTEM. IF NECESSARY, A GEOTEXTILE FABRIC CAN BE USED TO SEPARATE THE UNDERLYING SOILS AND THE BACKFILL MATERIAL. THIS GEOTEXTILE FABRIC (IF USED) IS TO BE SPECIFIED BY THE GEOTECHNICAL ENGINEER.
- 2. IF THE FOUNDATION SUBGRADE WILL BE EXPOSED FOR AN EXTENDED PERIOD DURING CONSTRUCTION, THEN IT SHOULD BE GRADED TO A SLIGHT SLOPE SUCH THAT SATURATION OF THE SUBGRADE DOES NOT OCCUR.
- 3. THE CONTRACTOR SHALL FURNISH, INSTALL, OPERATE, AND MAINTAIN ANY PUMPING EQUIPMENT, ETC. NEEDED FOR REMOVAL OF WATER FROM THE EXCAVATION. IT IS BEST TO BEGIN THE CONSTRUCTION OF THE SAND FILTER/DETENTION SYSTEMS AT THE DOWNSTREAM END WITH THE OUTLET ALREADY CONSTRUCTED TO ALLOW A ROUTE FOR WATER TO ESCAPE.
- 4. THE CONTRACTOR SHALL PROVIDE FOUNDATION DRAINS FOR THE UNDERGROUND SCM. THE FOUNDATION DRAIN SHALL CONSIST OF 8" DIAMETER PERFORATED PIPE WRAPPED IN NONWOVEN GEOTEXTILE FABRIC. THE FOUNDATION DRAINS SHALL BE PLACED ON ALL FOUR SIDES OF THE UNDERGROUND SCM AS SHOWN ON THE DRAWINGS AND WITHIN THE VAULT'S BEDDING SYSTEM (BUT NOT DIRECTLY BELOW THE VAULT). THE FOUNDATION DRAIN SYSTEM SHALL TIE TO THE NEAREST STORM SEWER INLET / JUNCTION BOX MAINTAINING A POSITIVE SLOPE TO THE DOWNSTREAM STRUCTURE. FOUNDATION DRAINS SHALL NOT TIE INTO THE UNDERGROUND VAULT AT ANY POINT.

BEDDING NOTES

- 1. THE EXCAVATION SUB GRADE MUST BE TRANSIT LEVEL.
- 2. THE EXCAVATION PIT SHALL BE LINED (ON THE BOTTOM AND ALL FOUR SIDES) WITH A NON-WOVEN GEO-TEXTILE (GEOTEX 401 OR APPROVED EQUIVALENT). THE ONSITE GEOTECHNICAL ENGINEER SHALL APPROVE FABRIC FOR USE.
- 3. THE SUBGRADE FOR THE DETENTION SYSTEM CAN BE A CONCRETE SLAB, OR CLEAN GRANULAR MATERIAL WITH A MAXIMUM AGGREGATE SIZE OF 3/4".
 THE BEDDING SHALL BE FREE FROM ROCK FORMATIONS, PROTRUDING STONES, FROZEN LUMPS, ROOTS, AND OTHER FOREIGN MATERIAL.
- 4. PREPARE THE SUBGRADE PER THE ONSITE GEOTECHNICAL ENGINEER'S DIRECTION (APPROXIMATELY 5-6" BELOW GRADE ON WHICH SLAB WILL SET). THE BEDDING MATERIAL SHOULD BE GRADED SUCH THAT A SMOOTH UNIFORM GRADE IS ESTABLISHED TO ALLOW FOR OPTIMUM PLACEMENT OF THE SAND
- 5. THE SUBGRADE MUST SUPPORT THE DETENTION SYSTEM WITHOUT DIFFERENTIAL SETTLEMENT BETWEEN PIECES.
- 6. IF CONSTRUCTION EQUIPMENT WILL BE OPERATING FOR AN EXTENDED PERIOD OF TIME ON THE BEDDING, THEN THE APPROPRIATE MEASURES (E.G. STIFF GEOGRID, ETC.) SHALL BE TAKEN TO ENSURE THE INTEGRITY OF THE BEDDING IS NOT COMPROMISED.

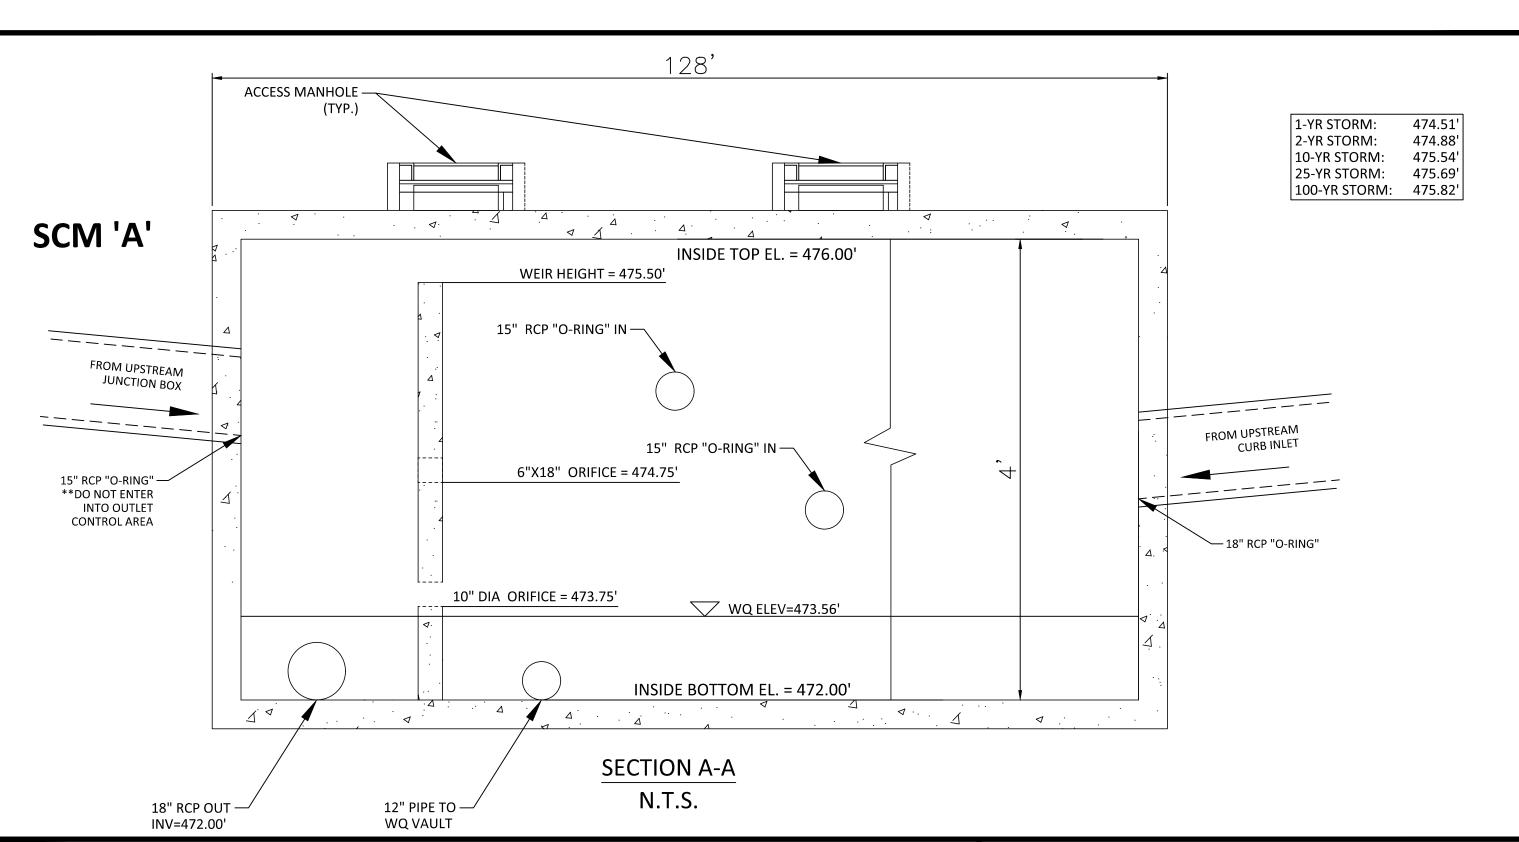

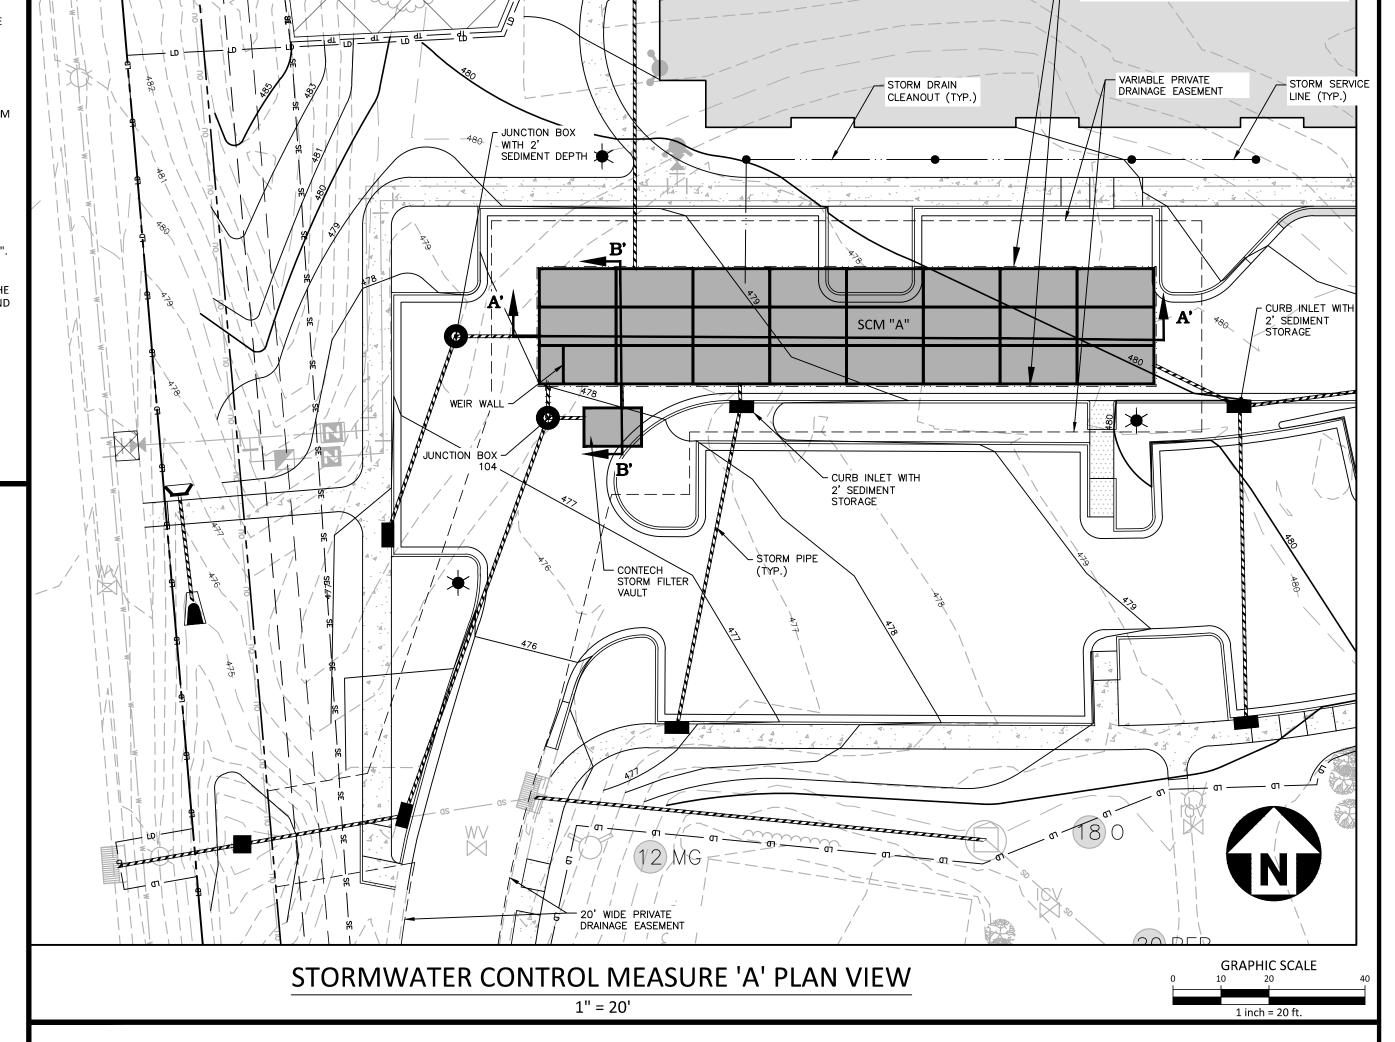

- DROP INLET WITH - BUILDING

FFE=482.00

2' SEDIMENT

STORAGE

STORMFILTER VAULT CONSTRUCTION NOTES

- STORMFILTER CONTROL MEASURE CONFIGURATION IS PROVIDED ON SHEET C9.01.
- 2. ABSOLUTELY NO RUNOFF SHALL ENTER THE STORMFILTER CONTROL MEASURE UNTIL ALL CONTRIBUTING DRAINAGE AREAS HAVE BEEN STABILIZED.
- 3. MANHOLE ACCESS SHALL BE PROVIDED FOR THE STORMFILTER CONTROL MEASURE. MANHOLES SHALL BE IN COMPLIANCE WITH CITY OF RALEIGH STANDARD DETAILS BUT SHALL BE A MINIMUM OF 24 INCHES IN DIAMETER TO COMPLY WITH OSHA CONFINED SPACE REQUIREMENTS (OR MINIMUM OSHA REQUIREMENTS APPLICABLE AT TIME OF CONSTRUCTION). CONTRACTOR SHALL PROVIDE ACCESS LADDERS FOR ACCESS BELOW ALL MANHOLES. MANHOLE COVERS SHALL ALLOW FOR PROPER VENTILATION.

STORMWATER SYSTEM MATERIAL SPECIFICATIONS


- 1. THE UNDERGROUND SCM UNITS ARE TO BE DESIGNED BY OTHERS. ANY CHANGES TO THE APPROVED PLANS SHALL BE PROVIDED TO THE DESIGN ENGINEER PRIOR TO INSTALLATION
- 2. ACCESS RISERS SHALL BE INSTALLED PER MANUFACTURE SPECIFICATIONS. ACCESS STEPS / LADDERS SHALL BE ATTACHED TO THE RISERS TO ALLOW FOR ACCESS INTO THE UNDERGROUND SCM SYSTEM.
- 3. DRAWDOWN OF THE STORMFILTER CARTRIDGE AREA AND DETENTION SYSTEMS IS VIA AN 6"Ø PLUG VALVE. THE VALVES SHALL BE A M&H STYLE 1820 X-CENTRIC VALVE OR ENGINEER APPROVED EQUIVALENT. THIS VALVE IS IN ACCORDANCE WITH AWWA C-517, AND SHALL BE OPERABLE FROM INSIDE THE SEDIMENTATION AND DETENTION SYSTEMS VIA A HANDWHEEL (SEE DETAIL SHEET SW-2). THE CONTRACTOR SHALL PROVIDE A REMOVABLE VALVE WRENCH WITH A HANDWHEEL ON TOP FOR OPERATION OF THE 6"Ø PLUG VALVE.
- 4. THE RCP OUTLET BARREL SHALL BE CLASS III RCP, MODIFIED BELL AND SPIGOT, MEETING THE REQUIREMENTS OF ASTM C76-LATEST. THE PIPE SHALL HAVE CONFINED O-RING RUBBER GASKET JOINTS MEETING ASTM C-443-LATEST. THE PIPE JOINTS SHALL BE TYPE R-4.
- 5. GEOTEXTILE FABRIC FOR THE OUTLET BARREL JOINTS SHALL BE MIRAFI 180N OR ENGINEER APPROVED EQUAL (NON-WOVEN FABRIC). THE ONSITE GEOTECHNICAL ENGINEER SHALL APPROVE FABRIC FOR USE.
- 6. ALL POURED CONCRETE SHALL BE MINIMUM 3000 PSI (28 DAY) UNLESS OTHERWISE NOTED.
- 7. THE CONTRACTOR SHALL INSTALL THE UNDERGROUND SCM UNITS PER MANUFACTURERS' SPECIFICATIONS. CONTRACTOR TO PROVIDE A LETTER FROM MATERIAL SUPPLIER(S) STATING MATERIALS MEET THE SPECIFIED STANDARDS PRIOR TO INSTALLATION.

BACKFILL MATERIAL NOTES

- 1. THE ON-SITE GEOTECHNICAL ENGINEER SHALL SPECIFY THE BACKFILL MATERIAL FOR THE UNDERGROUND SCM SYSTEM.
- 2. THE BACKFILL MATERIAL SHOULD BE FREE OF ROCKS, FROZEN LUMPS, AND OTHER FOREIGN MATTER THAT COULD CAUSE HARD SPOTS WITHIN THE BACKFILL MATERIAL, OR THAT COULD DECOMPOSE AND CREATE VOIDS.
- 3. HIGHLY PLASTIC SILTS, HIGHLY PLASTIC CLAYS, ORGANIC SILTS, ORGANIC CLAYS, AND PEATS SHOULD NOT BE USED AS A BACKFILL MATERIAL.
- 4. THE BACKFILL MATERIAL SHOULD BE PLACED IN 6" LOOSE LIFTS AND COMPACTED TO 95% OF THE STANDARD PROCTOR MAXIMUM DRY DENSITY (ASTM-D698). THE FILL SOILS SHOULD BE COMPACTED AT A MOISTURE CONTENT WITHIN +/- TWO PERCENT OF ITS OPTIMUM MOISTURE CONTENT.
- 5. ANY MATERIAL STOCKPILING ON TOP OF THE UNDERGROUND SCM SYSTEM SHALL BE APPROVED BY THE STRUCTURAL DESIGN ENGINEER.

STATEMENT OF RESPONSIBILITY

1. ALL REQUIRED MAINTENANCE AND INSPECTIONS OF THIS FACILITY SHALL BE THE RESPONSIBILITY OF THE PROPERTY OWNER, PER THE EXECUTED OPERATION AND MAINTENANCE AGREEMENT FOR THIS FACILITY.

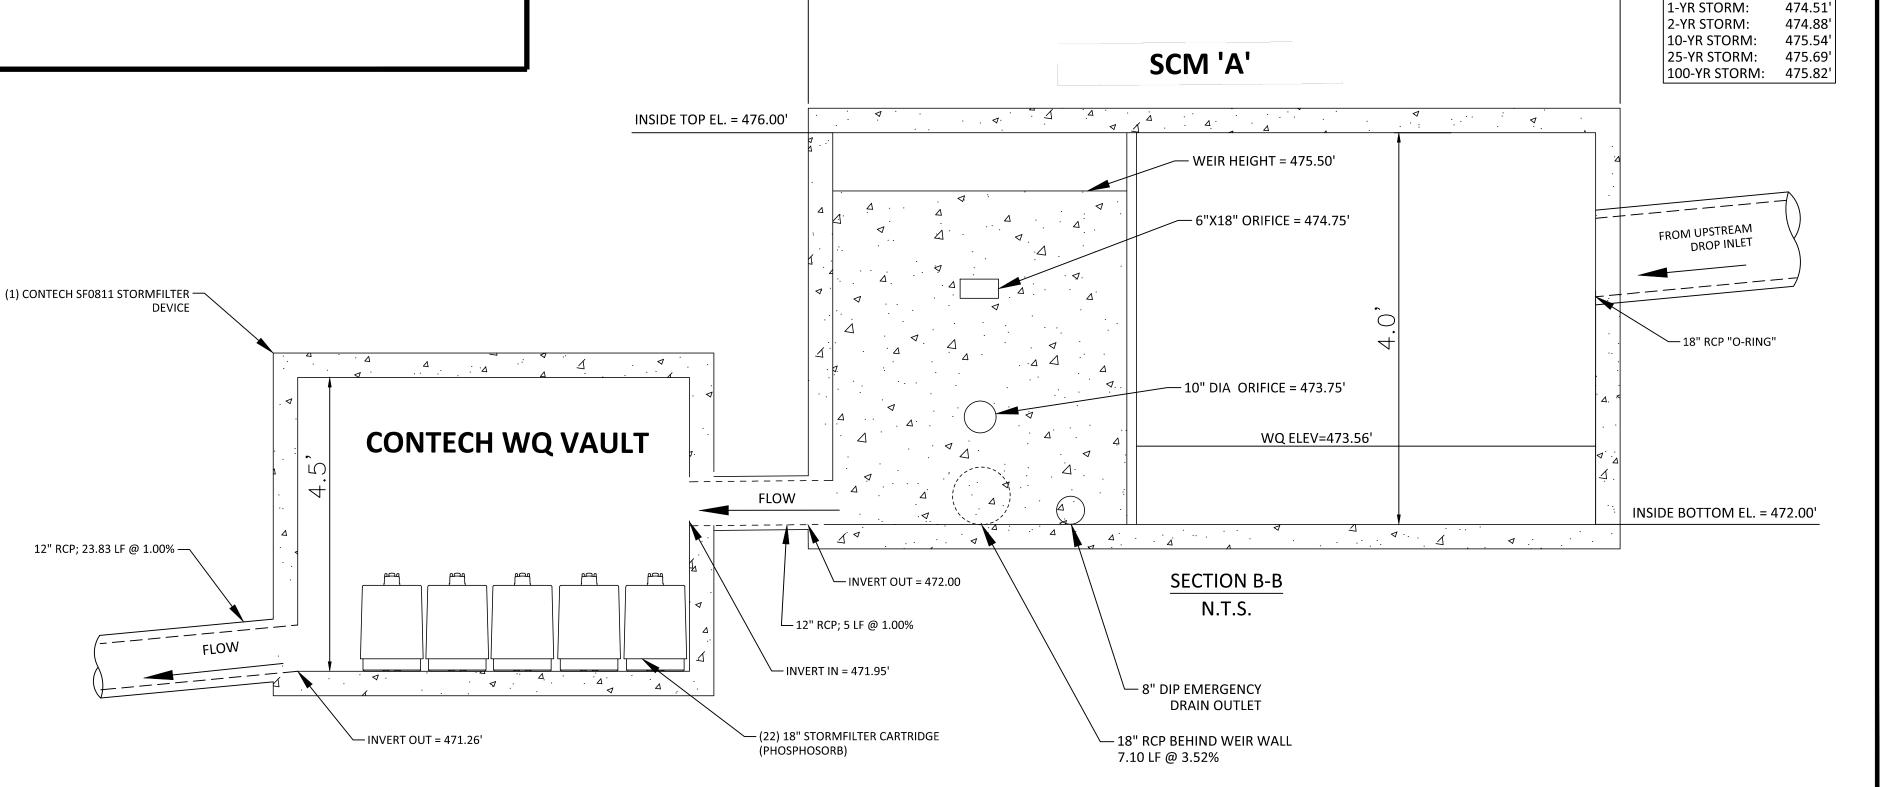



McAdams

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CLIENT

8" PERFORATED HDPE FOUNDATION DRAIN

PER DETAIL SHEET C9.02

WRAPPED IN NONWOVEN GEOTEXTILE FABRIC

CONTRACTOR TO MAINTAIN POSITIVE SLOPE TO


DOWNSTREAM JUNCTION BOX WITH TRUMBULL

CHECK VALVE OR ENGINEER APPROVED EQUIVALENT

OUTLET. FOUNDATION DRAIN SHALL TIE INTO

MR. JOE WHITEHOUSE KISCO SENIOR LIVING 5790 FLEET STREET, SUITE 300 CARLSBAD, CALIFORNIA 92008

ABBOTTSWOOD AT STONEHENGE DMINISTRATIVE SITE REVIEV 7900 CREEDMOOR ROAD

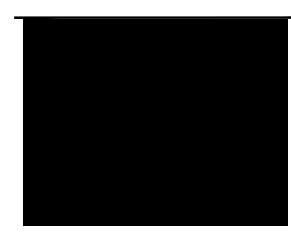

REVISIONS

NO. DATE

PLAN INFORMATION

PROJECT NO. KDC-20000

FILENAME KDC20000-ASR-SW1.DWG

CHECKED BY LJV

DRAWN BY JTB


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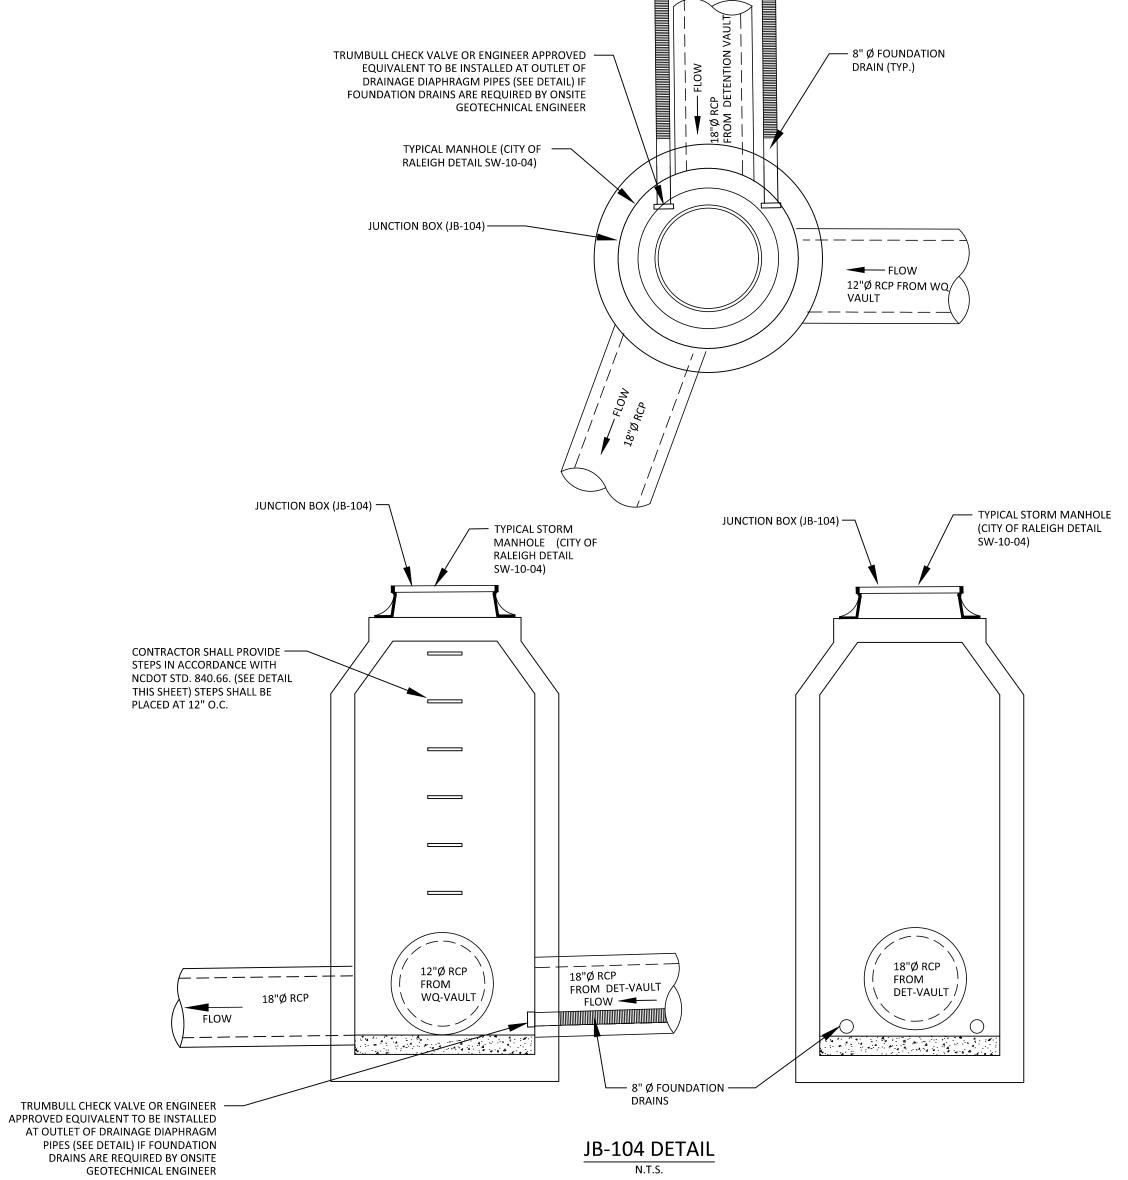
DATE 08.05.2024

SHEET

PRELIMINARY DRAWING - NOT RELEASED FOR CONSTRUCTION

SCM "A" PLAN VIEW
AND DETAILS



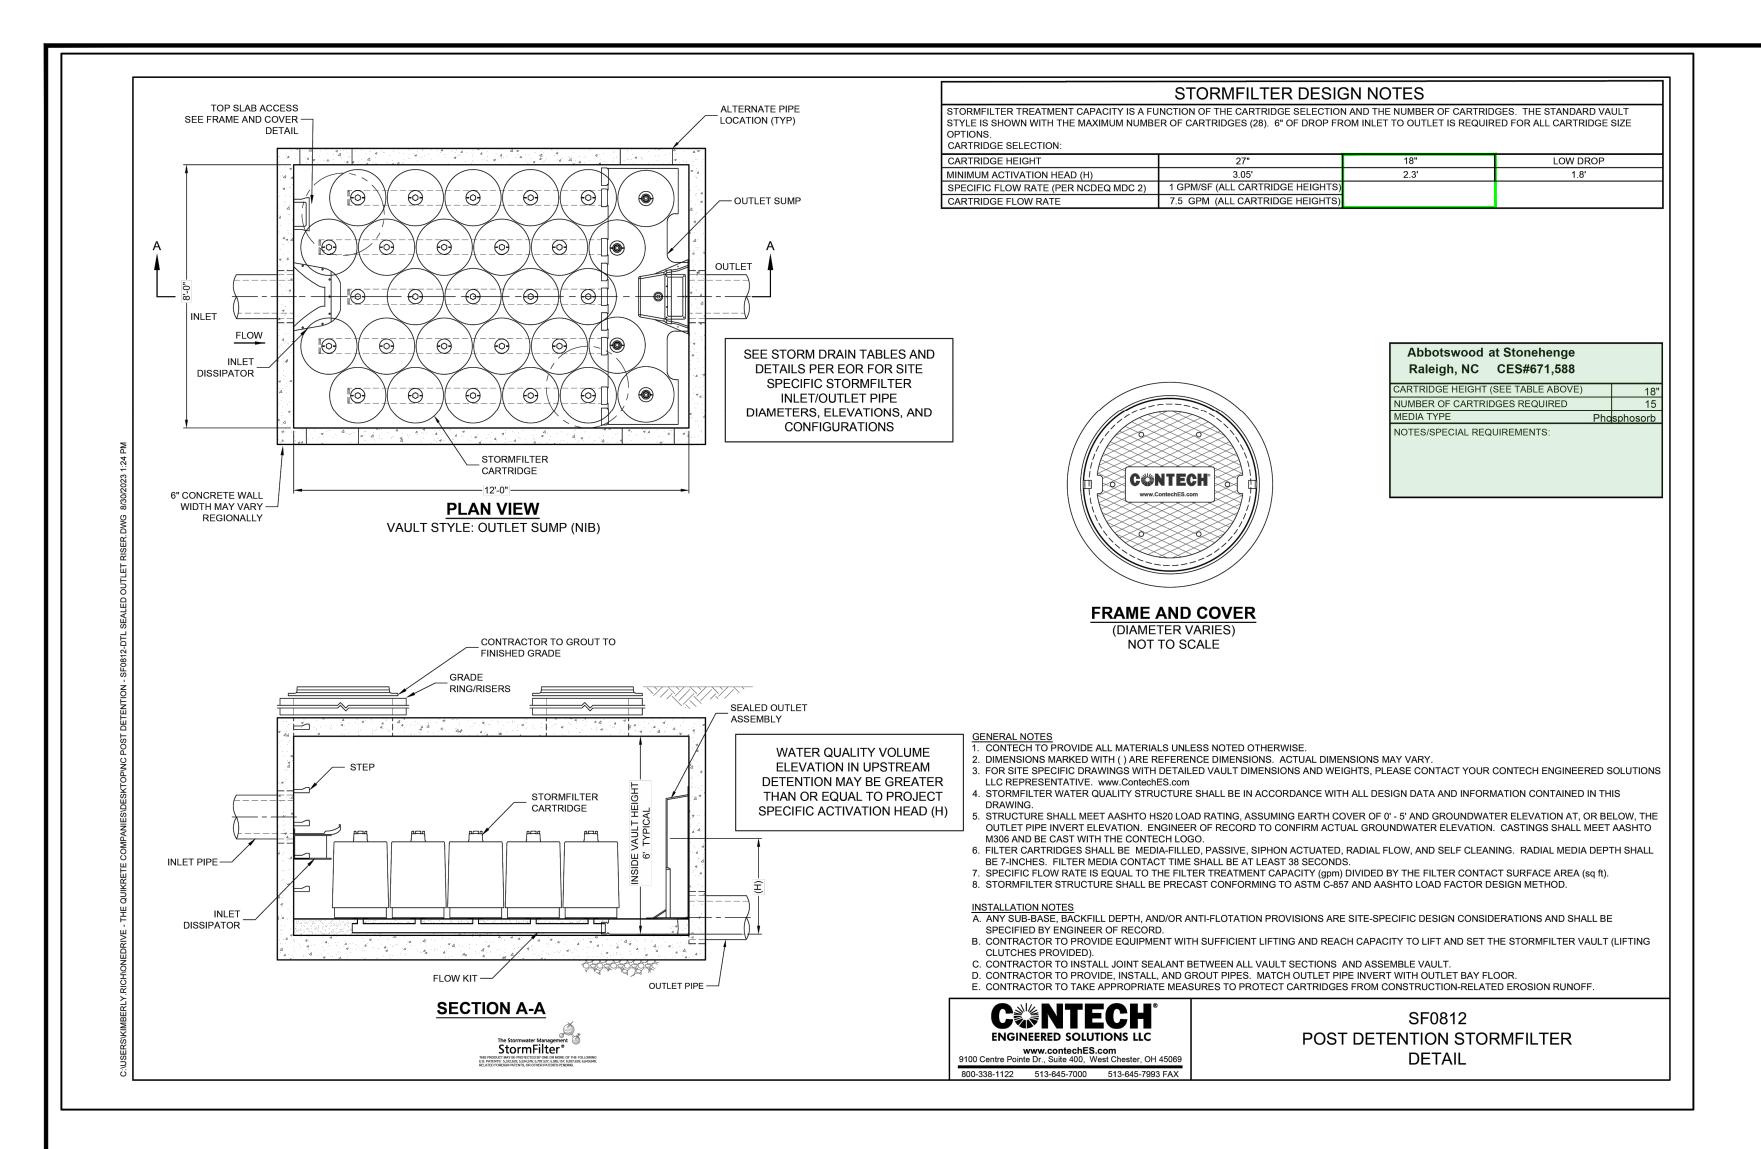



Durham, NC 27713

phone 919. 361. 5000 fax 919. 361. 2269

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CLIENT

MR. JOE WHITEHOUSE KISCO SENIOR LIVING 5790 FLEET STREET, SUITE 300 CARLSBAD, CALIFORNIA 92008

ABBOILISWOOD AI STONEHENGE DMINISTRATIVE SITE REVIEW 7900 CREEDMOOR ROAD



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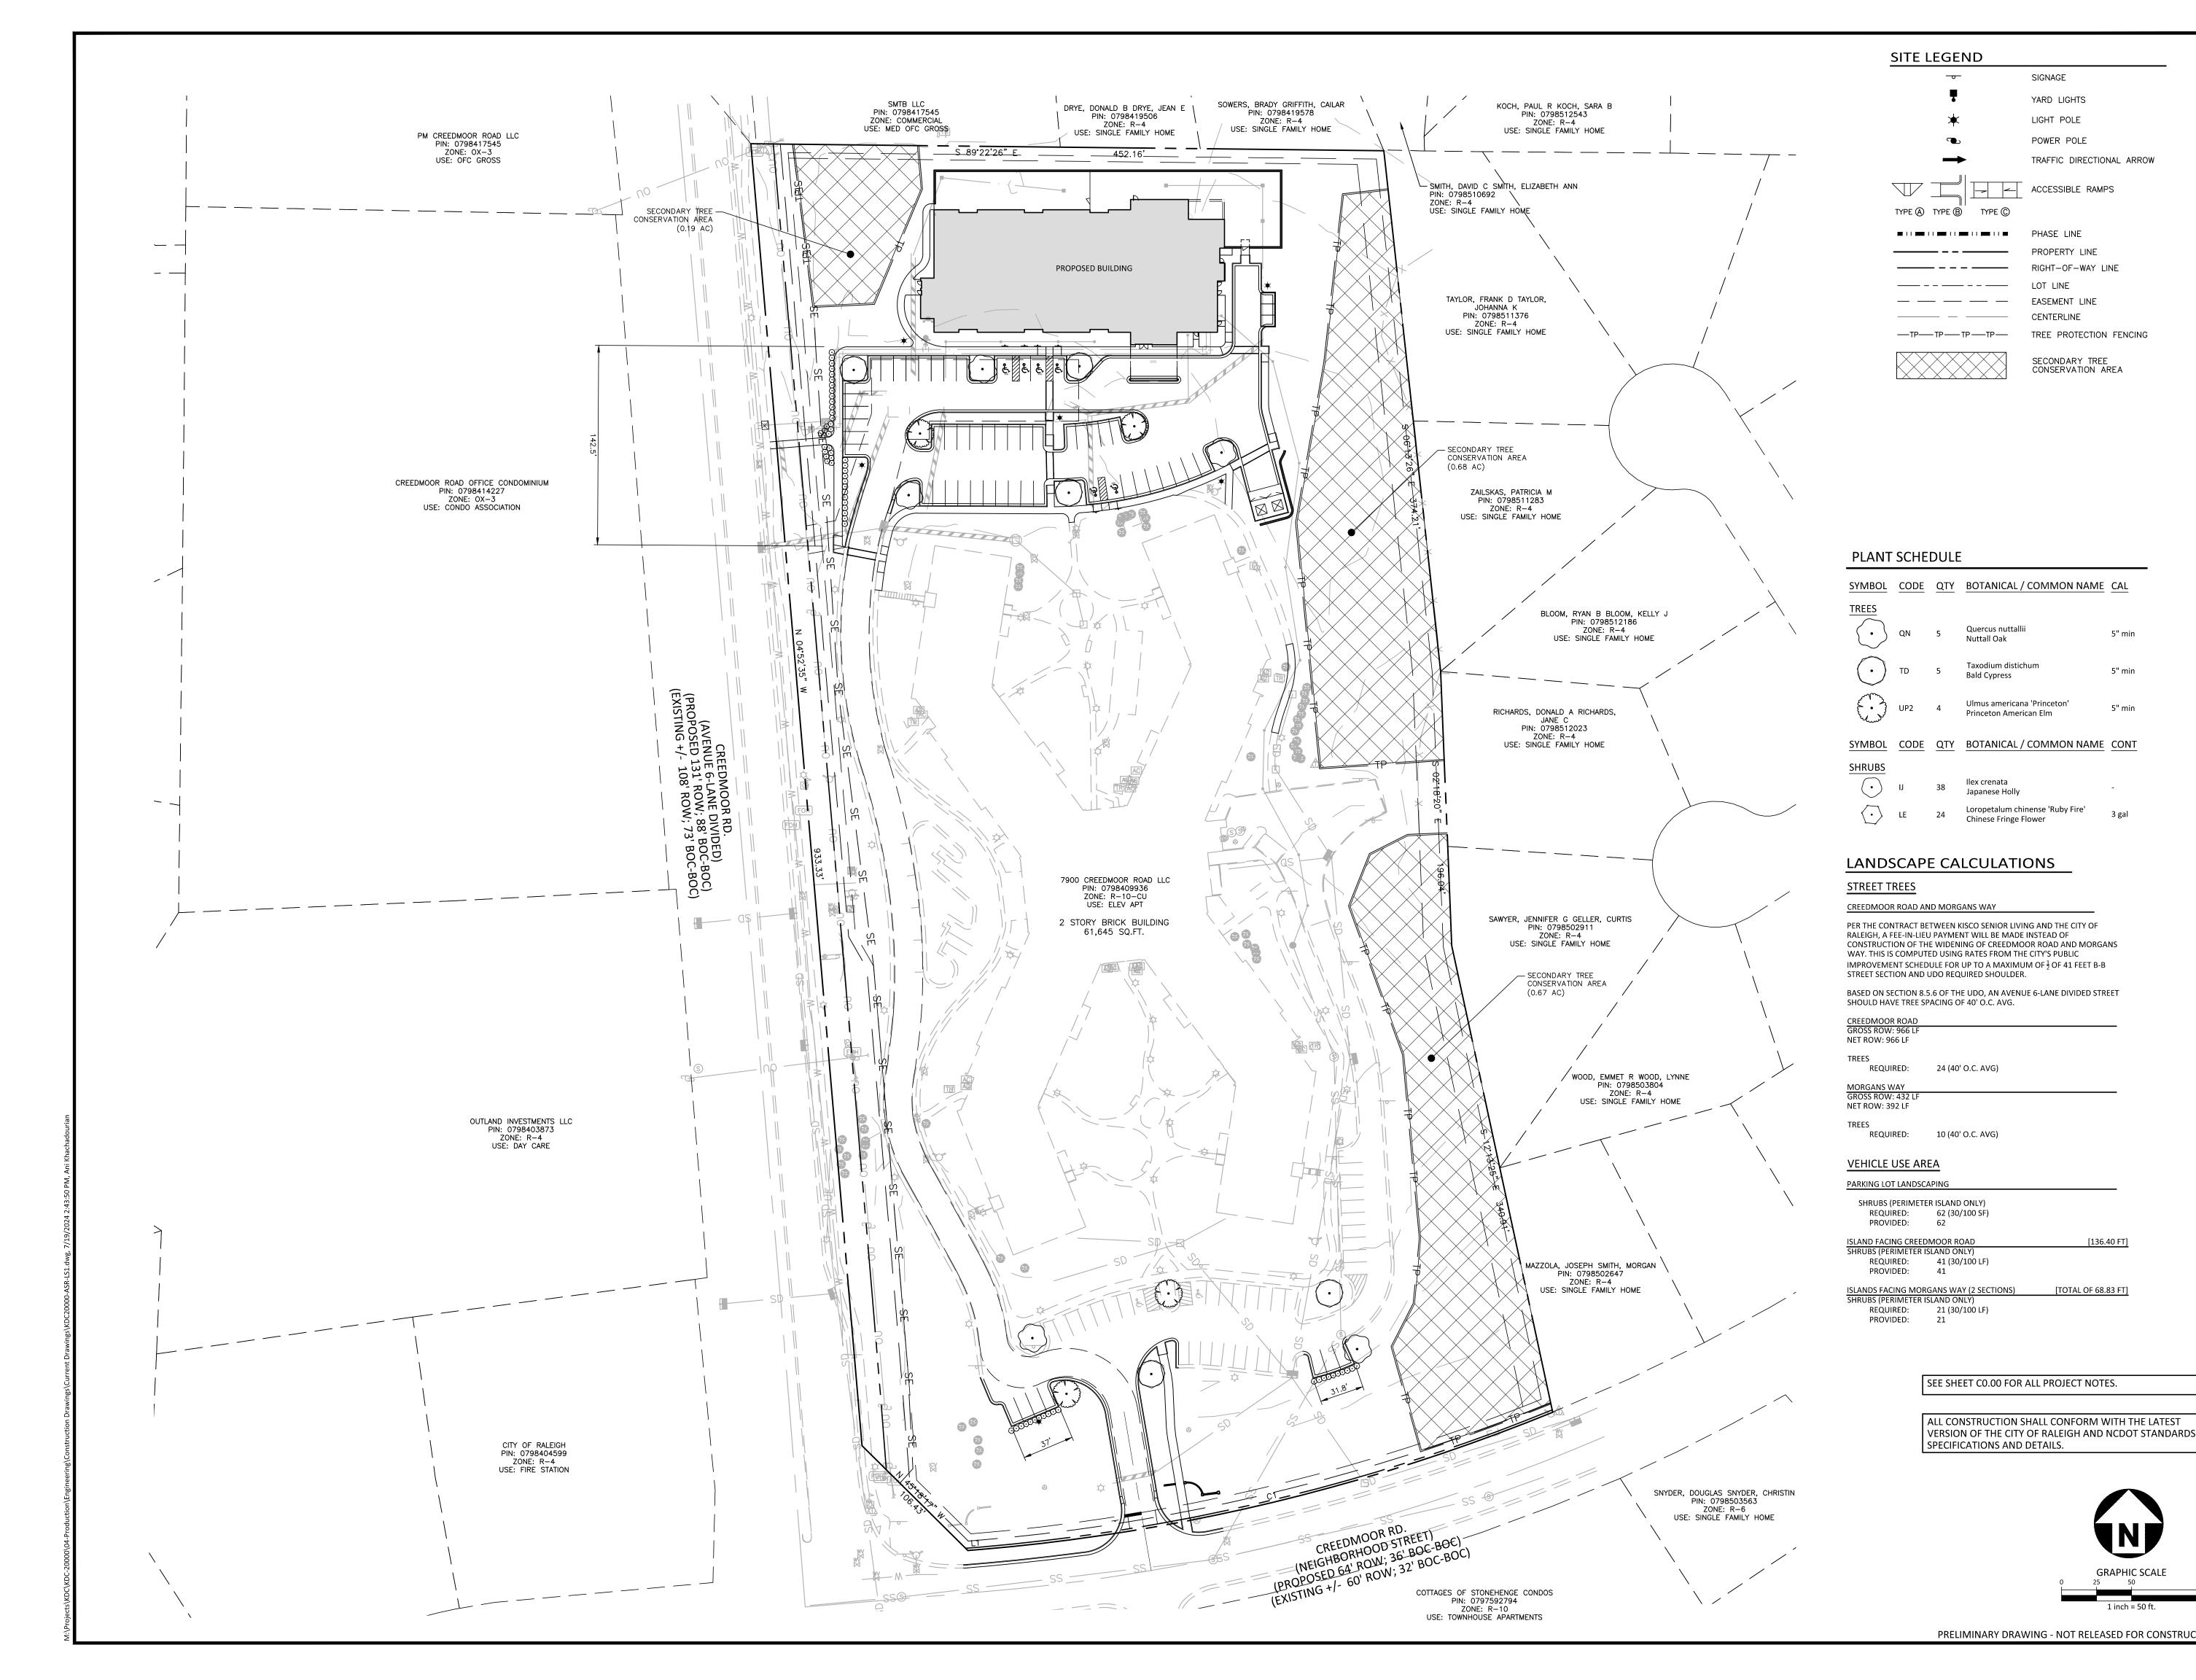
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SHEET

SCM DETAILS

C9.01





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CLIENT

SIGNAGE

YARD LIGHTS

LIGHT POLE

POWER POLE

PHASE LINE

LOT LINE

PROPERTY LINE

EASEMENT LINE

CENTERLINE

RIGHT-OF-WAY LINE

SECONDARY TREE CONSERVATION AREA

5" min

5" min

5" min

ACCESSIBLE RAMPS

TRAFFIC DIRECTIONAL ARROW

MR. JOE WHITEHOUSE KISCO SENIOR LIVING 5790 FLEET STREET, SUITE 300 CARLSBAD, CALIFORNIA 92008

VINIS 7900 (



REVISIONS

NO. DATE

PLAN INFORMATION

PROJECT NO. KDC-20000 KDC20000-ASR-LS1.DWG FILENAME

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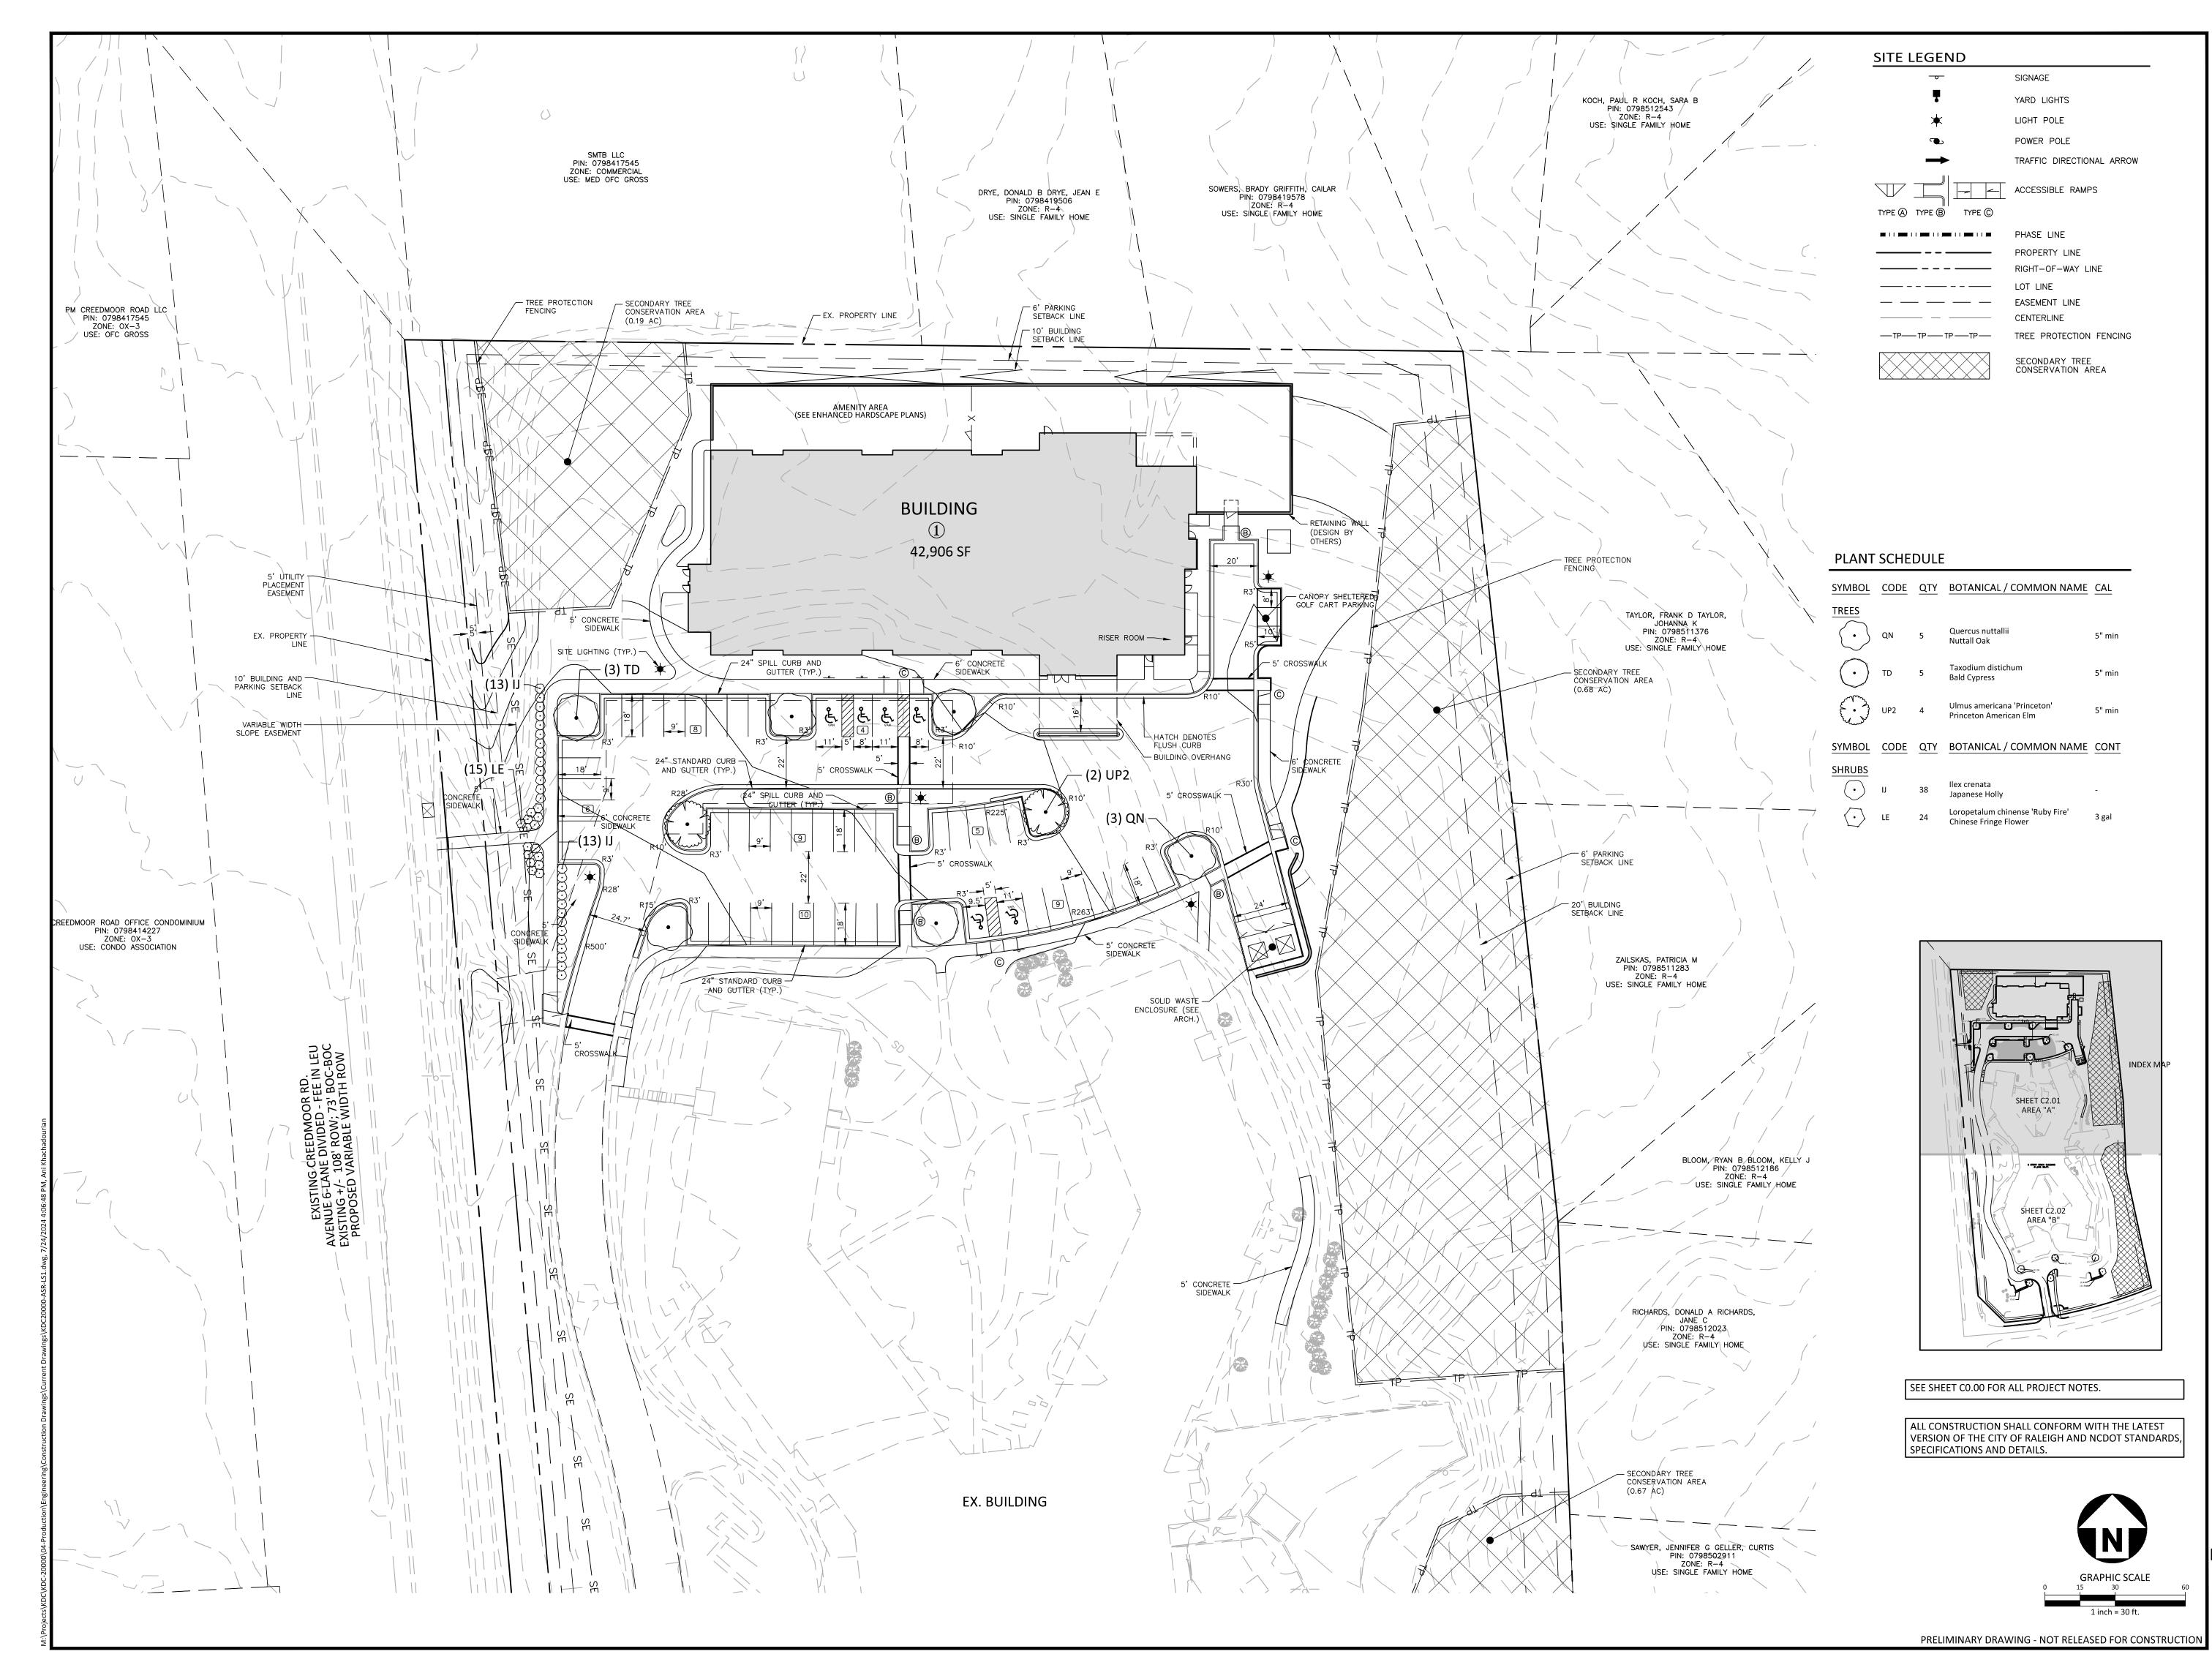
SCALE DATE 04. XX. 2024

SHEET

OVERALL LANDSCAPE PLAN

PRELIMINARY DRAWING - NOT RELEASED FOR CONSTRUCTION

[TOTAL OF 68.83 FT]





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PLAN INFORMATION


PROJECT NO. KDC-20000 KDC20000-ASR-LS1.DWG FILENAME CHECKED BY

DRAWN BY SCALE 1"=30' DATE

04. XX. 2024

SHEET

DETAILED LANDSCAPE PLAN AREA "A"

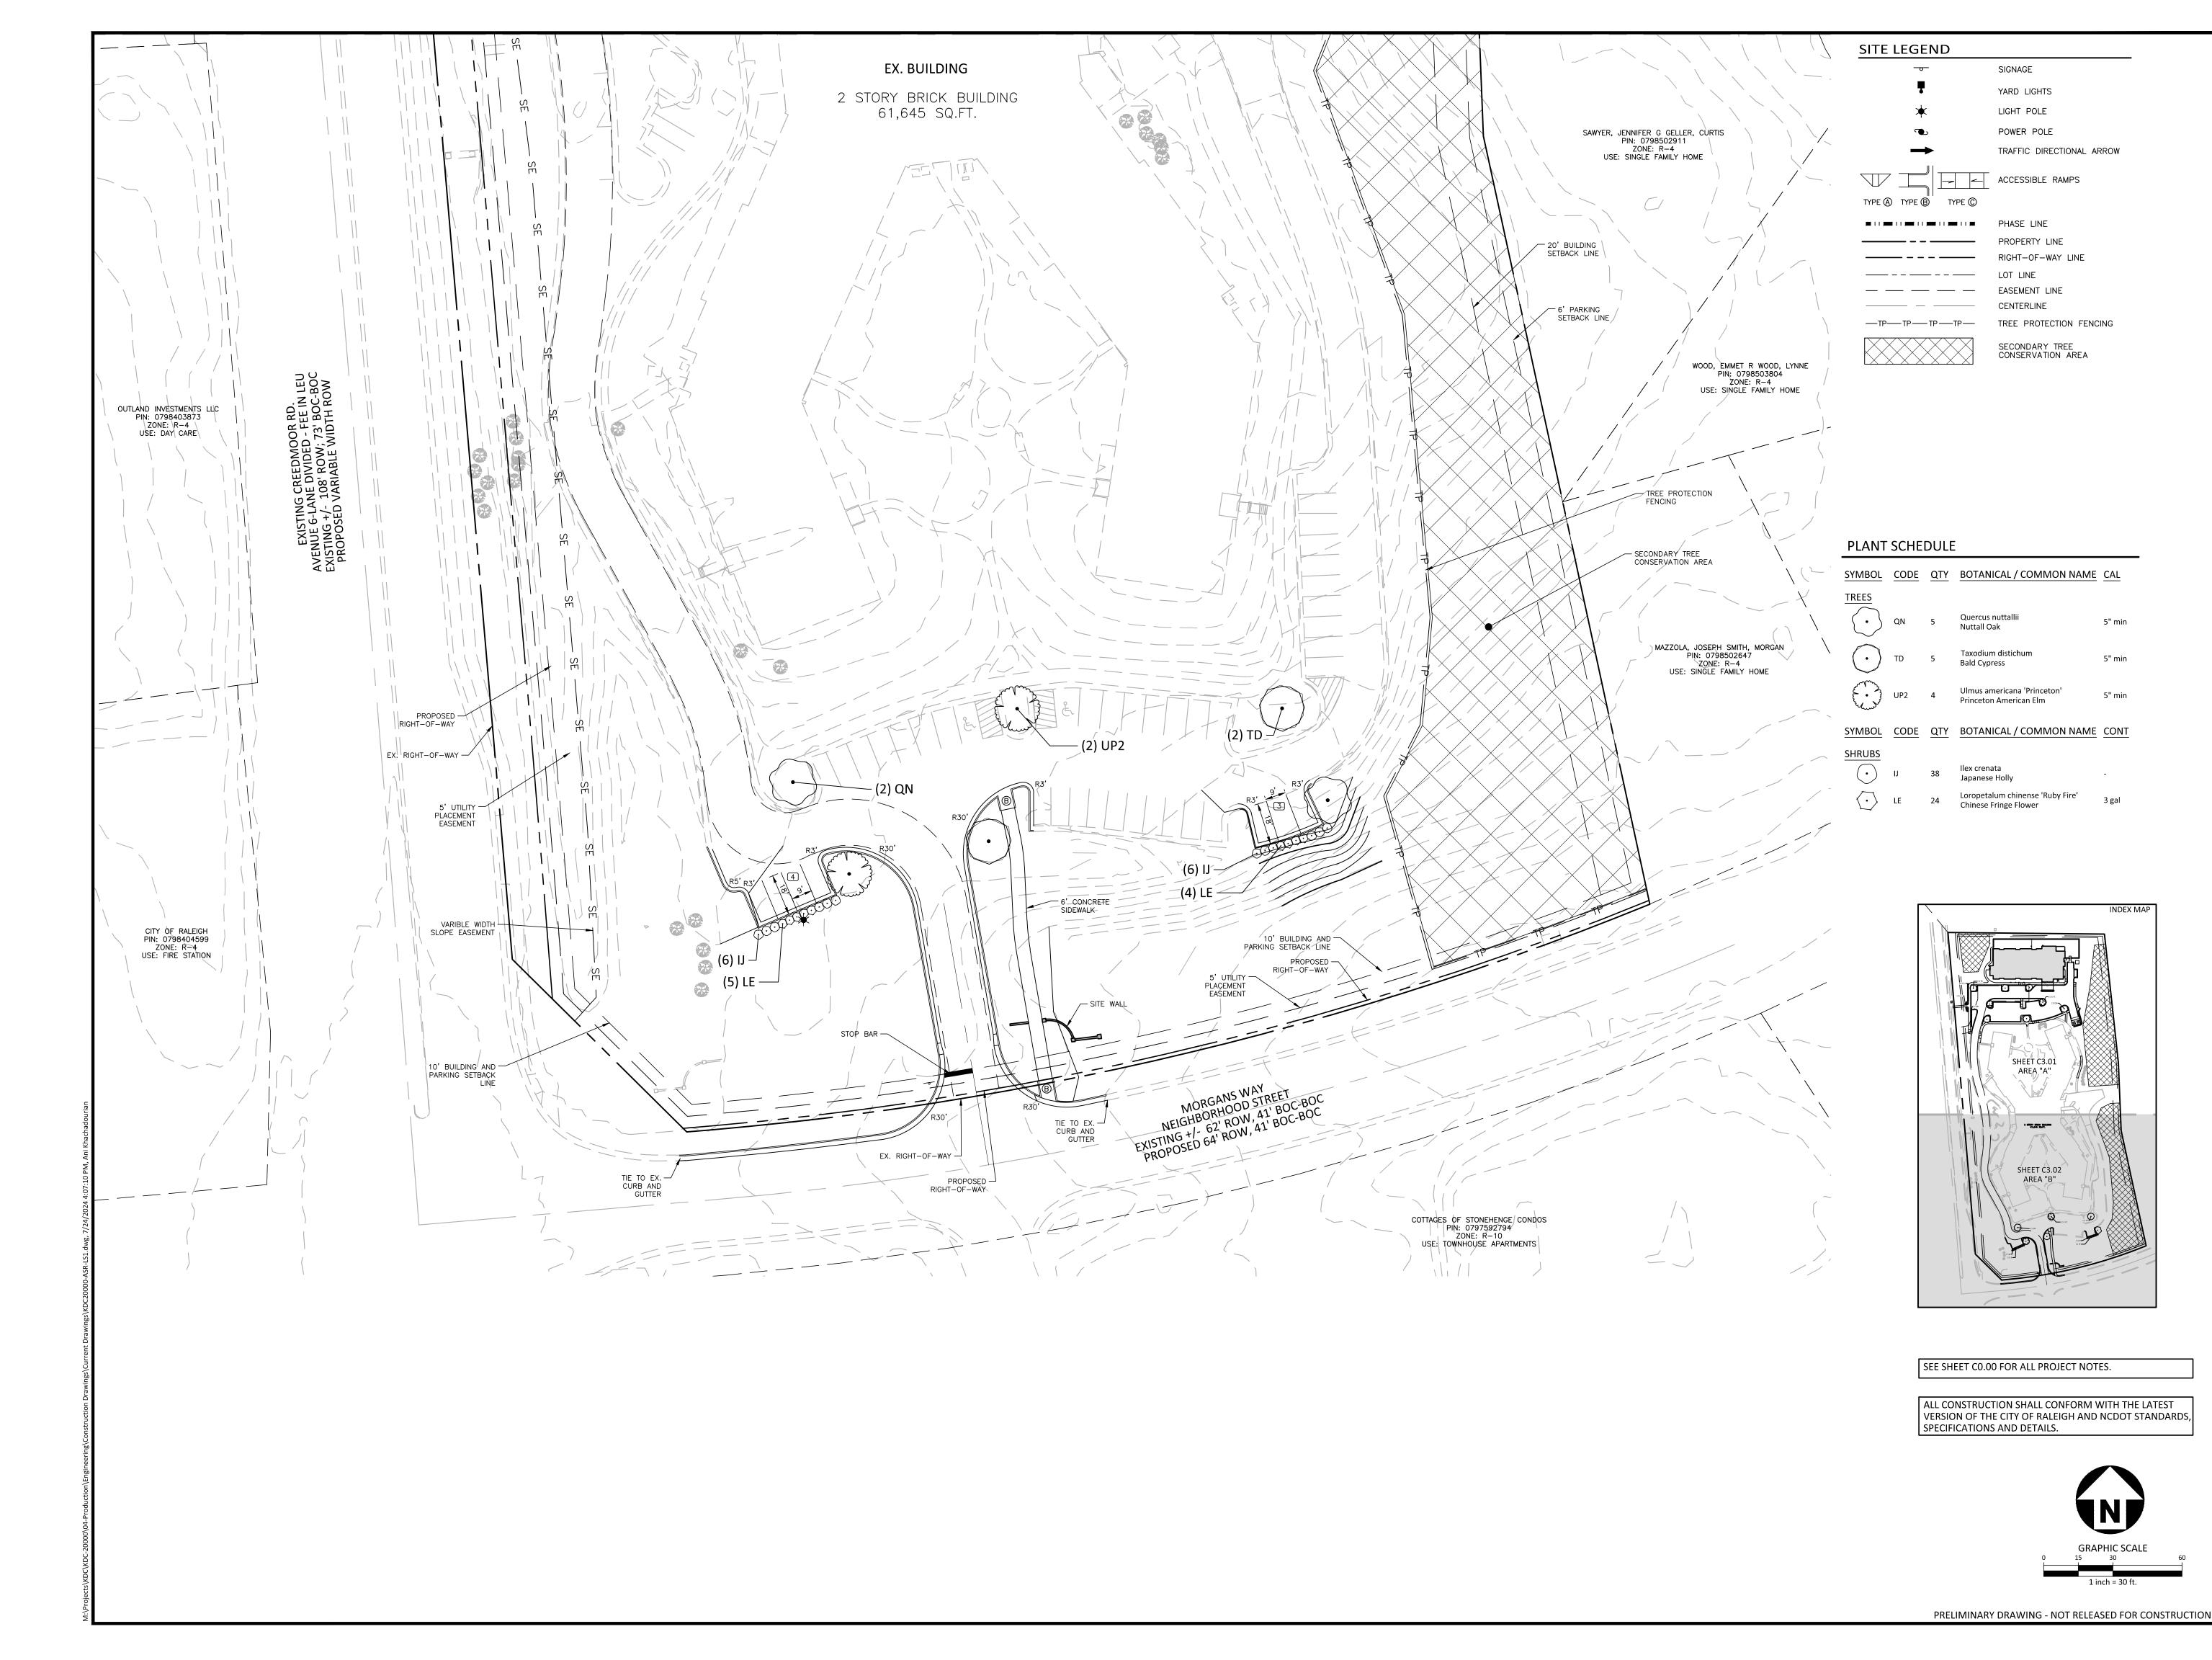



McAdams

The John R. McAdams Company, Inc. 2905 Meridian Parkway Durham, NC 27713

phone 919. 361. 5000 fax 919. 361. 2269 license number: C-0293, C-187

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CARLSBAD, CALIFORNIA 92008

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ABBOI ISWOOD AI
STONEHENGE
DMINISTRATIVE SITE REVIE
7900 CREEDMOOR ROAD



REVISIONS

NO. DATE

PLAN INFORMATION

PROJECT NO. KDC-20000

FILENAME KDC20000-ASR-LS1.DWG

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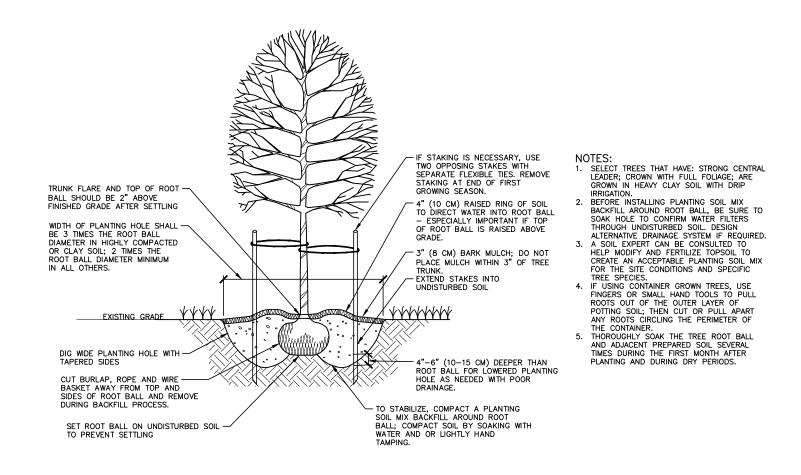
SCALE 1"=30'


DATE 04. XX. 2024

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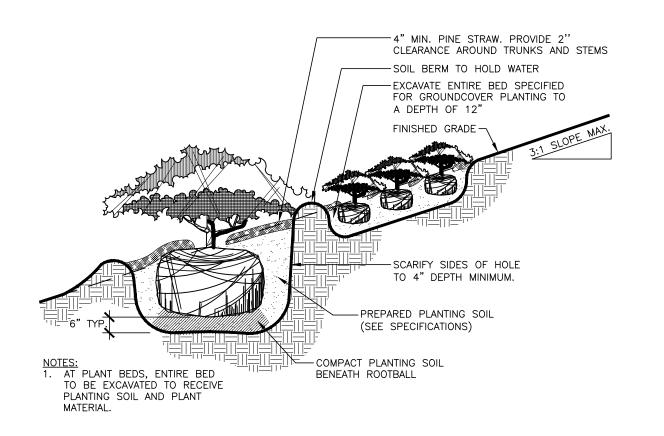
DETAILED LANDSCAPE PLAN AREA "B"

L5.02



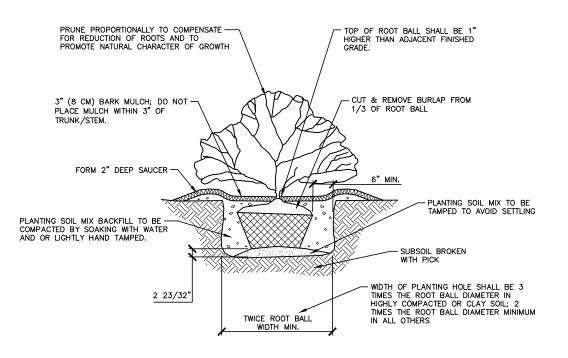

SHRUB INSTALLATION SCALE: 3/8"=1'-0"



WARRANTY & MAINTENANCE:

- . WARRANTY: INSTALLER SHALL REPAIR OR REPLACE ANY PLANTINGS THAT FAIL IN MATERIALS, WORKMANSHIP, OR GROWTH WITHIN ONE YEAR AFTER THE DATE OF SUBSTANTIAL COMPLETION. FAILURES INCLUDE, BUT ARE NOT LIMITED TO, THE FOLLOWING:
 - DEATH AND UNSATISFACTORY GROWTH, EXCEPT FOR DEFECTS RESULTING FROM LACK OF ADEQUATE MAINTENANCE, NEGLECT, ABUSE BY OWNER, OR INCIDENTS THAT ARE BEYOND CONTRACTOR'S CONTROL.
 - STRUCTURAL FAILURES INCLUDING PLANTINGS FALLING OR BLOWING OVER.
- 2. MAINTENANCE: INITIAL MAINTENANCE SHALL BE PROVIDED IMMEDIATELY AFTER EACH AREA IS PLANTED AND CONTINUE UNTIL SUBSTANTIAL COMPLETION. UPON SUBSTANTIAL COMPLETION, MAINTENANCE FOR ALL PLANT MATERIAL SHALL BE PROVIDED FOR ONE YEAR AT A MINIMUM SHALL INCLUDE:
- TREE AND SHRUB MAINTENANCE: MAINTAIN PLANTINGS BY PRUNING, CULTIVATING, WATERING, WEEDING, FERTILIZING, RESTORING PLANTING SAUCERS, AND RESETTING TO PROPER GRADES OR VERTICAL POSITION, AS REQUIRED TO ESTABLISH HEALTHY, VIABLE PLANTINGS. SPRAY OR TREAT AS REQUIRED TO KEEP TREES AND SHRUBS FREE OF INSECTS AND DISEASE.
- GROUND COVER AND PLANT MAINTENANCE: MAINTAIN AND ESTABLISH PLANTINGS BY WATERING, WEEDING, FERTILIZING, MULCHING, AND OTHER
- OPERATIONS AS REQUIRED TO ESTABLISH HEALTHY, VIABLE PLANTINGS. PROTECT EXTERIOR PLANTS FROM DAMAGE DUE TO LANDSCAPE OPERATIONS, OPERATIONS BY OTHER CONTRACTORS AND TRADES, AND OTHERS. MAINTAIN PROTECTION DURING INSTALLATION AND MAINTENANCE PERIODS. TREAT, REPAIR, OR REPLACE DAMAGED PLANTINGS.

GENERAL DETAIL NOTES:

- THESE NOTES SHALL APPLY TO ALL DETAILS INCLUDED IN THIS SET OF CONTRACT DOCUMENTS.
- 2. CONTRACTOR SHALL VERIFY ALL EXISTING CONDITIONS AND REPORT ANY DISCREPANCIES AND UNUSUAL CONDITIONS TO LANDSCAPE ARCHITECT PRIOR TO CONSTRUCTION.
- 3. ALL CONSTRUCTION SHALL BE IN COMPLIANCE WITH FEDERAL, STATE, AND LOCAL CODES AND REGULATIONS.
- 4. ALL CONCRETE SHALL BE 3,000 PSI.
- 5. CONSTRUCT EXPANSION JOINTS WHERE WALKS MEET CURBS, STEPS, WALLS, OR FIXED
- 6. ALL WOOD, IN CONTACT WITH GROUND, UNLESS OTHERWISE SPECIFIED, SHALL BE SOUTHERN YELLOW PINE, SPIB GRADE NO. 2 COMMON OR BETTER, S4S, SIZED AS SHOWN ON DRAWINGS, TREATED AWPB LP22, 10% MAXIMUM MOISTURE CONTENT.
- 7. BOLTS, THREADED RODS, WASHERS, NUTS AND ALL BUILDING HARDWARE SHALL BE HOT-DIPPED GALVANIZED.
- 8. ALL THROUGH BOLTS TO BE SMOOTH SHAFT WITH GALVANIZED NUTS, BOLTS AND
- 9. ALL NAILS SHALL BE HOT DIPPED GALVANIZED. FINISH NAILS SHALL BE ANNULAR ALLOY ALUMINUM.
- 10. ALL WELDS CONTINUOUS.
- 11. INSTALL ALL SITE FURNISHINGS PLUMB, LEVEL, TRUE TO LINE AND AT ELEVATIONS
- 12. RESTORE DAMAGED FINISHES AND REPLACE DAMAGED OR DEFECTIVE UNITS.
- 13. SUBMIT SHOP DRAWINGS, PRODUCT DATA AND MAINTENANCE DATA FOR APPROVAL PRIOR
- 14. CONTRACTOR TO PROVIDE MOCK-UPS FOR ALL SITE PAVING TO BE USED THROUGHOUT PROJECT TO DEMONSTRATE ALL JOINT PATTERNS, EDGE TREATMENTS AND PAVING
- 15. WALL DETAILS SHOWN FOR DESIGN INTENT. REFER TO STRUCTURAL DRAWINGS FOR ALL WALL REINFORCEMENT AND CONSTRUCTION.

GENERAL LANDSCAPE NOTES:

- 1. ALL MATERIALS AND METHODS OF CONSTRUCTION SHALL BE IN ACCORDANCE WITH THE CITY OF RALEIGH AND THE STATE OF NORTH CAROLINA STANDARDS AND SPECIFICATIONS.
- 2. CONTRACTOR IS RESPONSIBLE FOR THE SITE INSPECTION BEFORE LANDSCAPE CONSTRUCTION AND INSTALLATION IN ORDER TO BECOME FAMILIAR WITH THE EXISTING
- LANDSCAPE CONTRACTOR IS RESPONSIBLE FOR LOCATING ALL UNDERGROUND UTILITIES BEFORE BEGINNING DEMOLITION OR INSTALLATION.
- 4. CONTRACTOR SHALL NOTIFY LANDSCAPE ARCHITECT OF ANY DISCREPANCIES BETWEEN THE NOTES, SPECIFICATIONS, DRAWINGS OR SITE CONDITIONS FOR RESOLUTION PRIOR TO
- 5. ANY DAMAGE TO UTILITIES SHALL BE REPAIRED AT THE CONTRACTOR'S EXPENSE.
- 6. THIS PLAN IS FOR PLANTING PURPOSES ONLY. FOR INFORMATION REGARDING BUILDINGS, GRADING, WALLS, ETC., REFER TO ARCHITECTURE, SITE AND GRADING PLANS.
- VERIFICATION OF TOTAL PLANT QUANTITIES AS SHOWN IN THE PLANT SCHEDULE SHALL BE THE RESPONSIBILITY OF THE LANDSCAPE CONTRACTOR. ANY DISCREPANCIES SHALL BE BROUGHT TO THE ATTENTION OF THE LANDSCAPE ARCHITECT.
- 8. CONTRACTOR TO ENSURE PROPER STABILIZATION AND SEEDING OF THE SITE IN ACCORDANCE WITH APPLICABLE REGULATIONS.
- 9. LANDSCAPE MATERIAL SHALL BE WELL FORMED, VIGOROUS, GROWING SPECIMENS WITH GROWTH TYPICAL OF VARIETIES SPECIFIED AND SHALL BE FREE FROM DAMAGE, INSECTS AND DISEASES. MATERIAL SHALL EQUAL OR SURPASS #1 QUALITY AS DEFINED IN THE CURRENT ISSUE OF "AMERICAN STANDARD FOR NURSERY STOCK" AS PUBLISHED BY THE AMERICAN NURSERY & LANDSCAPE ASSOCIATION.
- 10. ALL PLANT MATERIAL IS TO BE CAREFULLY HANDLED BY THE ROOT BALL, NOT THE TRUNK, BRANCHES AND/OR FOLIAGE OF THE PLANT. MISHANDLED PLANT MATERIAL MAY BE REJECTED BY THE LANDSCAPE ARCHITECT.
- 11. ALL PLANT MATERIAL IS TO BE WELL ROOTED, NOT ROOT BOUND, SUCH THAT THE ROOT BALL REMAINS INTACT THROUGHOUT THE PLANTING PROCESS. DEFICIENT PLANT MATERIAL MAY BE REJECTED BY THE LANDSCAPE ARCHITECT OR OWNER.
- 12. ALL PLANTS TO BE A MINIMUM OF WHAT IS SPECIFIED IN THE PLANT SCHEDULE. ANY CHANGES OR SUBSTITUTIONS SHALL BE APPROVED BY THE LANDSCAPE ARCHITECT AND GOVERNING JURISDICTION PRIOR TO ANY HOLE BEING DUG.
- 13. CONTRACTOR TO COORDINATE WITH OWNER'S REPRESENTATIVE AND LANDSCAPE ARCHITECT TO ESTABLISH THE EXTENTS OF MULCH/SEED/SOD IF NOT SPECIFICALLY SHOWN
- 14. CONTRACTOR SHALL PROVIDE POSITIVE DRAINAGE IN ALL PLANTING AREAS.
- 15. PROPOSED TREES TO BE PLANTED A MINIMUM 10 FEET FROM ANY LIGHT POLE AS MEASURED FROM TRUNK OF THE TREE TO THE POLE.
- 16. PROPOSED TREES TO BE PLANTED A MINIMUM 5 FEET FROM ANY FIRE HYDRANT AS MEASURED FROM TRUNK OF THE TREE TO THE HYDRANT.
- 17. CONTRACTOR SHALL COMPLETE SOIL TEST IN ALL PLANTING AREAS TO DETERMINE SOIL AMENDMENT REQUIREMENTS UNLESS WAIVED BY OWNER'S REPRESENTATIVE. CONTRACTOR SHALL ADJUST PH AND FERTILITY BASED UPON THE SOIL TEST RESULTS.
- 18. TOPSOIL SHALL BE FREE OF MATERIAL LARGER THAN 1.0 INCH IN DIAMETER OR LENGTH AND SHALL NOT CONTAIN SLAG, CINDERS, STONES, LUMPS OF SOIL, STICKS, ROOTS, TRASH, OR OTHER EXTRANEOUS MATERIAL.
- 19. LOOSEN SUBGRADE / SURFACE SOIL TO A MINIMUM DEPTH OF 6 INCHES. APPLY SOIL AMENDMENTS AND FERTILIZERS AS REQUIRED BY THE SOIL TEST RESULTS TO ACHIEVE A HEALTHY GROWING MEDIA AND MIX THOROUGHLY INTO TOP 4 INCHES OF SOIL. SPREAD PLANTING SOIL MIX TO A DEPTH OF 6 INCHES BUT NOT LESS THAN REQUIRED TO MEET FINISH GRADES AFTER NATURAL SETTLEMENT. DO NOT SPREAD IF PLANTING SOIL OR SUBGRADE IS FROZEN, MUDDY, OR EXCESSIVELY WET.
- 20. IF IMPORTED TOPSOIL IS REQUIRED, THE SUBGRADE SHALL BE SCARIFIED OR TILLED TO A DEPTH OF AT LEAST 6 INCHES PRIOR TO INSTALLATION OF IMPORTED TOPSOIL. FOLLOWING INSTALLATION OF IMPORTED TOPSOIL, THE TOPSOIL SHALL BE TILLED TO INTEGRATE THE
- 21. PLANT MATERIALS ARE TO BE GUARANTEED FOR A PERIOD OF 12 MONTHS. PLANT MATERIALS WHICH REMAIN UNHEALTHY WILL BE REPLACED BY THE LANDSCAPE CONTRACTOR BEFORE THE EXPIRATION OF THE GUARANTEE PERIOD OR IMMEDIATELY IF SO DIRECTED BY THE OWNER'S REPRESENTATIVE OR LANDSCAPE ARCHITECT.
- 22. ALL TREE PLANTINGS SHALL BE MULCHED TO A DEPTH OF 3 INCHES, AND WITH A MINIMUM 3 FOOT RADIUS FROM BASE OF TREE OR TO DRIPLINE. MULCH SHALL BE FREE OF TRASH AND MAINTAINED WEED FREE. MULCH SHALL NOT COVER THE ROOT FLARE. CONFIRM MULCH SPECIFICATIONS WITH OWNER'S REPRESENTATIVE OR LANDSCAPE ARCHITECT.
- 23. DO NOT PRUNE TREES AND SHRUBS BEFORE DELIVERY. PROTECT BARK, BRANCHES, AND ROOT SYSTEMS FROM SUN SCALD, DRYING, SWEATING, WHIPPING, AND OTHER HANDLING AND TYING DAMAGE. DO NOT BEND OR BIND-TIE TREES OR SHRUBS IN SUCH A MANNER AS TO DESTROY THEIR NATURAL SHAPE. PROVIDE PROTECTIVE COVERING OF EXTERIOR PLANTS DURING DELIVERY. DO NOT DROP EXTERIOR PLANTS DURING DELIVERY AND HANDLING.
- 24. DELIVER EXTERIOR PLANTS AFTER PREPARATIONS FOR PLANTING HAVE BEEN COMPLETED AND INSTALL IMMEDIATELY. IMMEDIATELY AFTER UNLOADING, STAND THE TREES UP TO REDUCE THE RISK OF SUN SCALD. PROPERLY STAGED TREES ARE STANDING, UNTIED AND SPACED. UNLESS IMMEDIATELY INSTALLED, SET EXTERIOR PLANTS AND TREES IN SHADE, PROTECT FROM WEATHER AND MECHANICAL DAMAGE, AND KEEP ROOTS MOIST.
- 25. SEE LANDSCAPE DETAILS FOR TREE STAKING REQUIREMENTS.
- 26. EXCAVATE EDGES OF ALL PLANTING BEDS TO 2 INCH DEPTH TO FORM A NEAT AND CRISP
- 27. CONTRACTOR SHALL REMOVE DEBRIS AND FINE GRADE ALL PLANTING AREAS PRIOR TO INSTALLATION.
- 28. REMOVE GUY WIRES AND STAKES AT END OF WARRANTY PERIOD OR ESTABLISHMENT.
- 29. FINISH GRADING: GRADE PLANTING AREAS TO A SMOOTH, UNIFORM SURFACE PLANE WITH LOOSE, UNIFORMLY FINE TEXTURE. GRADE TO WITHIN PLUS OR MINUS 1/2 INCH OF FINISH ELEVATION. ROLL AND RAKE, REMOVE RIDGES, AND FILL DEPRESSIONS TO MEET FINISH GRADES. LIMIT FINISHED GRADING TO AREAS THAT CAN BE PLANTED IN THE IMMEDIATE FUTURE.



2905 Meridian Parkway Durham, NC 27713

phone 919. 361. 5000


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CLIENT

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REVISIONS

NO. DATE

PLAN INFORMATION


PROJECT NO. KDC-20000 FILENAME KDC20000-ASR-LS1.DWG

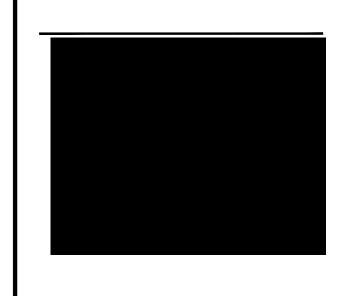CHECKED BY DRAWN BY SCALE AS SHOWN

DATE 04. XX. 2024

SHEET LANDSCAPE DETAILS

AND NOTES

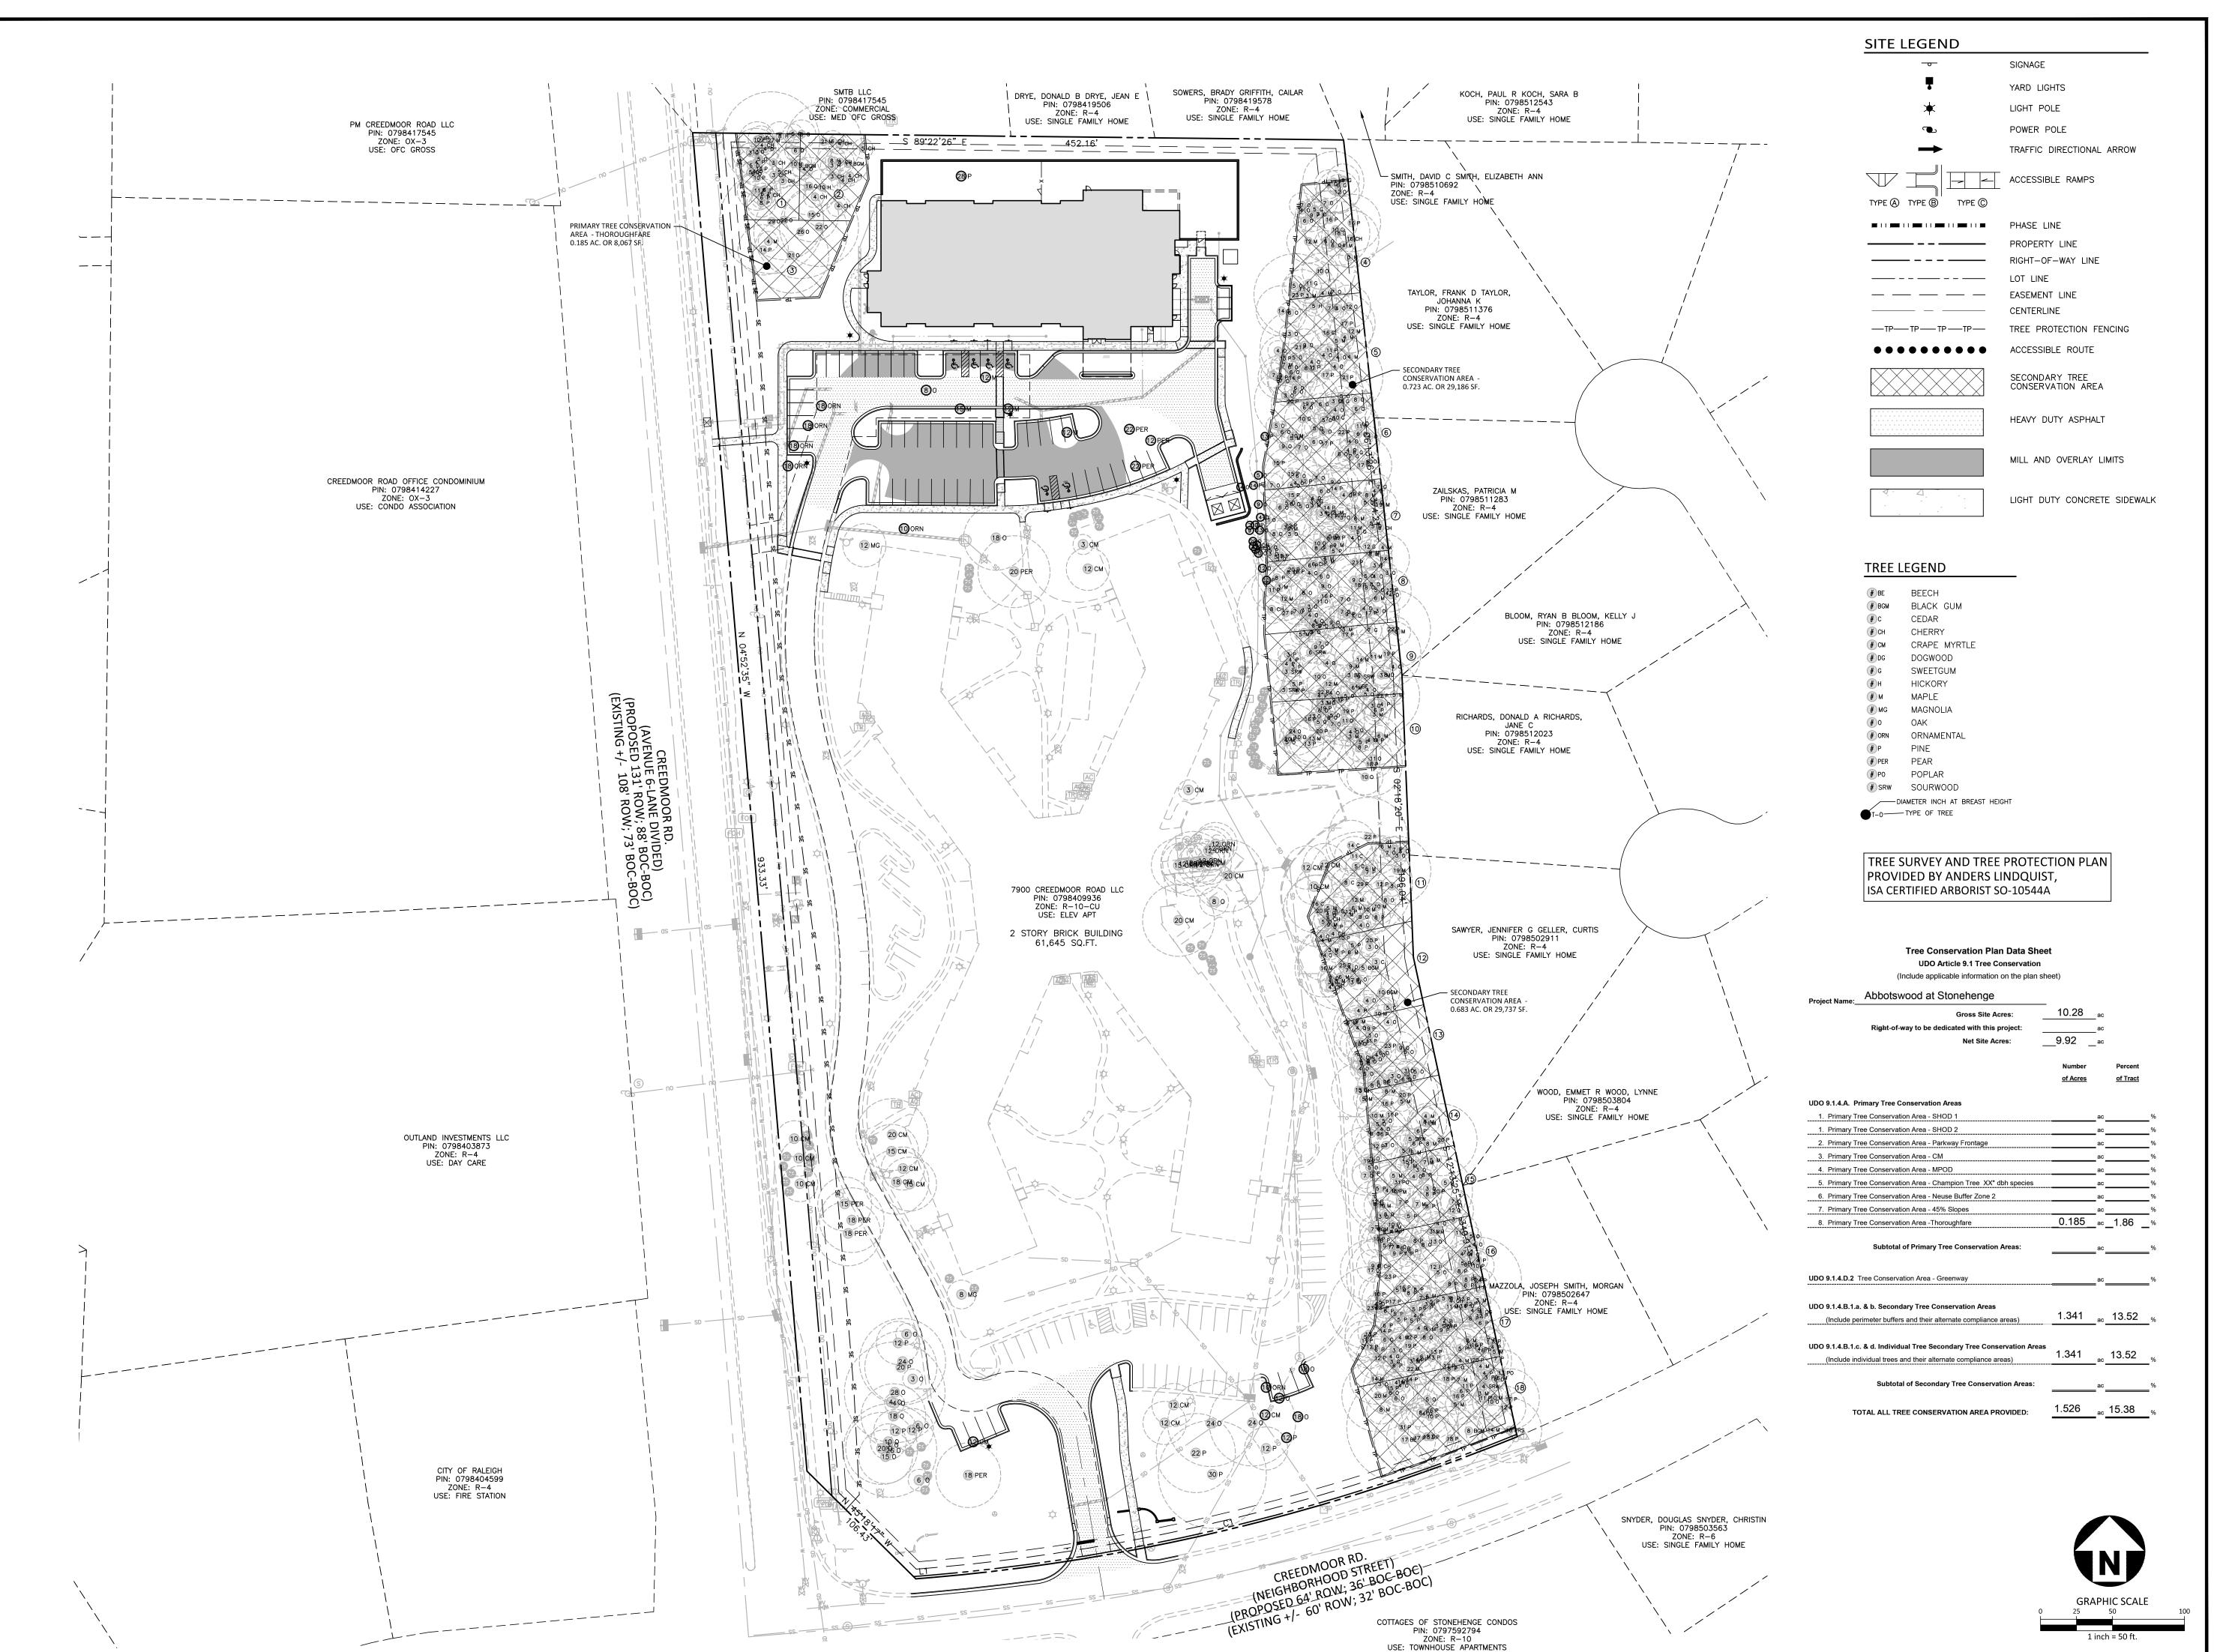



> phone 919. 361. 5000 fax 919. 361. 2269


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CARLSBAD, CALIFORNIA 92008



PLAN INFORMATION

PROJECT NO. KDC-20000 KDC20000-ASR-TC1.DWG FILENAME CHECKED BY

DRAWN BY SCALE 1"=30' DATE 08.05.2024

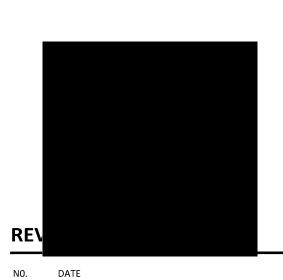PRELIMINARY DRAWING - NOT RELEASED FOR CONSTRUCTION

SHEET **OVERALL TREE CONSERVATION PLAN**

Plot 1	Plot 2	Plot 3	Plot	4	Plot 5		Plot 6	Plot 7	F	Plot 8	Plot 9		Plot 10		Plot 11		Plot 12		Plot 13	Plot 14	Plot 15	Plot 16	Plot 17	Plot 18
2391 SF	2616 SF	3061 SF	31	180 SF	4025 SF		4507 SF	4129 SF		4406 SF	4452		4486 SF		3637 SF		3484 SF		2588 SF	2739 SF	3045 SF	3466 SF	4552 SF	5708 SF
Basal Species DBH Area Species	Basal	Basal DBH Area S	Species DE	Basal BH Area Species		rea Species	Basal DBH Area Species	Basal DBH Area		Basal DBH Area	Species DBH	Basal Area Spe	Basa ecies DBH Area	1	Basa DBH Area	I		asal Irea Species	Basal DBH Area Specie	Basal es DBH Area Species	Basal s DBH Area Species	Basal DBH Area	Basal Species DBH Area	Basal Species DBH Area
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CH 4 0.09 CH CH 3 0.05 CH	6 0.20 O 4 0.09 O	22 2.64 c 21 2.40 c		11 0.66 G 11 0.66 H		0.35 _G	7 0.27 G 6 0.20 G	12 0.7 12 0.7	9 M	12 0.79 3 0.05	G 7	0.27 _M	1 3	.14 C	1 ++1	.66 C .14 C	3	0.05 M 0.14 M	6 0.20 M	8 0.35 _M 6 0.20 _M	7 0.27 M 10 0.55 M	3 0.05	G 3 0.05 G 4 0.09	
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O 5 0.14 CH	4 0.09 4 0.09	N	M	3 0.05 O		0.09 O	6 0.20 M	3 0.0		11 0.66 3 0.05		0.20 O 0.66 O		.14 M .14 M		.27 _M	3	0.05 _O	8 0.35 O 4 0.09 O	3 0.05 M 4 0.09 O	5 0.14 0	8 0.35 4 0.09	'''	M 4 0.09 M 3 0.05
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						Р	12 0.79 P	12 0.7		16 1.40												TOTAL BASAL AREA 21.12	P 12 0.79	PO 13 0.92
							BASAL AREA 23.36 P AREA/ ACRE 225.77 P	14 1.0 14 1.0		17 1.58 18 1.77												BASAL AREA/ ACRE 265.48	P 6 0.20	
						BASA	P P	15 1.2	7 F 3 P	18 1.77												<u>'</u> 	P 5 0.14	TOTAL BASAL AREA 34.37 BASAL AREA/ ACRE 262.30
							Р	15 1.2	3 P	20 2.18													P 4 0.09	
							P P	19 1.9 19 1.9		21 2.40 27 3.97												_	P 8 0.35 P 5 0.14	
							P	5 0.1	4 P	6 0.20													P 13 0.92	
							Р	5 0.1 5 0.1		8 0.35 9 0.44													P 12 0.79 P 13 0.92	
							P	5 0.1	4 TOTAL BA	ASALAREA 28.06												<u> </u> 	P 5 0.14	
								ALBASALAREA 19.5		REA/ACRE 277.45													P 6 0.20	
							BAS	ALAREA/ACRE 188.9	4													<u> </u>	P 6 0.20 P 5 0.14	
																						<u> </u>	P 5 0.14	
																						Ī	P 5 0.14	
																						_	P 9 0.44 P 7 0.27	
																						Ī	P 4 0.09	
																							P 4 0.09	
																						<u> </u>	SRW 3 0.05	
																							TOTAL BASAL AREA 29.42	
																							BASAL AREA/ ACRE 281.49	




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CLIENT

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PLAN INFORMATION

PROJECT NO. KDC-20000 FILENAME KDC20000-ASR-TC1.DWG CHECKED BY JAR

DRAWN BY AAL SCALE

DATE 08.05.2024

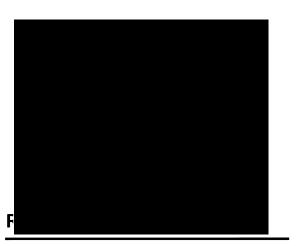SHEET

TREE CONSERVATION CALCULATIONS





SHEET NAME: BUILDING PERSPECTIVE

ORIG SUBMISSION:

A-200 PROGRESS

2024.08.02





ing tonehenge

C1 ELEVATION- EXTERIOR- SOUTH

1/8" = 1'-0"



A1 ELEVATION- EXTERIOR- NORTH

1/8" = 1'-0"

3

SHEET NAME:
BUILDING
ELEVATIONS

ORIG SUBMISSION:

SHEET: **A-201**

PROGRESS

2024.08.02



SENIOR LIVING



SHEET NAME:
BUILDING
ELEVATIONS

ORIG SUBMISSION:

A-202