



# Administrative Approval Action

Case File / Name: ASR-0056-2024  
DSLC- ABBOTTSWOOD AT STONEHENGE

City of Raleigh  
Development Services Department  
One Exchange Plaza  
Raleigh, NC 27602  
(919) 996-2492  
[currentplanning@raleighnc.gov](mailto:currentplanning@raleighnc.gov)  
[www.raleighnc.gov](http://www.raleighnc.gov)

**LOCATION:** The site is located at northeast corner of Creedmoor Road and Morgans Way, specifically at 7900 Creedmoor Rd., PIN 0798409936. The site is currently zoned R-10-CU.

**REQUEST:** The application is requesting an addition to the Congregate Care, Retirement, and Assisted Living Facility to include a new 49-room (47,160 sf) facility. This project will also include changes in surface parking and utilities.

**DESIGN  
ADJUSTMENT(S)/  
ALTERNATES, ETC:** N/A

**FINDINGS:** City Administration finds that this request, with the below conditions of approval being met, conforms to the Unified Development Ordinance. This approval is based on a preliminary plan dated February 19, 2025 by Mcadams.

## **CONDITIONS OF APPROVAL and NEXT STEPS:**

*This document must be applied to the second sheet of all future submittals except for final plats. This is a preliminary plan and as such no permits have been issued with this approval. To obtain permits and/or completion of the project, the following steps are required:*

**SITE PERMITTING REVIEW** - For land disturbance of 12,000 square feet or greater, public or private infrastructure, shared stormwater devices, etc. Site Permitting Review may be submitted upon receipt of this signed approval document.

***The following items are required prior to approval of Site Permitting Review plans:***

### **General**

1. The SPR cannot be approved until a lighting plan meeting the requirements of UDO 7.4 is submitted, reviewed, and approved for compliance.
2. Add a note to the cover sheet stating that the operator will maintain a log in compliance with Z-033-20 Condition #2 that will be made available to City staff upon request.

### **Stormwater**

3. A surety equal to of the cost of clearing, grubbing and reseeding a site, shall be paid to the City (UDO 9.4.4).
4. A nitrogen offset payment must be made to a qualifying mitigation bank (UDO 9.2.2.B).

### **Urban Forestry**

5. Submit a final tree conservation plan that includes metes and bounds descriptions of all tree conservation areas and tree protection fencing as required (UDO 9.1.5).
6. Tree protection fence must be inspected by Urban Forestry staff prior to the issuance of a grading permit.



# Administrative Approval Action

Case File / Name: ASR-0056-2024  
DSLC- ABBOTTSWOOD AT STONEHENGE

City of Raleigh  
Development Services Department  
One Exchange Plaza  
Raleigh, NC 27602  
(919) 996-2492  
[currentplanning@raleighnc.gov](mailto:currentplanning@raleighnc.gov)  
[www.raleighnc.gov](http://www.raleighnc.gov)

7. Submit with the items for review, a copy of the approval from NCDOT regarding the street trees to be planted along Creedmoor Road.

**LEGAL DOCUMENTS** - Email to [legaldocumentreview@raleighnc.gov](mailto:legaldocumentreview@raleighnc.gov). Legal documents must be approved, executed, and recorded prior to or in conjunction with the recorded plat on which the associated easements are shown. Copies of recorded documents must be returned to the City within one business day of recording to avoid withholding of further permit issuance.

<input checked="" type="checkbox"/>	Right of Way Deed of Easement Required
-------------------------------------	--

<input checked="" type="checkbox"/>	Slope Easement Deed of Easement Required
-------------------------------------	--

**RECORDED MAP(S)** - Submit plat to record new property lines, easements, tree conservation areas, etc.). Plats may be submitted for review when the Site Permitting Review plans, if required, have been deemed ready for mylar signature.

***The following items must be approved prior to recording the plat:***

## Engineering

1. A slope easement deed of easement, in addition to a plat showing the location of the easement, shall be submitted to the Planning and Development Services Department for review, and if acceptable, approved for recordation. Approved plats must be recorded at the Wake County Register of Deeds Office on or before the 14th day following approval by the City. The 14-day expiration date shall be clearly indicated on the plat. By the end of the next business day following recordation of the plat, all required legal instruments (including deeds of easement) shall be recorded, and recorded copies of the plat and all legal instruments required by the City in association with development approval shall be provided to the City. (Reference: UDO 8.1.7.A; 10.2.5.F.4.d)
2. A public street right-of-way deed of easement, in addition to a plat showing the location of the easement, shall be submitted to the Planning and Development Services Department for review, and if acceptable, approved for recordation. Approved plats must be recorded at the Wake County Register of Deeds Office on or before the 14th day following approval by the City. The 14-day expiration date shall be clearly indicated on the plat. By the end of the next business day following recordation of the plat, all required legal instruments (including deeds of easement) shall be recorded, and recorded copies of the plat and all legal instruments required by the City in association with development approval shall be provided to the City. (Reference: UDO 8.1.7.A; 10.2.5.F.4.d)

## Public Utilities

3. Site Permit Review plans (SPR) must be approved by the City of Raleigh Public Utilities Department for all public water, public sewer and/or private sewer extensions.

**BUILDING PERMITS** - For buildings and structures shown on the approved plans. Commercial building permit plans must include the signed, approved Site Permitting Review plans attached, if applicable. Permit sets may be reviewed prior to the recordation of required plats, but cannot be approved.



# Administrative Approval Action

Case File / Name: ASR-0056-2024  
DSLC- ABBOTTSWOOD AT STONEHENGE

City of Raleigh  
Development Services Department  
One Exchange Plaza  
Raleigh, NC 27602  
(919) 996-2492  
[currentplanning@raleighnc.gov](mailto:currentplanning@raleighnc.gov)  
[www.raleighnc.gov](http://www.raleighnc.gov)

***The following items must be approved prior to the issuance of building permits:***

## General

1. Retaining wall permits shall be reviewed and approved prior to the issuance of building permits.

## Engineering

2. A public infrastructure surety shall be provided to City of Raleigh Transportation – Development Engineering Division (UDO 8.1.3) in the amount of 100% of the improvement cost for the NCDOT portion and 125% of the improvement cost for the City of Raleigh infrastructure.
3. A fee-in-lieu for shortage of streetscape along Creedmoor Rd shall be paid to the City of Raleigh (UDO 8.1.10).

## Public Utilities

4. A plat must be recorded at the Wake County Register of Deeds office for all utility easement dedications.

## Stormwater

5. A surety equal to 125% of the cost of the construction of a stormwater device shall be paid to the Engineering Services Department (UDO 9.2.2.D.1.d).
6. All stormwater control measures and means of transporting stormwater runoff to and from any nitrogen and stormwater runoff control measures shall be shown on all plats for recording as private drainage easements (UDO 9.2).

## Urban Forestry

7. A public infrastructure surety for 43 street trees shall be provided to City of Raleigh Transportation – Development Engineering Division (UDO 8.1.3) in the amount of 100% of the improvement cost for the NCDOT portion, and a public infrastructure surety for 11 street trees shall be provided in the amount of 125% of the improvement cost for the City of Raleigh infrastructure.
8. A tree conservation plat shall be recorded with metes and bounds showing the designated tree conservation areas (UDO 9.1). This development proposes 1.521 acres of tree conservation area
9. A tree impact permit must be obtained for the approved streetscape tree installation in the right of way. This development proposes 43 street trees along Creedmoor Road and 11 street trees along Morgans Way for a total of 54 street trees.

***The following are required prior to issuance of building occupancy permit:***

## General



# Administrative Approval Action

Case File / Name: ASR-0056-2024  
DSLC- ABBOTTSWOOD AT STONEHENGE

City of Raleigh  
Development Services Department  
One Exchange Plaza  
Raleigh, NC 27602  
(919) 996-2492  
[currentplanning@raleighnc.gov](mailto:currentplanning@raleighnc.gov)  
[www.raleighnc.gov](http://www.raleighnc.gov)

1. All mechanical equipment shall be screened from view per UDO 7.2.5.D
2. Final inspection of all tree conservation areas and rights-of-way street trees by Urban Forestry Sta

## Stormwater

3. As-built impervious survey is accepted by the Engineering Services Department (UDO 9.2).
4. As-built drawings and associated forms for all Stormwater devices are accepted by the Engineering Services Department (UDO 9.2.2.D.3).

**EXPIRATION DATES:** The expiration provisions of UDO Section 10.2.8 E, including the ability to request extensions in the expiration date, apply to this site plan. If significant construction has not taken place on a project after administrative site review approval, that approval may expire and be declared void, requiring re-approval before permits may be issued. To avoid allowing this plan approval to expire the following must take place by the following dates:

**3-Year Expiration Date:** April 3, 2028

Obtain a valid building permit for the total area of the project, or a phase of the project.

**4-Year Completion Date:**

Within four years after issuance of the first building permit for the site plan, the construction of the entire site plan must be completed unless an applicant has been granted vested rights. Failure to complete construction within this specified time frame shall automatically void the approved site plan for which no building permits have been issued.

I hereby certify this administrative decision.

Signed: Keegan McDonald Date: 04/03/2025

Digitally signed by Keegan.McDonald@raleighnc.gov  
Reason: I am approving this document  
Date: 2025.04.09 13:59:44-04'00'

Development Services Dir/Designee

Staff Coordinator: Jeff Caines



MCADAMS

The John R. McAdams Company, Inc.  
621 Hillsborough Street  
Suite 500  
Raleigh, NC 27603  
phone: 919.561.5000  
fax: 919.561.2269  
license number: C-0293-C-187  
[www.mcadamsco.com](http://www.mcadamsco.com)

#### CONTACT

JONATHAN BALDERSON  
MCADAMS  
[balderson@mcadamsco.com](mailto:balderson@mcadamsco.com)  
PHONE: 919.287.0815

#### CLIENT

KISCO SENIOR LIVING  
GABE LEGASPI  
5790 FLEET STREET  
SUITE 300  
CAROLINA, CA 92008  
760-804-7095

#### PROJECT DIRECTORY

#### SHEET INDEX

C0.00	PROJECT NOTES
C1.00	EXISTING CONDITIONS PLAN
C1.01	DEMOLITION PLAN
C2.00	OVERALL SITE PLAN
C2.01	DETAILED SITE PLAN - AREA A
C2.02	DETAILED SITE PLAN - AREA B
C3.00	OVERALL GRADING AND STORM DRAINAGE PLAN
C3.01	DETAILED GRADING PLAN - AREA A
C3.02	DETAILED GRADING PLAN - AREA B
C4.00	OVERALL UTILITY PLAN
C4.01	DETAILED UTILITY PLAN - AREA A
C4.02	DETAILED UTILITY PLAN - AREA B
C8.00	SITE DETAILS
C8.01	SITE DETAILS
C8.02	WATER DETAILS
C8.03	WATER DETAILS
C8.04	STORM DRAINAGE DETAILS
C8.05	SANITARY SEWER DETAILS
C9.00	SCM "A" PLAN VIEW AND DETAILS
C9.01	SCM DETAILS
L5.00	OVERALL LANDSCAPE PLAN
L5.01	DETAILED LANDSCAPE PLAN
L5.02	DETAILED LANDSCAPE PLAN
L5.03	LANDSCAPE NOTES AND DETAILS
L8.00	TREE CONSERVATION PLAN
L8.01	TREE CONSERVATION CALCULATIONS

#### FROM OTHERS

A050	TRASH ENCLOSURE PLAN
A101	FLOOR PLAN LEVEL 1
A102	FLOOR PLAN LEVEL 2
A103	FLOOR PLAN LEVEL 3
A200	BUILDING PERSPECTIVES
A201	BUILDING ELEVATIONS
A202	BUILDING ELEVATIONS



VICINITY MAP

N.T.S.

#### ATTENTION CONTRACTORS

The Contractor responsible for the extension of water, sewer, and/or reuse, as approved in these plans, is responsible for contacting the Infrastructure Inspection Division and schedule a pre-construction inspection. Raleigh Water must be contacted at (919) 561-4540 at least twenty-four hours prior to beginning any work. If the contractor fails to contact Raleigh Water or fails to notify City Departments in advance of beginning construction, will result in the issuance of monetary fines, and require reinstallation of the facility at the contractor's expense. Failure to call for inspection, install a temporary water connection, or place signs on the job site, or any other violation of City of Raleigh Stormwater Management Plan and possible exclusion from future work in the City of Raleigh.

ALL CONSTRUCTION SHALL CONFORM WITH THE LATEST VERSION OF THE CITY OF RALEIGH AND NC DOT STANDARDS, SPECIFICATIONS AND DETAILS.

PRELIMINARY DRAWING - NOT RELEASED FOR CONSTRUCTION

No. Date  
1 10-31-2024 REVISED PER 1st ASR COMMENTS  
2 12-04-2024 REVISED PER 2nd ASR COMMENTS  
3 02-19-2025 REVISED PER 3rd ASR COMMENTS

#### ADMINISTRATIVE SITE REVIEW

ABBOTTSWOOD  
AT STONEHENGE  
RALEIGH, NORTH CAROLINA  
PROJECT NUMBER: KDC-20000

# ABBOTTSWOOD AT STONEHENGE

## Administrative Site Review Application

Planning and Development Customer Service Center • One Exchange Plaza, Suite 4001 • Raleigh, NC 27601 • 919.561.2500



This form is required when submitting site plans as referenced in the Unified Development Ordinance (UDO) Section 10.2.B. Please check the appropriate building types and include the plan checklist document when submitting.

**Office Use Only: Case #:**  Planner (initial)

Please review UDO Section 10.2.B. to determine the Site Plan tier. If a determination is made that a Site Plan Tier is needed a Site Plan Tier Application request can be submitted online via the [Permit and Development Portal](#). (Note: There is a fee associated with this service.)

**Site Plan Tier:**  Tier Two Site Plan  Tier Three Site Plan

**Building and Development Type** (Check all that apply)

Detached	<input type="checkbox"/> General	Subdivision
Attached	<input type="checkbox"/> Mixed Use	Business Park Case #:
House	<input type="checkbox"/> Residential	Certificate of Appropriateness #:
Apartment	<input checked="" type="checkbox"/> Cottage Court	Board of Adjustment #:
Tiny house	<input type="checkbox"/> Frequent Transit	Zoning Case # Z-2022
Open lot	<input type="checkbox"/> Development Option	Design Alternative #:

### GENERAL INFORMATION

Development name: Abbottswood at Stonehenge

Inside City Limits? Yes  No

Property address(es): 7900 Creedmoor Road

Site P.I.N. (s): 0798409936

Please describe the scope of work. Include any additions, expansions, and uses (UDO 6.1.4).

Addition of residential congregate care building, supporting surface parking, and utilities.

Current Property Owner(s): KISCO SENIOR LIVING

Title: OWNER

Address: 5790 FLEET STREET

Phone # 750-404-7096 Email:

Applicant Name (If different from owner. See "who can apply" in instructions): Jonathan Balderson

Relationship to owner:  Lessee or contract purchaser  Owner's authorized agent  Easement holder

Company: McAdams Address: 621 Hillsborough St, Suite 500, Raleigh NC 27603

Responsible Person (R.P.): [jeff.caines@raleighnc.gov](mailto:jeff.caines@raleighnc.gov)

Phone #: NOTE: please attach agreement or contract, lease or easement when submitting this form.

Developer Contact: GABE LEGASPI

Company: KISCO SENIOR LIVING Title: OWNER

Address: 5790 FLEET STREET

Phone # 750-404-7096 Email:

Applicant Name: Jonathan Balderson

Address: 621 Hillsborough St, Suite 500, Raleigh NC 27603

Phone # 919.297.0815 Email: [balderson@mcadamsco.com](mailto:balderson@mcadamsco.com)

### DEVELOPMENT TYPE + SITE DATA TABLE

(Applicable to all developments)

SITE DATA	BUILDING DATA
Zoning district(s) (please provide the acreage of each):	Existing gross floor area (not to be demolished): 0
R-10-CU	Proposed gross floor area to be demolished: 0
Gross site acreage: 0	Existing gross floor area to be demolished: 0
# of parking spaces proposed: 58	New gross floor area: 47,160
Max # of parking permitted (Z-1.2.C): No Max	Total gross (to remain and) new: 47,160
Overlay District (if applicable): n/a	Proposed # of buildings: 1
Existing use (UDO 6.1.4): Congregate Care Retail	Proposed # of stores for each: 3
Proposed use (UDO 6.1.4): Congregate Care Retail	Proposed # of basement levels (UDO 6.7.A.6) 0

### STORMWATER INFORMATION

Impervious Area on Parcel(s): Impervious Area for Compliance (includes ROW)

Existing (sf) 151395 Proposed total (sf) 199440

Existing (sf) 153367 Proposed total (sf) 201396

### RESIDENTIAL & OVERNIGHT LODGING

Pursuant to state law (N.C. Gen. Stat. § 160D-403(a)), applications may be made by the developer or landowner holding an option or contract to purchase or lease land, or an authorized agent of the landowner. An easement holder may also apply for development approval for such development as is authorized by the easement.

Acting as an authorized agent requires written permission from the property owner for the purposes of making an application for development approval. An easement holder may also apply for development approval as an authorized agent must be made available to the City of Raleigh upon request.

By submitting this application, the undersigned applicant acknowledges that they are either the property owner or the developer or landowner holding an option or contract to purchase or lease land, or an authorized agent of the landowner. The undersigned understands that development approvals are subject to revocation if the developer or landowner makes any false statement or misrepresentation made in securing the development approval pursuant to N.C. Gen. Stat. § 160D-403(f).

The undersigned indicates that the property owner(s) is aware of this application and that the proposed project is in accordance with the applicable zoning and building codes. The undersigned further certifies that the application is being submitted in good faith and that no false statements or misrepresentations have been made in the application. The undersigned further certifies that the property owner(s) has been advised of the time limit for responding to comments or providing additional information requested by the City for a period of six months or more or, if the application is resubmitted to the City, for a period of three months or more, after the application is returned. The undersigned further certifies that the application is in accordance with the provisions and regulations of the City of Raleigh Unified Development Ordinance.

The undersigned hereby acknowledges that pursuant to state law (N.C.G.S. 160D-750.1) if this permit application is denied, the developer or landowner holding an option or contract to purchase or lease land, or an authorized agent of the landowner, may file a petition for review of the denial with the North Carolina State Board of Equalization and Review within 30 days of the denial.

Signature:  Date:

Signature:  Date:

Printed Name:



CONTRACTOR SHALL NOTIFY "NC811" (811) OR (1-800-632-4949) AT LEAST 3 FULL BUSINESS DAYS PRIOR TO BEGINNING CONSTRUCTION FOR EXCAVATION WORKS LOCATED ON THE PROPERTY. LOCATOR SERVICES INDEPENDENT OF "NC811", REPORT ANY DISCREPANCIES TO THE ENGINEER IMMEDIATELY.

NOTES

1. THE MINIMUM CORNER CLEARANCE FOR A DRIVEWAY FROM THE CURB LINE OF INTERSECTING STREETS SHOULD BE AT LEAST 20 FEET FROM THE POINT OF TAKING THE TURN. NO DRIVEWAYS SHALL ENCROACH ON THE MINIMUM CORNER CLEARANCE REQUIREMENT SECTION 2.2.D.

2. WITHIN THE AREA OF A DEFINED SIGHT TRIANGLE, THERE SHALL BE NO SIGHT OBSTRUCTING OR PARTLY OBSTRUCTING WALL, FENCE, SIGN, FOGLAGE, BERMING OR PARKED VEHICLES BETWEEN THE HEIGHTS OF TWENTY-FOUR (24) INCHES AND EIGHT (8) FEET ABOVE THE CURB ELEVATION OR THE NEAREST TRAVELED WAY, IF NO CURBING EXISTS.

Duly signed by  
Jeff Caines  
DN: jeff.caines@raleighnc.gov  
Email: [jeff.caines@raleighnc.gov](mailto:jeff.caines@raleighnc.gov)  
Reason I am approving this  
Date: 2/25/2024  
10:37:53-04'00'

### SOLID WASTE INSPECTION STATEMENT:

1. THE DEVELOPER ACKNOWLEDGES THAT THEY HAVE REVIEWED AND ARE IN COMPLIANCE WITH THE REQUIREMENTS SET FORTH IN THE SOLID WASTE DESIGN MANUAL.

2. THE SOLID WASTE REMOVAL FOR THIS PROJECT WILL BE HANDLED BY PRIVATE SERVICES. THE CITY OF RALEIGH SOLID WASTE SERVICES (SWS) WILL NOT SERVICE THIS DESIGN.

NOTES

1. THE MINIMUM CORNER CLEARANCE FOR A DRIVEWAY FROM THE CURB LINE OF INTERSECTING STREETS SHOULD BE AT LEAST 20 FEET FROM THE POINT OF TAKING THE TURN. NO DRIVEWAYS SHALL ENCROACH ON THE MINIMUM CORNER CLEARANCE REQUIREMENT SECTION 2.2.D.

2. WITHIN THE AREA OF A DEFINED SIGHT TRIANGLE, THERE SHALL BE NO SIGHT OBSTRUCTING OR PARTLY OBSTRUCTING WALL, FENCE, SIGN, FOGLAGE, BERMING OR PARKED VEHICLES BETWEEN THE HEIGHTS OF TWENTY-FOUR (24) INCHES AND EIGHT (8) FEET ABOVE THE CURB ELEVATION OR THE NEAREST TRAVELED WAY, IF NO CURBING EXISTS.

ALL CONSTRUCTION SHALL CONFORM WITH THE LATEST VERSION OF THE CITY OF RALEIGH AND NC DOT STANDARDS, SPECIFICATIONS AND DETAILS.

PRELIMINARY DRAWING - NOT RELEASED FOR CONSTRUCTION



**MCADAMS**

The John R. McAdams Company, Inc.  
2905 Meridian Parkway  
Durham, NC 27713

phone 919.361.5000  
fax 919.361.3206  
license number: C-2929 C-187

www.mcadamsco.com

#### CLIENT

MCR JOE WHITEHOUSE  
KNSCO OWNER LIVING  
5270 FLEET STREET, SUITE 300  
CALIFORNIA, 92908

## ABBOTTSWOOD AT STONEHENGE ADMINISTRATIVE SITE REVIEW ASR-0056-2024

7900 CREEDMOOR ROAD  
RALEIGH, NORTH CAROLINA, 27613

#### SITE PLAN NOTES

- NON-ALLEY LOADED DRIVENWAYS MAY INTERSECT A STREET NO CLOSER THAN 20 FEET FROM THE INTERSECTION OF TWO STREET RIGHT-OF-WAYS. THE MINIMUM CORNER CLEARANCE FROM CURB LINE OR EDGE OF PAVEMENT OF INTERSECTING STREETS SHALL BE AT LEAST 10 FEET. THE MINIMUM CORNER CLEARANCE FROM CURB LINE OR EDGE OF PAVEMENT OF THE RIGHT-OF-WAY LINES, WHICH EVER IS GREATER, THE RADIUS OF THE DRIVEWAY SHALL NOT ENCROACH ON THE MINIMUM CORNER CLEARANCE. REFER TO SECTION 6.5 OF THE LATEST VERSION OF THE RALEIGH STREET DESIGN MANUAL FOR ADDITIONAL DETAILS.
- RIGHT-OF-WAY SHALL BE CLEARED AND GRADED WITHIN 50' OF ALL MINOR RESIDENTIAL, RESIDENTIAL, AND RESIDENTIAL COLLECTOR INTERSECTIONS. THE FULL LENGTH OF THE RIGHT-OF-WAY SHALL BE CLEARED AND GRADED ALONG ALL MAJOR, MINOR, & SICKLEBERRY STREETS.
- WITHOUT A DEDICATED SIGN TRAVERSING SHOWN IN THESE PLANS, THERE SHALL BE NO SIGN OBSTRUCTING OR PARTLY OBSTRUCTING WALL, FENCE, SIGN, FOULAGE BIRDS, OR PARKED VEHICLES BETWEEN THE HEIGHTS OF 24 INCHES AND 8 FEET ABOVE THE CURB LINE ELEVATION OF THE NEAREST SIDEWALK. IF NO SIDEWALK EXISTS, REFER TO SECTION 6.12 OF THE LATEST VERSION OF THE RALEIGH STREET DESIGN MANUAL FOR ADDITIONAL DETAILS.
- MULTIWAY STOP CONTROL WILL NOT BE USED AT ANY PUBLIC STREET INTERSECTION WITHOUT AN ENGINEERING STUDY TO PROVIDE DATA TO CITY OF RALEIGH TRANSPORTATION DIVISION THAT THE MULTIWAY STOP INSTALLATION WARRANTS CAN BE MET. REFER TO SECTION 6.12 OF THE LATEST CITY OF RALEIGH AND/OR NCDOT STANDARDS AND SPECIFICATIONS AS APPLICABLE.
- ALL DIMENSIONS SHOWN ON SITE PLAN ARE FOR FACE OF CURB UNLESS OTHERWISE NOTED.
- CONTRACTOR SHALL MAINTAIN AN IS-BUILT SET OF DRAWINGS TO RECORD THE EXACT LOCATION OF ALL PIPING PRIOR TO CONCEALMENT; DRAWINGS SHALL BE GIVEN TO THE ENGINEER UPON COMPLETION OF THE PROJECT WITH A COPY OF THE TRANSMITTER LETTER TO THE OWNER.
- EXISTING UTILITIES DURING CONSTRUCTION SHALL BE RELOCATED/PREFERRED TO THEIR ORIGINAL CONDITION AND TO THE SATISFACTION OF THE OWNER, OR THE CONTRACTOR RESPONSIBLE FOR THE DAMAGE.
- THE CONTRACTOR SHALL NOT: THAT THE DRAWINGS MAY NOT SHOW EVERY OFFSET, TRANSITION, FITTING, ETC. THAT MAY BE REQUIRED; THE CONTRACTOR SHALL INSTALL SUCH STANDARD APERTURES AS REQUIRED TO CLOSELY FOLLOW THE GRADES AND ALIGNMENTS OF THE PLANS.
- CONTRACTOR SHALL NOTIFY (811) (1-800-632-4849) AT LEAST 3 FULL BUSINESS DAYS PRIOR TO BEGINNING CONSTRUCTION ON EXCAVATIONS TO HAVE EXISTING UTILITIES LOCATED. CONTRACTOR SHALL CONTACT ANY LOCAL UTILITIES THAT PROVIDE THEIR OWN LOCATOR SERVICES INDEPENDENT OF "NCCB1". REPORT ANY DISCREPANCIES TO THE ENGINEER IMMEDIATELY.
- CONTRACTOR IS RESPONSIBLE FOR COORDINATING CONSTRUCTION ACTIVITIES WITH THE APPROPRIATE UTILITY COMPANIES FOR ANY REQUIRED RELOCATIONS (I.E. POWER, POLICE, PEDESTRIALS, WATER METERS, ETC.).
- PRIOR TO BEGINNING CONSTRUCTION BEYOND ERISON CONTROL MEASURES, THE GENERAL CONTRACTOR SHALL SCHEDULE AND ATTEND A PRE-CONSTRUCTION CONFERENCE WITH THE CITY OF RALEIGH WATER & SEWER DEPARTMENT (919-961-2409), AND THE ERISON CONTROL CONTRACTOR (919-961-2409) TO REVIEW THE REQUIREMENTS TO FOLLOW THE ERISON CONTROLS OF THE PLAN AND OPERATION OF THE UTILITIES DURING CONSTRUCTION.
- ALL DIMENSIONS AND GRADES SHOWN ON THE PLANS SHALL BE FIELD VERIFIED BY THE CONTRACTOR PRIOR TO CONSTRUCTION. IF ANY DISCREPANCY IS FOUND, THE CONTRACTOR SHALL MAKE A REVISION TO THE DRAWING. IF NO REVISION IS MADE, FOR NECESSARY PLAN OR GRADE CHANGES, NO EXTRA COMPENSATION SHALL BE PAID TO CONTRACTOR FOR ANY WORK DONE DUE TO DIMENSIONS OR GRADES SHOWN INCORRECTLY ON THESE PLANS IF SUCH NOTIFICATION HAS NOT BEEN GIVEN.
- ACCESSION RAMPS SHALL BE CONSTRUCTED IN ACCORDANCE WITH THE CITY OF RALEIGH UNIFIED DEVELOPMENT ORDINANCE.
- ALL SIDEWALKS THAT CONNECT TO THE PUBLIC RIGHT-OF-WAY MUST BE ACCESSIBLE TO PERSONS WHO ARE BLIND, HAVE LOW VISION AND PEOPLE WITH MOBILITY DISABILITIES. PEDESTRIAN ROUTES AND ALTERNATE PEDESTRIAN ROUTES DURING CONSTRUCTION ARE REQUIRED. REFER TO THE CITY OF RALEIGH PEDESTRIAN ROUTE DESIGN AND WALKABILITY (PROWAD), 2010 ADA STANDARDS FOR ACCESSIBLE DESIGN AND THE MANUAL ON UNIFORM TRAFFIC CONTROLS (UTCS) FOR MORE INFORMATION.
- TYPIICAL PAVEMENT SECTION DETAILS ARE SHOWN WITHIN THIS SET AND INTENDED TO BE A MINIMUM PAVEMENT SECTION REQUIREMENT. THE CURRENT GEOTECHNICAL REPORT SHALL OVER-IDE ALL TYPICAL PAVEMENT SECTIONS SHOWN, IF THE CONTRACTOR HAS ANY QUESTIONS, REFER TO THE GEOTECHNICAL REPORT.
- EQUIPMENT AND PRODUCTS OTHER THAN THOSE SPECIFIED MAY BE USED PROVIDED APPROVAL HAS BEEN OBTAINED FROM THE OWNER IN WRITING PRIOR TO ORDERING OR INSTALLATION. THE CONTRACTOR SHALL WAIVE ANY CLAIM FOR ADDITIONAL COST RELATED TO SUBSTITUTION OF ALTERNATE EQUIPMENT.
- IF UNFORESEEN CONDITIONS DEVELOP DURING CONSTRUCTION, REFER TO THE LATEST VERSION OF THE RALEIGH STREET DESIGN MANUAL AND CONTACT PUBLIC WORKS STAFF FOR FURTHER GUIDANCE.
- ALL SIGNAGE ASSOCIATED WITH THE PUBLIC STREET SYSTEM SHALL ADHERE TO MUTED STANDARDS AND SPECIFICATIONS.
- ANY TRANSIT STOP LOCATIONS SHOWN ARE PRELIMINARY ONLY. FINAL LOCATION SHALL BE DETERMINED ONCE THE CITY OF RALEIGH TRANSIT ROUTE HAS BEEN FINALIZED. ALL TRANSIT STOPS SHALL HAVE A 100'X10' 3000# CONCRETE PAD.

#### DEMOLITION NOTES

- ALL MATERIAL TO BE DEMOLISHED SHALL BE REMOVED FROM THE SITE AND DISPOSED OF AT A PERMITTED SITE IN ACCORDANCE WITH ALL LOCAL, STATE AND FEDERAL LAWS.
- COMPLY WITH REQUIREMENTS FOR FIRE SAFETY DURING CONSTRUCTION AND DEMOLITION (CHAPTER 14, 2018 NC FIRE CODE, NFPA 241 AND CHAPTER 33, 2018 NC BUILDING CODE).

#### RETAINING WALL NOTES

- THE RETAINING WALL ALIGNMENT SHOWN ON THESE PLANS DEPENDS THE LOCATION OF THE FRONT FACE OF THE RETAINING WALL AT THE BOTTOM OF THE WALL. THE CONTRACTOR IS RESPONSIBLE FOR ENSURING RETAINING WALLS ARE NOT LOCATED IN AREA WHERE THE FRONT FACE OF THE WALL IS LOCATED IN AN ADJACENT PROPERTY UNLESS THE CONTRACTOR INCORPORATES IN THE DESIGN OF THE WALL.
- RETAINING WALLS ARE TO BE DESIGN-BUILD PROJECTS BY THE CONTRACTOR. IT SHALL BE THE CONTRACTOR'S RESPONSIBILITY TO OBTAIN FINAL CONSTRUCTION DRAWINGS FROM A REGISTERED ENGINEER AND GATHER ANY APPROPRIATE PERMITS DUE TO THE DESIGN OF THE WALL.
- RETAINING WALLS SHALL BE ASSOCIATED TO BACKFILLED WITH OFF-SITE BORROW MATERIAL OR PROCESSED FILL, UNLESS THE CONTRACTOR CAN PROVIDE TO THE OWNER WITH CONFIRMATION FROM THE GEOTECHNICAL ENGINEER AND THE RETAINING WALL DESIGNER, THAT READY-MIX CONCRETE CAN BE USED.
- THE CONTRACTOR SHALL NOT USE WALL SELECTIONS SHOWN ON THESE PLANS TO IDENTIFY FINISHED GRADE ELEMENTS ONLY. THE EXTENT THAT THE RETAINING WALL WILL BE EXTENDED BELOW GRADE TO THE FOOTING OR ABOVE GRADE TO THE TOP OF THE BLOCK COURSE SHALL BE IDENTIFIED ON THE RETAINING WALL CONSTRUCTION DRAWINGS.
- ALL RETAINING WALLS OVER 8' HIGH SHALL HAVE A SAFETY FENCE (DESIGN BY OTHER).
- ANY PART OF ANY RETAINING WALL THAT EXTENDS INTO THE RIGHT-OF-WAY WILL REQUIRE AN ENCROACHMENT AGREEMENT. ENCROACHMENT AGREEMENTS FOR RETAINING WALLS SHALL BE APPROVED PRIOR TO CONSTRUCTION DRAWING APPROVAL.
- ANY TIEBACK SYSTEMS FOR RETAINING WALLS SHALL NOT BE ALLOWED WITHOUT PUBLIC RIGHT-OF-WAY.
- STORMWATER RUN-OFF SHALL BE DIRECTED AWAY FROM RETAINING WALLS, ANY RUN-OFF FLOWING TO AND OVER A RETAINING WALL SHALL BE LEFT TO THE ABSOLUTE MINIMUM AND BROUGHT TO THE ATTENTION OF THE WALL DESIGNER PRIOR TO THEIR DESIGN.

#### GRADING NOTES

- ALL DIMENSIONS AND GRADES SHOWN ON THE PLANS SHALL BE FIELD VERIFIED BY THE CONTRACTOR PRIOR TO CONSTRUCTION. IF ANY DISCREPANCY IS FOUND, THE ENGINEER OR PAY DISCREPANCY FIRST NOTIFICATION TO PROCEED WITH CONSTRUCTION, FOR NECESSARY PLAN OR GRADE CHANGES. NO EXTRA COMPENSATION SHALL BE PAID TO THE CONTRACTOR FOR ANY WORK DONE DUE TO DIMENSIONS OR GRADES SHOWN INCORRECTLY ON THESE PLANS IF SUCH NOTIFICATION HAS NOT BEEN GIVEN.
- OCCUPATIONAL SAFETY AND HEALTH ADMINISTRATION (OSHA) STANDARDS FOR EXCAVATIONS, FINAL RULE 29CFR PART 1526, PROVIDED BY THE CONTRACTOR. CONTRACTOR SHALL NOT EXCAVATE IN EXISTING UTILITIES, IN PAVING, IN EXISTING SIDEWALKS, OR IN EXISTING SIDEWALKS IN DEPTHS REQUIRES THE DESIGN OF A TRENCH SAFETY SYSTEM BY A REGISTERED PROFESSIONAL ENGINEER, PROVIDED BY CONTRACTOR RESPONSIBLE FOR EXCAVATION.
- ALL CONSTRUCTION SHALL BE IN ACCORDANCE WITH THE CITY OF RALEIGH AND/OR NCDOT STANDARDS AND SPECIFICATIONS AS APPLICABLE.
- CONTRACTOR SHALL NOTIFY (811) (1-800-632-4849) AT LEAST 3 FULL BUSINESS DAYS PRIOR TO BEGINNING CONSTRUCTION OR EXCAVATION TO HAVE EXISTING UTILITIES LOCATED. CONTRACTOR SHALL CONTACT ANY LOCAL UTILITIES THAT PROVIDE THEIR OWN LOCATOR SERVICES INDEPENDENT OF "NCCB1". REPORT ANY DISCREPANCIES TO THE ENGINEER IMMEDIATELY.
- PRIOR TO BEGINNING CONSTRUCTION, THE GENERAL CONTRACTOR SHALL SCHEDULE AND ATTEND A PRE-CONSTRUCTION CONFERENCE WITH THE CITY OF RALEIGH STORMWATER AND EROSION CONTROL DEPARTMENT, THE ENGINEER AND A REPRESENTATIVE OF THE CITY OF RALEIGH EROSION CONTROL INSPECTOR.
- EXISTING UTILITIES AND STRUCTURES SHOWN, BOTH UNDERGROUND AND ABOVE GROUND, ARE BASED ON A FIELD SURVEY AND PERTINENT TO THE DATE OF THE SURVEY. ANY CHANGES IN EXISTING UTILITIES OR STRUCTURES PRIOR TO BEGINNING RELATED CONSTRUCTION, ANY DISCREPANCY SHALL BE REPORTED TO THE ENGINEER IMMEDIATELY.
- SOIL UNDER BUILDINGS, PAVED AREAS AND WITHIN SLOPES GREATER THAN 3:1 (H:V) SHALL BE APPROVED, PLACED AND COMPACTED AS RECOMMENDED BY THE GEOTECHNICAL ENGINEER.

#### CITY OF RALEIGH PUBLIC UTILITIES STANDARD UTILITIES NOTES (AS APPLICABLE)

STANDARD UTILITIES NOTES  
1. ALL UTILITIES CONSTRUCTION METHODS SHALL BE IN ACCORDANCE WITH CITY OF RALEIGH DESIGN STANDARDS, DETAILS & SPECIFICATIONS (REFERENCE: CORPID HANDBOOK, CURRENT EDITION)  
2. UTILITY SEPARATION REQUIREMENTS  
A) A DISTANCE OF 100' SHALL BE MAINTAINED BETWEEN SANITARY SEWER & ANY PRIVATE OR PUBLIC WATER SUPPLY DODGE. IF THIS DISTANCE IS NOT POSSIBLE, THE MINIMUM HORIZONTAL SEPARATION SHALL BE 20'. IF THIS SEPARATION CANNOT BE ACHIEVED, FERROUS SANITARY SEWER PIPE SHALL BE SPECIFIED & INSTALLED TO WATERLINE SPECIFICATIONS. HOWEVER, THE CONTRACTOR MAY REQUEST APPROVAL FOR A LESS THAN 100' SEPARATION DISTANCE FROM A PUBLICWELL.  
B) WHEN INSTALLING WATER & SEWER DUCTILE IRON PIPE, THE VARIATION ALLOWED IS THE WATER MAIN IN A SEPARATE TRENCH WITH THE ELEVATION OF THE WATER MAIN AT LEAST 18" ABOVE THE TOP OF THE SEWER & 6" ABOVE THE TOP OF THE DUCTILE IRON PIPE. THE CONTRACTOR SHALL NOT EXCAVATE THE DUCTILE IRON PIPE TOWARD OUTSIDE DIAMETER.  
C) TO AVOID CONSTRUCTION DELAYS, TO OBTAIN PROPER SEPARATION, OR ANTICIPATE A SANITARY SEWER PASSES OVER A WATERMAIN, DIP MATERIAL OR STEEL ENCASMENT EXTENDED 10' ON EACH SIDE OF CROSSING MUST BE SPECIFIED & INSTALLED  
D) 0.5' MINIMUM HORIZONTAL SEPARATION IS REQUIRED ON ALL SANITARY SEWER & STORM SEWER FACILITIES, UNLESS DIP WATER TAP IS PROVIDED BY A SANITARY SEWER.  
E) DIP WATER TAPS ARE TO BE PROVIDED ON ALL SANITARY SEWER & RCP STORM DRAIN CROSSINGS; MAINTAIN 18" MIN. VERTICAL SEPARATION AT ALL SANITARY SEWER & RCP STORM DRAIN CROSSINGS, WHERE APPROPRIATE.  
F) ALL OTHER UNDERGROUND UTILITIES SHALL CROSS WATER & SEWER FACILITIES WITH 18" MIN. VERTICAL SEPARATION PER CORPID HANDBOOK.

3. ANY NEW/FUTURE UTILITIES ARE SUBJECT TO REVIEW & APPROVAL OF AN AMENDED PLAN &/OR PROFILE BY THE CITY OF RALEIGH PUBLIC UTILITIES DEPARTMENT PRIOR TO CONSTRUCTION.

4. DEVELOPERS SHALL PROVIDE 30 DAYS ADVANCE WRITTEN NOTICE TO OWNER FOR ANY WORK REQUIRED WITHIN AN EXISTING CITY OF RALEIGH UTILITY EASEMENT TRaversing PRIVATE PROPERTY.

5. CONTRACTOR SHALL MAINTAIN CONTINUOUS WATER & SEWER SERVICE TO EXISTING RESIDENCES & BUSINESSES THROUGHOUT CONSTRUCTION. CONTRACTOR SHALL NOTIFY THE CITY OF RALEIGH PUBLIC UTILITIES DEPARTMENT AS PRECOCED BY A 24-HOUR ADVANCE NOTICE TO THE CITY OF RALEIGH PUBLIC UTILITIES DEPARTMENT.

6. SEWER BYPASS PUMPING - A BYPASS PLAN SEATED BY AN NC PROFESSIONAL ENGINEER SHALL BE PROVIDED TO THE CITY OF RALEIGH PUBLIC UTILITIES DEPARTMENT FOR APPROVAL. THE OPERATIONS & EQUIPMENT SHALL COMPLY WITH THE PUBLIC UTILITIES HANDBOOK.

7. 0.5' MINIMUM COVER IS REQUIRED ON ALL WATER MAINS & SEWER FORCE MAINS. A 0.5' MINIMUM COVER IS REQUIRED ON ALL REUSE.

8. IT IS THE DEVELOPER'S RESPONSIBILITY TO REMOVE & RELOCATE FRESH WATER & SEWER SERVICES NOT BEING USED IN RELATION TO THE PROJECT SITE UNLESS OTHERWISE DIRECTED BY THE CITY OF RALEIGH PUBLIC UTILITIES DEPARTMENT, THIS INCLUDES ABANDONING MAIN & MAIN & REMOVAL OF SERVICE FROM ROW EASEMENT PER CORPID HANDBOOK.

9. NO DULL OR DIP WATER SERVICES WITH METER LOCATED AT ROW OR WITHIN A 2'X2' WATERLINE EASEMENT IMMEDIATELY ADJACENT. NOTICE IT IS THE APPLICANT'S RESPONSIBILITY TO PROPERLY SIZE THE WATER SERVICE FOR EACH CONNECTION TO PROVIDE ADEQUATE FLOW & PRESSURE.

10. INSTALL 1" PVC SEWER SERVICES @ 1.0% MINIMUM GRADE WITH CLEANOUTS LOCATED AT ROW OR EASEMENT LINE & SPACES NOT TO EXCEED 100'.

11. SANITARY REDUCING VALVE SHALL BE REQUIRED ON ALL WATER SERVICES EXCEDING 30' TO BACKWATER VALVES ARE REQUIRED ON ALL SANITARY SEWER SERVICES HAVING BUILDING DRAINS LOWER THAN 1.0' ABOVE THE NEXT UPSTREAM WASHOUT.

12. ALL ENVIRONMENTAL PERMITS APPLICABLE TO THE PROJECT MUST BE OBTAINED FROM NCWQ, USACE & OR/ FEMA FOR ANY RIPARIAN BUFFER, WETLAND &/OR FLOODPLAIN IMPACTS (RESPECTIVELY) PRIOR TO CONSTRUCTION.

13. NCOT / RAILROAD CONNECTION AGREEMENTS ARE REQUIRED FOR ANY UTILITY WORK (INCLUDING MAIN EXTENSIONS & SERVICE TAPS) WHETHER IN STATE OR NARROW HOW PRIOR TO CONSTRUCTION.

14. GREASE TRAP/CATCHER / OIL WATER SEPARATOR SIZING CALCULATIONS & INSTALLATION SPECIFICATIONS SHALL BE APPROVED BY THE CITY OF RALEIGH PUBLIC UTILITIES DEPARTMENT FOR AQUA AND/OR BUILDING PERMIT. CONTACT (919) 961-4516 OR FOG@RALEIGHNC.GOV FOR MORE INFORMATION.


15. CROSS-CONNECTION CONTROL PROTECTION DEVICES ARE REQUIRED BASED ON THE DEGREE OF HEALTH HAZARD INVOLVED AS LISTED IN THE TABLES GOVERNING PUBLIC WATER SYSTEMS IN NORTH CAROLINA.

16. THE DEVICES SHALL MEET THE AMERICAN SOCIETY OF SANITARY ENGINEERING (ASAE) STANDARDS AND BE ON THE UNIFORM LIST OF APPROVED DEVICES.

17. THE DEVICE AND INSTALLATION SHALL MEET THE GUIDELINES OF APPENDIX A - GUIDELINES AND REQUIREMENTS FOR THE CROSS CONNECTION PROGRAM IN RALEIGH'S SERVICE AREA.


18. THE DEVICES SHALL BE INSTALLED AND TESTED (BOTH, INITIAL AND PERIODIC TESTING THEREAFTER) IN ACCORDANCE WITH THE MANUFACTURER'S RECOMMENDATIONS OR THE LOCAL CROSS CONNECTION CONTROL PROGRAM, WHICHEVER IS MORE STRINGENT. CONTRACTOR SHALL NOT USE A DEVICE THAT IS NOT APPROVED BY THE LOCAL CROSS CONNECTION CONTROL PROGRAM.

19. NOTE: PROJECTS THAT INCLUDE AN OVERSIZED MAIN OR URBAN MAIN REPLACEMENT, ANY CITY REIMBURSEMENT GREATER THAN \$250,000.00 MUST UNDERGO THE PUBLIC BIDDING PROCESS.

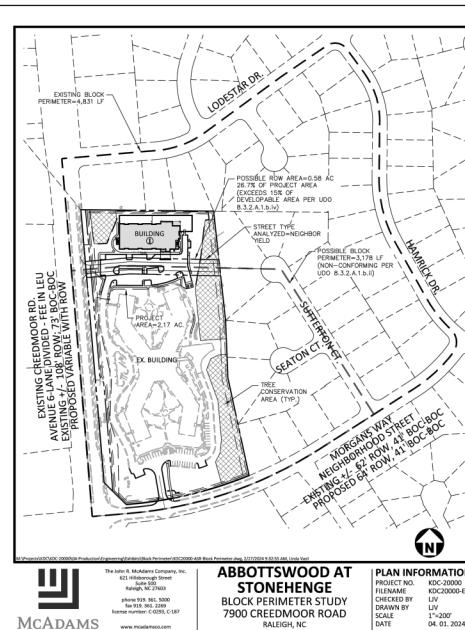

Abbottswood at Stonehenge  
Block Perimeter Study  
7900 Creedmoor Road  
Raleigh, NC

PLAN INFORMATION  
PROJECT NO. KDC-20000  
FILENAME KDC-20000-E1  
CHECKED BY LIV  
DRAWN BY LIV  
DATE 04-01-2024

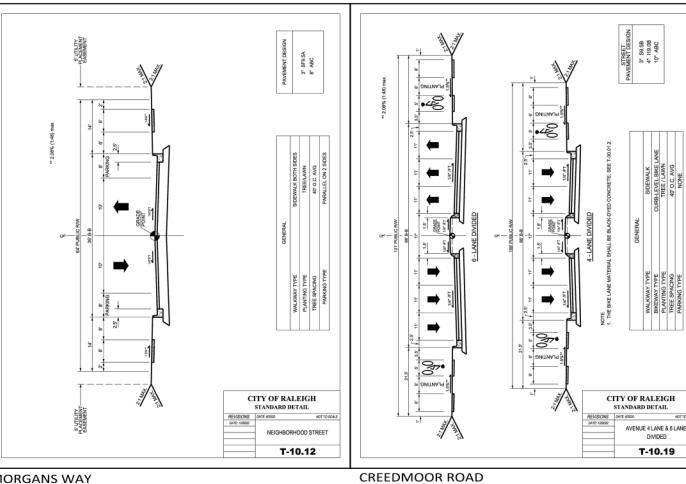

CREEDMOOR ROAD  
THIS PROJECT IS REQUESTING A VARIANCE TO  
INCLUDE STREET NAME PROJECT NO. 7900 CREE  
T-10.19  
NOTICE: THE BLDG MATERIAL SHALL BE ADDED/CONCRETE, SEE T-10.01.2

ALL CONSTRUCTION SHALL CONFORM WITH THE LATEST  
VERSION OF THE CITY OF RALEIGH AND NCDOT STANDARDS,  
SPECIFICATIONS AND DETAILS.

PRELIMINARY DRAWING - NOT RELEASED FOR CONSTRUCTION

#### REVISIONS

NO.	DATE	REVISION FOR 1st ASR COMMENTS
1	10-03-2024	REVISED FOR 1st ASR COMMENTS
2	12-04-2024	REVISED FOR 2nd ASR COMMENTS
3	02-20-2025	REVISED FOR 3rd ASR COMMENTS

#### PLAN INFORMATION

PROJECT NO.	KDC-20000
FILENAME	KDC20000-ASR-N1.DWG
CHECKED BY	LIV
DRAWN BY	LIV
SCALE	NTS
DATE	08.05.2024

#### SHEET

#### PROJECT NOTES

**CO.00**




**MCADAMS**

The John R. McAdams Company, Inc.  
One Glenwood Avenue  
Suite 201  
Raleigh, NC 27603  
phone: 919.361.2339, 4300  
fax: 919.361.2339  
license number: C-2393, C-187  
[www.mcadamsco.com](http://www.mcadamsco.com)

**CLIENT**

MR. JOE WHITEHOUSE  
KISCO SENIOR LIVING  
5270 FLEET STREET, SUITE 300  
CARMEL, CALIFORNIA 93012

**ABBOTTSWOOD AT STONEHENGE**  
ROADWAY FRONTAGE  
IMPROVEMENT PLAN  
RALEIGH, NORTH CAROLINA

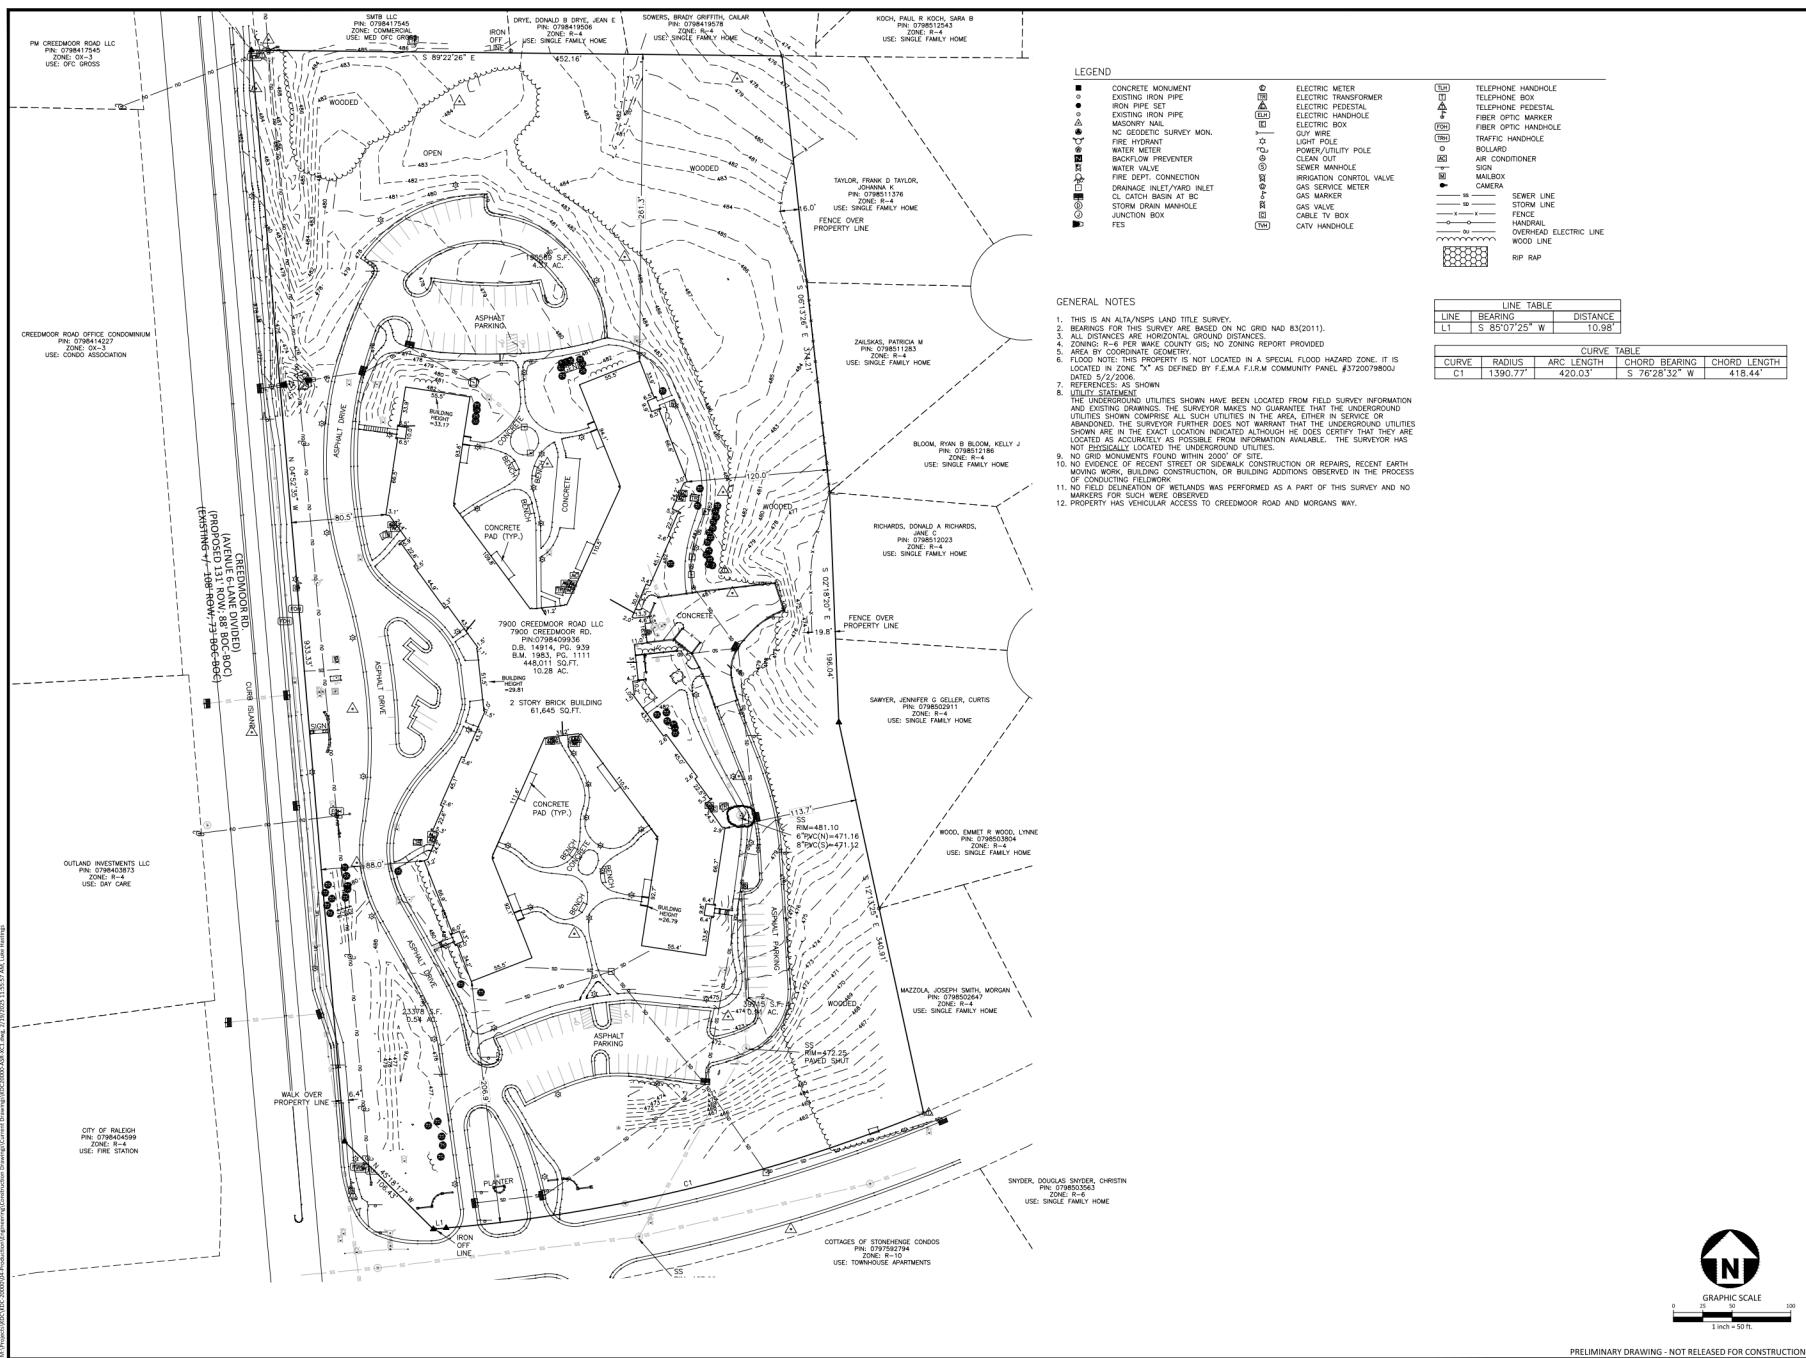




**MCADAMS**

The John H. McAdams Company, Inc.  
2905 Meridian Parkway  
Durham, NC 27713

phone 919.361.5000  
fax 919.361.2269  
license number: C-0293, C-187  
[www.mcadamsco.com](http://www.mcadamsco.com)

**CLIENT**  
MR. JOE WHITEHOUSE  
KISCO SENIOR LIVING  
5790 FLEET STREET, SUITE 300  
CARLSBAD, CALIFORNIA 92008

## ABBOTTSWOOD AT STONEHENGE ADMINISTRATIVE SITE REVIEW ASR-0056-2024 7900 CREEDMOOR ROAD RALEIGH, NORTH CAROLINA, 27613

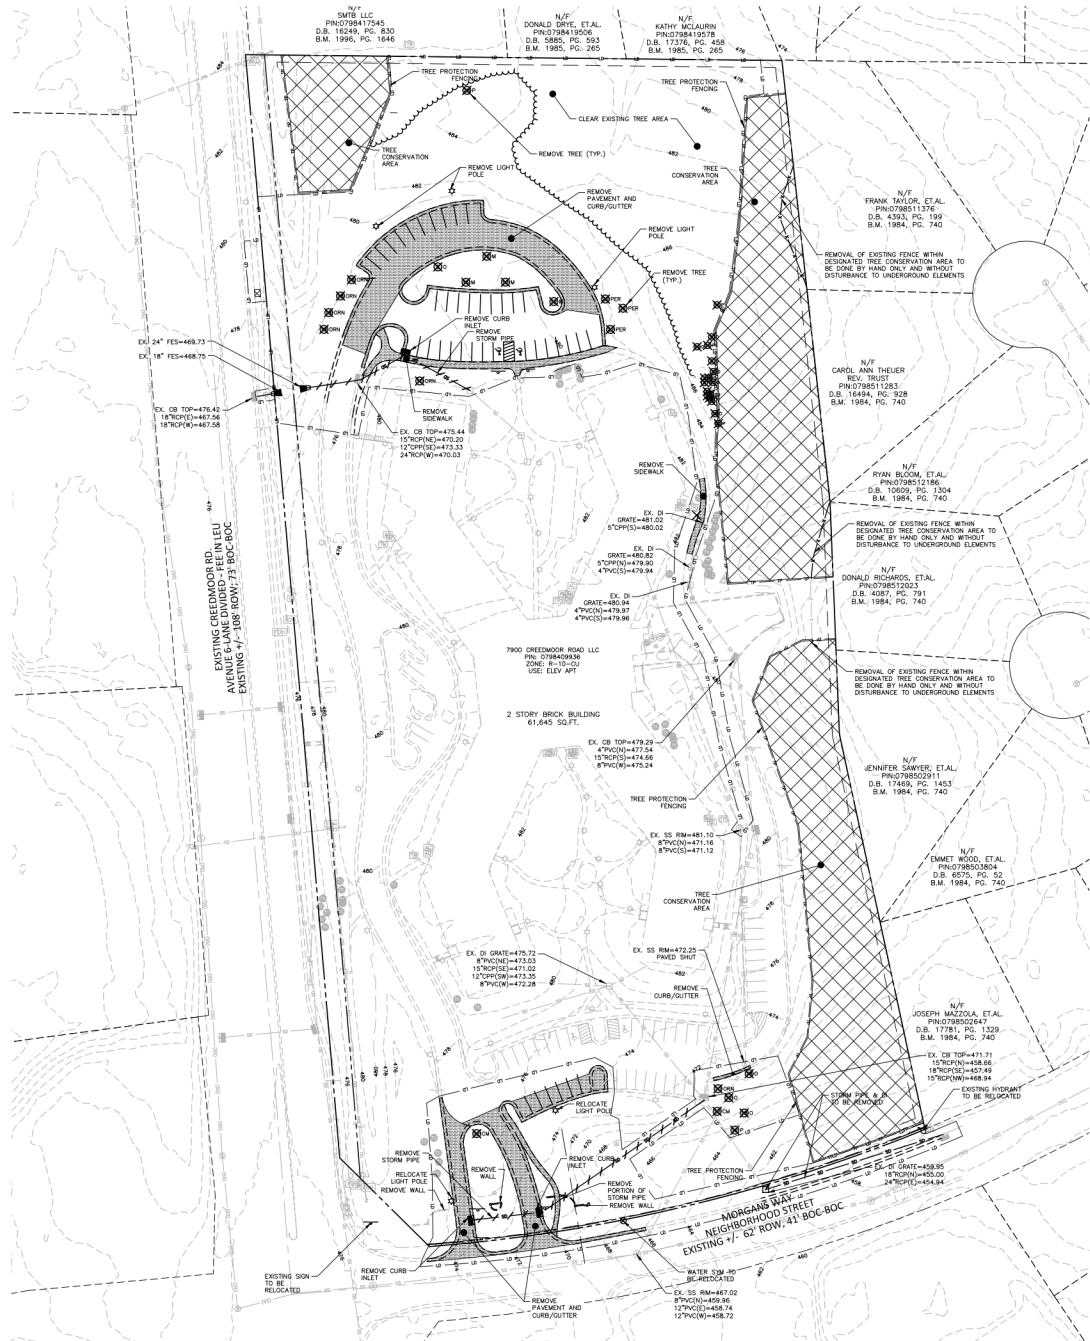

### DEMOLITION LEGEND

	TREE OR OTHER VEGETATION TO BE REMOVED
	UNDERGROUND UTILITY TO BE REMOVED
	AREA TO BE REMOVED (SIDEWALK, CURB AND GUTTER, STRUCTURES, ASPHALT, CONCRETE PAVING, ETC.)
	NOTE: SEE PLAN FOR DETAILED DEMOLITION PROCEDURES, SEQUENCING AND SPECIFICATIONS.

PRIMARY TREE CONSERVATION AREA  
 SECONDARY TREE CONSERVATION AREA



GRAPHIC SCALE  
0 25 50 100  
1 inch = 50 ft.

### REVISIONS

NO.	DATE
1	22.18.2024
2	22.04.2024
3	22.03.2024

1 REVISED PER 10-44A COMMENTS  
2 REVISED PER 2nd ASR COMMENTS  
3 REVISED PER 3rd ASR COMMENTS

### PLAN INFORMATION

PROJECT NO.	KDC-2000
FILENAME	KDC2000-ASR-DM1
CHECKED BY	LIV
DRAWN BY	LIV
SCALE	1"=50'
DATE	08.05.2024

### SHEET

**C1.01**

PRELIMINARY DRAWING - NOT RELEASED FOR CONSTRUCTION

SEE SHEET C0.00 FOR ALL PROJECT NOTES.

ALL CONSTRUCTION SHALL CONFORM WITH THE LATEST VERSION OF THE CITY OF RALEIGH AND NCDOT STANDARDS, SPECIFICATIONS AND DETAILS.

NOTE: GC TO KEEP ALL ADJACENT ROADWAYS, EXISTING PROPERTY AND NEIGHBORING PROPERTIES CLEAN OF ALL CONSTRUCTION MUD, CONCRETE, AND ANY OTHER CONSTRUCTION RELATED DEBRIS. GC TO CLEAN IMMEDIATELY IF THIS SHOULD OCCUR.



**MCADAMS**

The John H. McAdams Company, Inc.  
2905 Meridian Parkway  
Durham, NC 27713

phone 919.361.5000  
fax 919.361.2269  
license number: C-0293, C-187

[www.mcadamsco.com](http://www.mcadamsco.com)


**CLIENT**

MR. JOE WHITEHOUSE  
KISCO SENIOR LIVING  
5790 FLEET STREET, SUITE 300  
CARLSBAD, CALIFORNIA 92008

**ABBOTTSWOOD AT STONEHENGE**  
**ADMINISTRATIVE SITE REVIEW**  
**ASR-0056-2024**  
**7900 CREEDMOOR ROAD**  
**RALEIGH, NORTH CAROLINA, 27613**

**SITE LEGEND**

	SIGNAGE
	YARD LIGHTS
	LIGHT POLE
	POWER POLE
	TRAFFIC DIRECTIONAL ARROW
	ACCESSIBLE RAMPS
	TYPE ① PROPERTY LINE
	TYPE ② PROPERTY LINE
	RIGHT-OF-WAY LINE
	LOT LINE
	EASEMENT LINE
	CENTERLINE
	TREE PROTECTION FENCING
	ACCESSIBLE ROUTE
	PRIMARY TREE CONSERVATION AREA - THOROUGHFARE
	SECONDARY TREE CONSERVATION AREA
	HEAVY DUTY ASPHALT
	LIGHT DUTY CONCRETE SIDEWALK
	AMENITY AREA

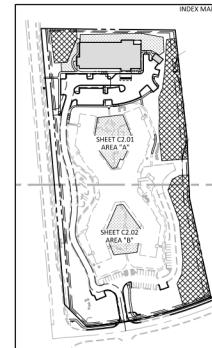

GRAPHIC SCALE  
0 100 200 400  
1 inch = 200 ft

**REVISIONS**

- No. Date  
1 03.18.2024 REVISED FOR 1st 4th COMMENTS  
2 03.26.2024 REVISED FOR 2nd ASR COMMENTS  
3 03.31.2024 REVISED FOR 3rd ASR COMMENTS

**PLAN INFORMATION**

PROJECT NO. KDC-20000  
FILENAME KDC-20000-ASR-OA51  
CHECKED BY LIV  
DRAWN BY LLH  
SCALE 1"=50'  
DATE 08.05.2024

**SHEET**

**OVERALL SITE PLAN**


**C2.00**

SEE SHEET C0.00 FOR ALL PROJECT NOTES.

ALL CONSTRUCTION SHALL CONFORM WITH THE LATEST VERSION OF THE CITY OF RALEIGH AND NCDOT STANDARDS, SPECIFICATIONS AND DETAILS.

GRAPHIC SCALE  
0 20 50 100  
1 inch = 50 ft

PRELIMINARY DRAWING - NOT RELEASED FOR CONSTRUCTION

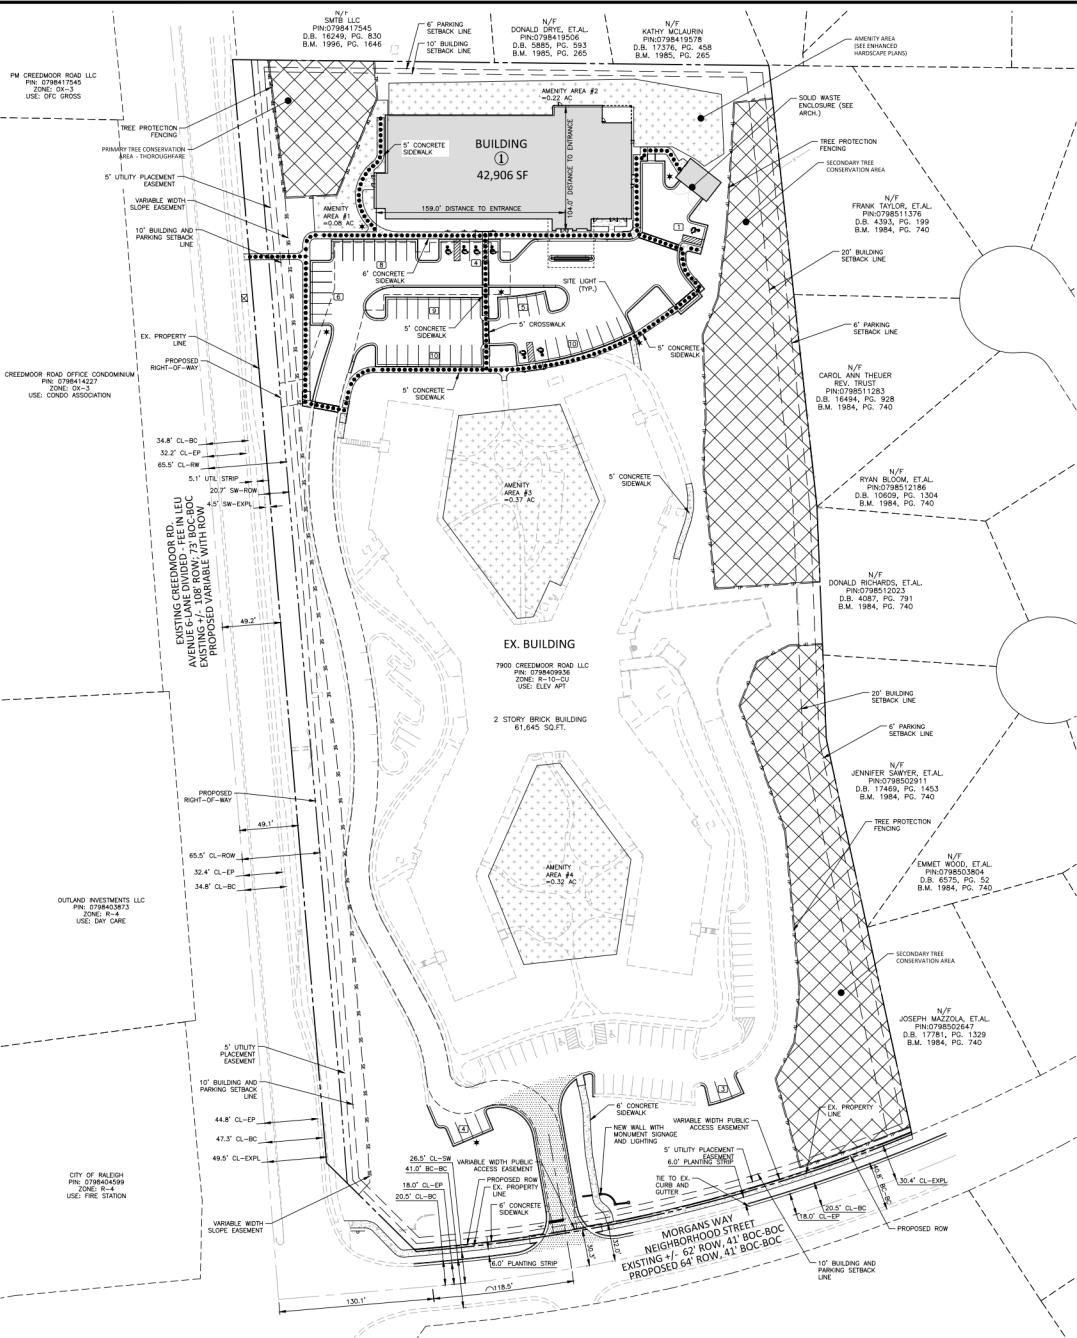





**MCADAMS**

The John R. McAdams Company, Inc.  
2905 Meridian Parkway  
Durham, NC 27713


Phone: 919.361.5000  
Fax: 919.361.2266  
License number: C-2929-C-187

www.mcadamsco.com

**CLIENT**  
MR. JOE WHITEHOUSE  
KISCO SENIOR LIVING  
5270 FLEET STREET, SUITE 300  
CALIFORNIA, CALIFORNIA 92908

## ABBOTTSWOOD AT STONEHENGE ADMINISTRATIVE SITE REVIEW ASR-0056-2024

7900 CREEDMOOR ROAD  
RALEIGH, NORTH CAROLINA, 27613

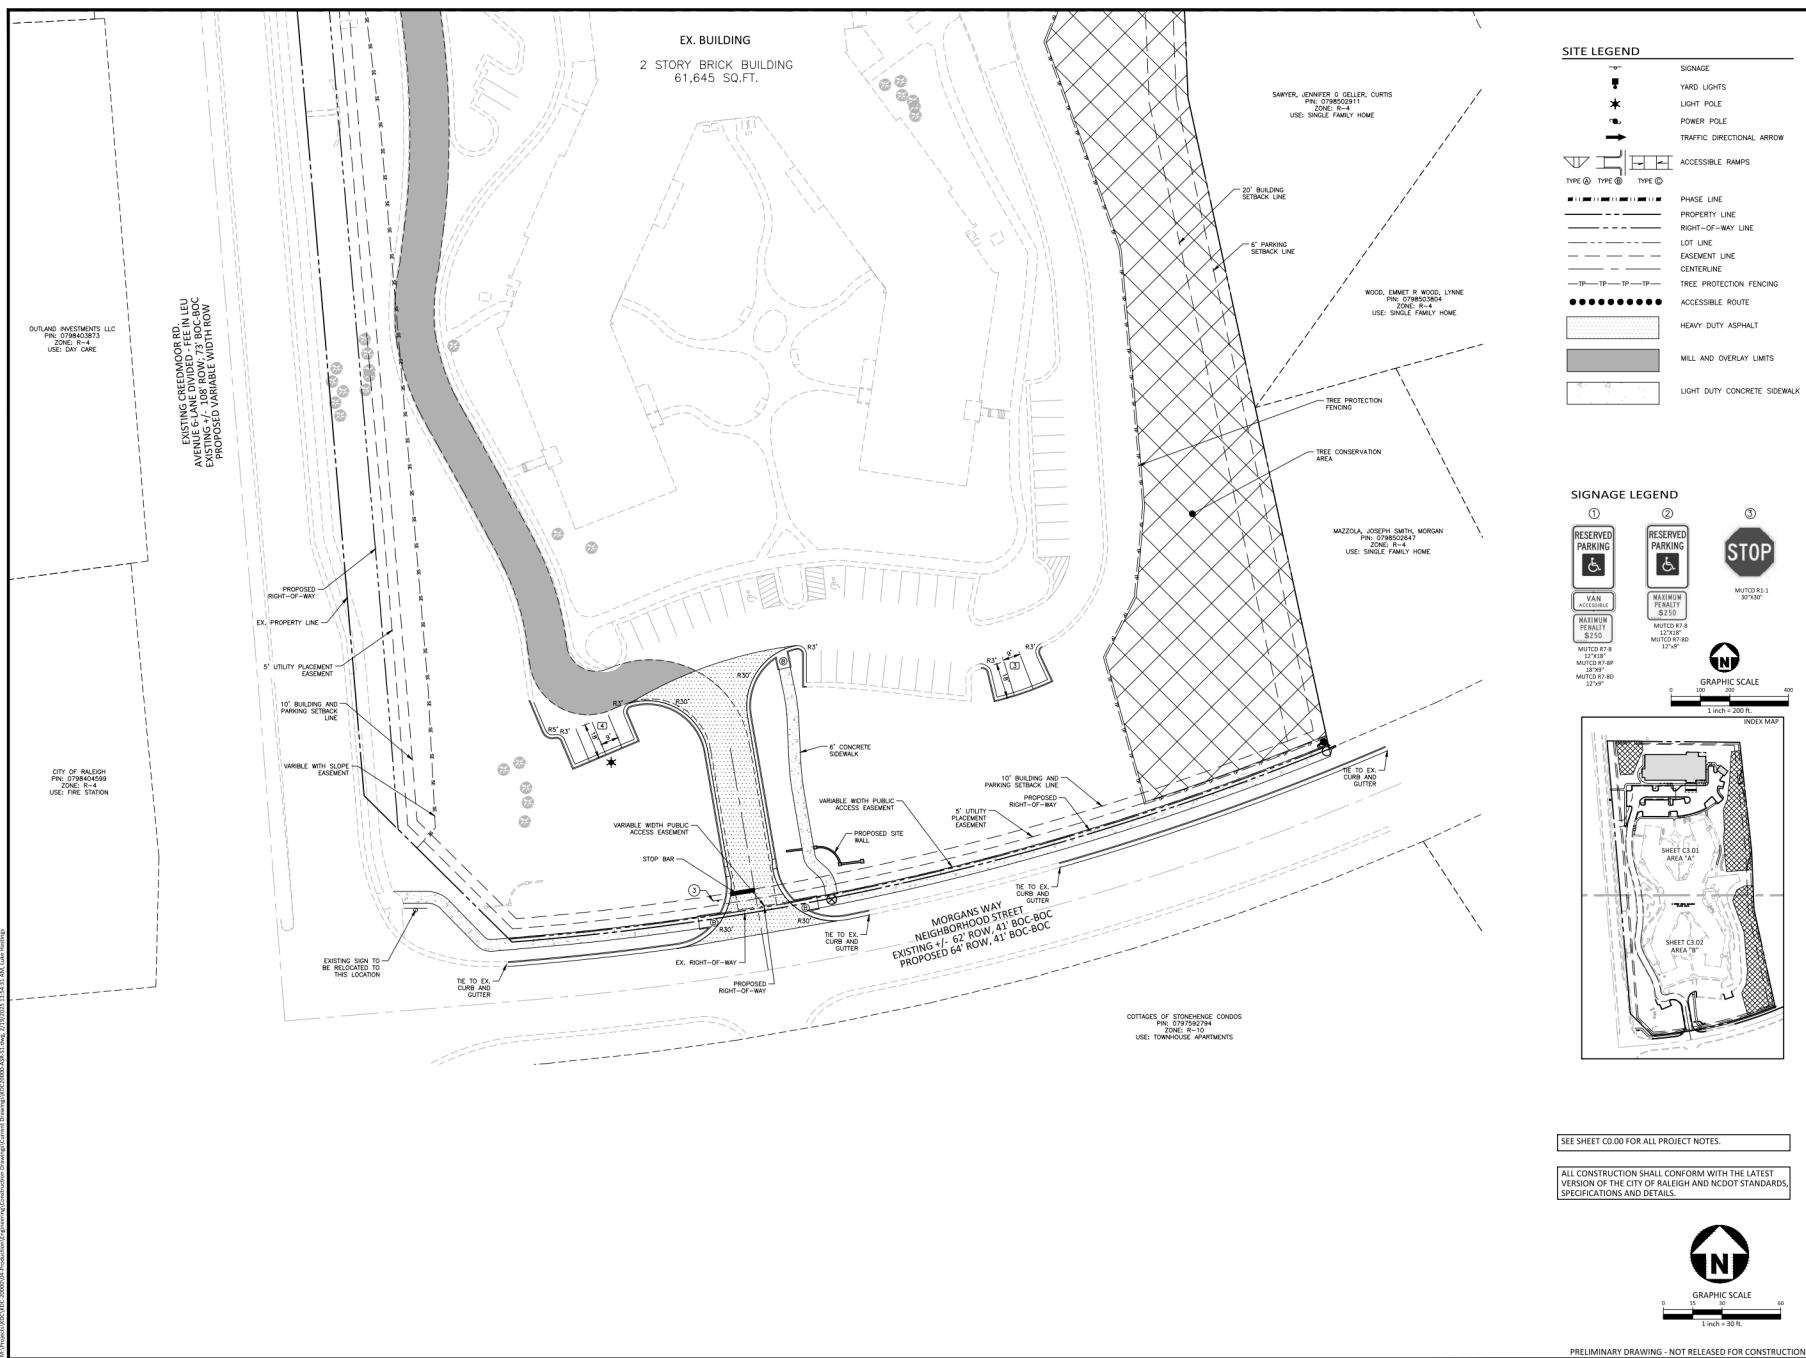


### SITE LEGEND

	SIGNAGE
	YARD LIGHTS
	LIGHT POLE
	POWER POLE
	TRAFFIC DIRECTIONAL ARROW
	ACCESSIBLE RAMPS
	PHASE LINE
	PROPERTY LINE
	RIGHT-OF-WAY LINE
	LOT LINE
	EASEMENT LINE
	CENTERLINE
	TREE PROTECTION FENCING
	ACCESSIBLE ROUTE
	HEAVY DUTY ASPHALT
	MILL AND OVERLAY LIMITS
	LIGHT DUTY CONCRETE SIDEWALK

### SIGNAGE LEGEND

	① RESERVED PARKING
	② RESERVED PARKING
	③ STOP
	GRAPHIC SCALE
	MUTCD 3A-1 30' X 30'
	MUTCD 3A-8 12'-0"
	MUTCD K-7.4 12'-0"
	MUTCD K-7.8D 12'-0"
	MUTCD K-7.8 12'-0"

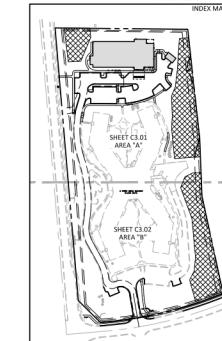

### REVISIONS

- |     |            |                              |
|-----|------------|------------------------------|
| NO. | DATE       | REVISION PER                 |
| 1   | 10.03.2024 | REVISED PER 1st ASR COMMENTS |
| 2   | 12.04.2024 | REVISED PER 2nd ASR COMMENTS |
| 3   | 02.19.2025 | REVISED PER 3rd ASR COMMENTS |

SEE SHEET C0.0 FOR ALL PROJECT NOTES.

ALL CONSTRUCTION SHALL CONFORM WITH THE LATEST VERSION OF THE CITY OF RALEIGH AND NCDOT STANDARDS, SPECIFICATIONS AND DETAILS.

ALL CONSTRUCTION SHALL CONFORM WITH THE LATEST VERSION OF THE CITY OF RALEIGH AND NCDOT STANDARDS, SPECIFICATIONS AND DETAILS.

ALL CONSTRUCTION SHALL CONFORM WITH THE LATEST VERSION OF THE CITY OF RALEIGH AND NCDOT STANDARDS, SPECIFICATIONS AND DETAILS.



### PLAN INFORMATION

PROJECT NO.: KDC-20000  
FILENAME: KDC20000-ASR-S1.DWG  
CHECKED BY: LIV  
DRAWN BY: LLH  
SCALE: 1"=30'  
DATE: 08.05.2024

### SHEET

DETAILED SITE PLAN  
AREA "B"

**C2.02**

PRELIMINARY DRAWING - NOT RELEASED FOR CONSTRUCTION






**MCADAMS**

The John H. McAdams Company, Inc.  
2905 Meridian Parkway  
Durham, NC 27713

phone 919.361.2269  
fax 919.361.2269  
license number: C-0293, C-187  
[www.mcadamsco.com](http://www.mcadamsco.com)

**CLIENT**  
MR. JOE WHITEHOUSE  
KISCO SENIOR LIVING  
5790 FLEET STREET, SUITE 300  
CARLSBAD, CALIFORNIA 92008

## ABBOTTSWOOD AT STONEHENGE ADMINISTRATIVE SITE REVIEW ASR-0056-2024 7900 CREEDMOOR ROAD RALEIGH, NORTH CAROLINA, 27613

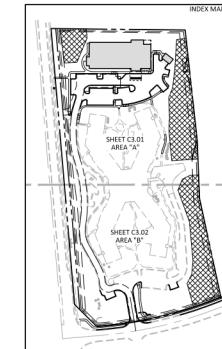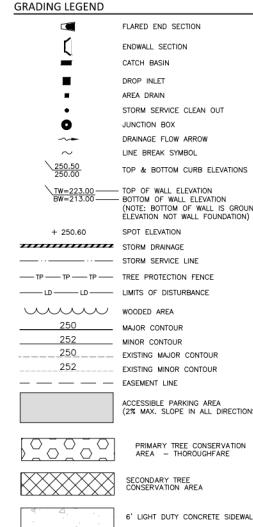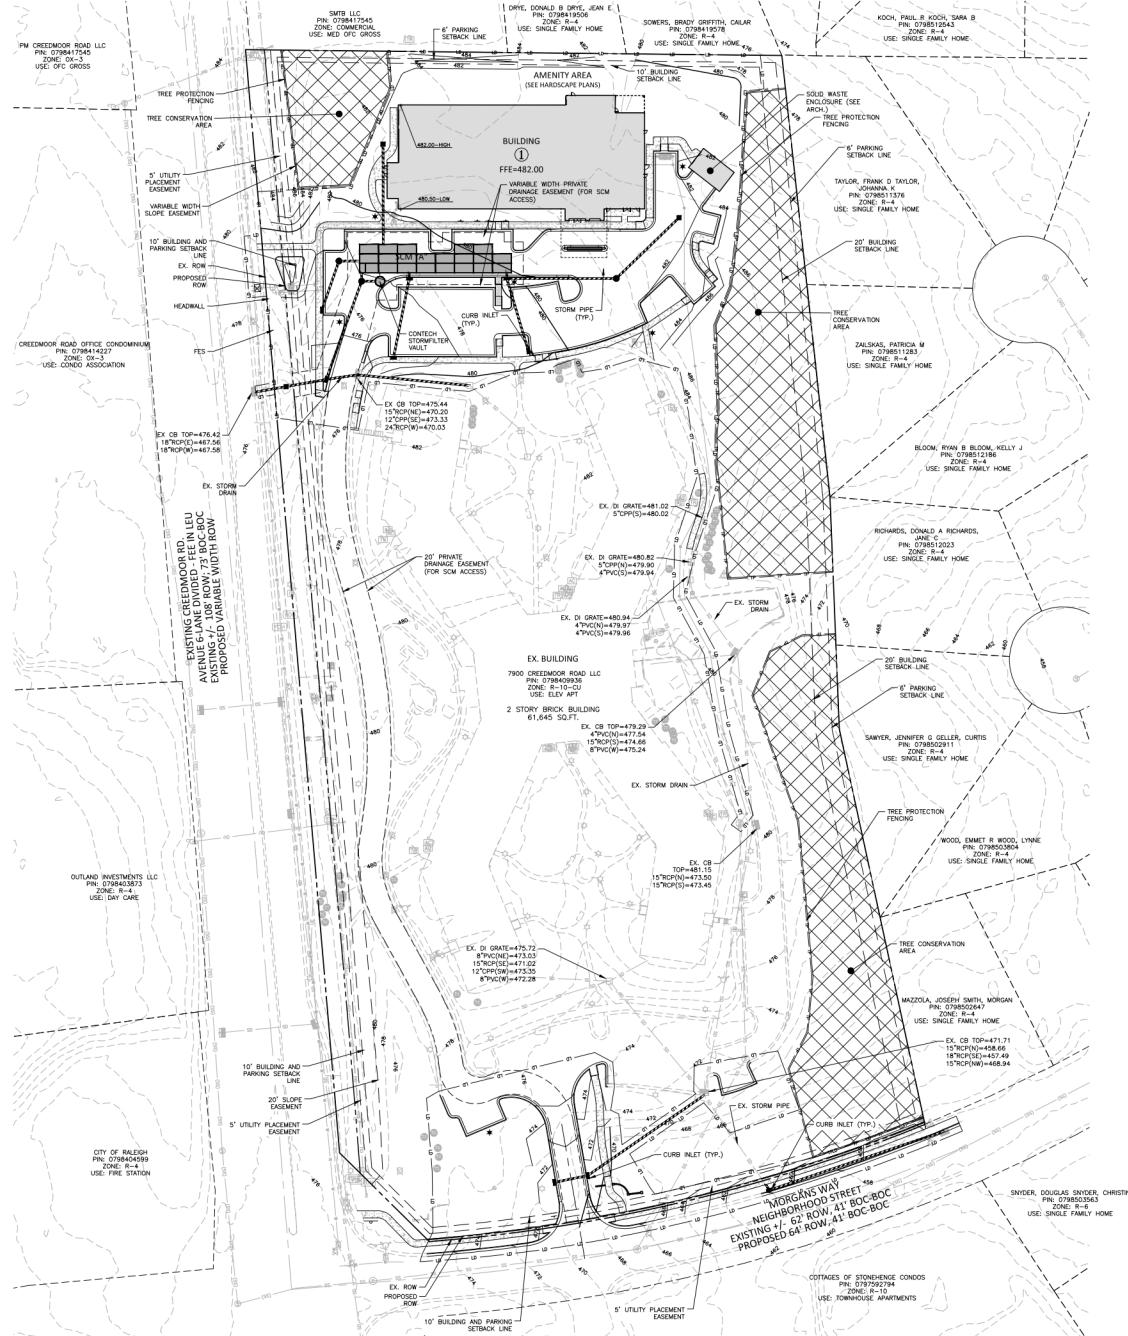

### BUILDING #1 AVERAGE GRADE PLANE

	HIGH	LOW	AVERAGE
CREEDMORE ROAD	482.00	480.50	481.25

### REVISIONS

- No. Date  
 1 22.18.2024 REVISED PER 1st 4HR COMMENTS  
 2 22.24.2024 REVISED PER 2nd ASR COMMENTS  
 3 03.13.2025 REVISED PER 3rd ASR COMMENTS

### PLAN INFORMATION

PROJECT NO. KDC-20000  
 FILENAME KDC20000-ASR-OAG1  
 CHECKED BY LIV  
 DRAWN BY JT  
 SCALE 1"=50'  
 DATE 08.05.2024



SEE SHEET C0.00 FOR ALL PROJECT NOTES.

ALL CONSTRUCTION SHALL CONFORM WITH THE LATEST VERSION OF THE CITY OF RALEIGH AND NC DOT STANDARDS, SPECIFICATIONS AND DETAILS.

PRELIMINARY DRAWING - NOT RELEASED FOR CONSTRUCTION

**C3.00**



**McADAMS**

The John R. McAdams Company, Inc.  
2905 Meridian Parkway  
Durham, NC 27713

phone 919.361.5000

fax 919.361.2266

license number: C-2929-C-187


www.mcadamsco.com

**CLIENT**

MR. JOE WHITEHOUSE  
KISCO SENIOR LIVING  
5270 FLEET STREET, SUITE 300  
CALIFORNIA, CALIFORNIA 92008

**ABBOTTSWOOD AT STONEHENGE**  
**ADMINISTRATIVE SITE REVIEW**  
**ASR-0056-2024**

7900 CREEDMOOR ROAD  
RALEIGH, NORTH CAROLINA, 27613

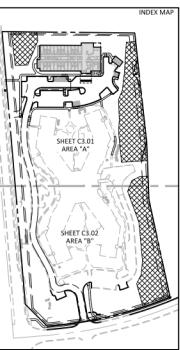

**REVISIONS**

NO.	DATE	REVISED PER 1st ASR COMMENTS
1	10.03.2024	REVISED PER 1st ASR COMMENTS
2	12.04.2024	REVISED PER 2nd ASR COMMENTS
3	02.09.2025	REVISED PER 3rd ASR COMMENTS

SEE SHEET C0.0 FOR ALL PROJECT NOTES.

ALL CONSTRUCTION SHALL CONFORM WITH THE LATEST VERSION OF THE CITY OF RALEIGH AND NCDOT STANDARDS, SPECIFICATIONS AND DETAILS.



GRAPHIC SCALE


1 inch = 30 ft

**PLAN INFORMATION**

PROJECT NO.: KDC-20000  
FILENAME: KDC20000-ASR-G1.DWG  
CHECKED BY: LIV  
DRAWN BY: LLH  
SCALE: 1"=30'  
DATE: 08.05.2024

**DETAILED GRADING PLAN AREA "A"**

**C3.01**

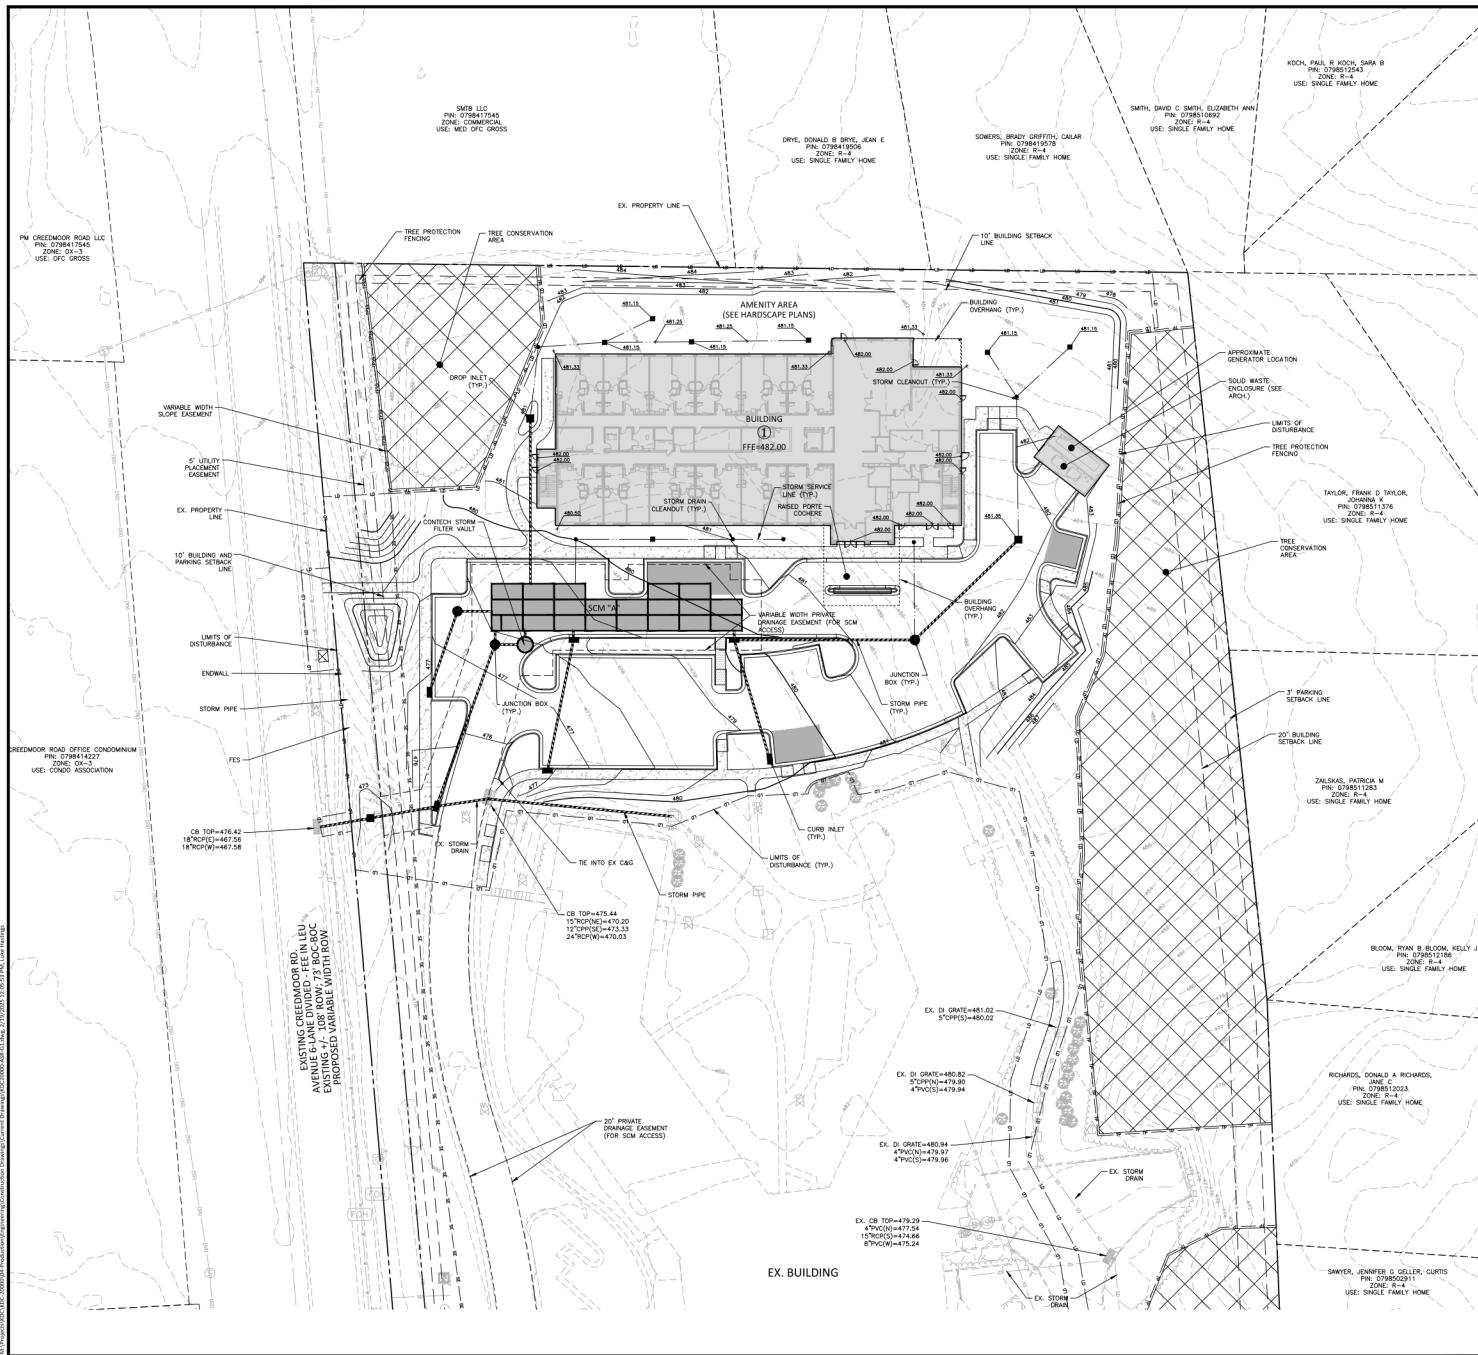

PRELIMINARY DRAWING - NOT RELEASED FOR CONSTRUCTION



**MCADAMS**

The John R. McAdams Company, Inc.  
2905 Meridian Parkway  
Durham, NC 27713

phone 919.361.5000

fax 919.361.2266

license number: C-2929-C-187


www.mcadamsco.com

**CLIENT**

MR. JOE WHITEHOUSE  
KCSO SENIOR LIVING  
5270 FLEET STREET, SUITE 300  
CALIFORNIA, CALIFORNIA 92008

**ABBOTTSWOOD AT STONEHENGE**  
**ADMINISTRATIVE SITE REVIEW**  
**ASR-0056-2024**  
**7900 CREEDMOOR ROAD**  
**RALEIGH, NORTH CAROLINA, 27613**

	<b>GRADING LEGEND</b>
	FLARED END SECTION
	ENDWALL SECTION
	CATCH BASIN
	DROP INLET
	STORM SERVICE ROOF-DRAIN
	JUNCTION BOX
	DRAINAGE FLOW ARROW
	LINE BREAK SYMBOL
	TOP & BOTTOM CURB ELEVATIONS
	TOP OF WALL ELEVATION
	BOTTOM OF WALL ELEVATION
	GND ELEVATION NOT WALL FOUNDATION
	SPOT ELEVATION
	STORM DRAIN
	STORM SERVICE LINE
	ROOF DRAIN, 8" ABS
	NON-PERFORATED TUBING OR DOWNTAKE, 8" ABS, 10' LONG, 1/2" MIN.
	COVER PVC, SCHEDULE 40, IN TRAFFIC AREAS
	TREE PROTECTION FENCE
	LIMITS OF DISTURBANCE
	WOODED AREA
	MAJOR CONTOUR
	MINOR CONTOUR
	EXISTING MAJOR CONTOUR
	EXISTING MINOR CONTOUR
	EASEMENT LINE
	ACCESSIBLE PARKING AREA (2% MAX. SLOPE IN ALL DIRECTIONS)
	TREE PROTECTION FENCING

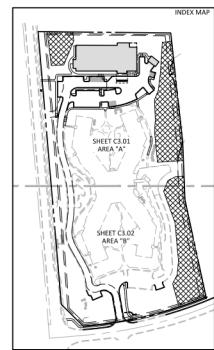

SEE SHEET C0.0 FOR ALL PROJECT NOTES.

ALL CONSTRUCTION SHALL CONFORM WITH THE LATEST VERSION OF THE CITY OF RALEIGH AND NCDOT STANDARDS, SPECIFICATIONS AND DETAILS.

1 10.0.2024 REVISED PER E14 ASR COMMENTS

2 12.04.2024 REVISED PER 2nd ASR COMMENTS

3 02.05.2025 REVISED PER 3rd ASR COMMENTS

4 10.0.2024 REVISED PER E14 ASR COMMENTS

5 12.04.2024 REVISED PER 2nd ASR COMMENTS

6 02.05.2025 REVISED PER 3rd ASR COMMENTS

7 10.0.2024 REVISED PER E14 ASR COMMENTS

8 12.04.2024 REVISED PER 2nd ASR COMMENTS

9 02.05.2025 REVISED PER 3rd ASR COMMENTS

10 10.0.2024 REVISED PER E14 ASR COMMENTS

11 12.04.2024 REVISED PER 2nd ASR COMMENTS

12 02.05.2025 REVISED PER 3rd ASR COMMENTS

13 10.0.2024 REVISED PER E14 ASR COMMENTS

14 12.04.2024 REVISED PER 2nd ASR COMMENTS

15 02.05.2025 REVISED PER 3rd ASR COMMENTS

16 10.0.2024 REVISED PER E14 ASR COMMENTS

17 12.04.2024 REVISED PER 2nd ASR COMMENTS

18 02.05.2025 REVISED PER 3rd ASR COMMENTS

19 10.0.2024 REVISED PER E14 ASR COMMENTS

20 12.04.2024 REVISED PER 2nd ASR COMMENTS

21 02.05.2025 REVISED PER 3rd ASR COMMENTS

22 10.0.2024 REVISED PER E14 ASR COMMENTS

23 12.04.2024 REVISED PER 2nd ASR COMMENTS

24 02.05.2025 REVISED PER 3rd ASR COMMENTS

25 10.0.2024 REVISED PER E14 ASR COMMENTS

26 12.04.2024 REVISED PER 2nd ASR COMMENTS

27 02.05.2025 REVISED PER 3rd ASR COMMENTS

28 10.0.2024 REVISED PER E14 ASR COMMENTS

29 12.04.2024 REVISED PER 2nd ASR COMMENTS

30 02.05.2025 REVISED PER 3rd ASR COMMENTS

31 10.0.2024 REVISED PER E14 ASR COMMENTS

32 12.04.2024 REVISED PER 2nd ASR COMMENTS

33 02.05.2025 REVISED PER 3rd ASR COMMENTS

34 10.0.2024 REVISED PER E14 ASR COMMENTS

35 12.04.2024 REVISED PER 2nd ASR COMMENTS

36 02.05.2025 REVISED PER 3rd ASR COMMENTS

37 10.0.2024 REVISED PER E14 ASR COMMENTS

38 12.04.2024 REVISED PER 2nd ASR COMMENTS

39 02.05.2025 REVISED PER 3rd ASR COMMENTS

40 10.0.2024 REVISED PER E14 ASR COMMENTS

41 12.04.2024 REVISED PER 2nd ASR COMMENTS

42 02.05.2025 REVISED PER 3rd ASR COMMENTS

43 10.0.2024 REVISED PER E14 ASR COMMENTS

44 12.04.2024 REVISED PER 2nd ASR COMMENTS

45 02.05.2025 REVISED PER 3rd ASR COMMENTS

46 10.0.2024 REVISED PER E14 ASR COMMENTS

47 12.04.2024 REVISED PER 2nd ASR COMMENTS

48 02.05.2025 REVISED PER 3rd ASR COMMENTS

49 10.0.2024 REVISED PER E14 ASR COMMENTS

50 12.04.2024 REVISED PER 2nd ASR COMMENTS

51 02.05.2025 REVISED PER 3rd ASR COMMENTS

52 10.0.2024 REVISED PER E14 ASR COMMENTS

53 12.04.2024 REVISED PER 2nd ASR COMMENTS

54 02.05.2025 REVISED PER 3rd ASR COMMENTS

55 10.0.2024 REVISED PER E14 ASR COMMENTS

56 12.04.2024 REVISED PER 2nd ASR COMMENTS

57 02.05.2025 REVISED PER 3rd ASR COMMENTS

58 10.0.2024 REVISED PER E14 ASR COMMENTS

59 12.04.2024 REVISED PER 2nd ASR COMMENTS

60 02.05.2025 REVISED PER 3rd ASR COMMENTS

61 10.0.2024 REVISED PER E14 ASR COMMENTS

62 12.04.2024 REVISED PER 2nd ASR COMMENTS

63 02.05.2025 REVISED PER 3rd ASR COMMENTS

64 10.0.2024 REVISED PER E14 ASR COMMENTS

65 12.04.2024 REVISED PER 2nd ASR COMMENTS

66 02.05.2025 REVISED PER 3rd ASR COMMENTS

67 10.0.2024 REVISED PER E14 ASR COMMENTS

68 12.04.2024 REVISED PER 2nd ASR COMMENTS

69 02.05.2025 REVISED PER 3rd ASR COMMENTS

70 10.0.2024 REVISED PER E14 ASR COMMENTS

71 12.04.2024 REVISED PER 2nd ASR COMMENTS

72 02.05.2025 REVISED PER 3rd ASR COMMENTS

73 10.0.2024 REVISED PER E14 ASR COMMENTS

74 12.04.2024 REVISED PER 2nd ASR COMMENTS

75 02.05.2025 REVISED PER 3rd ASR COMMENTS

76 10.0.2024 REVISED PER E14 ASR COMMENTS

77 12.04.2024 REVISED PER 2nd ASR COMMENTS

78 02.05.2025 REVISED PER 3rd ASR COMMENTS

79 10.0.2024 REVISED PER E14 ASR COMMENTS

80 12.04.2024 REVISED PER 2nd ASR COMMENTS

81 02.05.2025 REVISED PER 3rd ASR COMMENTS

82 10.0.2024 REVISED PER E14 ASR COMMENTS

83 12.04.2024 REVISED PER 2nd ASR COMMENTS

84 02.05.2025 REVISED PER 3rd ASR COMMENTS

85 10.0.2024 REVISED PER E14 ASR COMMENTS

86 12.04.2024 REVISED PER 2nd ASR COMMENTS

87 02.05.2025 REVISED PER 3rd ASR COMMENTS

88 10.0.2024 REVISED PER E14 ASR COMMENTS

89 12.04.2024 REVISED PER 2nd ASR COMMENTS

90 02.05.2025 REVISED PER 3rd ASR COMMENTS

91 10.0.2024 REVISED PER E14 ASR COMMENTS

92 12.04.2024 REVISED PER 2nd ASR COMMENTS

93 02.05.2025 REVISED PER 3rd ASR COMMENTS

94 10.0.2024 REVISED PER E14 ASR COMMENTS

95 12.04.2024 REVISED PER 2nd ASR COMMENTS

96 02.05.2025 REVISED PER 3rd ASR COMMENTS

97 10.0.2024 REVISED PER E14 ASR COMMENTS

98 12.04.2024 REVISED PER 2nd ASR COMMENTS

99 02.05.2025 REVISED PER 3rd ASR COMMENTS

100 10.0.2024 REVISED PER E14 ASR COMMENTS

101 12.04.2024 REVISED PER 2nd ASR COMMENTS

102 02.05.2025 REVISED PER 3rd ASR COMMENTS

103 10.0.2024 REVISED PER E14 ASR COMMENTS

104 12.04.2024 REVISED PER 2nd ASR COMMENTS

105 02.05.2025 REVISED PER 3rd ASR COMMENTS

106 10.0.2024 REVISED PER E14 ASR COMMENTS

107 12.04.2024 REVISED PER 2nd ASR COMMENTS

108 02.05.2025 REVISED PER 3rd ASR COMMENTS

109 10.0.2024 REVISED PER E14 ASR COMMENTS

110 12.04.2024 REVISED PER 2nd ASR COMMENTS

111 02.05.2025 REVISED PER 3rd ASR COMMENTS

112 10.0.2024 REVISED PER E14 ASR COMMENTS

113 12.04.2024 REVISED PER 2nd ASR COMMENTS

114 02.05.2025 REVISED PER 3rd ASR COMMENTS

115 10.0.2024 REVISED PER E14 ASR COMMENTS

116 12.04.2024 REVISED PER 2nd ASR COMMENTS

117 02.05.2025 REVISED PER 3rd ASR COMMENTS

118 10.0.2024 REVISED PER E14 ASR COMMENTS

119 12.04.2024 REVISED PER 2nd ASR COMMENTS

120 02.05.2025 REVISED PER 3rd ASR COMMENTS

121 10.0.2024 REVISED PER E14 ASR COMMENTS

122 12.04.2024 REVISED PER 2nd ASR COMMENTS

123 02.05.2025 REVISED PER 3rd ASR COMMENTS

124 10.0.2024 REVISED PER E14 ASR COMMENTS

125 12.04.2024 REVISED PER 2nd ASR COMMENTS

126 02.05.2025 REVISED PER 3rd ASR COMMENTS

127 10.0.2024 REVISED PER E14 ASR COMMENTS

128 12.04.2024 REVISED PER 2nd ASR COMMENTS

129 02.05.2025 REVISED PER 3rd ASR COMMENTS

130 10.0.2024 REVISED PER E14 ASR COMMENTS

131 12.04.2024 REVISED PER 2nd ASR COMMENTS

132 02.05.2025 REVISED PER 3rd ASR COMMENTS

133 10.0.2024 REVISED PER E14 ASR COMMENTS

134 12.04.2024 REVISED PER 2nd ASR COMMENTS

135 02.05.2025 REVISED PER 3rd ASR COMMENTS

136 10.0.2024 REVISED PER E14 ASR COMMENTS

137 12.04.2024 REVISED PER 2nd ASR COMMENTS

138 02.05.2025 REVISED PER 3rd ASR COMMENTS

139 10.0.2024 REVISED PER E14 ASR COMMENTS

140 12.04.2024 REVISED PER 2nd ASR COMMENTS

141 02.05.2025 REVISED PER 3rd ASR COMMENTS

142 10.0.2024 REVISED PER E14 ASR COMMENTS

143 12.04.2024 REVISED PER 2nd ASR COMMENTS

144 02.05.2025 REVISED PER 3rd ASR COMMENTS

145 10.0.2024 REVISED PER E14 ASR COMMENTS

146 12.04.2024 REVISED PER 2nd ASR COMMENTS

147 02.05.2025 REVISED PER 3rd ASR COMMENTS

148 10.0.2024 REVISED PER E14 ASR COMMENTS

149 12.04.2024 REVISED PER 2nd ASR COMMENTS

150 02.05.2025 REVISED PER 3rd ASR COMMENTS

151 10.0.2024 REVISED PER E14 ASR COMMENTS

152 12.04.2024 REVISED PER 2nd ASR COMMENTS

153 02.05.2025 REVISED PER 3rd ASR COMMENTS

154 10.0.2024 REVISED PER E14 ASR COMMENTS

155 12.04.2024 REVISED PER 2nd ASR COMMENTS

156 02.05.2025 REVISED PER 3rd ASR COMMENTS

157 10.0.2024 REVISED PER E14 ASR COMMENTS

158 12.04.2024 REVISED PER 2nd ASR COMMENTS

159 02.05.2025 REVISED PER 3rd ASR COMMENTS

160 10.0.2024 REVISED PER E14 ASR COMMENTS

161 12.04.2024 REVISED PER 2nd ASR COMMENTS

162 02.05.2025 REVISED PER 3rd ASR COMMENTS

163 10.0.2024 REVISED PER E14 ASR COMMENTS

164 12.04.2024 REVISED PER 2nd ASR COMMENTS

165 02.05.2025 REVISED PER 3rd ASR COMMENTS

166 10.0.2024 REVISED PER E14 ASR COMMENTS

167 12.04.2024 REVISED PER 2nd ASR COMMENTS

168 02.05.2025 REVISED PER 3rd ASR COMMENTS

169 10.0.2024 REVISED PER E14 ASR COMMENTS

170 12.04.2024 REVISED PER 2nd ASR COMMENTS

171 02.05.2025 REVISED PER 3rd ASR COMMENTS



**MCADAMS**

The John H. McAdams Company, Inc.  
2905 Meridian Parkway  
Durham, NC 27713

phone 919.361.5000

fax 919.361.2269

license number C-0293, C-187

www.mcadamsco.com

#### CLIENT

MR. JOE WHITEHOUSE  
KISCO SENIOR LIVING  
5790 FLEET STREET, SUITE 300  
CARLSBAD, CALIFORNIA 92008


#### UTILITY LEGEND

FI	FIRE HYDRANT ASSEMBLY
FD	FIRE DEPARTMENT CONNECTION (FDC)
WM	WATER METER
VA	WATER VALVE
PIV	POST INDICATOR VALVE
VM	VALVE IN MANHOLE
MV	METER & VAULT
BFP	BAGFLOW PREVENTER
R	REDUCER
BOA	BLOW-OFF ASSEMBLY
SM	SANITARY SEWER MANHOLE
SC	SEWER CLEAN-OUT
GT	GREASE TRAP
SFD	SEWER FLOW DIRECTION ARROW
YL	YARD LIGHTS
LP	LIGHT POLE
PP	POWER POLE
LB	LINE BREAK SYMBOL
WL	WATERLINE
WSL	WATER SERVICE LINE
SS	SANITARY SEWER
SSL	SEWER SERVICE LINE
FM	SEWER FORCE MAIN
GL	GAS LINE
OU	OVERHEAD UTILITY
UE	UNDERGROUND ELECTRIC
EL	EASEMENT LINE
TP	TREE PROTECTION FENCING
PTC	PRIMARY TREE CONSERVATION AREA - THOROUGHFARE
STCA	SECONDARY TREE CONSERVATION AREA

#### ABBOTTSWOOD AT STONEHENGE ADMINISTRATIVE SITE REVIEW

ASR-0056-2024

7900 CREEDMOOR ROAD  
RALEIGH, NORTH CAROLINA, 27613

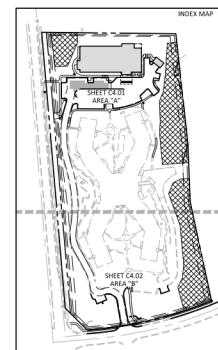

#### REVISIONS

- No. Date  
 1 03.18.2024 REVISED FOR 1st ASR COMMENTS  
 2 03.24.2024 REVISED FOR 2nd ASR COMMENTS  
 3 03.23.2025 REVISED FOR 3rd ASR COMMENTS

#### PLAN INFORMATION

PROJECT NO. KDC-20000  
 FILENAME KDC-20000-ASR-OA01  
 CHECKED BY LIV  
 DRAWN BY JTB  
 SCALE 1"=50'  
 DATE 08.05.2024

#### Sheet

**OVERALL UTILITY PLAN**

**C4.00**

PRELIMINARY DRAWING - NOT RELEASED FOR CONSTRUCTION

#### ATTENTION CONTRACTORS

The Construction Contractor responsible for the extension of water, sewer, and/or reuse, as approved in these plans, is responsible for providing the information required for the pre-construction meeting on the Development Portal prior to starting any construction. Raleigh Water must be notified of all reuse activity at least two weeks prior to beginning any reuse activity around critical water and sewer infrastructure. Failure to provide notice will result in a fine of \$1,000 per day. All reuse must be in the issuance of monetary funds, and require notification of all reuse activity at least two weeks prior to beginning any reuse activity. Failure to call for inspection, install, or provide maintenance on reuse equipment, or any other violation of City of Raleigh Standards will result in a one and possible exclusion from future work in the City of Raleigh.

#### CITY OF RALEIGH PUBLIC UTILITIES STANDARD UTILITY NOTES (AS APPLICABLE)

STANDARD UTILITY NOTES  
 1. ALL MATERIALS & CONSTRUCTION METHODS SHALL BE IN ACCORDANCE WITH CITY OF RALEIGH DESIGN SPECIFICATIONS (REFERENCE: CORPID HANDBOOK, CURRENT EDITION)

2. UTILITY SEPARATION REQUIREMENTS:  
 A) A DISTANCE OF 100' SHALL BE MAINTAINED BETWEEN SANITARY SEWER & ANY PRIVATE OR PUBLIC WATER MAINS OR SEWER MAINS LOCATED AS A SOURCE OF DRINKING WATER. IF ADEQUATE LATERAL SEPARATION CANNOT BE ACHIEVED, FERROUS SANITARY SEWER PIPE SHALL BE SPECIFIED & INSTALLED TO WATERLINE SPECIFICATIONS. HOWEVER, THE MINIMUM SEPARATION SHALL NOT BE LESS THAN 10' AND SHALL NOT EXCEED 100'. SEE CORPID HANDBOOK FOR DETAILS.

B) WHEN INSTALLING WATER & SEWER MAINS, THE HORIZONTAL SEPARATION BETWEEN UTILITIES SHALL BE 100'. IF THIS SEPARATION CANNOT BE MAINTAINED DUE TO EXISTING CONDITIONS, THE MAXIMUM VERTICAL SEPARATION SHALL BE 10' FROM THE TOP OF THE WATER MAIN TO THE TOP OF THE WATER MAIN AT LEAST 10' ABOVE THE TOP OF THE SEWER & MUST BE APPROVED BY THE PUBLIC UTILITIES DIRECTOR. ALL DISTANCES ARE MEASURED FROM OUTSIDE DIAMETER TO OUTSIDE DIAMETER.

C) WHERE IT IS IMPOSSIBLE TO OBTAIN PROPER SEPARATION, OR ANTIMAINTAIN SANITARY SEWER PASSES OVER A WATERLINE, THE WATERLINE SHALL BE SPACED AS EXTENDED ON EACH SIDE OF CROSSING MUST BE SPECIFIED & INSTALLED TO WATERLINE SPECIFICATIONS.

D) 5' 0" MINIMUM HORIZONTAL SEPARATION IS REQUIRED BETWEEN ALL SANITARY SEWER & STORM SEWER FACILITIES, UNLESS DIP MATERIAL IS SPECIFIED FOR SANITARY SEWER.

E) MAINTAIN 18" MIN. VERTICAL SEPARATION AT ALL WATERLINE & RCP STORM DRAIN CROSSINGS; MAINTAIN 18" MIN. VERTICAL SEPARATION AT ALL SANITARY & RCP STORM DRAIN CROSSINGS. WHERE ADEQUATE SEPARATIONS CANNOT BE ACHIEVED, SPECIFY DIP MATERIAL & A CONCRETE CRADLE HAVING 6" DIP (PER CORPID HANDBOOK W-41 8-5-49).

F) ALL OTHER UNDERGROUND UTILITIES SHALL CROSS WATER & SEWER FACILITIES WITH 18" MIN. VERTICAL SEPARATION.

G) ANY NECESSARY FIELD REVISIONS ARE SUBJECT TO REVIEW & APPROVAL OF AN AMENDED PLAN & PROFILE BY THE CITY OF RALEIGH PUBLIC UTILITIES DEPARTMENT PRIOR TO CONSTRUCTION.

H) DEVELOPERS SHALL PROVIDE 30 DAYS ADVANCE WRITTEN NOTICE TO OWNER FOR WORK REQUIRED WITHIN AN EXISTING CITY OF RALEIGH UTILITY EASEMENT TRaversing PRIVATE PROPERTY.

I) CONTRACTOR SHALL MAINTAIN CONTINUOUS WATER & SEWER SERVICE TO EXISTING RESIDENCES & BUSINESS FACILITIES DURING CONSTRUCTION. THIS REQUIREMENT SHALL BE MAINTAINED UNTIL APPROVAL IS RECEIVED BY A 24-HOUR ADVANCE NOTICE TO THE CITY OF RALEIGH PUBLIC UTILITIES DEPARTMENT.

J) SEWER BYPASS PUMPING - A BYPASS PLATE SEALED BY AN NC PROFESSIONAL ENGINEER SHALL BE PROVIDED TO RALEIGH WATER PRIOR TO PUMPING OPERATIONS FOR APPROVAL THE OPERATIONS AND EQUIPMENT USED FOR BYPASS PUMPING (SEE CORPID HANDBOOK).

K) 7' 0" MINIMUM COVER IS REQUIRED ON ALL WATER MAINS & SEWER MAINS. 4' 0" MINIMUM COVER IS REQUIRED FOR ALL REUSE MAINS.

L) IT IS THE DEVELOPER'S RESPONSIBILITY TO ABANDON OR REMOVE EXISTING WATER & SEWER SERVICES NOT BEING USED IN DEVELOPMENT OF A SITE, UNLESS OTHERWISE DIRECTED BY THE CITY OF RALEIGH PUBLIC UTILITIES DEPARTMENT. THIS REQUIREMENT SHALL BE MAINTAINED UNTIL APPROVAL IS RECEIVED BY A 24-HOUR ADVANCE NOTICE TO THE CITY OF RALEIGH PUBLIC UTILITIES DEPARTMENT.

M) 8" PVC SEWER SERVICES WITH METERS LOCATED AT ROW OR ROW AND 2" PVC WATERLINE TAKEN FROM THE EXISTING CITY OF RALEIGH UTILITY EASEMENT TO PROPERTY SIZE THE WATER SERVICE FOR EACH CONNECTION TO PROVIDE ADEQUATE FLOW & PRESSURE.

N) INSTALL 8" DIP SEWER SERVICES @ 1% MINIMUM GRADE WITH CLEAUNOTS LOCATED AT ROW OR EASEMENT LINE AND SPACED EVERY 75 LINEAR FEET MAXIMUM.

O) PRESSURE REDUCING VALVES ARE REQUIRED ON ALL WATER SERVICES PUMPING 80 PSI; BACKWATER VALVE IS REQUIRED ON ALL WATER SERVICES HAVING BUILDING DRAINS LOWER THAN 1' 0" ABOVE THE NEXT UPSTREAM MAIN.

P) ALL ENVIRONMENTAL PERMITS APPLICABLE TO THE PROJECT MUST BE OBTAINED FROM NCDCW, USACE & FEMA FOR ANY RIPARIAN BUFFER, WETLAND & FLOODPLAIN IMPACTS (RESPECTIVELY). PERMITTING IS THE RESPONSIBILITY OF THE DEVELOPER.

Q) NOGAT / RAILROAD ENCROACHMENT AGREEMENTS ARE REQUIRED FOR ANY UTILITY WORK (INCLUDING MAIN EXTENSIONS & SERVICE TAPS) WITHIN STATE OR RAILROAD ROW PRIOR TO CONSTRUCTION.

R) GREASE CATCHER CALCULATION & INSTALLATION SPECIFICATIONS SHALL BE APPROVED BY THE RW FOI PROGRAM COORDINATOR PRIOR TO ISSUANCE OF A UC AND/OR BUILDING PERMIT. CONTACT (919) 956-4516 OR FOI@RALEIGHNC.GOV FOR MORE INFORMATION.

S) CROSS CONNECTION CONTROL PROTECTION DEVICES ARE REQUIRED BASED ON THE DEGREE OF HAZARD INVOLVED AS LISTED IN APPENDIX B OF THE RULES GOVERNING PUBLIC WATER SYSTEMS IN NORTH CAROLINA.

T) THE DEVICES SHALL MEET THE AMERICAN SOCIETY OF SANITARY ENGINEERING (A.S.A.E) STANDARDS AND BE ON THE UNIVERSITY OF SOUTHERN CALIFORNIA APPROVAL LIST.

U) THE DEVICE AND INSTALLATION SHALL MEET THE GUIDELINES OF APPENDIX A - GUIDELINES AND REQUIREMENTS FOR THE PROTECTION OF PUBLIC WATER SYSTEMS.

V) THE DEVICES SHALL BE INSTALLED AND TESTED (BOTH, INITIAL AND PERIODIC TESTING THEREAFTER) IN ACCORDANCE WITH THE MANUFACTURER'S RECOMMENDATIONS OR THE LOCAL CROSS CONNECTION CODE. IF THE LOCAL CODE IS MORE STRINGENT, CONTACT CROSS.CONNECTION@RALEIGHNC.GOV FOR MORE INFORMATION.


W) NOTICE FOR PROJECTS THAT INVOLVE AN OVERRSIZE MAIN OR URBAN MAIN REPLACEMENT, ANY CITY REIMBURSEMENT GREATER THAN \$250,000.00 MUST UNDERGO THE PUBLIC BIDDING PROCESS.

SEE SHEET C0.00 FOR ALL PROJECT NOTES.

ALL CONSTRUCTION SHALL CONFORM WITH THE LATEST VERSION OF THE CITY OF RALEIGH AND NCDOF STANDARDS, SPECIFICATIONS AND DETAILS.



GRAPHIC SCALE  
0 100  
1 in = 50 ft.

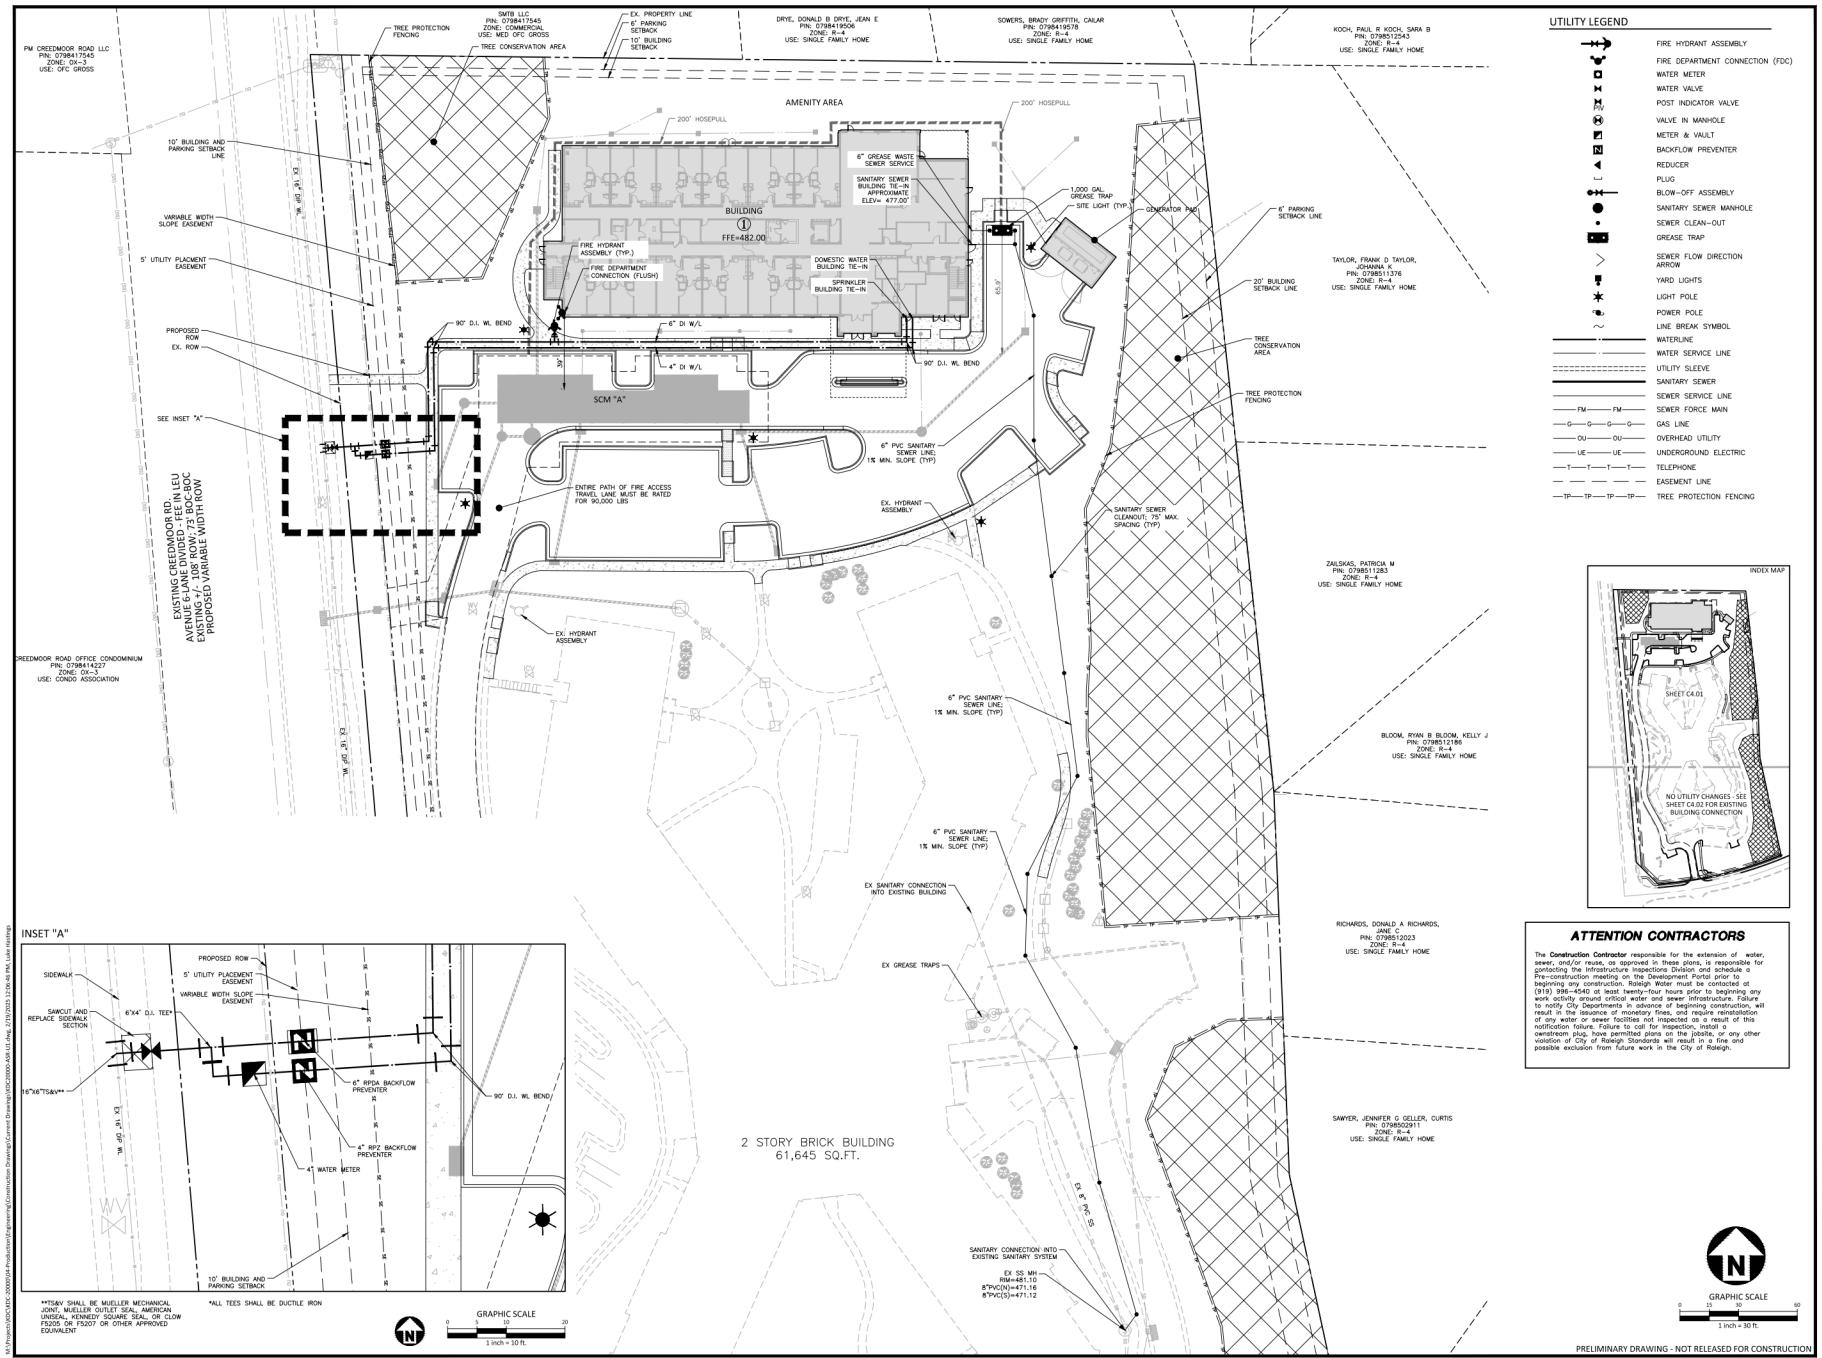

**ABBOTTSWOOD AT  
STONEHENGE**  
ADMINISTRATIVE SITE REVIEW  
ASR-0056-2024  
7900 CREAMMOOR ROAD  
RALEIGH, NORTH CAROLINA 27612

**MCADAMS**  
The John R. McAdams Company, Inc.  
2905 Merriman Parkway  
Durham, NC 27713  
  
phone 919.361.5000  
fax 919.361.2269  
license number: C-0293, C-187  
  
[www.mcadamsco.com](http://www.mcadamsco.com)

#### CLIENT

## **CLIENT**

MR. JOE WHITEHOUSE  
FISCO SENIOR LIVING  
5790 FLEET STREET, SUITE 300  
CARLSBAD, CALIFORNIA 92008

## REVISIONS

- NO. DATE REVISED PER

1	10.18.2024	1st ASR COMMENTS
2	12.04.2024	2nd ASR COMMENTS
3	02.19.2025	3rd ASR COMMENTS

## PLAN INFORMATION

PROJECT NO. KDC-20000  
FILENAME KDC20000-ASR-U1.DWG  
CHECKED BY LIV  
DRAWN BY JTB  
SCALE 1"=30'  
DATE 08.05.2024

## **DETAILED UTILITY PLAN**


## **DETAILED UTILITY PLAN**

24/21

(40)

84.01

C4.01

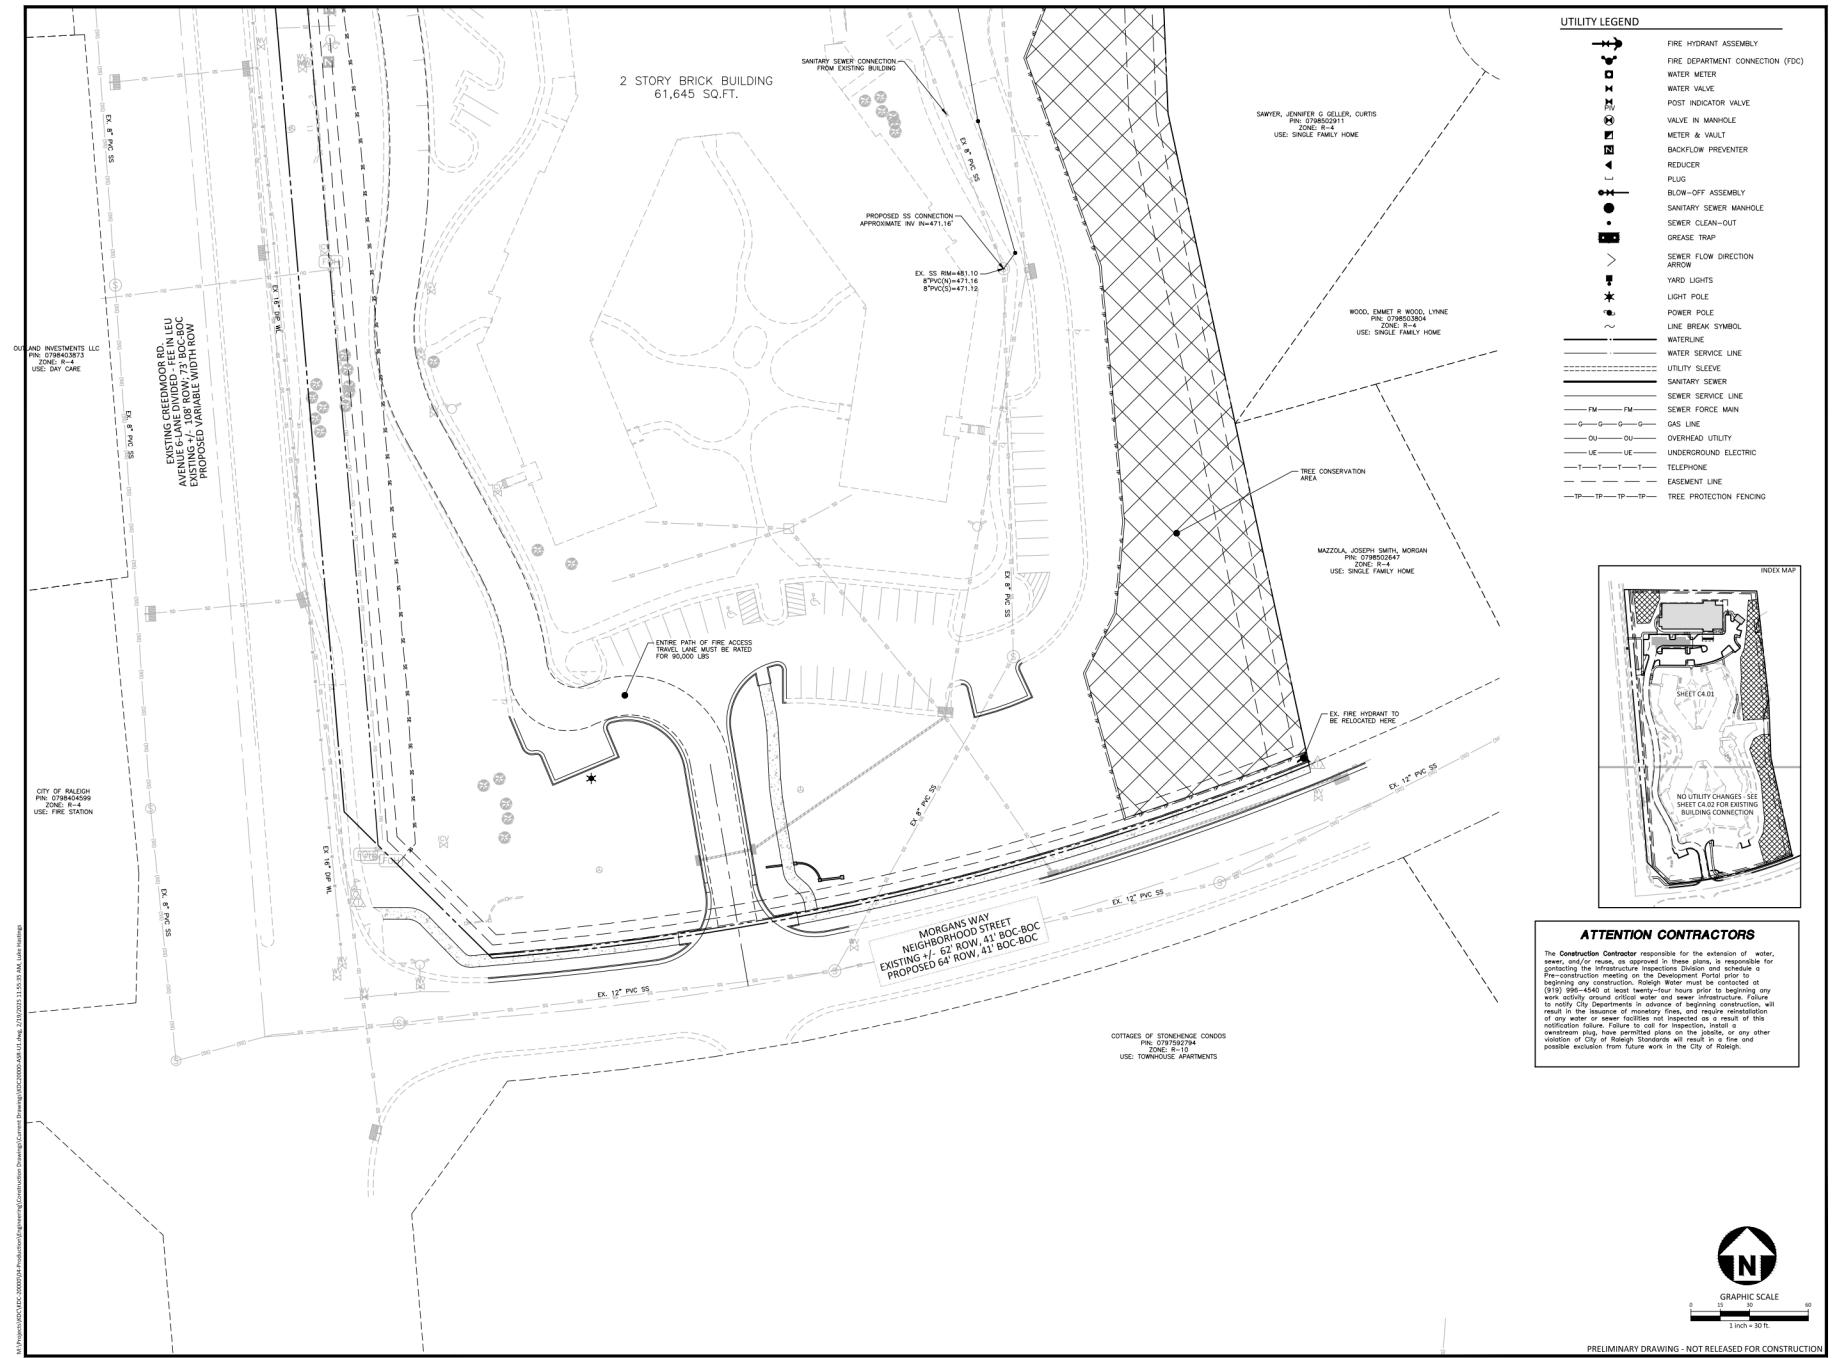

MCADAMS

The John R. McAdams Company, Inc.  
2905 Meridian Parkway  
Durham, NC 27713

phone 919. 361. 5000  
fax 919. 361. 2269  
license number: C-0293, C-187

[www.mcadamsco.com](http://www.mcadamsco.com)

## CLIENT

MR. JOE WHITEHOUSE  
KISCO SENIOR LIVING  
5790 FLEET STREET, SUITE 300  
CARLSBAD, CALIFORNIA 92008

ABBOTTSWOOD AT  
STOKE  
ON TRENT

**STONEHENGE** ADMINISTRATIVE SITE REVIEW

**ASR-0056-2024**  
**7900 CREAMMOOR ROAD**  
RALEIGH, NORTH CAROLINA, 27613

## REVISIONS

- | NO. | DATE       | REVISION                     |
|-----|------------|------------------------------|
| 1   | 10.18.2024 | REVISED PER 1st ASR COMMENTS |
| 2   | 12.04.2024 | REVISED PER 2nd ASR COMMENTS |
| 3   | 02.19.2025 | REVISED PER 3rd ASR COMMENTS |

## PLAN INFORMATION

PROJECT NO.	KDC-20000
FILENAME	KDC20000-ASR-U1.DWG
CHECKED BY	LJV
DRAWN BY	JTB
SCALE	1"=30'
DATE	08.05.2024

---

## **DETAILED UTILITY PLAN**

## **DETAILED UTILITY PLAN**

212

C4 C5

C4.02

## C4.02





**MCADAMS**

The John R. McAdams Company, Inc.

2905 Meridian Parkway

Durham, NC 27713

phone 919.361.5000

fax 919.361.2266

license number: C-2929-C-187

www.mcadamsco.com

**CLIENT**

MRI JOE WHITEHOUSE


KISCO SENIOR LIVING

5290 FLEET STREET, SUITE 300

CALIFORNIA, CALIFORNIA 92008

## ABBOTTSWOOD AT STONEHENGE ADMINISTRATIVE SITE REVIEW ASR-0056-2024

7900 CREEDMOOR ROAD  
RALEIGH, NORTH CAROLINA, 27613

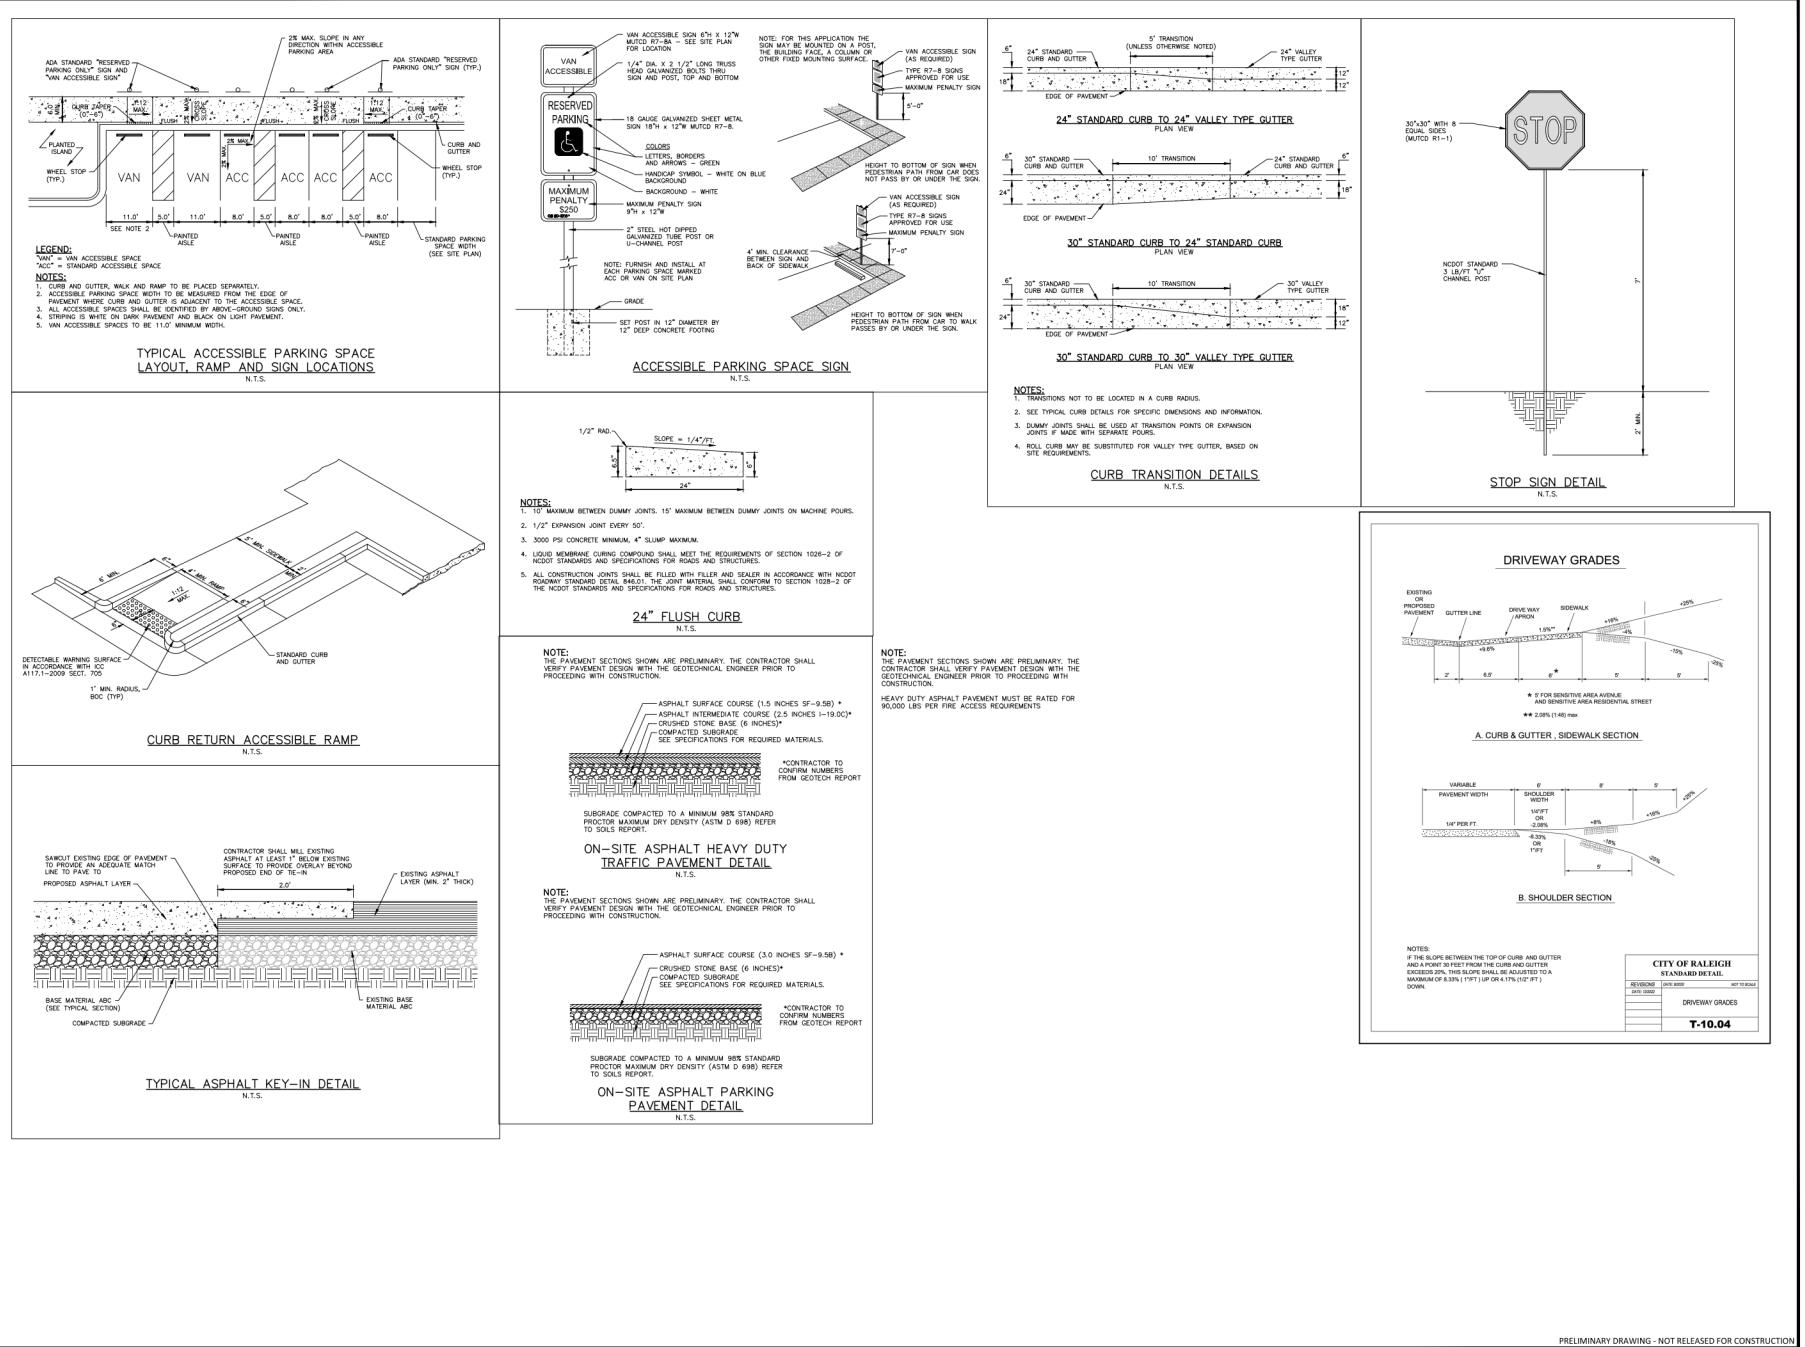



**MCADAMS**

The John R. McAdams Company, Inc.  
2905 Meridian Parkway  
Durham, NC 27713

Phone: 919.361.5000  
Fax: 919.361.2266  
License number: C-2929









www.mcadamsco.com

**CLIENT**

MRI. JOE WHITEHOUSE  
KCSO SENIOR LIVING  
5270 FLEET STREET, SUITE 300  
CALIFORNIA, CALIFORNIA 92908

**ABBOTTSWOOD AT STONEHENGE**  
**ADMINISTRATIVE SITE REVIEW**  
**ASR-0056-2024**

7900 CREEDMOOR ROAD  
RALEIGH, NORTH CAROLINA, 27613

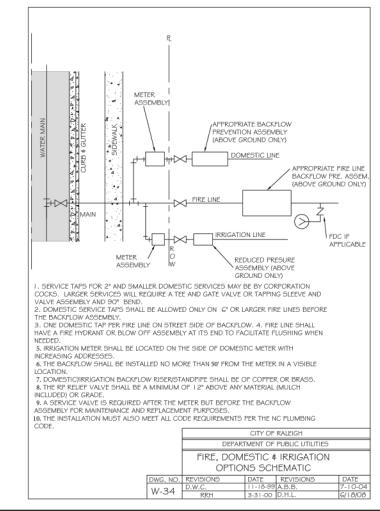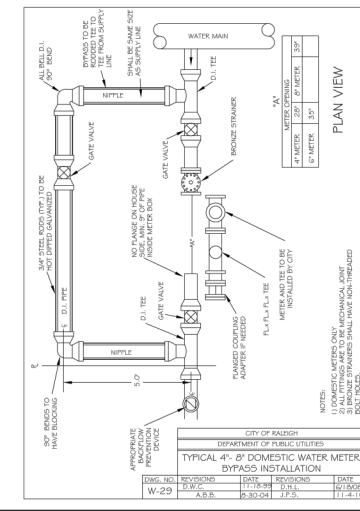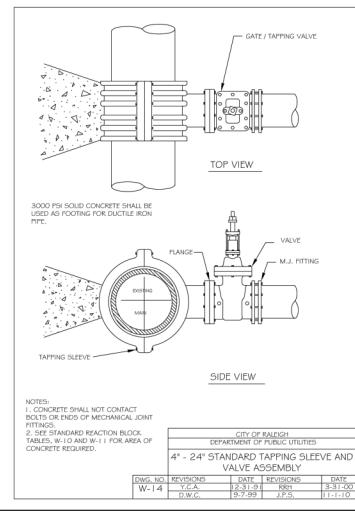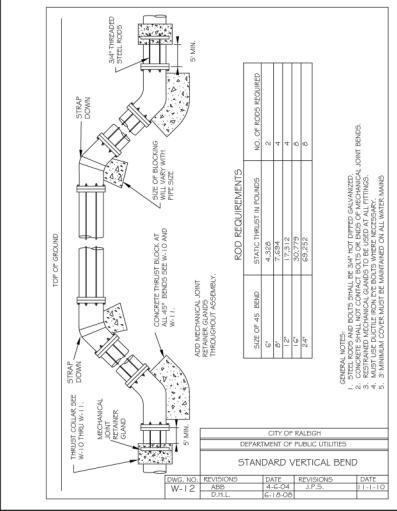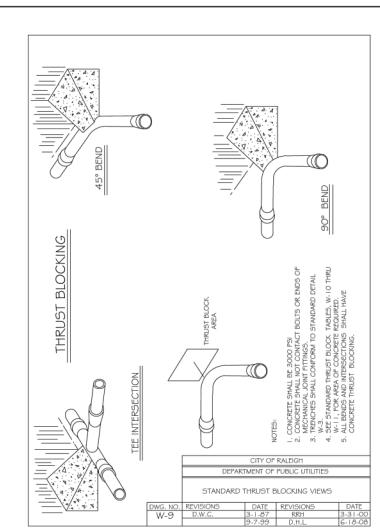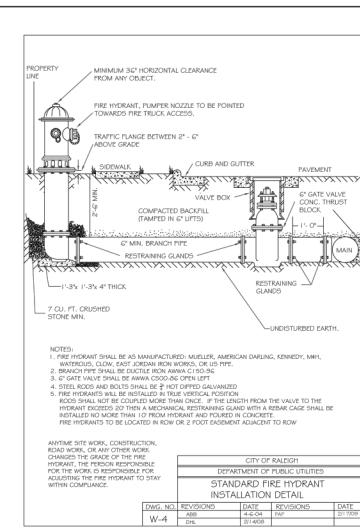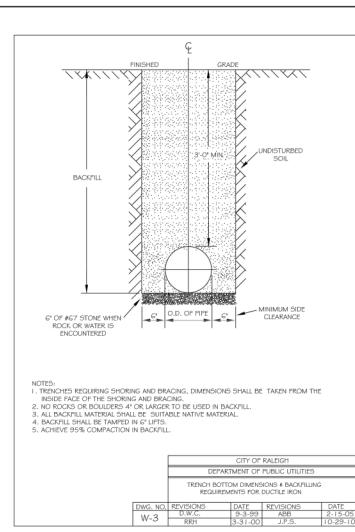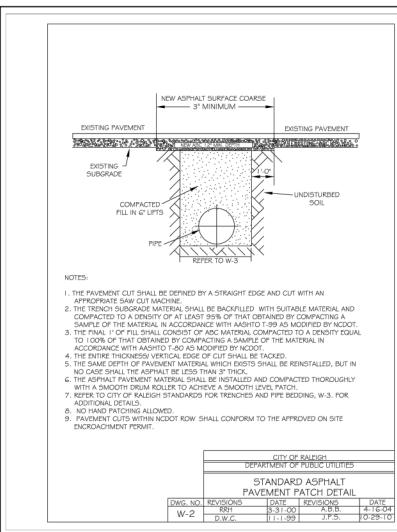

**REVISIONS**

- 1. 10-10-2024 REVISED FOR 2nd PH ASR COMMENTS
- 2. 12-04-2025 REVISED FOR 3rd PH ASR COMMENTS
- 3. 02-20-2025 REVISED FOR 3rd PH ASR COMMENTS

**PLAN INFORMATION**

PROJECT NO.: KDC-20000  
FILENAME: KDC20000-ASR-01.DWG  
CHECKED BY: LIV  
DRAWN BY: LIV  
SCALE: NTS  
DATE: 08.2024  
SHEET: C8.02

**WATER DETAILS**

**C8.02**

PRELIMINARY DRAWING - NOT RELEASED FOR CONSTRUCTION





**McADAMS**

The John R. McAdams Company, Inc.  
2905 Meridian Parkway  
Durham, NC 27713

phone 919.361.5000

fax 919.361.2269








license number: C-2929

www.mcadamsco.com

**CLIENT**

MR. JOE WHITEHOUSE  
KCSO SENIOR LIVING  
5270 FLEET STREET, SUITE 300  
CALIFORNIA, CALIFORNIA 92008

**ABBOTTSWOOD AT STONEHENGE**  
**ADMINISTRATIVE SITE REVIEW**  
**ASR-0056-2024**  
**7900 CREEDMOOR ROAD**  
**RALEIGH, NORTH CAROLINA, 27613**

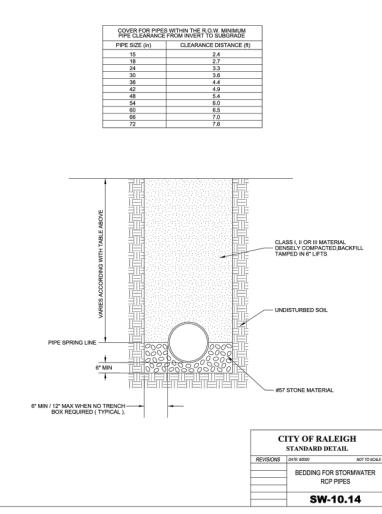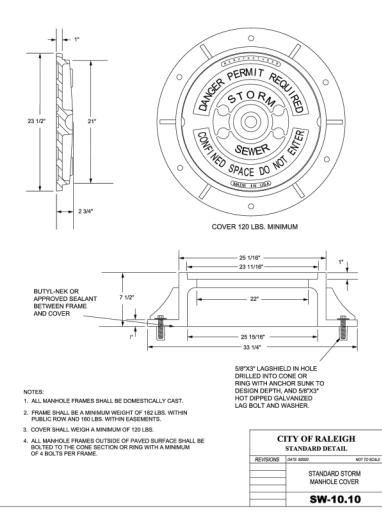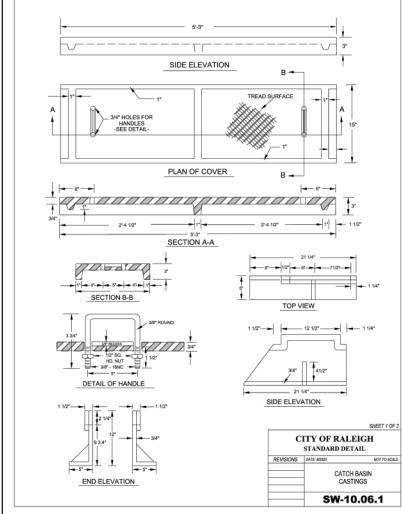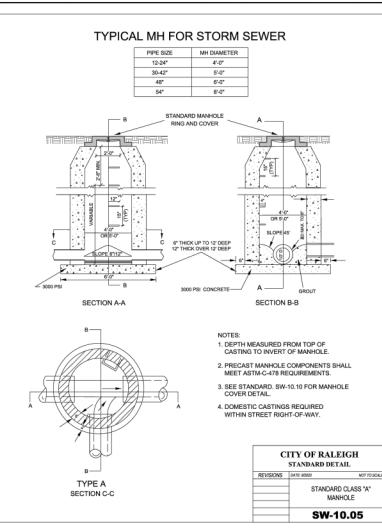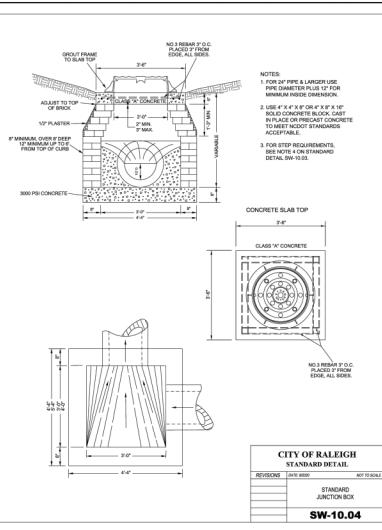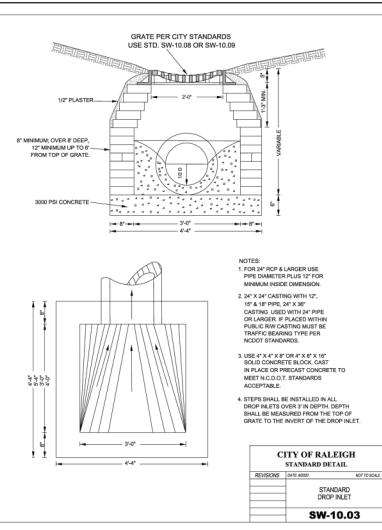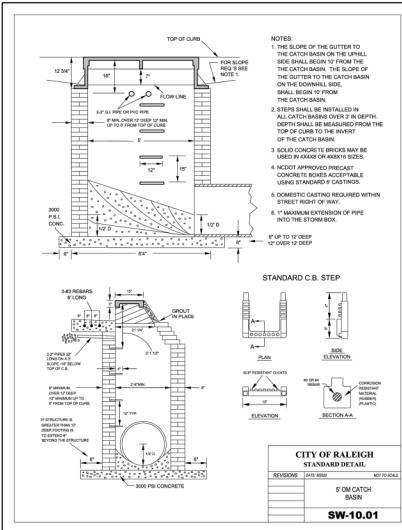

**REVISIONS**

1. 10.03.2024 REVISED PER ESR ASR COMMENTS
2. 12.04.2024 REVISED PER 2nd ESR COMMENTS
3. 02.05.2025 REVISED PER 3rd ESR COMMENTS

**PLAN INFORMATION**

PROJECT NO.: KDC-20000  
FILENAME: KDC20000-ASR-01.DWG  
CHECKED BY: LIV  
DRAWN BY: LIV  
SCALE: NTS  
DATE: 08.05.2024

**SHEET**

**STORM DRAINAGE DETAILS**

**C8.04**

PRELIMINARY DRAWING - NOT RELEASED FOR CONSTRUCTION



**MCADAMS**

The John R. McAdams Company, Inc.  
2905 Meridian Parkway  
Durham, NC 27713

phone 919.361.5000

fax 919.361.2269





license number: C-2939. C-187

www.mcadamsco.com

**CLIENT**

MR. JES WHITEHOUSE  
KINCS SENIOR LIVING  
5790 FLEET STREET, SUITE 300  
CARLSBAD, CALIFORNIA 92008

**ABBOTTSWOOD AT STONEHENGE**  
**ADMINISTRATIVE SITE REVIEW**  
**ASR-0056-2024**  
**7900 CREEDMOOR ROAD**  
**RALEIGH, NORTH CAROLINA, 27613**

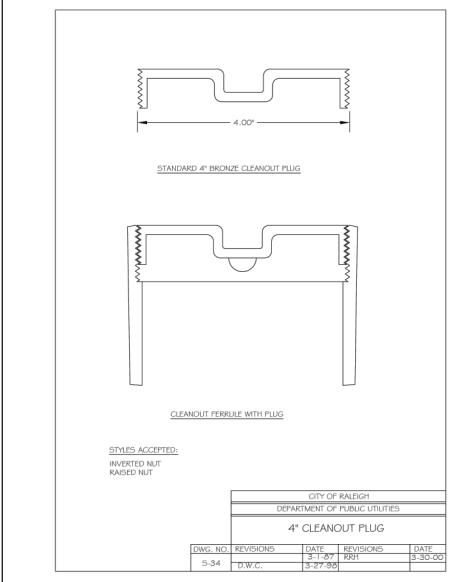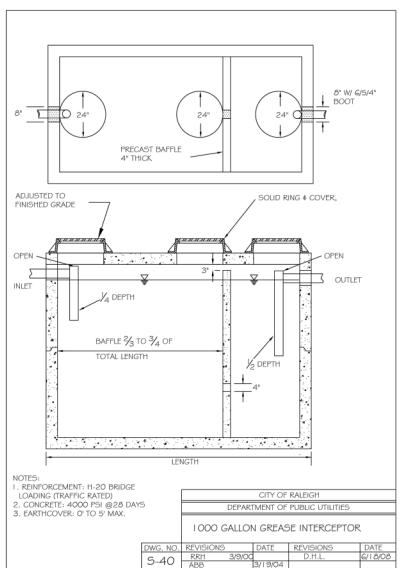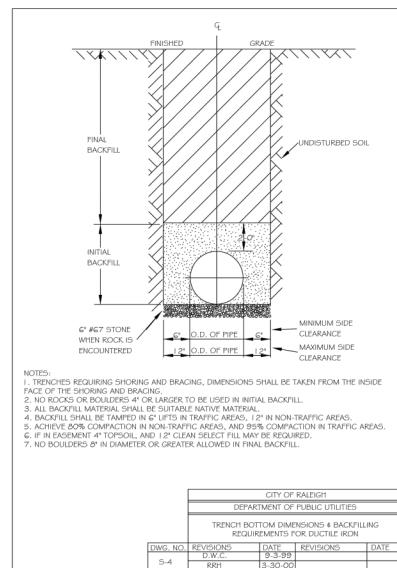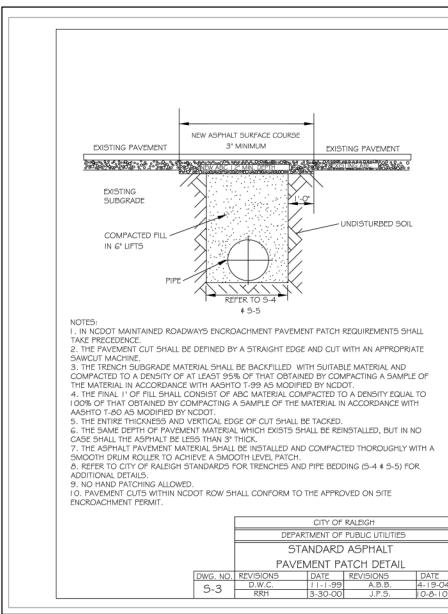

LOCALLY AVAILABLE SIZES	
INTERCEPTORS CAPACITY (GAL)	SEPARATORS CAPACITY (GAL)
300	1000
550	1200
1100	1600
1200	
1700	
2000	
2500	
3000	
4000	
5000	
6000	
8000	

**NOTES:**

1. Baffle wall located at a distance from inlet wall  $\frac{1}{2}$  to  $\frac{3}{4}$  of the total length of the interceptor or separator as shown on detail S-40.
2. Baffle walls located at a distance approximately  $\frac{1}{3}$  of the total length of the separator or interceptor from the inlet tee.
3. EACH INTERCEPTOR OR SEPARATOR SHALL HAVE INLET AND OUTLET TEES. THE OUTLET TEES SHALL BE LOCATED IN THE CENTER OF THE SEPARATOR OR INTERCEPTOR. THE OUTLET TEES SHALL BE OPEN TO ALLOW FOR DRAINAGE OF LIQUID. INLET AND OUTLET TEES MUST BE OPEN TO ALLOW THE COLLECTION OF F.O.G. SAMPLES.
4. ACCESS OPENINGS OVER EACH COMPARTMENT WITHIN THE INTERCEPTOR OR SEPARATOR SHALL BE 24 INCHES IN DIAMETER AND CONTAIN ROLL HOLE. ALL COVERS SHALL BE CONSTRUCTED OF CAST IRON OR CORVAN PLATE. COVERS SHALL BE TIGHTLY SECURED TO THE INTERCEPTOR OR SEPARATOR TO FINISH GRADE AND BE INSTALLED TO EXCLUDE THE ENTRANCE OF STORMWATER INTO THE INTERCEPTOR OR SEPARATOR.
5. FULL SIZE DUAL SWEEP CLEANOUTS SHALL BE INSTALLED ON THE INLET AND OUTLET SIDES OF THE INTERCEPTOR OR SEPARATOR.
6. INTERCEPTORS AND SEPARATORS MUST BE VENTED IN ACCORDANCE WITH THE NC STATE PLUMBING CODE.
7. DESIGN AS S-16 BUILDING CODE
8. DESIGN AS S-16 BUILDING CODE
9. INTERCEPTORS AND SEPARATORS SHALL BE DESIGNED TO WITHSTAND AN H-20 WHEEL LOAD.
10. INTERCEPTORS OR SEPARATORS MADE OF POLYETHYLENE OR HDPE/HDPE SHALL INCLUDE A MINIMUM 1000 psi TENSILE STRENGTH, 2000 psi FLEXURAL STRENGTH, AND 10000 psi FUSURAL MODULUS.
11. ALL INTERCEPTORS AND SEPARATORS SHALL BE INSTALLED IN ACCORDANCE WITH THE MANUFACTURER'S SPECIFICATIONS.

CITY OF RALEIGH	DEPARTMENT OF PUBLIC UTILITIES			
DIMENSIONS: GREASE INTERCEPTORS OIL-WATER-SAND SEPARATORS				
DWG. NO.	REVISI ONS	DATE	REVISI ONS	DATE
S-41	R.R.H.	3/30/04	D.H.L.	6/1/00
	ANNUAL	[REDACTED]	JULY	[REDACTED]

**REVISIONS**

1. 10-10-2024 REVISED PER 1st ASR COMMENTS
2. 12-04-2024 REVISED PER 2nd ASR COMMENTS
3. 02-19-2025 REVISED PER 3rd ASR COMMENTS

**PLAN INFORMATION**

PROJECT NO.	KDC-20000
FILENAME	KDC20000-ASR-01.DWG
CHECKED BY	LIV
DRAWN BY	LIV
SCALE	NTS
DATE	08/2024

**SHEET**

**SANITARY SEWER DETAILS**

**C8.05**

PRELIMINARY DRAWING - NOT RELEASED FOR CONSTRUCTION

## GENERAL NOTES


1. PRIOR TO CONSTRUCTION, ANY DISCREPANCIES IN THE PLANS AND NOTES SHALL BE BROUGHT TO THE ENGINEER'S ATTENTION.
2. PRIOR TO CONSTRUCTION OR PLACEMENT OF ANY BACKFILL, THE ON-SITE GEOTECHNICAL ENGINEER SHALL INSPECT THE EXCAVATION AREA FOR THE UNDERGROUND SCM WITHIN THIS AREA TO ASSESS WHETHER SUITABLE SOILS EXIST AT THE SURFACE LEVEL. IF THE CONTRACTOR CONSTRUCTS AND COVERS UP THE UNDERGROUND SCM PRIOR TO INSPECTION, THEN THIS AREA SHALL BE UNCOVERED AND TESTED TO THE ENGINEER'S AND OWNER'S APPROVAL AT THE CONTRACTOR'S EXPENSE.
3. THE CONTRACTOR SHALL NOT USE ANY SOILS THAT DO NOT MEET THE REQUIREMENTS FOR THE SCM SYSTEM.
4. PRIOR TO PLACING STORMWATER CARTRIDGES WITHIN THE UNDERGROUND SCM, THE CONTRACTOR SHALL REQUEST AN INSPECTION MEETING WITH THE DESIGN ENGINEER AND THE EROSION CONTROL INSPECTOR TO INSURE THE UPSTREAM DRAINAGE AREA IS COMPLETELY STABILIZED & HAS GOOD VEGETATION COVERAGE. IF THE CONTRACTOR DECIDES TO PLACE THE STORMWATER CARTRIDGES PRIOR TO APPROVAL FROM THE DESIGN ENGINEER AND THE EROSION CONTROL INSPECTOR, THE CONTRACTOR SHALL PAY ALL COSTS ASSOCIATED WITH THE APPROVAL BY THE ON-SITE GEOTECHNICAL ENGINEER. THE APPROVED BACKFILL MATERIAL SHOULD HAVE A GRADATION THAT WILL NOT ALLOW THE MIGRATION OF FINES, WHICH COULD DAMAGE THE SCM SYSTEM. THE CONTRACTOR SHALL NOT USE ANY BACKFILL MATERIAL THAT IS APPROVED BY THE ON-SITE GEOTECHNICAL ENGINEER. THE APPROVED BACKFILL MATERIAL SHOULD HAVE A GRADATION THAT WILL NOT ALLOW THE MIGRATION OF FINES, WHICH COULD DAMAGE THE SCM SYSTEM.
5. ONCE CONSTRUCTED, THE STORMWATER CARTRIDGES SHALL NOT RECEIVE UNSTABILIZED BACKFILL UNTIL THE ENTIRE CONTRIBUTING DRAINAGE AREA IS STABILIZED AND THE STORMWATER CARTRIDGE SITE CONSTRUCTION IS COMPLETE.
6. ALL COMPONENTS OF THE UNDERGROUND SCM SYSTEM (JUNCTION BOXES, ACCESS MANHOLES, ETC.) SHALL BE DESIGNED BY OTHERS. ANY VARIATIONS OR CHANGES MADE FROM THESE SPECIFICATIONS AND DRAWINGS DURING THE ORDERING AND/ OR INSTALLATION OF ALL COMPONENTS MUST BE APPROVED BY THE DESIGN ENGINEER. THE STRUCTURAL DESIGN OF THE UNDERGROUND SCM, ALONG WITH ITS FUNCTIONALITY, IS THE RESPONSIBILITY OF THE DESIGN ENGINEER. THE CONTRACTOR SHALL NOT BE HELD LIABLE FOR ANY VARIATIONS OR CHANGES MADE TO THE STRUCTURAL DESIGN OF THE UNDERGROUND SCM SYSTEM.
7. ALL PIPERELINE CONNECTIONS AND JOINTS CONNECTED WITH THE STORMWATER FILTER SYSTEM AND UNDERGROUND DETENTION PIPE SHALL BE WATER TIGHT AND LEAK FREE.
8. THE CONTRACTOR SHALL FURNISH, INSTALL, OPERATE, AND MAINTAIN ANY PUMPING EQUIPMENT, ETC., NEEDED FOR REMOVAL OF WATER FROM VARIOUS PARTS OF THE SAND FILTER SYSTEM. IT IS ANTICIPATED THAT PUMPING WILL BE NECESSARY IN THE EXCAVATION AREAS DURING PLACEMENT OF FILL WITHIN THIS AREA (OR OTHER AREAS AS NECESSARY). THE CONTRACTOR SHALL KEEP THE WATER LEVEL BELOW THE BOTTOM OF THE EXCAVATION AREAS. THE GRADE OF THE BEDDING REMOVED SHALL BE SUCH THAT THE EXCAVATION BOTTOM AND SIDE SLOPES ARE STABLE.
9. IT SHALL BE THE RESPONSIBILITY OF THE CONTRACTOR TO ADHERE TO ALL CURRENT OSHA REGULATIONS FOR CONFINED SPACE ENTRY AND PROVIDE SUCH DURING ENGINEER WALK-THROUGH/INSPECTION.
10. ALL PIPE PENETRATIONS THROUGH A CONCRETE OR CMP STRUCTURE (E.G. STORMWATER CARTRIDGE / DETENTION SYSTEM, STORM DRAINAGE MANHOLES, ETC.) SHALL BE FAIRLY TIGHT USING NON-SHRINK CEMENTITIOUS GROUT.
11. ACCESS MANHOLES SHALL INCLUDE LADDERS OR MANHOLE STEPS. IF, AT ANY ACCESS POINT, MANHOLE DEPS SHOULD RESULT IN A 1" DEEP GREATER THAN THE DEPTH OF THE ACCESS MANHOLE, THE CONTRACTOR SHALL PROVIDE AN EXTENDING OR RETRACTING SECTION THAT ALLOWS THE LADDER TO BE EXTENDED ABOVE THE ACCESS HUB TO FACILITATE SAFE INGRESS AND EGRESS TO/FROM A STANDING POSITION.

## FOUNDATION NOTES

1. ONCE THE EXCAVATION IS COMPLETE AND PRIOR TO INSTALLATION OF THE UNDERGROUND SCM SYSTEM, THE ON-SITE GEOTECHNICAL ENGINEER SHALL VERIFY THE BEARING CAPACITY OF THE UNDERRYING SOILS TO SERVE AS A FOUNDATION FOR THE UNDERGROUND SCM SYSTEM. IF THE ON-SITE GEOTECHNICAL ENGINEER DETERMINES THE UNDERRYING SOILS AS UNSTABILE, THE CONTRACTOR SHALL BE REQUIRED TO PROVIDE A SUITABLE DETERIORATION BARRIER UP TO THE CONTRACTOR'S ELEVATION. THE CONTRACTOR SHALL APPROVE THE ON-SITE GEOTECHNICAL ENGINEER. THE APPROVED BACKFILL MATERIAL SHOULD HAVE A GRADATION THAT WILL NOT ALLOW THE MIGRATION OF FINES, WHICH COULD DAMAGE THE SCM SYSTEM. THE CONTRACTOR SHALL NOT USE ANY BACKFILL MATERIAL THAT IS APPROVED BY THE ON-SITE GEOTECHNICAL ENGINEER.
2. IF THE FOUNDATION SUBGRADE WILL BE EXPOSED FOR AN EXTENDED PERIOD DURING CONSTRUCTION, THEN IT SHOULD BE GRADED TO A SLIGHT SLOP SUCH THAT THE GRADE IS ABOVE THE SURFACE. THE DESIGNER'S NOTES DO NOT REQUIRE A SLOP.
3. THE CONTRACTOR SHALL TURN ON, OPERATE, AND MAINTAIN ANY PUMPING EQUIPMENT, ETC., NEEDED FOR REMOVAL OF WATER FROM THE EXCAVATION. IT IS BEST TO BEGIN THE CONSTRUCTION OF THE SAND FILTER/DETENTION SYSTEM AT THE DOWNSTREAM END WITH THE OUTLET ALREADY CONSTRUCTED TO ALLOW A ROUTE FOR WATER TO ESCAPE.
4. THE CONTRACTOR SHALL PROVIDE FOUNDATION DRAWINGS FOR THE UNDERGROUND SCM. THE FOUNDATION DRAWN SHALL CONSIST OF 8" DIAMETER PERFORATED HOLES SPACED 12' ON CENTER. THE HOLES SHALL BE 12' DEEP AND 12" IN DIAMETER. THE FOUNDATION DRAWN SHALL BE LOCATED ON THE UNDERGROUND SCM AS SHOWN ON THE DRAWINGS AND WITHIN THE VAULTS BEDDING SYSTEM (BUT NOT DIRECTLY BELOW THE VAULT). THE FOUNDATION DRAWN SYSTEM SHALL TIE TO THE NEAREST STORM SEWER INLET / JUNCTION BOX MAINTAINING A POSITIVE SLOPE TO THE DOWNSTREAM OUTLET. THE FOUNDATION DRAWN SHALL NOT TIE INTO THE UNDERGROUND VAULT AT ANY POINT.
5. THE SUBGRADE MUST SUPPORT THE DETENTION SYSTEM WITHOUT DIFFERENTIAL SETTLEMENT BETWEEN PIECES.
6. IF CONSTRUCTION EQUIPMENT WILL BE OPERATING FOR AN EXTENDED PERIOD OF TIME ON THE BEDDING, THEN THE APPROPRIATE MEASURES (E.G. STAY GEODR, ETC.) SHALL BE TAKEN TO ENSURE THE INTEGRITY OF THE BEDDING IS NOT COMPROMISED.

## BEDDING NOTES

1. THE EXCAVATION SUB GRADE MUST BE TRANSITION LEVEL.
2. THE EXCAVATION PIT SHALL BE LINED (ON THE BOTTOM AND ALL FOUR SIDES) WITH A NON-WOVEN GEO-TEXTILE (GEOTEX 401 OR APPROVED EQUIVALENT). THE ON-SITE GEOTECHNICAL ENGINEER SHALL APPROVE THE APPROVED EQUIVALENT.
3. THE EXCAVATION PIT FLOOR SHALL BE FILLED WITH 12" DEEP CLEAN GRANULAR MATERIAL WITH A MAXIMUM AGGREGATE SIZE OF 3/4". THE BEDDING SHALL BE FREE FROM ROCK FORMATIONS, PROTRUDING STONES, FROZEN LUMPS, ROOTS, AND OTHER FOREIGN MATERIAL.
4. PREPARE THE SUBGRADE PER THE ON-SITE GEOTECHNICAL ENGINEER'S DIRECTION APPROXIMATELY 5"-6" BELOW GRADE ON WHICH SLAB WILL SET. THE BEDDING MATERIAL SHOULD BE GRADED SUCH THAT A SMOOTH UNIFORM GRADE IS ESTABLISHED TO ALLOW FOR OPTIMUM PLACEMENT OF THE SAND FILTER.
5. THE SUBGRADE MUST SUPPORT THE DETENTION SYSTEM WITHOUT DIFFERENTIAL SETTLEMENT BETWEEN PIECES.
6. IF CONSTRUCTION EQUIPMENT WILL BE OPERATING FOR AN EXTENDED PERIOD OF TIME ON THE BEDDING, THEN THE APPROPRIATE MEASURES (E.G. STAY GEODR, ETC.) SHALL BE TAKEN TO ENSURE THE INTEGRITY OF THE BEDDING IS NOT COMPROMISED.

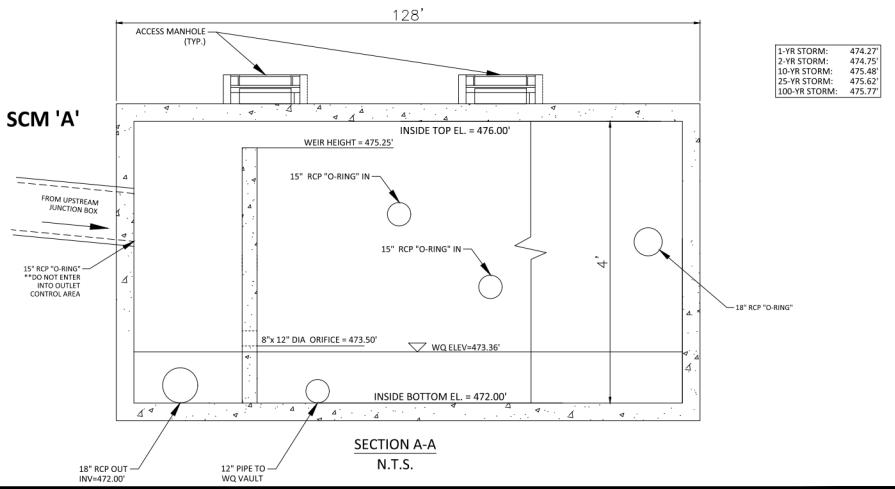

## STORMFILTER VAULT CONSTRUCTION NOTES




1. STORMWATER CONTROL MEASURE CONFIGURATION IS PROVIDED ON SHEET C9.01.
2. ABSOLUTELY NO RUNOFF SHALL ENTER THE STORMFILTER CONTROL MEASURE UNTIL ALL CONTRIBUTING DRAINAGE AREAS HAVE BEEN STABILIZED.
3. MANHOLE ACCESS SHALL BE PROVIDED FOR THE STORMFILTER CONTROL MEASURE. MANHOLES SHALL BE IN COMPLIANCE WITH CITY OF RALEIGH STANDARD DETAILS BUT SHALL BE A MINIMUM OF 24 INCHES IN DIAMETER TO COMPLY WITH OSHA CONFINED SPACE REQUIREMENTS (OR MINIMUM OSHA REQUIREMENTS APPLICABLE AT TIME OF CONSTRUCTION). CONTRACTOR SHALL PROVIDE ACCESS LADDER FOR ACCESS BELOW THE MANHOLE. MANHOLE COVERS SHALL ALLOW FOR PROPER VENTILATION.
4. THE RCP OUTLET BARREL SHALL BE CLASS IRCP, MODIFIED BELL AND SPURIT, MEETING THE REQUIREMENTS OF ASTM C76-LATEST. THE PIPE SHALL HAVE CONFINED O-RING RUBBER (ASTM D3088) AND IRCP 1441. THE PIPE LENGTH SHALL BE 12'.
5. GEOTEXTILE FABRIC FOR THE OUTLET GASKET JOINTS SHALL BE MIKAT 130N OR ENGINEER APPROVED EQUIVALENT (NON-WOVEN FABRIC). THE ON-SITE GEOTECHNICAL ENGINEER SHALL APPROVE FABRIC FOR USE.
6. ALL Poured CONCRETE SHALL BE MINIMUM 3000 psi (28 DAY) UNLESS OTHERWISE NOTED.
7. THE CONTRACTOR SHALL INSTALL THE UNDERGROUND SCM UNITS PER MANUFACTURER'S SPECIFICATIONS. CONTRACTOR TO PROVIDE A LETTER FROM MATERIAL SUPPLIER(S) STATING MATERIALS MEET THE CURRENT STANDARD PRIOR TO INSTALLATION.

## STORMWATER SYSTEM MATERIAL SPECIFICATIONS

1. THE ON-SITE GEOTECHNICAL ENGINEER SHALL SPECIFY THE BACKFILL MATERIAL FOR THE UNDERGROUND SCM SYSTEM.
2. THE BACKFILL MATERIAL SHOULD BE FREE OF ROCKS, FROZEN LUMPS, AND OTHER FOREIGN MATTER THAT COULD CAUSE HARM SPOTS WITHIN THE BACKFILL MATERIAL, OR THAT COULD DECOMPOSE AND CREATE VOIDS.
3. HIGHLY PLASTIC CLATS, HIGHLY PLASTIC CLAYS, ORGANIC SILTS, ORGANIC CLAYS, AND PEATS SHOULD NOT BE USED AS A BACKFILL MATERIAL.
4. THE BACKFILL MATERIAL SHOULD BE PLACED IN 6" LOOSE LIFTS AND COMPACTED TO 95% OF THE STANDARD PROCTOR MAXIMUM DRY DENSITY (ASTM D698). THE FILL SOILS SHOULD BE COMPACTED AT A MOISTURE CONTENT WITHIN +/- TWO PERCENT OF ITS OPTIMUM MOISTURE CONTENT.
5. ANY MATERIAL STOCKPILING ON TOP OF THE UNDERGROUND SCM SYSTEM SHALL BE APPROVED BY THE STRUCTURAL DESIGN ENGINEER.

## STATEMENT OF RESPONSIBILITY

1. ALL REQUIRED MAINTENANCE AND INSPECTIONS OF THIS FACILITY SHALL BE THE RESPONSIBILITY OF THE PROPERTY OWNER, PER THE EXECUTED OPERATION AND MAINTENANCE AGREEMENT FOR THIS FACILITY.

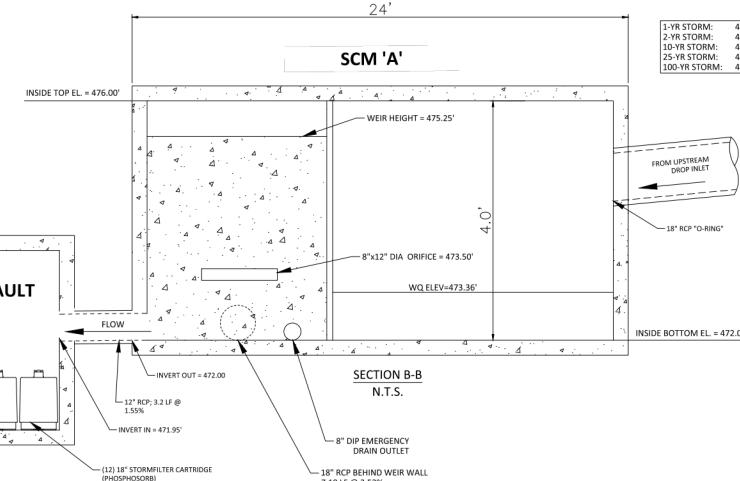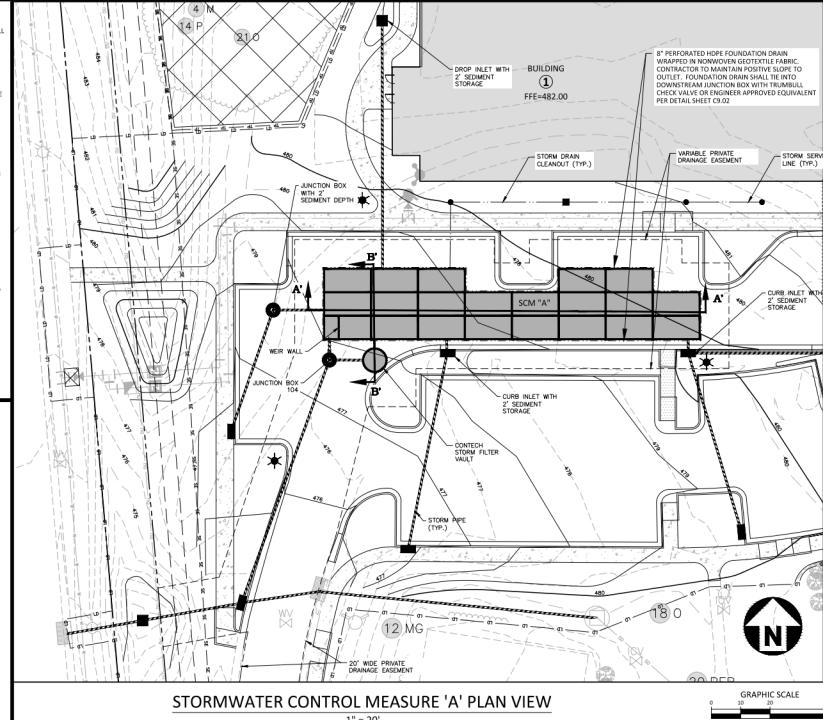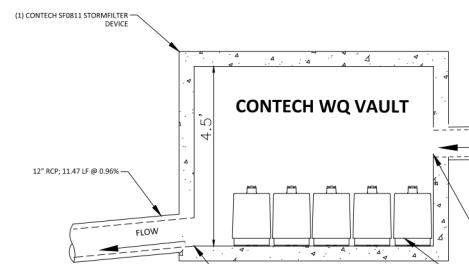

## ABBOTTSWOOD AT STONEHENGE

ADMINISTRATIVE SITE REVIEW

ASR-0056-2024

7900 CREEDMOOR ROAD

RALEIGH, NORTH CAROLINA, 27613

## REVISIONS

NO.	DATE	REVISION
1	10-10-2024	REVISED PER ESR ASR COMMENTS
2	12-04-2024	REVISED PER 2nd ESR COMMENTS
3	02-29-2025	REVISED PER 3rd ESR COMMENTS

## PLAN INFORMATION

PROJECT NO.	KDC-20000
FILENAME	KDC20000-ASR-SW1.DWG
CHECKED BY	LIV
DRAWN BY	JTB
SCALE	AS NOTED
DATE	08.2024

## SHEET

**SCM "A" PLAN VIEW AND DETAILS**  
**C9.00**

PRELIMINARY DRAWING - NOT RELEASED FOR CONSTRUCTION



The John R. McAdams Company, Inc.  
2905 Meridian Parkway  
Durham, NC 27713  
phone 919.361.5000  
fax 919.361.2206  
license number: C-2929  
www.mcadamsco.com

## CLIENT

MRI, JOE WHITEHOUSE  
KISCO SENIOR LIVING  
5280 FLEET STREET, SUITE 300  
CALIFORNIA, 92108



**MCADAMS**

The John R. McAdams Company, Inc.  
2905 Meridian Parkway  
Durham, NC 27713

phone 919.361.5000  
fax 919.361.2266  
license number: C-0293-C-187  
[www.mcadamsco.com](http://www.mcadamsco.com)

**CLIENT**

MR. JOE WHITEHOUSE  
KCSO SENIOR LIVING  
5270 FLEET STREET, SUITE 300  
CALIFORNIA, CALIFORNIA 92310

# ABBOTTSWOOD AT STONEHENGE

ADMINISTRATIVE SITE REVIEW  
ASR-0056-2024  
7900 CREEDMOOR ROAD  
RALEIGH, NORTH CAROLINA, 27613

**REVISIONS**

- 1 10.03.2024 REVISED PER E12 ASR COMMENTS
- 2 12.04.2024 REVISED PER 2nd ASR COMMENTS
- 3 02.09.2025 REVISED PER 3rd ASR COMMENTS

**PLAN INFORMATION**



PROJECT NO.: KDC-20000  
FILENAME: KDC20000-ASR-SW1.DWG  
CHECKED BY: LIV  
DRAWN BY: JTB  
SCALE: AS NOTED  
DATE: 08.05.2024

**SHEET**

**SCM DETAILS**

**C9.01**

PRELIMINARY DRAWING - NOT RELEASED FOR CONSTRUCTION

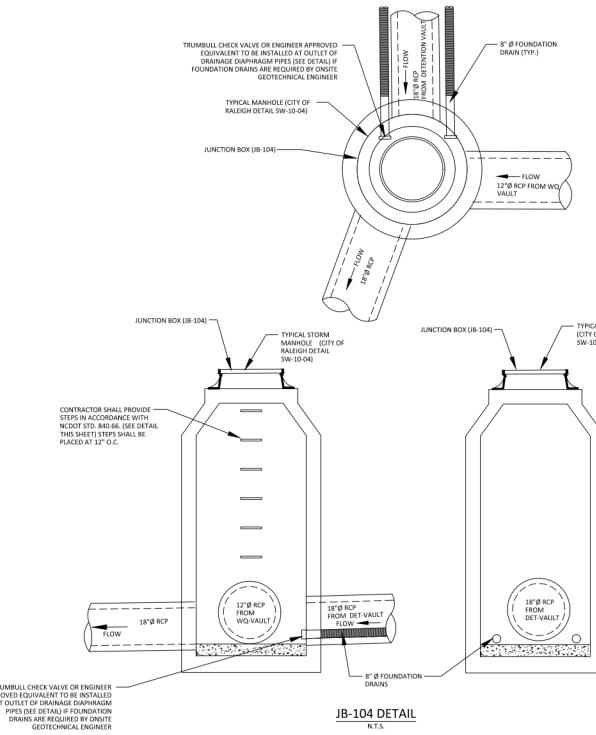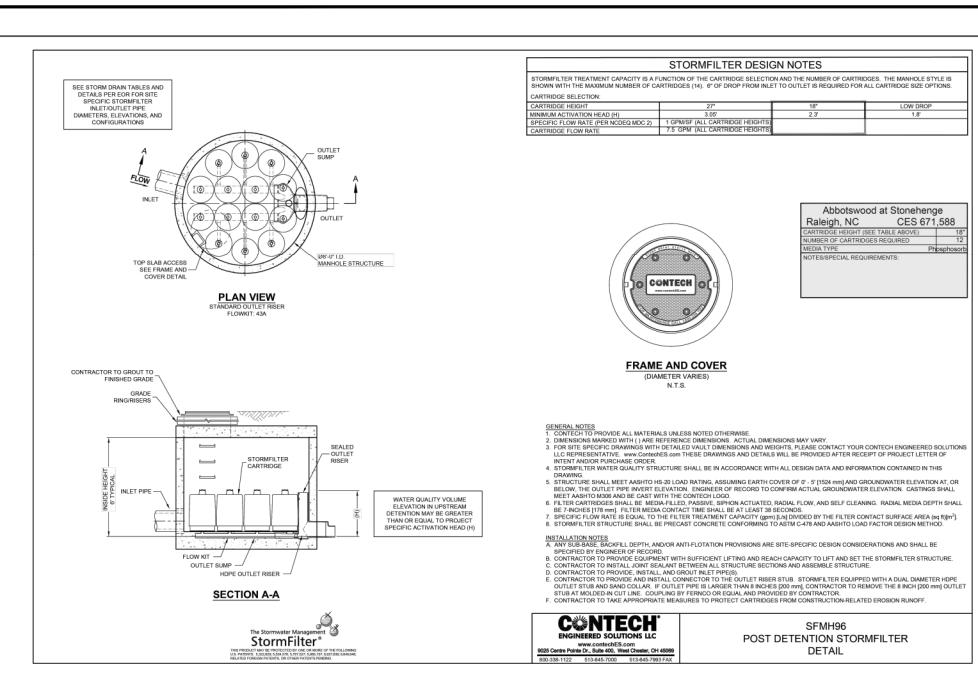

CONTRACTOR SHALL PROVIDE STEPS IN ACCORDANCE WITH NC DOT STD 845.66. (SEE DETAIL THIS SECTION SHALL BE PLACED AT 12" O.C.)

TRUMBULL CHECK VALVE OR ENGINEER APPROVED EQUIVALENT TO BE INSTALLED AT OUTLET OF FOUNDATION DRAINS (SEE DETAIL) IF FOUNDATION DRAINS ARE PROVIDED. SEE GEOTECHNICAL ENGINEER



**MCADAMS**

The John R. McAdams Company, Inc.  
2905 Meridian Parkway  
Durham, NC 27713


phone 919.361.5000  
fax 919.361.2266  
license number: C-2929-C-187

[www.mcadamsco.com](http://www.mcadamsco.com)

**CLIENT**

MR. JOE WHITEHOUSE  
KCSO SENIOR LIVING  
5270 FLEET STREET, SUITE 300  
CALIFORNIA, CALIFORNIA 92008

**ABBOTTSWOOD AT STONEHENGE**  
**ADMINISTRATIVE SITE REVIEW**  
**ASR-0056-2024**  
**7900 CREEDMOOR ROAD**  
**Raleigh, North Carolina, 27613**

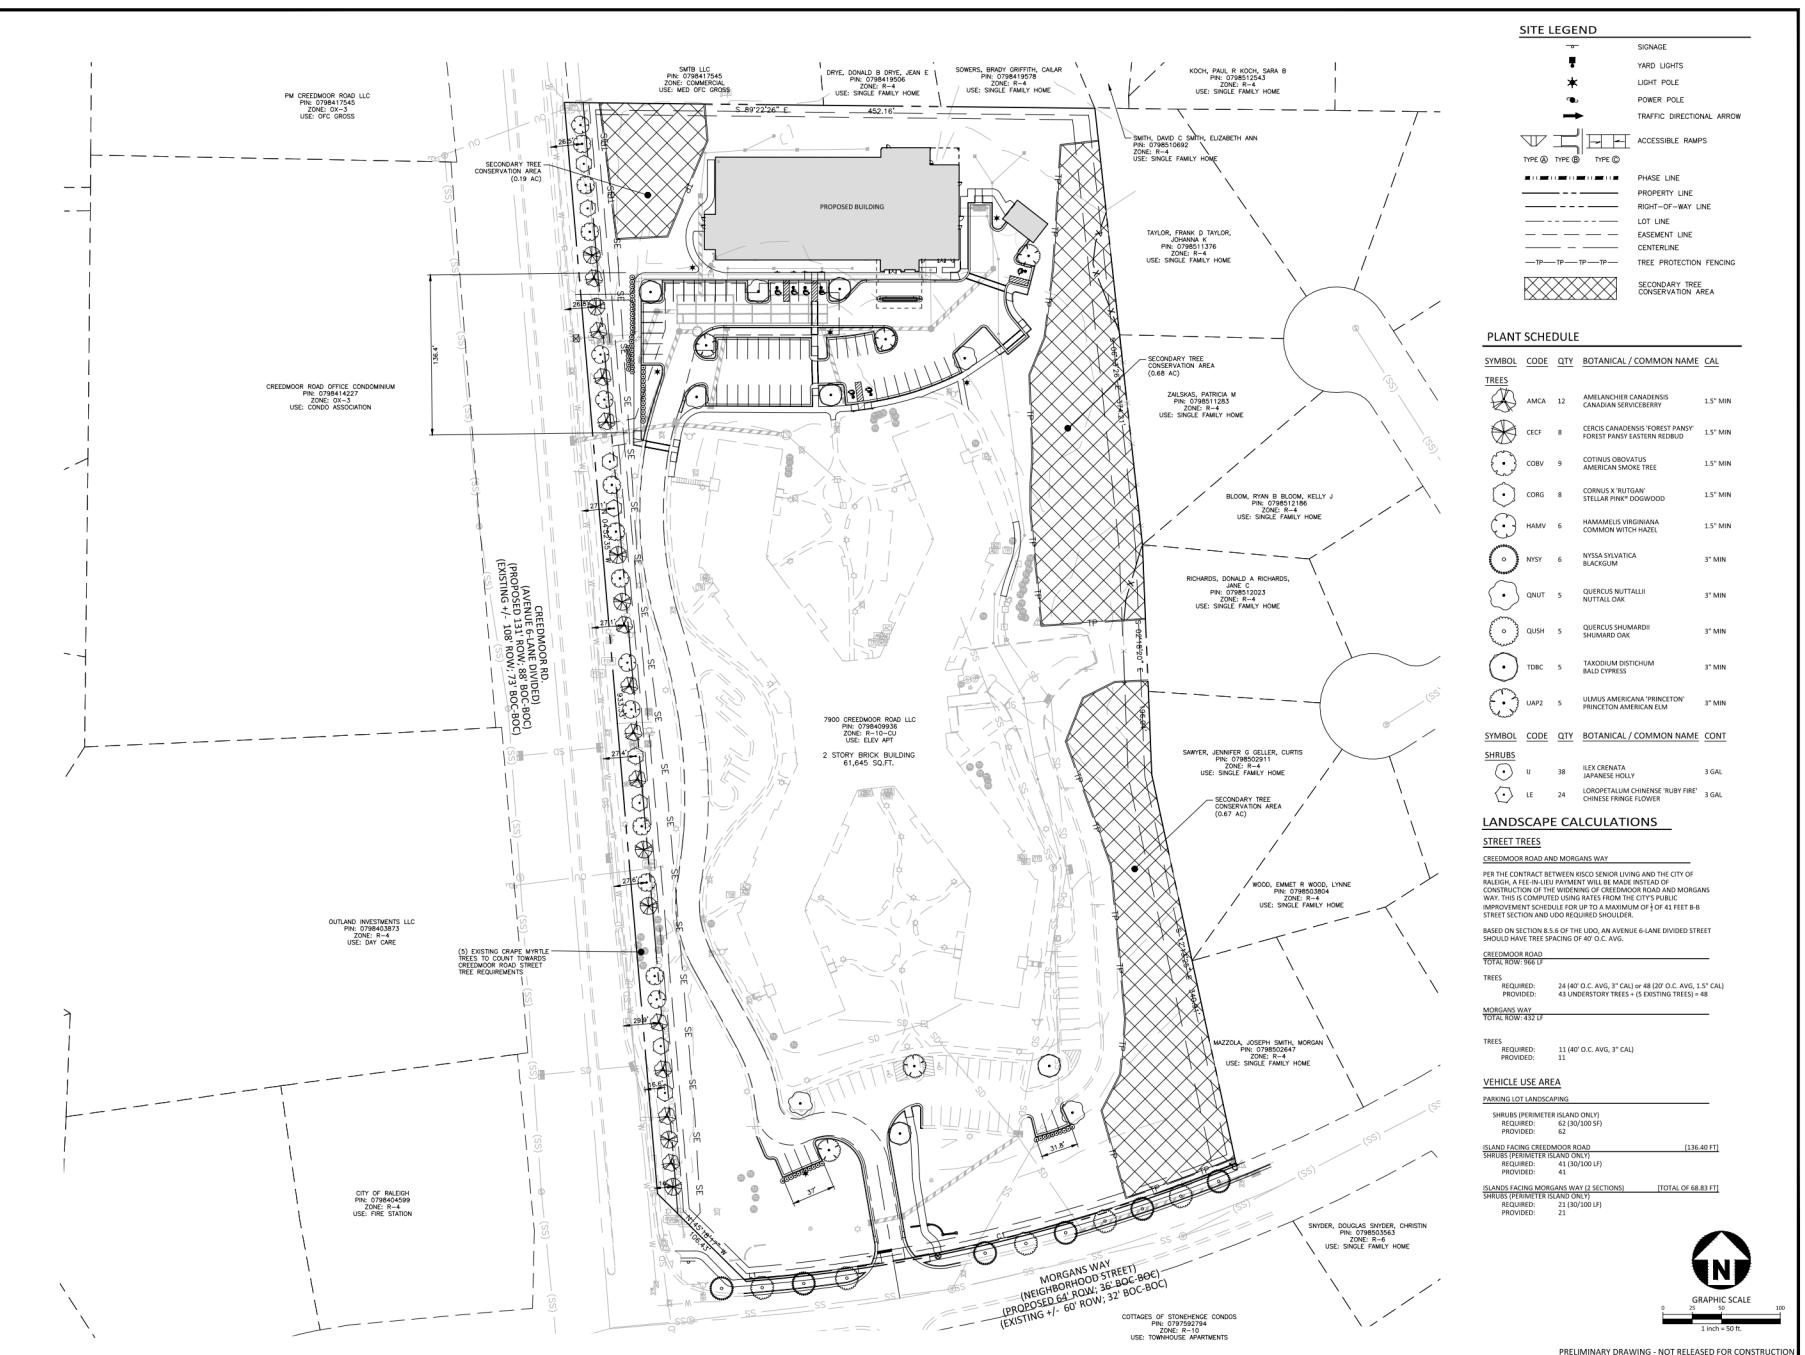

**L5.00**



**MCADAMS**

The John R. McAdams Company, Inc.  
2905 Meridian Parkway  
Durham, NC 27713

phone 919.361.5000  
fax 919.361.2266  
license number: C-2939-C-187


www.mcadamsco.com

**CLIENT**

MR. JOE WHITEHOUSE  
KISCO SENIOR LIVING  
5270 FLEET STREET, SUITE 300  
CALIFORNIA, 92008

**ABBOTTSWOOD AT STONEHENGE**  
**ADMINISTRATIVE SITE REVIEW**  
**ASR-0056-2024**

7900 CREEDMOOR ROAD  
RALEIGH, NORTH CAROLINA, 27613

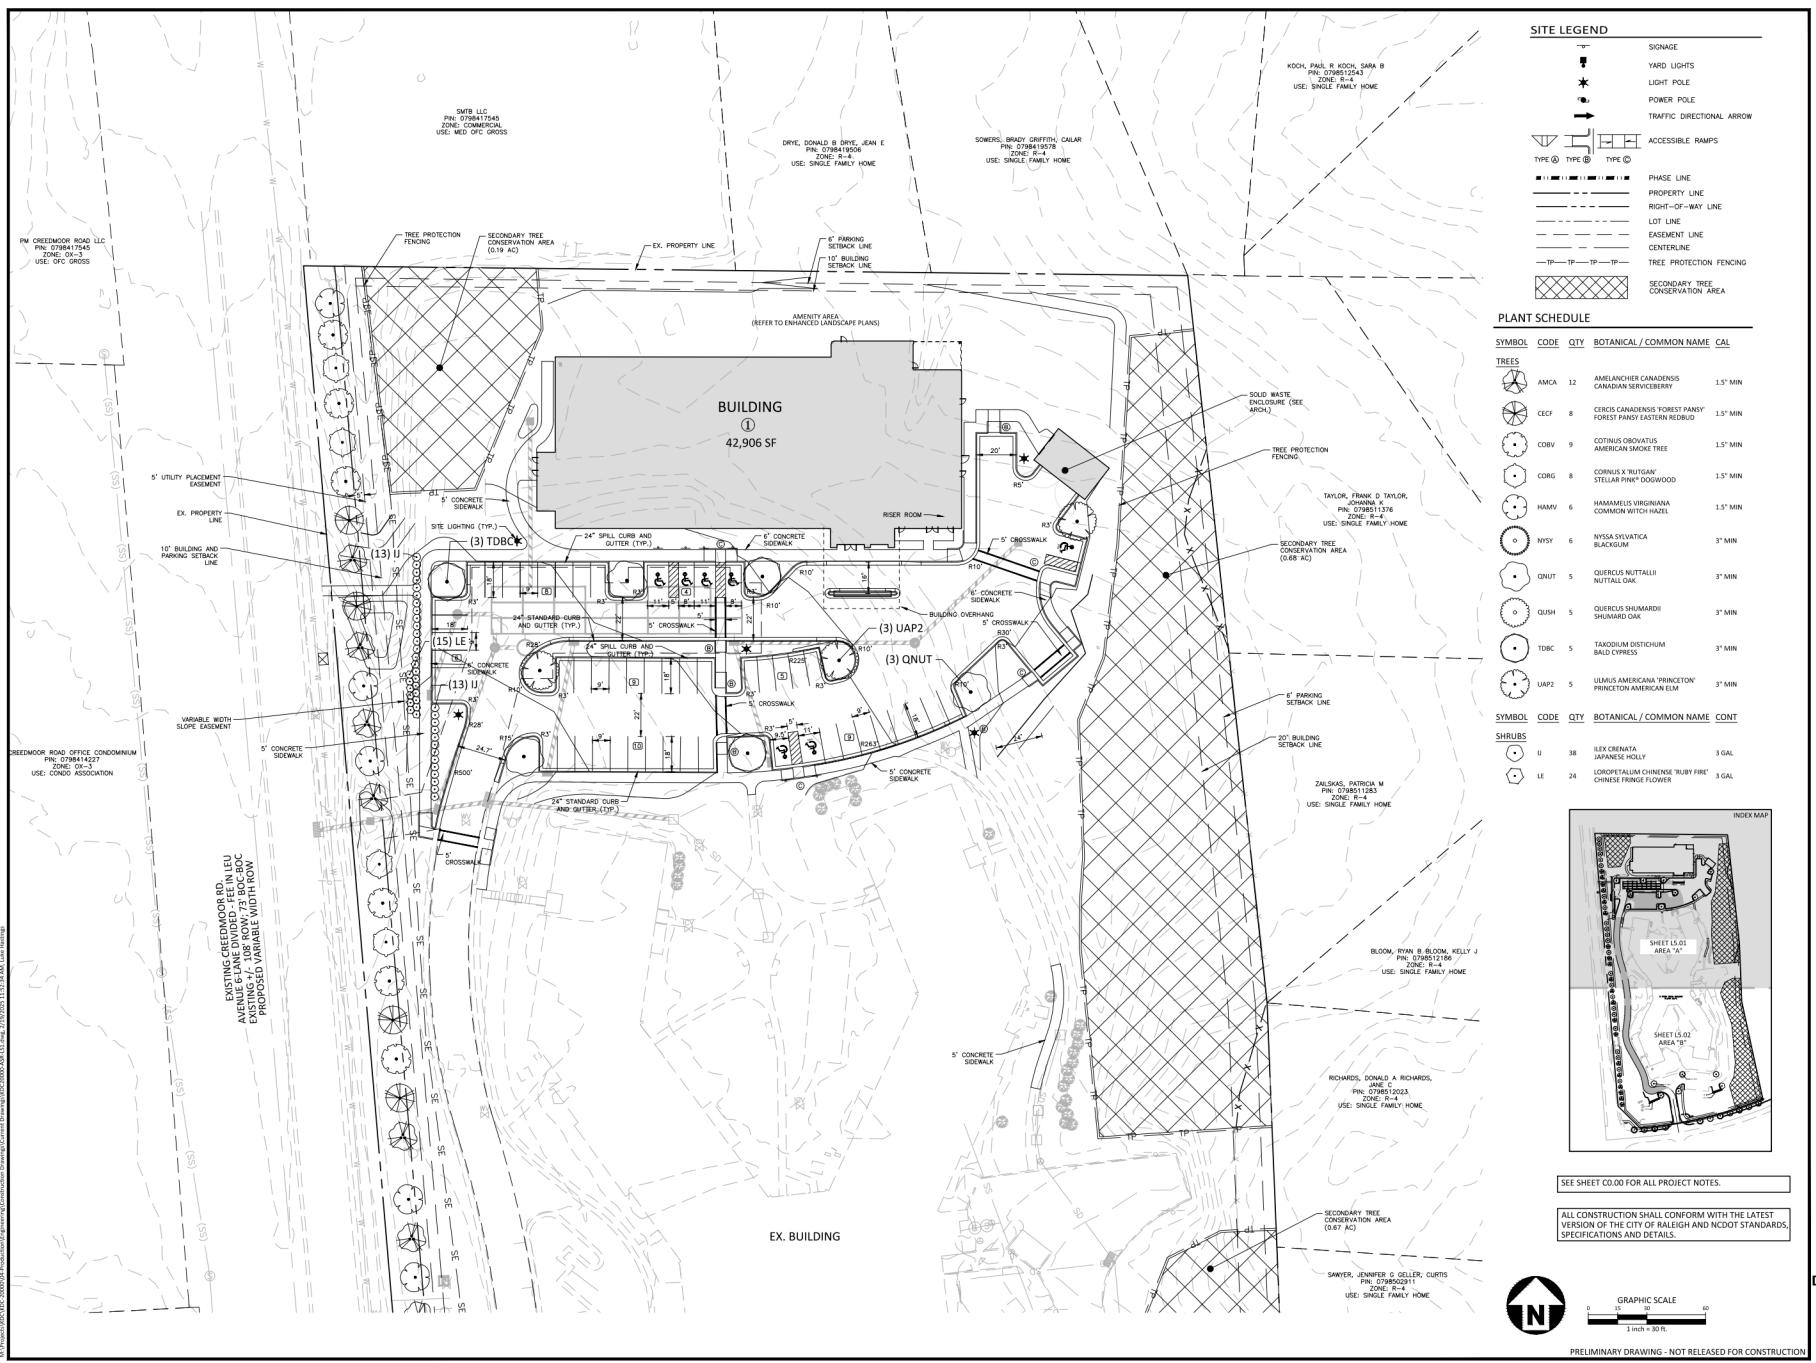



**MCADAMS**

The John R. McAdams Company, Inc.  
2905 Meridian Parkway  
Durham, NC 27713

phone 919.361.5000  
fax 919.361.2266  
license number C-2929 C-187


[www.mcadamsco.com](http://www.mcadamsco.com)

**CLIENT**

MR. JOE WHITEHOUSE  
KISCO SENIOR LIVING  
5270 FLEET STREET, SUITE 300  
CALIFORNIA, CALIFORNIA 92008

**ABBOTTSWOOD AT STONEHENGE  
ADMINISTRATIVE SITE REVIEW  
ASR-0056-2024**

7900 CREEDMOOR ROAD  
RALEIGH, NORTH CAROLINA, 27613

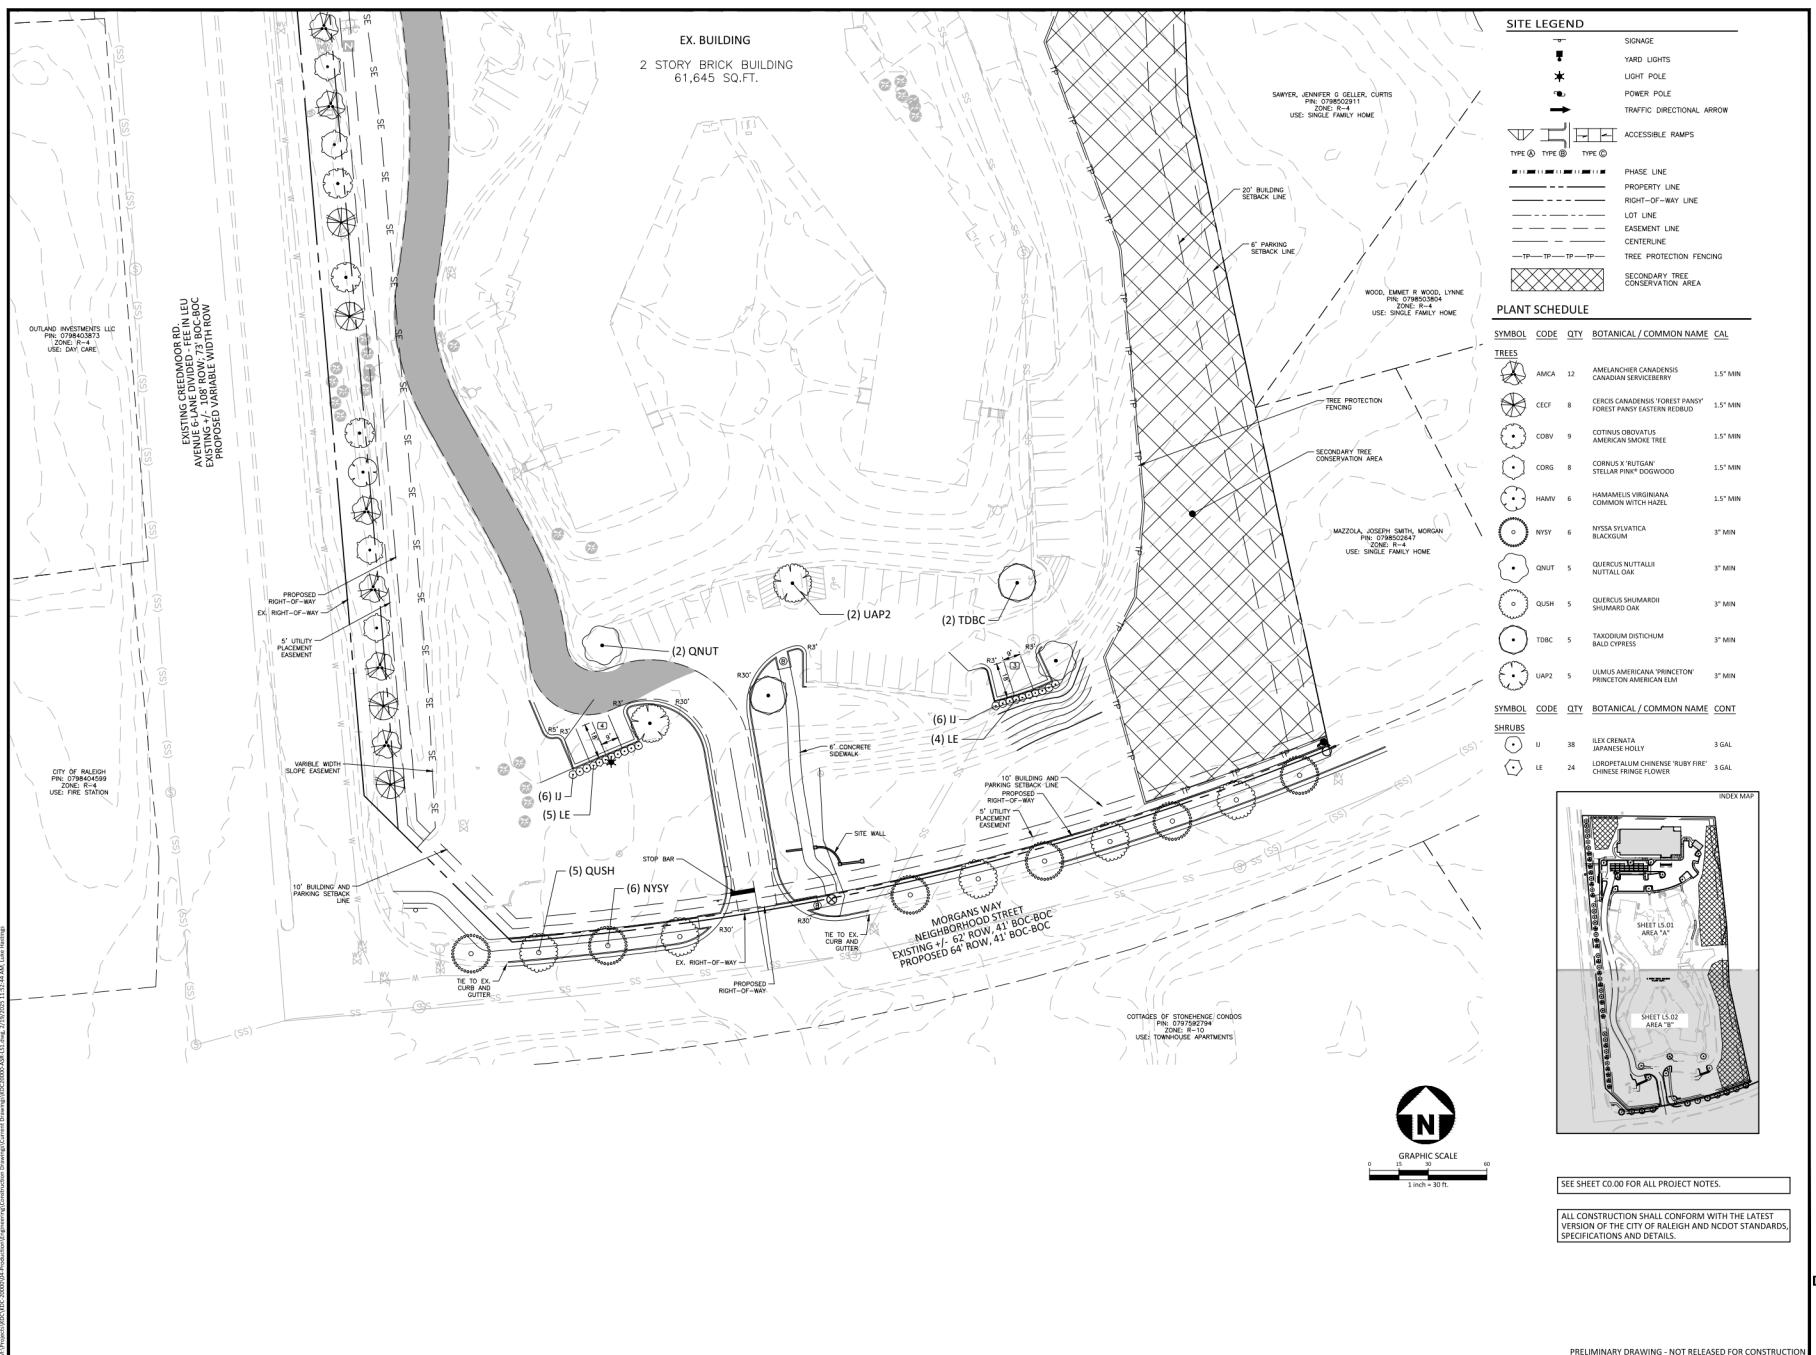



**MCADAMS**

The John R. McAdams Company, Inc.  
2905 Meridian Parkway  
Durham, NC 27713

phone 919.361.5000  
fax 919.361.2269

license number: C-2929


www.mcadamsco.com

**CLIENT**

MR. JOE WHITEHOUSE  
KCSO SENIOR LIVING  
5270 FLEET STREET, SUITE 300  
CALIFORNIA, 92908


**ABBOTTSWOOD AT STONEHEDGE**  
**ADMINISTRATIVE SITE REVIEW**  
**ASR-0056-2024**

7900 CREEDMOOR ROAD  
RALEIGH, NORTH CAROLINA, 27613

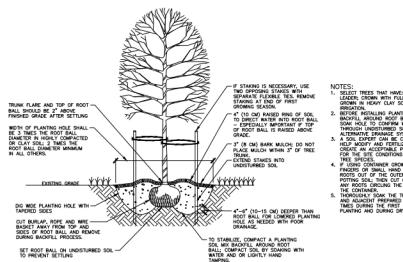


## 01 TREE INSTALLATION

SCALE: 3/8"=1'-0"

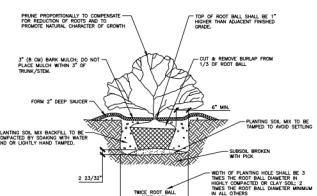

## 02 SHRUB INSTALLATION

SCALE: 3/8"=1'-0"

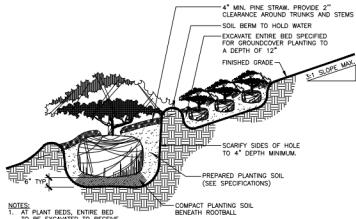


## 03 SHRUB PLANTING ON SLOPE

SCALE: 3/4"=1'-0"

## 04 TREE ON SLOPE 5% (2:1) TO 50% (2:1) - MODIFIED SOIL

SCALE: N.T.S.

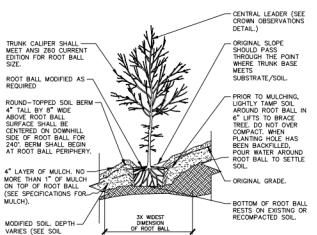

NOTES:  
1. TREES SHALL BE OF QUALITY PRESCRIBED IN CROWN OBSERVATIONS AND ROOT OBSERVATIONS DETAILS AND SPECIFICATIONS.  
2. SEE SPECIFICATIONS FOR PARTNER REQUIREMENTS RELATED TO THIS DETAIL.

## WARRANTY & MAINTENANCE:

1. WARRANTY: INSTALLER SHALL REPAIR OR REPLACE ANY PLANTINGS THAT FAIL IN MATERIAL, WORKMANSHIP OR DESIGN WITHIN ONE YEAR AFTER THE DATE OF SUBSTANTIAL COMPLETION. FAILURES INCLUDE, BUT ARE NOT LIMITED TO, THE FOLLOWING:
  - DEFECTS AND UNSATISFACTORY GROWTH, EXCEPT FOR DEFECTS RESULTING FROM LACK OF ADEQUATE MAINTENANCE, NEGLECT, ABUSE BY OWNER, OR INCIDENTS THAT ARE BEYOND CONTRACTOR'S CONTROL.
  - LOSS OF PLANTING MATERIAL DUE TO EXCESSIVE WIND, FROST, BLOWING DIRT, ETC.

2. MAINTENANCE: INITIAL MAINTENANCE SHALL BE PROVIDED IMMEDIATELY AFTER EACH AREA IS PLANTED AND CONTINUE UNTIL SUBSTANTIAL COMPLETION. UPON SUBSTANTIAL COMPLETION, MAINTENANCE FOR ALL PLANT MATERIAL SHALL BE PROVIDED AS SPECIFIED IN THE CONTRACT DOCUMENTS, WHICH SHALL INCLUDE:
  - TREE AND SHRUB MAINTENANCE: MAINTAIN PLANTINGS BY PRUNING, CULTIVATING, WATERING, WEEDING, FERTILIZING, RESTORING, PLANTING SALVAGED PLANTS, AND OTHER MEANS AS MAY BE NECESSARY. PLANT MATERIAL AS REQUIRED TO ESTABLISH VIBRANT PLANTINGS. SPRAY OR TREAT AS REQUIRED TO PROTECT PLANTINGS FROM PESTS AND DISEASES.
  - GROUND COVER AND PLANT MAINTENANCE: MAINTAIN AND ESTABLISH PLANTINGS BY WATERING, WEEDING, FERTILIZING, MULCHING, AND OTHER OPERATIONS AS REQUIRED TO ESTABLISH VIBRANT PLANTINGS.
  - PROTECT EXTERIOR PLANTS FROM DAMAGE DUE TO LANDSCAPE OPERATIONS, OPERATIONS BY OTHER CONTRACTORS AND TRADES, AND OTHERS. MAINTAIN PLANTED AREAS DURING INSTALLATION AND MAINTENANCE PERIODS. TREAT, REPAIR, OR REPLACE DAMAGED PLANTINGS.

## GENERAL LANDSCAPE NOTES:

1. ALL MATERIALS AND METHODS OF CONSTRUCTION SHALL BE IN ACCORDANCE WITH THE CITY OF RALEIGH AND THE STATE OF NORTH CAROLINA STANDARDS AND SPECIFICATIONS.
2. CONTRACTOR IS RESPONSIBLE FOR THE SITE INSPECTION BEFORE LANDSCAPE PLANTING AND INSTALLATION IN ORDER TO BECOME FAMILIAR WITH THE EXISTING CONDITIONS.
3. LANDSCAPE CONTRACTOR IS RESPONSIBLE FOR LOCATING ALL UNDERGROUND UTILITIES BEFORE BEGINNING DEMOLITION OR INSTALLATION.

4. CONTRACTOR SHALL NOTIFY LANDSCAPE ARCHITECT OF ANY DISCREPANCIES BETWEEN THE SITE CONDITIONS AND THE SPECIFICATIONS, DRAWINGS OR SITE CONDITIONS FOR RESOLUTION PRIOR TO INSTALLATION.

5. ANY DAMAGE TO UTILITIES SHALL BE REPAIRED AT THE CONTRACTOR'S EXPENSE.

6. THIS PLAN IS FOR PLANTING PURPOSES ONLY. FOR INFORMATION REGARDING BUILDINGS, GRADING, LINES, ETC., REFER TO THE APPROPRIATE CONTRACT DOCUMENTS.

7. VERIFICATION OF TOTAL PLANT QUANTITIES AND PLANT TYPES SHALL BE THE RESPONSIBILITY OF THE LANDSCAPE CONTRACTOR. ANY SHORTAGES SHALL BE BROUGHT TO THE ATTENTION OF THE LANDSCAPE ARCHITECT.

8. CONTRACTOR TO ENSURE PROPER STABILIZATION AND SEDIMENT OF THE SITE IN ACCORDANCE WITH THE CONTRACT DOCUMENTS.

9. LANDSCAPE MATERIAL SHALL BE CAREFULLY HANDLED BY THE ROOT BALL, NOT THE TRUNK, BRANCHES AND/OR FOLIAGE OF THE PLANT. MISHANDED PLANT MATERIAL MAY BE SUBJECT TO DAMAGE AND LOSS OF PLANT MATERIAL.

10. ALL PLANT MATERIAL IS TO BE WELL ROOTED. NO ROOT BOUND, SUCH THAT THE ROOT BALL REMAINS INTACT THROUGHOUT THE PLANTING PROCESS. DEFICIENT PLANT MATERIAL SHALL NOT BE PLANTED AND SHALL BE REPAIRED OR REPLACED.

11. ALL PLANTS TO BE A MINIMUM OF WHAT IS SPECIFIED IN THE PLANT SCHEDULE. ANY CHANGES OR SUBSTITUTIONS SHALL BE APPROVED BY THE LANDSCAPE ARCHITECT AND GOVERNING JURISDICTION PRIOR TO ANY HOLE BEING DUG.

12. CONTRACTOR TO COORDINATE WITH OWNER'S REPRESENTATIVE AND LANDSCAPE ARCHITECT TO ESTABLISH THE EXTENTS OF MULCH/BEDDING/SOIL IF NOT SPECIFICALLY SHOWN ON PLANS.

13. CONTRACTOR SHALL PROVIDE POSITIVE DRAINAGE IN ALL PLANTING AREAS.

14. PROPRIETED TREES TO BE PLANTED A MINIMUM 10 FEET FROM ANY LIGHT POLE AS MEASURED FROM TRUNK OF THE TREE TO THE POLE.

15. PROPRIETED TREES TO BE PLANTED A MINIMUM 5 FEET FROM ANY FIRE HYDRANT AS MEASURED FROM TRUNK OF THE TREE TO THE HYDRANT.

16. CONTRACTOR SHALL COMPLETE SOIL TEST IN ALL PLANTING AREAS TO DETERMINE SOIL AMENDMENT REQUIREMENTS UNLESS WAIVED BY OWNER'S REPRESENTATIVE. CONTRACTOR SHALL ADJUST PH AND FERTILITY BASED UPON THE SOIL TEST RESULTS.

17. TOPSOIL SHALL BE FREE OF MATERIAL LARGER THAN 1.0 INCH IN DIAMETER OR LENGTH. NO STONES, ROCKS, METALS, GLASS, CEMENT, CONCRETE, STONES, LUMPS OF SOIL, STICKS, ROOTS, TRASH, OR OTHER EXTRABODIES MATERIAL.

18. LOOSE SURGRADE / SURFACE SOIL TO A MINIMUM DEPTH OF 6 INCHES. APPLY SOIL TO A THICKNESS OF 1/2 INCH. SOIL MUST BE TILLED TO A DEPTH OF 6 INCHES. ADD A HEALTHY GROWING MEDIA AND MULCH THROUGHOUT TO TOP 4 INCHES OF SOIL. SPREAD PLANTING SOIL MIX TO A DEPTH OF 6 INCHES BUT LESS THAN REQUIRED TO MEET PLANTING REQUIREMENTS. DO NOT SPREAD SOIL OVER PLANTING Holes. DO NOT SPREAD PLANTING SOIL OR SURGRADE IF SOIL IS FRESH, MUDDY, OR OTHERWISE WET.

19. IF IMPORTED TOPSOIL IS REQUIRED, THE SURGRADE SHALL BE SCARfed OR TILLED TO A DEPTH OF 6 INCHES. CONTRACTOR SHALL REMOVE ALL PLANT MATERIALS PRIOR TO SPREADING SURGRADE AND DROPPING PLANT MATERIALS. CONTRACTOR SHALL PROVIDE POSITIVE DRAINAGE IN ALL PLANTING AREAS PRIOR TO SPREADING SURGRADE.

20. ALL TREE PLANTINGS SHALL BE MULCHED TO A DEPTH OF 3 INCHES, AND WITH A MINIMUM 3 FOOT RADIUS FROM BASE OF TREE TO DRIPLINE. MULCH SHALL BE FREE OF TRASH AND OTHER MATERIALS. MULCH SHOULD NOT COVER THE ROOT FLARE, CONTRACTOR MULCH SPECIFICATIONS SHALL BE REFERENCED FOR MULCH REQUIREMENTS.

21. DO NOT PRUNE TREES AND SHRUBS BEFORE DELIVERY. PROTECT BARK, BRANCHES, AND ROOT SYSTEMS FROM SUN SCALD, DRYING, SWATHING, WHIPPING, AND OTHER HANDLING DURING DELIVERY. DO NOT BEND, TWIST, OR CRUSH PLANT MATERIALS AS TO DESTROY THEIR NATURAL SHAPE. PROVIDE PROTECTIVE COVING OF EXTERIOR PLANTS DURING DELIVERY. DO NOT DROP EXTERIOR PLANTS DURING DELIVERY AND HANDLING.

22. DROPPED PLANT MATERIALS ARE TO BE GUARANTEED FOR A PERIOD OF 12 MONTHS. PLANT MATERIAL WHICH REMAIN UNHEALTHY WILL BE REFUSED IN THE LANDSCAPE CONTRACTOR BEFORE EXPIRATION OF THE GUARANTEE PERIOD OR IMMEDIATELY IF SO MATERIAL IS FOUND IN THE LANDSCAPE CONTRACTOR'S POSSESSION.

23. ALL TREE PLANTINGS SHALL BE MULCHED AS PREFERRED AS TO THE LANDSCAPE CONTRACTOR. CONTRACTOR SHALL REMOVE DEBRIS AND FINE GRADE ALL PLANTING AREAS PRIOR TO SPREADING SURGRADE.

24. RETAIN EXISTING AND STABILIZE AT END OF WARRANTY PERIOD OR EXISTING SURFACE.

25. FRESH GRADING: GRADE PLANTING AREAS TO A SMOOTH, UNIFORM SURFACE PLANE WITH LOOSE, UNIFORM FINE TEXTURE. GRADE TO WITHIN PLUS OR MINUS 3/2 INCH OF FINISH ELEVATION. ROLL AND RAKE, REMOVE RIDGES, AND FILL DEPRESSIONS TO MEET FINISH ELEVATION. LIMIT FINISHED GRADING TO AREAS THAT CAN BE PLANTED IN THE IMMEDIATE FUTURE.

## REVISIONS

- |     |                              |
|-----|------------------------------|
| NO. | DATE                         |
| 1.  | 10.03.2024                   |
|     | REVISED PER ESR ASR COMMENTS |
| 2.  | 12.04.2024                   |
|     | REVISED PER 2nd ESR COMMENTS |
| 3.  | 03.20.2025                   |
|     | REVISED PER 3rd ESR COMMENTS |

## PLAN INFORMATION

PROJECT NO.	KDC-20000
FILENAME	KDC20000-ASR-L51.DWG
CHECKED BY	JAR
DRAWN BY	AZK
SCALE	AS SHOWN
DATE	08.05.2024

## SHEET

## LANDSCAPE DETAILS AND NOTES

**L5.03**

PRELIMINARY DRAWING - NOT RELEASED FOR CONSTRUCTION



**MCADAMS**

The John R. McAdams Company, Inc.  
2905 Meridian Parkway  
Durham, NC 27713


phone 919.361.5000  
fax 919.361.2269  
license number: C-292-C-187

www.mcadamsco.com

**CLIENT**

MR. JOE WHITEHOUSE  
KISCO SENIOR LIVING  
5270 FLEET STREET, SUITE 300  
CALIFORNIA, CALIFORNIA 92008

**ABBOTTSWOOD AT STONEHENGE**  
**ADMINISTRATIVE SITE REVIEW**  
**ASR-0056-2024**  
**7900 CREEDMOOR ROAD**  
**Raleigh, North Carolina, 27613**

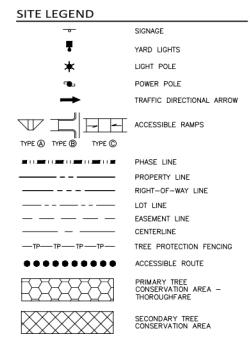

**TREE LEGEND**

(W)	BEECH
(B)	BLACK GUM
(C)	CEDAR
(E)	CHERRY
(M)	CRAPÉ MYRTLE
(D)	DOGWOOD
(S)	SWEET GUM
(H)	HICKORY
(M)	MAGNOLIA
(Q)	OAK
(O)	ORNAMENTAL
(P)	PINE
(F)	PEAR
(G)	POPLAR
(R)	REDWOOD
(D)	DIMETER INCH AT BREAST HEIGHT
(T)	TYPE OF TREE

NOTE: THE TREE STANDS ARE GENERALLY IN GOOD HEALTH, WITH MINIMAL AMOUNT OF INVASIVE SPECIES

TREE SURVEY AND TREE PROTECTION PLAN  
PROVIDED BY ANDERS LINQUIST,  
ISA CERTIFIED ARBORIST SO-10544A

Tree Conservation Plan Data Sheet  
ASD Article 8-1 Tree Conservation  
(Include applicable information on the plan sheet)

Project Name: Abbottswood at Stonehenge  
Gross Site Area: 10.28 ac  
Right of way to be dedicated from this project: 0.00 ac  
Net Site Area: 9.92 ac

Number of Trees  
Percent of Total  
  
UDO 8.1.4.A. Primary Tree Conservation Areas  
Primary Tree Conservation Area: SH02 1 %  
Primary Tree Conservation Area: SH02 2 %  
Primary Tree Conservation Area: Parkway Frontage %  
Primary Tree Conservation Area: MPOO %  
Primary Tree Conservation Area: Champion Tree XX\* dbh species %  
Primary Tree Conservation Area: New Buffer Zone 2 %  
Primary Tree Conservation Area: 4% Stems %  
Primary Tree Conservation Area: Thoroughfare %  
  
Subtotal of Primary Tree Conservation Areas: %

UDO 8.1.4.D.2. Tree Conservation Area - Greenway %

UDO 8.1.4.B.1.a & b. Secondary Tree Conservation Areas  
(Include perimeter buffers and their alternate compliance areas) 1.521 = 15.33 %

UDO 8.1.4.B.1.c & d. Individual Tree Secondary Tree Conservation Areas  
(Include individual trees and their alternate compliance areas) %

Subtotal of Secondary Tree Conservation Areas: 1.521 = 15.33 %

TOTAL ALL TREE CONSERVATION AREA PROVIDED: 1.521 = 15.33 %



GRAPHIC SCALE

1 inch = 50 ft

**REVISIONS**

- 1 10-10-2024 REVISED PER 1st 4th ASR COMMENTS
- 2 12-04-2024 REVISED PER 2nd 4th ASR COMMENTS
- 3 02-20-2025 REVISED PER 3rd 4th ASR COMMENTS

**PLAN INFORMATION**

PROJECT NO.: KDC-20000  
FILENAME: KDC20000-ASR-TCL-DWG  
CHECKED BY: JAR  
DRAWN BY: AAL  
SCALE: 1"=30'  
DATE: 08.05.2024

**SHEET**

**OVERALL TREE CONSERVATION PLAN**

**L8.00**

PRELIMINARY DRAWING - NOT RELEASED FOR CONSTRUCTION



**MCADAMS**

The John R. McAdams Company, Inc.  
2905 Meridian Parkway  
Durham, NC 27713

phone 919.361.5000

fax 919.361.2269

license number: C-2929-C-187

www.mcadamsco.com

**CLIENT**

JOE WHITEHOUSE  
KCSO SENIOR LIVING  
5270 FLEET STREET, SUITE 300  
CALIFORNIA, CALIFORNIA 92908


## ABBOTTSWOOD AT STONEHENGE ADMINISTRATIVE SITE REVIEW ASR-0056-2024

7900 CREAMMOOR ROAD  
RALEIGH, NORTH CAROLINA, 27613

Plot 1		Plot 2		Plot 3		Plot 4		Plot 5		Plot 6		Plot 7		Plot 8		Plot 9		Plot 10		Plot 11		Plot 12		Plot 13		Plot 14		Plot 15		Plot 16		Plot 17		Plot 18	
2391 SF	Balai	2616 SF	Balai	3061 SF	Balai	3027 SF	Balai	3639 SF	Balai	4287 SF	Balai	4129 SF	Balai	4408 SF	Balai	4452 SF	Balai	4466 SF	Balai	4487 SF	Balai	2537 SF	Balai	3464 SF	Balai	2739 SF	Balai	3445 SF	Balai	4452 SF	Balai	5705 SF	Balai		
Species	DBH	Area	Species	DBH	Area	Species	DBH	Area	Species	DBH	Area	Species	DBH	Area	Species	DBH	Area	Species	DBH	Area	Species	DBH	Area	Species	DBH	Area	Species	DBH	Area	Species	DBH	Area			
CH	3	0.09	BIGM	5	0.14	M	4	0.09	G	11	0.09	G	7	0.07	G	10	0.05	CH	6	0.20	CH	3	0.05	C	8	0.35	BDM	5	0.14	BE	6	0.20			
CH	4	0.09	ACM	11	0.09	O	26	0.09	G	16	0.09	G	18	0.07	G	19	0.05	CH	9	0.20	CH	10	0.05	C	11	0.14	BDM	9	0.14	BE	17	1.95			
CH	4	0.09	CH	5	0.20	D	21	2.64	G	5	0.35	G	7	0.27	S	12	0.78	CH	12	0.78	M	2	0.27	M	11	0.86	C	11	0.14	M	10	0.55			
CH	3	0.05	CH	4	0.09	O	21	2.40	G	18	1.77	G	5	0.14	G	6	0.20	G	12	0.79	M	3	0.05	M	4	0.09	C	5	0.14	M	9	0.44			
CH	3	0.05	CH	4	0.09	O	22	2.64	G	6	0.20	M	4	0.09	M	10	0.05	G	8	0.35	M	6	0.20	CH	5	0.14	M	7	0.27						
CH	5	0.14	CH	3	0.05	O	26	3.69	G	5	0.14	M	12	0.79	M	5	0.14	M	5	0.14	M	5	0.14	M	3	0.05	M	4	0.09	M	8	0.35			
H	10	0.55	CH	8	0.35	P	14	0.09	D	10	0.09	M	8	0.14	M	13	0.09	G	10	0.05	M	8	0.35	M	4	0.09	M	7	0.27	M	22	2.64			
H	4	0.09	TOTAL BASAL AREA	17.13	M	10	0.09	M	5	0.14	D	5	0.14	G	7	0.27	M	9	0.05	M	10	0.55	M	8	0.35	M	4	0.09	M	8	0.35				
O	5	0.14	TOTAL BASAL AREA	243.44	M	3	0.05	D	4	0.09	O	7	0.27	M	11	0.66	M	9	0.44	O	9	0.44	O	13	0.56	M	10	0.55	M	5	0.14	M	5	0.14	
O	5	0.14	ACM	5	0.14	TOTAL BASAL AREA	243.44	M	4	0.09	M	5	0.14	M	3	0.05	O	11	0.66	M	6	0.20	O	5	0.14	M	7	0.27	M	5	0.14				
O	5	0.14	CH	4	0.09	M	4	0.09	D	5	0.14	M	3	0.05	O	11	0.66	M	7	0.27	M	3	0.05	M	8	0.35	M	4	0.09	M	8	0.35			
O	5	0.14	CH	4	0.09	O	6	0.20	M	3	0.05	O	10	0.20	M	3	0.05	O	11	0.66	M	24	3.14	M	5	0.14	M	4	0.09	M	3	0.05			
O	4	0.20	H	8	0.35	P	14	0.09	D	6	0.20	M	8	0.20	M	9	0.05	O	10	0.20	M	4	0.09	M	7	0.27	M	6	0.20						
O	4	0.09	H	10	0.55	P	4	0.09	D	5	0.14	M	3	0.05	O	10	0.55	M	10	0.55	M	3	0.05	O	12	0.92	M	11	0.66						
O	6	0.20	H	9	0.05	P	12	0.27	P	3	0.05	M	6	0.20	M	3	0.05	O	6	0.20	M	10	0.55	M	8	0.35	M	4	0.09	M	6	0.20			
O	5	0.14	H	8	0.35	P	7	0.27	P	6	0.20	M	3	0.05	O	10	0.55	M	6	0.20	M	5	0.14	M	5	0.14									
O	4	0.09	H	13	2.23	P	9	0.27	P	6	0.20	M	5	0.14	M	8	0.35	M	12	0.79	M	10	0.55	M	3	0.05	M	9	0.35						
O	13	0.92	O	4	0.09	P	16	1.40	P	6	0.20	M	4	0.09	M	9	0.44	P	9	0.44	P	11	0.66	M	8	0.35	M	4	0.09	M	8	0.35			
P	9	0.05	TOTAL BASAL AREA	95.31	P	17	0.27	P	21	2.40	P	4	0.09	O	11	0.66	P	5	0.14	O	3	0.05	M	10	0.55	M	14	1.97	M	6	0.20				
P	6	0.20	TOTAL BASAL AREA	147.95	P	7	0.27	P	21	2.40	P	4	0.09	O	11	0.66	P	5	0.14	O	7	0.27	P	3	0.05	M	10	0.55	M	12	0.79				
P	8	0.35	TOTAL BASAL AREA	102.28	P	14	1.07	P	9	0.44	O	3	0.05	D	6	0.20	M	3	0.05	O	19	1.97	P	23	2.88	M	8	0.35	M	10	0.55				
P	6	0.20	TOTAL BASAL AREA	147.95	P	11	0.27	P	21	2.40	P	7	0.27	P	3	0.05	D	6	0.20	M	3	0.05	O	19	1.97	P	23	2.88	M	8	0.35	M	10	0.55	
P	7	0.27	TOTAL BASAL AREA	161.17	P	11	0.27	P	21	2.40	P	7	0.27	P	3	0.05	D	6	0.20	M	3	0.05	O	19	1.97	P	23	2.88	M	8	0.35	M	10	0.55	
P	13	0.92	TOTAL BASAL AREA	7.40	P	12	0.27	P	21	2.40	P	7	0.27	P	3	0.05	D	6	0.20	M	3	0.05	O	19	1.97	P	23	2.88	M	8	0.35	M	10	0.55	
P	12	0.27	TOTAL BASAL AREA	134.77	P	11	0.27	P	21	2.40	P	7	0.27	P	3	0.05	D	6	0.20	M	3	0.05	O	19	1.97	P	23	2.88	M	8	0.35	M	10	0.55	
P	6	0.20	TOTAL BASAL AREA	149.75	P	11	0.27	P	21	2.40	P	7	0.27	P	3	0.05	D	6	0.20	M	3	0.05	O	19	1.97	P	23	2.88	M	8	0.35	M	10	0.55	
P	17	0.27	TOTAL BASAL AREA	161.17	P	11	0.27	P	21	2.40	P	7	0.27	P	3	0.05	D	6	0.20	M	3	0.05	O	19	1.97	P	23	2.88	M	8	0.35	M	10	0.55	
P	10	0.35	TOTAL BASAL AREA	161.17	P	11	0.27	P	21	2.40	P	7	0.27	P	3	0.05	D	6	0.20	M	3	0.05	O	19	1.97	P	23	2.88	M	8	0.35	M	10	0.55	
P	17	0.27	TOTAL BASAL AREA	161.17	P	11	0.27	P	21	2.40	P	7	0.27	P	3	0.05	D	6	0.20	M	3	0.05	O	19	1.97	P	23	2.88	M	8	0.35	M	10	0.55	
P	19	1.97	TOTAL BASAL AREA	161.17	P	11	0.27	P	21	2.40	P	7	0.27	P	3	0.05	D	6	0.20	M	3	0.05	O	19	1.97	P	23	2.88	M	8	0.35	M	10	0.55	
P	19	1.97	TOTAL BASAL AREA	161.17	P	11	0.27	P	21	2.40	P	7	0.27	P	3	0.05	D	6	0.20	M	3	0.05	O	19	1.97	P	23	2.88	M	8	0.35	M	10	0.55	
P	19	1.97	TOTAL BASAL AREA	161.17	P	11	0.27	P	21	2.40	P	7	0.27	P	3	0.05	D	6	0.20	M	3	0.05	O	19	1.97	P	23</td								


Architectural Drawing  
Mechanical Screening Diagram

E

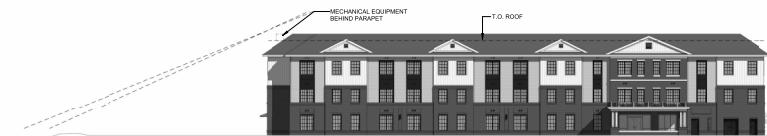

D2 MECHANICAL SCREENING DIAGRAM

D

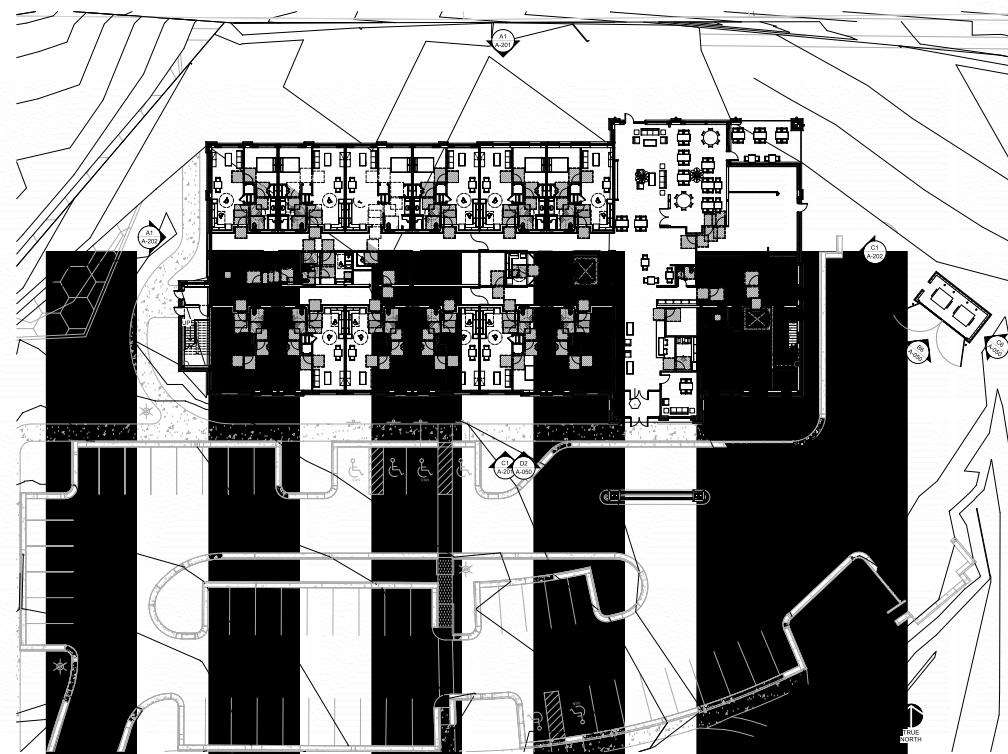


A1 ARCHITECTURAL SITE BUILDING PLAN- LEVEL 1

A

1/16" = 1'-0"


E6 TRASH ENCLOSURE PLAN

E

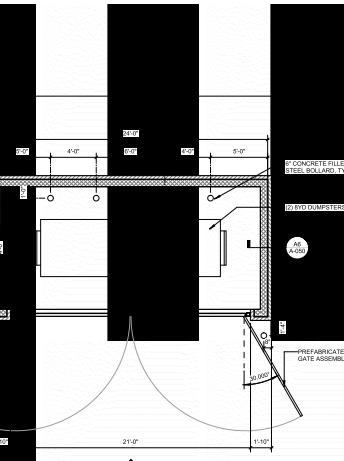


C6 TRASH ENCLOSURE ELEVATION 1

C

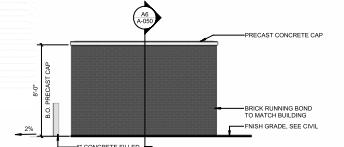


B6 TRASH ENCLOSURE ELEVATION 2

B

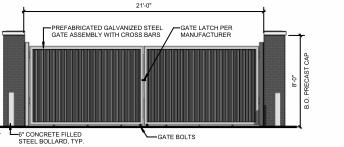

A6 TRASH ENCLOSURE SECTION

A

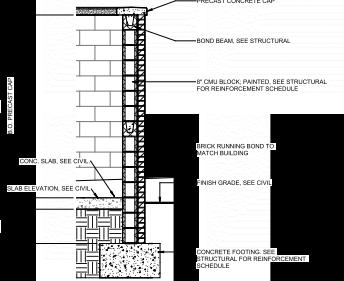

DR LIVING  
at Stonehenge  
Living Building

313

SHEET:  
A-050

PAGE TURN



LS3P

E

D

C

B

A

GENERAL NOTE:  
SEE SHEET A-441 FOR TYPICAL ENLARGED UNIT PLANS

PARTITION GRAPHICS

GRAPHIC SAMPLE: 1 HOUR RATED CMU FIRE/SMOKE BARRIER:  
SEE FILL PATTERN LEGEND FOR FIRE-RESISTANCE RATING,  
DECK LOCATION, CONSTRUCTION CONDITION AND FIRE SMOKE  
PROTECTION TYPE.  
DETAILED INFORMATION TAG AND SCHEDULE FOR COMPLETE PARTITION  
INFORMATION

[Blank]	NON-RATED PARTITION TO 8' ABOVE CEILING, U.N.O.
[Solid Gray]	NON-RATED PARTITION TO DECK
[Hatched]	1HR RATED SMOKE BARRIER TO DECK
[Solid Black]	1HR RATED FIRE BARRIER TO DECK
[Horizontal Line]	1HR RATED HORIZONTAL ASSEMBLY



LS3P

KISCO SENIOR LIVING  
Abbotswood at Stonehenge  
New Assisted Living Building  
7550 Creedmoor Rd  
Raleigh, NC 27613  
LS3P PROJECT: 0404-202635

SHEET NAME:  
FLOOR PLAN-  
LEVEL 1


ORG:  
SUBMISSION: 2024.11.21


SHEET: A-101


PAGE TURN

(A1) OVERALL FLOOR PLAN- LEVEL 1

10'-0" x 10'-0"

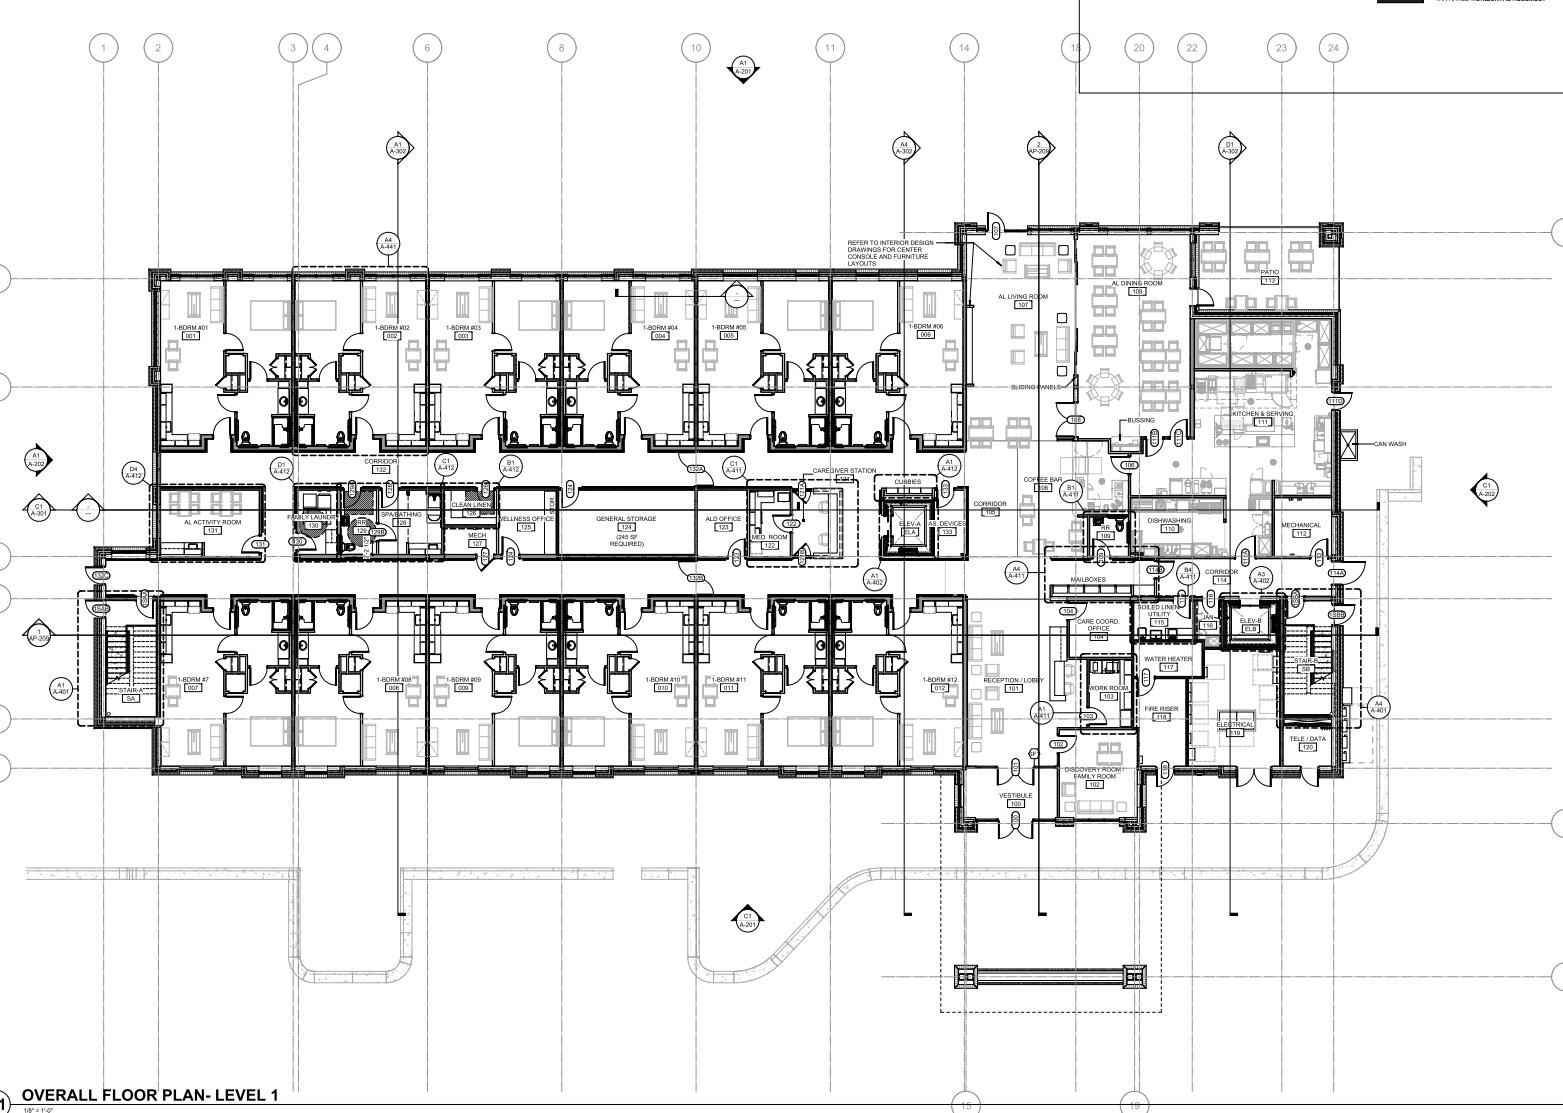

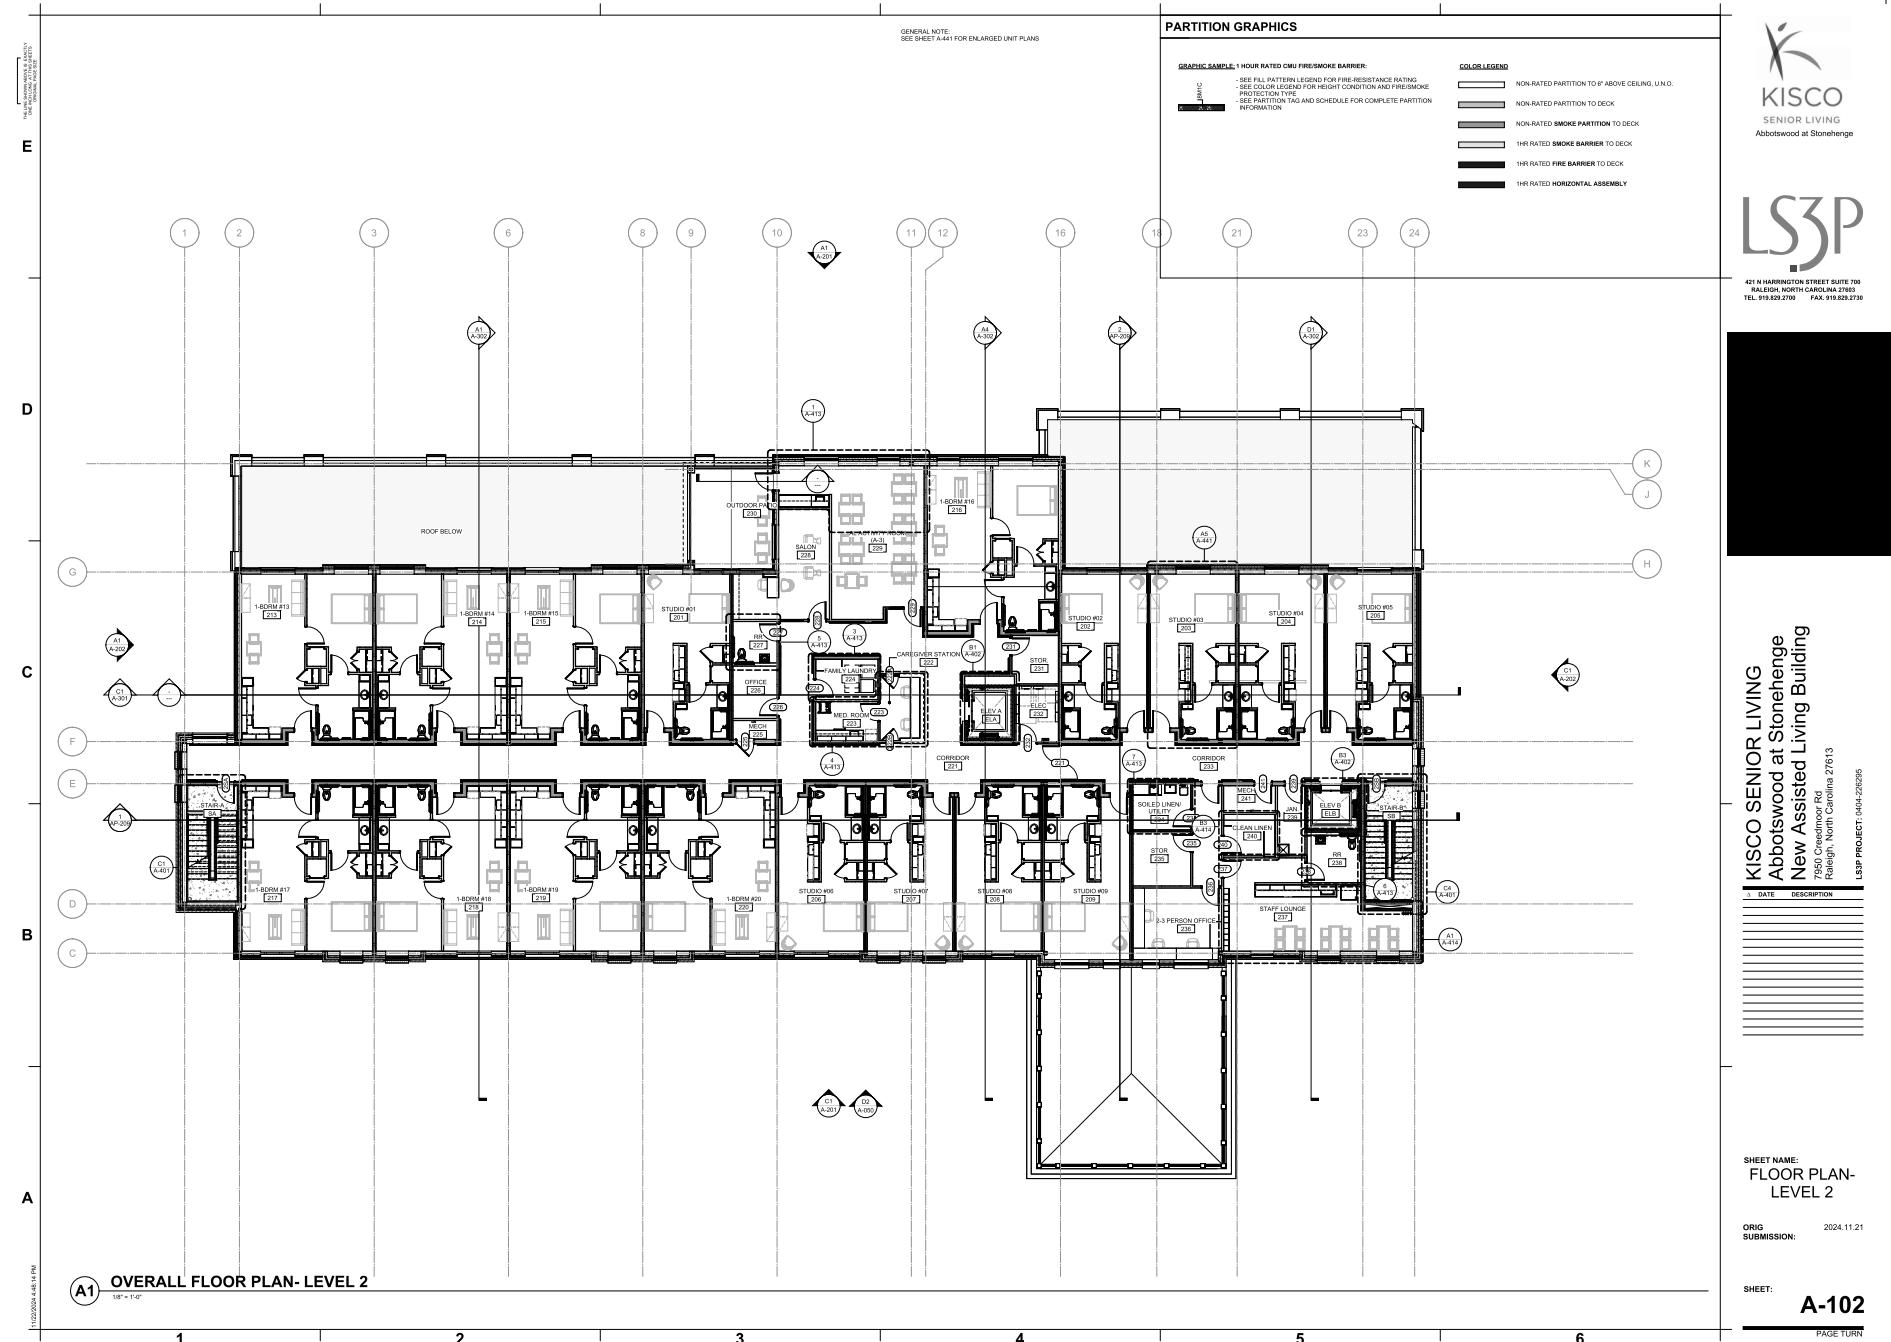

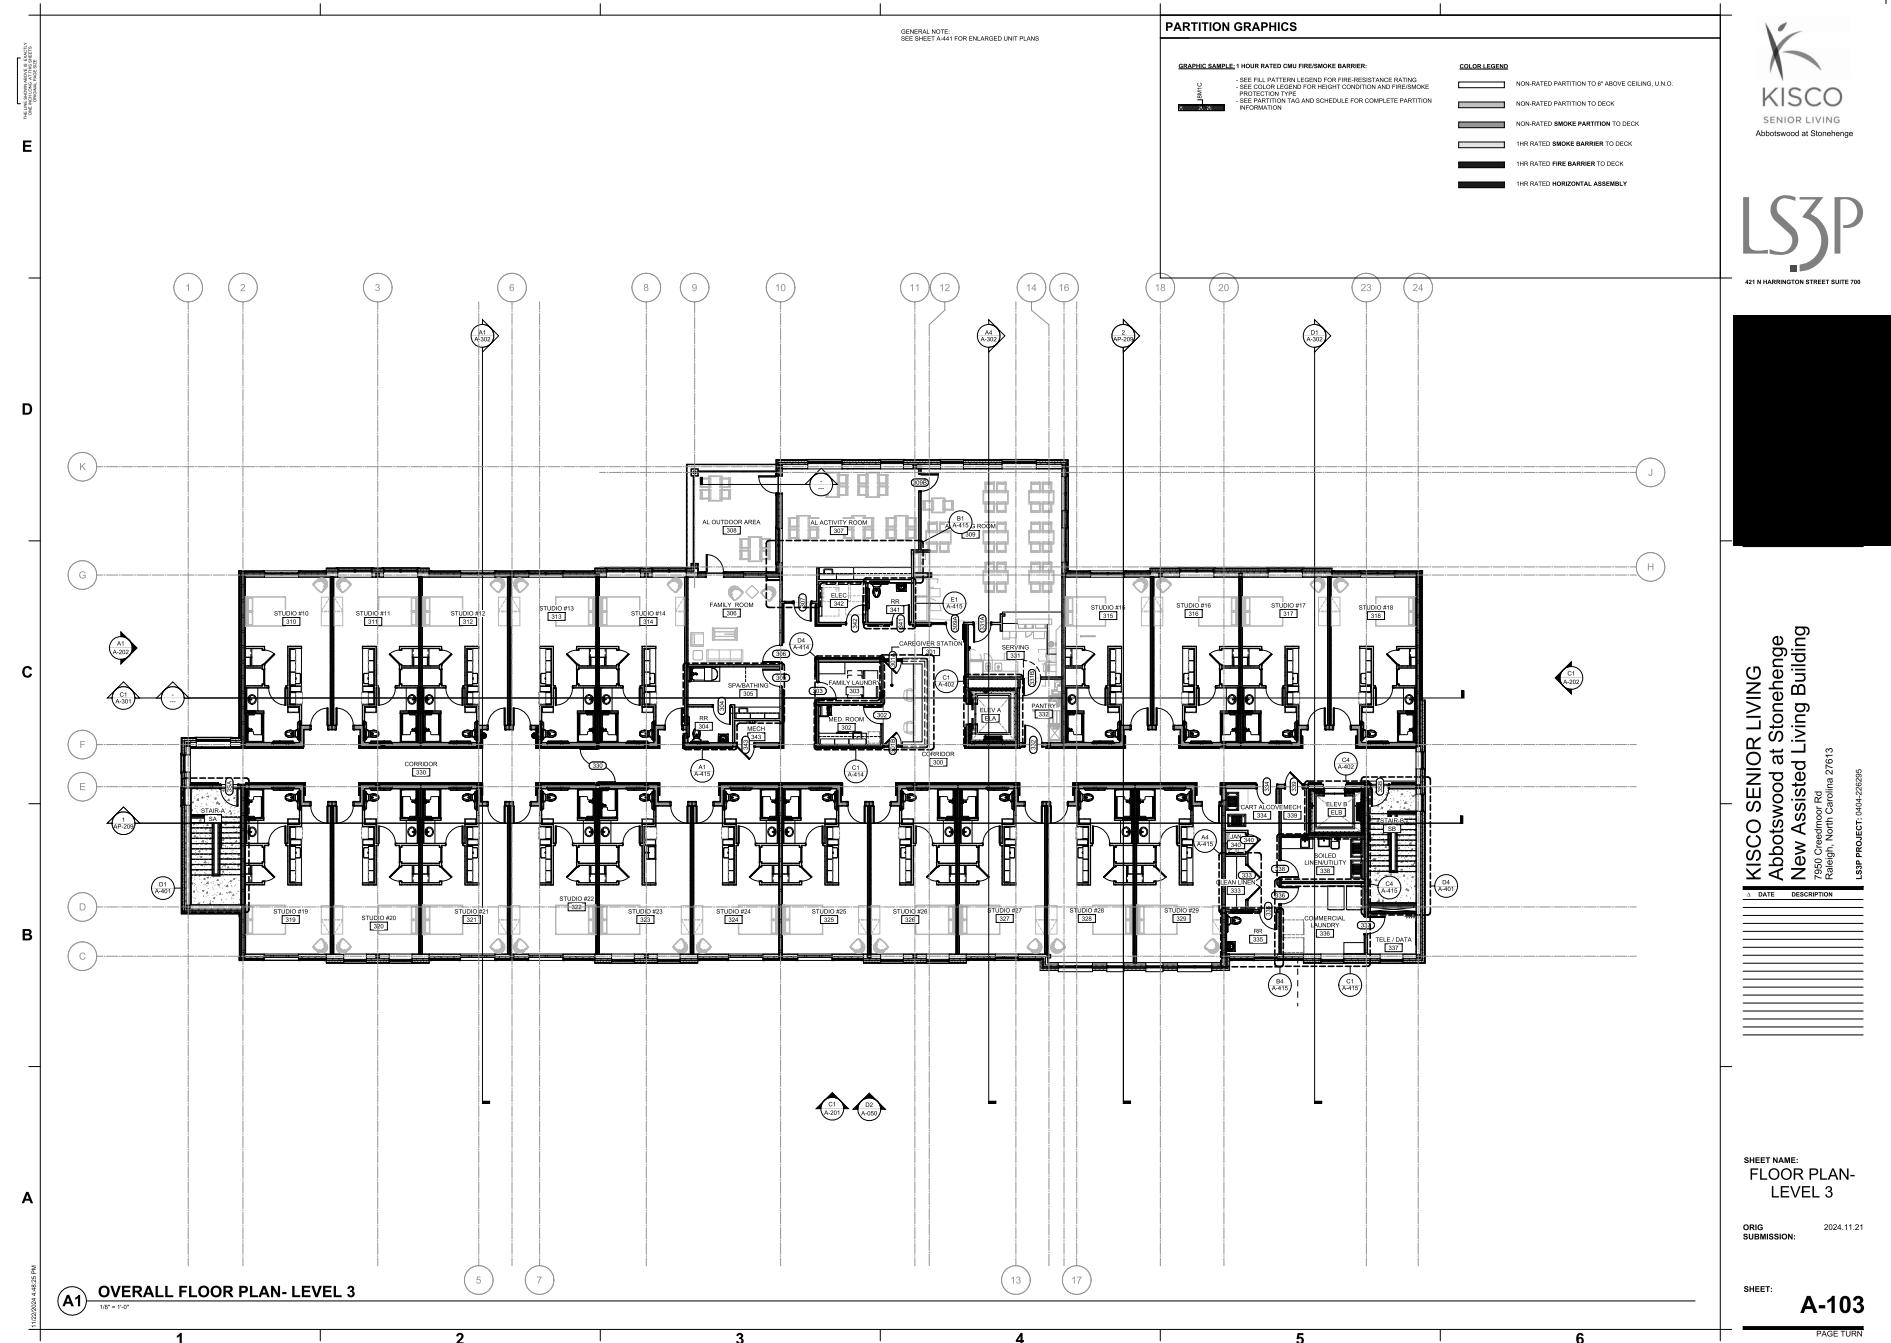

1 2 3 4 5 6



(C1) NORTHWEST PERSPECTIVE



(A1) SOUTHWEST PERSPECTIVE

1 2 3 4 5 6



(C4) NORTHEAST PERSPECTIVE



(A4) SOUTHEAST PERSPECTIVE




LS3P

SENIOR LIVING  
at Stonehenge  
Living Building

ORG  
SUBMISSION:

SHEET:  
**A-200**

PAGE TURN

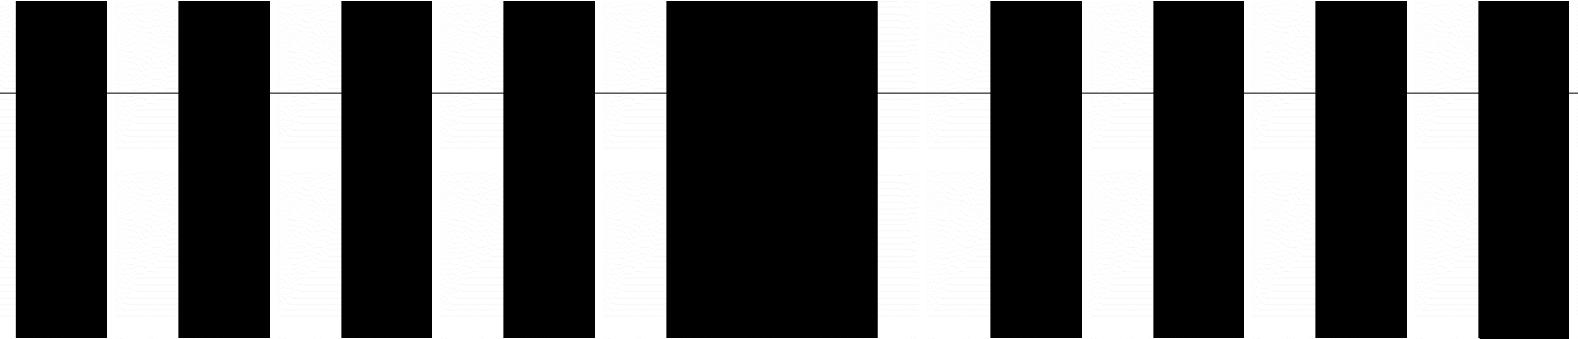

LS3P



C1 ELEVATION-EXTERIOR-SOUTH



A1 ELEVATION-EXTERIOR-NORTH

KISCO SENIOR LIVING  
Abbotswood at Stonehenge  
New Assisted Living Building  
7/2014 Construction Doc  
313

DATE DESCRIPTION

SHEET: A-201

PAGE TURN

PRINTED ON 10/20/2014 BY ADOBE PRINT & PUBLISH

E

D

C

B

A

(C1) ELEVATION- EXTERIOR- EAST

(A1) ELEVATION- EXTERIOR- WEST

10/20/2014 9:23:37 AM

1

2

3

4

5

6

A-202

PAGE TURN

DR LIVING  
at Stonehenge  
Living Building

313

DATE DESCRIPTION

SHEET:

LS3P

KISCO  
SENIOR LIVING