

Administrative Approval Action

Case File / Name: ASR-0062-2019 301 W. CABARRUS STREET City of Raleigh
Development Services Department
One Exchange Plaza
Raleigh, NC 27602
(919) 996-2492
currentplanning@raleighnc.gov
www.raleighnc.gov

LOCATION:

This site is located on the south side of W. Cabarrus Street, west of S. Dawson

Street at 301 W. Cabarrus Street. (PIN#1703-56-5859).

REQUEST:

Development of an existing 2-story building, 23,607 sf gross floor area (11,752 sf for the lower level; 11,855 sf gross floor area for upper level) on a 0.47 acre tract zoned DX-12-UG for a change of use. The existing uses are office/retail and the mixed change of use will be а use development: office/restuarant/bar/indoor recreation. The proposed Indoor Recreation on the lower level floor will include two proposed uses (Golf Simulation (5,236 sf) and Health Club (6,516 sf)). On the upper level 11,855 sf gross floor area will include 3 new proposed uses, office (2,754 sf); restaurant/bar (3,160 sf) & Indoor Recreation (5.941 sf). Per UDO Sec.7.1.3.A.1.E, the site is exempt from providing the required 88 parking spaces for the new uses; however the site is providing 6 new redesigned parking spaces. This site is an existing structure & therefore exempt from transparency requirements noted in UDO Sec.3.2.6 and Sec.3.4.2.C.1.6. The applicant has indicated on the elevation sheets A3.1, A3.2, no existing transparency is being removed. Transparency is either being replaced in the same location or new additional transparency is being added from what currently exists to the same or new areas as noted on the elevation plans.

PRIMARY STREET DETERMINATION: Per TC-5A-18, S. Dawson Street & W. Cabarrus Street are both designated as Primary Street Designations.

BOARD of ADJUSTMENT - APPROVED VARIANCE DECISIONS.

A-137-19: • BLOCK PERIMETER A-137A-19: • PARKING VARIANCE A-164-19: • DESIGN ADJUSTMENT

DESIGN

ADJUSTMENT(S)/

ALTERNATES, ETC: N/A

FINDINGS: City Administration finds that this request, with the below conditions of

approval being met, conforms to the Unified Development Ordinance. This approval is based on a preliminary plan dated February 11, 2020 by

Crumpler Consulting Services.

CONDITIONS OF APPROVAL and NEXT STEPS:

This document must be applied to the second sheet of all future submittals except for final plats. This is a preliminary plan and as such no permits have been issued with this approval. To obtain permits and/or completion of the project, the following steps are required:

☑ <u>BUILDING PERMITS</u> - For buildings and structures shown on the approved plans. Commercial building permit plans must include the signed, approved Site Permitting Review plans attached, if applicable. Permit sets may be reviewed prior to the recordation of required plats, but cannot be approved.



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The following items must be approved prior to the issuance of building permits:

General

- 1. Comply with all conditions of A-137-19; A-137A-19 & A-164-19.
- 2. A detail of the proposed solid waste services screening and dumpster layout is provided with a SPR or Building Permit plans set, whichever is reviewed first.

Engineering

- 3. A right-of-way obstruction permit shall be obtained from Right-of-way Services for any construction activity within the right-of-way. Depending on the impacts and duration of construction phases, public outreach to adjacent properties and businesses may be required.
- A public infrastructure surety shall be provided to the City of Raleigh Development Services Development Engineering (UDO 8.1.3) covering the cost of public infrastructure improvements in the right-of-way.
- 5. An encroachment agreement for the proposed curb, to provide vertical separation from the drive aisle and adjacent public sidewalk, within the public right-of-way shall be approved by City Council and the City Council approved encroachment agreement shall be filed with the Development Services Department, and the encroachment agreement shall be recorded with the Wake County Register of Deeds. A recorded copy of these documents must be provided to the Development Services Department.

Stormwater

6. Director approved 'Stormwater Design Exception' shall be provided to permit retaining wall encroachment into slope setback requirements from property line(s) and building(s); See UDO 9.4.2, Guidelines for Land Disturbing Activities Appendix 'B'.

Urban Forestry

7. A fee-in-lieu for 5 street trees along S.Cabarrus St. and 2 street trees along S. Dawson St. shall be paid to the City of Raleigh (UDO 8.1.10).

The following are required prior to issuance of building occupancy permit:

Stormwater

1. As-built impervious survey is accepted by the Engineering Services Department (UDO 9.2).

EXPIRATION DATES: The expiration provisions of UDO Section 10.2.8 E, including the ability to request extensions in the expiration date, apply to this site plan. If significant construction has not taken place on a project after administrative site review



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approval, that approval may expire and be declared void, requiring re-approval before permits may be issued. To avoid allowing this plan approval to expire the following must take place by the following dates:

3-Year Expiration Date: March 4, 2023

Obtain a valid building permit for the total area of the project, or a phase of the project.

4-Year Completion Date:


Within four years after issuance of the first building permit for the site plan, the construction of the entire site plan must be completed unless an applicant has been granted vested rights. Failure to complete construction within this specified time frame shall automatically void the approved site plan for which no building permits have been issued.


I hereby certify this administrative decision.

Signed: Development Services Dir/Designee

Development Services Dir/Designee

Staff Coordinator: Jermont Purifoy

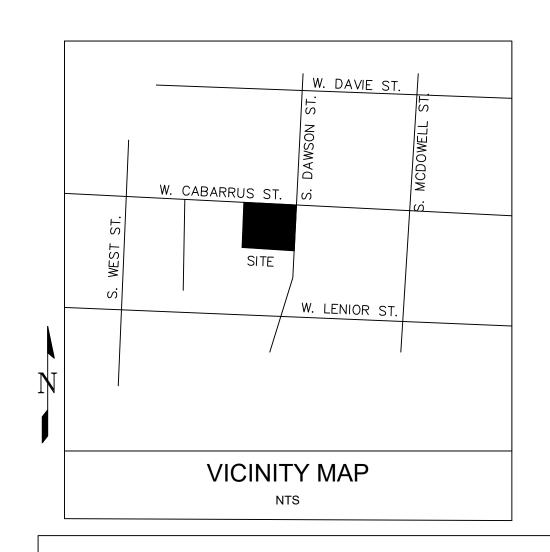

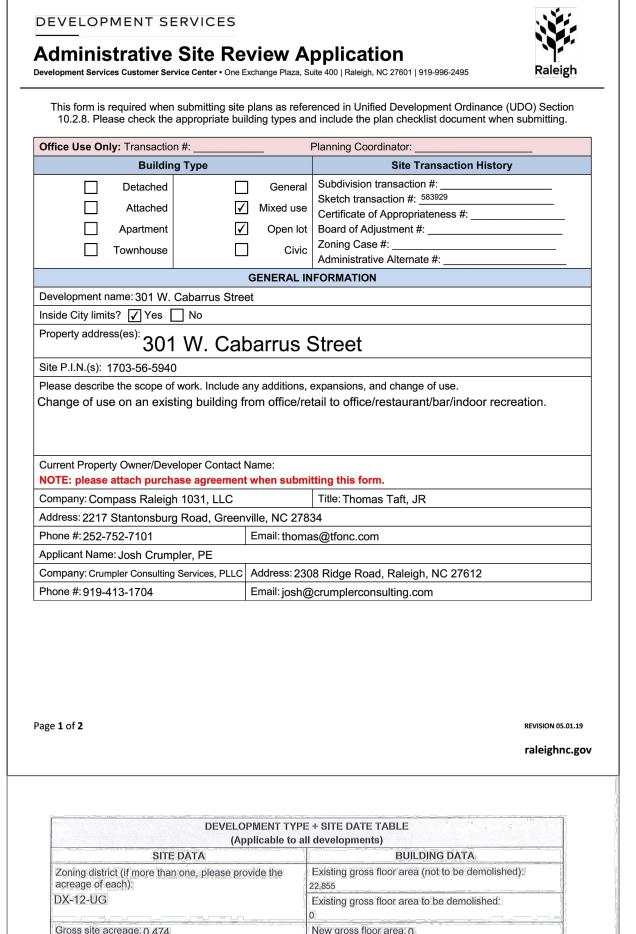

Total sf gross (to remain and new): 22,855

roposed # of buildings: 1

Total # of hotel units

raleighnc.gov

STORMWATER INFORMATION

RESIDENTIAL DEVELOPMENTS

SIGNATURE BLOCK

executors, administrators, successors, and assigns jointly and severally to construct all improvements and make

this application, to receive and response to administrative comments, to resubmit plans on my behalf, and to

I/we have read, acknowledge, and affirm that this project is conforming to all application requirements applicable

with the proposed development use. I acknowledge that this application is subject to the filing calendar and

In filling this plan as the property owner(s). I/we do hereby agree and firmly bind ourselves, my/our heirs,

all dedications as shown on this proposed development plan as approved by the City of Raleigh.

Proposed # of stories for each: 2

of parking spaces proposed: (

Existing use (UDO 6.1.4): OFFICE/RETAIL

Is this a flood hazard area? Yes X No

epresent me in any public meeting regarding this application.

Signature

Printed Name: Thomas Tatt

Page 2 of 2

submittal policy, which states applications will expire after 180 days of inactivity.

Overlay District (if applicable

If yes, please provide: Alluvial soils: Flood stu_ FEMA Map Panel # Neuse River Buffer

Total # of dwelling units:

of bedroom units: 1br.

ADMINISTRATIVE SITE PLAN FOR

301 W. CABARRUS STREET RALEIGH, NORTH CAROLINA

CITY OF RALEIGH FILE: ASR-0062-2019

PREPARED FOR: COMPASS RALEIGH 1031, LLC 2217 STANTONSBURG ROAD GREENVILLE, NC 27834

PRIMARY STREET DESIGNATION NOTES:

CITY OF RALEIGH PRIMARY STREET DETERMINATION PER TC-5A-18 HAS DESIGNATED W. CABARRUS AND S. DAWSON STREETS AS PRIMARY.

SITE EXEMPTION NOTES

-THE SITE WILL BE CONFORMING TO THE EXEMPTION OF TREE CONSERVATION REQUIREMENTS THROUGH THE CITY OF RALEIGH'S UNIFIED DEVELOPMENT CODE SECTION 9.1.2 FOR PARCELS LESS THAN 2 ACRES IN

-THE SITE WILL BE CONFORMING TO THE EXEMPTION OF STORMWATER CONTROL REQUIREMENTS THROUGH THE CITY OF RALEIGH'S UNIFIED **DEVELOPMENT CODE SECTION 9.2.2.A-3-B.**

PREPARED BY: CRUMPLER

Consulting Services, PLLC

2308 Ridge Road Raleigh, North Carolina 27612 Ph. 919-413-1704

BOARD OF ADJUSTMENT-APPROVED VARIANCE DECISIONS

(A-137-19-12/09/19)

DECISION: 1-BLOCK PERIMETER REQUEST WITHDRAWN REMOVED VIA ADOPTION OF TC-6-19 ADOPTED 12/3/19. 2-ALL REMAINING REQUESTS APPROVED AS REQUESTED.

WHEREAS COMPASS RALEIGH 1031, LLC, PROPERTY OWNER, REQUESTS A 5 FOOT DESIGN ADJUSTMENT TO THE MINIMUM 10 SIDEWALK WIDTH REQUIREMENT AND A 3 FOOT DESIGN ADJUSTMENT TO THE MINIMUM 6 FEET PLANTING AREA WIDTH REQUIREMENT BOTH SET FORTH IN SECTION 8.5.2.B FOR WEST CABARRUS STREET, A 5 FOOT DESIGN ADJUSTMENT TO THE MINIMUM 10 FOOT SIDEWALK WIDTH REQUIREMENT AND A DESIGN ADJUSTMENT FOR COMPLETE RELIEF FROM THE MINIMUM 6 FEET PLANTING AREA WIDTH REQUIREMENT BOTH SET FORTH IN SECTION 8.5.2.B FOR SOUTH DAWSON STREET; AND A 262 FOOT DESIGN ADJUSTMENT FROM THE 2,000 FEET MAXIMUM BLOCK PERIMETER REQUIREMENT SET FORTH IN SECTION 8.3.2.A THAT RESULTS IN A BLOCK PERIMETER OF 2.262 FEET TO PERMIT A CHANGE IN USE FROM OFFICE/RETAIL TO BAR/OFFICE/INDOOR RECREATION ON A 0.47-ACRE PROPERTY ZONED DOWNTOWN MIXED-USE-12 URBAN GENERAL LOCATED AT 301 WEST CABARRUS STREET

(A-137A-19-12/09/19)

DECISION: APPROVED AS REQUESTED.

WHEREAS COMPASS RALEIGH 1031, LLC, PROPERTY OWNER, REQUESTS A VARIANCE FROM SECTION 3.4.8.D.2 OF THE UNIFIED DEVELOPMENT ORDINANCE TO PERMIT THE CONTINUED USE OF AN EXISTING PARKING AREA BETWEEN THE EXISTING BUILDING AND WEST CABARRUS STREET AND A VARIANCE FROM SECTION 7.2.5.C.1 TO PERMIT THE PLACEMENT OF A SCREENED SERVICE AREA ALONG WEST CABARRUS STREET WHICH HAS BEEN DESIGNATED A PRIMARY STREET TO PERMIT A CHANGE IN USE FROM OFFICE/RETAIL TO BAR/OFFICE/INDOOR RECREATION ON A 0.47 ACRE PROPERTY ZONED DOWNTOWN MIXED-USE-12 URBAN GENERAL LOCATED AT 301 WEST CABARRUS STREET

(A-164-19 - 01/13/20)

DECISION: APPROVED AS REQUESTED

WHEREAS COMPASS RALEIGH 1031, LLC, PROPERTY OWNER, REQUESTS A 3.5 FOOT DESIGN ADJUSTMENT AND A 0.35 FOOT DESIGN ADJUSTMENT PERMITTING THE RETENTION OF THE EXISTING 66 FOOT RIGHT-OF-WAY WIDTH AND A 40.3 FOOT BACK OF CURB TO BACK OF CURB WITH FOR WEST CABARRUS STREET, A MAIN STREET, PARALLEL PARKING STREET WHICH IS LESS THAN THE 73 FOOT RIGHT-OF-WAY WIDTH AND 41 FOOT BACK OF CURB TO BACK OF CURB WIDTH SET FORTH IN SECTION 8.4.5.D AND REFERENCED IN SECTION 8.5 OF THE UNIFIED DEVELOPMENT ORDINANCE; A 33.5 FOOT DESIGN ADJUSTMENT AND A 27.36 FOOT DESIGN ADJUSTMENT PERMITTING THE RETENTION OF THE EXISTING 59 FOOT RIGHT-OF-WAY-WIDTH AND 43.28 FOOT BACK OF CURB TO BACK OF CURB WITH FOR SOUTH DAWSON STREET, AN AVENUE 6-LANE DIVIDED STREET, WHICH IS LESS THAN THE 126 FOOT RIGHT OF WAY WIDTH AND 98 FOOT BACK OF CURB TO BACK OF CURB WIDTH REQUIRED BY UDO SECTION 8.4.6.C AND REFERENCED IN SECTION 8.5; A 120 FOOT DESIGN ADJUSTMENT PERMITTING TWO ONE-WAY DRIVEWAYS ON WEST CABARRUS STREET TO BE LOCATED APPROXIMATELY 80 FEE APART. WHICH IS LESS THAN THE 200 FOOT MINIMUM DISTANCE SET FORTH IN UDO SECTION 8.3.5.C(3)(c), CREATING A ONE-WAY PARKING OPERATION WITH THE DRIVEWAY ENTRANCE FURTHER FROM THE INSTERSECTION OF WEST CABARRUS STREET AND SOUTH DAWSON STREET, A 26 FOOT DESIGN ADJUSTMENT PERMITTING A ONE-WAY EXIST DRIVEWAY TO BE LOCATED WITHIN ABOUT 24 FEET OF THE INTERSECTION OF WEST CABARRUS STREET AND SOUTH DAWSON STREET, WHICH IS LESS THAN THE 50 FOOT MINIMUM DISTANCE SET FORTH IN UDO SECTION 8.3.5.C(3)(f), CREATING A ONE-WAY PARKING OPERATION WITH THE DRIVEWAY ENTRANCE FURTHER FROM THE INTERSECTION OF WEST CABARRUS STREET AND SOUTH DAWSON STREET; AND A DESIGN ADJUSTMENT FOR COMPLETE RELIEF FROM PROVIDING CROSS-ACCESS TO THE PROPERTY TO THE SOUTH (PIN 1703565779) REQUIRED IN UDO SECTION 8.3.5.D TO PERMIT A CHANGE IN USE FROM OFFICE/RETAIL TO BAR/OFFICE/INDOOR RECREATION ON A 0.47-ACRE PROPERTY ZONED DOWNTOWN MIXED-USE-12 URBAN GENERAL LOCATED AT 301 WEST CABARRUS STREET.

ALL CONSTRUCTION TO BE IN ACCORDANCE WIT ALL CITY OF RALEIGH STANDARDS AND SPECIFICATIONS.

> CALL 48 HOURS BEFORE YOU DIG



NORTH CAROLINA ONE-CALL CENTER 1-800-632-4949

1TH	SHEET	DESCRIPTION
	C-1	COVER
	C-2	EXISTING CONDITIONS PLAN
	C-3	SITE PLAN
	C-4	UTILITY PLAN
	C5	GRADING AND
		STORMDRAINAGE PLAN
	C-6	LANDSCAPING PLAN
	D-1	DETAILS


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PERMITTING

antillin,

DESIGNED BY: JAC DRAWN BY: JAC CHECKED BY: **JAC** 08/14/19

NOT TO SCALE

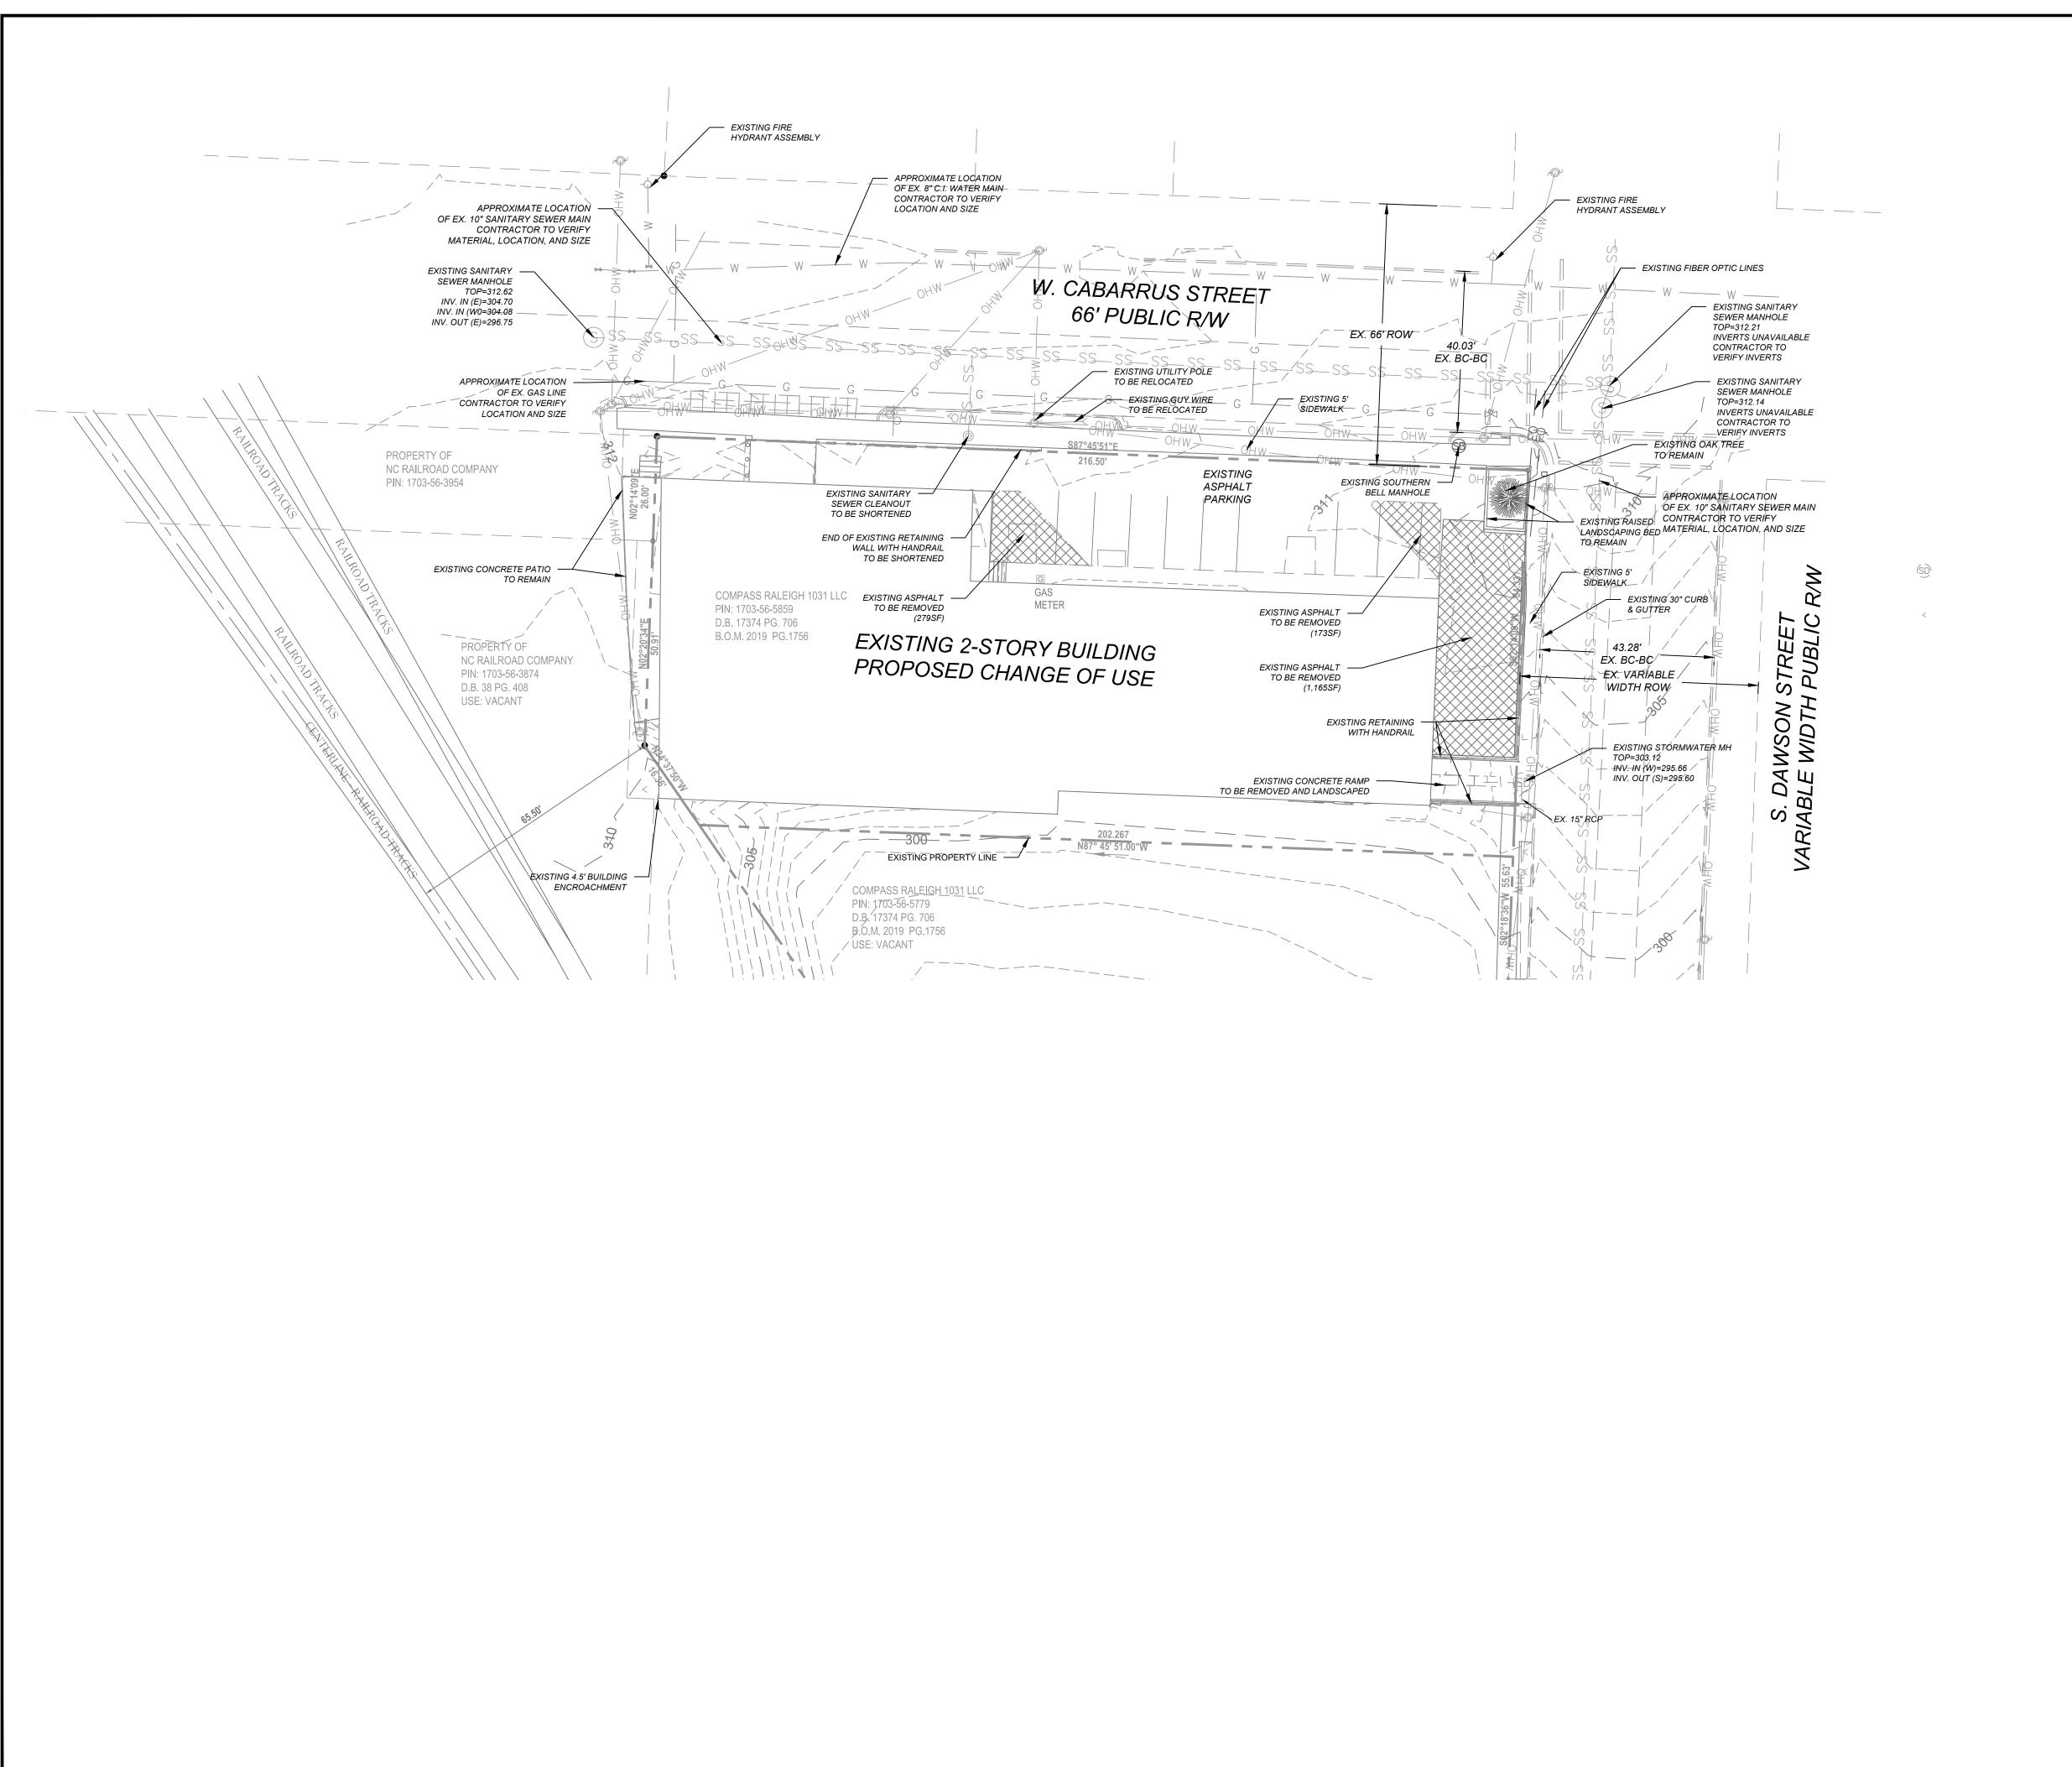

LEGEND		_E	/19	/20
	EXISTING PROPERTY LINE	DATE	10/31/19	01/20/20
	EXISTING ABUTTING PROPERTY LINE EXISTING RIGHT-OF-WAY EXISTING OVERHEAD POWER LINE	ВУ	JAC	JAC
	EXISTING OVERHEAD POWER LINE EXISTING ABUTTING PROPERTY LINE			
	EXISTING BUILDING SETBACK LINE			
	EXISTING PARKING SETBACK LINE			
	EXISTING EDGE OF PAVEMENT			
SSSSSSSS	EXISTING SANITARY SEWER			
W W	EXISTING WATERMAIN			
		REVISION	COMMENTS	COMMENTS

NOTES

- TOPOGRAPHIC AND BOUNDARY SURVEY PROVIDED BY BASS, NIXON, AND KENNEDY, DATED 06-20-2019.
- PROPERTY IS LOCATED IN ZONES X (AREA DETERMINED TO BE OUTSIDE THE O.2% ANNUAL CHANCE AND FUTURE 1% ANNUAL CHANCE FLOODPLAIN) BASED ON THE FEMA MAP NUMBER 3720170300J DATED MAY 2, 2006.
- 3. NO ONSITE STREAMS OR WETLANDS HAVE BEEN IDENTIFIED WITHIN THE PROJECT OR PARCEL AS SHOWN.
- 4. THIS DRAWING IS NOT FOR RECORDATION.

SUED FOR PERMITTING	REVISION	CITY OF RALEIGH COMMENTS	CITY OF RALEIGH COMMENTS	CITY OF RALEIGH COMMENTS			
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DESIGNED BY: JAC


DRAWN BY: JAC

CHECKED BY: JAC

DATE: 08/14/19

SCALE: 1" = 20'

C-2

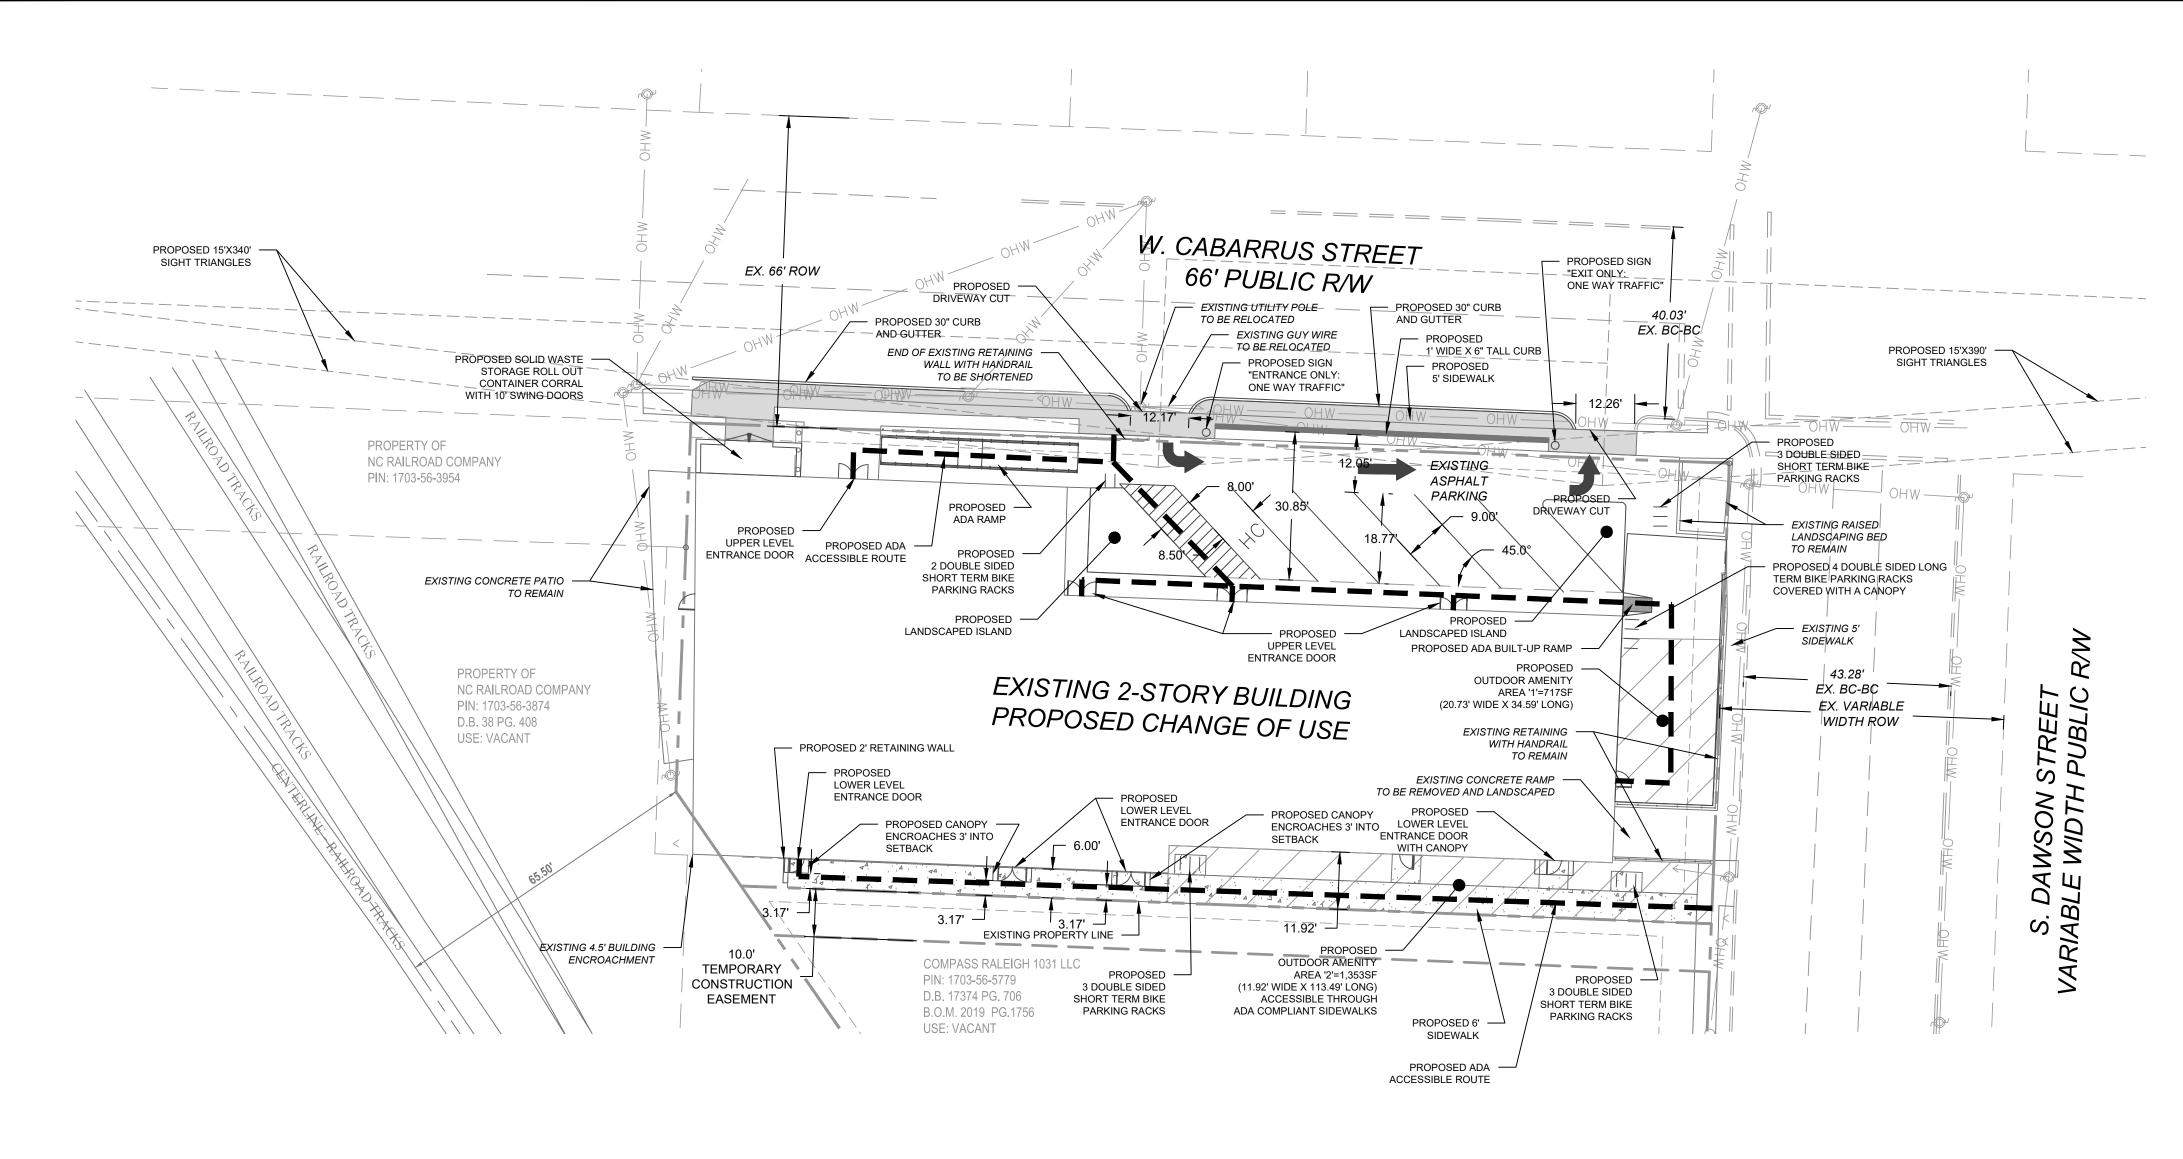

				BUILDING	G USE AND PARK	ING TABLE					
USE	DESCRIPTION	FLOOR	GROSS AREA	% FLOOR AREA	VEHICLE PARKING REQUIRED	VEHICLE PARKING SPACES REQUIRED	VEHICLE PARKING PROVIDED**	SHORT TERM BIKE PARKING REQUIRED	SHORT TERM BIKE PARKING PROVIDED	LONG TERM BIKE PARKING REQUIRED	LONG TERM BIKE PARKING PROVIDE
INDOOR RECREATION	GOLF SIMULATION FACILITY (6.4.2.A)- PRIMARY USE	LOWER	5,236	5,236/11,752=44.6%	1 PER 300SF	18	0	1 PER 5,000SF OR MINIMUM OF 4	4	N/A	N/A
INDOOR RECREATION	HEALTH CLUB (6.4.2.C)-PRIMARY USE	LOWER	6,516	6,516/11,752=55.4%	1 PER 300SF	22	0	1 PER 5,000SF OR MINIMUM OF 4	4	N/A	N/A
INDOOR RECREATION	HATCHET THROWING FACILITY (6.4.2.C)- PRIMARY USE	UPPER	5,941	5,941/11,855=50.1%	1 PER 300SF	20	0	1 PER 5,000SF OR MINIMUM OF 4	4	N/A	N/A
OFFICE	PROFESSIONAL SERVICES (6.4.4.A.2)- PRIMARY USE	UPPER	2,754	2,754/11,855=23.2%	1 PER 400SF	7	0	1 PER 1,000SF OR MINIMUM OF 4	4	4	4
RESTAURANT/BAR	BAR- ALCOHOLIC BEVERAGE SALES IN EXCESS OF 70% OF THE BUSINESS TOTAL ANNUAL SALES (6.4.10.B)-PRIMARY USE	UPPER	3,160	3,160/11,855=26.7%	1 PER 150SF OR 1 PER 5 SEATS	21	0	1 PER 50,000SF OR MINIMUM OF 4	4	4	4
TOTALS	-	-	LOWER = 11,752 UPPER = 11,855 TOTAL = 23,607	-	-	88	0	20	20	8	8

LEGEND			/19	/20	/20
	EXISTING PROPERTY LINE	DATE	10/31/19	01/20/20	02/11/20
	EXISTING ABUTTING PROPERTY LINE				
	EXISTING RIGHT-OF-WAY	>	JAC	JAC	IAC.
OHW OHW OHW OHW OHW	EXISTING OVERHEAD POWER LINE	ВУ	7	→	-
	EXISTING ABUTTING PROPERTY LINE				
	EXISTING BUILDING SETBACK LINE				
	EXISTING PARKING SETBACK LINE				
	EXISTING EDGE OF PAVEMENT				
SSSSSSSS	EXISTING SANITARY SEWER				
	PROPOSED EDGE OF PAVEMENT				
	PROPOSED TEMPORARY EASEMENT				
	PROPOSED OUTDOOR AMENITY AREA	7			
	PROPOSED ADA ACCESSIBLE ROUTE	EVISION	TS	TS	υ. -
SUMMARY INFORM	IATION	REV	COMMENT	COMMENTS	COMMENTS
DEVELOPMENT NAME: 301 W. CABARRUS	STREET		11	l	
SITE ADDRESS: 301 W. CABARRUS STREE RALEIGH, NORTH CAROL			RALEIGH	RALEIGH	
PIN NUMBER: 1703-56-5859 (DB 17374, PG	5 706; BM 2019, PG 1756)		II —	_	7 0 0
TOTAL ACREAGE: 0.474 ACRES (20.651SE	,		Ю	P	

TOTAL ACREAGE: 0.474 ACRES (20,651SF)

CURRENT ZONING DISTRICT: DX-12-UG

*SEE BUILDING USE AND PARKING TABLE

SIDE STREET: 3'

FRONT: 3'

EXISTING BUILDING SQUARE FOOTAGE: 23,607SF*

PROPOSED BUILDING SQUARE FOOTAGE: 23,607SF*

JURISDICTION: CITY OF RALEIGH

EXISTING USE: OFFICE/RETAIL

PROPOSED USE: MIXED USE

BUILDING SETBACKS:


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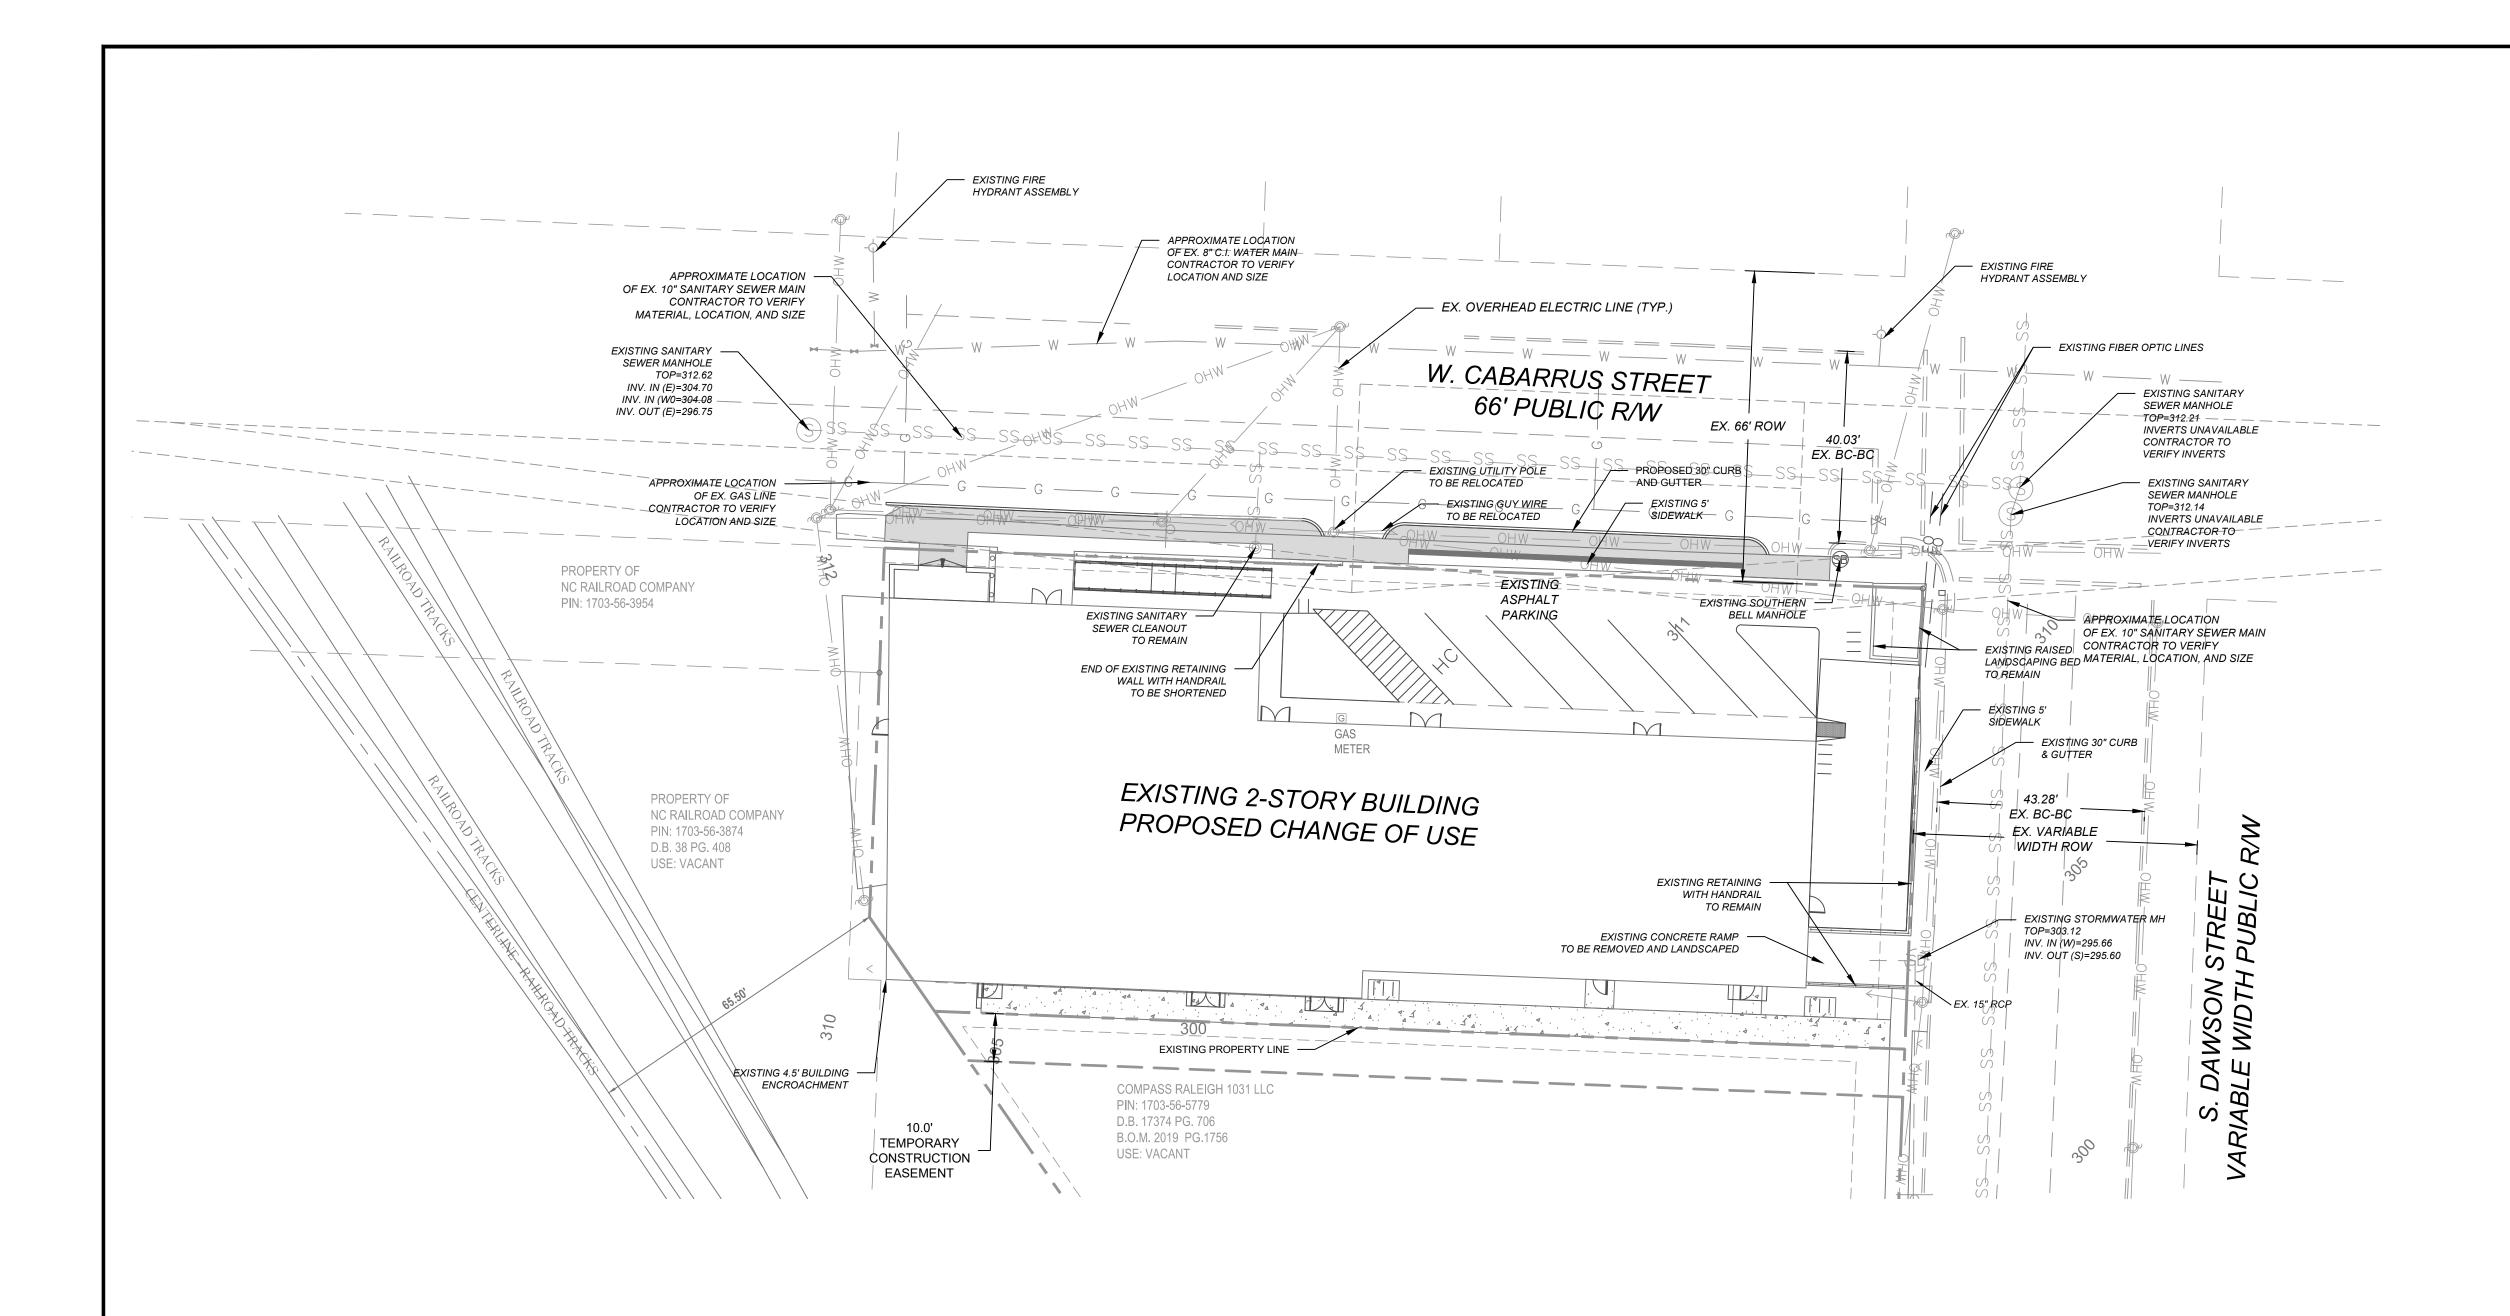
	SIDE STREET: 3' SIDE: 0 OR 6' REAR: 0 OR 6'	
	PARKING SETBACKS: FRONT: 10' SIDE STREET: 10' SIDE: 0 OR 3' REAR: 0 OR 3'	Ī
	REQUIRED PRIMARY BUILD-TO (70% BETWEEN 0'-20') REQUIRED SIDE STREET BUILD-TO (35% BETWEEN 0'-20') EXEMPT DUE TO EXISTING BUILDING CONDITIONS	
	REQUIRED OUTDOOR AMENITY AREA: 2,065 SF PROVIDED OUTDOOR AMENITY AREA: 2,070 SF AREA '1' = 717 SF AREA '2' = 1,353 SF TOTAL AREA = 2,070 SF	
	PRE DEVELOPMENT IMPERVIOUS AREA (SF/AC): 20,973SF/ 0.481AC POST DEVELOPMENT IMPERVIOUS AREA (SF/AC): 20,859SF/ 0.479AC	
	BLOCK PERIMETER REQUIRED (MAX): 2,000' BLOCK PERIMETER PROVIDED: 1,650'** **EXEMPT BASED ON UDO SECTION 8.3.2.A.1.b.ix FOR SITE LESS THAN 2 ACRES	
	OWNER/DEVELOPER: COMPASS RALEIGH 1031, LLC 2217 STANTONSBURG ROAD GREENVILLE, NC 27834	
	ENGINEER: CRUMPLER CONSULTING SERVICES, PLLC CONTACT: JOSH CRUMPLER, PE 2308 RIDGE ROAD	
	RALEIGH, NC 27612 (919) 413-1704	
Γ	<u>ES</u>	

NOTES


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- 2. PROPERTY IS LOCATED IN ZONES X (AREA DETERMINED TO BE OUTSIDE THE O.2% ANNUAL CHANCE AND FUTURE 1% ANNUAL CHANCE FLOODPLAIN) BASED ON THE FEMA MAP NUMBER 3720170300J DATED MAY
- 3. NO ONSITE STREAMS OR WETLANDS HAVE BEEN IDENTIFIED WITHIN THE PROJECT OR PARCEL AS SHOWN.
- 4. THIS DRAWING IS NOT FOR RECORDATION.



(SITE		301 W. CABAR RALEIGH, NOR
	DESIGNED BY:	JAC	
	DRAWN BY:	JAC	
	CHECKED BY:	JAC	
	DATE:	08/1	4/19
	SCALE:	1" =	20'
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	3 of	7	sheets

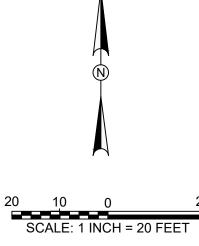

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				EXISTING PROPERTY LINE
				EXISTING ABUTTING PROPERTY LINE
				EXISTING RIGHT-OF-WAY
— онw—— онw—	— онw—	— онw—	— ОНW	EXISTING OVERHEAD POWER LINE
				EXISTING ABUTTING PROPERTY LINE
				EXISTING BUILDING SETBACK LINE
				EXISTING PARKING SETBACK LINE
				EXISTING EDGE OF PAVEMENT
_SS_S	SS_	_SS_	_SS	EXISTING SANITARY SEWER
- w w	w w	—— w -	w	EXISTING WATER MAIN
				PROPOSED EDGE OF PAVEMENT
_SS_SS	SS_	_SS_	_SS	PROPOSED SANITARY SEWER SERVI
w		w		PROPOSED WATER SERVICE

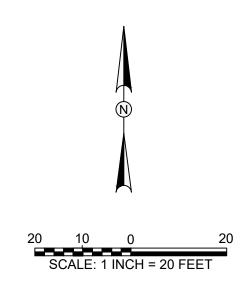- 1. ALL MATERIALS & CONSTRUCTION METHODS SHALL BE IN ACCORDANCE WITH CITY OF RALEIGH DESIGN STANDARDS, DETAILS & SPECIFICATIONS (REFERENCE: CORPUD HANDBOOK, CURRENT
- 2. UTILITY SEPARATION REQUIREMENTS:

REQUIRED.

- a. A DISTANCE OF 100' SHALL BE MAINTAINED BETWEEN SANITARY SEWER & ANY PRIVATE OR PUBLIC WATER SUPPLY SOURCE SUCH AS AN IMPOUNDED RESERVOIR USED AS A SOURCE OF DRINKING WATER. IF ADEQUATE LATERAL SEPARATION CANNOT BE ACHIEVED, FERROUS SANITARY SEWER PIPE SHALL BE SPECIFIED & INSTALLED TO WATERLINE SPECIFICATIONS. HOWEVER, THE MINIMUM SEPARATION SHALL NOT BE LESS THAN 25' FROM A PRIVATE WELL OR 50' FROM A PUBLIC WELL.
- b. WHEN INSTALLING WATER &OR SEWER MAINS, THE HORIZONTAL SEPARATION BETWEEN UTILITIES SHALL BE 10'. IF THIS SEPARATION CANNOT BE MAINTAINED DUE TO EXISTING CONDITIONS, THE VARIATION ALLOWED IS THE WATER MAIN IN A SEPARATE TRENCH WITH THE ELEVATION OF THE WATER MAIN AT LEAST 18" ABOVE THE TOP OF THE SEWER & MUST BE APPROVED BY THE PUBLIC UTILITIES DIRECTOR. ALL DISTANCES ARE MEASURED FROM OUTSIDE DIAMETER TO OUTSIDE DIAMETER.
- c. WHERE IT IS IMPOSSIBLE TO OBTAIN PROPER SEPARATION, OR ANYTIME A SANITARY SEWER PASSES OVER A WATERMAIN, DIP MATERIALS OR STEEL ENCASEMENT EXTENDED 10' ON EACH SIDE OF CROSSING MUST BE SPECIFIED & INSTALLED TO WATERLINE SPECIFICATIONS.
- d. 5.0' MINIMUM HORIZONTAL SEPARATION IS REQUIRED BETWEEN ALL SANITARY SEWER & STORM SEWER FACILITIES, UNLESS DIP MATERIAL IS SPECIFIED FOR SANITARY SEWER.
- e. MAINTAIN 18" MIN. VERTICAL SEPARATION AT ALL WATERMAIN & RCP STORM DRAIN CROSSINGS; MAINTAIN 24" MIN. VERTICAL SEPARATION AT ALL SANITARY SEWER & RCP STORM DRAIN CROSSINGS. WHERE
- MATERIALS & A CONCRETE CRADLE HAVING 6" MIN. CLEARANCE (PER CORPUD DETAILS W-41 & S-49) f. ALL OTHER UNDERGROUND UTILITIES SHALL CROSS WATER & SEWER FACILITIES WITH 18" MIN. VERTICAL SEPARATION

ADEQUATE SEPARATIONS CANNOT BE ACHIEVED, SPECIFY DIP

- 3. ANY NECESSARY FIELD REVISIONS ARE SUBJECT TO REVIEW & APPROVAL OF AN AMENDED PLAN &/OR PROFILE BY THE CITY OF RALEIGH PUBLIC UTILITIES DEPARTMENT PRIOR TO CONSTRUCTION.
- 4. CONTRACTOR SHALL MAINTAIN CONTINUOUS WATER & SEWER SERVICE TO EXISTING RESIDENCES & BUSINESSES THROUGHOUT CONSTRUCTION OF PROJECT. ANY NECESSARY SERVICE INTERRUPTIONS SHALL BE PRECEDED BY A 24 HOUR ADVANCE NOTICE TO THE CITY OF RALEIGH PUBLIC UTILITIES DEPARTMENT.
- 5. 3.0' MINIMUM COVER IS REQUIRED ON ALL WATER MAINS & SEWER FORCEMAINS. 4.0' MINIMUM COVER IS REQUIRED ON ALL REUSE
- 6. ABANDON AND REMOVE EXISTING WATER AND SEWER SERVICES NOT BEING USED IN REDEVELOPMENT OF SITE AS DIRECTED BY THE CITY OF RALEIGH PUBLIC UTILITIES DEPARTMENT. THIS INCLUDES ABANDONING TAP AT MAIN & REMOVAL OF SERVICE FROM ROW OR EASEMENT PER CORPUD HANDBOOK PROCEDURE.
- 7. INSTALL 2" COPPER WATER SERVICES WITH METERS LOCATED AT ROW OR WITHIN A 2'X2' WATERLINE EASEMENT IMMEDIATELY ADJACENT. NOTE: IT IS THE APPLICANT'S RESPONSIBILITY TO PROPERLY SIZE THE WATER SERVICE FOR EACH CONNECTION TO PROVIDE ADEQUATE FLOW & PRESSURE.
- 8. INSTALL 4" PVC SEWER SERVICES @ 1.0% MINIMUM GRADE WITH CLEANOUTS LOCATED AT ROW OR EASEMENT LINE & SPACED EVERY 75 LINEAR FEET MAXIMUM.
- 9. PRESSURE REDUCING VALVES ARE REQUIRED ON ALL WATER SERVICES EXCEEDING 80 PSI; BACKWATER VALVES ARE REQUIRED ON ALL SANITARY SEWER SERVICES HAVING BUILDING DRAINS LOWER THAN 1.0' ABOVE THE NEXT UPSTREAM MANHOLE.
- 10. ALL ENVIRONMENTAL PERMITS APPLICABLE TO THE PROJECT MUST BE OBTAINED FROM NCDWQ, USACE &/OR FEMA FOR ANY RIPARIAN BUFFER, WETLAND &/OR FLOODPLAIN IMPACTS (RESPECTIVELY) PRIOR TO CONSTRUCTION.
- 11. NCDOT / RAILROAD ENCROACHMENT AGREEMENTS ARE REQUIRED FOR ANY UTILITY WORK (INCLUDING MAIN EXTENSIONS & SERVICE TAPS) WITHIN STATE OR RAILROAD ROW PRIOR TO CONSTRUCTION.
- 12. GREASE INTERCEPTOR / OIL WATER SEPARATOR SIZING CALCULATIONS & INSTALLATION SPECIFICATIONS SHALL BE APPROVED BY THE CORPUD FOG PROGRAM COORDINATOR PRIOR TO ISSUANCE OF A BUILDING PERMIT. CONTACT TIM BEASLEY AT (919) 996-2334 OR timothy.beasley@raleighnc.gov FOR MORE INFORMATION.
- 13. CROSS-CONNECTION CONTROL PROTECTION DEVICES ARE REQUIRED BASED ON DEGREE OF HEALTH HAZARD INVOLVED AS LISTED IN APPENDIX-B OF THE RULES GOVERNING PUBLIC WATER SYSTEMS IN NORTH CAROLINA. THESE GUIDELINES ARE THE MINIMUM REQUIREMENTS. THE DEVICES SHALL MEET AMERICAN SOCIETY OF SANITARY ENGINEERING (ASSE) STANDARDS OR BE ON THE UNIVERSITY OF SOUTHERN CALIFORNIA APPROVAL LIST. THE DEVICES SHALL BE INSTALLED AND TESTED (BOTH INITIAL AND PERIODIC TESTING THEREAFTER) IN ACCORDANCE WITH THE MANUFACTURER'S RECOMMENDATIONS OR THE LOCAL CROSS-CONNECTION CONTROL PROGRAM, WHICHEVER IS MORE STRINGENT. CONTACT JOANIE HARTLEY AT (919) 996-5923 OR joanie.hartley@raleighnc.goc FOR MORE INFORMATION


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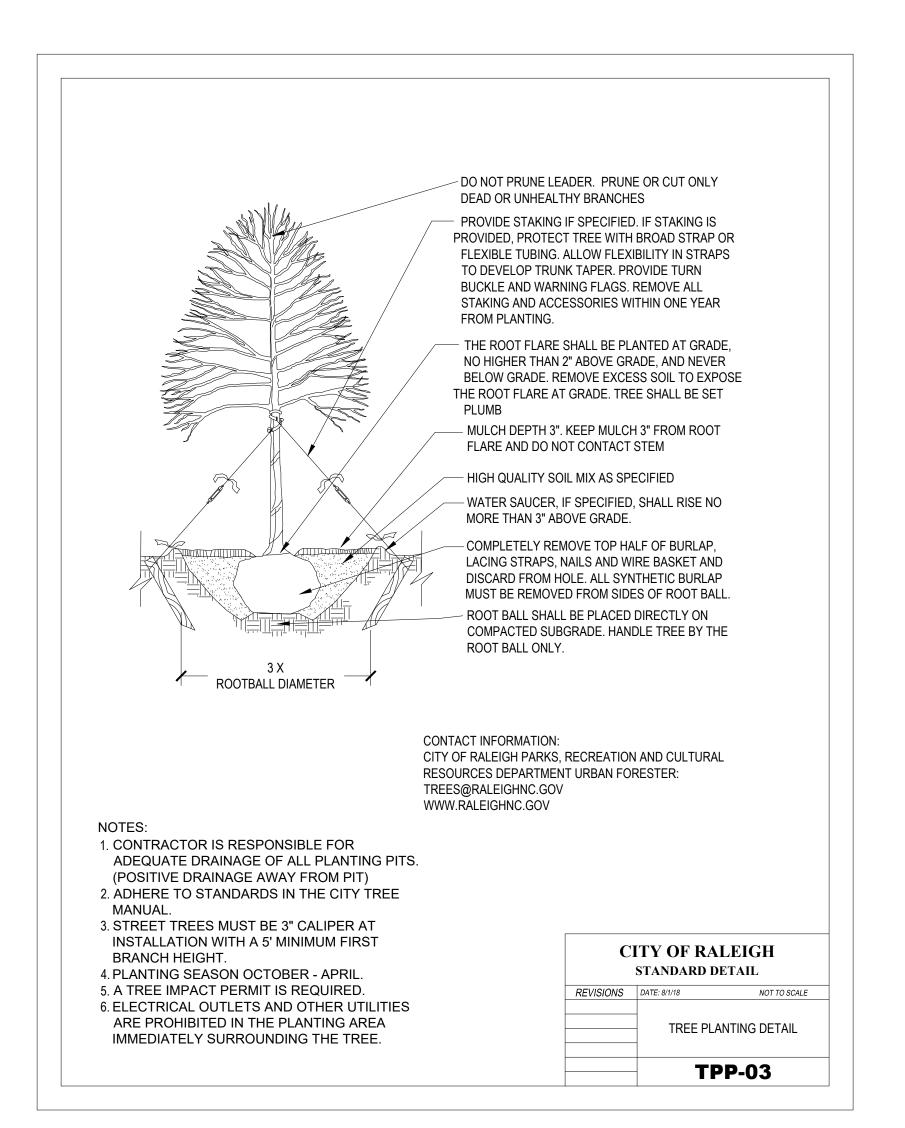
PERMITTING

ISSUED FOR

DESIGNED BY: JAC DRAWN BY: JAC CHECKED BY: **JAC**

08/14/19 1"=20'



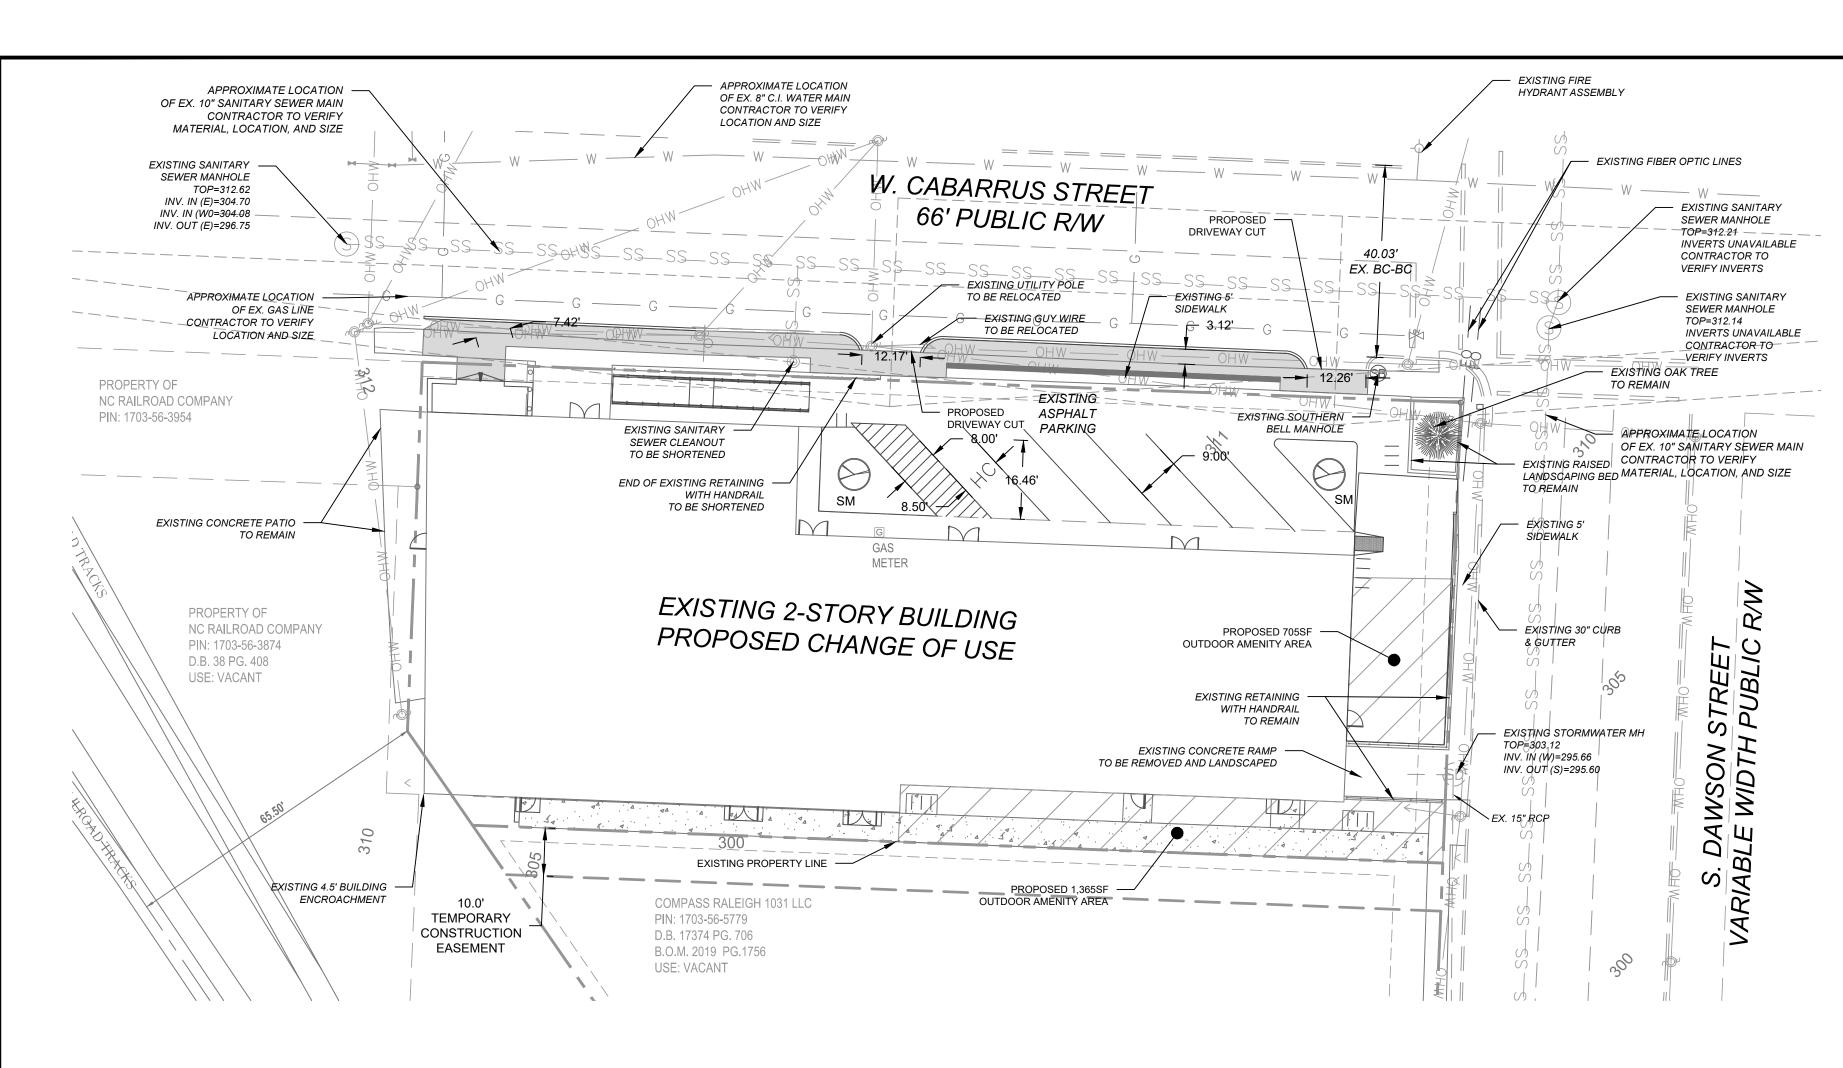

LANDSCAPING NOTES

- 1. ALL DISTURBED AREAS NOT OCCUPIED BY STRUCTURES, PAVING OR PLANTINGS SHALL BE SEEDED AND WATERED.
- 2. SEE DETAIL SHEETS FOR SEEDING SCHEDULE.
- 3. TWO LAYERS OF WEED BARRIER MADE FROM FIBERGLASS AND ULTRA-VIOLET LIGHT RESISTANT MATERIAL SHALL BE PLACED UNDER ALL PLANTING BEDS PRIOR TO
- 4. ALL TREE PLANTINGS SHALL BE MULCHED WITH 3" CLEAN, BARK MULCH.
- 5. A MINIMUM OF FOUR INDIVIDUAL SOIL SAMPLES SHALL BE TAKEN THROUGHOUT THE 1.2 STRUCTURAL SOIL COMPONENTS: SITE FOR OVERALL SOIL ANALYSIS.
- 6. MINIMUM TOPSOIL DEPTH SHALL BE 4" IN LAWN AREAS AND 12" IN LANDSCAPED AREAS. CONTRACTOR TO UTILIZE ALL ONSITE TOPSOIL. CONTRACTOR SHALL SUPPLY ADDITIONAL TOPSOIL AT NO ADDITIONAL COST TO OWNER IF EXISTING TOPSOIL IS NOT SUFFICIENT TO MEET THE NEEDS OF THIS PROJECT.
- 7. ALL PLANTING AREAS TO RECEIVE 1 CY OF SOIL CONDITIONER FOR EACH 75 SF OF PLANT BED AREA. ACCEPTABLE SOIL CONDITIONERS SHALL BE PULVERIZED PINE BARK, PEAT MOSS OR SHREDDED/COMPOSTED LEAVES.
- 8. CONTRACTOR TO FIELD VERIFY LOCATION OF EXISTING UTILITIES BEFORE BEGINNING OF GRADING AND LANDSCAPE INSTALLATION.
- 9. CONTRACTOR TO VERIFY QUANTITIES OF PLANTINGS AS SHOWN. PLANTINGS INDICATED ON PLANS SHALL PREVAIL OVER QUANTITIES INDICATED IN PLANT LIST IF DISCREPANCIES ARISE.
- 10. ALL PLANTS ARE TO BE THOROUGHLY "WATERED IN" THE SAME DAY AS PLANTED.
- 11. THE PLANT HOLE WIDTH SHALL BE A MINIMUM TWO TIMES THE DIAMETER OF THE ROOT BALL.
- 12. REMOVE BURLAP FROM TOP OF ROOT BALL BEFORE BACKFILLING AROUND BALL IS
- 13. ALL TREES, WHEN PLANTED, SHALL HAVE THE SAME RELATIONSHIP TO FINISHED
- 14. LANDSCAPING SHOWN MEETS REQUIREMENTS.

GRADE AS TO THE GRADING PLAN.

- 15. ALL ADDITIONAL LANDSCAPING SHALL BE PER OWNER.
- 16 ALL LANDSCAPING SHALL BE GUARANTEED FOR ONE (1) YEAR AFTER FINAL ACCEPTANCE. ANY PLANTINGS NEEDING REPLACEMENT WILL BE GUARANTEED FROM THE TIME OF REPLACEMENT IF AFTER FINAL ACCEPTANCE.

TREE CONSERVATION AND LANDSCAPING NOTES:

-THE SITE WILL BE CONFORMING TO THE EXEMPTION OF TREE CONSERVATION REQUIREMENTS THROUGH THE CITY OF RALEIGH'S UNIFIED DEVELOPMENT CODE SECTION 9.1.2 FOR PARCELS LESS THAN 2 ACRES IN SIZE.

-TREE IMPACT PERMIT IS REQUIRED PRIOR TO ISSUANCE OF BUILDING PERMIT TO PLANT TREES IN THE PUBLIC RIGHT OF WAY IF REQUIRED.

LANDSCAPING REQUIREMENTS

PROVIDED: 1 SHADE TREE (EXISTING)

S. DAWSON STREET

PARKING LOT LANDSCAPING

REQUIREMENT: 1 CANOPY TREE PER 40LF=216LF/40LF=5 TREES

REQUIREMENT: 1 CANOPY TREE PER 40LF=96LF/40LF=2 TREES

REQUIREMENT: 1 SHADE TREE FOR PARKING LESS THAN 10 SPACES

FEE IN LIEU TO BE PROVIDED

FEE IN LIEU TO BE PROVIDED

PROVIDED: 0 TREES DUE TO EXISTING SIDEWALK WIDTH LESS THAN 3.50'

PROVIDED: 0 TREES DUE TO EXISTING SIDEWALK WIDTH LESS THAN 3.50'

- 1. TOPOGRAPHIC AND BOUNDARY SURVEY PROVIDED BY BASS, NIXON, AND KENNEDY, DATED 06-20-2019.
- 2. PROPERTY IS LOCATED IN ZONES X (AREA DETERMINED TO BE OUTSIDE THE O.2% ANNUAL CHANCE AND FUTURE 1% ANNUAL CHANCE FLOODPLAIN) BASED ON THE FEMA MAP NUMBER 3720170300J DATED MAY
- 3. NO ONSITE STREAMS OR WETLANDS HAVE BEEN IDENTIFIED WITHIN THE PROJECT OR PARCEL AS SHOWN.
- 4. THIS DRAWING IS NOT FOR RECORDATION.

PLANTING REQUIREMENTS

- 1.1 GENERAL PRODUCT REQUIREMENTS A. PROVIDE A STRUCTURAL PLANTING SOIL USING THE TWO COMPONENTS LISTED BELOW THAT
 - MEET ASTM STANDARDS AS FOLLOWS: 1. 3/4" EXPANDED SLATE 80%

LEGEND

2. SANDY CLAY LOAM 20% 3. PERCENTAGES OF SAND AND CLAY MAY VARY TO MEET TEST REQUIREMENTS. B. COMPACTION: WHEN CALCULATING THE VOLUME NECESSARY FOR THE PROJECT, ADD

EXISTING PROPERTY LINE

EXISTING RIGHT-OF-WAY

EXISTING ABUTTING PROPERTY LINE

EXISTING OVERHEAD POWER LINE

EXISTING ABUTTING PROPERTY LINE

EXISTING BUILDING SETBACK LINE

EXISTING PARKING SETBACK LINE

EXISTING EDGE OF PAVEMENT

PROPOSED EDGE OF PAVEMENT

PROPOSED OUTDOOR AMENITY AREA

EXISTING SANITARY SEWER

- APPROXIMATELY 18% TO THE CALCULATED VOLUME TO ALLOW FOR COMPACTION WHICH OCCURS DURING INSTALLATION DUE TO DRIVING SMALL EQUIPMENT OVER THE PRODUCT, IN ADDITION TO THE NATURAL SETTLING PROCESS.
- 1. ONLY NON-HAZARDOUS FUELS SUCH AS COAL OR NATURAL GAS MAY BE USED TO PROCESS
- 2. UNIT DRY WEIGHT LOOSE: 48 LB./C.F. TO 55 LB./C.F. (ASTM C29)(SATURATED SURFACE LOOSE: 55 LBS./C.F. TO 60 LBS./C.F.)
- 3. SPECIFIC GRAVITY: 1.45 TO 1.60, DRY BULK (ASTM C127) 4. GRADATION: 3/4" - #4 SIZE
 - SIEVE SIZE % PASSING
 - 10-50
- 5. TEST FOR DEGRADATION LOSS USING LOS ANGELES ABRASION TESTING IN ACCORDANCE WITH ASTM C-131 MODIFIED METHOD FM 1-T096. NO MORE THAN 28% OF THE WEIGHT OF THE AGGREGATE MUST BE LOST TO DEGRADATION.
- B. SANDY CLAY LOAM: SANDY CLAY LOAM IS FOR MIXING WITH STRUCTURAL SOIL ONLY AND NOT TO BE CONFUSED WITH "PLANTING SOIL
 - TEXTURE: 40 - 65% SAND
 - 15 25% SILT 20 - 35% CLAY
- 2 5 % ORGANIC MATTER

3.0 PREPARATION:

- 1. STRUCTURAL SOIL IS SHOWN IN A PUBLIC RIGHT-OF-WAY OR EASEMENT. OBTAIN APPROVALS FROM PROPER AUTHORITIES BEFORE AND AFTER PLACING STRUCTURAL SOIL 2. ACHIEVE 90% OF MAXIMUM DRY DENSITY FOR THE SUBGRADE. (ASTM D698)
- B. PREPARING SUBGRADE:
- 1. THE SUBGRADE SHALL BE PREPARED ACCORDING TO THE FOLLOWING PROCEDURE: REMOVE ALL ORGANIC MATTER, DEBRIS, LOOSE MATERIAL AND LARGE ROCKS.

2. DIG OUT SOFT AND MUCKY SPOTS AND REPLACE WITH SUITABLE MATERIAL.

- 3. LOOSEN HARD SPOTS; UNIFORMLY COMPACT SUBGRADE TO 95% OF ITS MAXIMUM DRY
- C. PERFORATED UNDERDRAIN SYSTEM (IF USED): 1. INSTALL UNDER DRAIN SYSTEM, WITH SOCK OR SOIL SEPARATOR FABRIC, ACCORDING TO
- DRAWINGS AND CONNECTED TO STORM DRAIN.


3.3 INSTALLATION OF STRUCTURAL SOIL MIX: A. GENERAL:

- 1. INSTALL THE SOIL DRAINS ENSURING THE STRUCTURAL SOIL IS PROPERLY COMPACTED UNDER AND AROUND EACH PIPE.
- 2. CONSIDER USING ROOT BARRIERS IF IT IS DESIRED TO AVOID ROOT PENETRATION INTO ADJACENT UTILITIES.
- B. PLACING AND COMPACTING STRUCTURAL SOIL:
- 1. PLACE STRUCTURAL SOIL MIX IN HORIZONTAL LIFTS NOT EXCEEDING 12 INCHES DEPTH. COMPACT USING A VIBRATORY PLATE COMPACTING MACHINE, PERFORM A MINIMUM OF TWO PASSES, OF NOT LESS THAN 10 SECONDS PER PASS, BEFORE MOVING THE VIBRATORY PLATE TO THE NEXT ADJACENT LOCATION. ADDITIONAL PASSES MAY BE REQUIRED SHOULD THE FIELD ENGINEER DETERMINE ADDITIONAL COMPACTION IS NECESSARY TO INSURE STABILITY OF THE LAYER. CONTINUE PLACING AND COMPACTING 12 INCH LIFTS UNTIL THE SPECIFIED DEPTH IS REACHED.
- 2. FOR LARGE SPACES, A VIBRATORY STEEL ROLLER WEIGHING NO MORE THAN 12 TONS STATIC WEIGHT CAN BE USED. HORIZONTAL LIFTS SHOULD NOT EXCEED 12 INCHES COMPACTED. THE MINIMUM NUMBER OF PASSES IS TWO AND MAXIMUM NUMBER IS FOUR. ADDITIONAL PASSES MAY BE REQUIRED SHOULD THE FIELD ENGINEER DETERMINE ADDITIONAL COMPACTION IS NECESSARY TO INSURE STABILITY OF THE LAYER.

3.5 TREE PIT PREPARATION:

- A. TREE PIT EXCAVATION: 1. EXCAVATE THE TREE PIT USING THE FOLLOWING PROCEDURE:
 - a. EXCAVATE THE STRUCTURAL SOIL MIX TO A DEPTH EQUAL TO THE HEIGHT OF THE ROOT BALL OF THE TREE TO BE PLANTED. REMOVE THE STRUCTURAL SOIL TO WITHIN NO MORE THAN ONE FOOT OF THE EDGE OF THE PAVED AREA.
 - b. PLACE THE TREE IN THE PIT AND BACKFILL AS DESCRIBED BELOW AS SOON AS POSSIBLE.
 - c. NO TREE PIT SHALL REMAIN EXCAVATED FOR MORE THAN 2 HOURS UNLESS FORMS ARE USED.
- B. TREE PIT BACKFILL PLANTING MIX:
 - BACKFILL TREE PIT USING THE FOLLOWING PROCEDURE:
 - a. REMOVE ANY WOODEN FORMS. IMMEDIATELY PLACE THE TREE IN THE PIT AS DETAILED AND REPLACE THE EXCAVATED STRUCTURAL SOIL WITH EITHER OF THE FOLLOWING:
 - b. PLANTING SOIL FOR TREES AS SPECIFIED c. HAND TAMP THE PLANTING MIX IN 12 INCH LIFTS UNTIL THE PIT IS FILLED TO THE
 - SPECIFIED GRADE. d. DO NOT USE EXCAVATED SOIL AS ENGINEERED FILL TO SUPPORT PAVING OR
 - STRUCTURES. EXCESS EXCAVATED STRUCTURAL SOIL MIX MAY BE USED FOR OTHER PLANTING BACKFILL OPERATIONS.

KEY	QUA.	BOTANICAL NAME	COMMON NAME	AT PL	ANTING		MA	TURE
				HEIGHT	CALIPER	ROOT	HEIGHT	SPREAD
		SHADE TREES						
SM	2	ACER SACCHARUM	SUGAR MAPLE	10'	3"	B&B	60'	40'

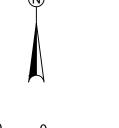

SCALE: 1 INCH = 20 FEET

1"=20'

08/14/19

DESIGNED BY: JAC

DRAWN BY: JAC


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TE 01.09.2020 EWM DSM OJ. # 19005

REVISIONS

DESCRIPTION DATE

ASR Review Cycle 1 10.31.20

ASR Review Cycle 2 01.21.20

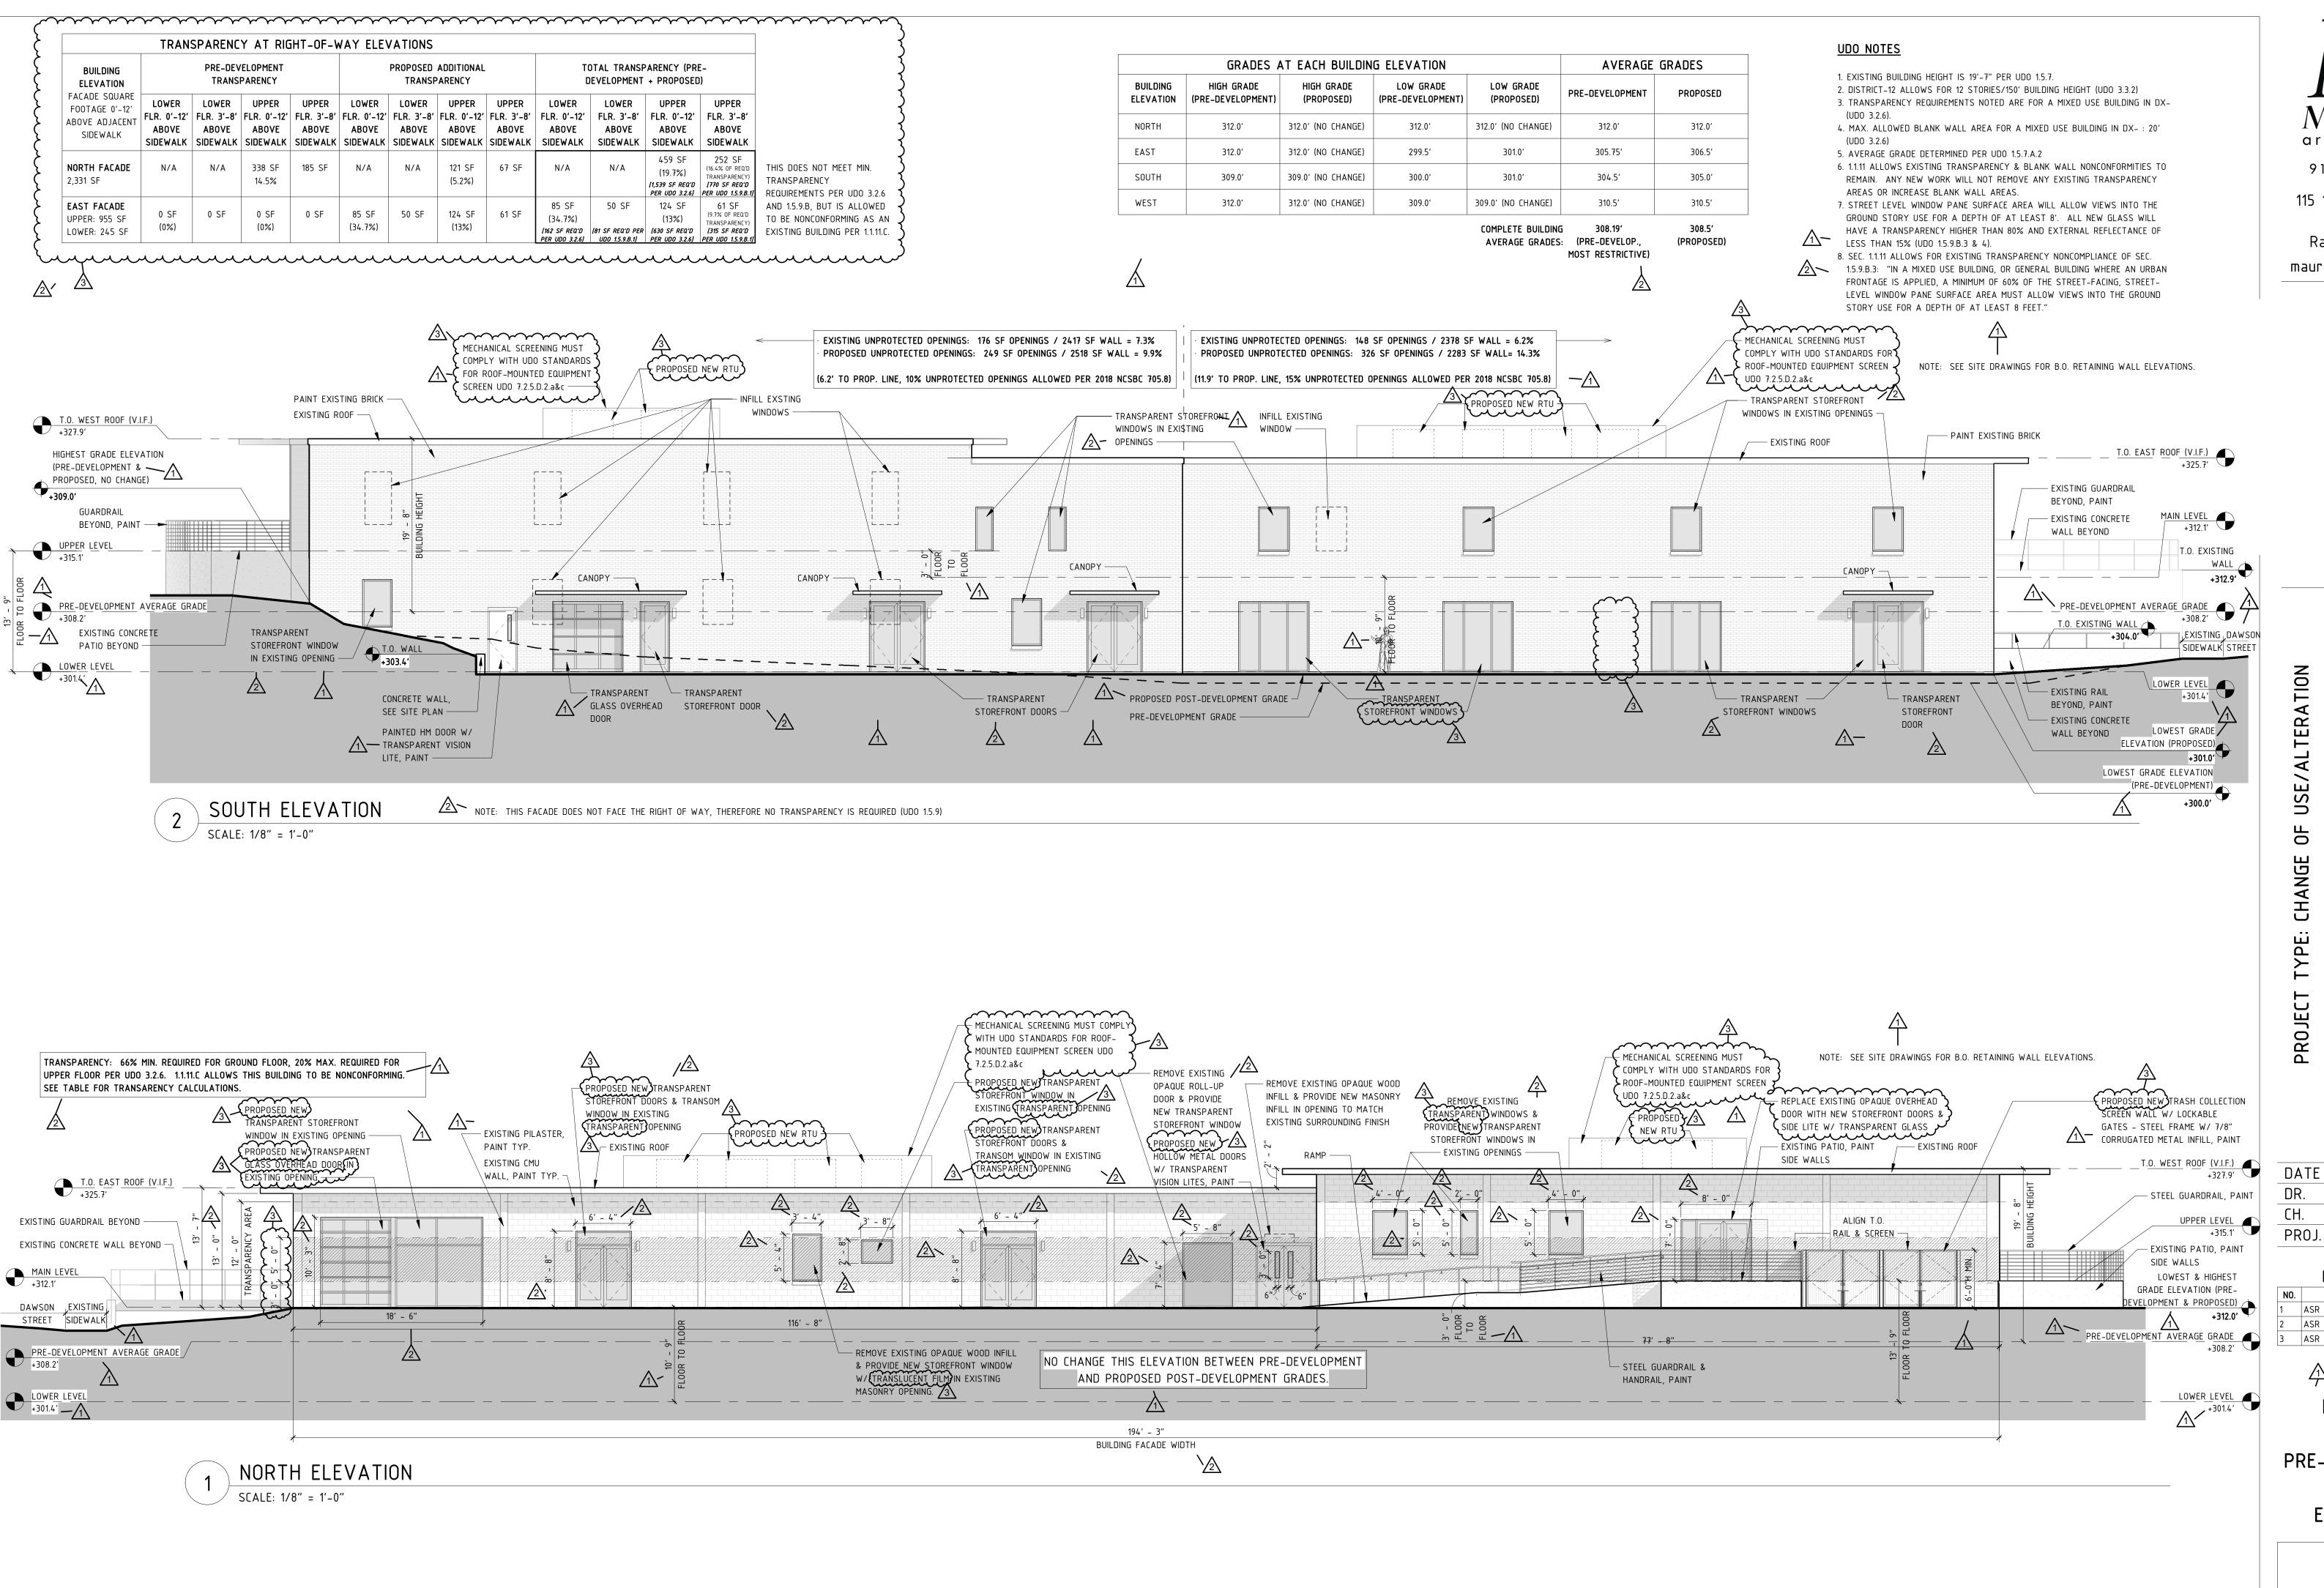PROPOSED

POST_ &

PROPOSED
POST- &
PRE-DEVELOPMENT
BUILDING
ELEVATIONS

A3.1

	TRANSPARENCY AT RIGHT-OF-WAY ELEVATIONS												
BUILDING ELEVATION			ELOPMENT PARENCY				ADDITIONAL PARENCY		TOTAL TRANSPARENCY (PRE- DEVELOPMENT + PROPOSED)				
FACADE SQUARE FOOTAGE 0'-12' BOVE ADJACENT SIDEWALK	LOWER FLR. 0'-12' ABOVE SIDEWALK	LOWER FLR. 3'-8' ABOVE SIDEWALK	UPPER FLR. 0'-12' ABOVE SIDEWALK	UPPER FLR. 3'-8' ABOVE SIDEWALK	LOWER FLR. 0'-12' ABOVE SIDEWALK	LOWER FLR. 3'-8' ABOVE SIDEWALK	UPPER FLR. 0'-12' ABOVE SIDEWALK	UPPER FLR. 3'-8' ABOVE SIDEWALK	LOWER FLR. 0'-12' ABOVE SIDEWALK	LOWER FLR. 3'-8' ABOVE SIDEWALK	UPPER FLR. 0'-12' ABOVE SIDEWALK	UPPER FLR. 3'-8' ABOVE SIDEWALK	
I ORTH FACADE ,331 SF	N/A	N/A	338 SF 14.5%	185 SF	N/A	N/A	121 SF (5.2%)	67 SF	N/A	N/A	459 SF (19.7%) [1,539 SF REQ'D PER UDO 3.2.6]	252 SF (16.4% OF REQ'D TRANSPARENCY) [770 SF REQ'D PER UDO 1.5.9.B.1]	THIS DOES NOT MEET MIN. TRANSPARENCY REQUIREMENTS PER UDO 3.
AST FACADE JPPER: 955 SF OWER: 245 SF	0 SF (0%)	0 SF	0 SF (0%)	0 SF	85 SF (34.7%)	50 SF	124 SF (13%)	61 SF	85 SF (34.7%) [162 SF REQ'D PER UDO 3.2.6]	50 SF [81 SF REQ'D PER UDO 1.5.9.B.1]	124 SF (13%) [630 SF REQ'D PER UDO 3.2.6]	61 SF (9.7% OF REQ'D TRANSPARENCY) (315 SF REQ'D PER UDO 1.5.9.8.1)	AND 1.5.9.B, BUT IS ALLOW TO BE NONCONFORMING AS EXISTING BUILDING PER 1.1.

	GRADES A	AVERAGE	GRADES			
BUILDING ELEVATION	HIGH GRADE (PRE-DEVELOPMENT)	HIGH GRADE (PROPOSED)	LOW GRADE (PRE-DEVELOPMENT)	LOW GRADE (PROPOSED)	PRE-DEVELOPMENT	PROPOSED
NORTH	312.0′	312.0' (NO CHANGE)	312.0′	312.0' (NO CHANGE)	312.0′	312.0′
EAST	312.0'	312.0' (NO CHANGE)	299.5'	301.0′	305.75'	306.5'
SOUTH	309.0′	309.0' (NO CHANGE)	300.0'	301.0′	304.5′	305.0'
WEST	312.0'	312.0' (NO CHANGE)	309.0'	309.0' (NO CHANGE)	310.5′	310.5′
				COMPLETE BUILDING	i 308.19'	308.5′

AVERAGE GRADES: (PRE-DEVELOP.,

MOST RESTRICTIVE)


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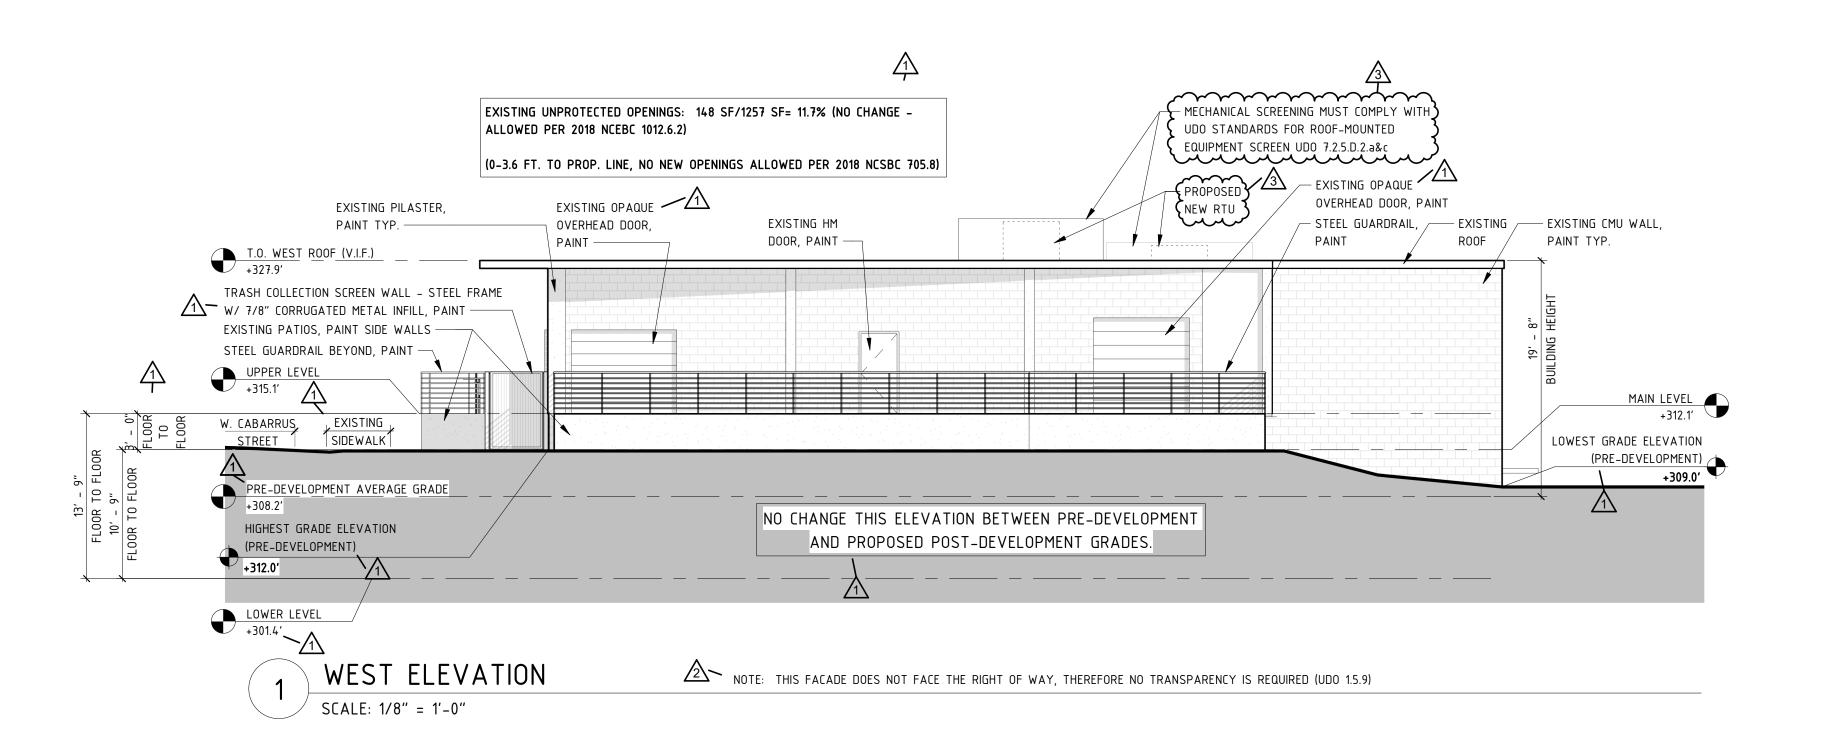
- 1. EXISTING BUILDING HEIGHT IS 19'-7" PER UDO 1.5.7.
- 2. DISTRICT-12 ALLOWS FOR 12 STORIES/150' BUILDING HEIGHT (UDO 3.3.2)
- 3. TRANSPARENCY REQUIREMENTS NOTED ARE FOR A MIXED USE BUILDING IN DX-
- 4. MAX. ALLOWED BLANK WALL AREA FOR A MIXED USE BUILDING IN DX- : 20' (UDO 3.2.6)
- 5. AVERAGE GRADE DETERMINED PER UDO 1.5.7.A.2
- 6. 1.1.11 ALLOWS EXISTING TRANSPARENCY & BLANK WALL NONCONFORMITIES TO REMAIN. ANY NEW WORK WILL NOT REMOVE ANY EXISTING TRANSPARENCY
- AREAS OR INCREASE BLANK WALL AREAS. 7. STREET LEVEL WINDOW PANE SURFACE AREA WILL ALLOW VIEWS INTO THE GROUND STORY USE FOR A DEPTH OF AT LEAST 8'. ALL NEW GLASS WILL HAVE A TRANSPARENCY HIGHER THAN 80% AND EXTERNAL REFLECTANCE OF LESS THAN 15% (UDO 1.5.9.B.3 & 4).



(PROPOSED)

8. SEC. 1.1.11 ALLOWS FOR EXISTING TRANSPARENCY NONCOMPLIANCE OF SEC. 1.5.9.B.3: "IN A MIXED USE BUILDING, OR GENERAL BUILDING WHERE AN URBAN FRONTAGE IS APPLIED, A MINIMUM OF 60% OF THE STREET-FACING, STREET-LEVEL WINDOW PANE SURFACE AREA MUST ALLOW VIEWS INTO THE GROUND STORY USE FOR A DEPTH OF AT LEAST 8 FEET."



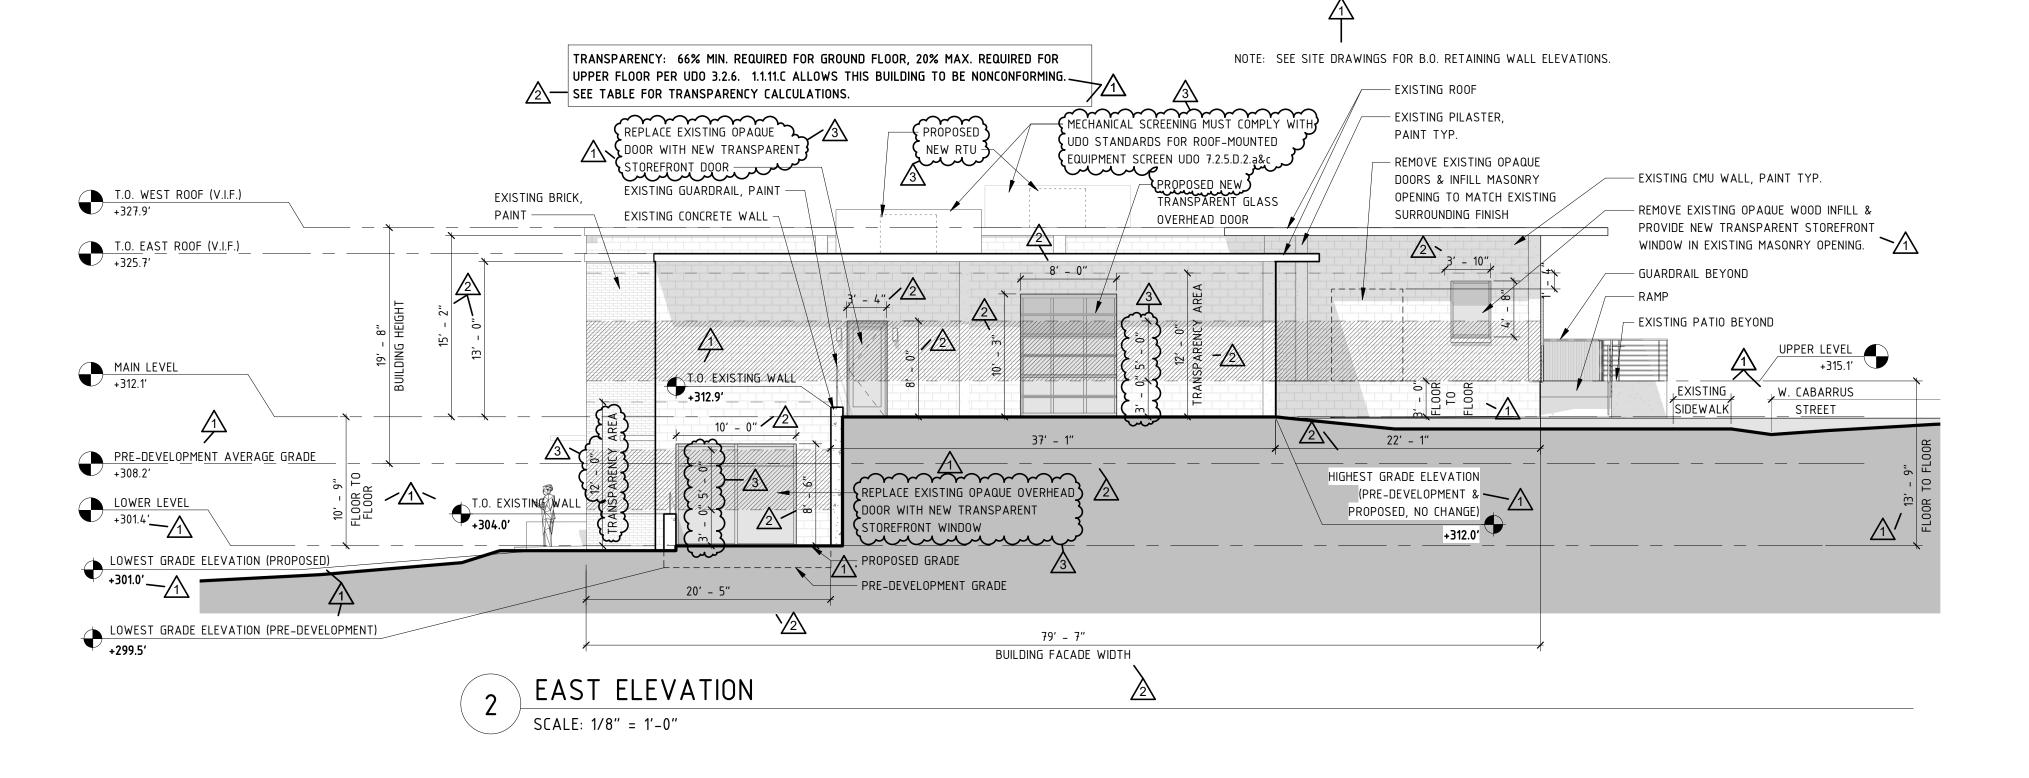

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USE/ALTERATION

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CHANGE

YPE:

PROJECT

01.09.2020 DATE EWM DSM PROJ. # 19005

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REVISIONS DESCRIPTION ASR Review Cycle 1 01.21.2020 ASR Review Cycle 2 ASR Review Cycle 3 02.14.2020

PROPOSED POST- & PRE-DEVELOPMENT

BUILDING **ELEVATIONS**


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PROPOSED **BUILDING USE PLANS**

A3.3



UPPER FLOOR PLAN - PROPOSED TENANT USE SCALE: 1/16" = 1'-0"

INNING TABLE BLEG	W DUPLICATED FROM SHEET C-3, FOR	R REFERENCE C	ONL Y								
				BUILDIN	G USE AND PARKI	NG TABLE					
USE	DESCRIPTION	FLOOR	GROSS AREA	% FLOOR AREA	VEHICLE PARKING REQUIRED	VEHICLE PARKING SPACES REQUIRED	VEHICLE PARKING PROVIDED**	SHORT TERM BIKE PARKING REQUIRED	SHORT TERM BIKE PARKING PROVIDED	LONG TERM BIKE PARKING REQUIRED	LONG TERM BIKE PARKING PROVIDED
INDOOR RECREATION	GOLF SIMULATION FACILITY (6.4.2.A)- PRIMARY USE	LOWER	5,236	5,236/11,752=44.6%	1 PER 300SF	18	0	1 PER 5,000SF OR MINIMUM OF 4	4	N/A	N/A
INDOOR RECREATION	HEALTH CLUB (6.4.2.C)-PRIMARY USE	LOWER	6,516	6,516/11,752=55.4%	1 PER 300SF	22	0	1 PER 5,000SF OR MINIMUM OF 4	4	N/A	N/A
INDOOR RECREATION	HATCHET THROWING FACILITY (6.4.2.C)- PRIMARY USE	UPPER	5,941	5,941/11,855=50.1%	1 PER 300SF	20	0	1 PER 5,000SF OR MINIMUM OF 4	4	N/A	N/A
OFFICE	PROFESSIONAL SERVICES (6.4.4.A.2)- PRIMARY USE	UPPER	2,754	2,754/11,855=23.2%	1 PER 400SF	7	0	1 PER 1,000SF OR MINIMUM OF 4	4	4	4
RESTAURANT/BAR	BAR- ALCOHOLIC BEVERAGE SALES IN EXCESS OF 70% OF THE BUSINESS TOTAL ANNUAL SALES (6.4.10.B)-PRIMARY USE	UPPER	3,160	3,160/11,855=26.7%	1 PER 150SF OR 1 PER 5 SEATS	21	0	1 PER 50,000SF OR MINIMUM OF 4	4	4	4
TOTALS	-	-	LOWER = 11,752 UPPER = 11,855 TOTAL = 23,607	-	-	88	0	20	20	8	8

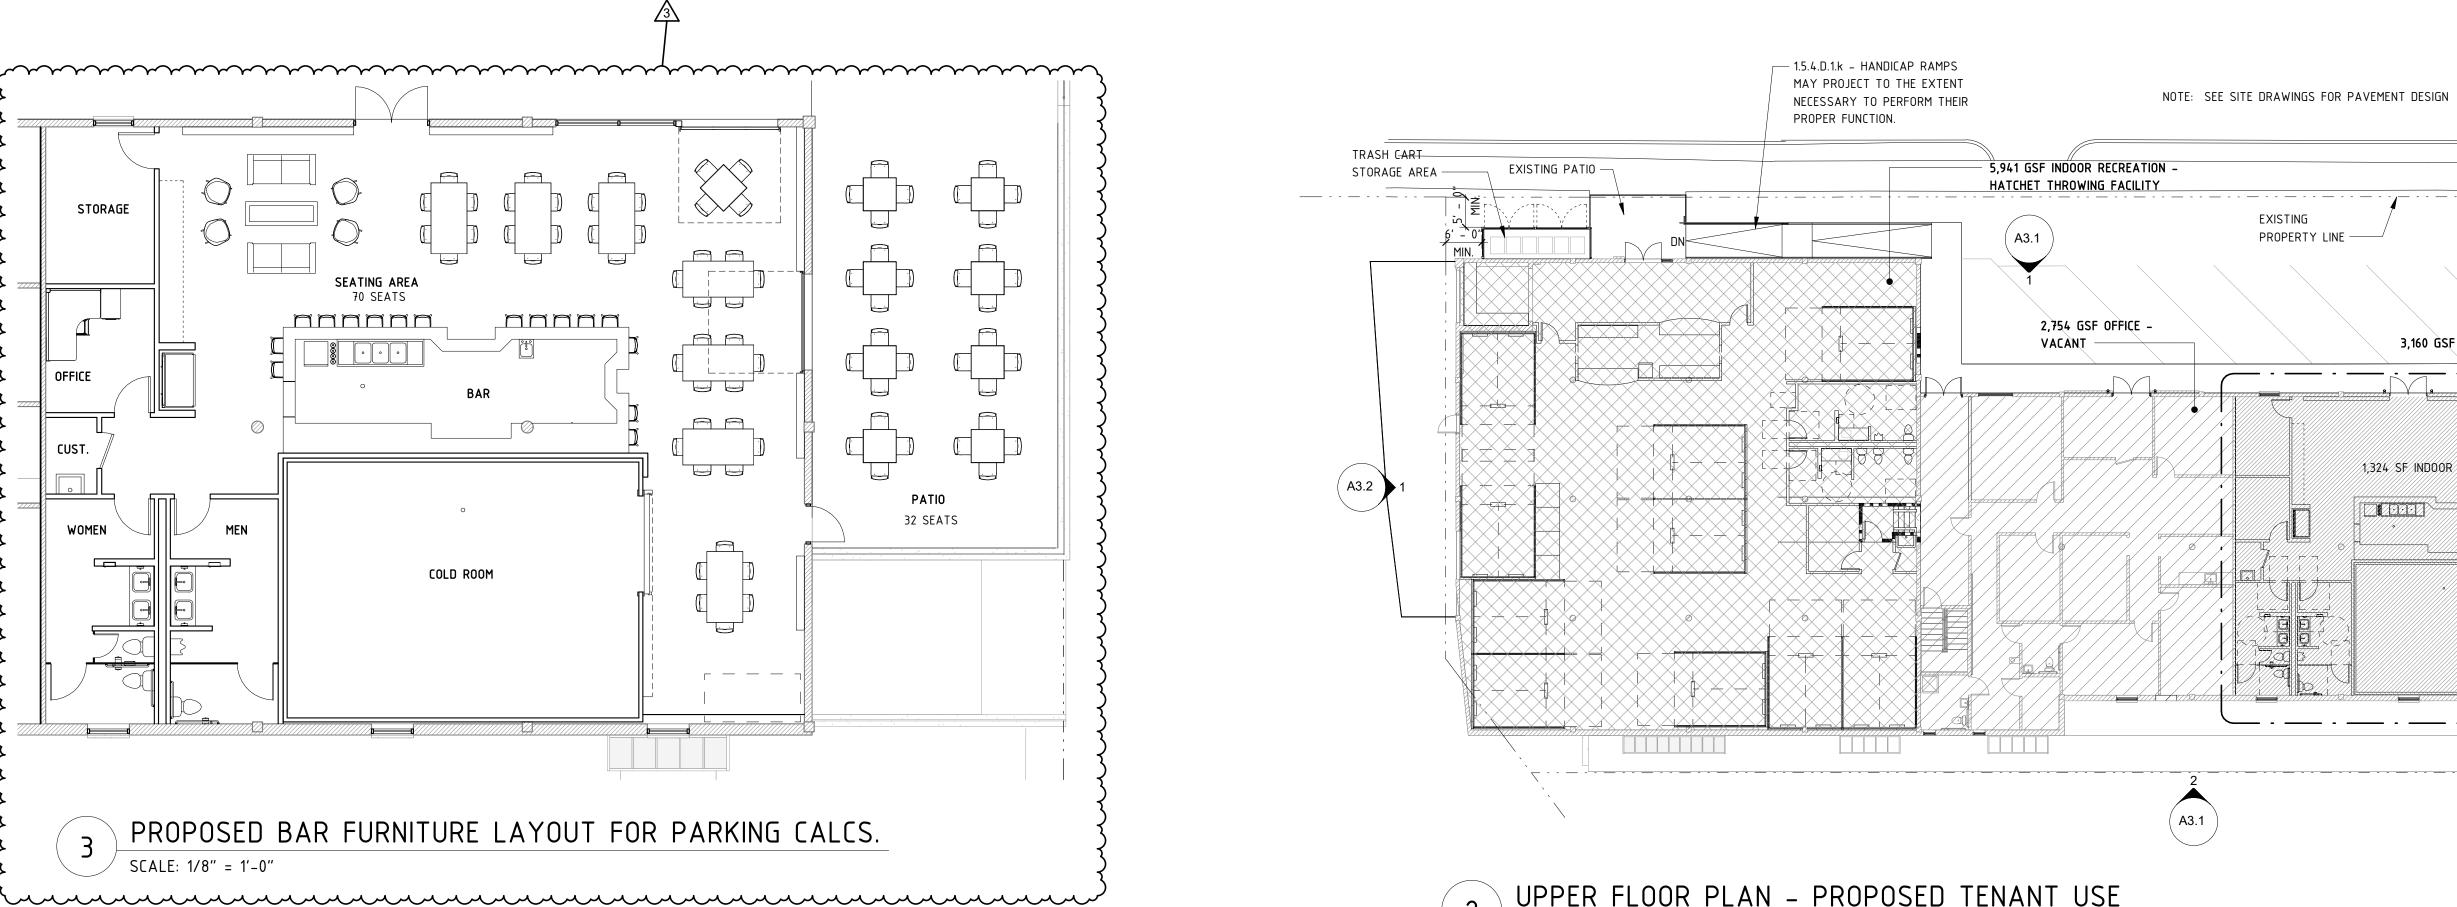
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COLD ROOM

PROPOSED BAR FURNITURE LAYOUT FOR PARKING CALCS.

BUILDING USES (
USE	DESCRIPTION	PTION FLOOR GROSS AREA (SF)		% TOTAL BUILDING AREA	% FLOOR AREA	
INDOOR RECREATION	GOLF SIMULATION FACILITY (6.4.2.A) – PRIMARY USE	LOWER	5,236	5,236 / 23,607 = 22.2%	5,236 / 11,752 = 44.6% LOWER FLOOR	
INDOOR RECREATION	HEALTH CLUB (6.4.2.C) - PRIMARY USE	LOWER	6,516	6,516 / 23,607 = 27.6%	6,516 / 11,752 = 55.4% LOWER FLOOR	
INDOOR RECREATION	HATCHET THROWING FACILITY (6.4.2.A) - PRIMARY USE	UPPER	5,941	5,941 / 23,607 = 25.1% (5,941 / 11,855 = 50.1% UPPER FLOOR	
OFFICE	PROFESSIONAL SERVICES (6.4.4.A.2) – PRIMARY USE	UPPER	2,754	2,754 / 23,607 = 11.7%	2,754 / 11,855 = 23.2% UPPER FLOOR	
RESTAURANT/BAR	BAR - ALCOHOLIC BEVERAGE SALES IN EXCESS OF 70% OF THE BUSINESS'S TOTAL ANNUAL SALES (6.4.10.B) - PRIMARY USE	UPPER	3,160	3,160 / 23,607 = 13.4% (3,160 / 11,855 = 26.7% UPPER FLOOR	

LOWER FLOOR GROSS AREA = 11,752 SF UPPER FLOOR GROSS AREA = 11,855 SF TOTAL BUILDING GROSS AREA = 23,607 SF

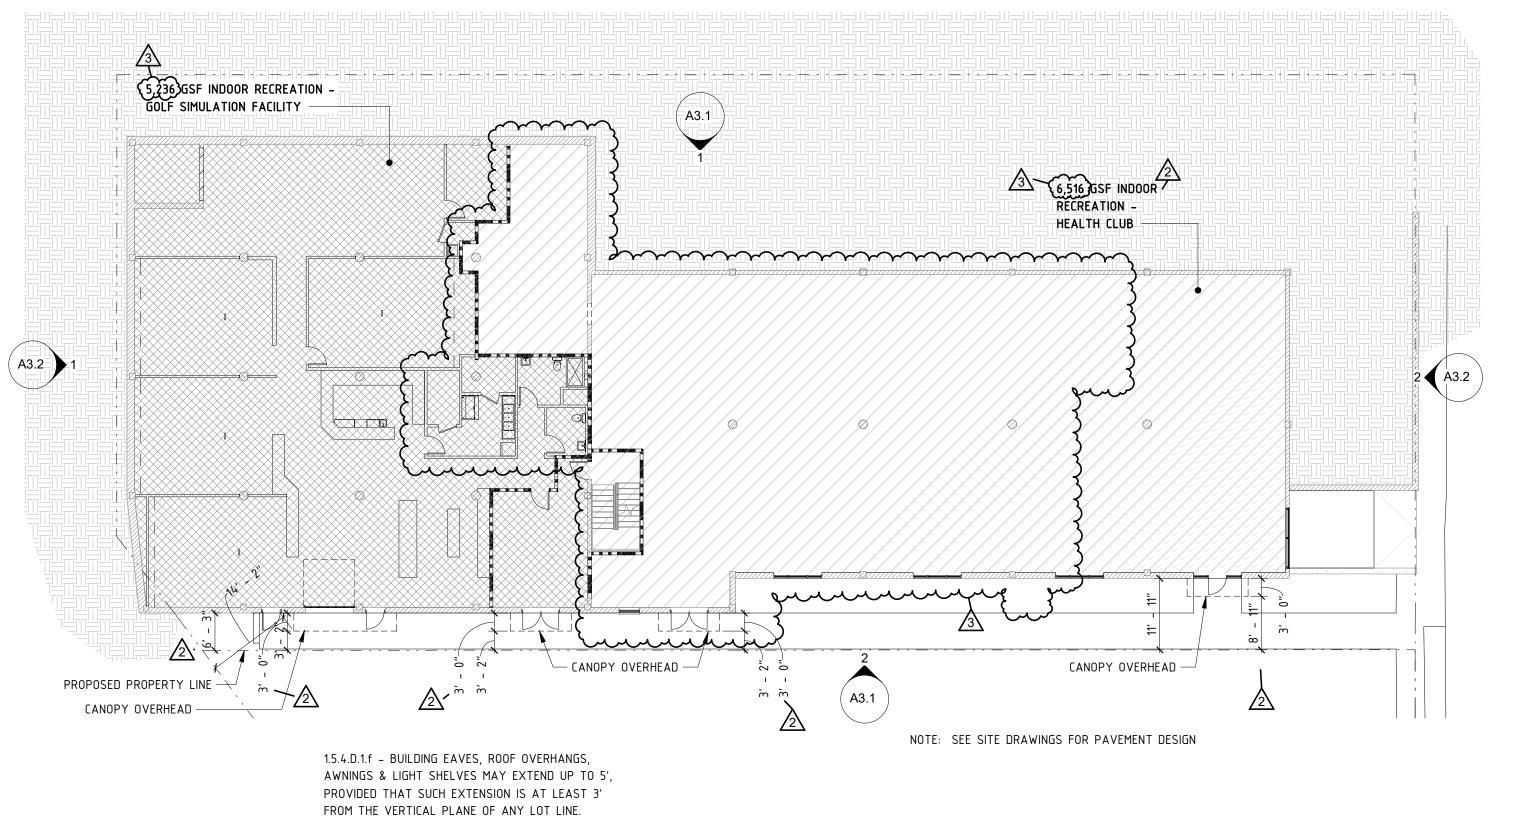

1,324 SF INDOOR DINING AREA

733 SF OUTDOOR

DINING AREA

LOWER FLOOR PLAN - PROPOSED TENANT USE

32 SEATS

SCALE: 1/16" = 1'-0"

STORAGE

OFFICE

CUST.

WOMEN

SCALE: 1/8'' = 1'-0''

DR. CH.

PROJECT

19005