

Administrative Site Review

Submittal Instructions

Site plan applications fall under one of the three tiers. The tier category indicates which Unified Development Ordinance (UDO) provisions are applicable in the review and approval of a site plan application. The Administrative Site Review (ASR) review process is for site plans that qualify as either a Tier Two or Tier Three Site Plan as specified in UDO Section 10.2.8.

Email all documents with your ASR plans to SiteReview@raleighnc.gov.

- Tier One Site Plans are reviewed under the Non-Residential Permit review process
- If assistance determining a Site Plan Tier is needed a Site Plan Tier Verification request can be submitted online via the <u>Permit and Development Portal</u>. Please note you will need a registered account to submit an online portal request. There is also a fee for this verification service.

Note: Applicants seeking to revise an already approved site plan must follow the "Modifications to an Approved Site Plan" application process.

Who can apply:

In accordance with state law (N.C.G.S. § 160D-403(a)), applications for site plan approvals may be made by the following individuals:

- The landowner (holder of the title in fee simple);
- A lessee or person holding an option or contract to purchase or lease land;
- An authorized agent of the landowner; or
- An easement holder, for such development as is authorized by the easement.

What to Submit:

- Administrative Site Review Checklist
- Administrative Site Review Application
- One digital copy of proposed plans and supporting documents
 - Original plans scanned to scale, in sequential order
 - o To engineering scale, example: 1"=20', 1"=100'
 - o For resubmittals, include all revisions and responses to comments
- If dwelling units are proposed, submit the <u>Wake County Residential Development Notification Form</u>

Mailed Notification Process (if applicable):

Notification letters should be mailed to:

Planning and Development Department

ATTN: Daniel L. Stegall

One Exchange Plaza, Suite 400

Raleigh, NC 27601

- Per UDO Section 10.2.8.C.1d and Section 10.2.1.C, notification letters must be provided at the time of application submission (when applicable). Please mail your letters as soon as possible to avoid delays. (See adopted UDO text change TC-11-20 "Tenant Notification")
- Mailouts will be processed once we receive both your digital application and your notification letter package.

Payment:

Please review the Development Fee Schedule to estimate your fees. Payments can be made:

- Online via the Permit and Development Portal (you must be a registered user)
- Over the phone via the Customer Service Center (919-996-2500)
- Fees for Site Plans are based on the project scope as defined in the Development Fee Schedule. (Please note: The Site Plan Tier and the Site Plan Level defined in the fee schedule are independent of one another.)

Questions? We're here to help! Contact the Planning and Development Customer Service Center at 919-996-2500 or ds.help@raleighnc.gov.

Administrative Site Review Application

Office Use Only: Case #:



Planning and Development Customer Service Center • One Exchange Plaza, Suite 400 | Raleigh, NC 27601 | 919-996-2500

This form is required when submitting site plans as referenced in Unified Development Ordinance (UDO) Section 10.2.8. Please check the appropriate building types and include the plan checklist document when submitting.

Planner (print):

-		* *
	n request can be submitted onli	olan tier. If assistance determining a Site Plan Tier is needed ne via the Permit and Development Portal. (Note: There is a
Site Plan Tier: Tier Tw	o Site Plan Tier Thr	ree Site Plan
_	d Development Type all that apply)	Site Transaction History
Detached Attached Townhouse Apartment Tiny house Open lot	General Mixed use Civic Cottage Court Frequent Transit Development Option	Subdivision case #: Scoping/sketch plan case #: Certificate of Appropriateness #: Board of Adjustment #: Zoning Case #: Design Alternate #:
Development name:	·	INFORMATION
Inside City limits? Ye Property address(es):	es No	
Site P.I.N.(s): Please describe the scop	e of work. Include any additions	s, expansions, and uses (UDO 6.1.4).
Current Property Owner	r(s):	
Company:		Title:
Address:		-
Phone #:	Email:	
Applicant Name (If diffe	rent from owner. See "who ca	an apply" in instructions):
Relationship to owner:	Lessee or contract purchaser	Owner's authorized agent Easement holder
Company:	Address:	

Page 1 of 3 REVISION 1.23.23

Phone #:	Email:	
NOTE: please attach purchase agreemen	t or contract,	lease or easement when submitting this form.
Developer Contact:		
Company:		Title:
Address:		
Phone #:	Email:	
Applicant Name:		
Company:	Address:	
Phone #:	Email:	
	•	

	PE + SITE DATE TABLE o all developments)
SITE DATA	BUILDING DATA
Zoning district(s) (please provide the acreage of each):	Existing gross floor area (not to be demolished):
Gross site acreage:	Existing gross floor area to be demolished:
# of parking spaces proposed:	New gross floor area:
Max # parking permitted (7.1.2.C):	Total sf gross (to remain and new):
Overlay District (if applicable):	Proposed # of buildings:
Existing use (UDO 6.1.4):	Proposed # of stories for each:
Proposed use (UDO 6.1.4):	Proposed # of basement levels (UDO 1.5.7.A.6)

STORMWATER	INFORMATION
Imperious Area on Parcel(s):	Impervious Area for Compliance (includes ROW):
Existing (sf) Proposed total (sf)	Existing (sf) Proposed total (sf)

	RESIDENTIAL & (OVERNIGHT	LODGING DEVELOPMENTS			
Total # of dwelling units:			Total # of hotel bedrooms:			
# of bedroom units: 1br	2br	3br	4br or more			
# of lots:			Is your project a cottage court?	Yes	No	
			A frequent transit development?	Yes	No	

Continue to Applicant Signature Block on Page Three.

Page 2 of 3 REVISION 1.23.23

APPLICANT SIGNATURE BLOCK

Pursuant to state law (N.C. Gen. Stat. § 160D-403(a)), applications for development approvals may be made by the landowner, a lessee or person holding an option or contract to purchase or lease land, or an authorized agent of the landowner. An easement holder may also apply for development approval for such development as is authorized by the easement.

By submitting this application, the undersigned applicant acknowledges that they are either the property owner or one of the persons authorized by state law (N.C.G.S. 160D-403(a)) to make this application, as specified in the application. The undersigned also acknowledges that the information and statements made in the application are correct and the undersigned understands that developments approvals are subject to revocation for false statements or misrepresentations made in securing the development approval, pursuant to N.C. Gen. Stat. § 160D-403(f).

The undersigned indicates that the property owner(s) is aware of this application and that the proposed project described in this application will be maintained in all respects in accordance with the plans and specifications submitted herewith, and in accordance with the provisions and regulations of the City of Raleigh Unified Development Ordinance.

The undersigned hereby acknowledges that, pursuant to state law (N.C.G.S. 143-755(b1), if this permit application is placed on hold at the request of the applicant for a period of six consecutive months or more, or if the applicant fails to respond to comments or provide additional information requested by the City for a period of six consecutive months or more, then the application review is discontinued and a new application is required to proceed and the development regulations in effect at the time permit processing is resumed shall apply to the new application.

Signature: Date: 12-8-23

Printed Name: Alexander Shapiro

Page 3 of 3 REVISION 1.23.23

Administrative Site Review Checklist



Planning and Development Customer Service Center • One Exchange Plaza, Suite 400 | Raleigh, NC 27601 | 919-996-2500

Use this checklist as a guide for Administrative Site Review submittals requirements. This checklist must be submitted with your application.

MAILED NOTIFICATION REQUIREMENTS

Mailed notice is required for projects that:

- 1. Include new buildings greater than 25,000 square feet, or additions that represent a 10% increase in building area or 25,000 square feet (whichever is greater), AND;
- 2. The subject property is located within 100 feet of a property that is zoned: R-1, R-2, R-4, R-6, R-10 If your project requires mailed notice, click here to download the letter template and other helpful information.

Please check one of the following:

Yes, my project meets the mailed notification requirement and my letters are provided with this application. The mailed notification is not applicable for my project.

GENERAL REQUIREMENTS	APPLI	CANT	С	ITY STAF	F
Applicant to provide the following plan information:	YES	N/A	YES	NO	N/A
1. Cover sheet and/or second sheet: include project name and location; copy of applications, site data table (include Property Identification Numbers (PINs), Zoning, Overlay District(s), Frontage Type, Current Use(s), Proposed Use(s), Building Square Footage(s), residential density and unit data, existing and proposed parking calculations); general notes; sheet index and legend defining symbols with north arrow; contact information for owner, applicant, and all consultants; vicinity map no smaller than 1"=500" and no larger than 1"=1000'; and adopted zoning conditions (if any)					
2. Existing conditions sheet: including, but not limited to - graphic scale; site size with meets and bounds; setbacks/ build-to lines; existing structures; utilities and easements; topography, infrastructure (adjacent streets with names and r/w width, sidewalks, water, and sewer); built improvements (parking, driveways, alleys); and vegetation					
3. Demolition plan: Clearly indicate items to be removed					
4. Proposed site plan: including but not limited to – north arrow and graphic scale; show and distinguish between existing and proposed conditions (<i>structures, streets, driveways, parking, storage areas, service areas, etc.</i>); setback/build-to lines; proposed property lines; streetscape; mechanical equipment (<i>HVAC, generators, etc.</i>); sidewalks, walkways, trails; solid waste facilities; parking and parking calculations (<i>UDO Section 7.1.2</i>); amenity area (<i>UDO Section 1.5.3.</i>) open space and/or greenways; transition protective yard (<i>UDO Section 7.2.4</i>); Site Data (<i>Square footages for proposed and existing uses; Parking calculations; amenity area calculations</i> ; Setback/Build-to; transitional protective yard type (<i>UDO Section 7.2.4.B.</i>)					

Please continue to page two >>

Page 1 of 2 REVISION 1.23.23

GENERAL REQUIREMENTS	APPLI	CANT	С	ITY STAF	F
Applicant to provide the following plan information:	YES	N/A	YES	NO	N/A
5. Proposed grading plan: including but not limited to - Limits of land disturbance; grading; structural improvements with finished floor elevations; stream buffers with labels; labeled impervious surfaces (and calculations); tree protection fencing information; retaining walls with top and bottom of wall; stormwater ponds, bioretention facilities, etc.					
6. Proposed stormwater plan: include preliminary stormwater quantity and quality summary and calculations package. If not required, provide notes indicating such and reference UDO section on front cover					
7. Proposed Utility Plan: All utilities (shown underground); above ground utilities and equipment with required screening (<i>UDO Section 7.2.5.D.</i>); include Fire					
8. Lighting Plan: Pole mounted fixture locations and details (with height labeled to top of fixture; building mounted fixture locations; graphics and notes conveying compliance with UDO Section 7.4					
9. Proposed tree conservation plan: for secondary tree conservation areas, include tree cover report completed by a certified arborist, NC licensed landscape architect, or NC registered forester. If not required, provide notes indicating such and reference UDO section on front cover					
10. Proposed landscape plan: (<i>UDO Section 7.2</i>) including but not limited to – existing vegetation to remain; proposed landscaping meeting minimum size and species mixing requirements; plant list; label yard types; show and label parking lot landscaping (<i>UDO Section 7.1.7.</i>) include existing and/or proposed parking lot light fixtures					
11. Architectural Elevations showing existing and/or proposed building height per UDO Section 1.5.7., 2.3, 3.2., and 3.3., transparency per UDO Section 1.5.9., 2.3 and 3.2, and blank wall area per UDO Section 1.5.10.					

Page 2 of 2 REVISION 1.23.23



GO RALEIGH - NEW HOPE PARK AND

1426 WILDERS GROVE LN AND 1451 N. NEW HOPE RD. RALEIGH, NORTH CAROLINA, 27604

CLIENT

SITE DEVELOPMENT PLANS


PROJECT NUMBER: RAL22005 DATE: DECEMBER 6, 2023

SHEET INDEX

C9.00

PROJECT NOTES **EXISTING CONDITIONS** C2.00 SITE PLAN C3.00 GRADING AND STORM DRAINAGE PLAN C6.00 STAGE 1 EROSION CONTROL PLAN C6.01 STAGE 2 EROSION CONTROL PLAN **EROSION CONTROL DETAILS** C6.11 **EROSION CONTROL DETAILS EROSION CONTROL DETAILS** C8.00 STORMWATER DETAILS C8.01 TRANSPORTATION DETAILS C8.02 TRANSPORTATION DETAILS C8.03 TRANSPORTATION DETAILS

SCM A AND SCM B PLAN VIEW

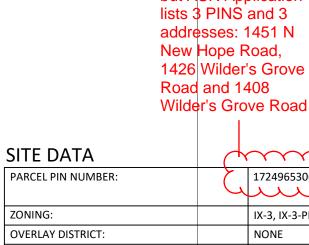

SITE DATA	(
PARCEL PIN NUMBER:	(1724965306, 1724962367
ZONING:		IX-3, IX-3-PL
OVERLAY DISTRICT:		NONE
WATERSHED:		CRABTREE CREEK
FLOODPLAIN/FIRM PAI	NEL:	3720079600J
SITE AREA		1.43 AC (62486 SF), SEE ALTA/NSPS LAND TITLE SURVEY
EXISTING USE:		VACANT; COMMERCIAL
PROPOSED USE:		GORALEIGH FACILITY
PARKING DATA:	VEHICLE PARKING	REQUIRED: NO MAXIMUM PROVIDED: 98 SPACES
	EV VEHICLE PARKING	PROVIDED: 11 SPACES EV READY: 10 SPACES
	ACCESSIBLE PARKING	REQUIRED: 4 SPACES; 1 VAN SPACE PROVIDED: 6 SPACES; 3 VAN SPACES
	BIKE PARKING	PROVIDED: 20 SPACES
NEIGHBORHOOD TRANSITIONS AND	NORTHERN PROPERTY LINE	N/A
PARKING + BUILDING SETBACKS:	SOUTHERN PROPERTY LINE	N/A
	N NEW HOPE RD AND NEW BERN AVE	N/A
	BUILD-TO	N/A
DWELLING UNITS:		MAXIMUM ALLOWED: 185 DWELLING UNITS PROPOSED: N/A
OUTDOOR AMENITY A	REA:	REQUIRED: 0.475 AC, 20,710 SF (95 UNITS * 218 SF/UNIT PROVIDED: 1.21 AC, 52,893 SF (26.6%) SEE C2.00 FOR DETAILS

RIGHT-OF-WAY OBSTRUCTION NOTES

REQUIRED: PROVIDED:

TREE CONSERVATION:

LANE AND SIDEWALK CLOSURES OR DETOURS: PRIOR TO ANY LANE OR SIDEWALK OBSTRUCTION, THE
CONTRACTOR OR ENGINEER SHALL SUBMIT A TRAFFIC CONTROL AND/OR PEDESTRIAN PLAN ALONG WITH A
RIGHT-OF-WAY SERVICES APPLICATION TO REQUEST THE OBSTRUCTION PRIOR TO THE START OF WORK.
rightofwayservices@raleighnc.gov FOR APPROVAL.

0.456 AC, 19,865 SF (10% PARCEL NET AREA)

0.462 AC, 20,112 SF (10.1%)

- 2. THE CITY OF RALEIGH REQUIRES AN APPROVED RIGHT-OF-WAY OBSTRUCTION PERMIT FOR WORK ON ANY PUBLIC STREET OR SIDEWALK AND NCDOT ROAD WITHIN RALEIGH'S JURISDICTION.
- 3. ALL TRAFFIC CONTROL SIGNAGE AND PRACTICES SHALL ADHERE TO THE MANUAL ON UNIFORM TRAFFIC CONTROL, AND THE LATEST EDITION OF THE NCDOT "STANDARD SPECIFICATION FOR ROADWAY STRUCTURES", NCDOT "ROADWAY STANDARD DRAWING MANUAL", AND THE NCDOT SUPPLEMENT TO THE MUTCD.

ALL PUBLIC SIDEWALKS MUST BE ACCESSIBLE TO PEDESTRIANS WHO ARE VISUALLY IMPAIRED AND/OR PEOPLE


ENGINEERING INSPECTIONS COORDINATOR TO REVIEW THE SPECIFIC COMPONENTS OF THE APPROVED PLAN,

- WITH MOBILITY CONCERNS. EXISTING AND ALTERNATIVE PEDESTRIAN ROUTES DURING CONSTRUCTION SHALL BE REQUIRED TO BE COMPLIANT WITH THE PUBLIC RIGHTS OF WAY ACCESSIBILITY GUIDELINES (PROWAG), THE ADA STANDARDS FOR ACCESSIBILITY DESIGN AND THE MANUAL ON UNIFORM TRAFFIC CONTROL DEVICES (MUTCD).

 5. PRIOR TO THE START OF WORK, THE CLIENT SHALL SCHEDULE A PRE-CONSTRUCTION MEETING WITH THE
- AND ENSURE ALL PERMITS ARE ISSUED.


 5. ALL PERMITS MUST BE AVAILABLE AND VISIBLE ON SITE DURING THE OPERATION.



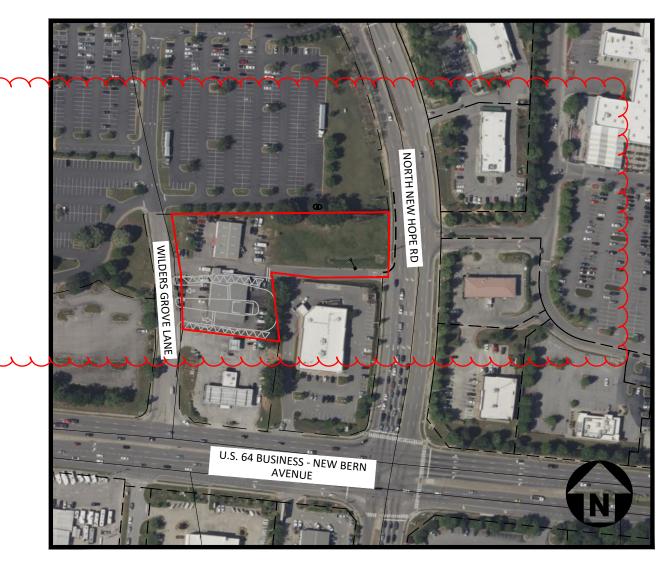

VICINITY MAP

NTS

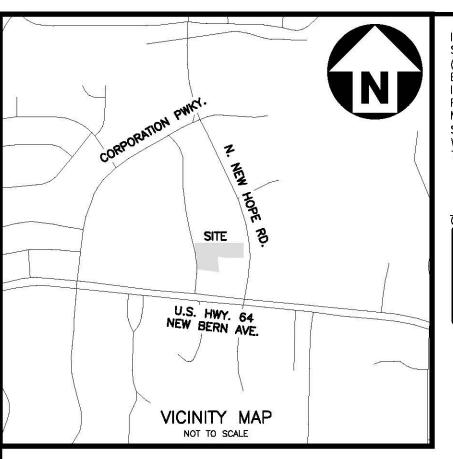

CONNOR J. STEARNS, CERTIFY THAT THIS PLAT WAS DRAWN UNDER MY SUPERVISION FROM AN ACTUAL SURVEY MADE UNDER MY SUPERVISION (DEED DESCRIPTION RECORDED IN BOOK AND PAGE AS SHOWN); THAT THE BOUNDARIES NOT SURVEYED ARE CLEARLY INDICATED AS DRAWN FROM INFORMATION FOUND IN BOOK AND PAGE AS SHOWN; THAT THE RATIO OF PRECISION OR POSITIONAL ACCURACY IS 1:552,802+; AND THAT THIS MAP MEETS THE REQUIREMENTS OF THE STANDARDS OF PRACTICE FOR LAND SURVEYING IN NORTH CAROLINA (21 NCAC 56.1600). WITNESS MY ORIGINAL SIGNATURE, LICENSE NUMBER AND SEAL

THIS _____, A.D., _____. PRELIMINAR

SURVEY WAS COMPLETED ON MARCH 27, 2023; THAT CONTOURS SHOWN AS [BROKEN LINES] MAY MEET THE STATED STANDARD; AND ALL COORDINATES ARE BASED ON NAD83 AND REALIZATION (2001) AND ALL ELEVATIONS ARE BASED ON NAVD 88.

PERFORMED TO MEET THE REQUIREMENTS FOR A

ONNOR J. STEARNS, PLS L-5469

I, CONNOR J. STEARNS, CERTIFY THAT THIS PROJECT WAS COMPLETED

PERFORMED AT THE 95 PERCENT CONFIDENCE LEVEL TO MEET FEDERAL

TOPOGRAPHIC/PLANIMETRIC SURVEY TO THE ACCURACY OF CLASS A AND

VERTICAL ACCURACY WHEN APPLICABLE TO THE CLASS A STANDARD, AND THAT THE ORIGINAL DATA WAS OBTAINED ON MARCH 22, 2023; THAT THE

MADE UNDER MY SUPERVISION; THAT THIS GROUND SURVEY WAS

GEOGRAPHIC DATA COMMITTEE STANDARDS; THAT THIS SURVEY WAS

UNDER MY DIRECT AND RESPONSIBLE CHARGE FROM AN ACTUAL SURVEY

GENERAL NOTES

- 1. THIS IS A SURVEY OF AN EXISTING PARCEL OF LAND. THIS IS A BOUNDARY AND TOPOGRAPHIC SURVEY.

 2. BEARINGS FOR THIS SURVEY ARE BASED ON NC GRID NAD83
- ALL DISTANCES ARE HORIZONTAL GROUND DISTANCES. ZONING: IX-3 PER WAKE COUNTY GIS
- AREA BY COORDINATE GEOMETRY.
- FLOOD NOTE: THIS PROPERTY IS NOT LOCATED IN A SPECIAL FLOOD HAZARD ZONE. IT IS LOCATED IN ZONE "X" AS DEFINED BY F.E.M.A F.I.R.M COMMUNITY PANEL #3720172400K DATED 07/19/2022. REFERENCES: AS SHOWN

UTILITY STATEMENT
THE UNDERGROUND UTILITIES SHOWN HAVE BEEN LOCATED FROM FIELD SURVEY INFORMATION AND EXISTING DRAWINGS. THE SURVEYOR MAKES NO GUARANTEE THAT THE UNDERGROUND UTILITIES SHOWN COMPRISE ALL SUCH UTILITIES IN THE AREA, EITHER IN SERVICE OR ABANDONED. THE SURVEYOR FURTHER DOES NOT WARRANT THAT THE UNDERGROUND UTILITIES SHOWN ARE IN THE EXACT LOCATION INDICATED ALTHOUGH HE DOES CERTIFY THAT THEY ARE LOCATED AS ACCURATELY AS POSSIBLE

PHYSICALLY LOCATED THE UNDERGROUND UTILITIES.
THIS SURVEY PERFORMED AND MAP PREPARED WITHOUT BENEFIT OF A TITLE REPORT. THIS SURVEY SUBJECT TO ANY FACTS AND EASEMENTS WHICH MAY BE DISCLOSED BY A FULL AND

FROM INFORMATION AVAILABLE. THE SURVEYOR HAS NOT

ACCURATE TITLE SEARCH. 10. ELEVATIONS FOR THIS SURVEY ARE BASED ON NAVD88.

- BENCHMARK

ELEV.: 303.35

POINT #100 (COTTON-SPINDLE)



MCADAMS

The John R. McAdams Company, Inc.

621 Hillsborough Street

Suite 500

Raleigh, NC 27603

phone 919. 361. 5000

fax 919. 361. 2269

license number: C-0293, C-187

www.mcadamsco.com

CITY OF RALEIGH TRANSPORTATION/TRANSIT DIVISION P.O. BOX 590 RALEIGH, NORTH CAROLINA 27602

CLIENT

R

4

~

0

REVISIONS

NO. DATE

SHEET

SD1-CB TOP=300.04' 24" RCP (NW)=293.67" 24" RCP (S)=293.43'

SD2-CB TOP=297.40' 24" RCP (E)=290.82' SD3-CB TOP=297.39'

24" RCP (W)=290.81' 24" RCP (N)=290.94' 24" RCP (E)=290.43' SD4-DI

TOP=289.13' 24" RCP (W)=285.66' 24" RCP (NE)=285.51" SD5-DMH

RIM = 289.59'24" RCP (SW)=285.56' 15" RCP (S)=285.60' 24" RCP (NE)=285.55 SD6-CB

15" RCP (S)=285.37' SD7-DI TOP=291.62' 15" RCP (N)=288.29'

TOP=289.37'

SD8-DI TOP=290.91' 15" RCP (S)=287.19' 18" RCP (NW)=287.17'

TOP=289.41' 15" RCP (N)=285.13' 18" RCP (SE)=285.55' 24" RCP (SW)=285.51 18" RCP (S)=284.81'

SD10-CB

TOP=290.11'

18" RCP (N)=284.03' 42" RCP (W)=283.96' 42" RCP (SE)=283.53' SD11-DMH RIM=290.59' 42" RCP (NW)=277.25' 18" RCP (SW)=277.09"

42" RCP (E)=276.99'

SD13-CB TOP=294.71' 15" RCP (SW)=290.57' 15" RCP (S)=290.79' 18" RCP (E)=290.55'

TOP=293.05' 18" RCP (W)=288.36' 18" RCP (NE)=288.33' SD15-DI

SD16-DMH RIM=293.35' 12" RCP (W)=288.90'

SD17-DMH RIM=299.36' 15" RCP (E)=296.24' SD18-CB

TOP=299.52' 15" RCP (W)=296.13' SD19-DMH TOP=298.99'

SS1-SMH RIM=297.75' 8" DIP (NW)=292.89'

SS2-SMH

RIM=309.70' 6" PVC (SE)=301.96' 8" DIP (N)=301.75' SS3-SMH

RIM=307.79' 8" DIP (SE)=292.05' 8" DIP (S)=292.75' 8" DIP (SW)=291.97'

SS4-SMH RIM=308.45' 8" DIP (NE)=291.25' 8" DIP (W)=291.23'

TOTAL AREA SURVEYED: 94,325 S.F. 2.17 AC.

SD12-DMH RIM=299.17' 15" RCP (N)=293.54'

SD14-CB

TOP=301.77' 12" RCP (E)=299.97'

12" RCP (E)=288.77'

15" RCP (NE)=294.59' 15" RCP (SW)=294.12' 15" RCP (NW)=294.01" 24" RCP (SE)=293.84'

THE CITY OF RALEIGH
TRACT D
WILDERS GROVE ASSOCIATES WILDERS GROVE, INC. D.B. 19136, PG. 169 B.M. 1996, PG. 185 P.I.N.: 1724-96-2367 LOT 1
WILDERS GROVE, INC. D.B. 10578, PG. 194 B.M. 1992, PG. 1298 1426 WILDERS GROVE LANE AREA: 25,544 S.F. P.I.N.: 1724-86-8905 N/F WILDERS GROVE, INC. 4121 NEW BERN AVENUE 0.59 AC. LOT 1 WILDERS GROVE, INC. D.B. 10578, PG. 194 B.M. 1992, PG. 1298 ③ **③**M ⋅ [™] @м / ØM SIDEWALK SIGN -+ 304.81 +296.31P.I.N.: 1724-86-8905 4121 NEW BERN AVENUE N 89"29'58" E 483.96' (TOTAL) 251.90' BILLBOARD SOUTH OF LINE 74.2' THE CITY OF RALEIGH + 305.52 SLOPE EASEMENT -LOT 2R
WILDERS GROVE ASSOCIATES + 294.52 +302.60D.B. 5826, PG. 57 — B.M. 1988, PG. 1589 +301.51D.B. 19136, PG. 169 B.M. 1996, PG. 185 P.I.N.: 1724-96-5306 PROJECT LOCALIZATION POINT AND BENCHMARK **ASPHALT** POINT #101 (CONTROL REBAR WITH CAP) PERMANENT DRAINAGE EASEMENT -1451 N. NEW HOPE ROAD N.C. STATE PLANE GRID COORDINATES: D.B. 5871, PG. 631 36,942 S.F. B.M. 1988, PG. 1589-NAD83 (2001) NAVD88 N:746,326.11 E:2,129,115.13' 42" FES 🥆 +293.48VARIABLE WIDTH STORMWATER EASEMENT | INVERT=284.99' ELEV .: 307.88' COMBINED SCALE FACTOR: 0.99990963 B.M. 2009, PG. 851 +303.5618" FES -17.12 INVERT FULL AT TIME OF SURVEY N 81'59'39" E (GRID) 2195.51' (GROUND) N.G.S. MONUMENT "TAYLORS" INVERT=287.86' N.C. GRID COORDINATES: NAD83 (2001) NAVD88 N:746,020.36 +305.61N 82'46'07" W 208.61' E:2,126,941.22' 9286.91' (GRID) 9287.75' (GROUND) N 82'46'21" W 94.88' ELEV .: 286.22' __ S 89°30'40" W 165.67' (TOTAL) +305.19SD19 D **ASPHALT** MONUMENT **ASPHALT** "NEUSE" - CONNECTIVITY 1-STORY GARAGE 35' PUBLIC ACCESS COULD NOT BE EASEMENT FFE=305.70' DETERMINED B.M. 2009, PG. 851

ASPHALT

+304.71

THE CITY OF RALEIGH

D.B. 19136, PG. 169 B.M. 1984, PG. 1442

P.I.N.: 1724-96-3213 1408 WILDERS GROVE LANE

31,839 S.F. 0.73 AC.

HEIGHT=

/ 17.44'

NORTH OF LINE

GLEN H. PARTIN

WILDERS GROVE ASSOCIATES

D.B. 9895, PG. 1403 B.M. 1984, PG. 1442

P.I.N.: 1724-96-2098

4301 NEW BERN AVENUE

LEGEND EXISTING NAIL BENCHMARK CONTROL REBAR WITH CAP CONCRETE MONUMENT EXISTING IRON PIPE (EIP)/REBAR (RB) IRON PIPE SET

THOMAS EDWARD BAILEY, ET.AL. TRACT 1

WILDERS GROVE ASSOCIATES

D.B. 18863, PG. 2627 B.M. 2009, PG. 851 P.I.N.: 1724-96-5110

4309 NEW BERN AVENUE

SLOPE EASEMENT

CALCULATED POINT NC GEODETIC SURVEY MON. FIRE HYDRANT WATER METER BACKFLOW PREVENTER WATER VALVE WATER WELL DRAINAGE INLET/YARD INLET

----- ss ----- SEWER LINE ----- STORM LINE \sim

CL CATCH BASIN AT BC BOUNDARY LINE ADJOINER LINE NOT SURVEYED ---- ADJOINER GIS LINE NOT SURVEYED OVERHEAD ELECTRIC LINE WOOD LINE/LANDSCAPING


STORM DRAIN MANHOLE BLIND JUNCTION BOX ELECTRIC METER ELECTRIC TRANSFORMER ELECTRIC PEDESTAL **GUY WIRE** LIGHT POLE POWER/UTILITY POLE CLEAN OUT SEWER MANHOLE IRRIGATION CONRTOL VALVE GAS SERVICE METER GAS VALVE GAS TEST STATION TELEPHONE MANHOLE TELEPHONE PEDESTAL FIBER OPTIC HANDHOLE **BOLLARD** AC AIR CONDITIONER SIGN -0 MAPLE


OAK

PLAN INFORMATION

PROJECT NO. RAL-22005 RAL22005-C1 FILENAME **CHECKED BY DRAWN BY SCALE** 1"=40' DATE 03. 24. 2023

BOUNDARY AND TOPOGRAPHIC SURVEY

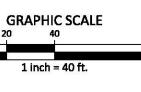

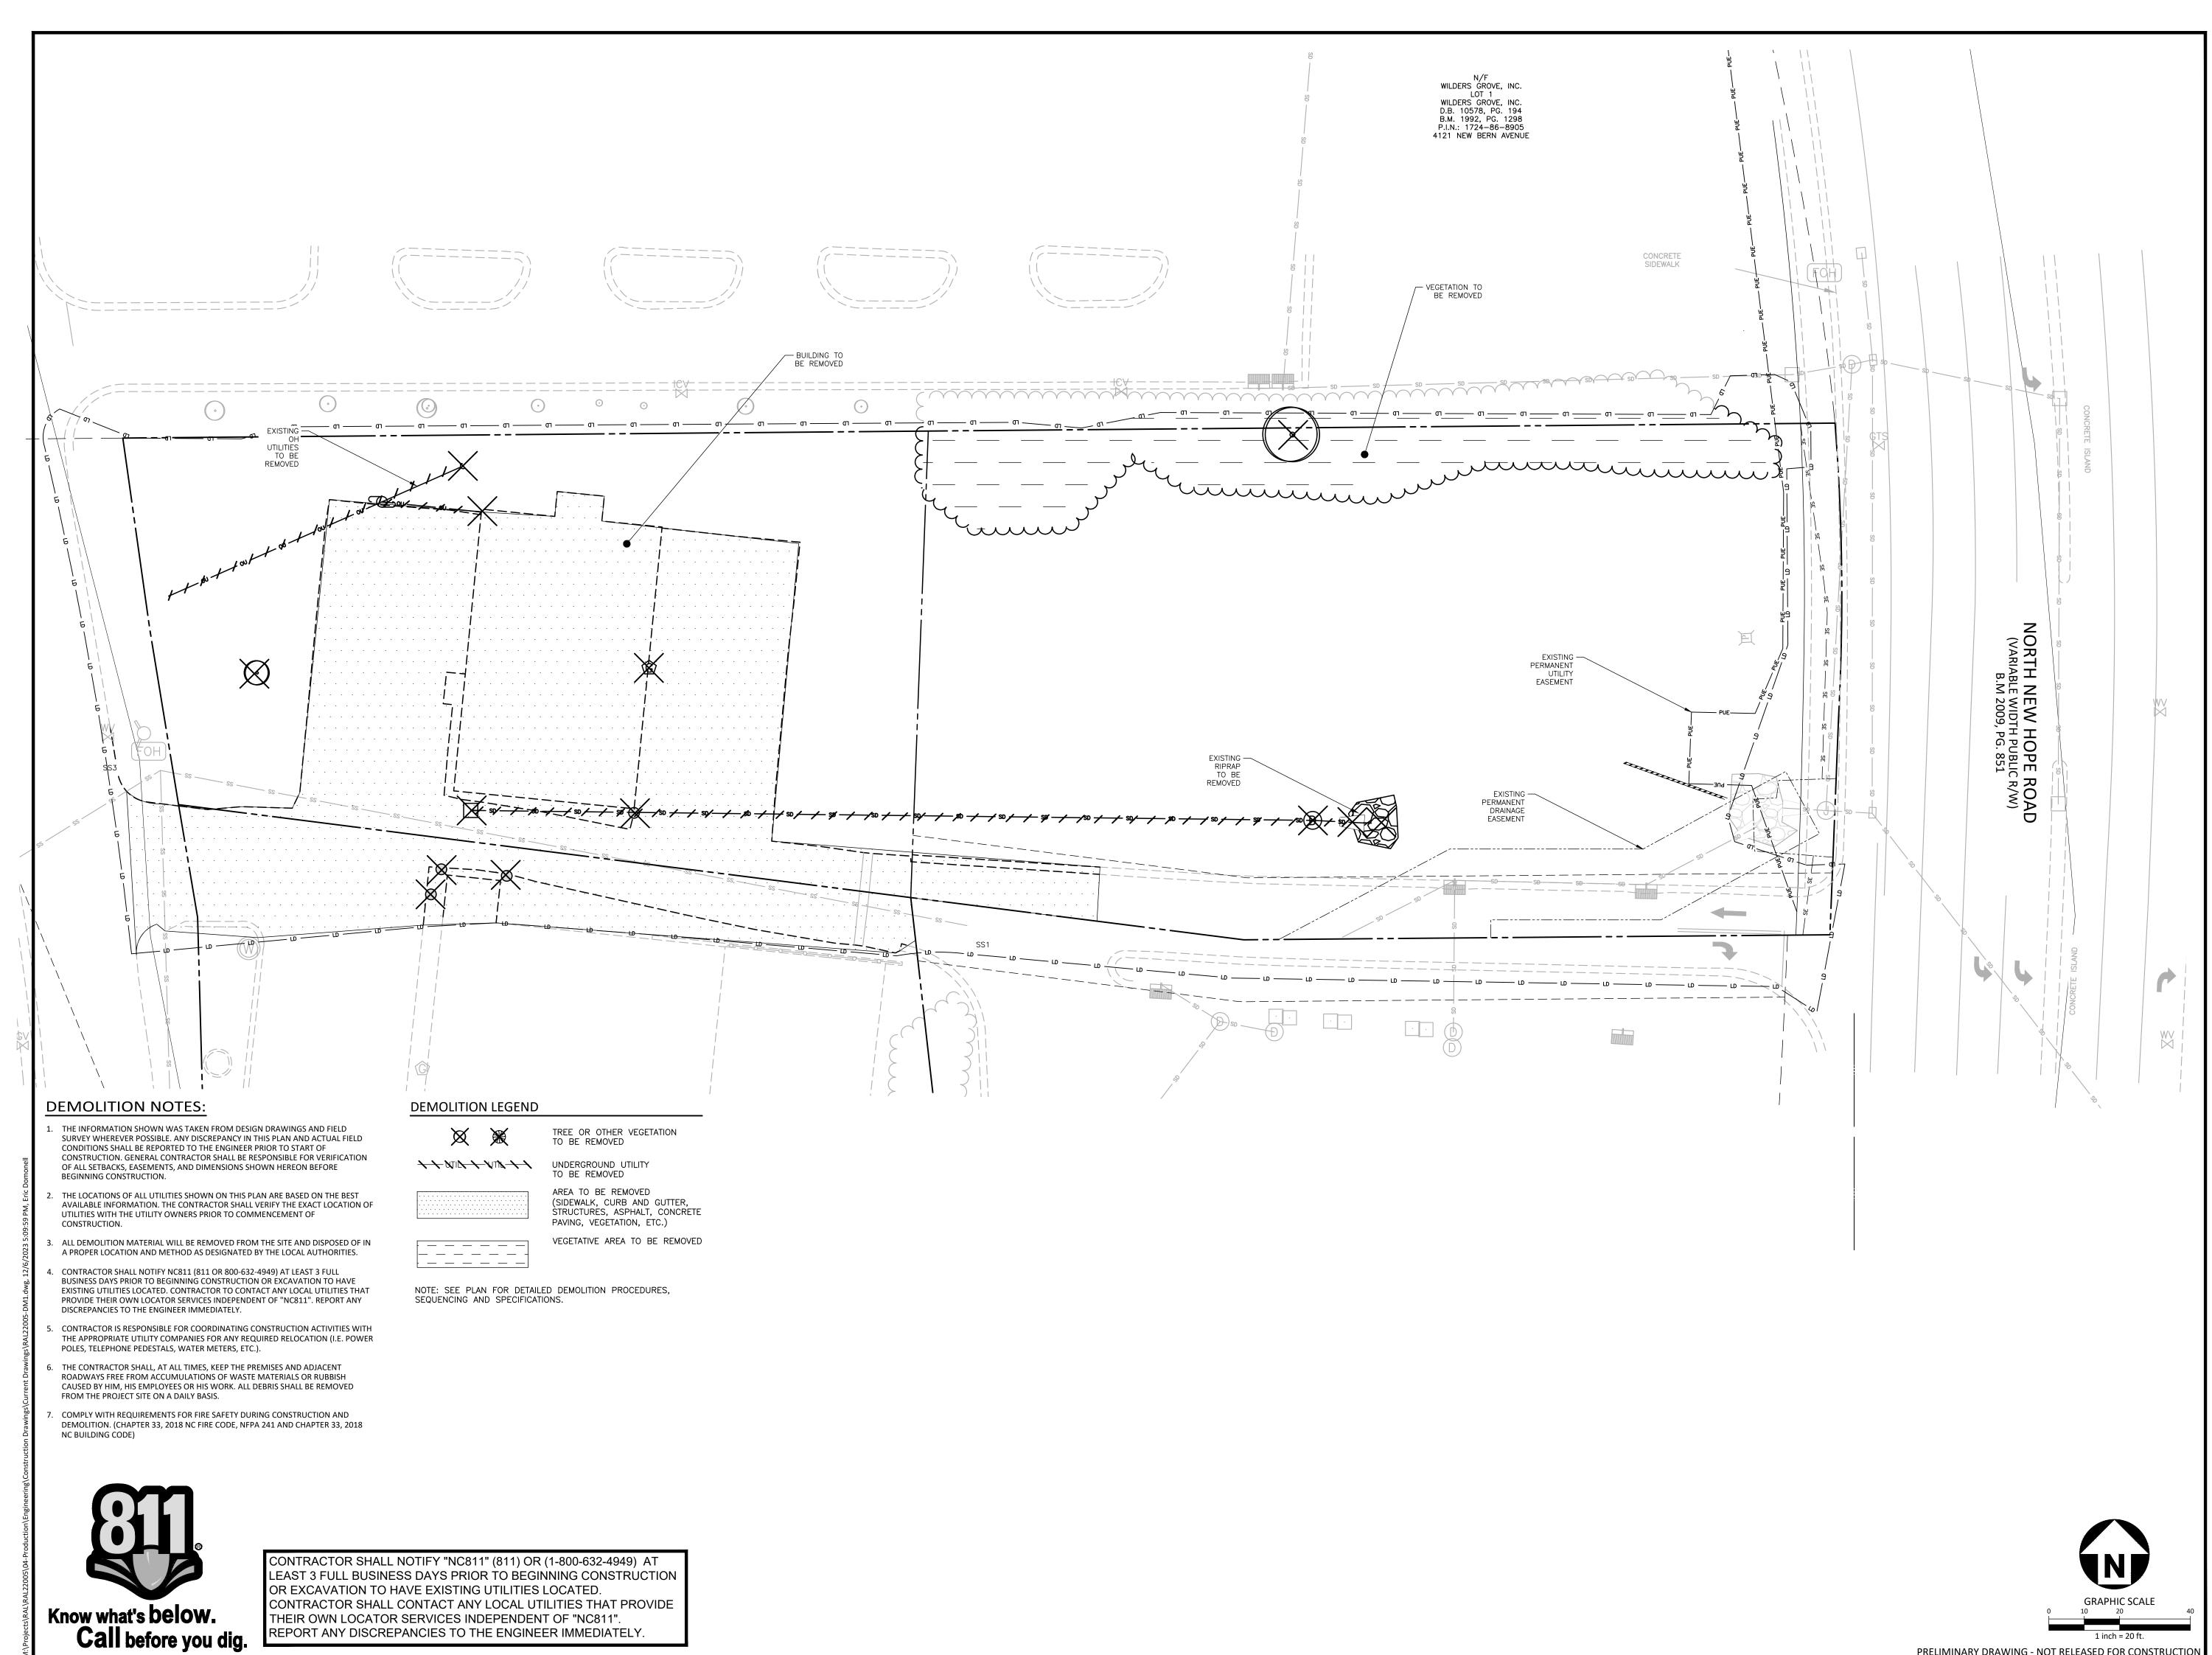

REPORT ANY DISCREPANCIES TO THE ENGINEER IMMEDIATELY.

The John R. McAdams Company, Inc. 2905 Meridian Parkway Durham, NC 27713

phone 919. 361. 5000 fax 919. 361. 2269 license number: C-0293, C-187

www.mcadamsco.com



NO. DATE


PLAN INFORMATION

PROJECT NO. RAL22005 RAL22005-DM1.DWG FILENAME CHECKED BY DRAWN BY

SCALE DATE 12.06.2023

PRELIMINARY DRAWING - NOT RELEASED FOR CONSTRUCTION

TITLE **DEMOLITION PLAN**

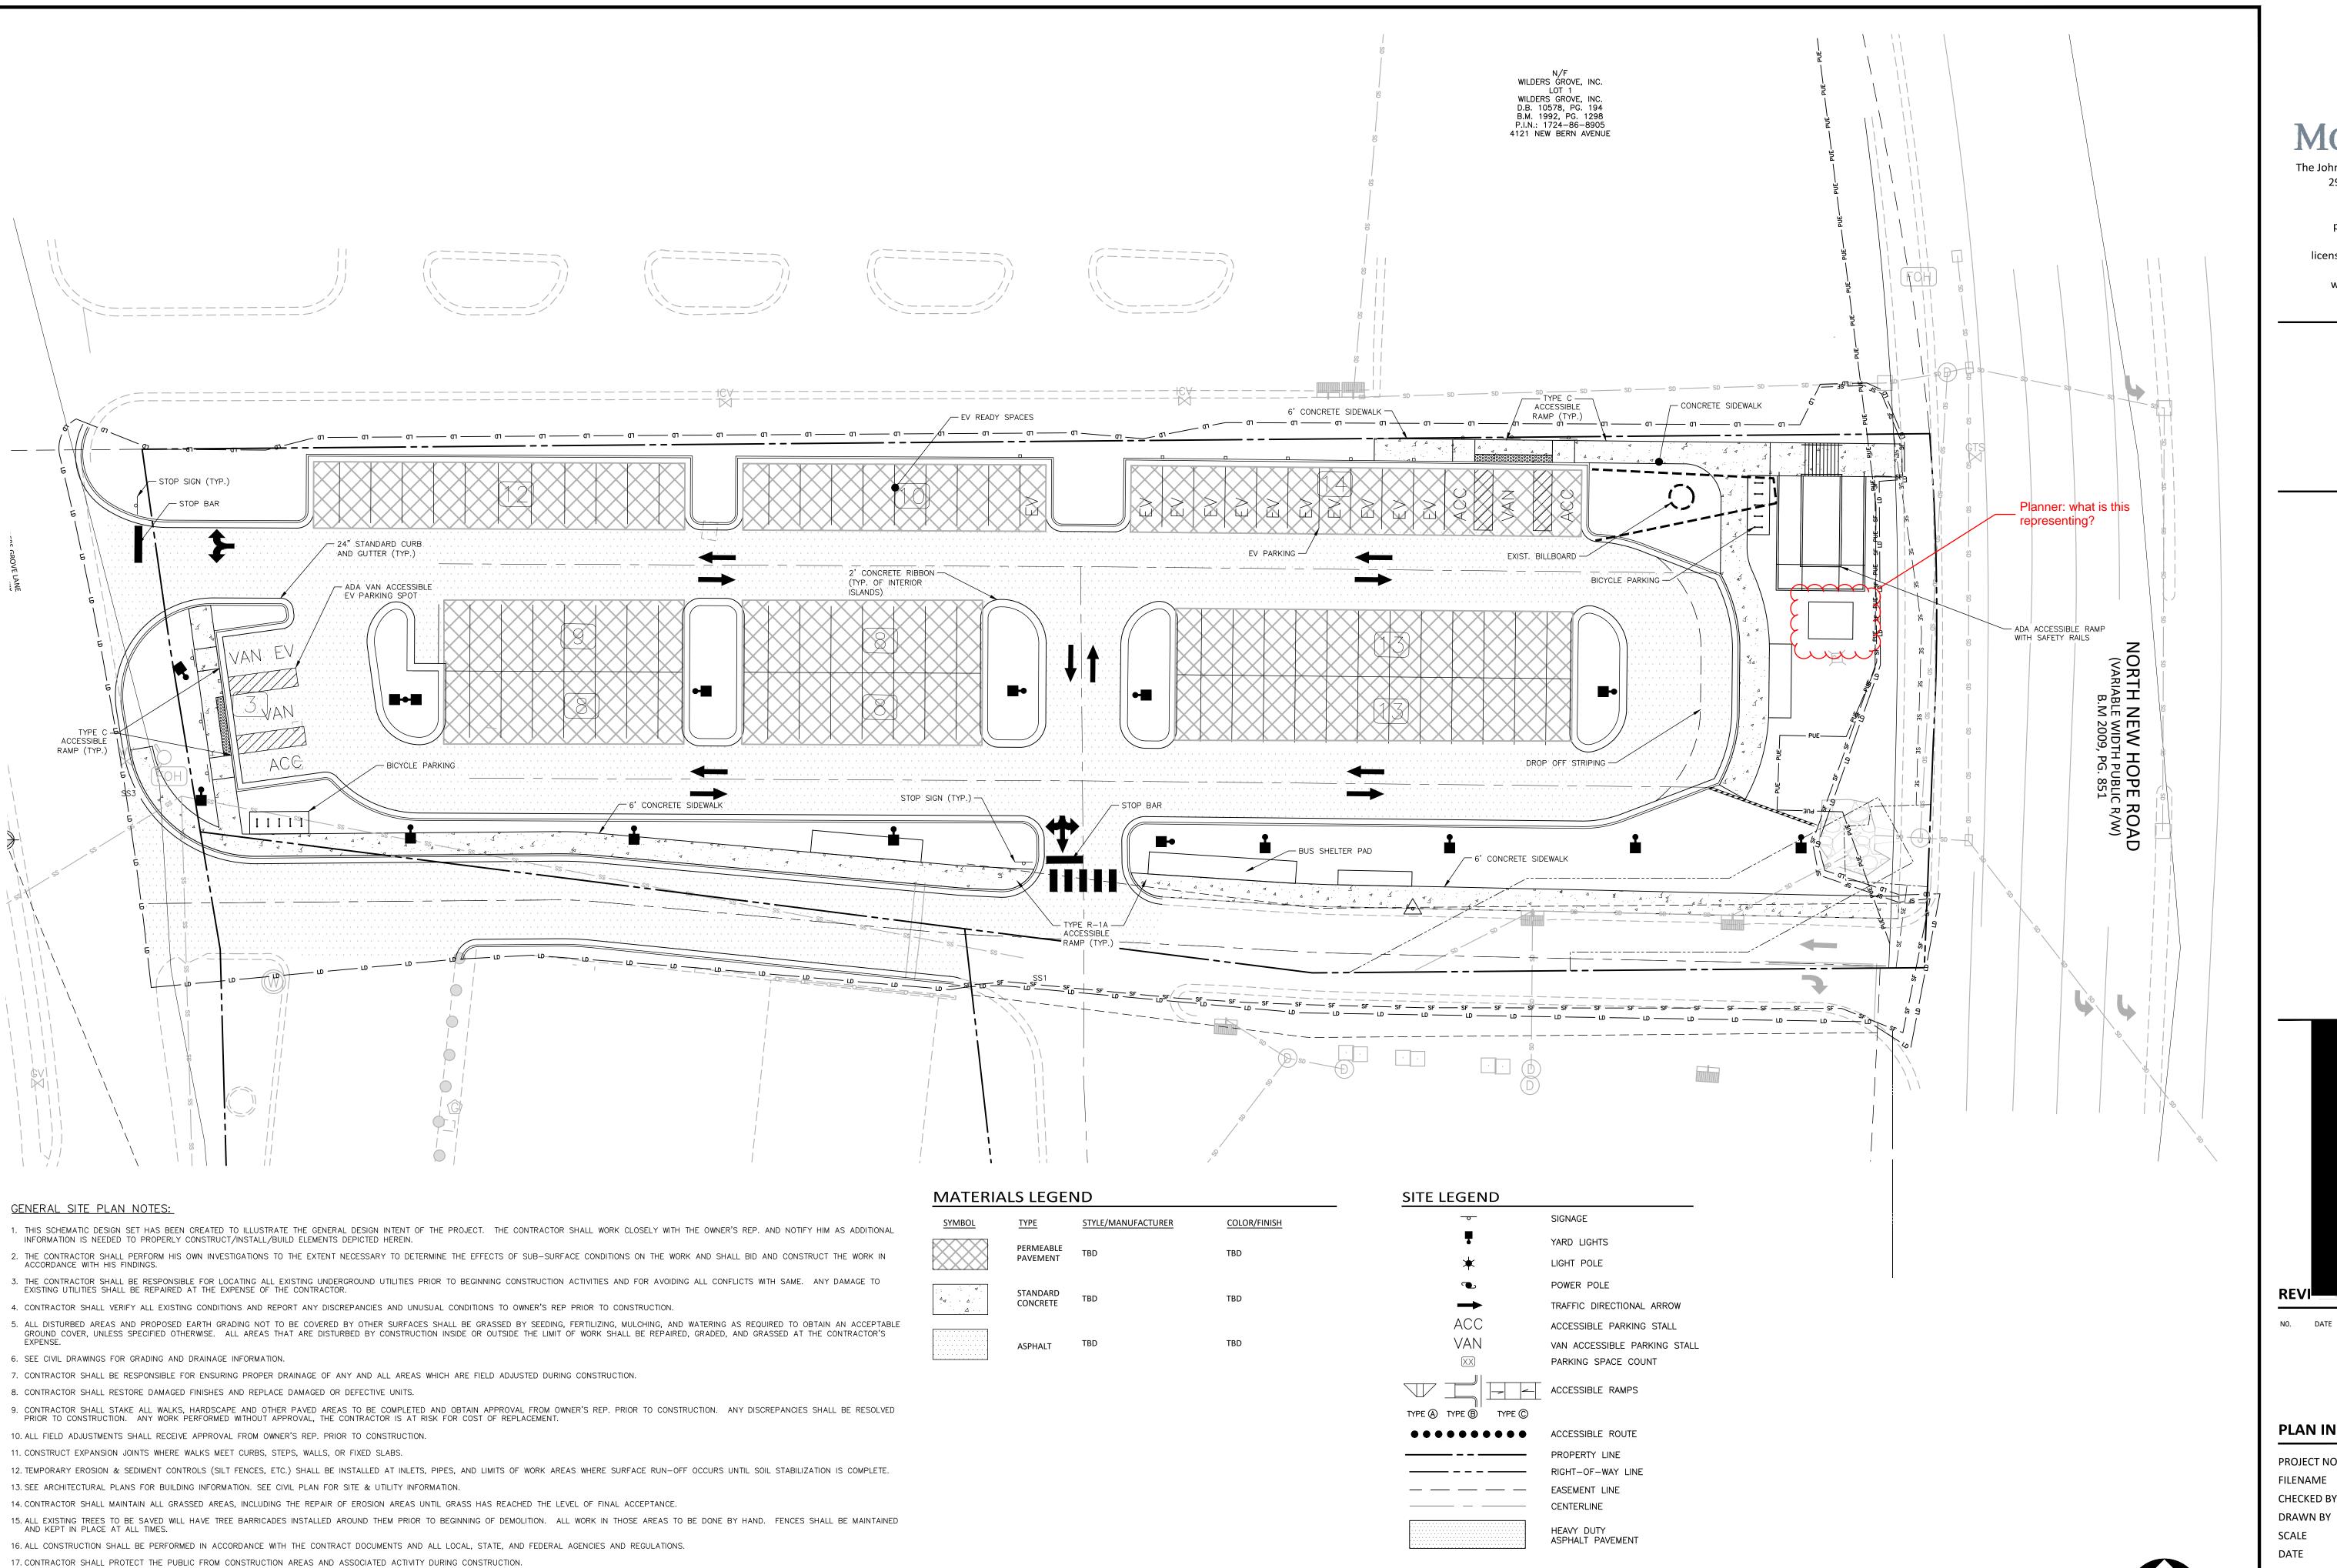

18. DIGITAL BASE FILE SHALL BE MADE AVAILABLE FOR USE IN FIELD LOCATION OF ELEMENTS AND SITE FEATURES. ANY HARDCOPY INFORMATION THAT CONFLICTS WITH THE DIGITAL FILE SHALL BE BROUGHT TO THE

OWNER'S REPRESENTATIVE AND/OR LANDSCAPE ARCHITECT'S ATTENTION

19. CONTRACTOR SHALL COORDINATE CONDUIT LOCATIONS (I.E. IRRIGATION, ETC.). 20.NO SPECIMEN TREES FOUND ON SITE. NO SPECIMEN TREES TO BE REMOVED.



The John R. McAdams Company, Inc. 2905 Meridian Parkway Durham, NC 27713

license number: C-0293, C-187

phone 919. 361. 5000 fax 919. 361. 2269

www.mcadamsco.com



PLAN INFORMATION


PROJECT NO. RAL22005 FILENAME RAL22005-S1.DWG CHECKED BY DRAWN BY

SCALE 12.06.2023

TITLE

PRELIMINARY DRAWING - NOT RELEASED FOR CONSTRUCTION

SITE PLAN

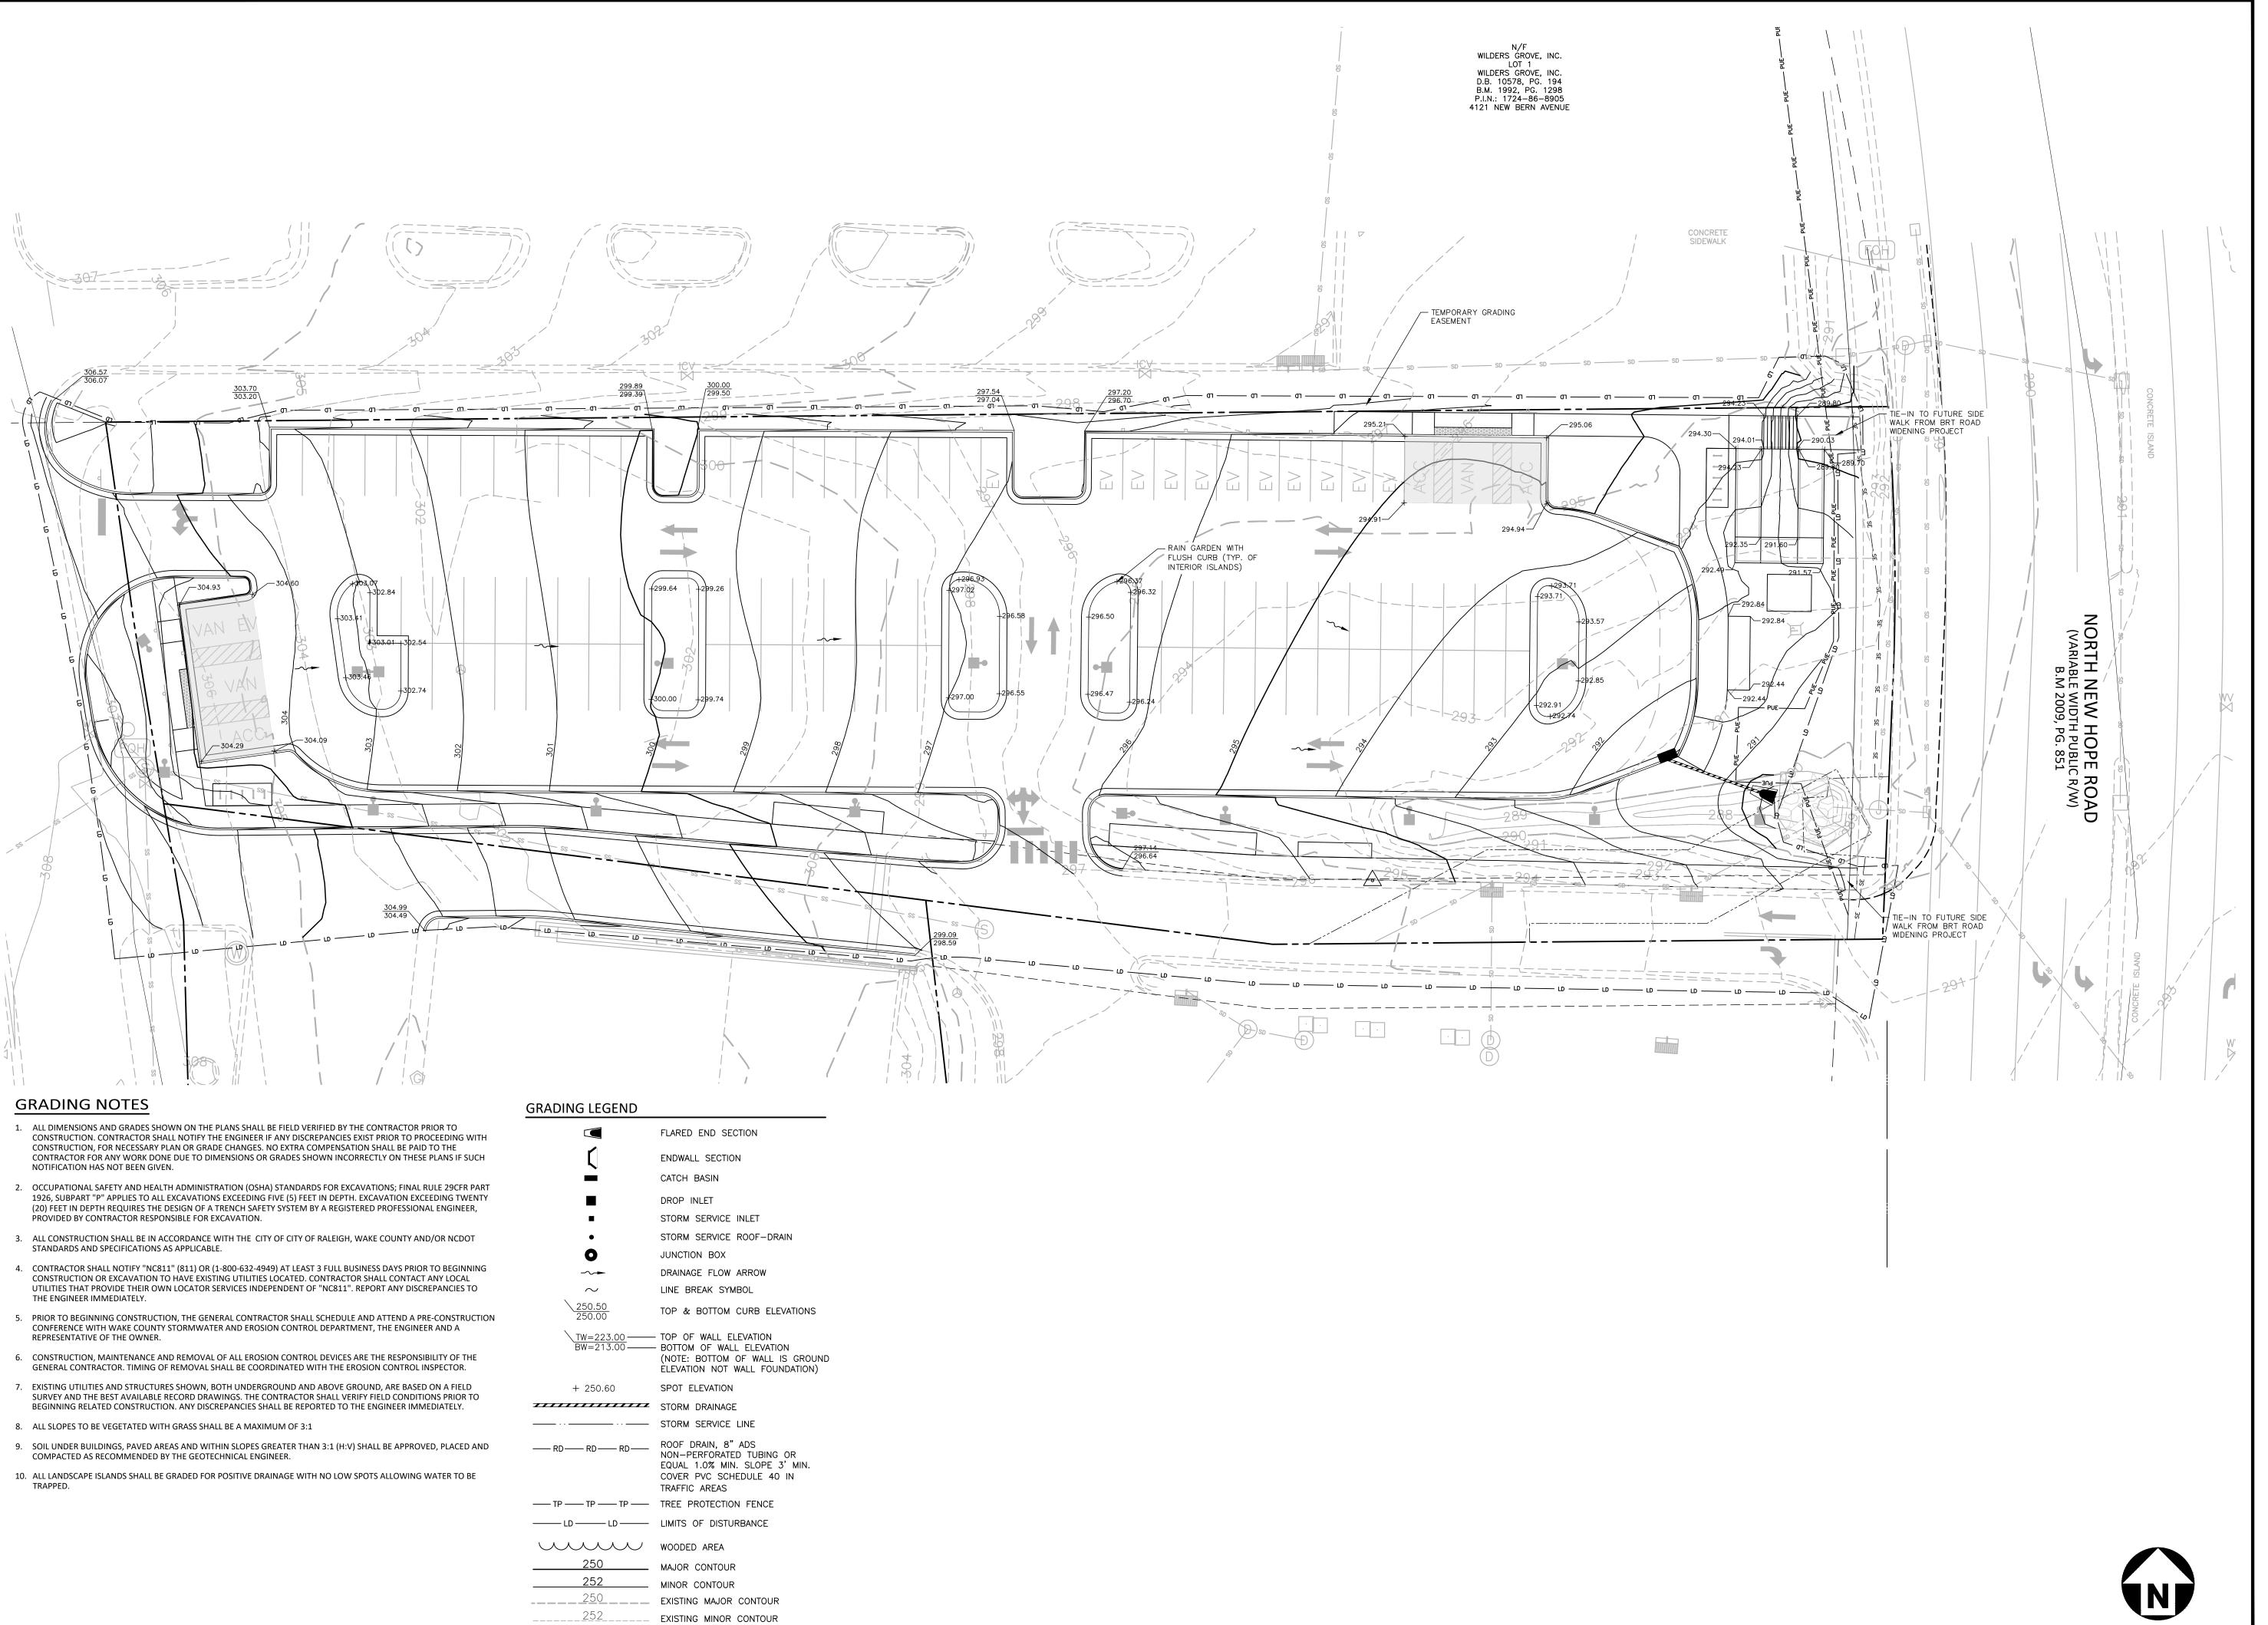

— — EASEMENT LINE

ACCESSIBLE PARKING AREA

(2% MAX. SLOPE IN ALL DIRECTIONS)



The John R. McAdams Company, Inc. 2905 Meridian Parkway Durham, NC 27713

phone 919. 361. 5000

fax 919. 361. 2269 license number: C-0293, C-187

www.mcadamsco.com



PLAN INFORMATION

PROJECT NO. RAL22005 FILENAME RAL22005-G1.DWG CHECKED BY

DRAWN BY SCALE 1"=20' DATE 12.06.2023

TITLE

PRELIMINARY DRAWING - NOT RELEASED FOR CONSTRUCTION

GRADING AND DRAINAGE PLAN

CONSTRUCTION SEQUENCE - STAGE 1

- 1. REQUEST PRE-CONSTRUCTION MEETING WITH DEMLR RALEIGH REGIONAL OFFICE AT LEAST 72 HOURS PRIOR TO COMMENCING THE PROJECT. CONTACT THE OFFICE AT LEAST 48 HOURS PRIOR TO COMMENCING THE LAND-DISTURBING ACTIVITY.
- 2. EROSION AND SEDIMENT CONTROL (E&SC) PERMIT AND A CERTIFICATE OF COVERAGE (COC) MUST BE OBTAINED BEFORE ANY LAND DISTURBING ACTIVITIES (INCLUDING TIMBERING AND DEMOLITION) OCCUR. A COPY OF THE E&SC PERMIT, THE COC, AND A HARD COPY OF THE PLANS MUST BE KEPT ON SITE, PREFERABLY IN A PERMITS BOX, AND ACCESSIBLE DURING INSPECTION.
- 3. INSTALL TREE PROTECTION FENCE AT FINAL LOCATIONS SHOWN. CALL NCDEQ TO INSPECT TREE PROTECTION FENCE. TREE PROTECTION FENCING MUST BE INSTALLED AND INSPECTED BY NCDEQ SITE INSPECTOR PRIOR TO A
- 4. ATTEND PRE-CONSTRUCTION MEETING WITH NCDEQ EROSION CONTROL INSPECTOR.
- 5. OBTAIN GRADING PERMIT.
- 6. INSTALL CONSTRUCTION ENTRANCE, SILT FENCE WITH OUTLETS, AND TEMPORARY STREAM CROSSING AS SHOWN ON THIS EROSION CONTROL PLAN STAGE 1. CONTRACTOR SHALL CLEAR ONLY AS NECESSARY FOR CONSTRUCTION EQUIPMENT TO ACCESS AND INSTALL THE TEMPORARY EROSION CONTROL DEVICES. INSTALL THE REQUIRED LINER FOR ALL DIVERSION DITCHES WHEN INSTALLING THE DITCHES. NO CLEARING SHALL OCCUR OUTSIDE OF THE LIMITS OF CONSTRUCTION SHOWN UNLESS PRIOR APPROVAL IS OBTAINED FROM NCDEQ EROSION CONTROL INSPECTOR. ENSURE EXISTING SEDIMENT BASIN IS FUNCTIONING PROPERLY. IF SEDIMENT BASIN WAS CONVERTED TO AN SCM, REINSTALL THE SKIMMER AND BAFFLES AS SHOWN UNDER THE PHASE 1C INFRASTRUCTURE PLANS (22-DP-1332).
- 7. INSTALL ALL REMAINING PERIMETER EROSION CONTROL MEASURES AS SHOWN TO PREVENT EROSION AND SEDIMENTATION FROM OCCURRING WHEN GENERAL GRADING COMMENCES.
- 8. OBTAIN CERTIFICATE OF COMPLIANCE THROUGH ON-SITE INSPECTION BY NCDEQ EROSION CONTROL INSPECTOR.
- 9. PROCEED WITH CLEARING OF SITE.
- 10. ALL EROSION AND SEDIMENTATION CONTROL PRACTICES SHALL BE CHECKED BY CONTRACTOR FOR STABILITY AND OPERATION FOLLOWING EVERY RUNOFF-PRODUCING RAINFALL BUT IN NO CASE LESS THAN ONCE EVERY WEEK. ANY NEEDED REPAIRS SHALL BE MADE IMMEDIATELY TO MAINTAIN ALL PRACTICES AS DESIGNED
- 11. CLEAN SEDIMENT BASINS WHEN ONE-HALF FULL
- 12. ALL AREAS AND SLOPES DISTURBED DURING CONSTRUCTION AND EXPOSED SHALL BE STABILIZED WITH TEMPORARY SEEDING AND MULCHING WITHIN 14 CALENDAR DAYS, FOLLOWING COMPLETION OF ANY PHASE OF GRADING OR PERIOD OF INACTIVITY. PERMANENT GROUNDCOVER IS TO BE ESTABLISHED FOR ALL DISTURBED. AREAS WITHIN 14 WORKING DAYS OR 90 CALENDAR DAYS, WHICHEVER IS SHORTER, FOLLOWING COMPLETION OF CONSTRUCTION, COMPLETION OF GRADING OR PERIOD OF INACTIVITY. PERMANENT SEEDING, MULCHING AND GROUND COVER SHALL BE APPLIED TO THE SITE FOLLOWING COMPLETION OF CONSTRUCTION, HIGH QUALITY WATER (HWQ) ZONES AND PERIMETER DIKES, SWALES, DITCHES, AND SLOPES SHALL BE STABILIZED WITH TEMPORARY SEEDING AND MULCHING WITHIN 7 CALENDAR DAYS.
- 13. MAINTAIN SOIL EROSION CONTROL MEASURES UNTIL PERMANENT GROUND COVER IS ESTABLISHED.
- 14. WITH APPROVAL FROM NCDEQ EROSION CONTROL INSPECTOR MOVE TO EROSION CONTROL PLAN STAGE 2.

CONSTRUCTION SEQUENCE - STAGE 2

- 1. PROCEED WITH GRADING/BUILDING CONSTRUCTION.
- 2. INSTALL STORM DRAINAGE SYSTEM AND DIVERT FLOW TO INLETS WITH EXCAVATED INLET PROTECTION. INSTALL RETAINING WALLS AS NECESSARY WHILE MAINTAINING EROSION CONTROL MEASURES.
- 3. DRAIN AND REDUCE THE SEDIMENT BASIN UTILIZING THE SEDIMENT FILTER BAG WHICH WILL BE CONTINUOUSLY MONITORED DURING OPERATION. IN COORDINATION WITH NCDEQ EROSION CONTROL INSPECTOR
- 4. CLEAN SEDIMENT BASIN WHEN ONE-HALF FULL
- 5. ALL EROSION AND SEDIMENTATION CONTROL PRACTICES SHALL BE CHECKED BY CONTRACTOR FOR STABILITY AND OPERATION FOLLOWING EVERY RUNOFF-PRODUCING RAINFALL BUT IN NO CASE LESS THAN ONCE EVERY WEEK. ANY NEEDED REPAIRS SHALL BE MADE IMMEDIATELY TO MAINTAIN ALL PRACTICES AS DESIGNED.
- 6. ALL AREAS AND SLOPES DISTURBED DURING CONSTRUCTION AND EXPOSED SHALL BE STABILIZED WITH TEMPORARY SEEDING AND MULCHING WITHIN 14 CALENDAR DAYS, FOLLOWING COMPLETION OF ANY PHASE OF GRADING OR PERIOD OF INACTIVITY. PERMANENT GROUNDCOVER IS TO BE ESTABLISHED FOR ALL DISTURBED AREAS WITHIN 14 WORKING DAYS OR 90CALENDAR DAYS, WHICHEVER IS SHORTER, FOLLOWING COMPLETION OF CONSTRUCTION, COMPLETION OF GRADING OR PERIOD OF INACTIVITY. PERMANENT SEEDING, MULCHING AND GROUND COVER SHALL BE APPLIED TO THE SITE FOLLOWING COMPLETION OF CONSTRUCTION. HIGH QUALITY WATER (HWQ) ZONES AND PERIMETER DIKES, SWALES, DITCHES, AND SLOPES SHALL BE STABILIZED WITH TEMPORARY SEEDING AND MULCHING WITHIN 7 CALENDAR DAYS..

CONTRACTOR'S MAINTENANCE PLAN:

- 1. ALL EROSION AND SEDIMENT CONTROL MEASURES SHALL BE CHECKED FOR STABILITY AND OPERATION FOLLOWING EVERY RUNOFF-PRODUCING RAINFALL BUT IN NO CASE LESS THAN ONCE EVERY WEEK. ANY NEEDED REPAIRS SHALL BE MADE IMMEDIATELY TO MAINTAIN ALL MEASURES AS DESIGNED.
- 2. SEDIMENT BASINS SHALL BE INSPECTED REGULARLY DURING LAND DISTURBING ACTIVITIES AND AFTER EACH RUNOFF-PRODUCING RAINFALL. SEDIMENT SHALL BE REMOVED AND THE BASIN RESTORED TO ITS ORIGINAL DIMENSIONS WHEN SEDIMENT HAS ACCUMULATED TO ONE-HALF THE DESIGN DEPTH OF EACH BASIN. PORTIONS OF THE BASIN'S GRAVEL FACING THAT ARE CONTAMINATED BY SEDIMENT SHALL BE REPLACED WITH FRESH GRAVEL DURING EACH SEDIMENT REMOVAL EPISODE.
- 3. SEDIMENT FENCES SHALL BE INSPECTED AT LEAST ONCE A WEEK AND AFTER EACH RUNOFF PRODUCING RAINFALL. REPAIRS SHALL BE MADE IMMEDIATELY. SEDIMENT DEPOSITS SHALL BE REMOVED AS NEEDED TO PROVIDE ADEQUATE STORAGE VOLUME FOR THE NEXT RAINFALL EVENT. AND TO REDUCE PRESSURE ON THE FENCE. FENCING MATERIALS AND SEDIMENT DEPOSITS SHALL BE REMOVED, AND THE AREA BROUGHT TO GRADE FOLLOWING STABILIZATION OF UPGRADIENT DISTURBED AREAS.
- 4. DIVERSION DITCHES MUST REMAIN IN PLACE UNTIL PROJECT IS STABILIZED.
- 5. EROSION CONTROL DURING SITE CONSTRUCTION WILL BE ACCOMPLISHED BY USE OF SILT FENCING AND SILT FENCE OUTLETS. DEVICES MUST BE EMPTIED WHEN SEDIMENT ACCUMULATION HAS REACHED 6" DEPTH.

EROSION CONTROL NOTES:

- 1. EROSION AND SEDIMENT CONTROL DEVICES MUST BE INSTALLED AND INSPECTED PRIOR TO ANY GRADING ON SITE. THE CONTRACTOR SHALL CALL FOR A INSPECTION BY NCDEQ SEDIMENTATION AND EROSION CONTROL (SEC) ONCE INITIAL MEASURES ARE IN PLACE.
- 2. REQUIRED TREE PROTECTION FENCING SHALL BE INSTALLED AND INSPECTED AND A PRE-CONSTRUCTION CONFERENCE SCHEDULED WITH THE TOWN'S URBAN FORESTER PRIOR TO BEGINNING LAND DISTURBANCE.
- 3. GRADING PERMIT WILL NOT BE ISSUED UNTIL NCDEQ HAS RECEIVED NOTIFICATION FROM THE ECOSYSTEM ENHANCEMENT PROGRAM OR AN APPROVED NUTRIENT OFFSET BANK THAT A RECEIPT HAS BEEN ISSUED TO THE DEVELOPER AND THE LOCAL GOVERNMENT STATING THE NITROGEN BUY DOWN HAS BEEN COMPLETED.
- 4. SEDIMENT/EROSION CONTROL DEVICES MUST BE CHECKED AFTER EACH STORM EVENT. EACH DEVICE IS TO BE MAINTAINED OR REPLACED IF SEDIMENT ACCUMULATION HAS REACHED ONE HALF THE CAPACITY OF THE
- 5. IN ADDITION TO THE REQUIREMENT DURING CONSTRUCTION FOR THE INSPECTION OF EROSION CONTROL DEVICES AFTER EVERY RAINFALL, THE CONTRACTOR SHALL INSPECT THE EROSION AND SEDIMENT CONTROL DEVICES AND OFFSITE ROADWAYS DAILY, MAKE ANY NECESSARY REPAIRS OR ADJUSTMENTS TO THE DEVICES, REMOVE DEPOSITION OF WET OR DRY SILT ON ADJACENT ROADWAYS AND MAINTAIN INSPECTION LOGS DOCUMENTING THE DAILY INSPECTIONS AND ANY NECESSARY REPAIRS.
- 6. A COPY OF THE APPROVED EROSION CONTROL PLAN MUST BE ON FILE AT THE JOB SITE AT ALL TIMES.
- 7. CONSTRUCTION, MAINTENANCE, AND REMOVAL OF ALL EROSION CONTROL DEVICES ARE THE RESPONSIBILITY OF THE GRADING CONTRACTOR UNLESS OTHERWISE NOTED.
- 8. ANY GRADING BEYOND THE DENUDED LIMITS SHOWN ON THE PLAN IS A VIOLATION OF THE COUNTY EROSION CONTROL ORDINANCE AND IS SUBJECT TO A FINE.
- 9. NO DEBRIS SHALL BE TRACKED ONTO ANY EXISTING PAVED AREAS OR PUBLIC RIGHT OF WAY. IF THE SITUATION OCCURS WHERE MUD, ROCK AND DEBRIS IS TRACKED ONTO PAVEMENT, THE CONTRACTOR SHALL CLEAN THE PAVEMENT AND INSTALL ADDITIONAL MEASURES TO PREVENT THE FUTURE OCCURRENCE.
- 10. DURING THE CONSTRUCTION PHASE, ADDITIONAL EROSION AND SEDIMENT CONTROLS MAY BE REQUIRED IF THE PROPOSED MEASURES DO NOT CONTAIN THE SEDIMENT ON SITE. THE EROSION CONTROL INSPECTOR MAY REQUIRE ADDITIONAL FIELD MEASURES AS NECESSARY TO PROVIDE ADEQUATE PROTECTION FROM RECEIVING WATER COURSES.
- 11. PROTECTION OF EXISTING VEGETATION: AT THE START OF GRADING INVOLVING THE STRIPPING OF TOPSOIL OR LOWERING OF EXISTING GRADE AROUND A TREE, A CLEAN, SHARP, VERTICAL CUT SHALL BE MADE AT THE EDGE OF THE TREE SAVE AREA AT THE SAME TIME AS OTHER FROSION CONTROL MEASURES ARE INSTALLED. THE TREE PROTECTION FENCING SHALL BE INSTALLED ON THE SIDE OF THE CUT FARTHEST AWAY FROM THE TREE TRUNK AND SHALL REMAIN IN PLACE UNTIL ALL CONSTRUCTION IN THE VICINITY OF THE TREES IS COMPLETE. NO STORAGE OF MATERIALS, FILL, OR EQUIPMENT AND NO TRESPASSING SHALL BE ALLOWED WITHIN THE BOUNDARY OF THE PROTECTED AREA AND SHALL BE POSTED ON THE PROTECTION FENCE. A PROTECTION FENCE CONSTRUCTED OF MATERIAL RESISTANT TO DEGRADATION BY SUN, WIND, AND MOISTURE FOR THI DURATION OF THE CONSTRUCTION, SHALL BE INSTALLED AT THE SAME TIME AS THE EROSION CONTROL MEASURES AND SHALL BE IN PLACE UNTIL ALL CONSTRUCTION IN THE VICINITY OF THE TREES IS COMPLETE
- 12. A CONSTRUCTION SEQUENCE HAS BEEN PROVIDED, INSTALLATION OF ALL PROPOSED SEDIMENTATION & EROSION CONTROL MEASURES IN THE SEQUENCE(S) PROVIDED AND MAINTENANCE OF THOSE DEVICES IS REQUIRED. THE CONTRACTOR MAY BE ALLOWED, WITH PRIOR APPROVAL FROM THE OWNER, TO COORDINATE CHANGES TO THE PLAN WITH THE ON-SITE SEDIMENTATION & EROSION CONTROL INSPECTOR AND THE
- 13. CUT AND FILL SLOPE THAT IS TWO TO ONE (2:1) OR GREATER SHALL BE STABILIZED WITH PERMANENT SLOPE RETENTION DEVICES OR A SUITABLE COMBINATION OF PLANTINGS AND RETENTION DEVICES. SLOPES GREATER THAN THREE TO ONE (3:1) SHALL NOT BE STABILIZED WITH TURF GRASS BUT MUST BE STABILIZED WITH VEGETATION THAT REQUIRES MINIMAL MAINTENANCE. WEEPING LOVE GRASS, RED FESCUE OR OTHER APPROVED VARIETY. (CHAPTER 7, PART 2, SECTION 4, (G) LDO).
- 14. PROVIDE INLET PROTECTION AROUND ALL SITE STORM INLETS. PROTECT OPEN PIPES UNDER CONSTRUCTION WITH EITHER PLYWOOD OR WITH MESH AND GRAVEL WEIRS. RUNOFF SHALL NOT BE ALLOWED IN ANY OPEN
- 15. CONTRACTOR TO VERIFY SILT FENCE OUTLET PLACEMENT AT LOW POINTS AS THEY EXIST OR DEVELOP. ADDITIONAL SILT FENCE OUTLETS MAY BE REQUIRED TO PREVENT EROSION DURING AND AFTER CONSTRUCTION AND LAND DISTURBANCE ACTIVITIES. IF ADDITIONAL SILT FENCE OUTLETS ARE NECESSARY CONTRACTOR TO ADD ADDITIONAL SILT FENCE OUTLETS PER ENGINEER, NCDEQ EROSION CONTROL INSPECTOR, OR OWNER DIRECTION. IF PONDING OF WATER OR SEDIMENT OCCURS ALONG SILT FENCE, CONTRACTOR SHALL INSTALL AN ADDITIONAL SILT FENCE OUTLET.
- 16. TEMPORARY DIVERSIONS SHALL BE MAINTAINED DAILY BY CONTRACTOR SO THAT THEY ARE FUNCTIONAL AT THE END OF EACH WORKDAY AND WHEN STOPPING WORK FOR RAIN
- 17. THE TREE PROTECTION FENCE SHALL BE MAINTAINED ON THE SITE UNTIL ALL SITE WORK IS COMPLETED AND THE FINAL SITE INSPECTION IS SCHEDULED PRIOR TO THE ISSUANCE OF A CERTIFICATE OF OCCUPANCY (CO). THE FENCING SHALL BE REMOVED IMMEDIATELY PRIOR TO THE FINAL SITE INSPECTION FOR THE SITE.
- 18. TREE PROTECTION FENCING SHALL NOT BE MOVED AND THERE SHALL BE NO ENCROACHMENT INTO SUCH PROTECTED AREA(S) WITHOUT WRITTEN AUTHORIZATION OF THE TOWN'S ZONING COMPLIANCE STAFF. ANY ACTIVITY (LANDSCAPING FENCING, OR UTILITY INSTALLATION) SHOWN ON THE APPROVED PLANS IN A TREE PROTECTION AREA SHALL ALSO NOT OCCUR WITHOUT WRITTEN AUTHORIZATION FROM THE TOWN'S ZONING COMPLIANCE STAFF, ANY UNAUTHORIZED ENCROACHMENT OR DISTURBANCE WITHIN THE BOUNDARIES OF A REE PROTECTION AREA SHALL AUTOMATICALLY RESULT IN FINES AND THE REPLACEMENT OF ANY DAMAGED VEGETATION IN ACCORDANCE WITH THE LAND DEVELOPMENT ORDINANCE.
- 19. CONSTRUCTION ENTRANCES MUST BE MODIFIED TO ACHIEVE ADA COMPLIANCE WHERE APPLICABLE.
- 20. THE STREETS IN FRONT OF THE PROJECT AREA WILL BE KEPT CLEAN AT ALL TIMES OR A WASH STATION WILL BE
- 21. THE PROJECT MAY REQUIRE A PRE-CONSTRUCTION CONFERENCE BEFORE THE GRADING PERMIT IS ISSUED. 22. THE SKIMMER AND SEDIMENT BASIN OUTLET PIPE MUST BE ON SITE BEFORE THE GRADING PERMIT IS ISSUED.
- 23. THE TREE PROTECTION FENCE SHALL BE MAINTAINED ON THE SITE UNTIL ALL SITE WORK IS COMPLETED AND THE FINAL SITE INSPECTION IS SCHEDULED PRIOR TO THE ISSUANCE OF A CERTIFICATE OF OCCUPANCY (CO). THE FENCING SHALL BE REMOVED IMMEDIATELY PRIOR TO THE FINAL SITE INSPECTION FOR THE SITE.
- 24. TREE PROTECTION FENCING SHALL NOT BE MOVED AND THERE SHALL BE NO ENCROACHMENT INTO SUCH PROTECTED AREA(S) WITHOUT WRITTEN AUTHORIZATION OF THE TOWN'S ZONING COMPLIANCE STAFF. ANY ACTIVITY (LANDSCAPING, FENCING, OR LITHLITY INSTALLATION) SHOWN ON THE APPROVED PLANS IN A TREE PROTECTION AREA. SHALL ALSO NOT OCCUR WITHOUT WRITTEN AUTHORIZATION FROM THE TOWN'S ZONING COMPLIANCE STAFF. ANY UNAUTHORIZED ENCROACHMENT OR DISTURBANCE WITHIN THE BOUNDARIES OF A TREE PROTECTION AREA SHALL AUTOMATICALLY RESULT IN FINES AND THE REPLACEMENT OF ANY DAMAGED VEGETATION IN ACCORDANCE WITH THE LAND DEVELOPMENT ORDINANCE.

TEMPORARY SEEDING SCHEDULE

SEEDING DATE	SEEDING MIXTURE	APPLICATION RATE
JAN 1 - MAY 1	RYE (GRAIN)	120 LBS/AC
	KOBE LESPEDEZA	50 LBS/AC
MAY 1 - AUG 15	GERMAN MILLET	40 LBS/AC
AUG 15 - DEC 30	RYE (GRAIN)	120 LBS/AC

FERTILIZER (FROM AUG 15 - DEC 30, INCREASE 10-10-10 FERTILIZER TO 1000 LB/AC).

FOLLOW RECOMMENDATIONS OF SOIL TESTS OR APPLY 4,000 LB/AC GROUND AGRICULTURE LIMESTONE AND 750 LB/AC 10-10-10

APPLY 4000 LB/AC STRAW. ANCHOR STRAW BY TACKING WITH ASPHALT, NETTING, OR A MULCH ANCHORING TOOL. A DISK WITH

BLADES SET NEARLY STRAIGHT CAN BE USED AS A MULCH ANCHORING TOOL.

JAN 1 - AUG 15: REFERTILIZE IF GROWTH IS NOT FULLY ADEQUATE. RESEED. REFERTILIZE. AND MULCH IMMEDIATELY FOLLOWING EROSION OR OTHER DAMAGE.

AUG 15 - DEC 30: REPAIR AND REFERTILIZE DAMAGED AREAS IMMEDIATELY. TOP DRESS WITH 50 LB/AC OF NITROGEN IN MARCH. IF IT IS NECESSARY TO EXTEND TEMPORARY COVER BEYOND JUNE 15, OVERSEED WITH 50 LB/AC KOBE LESPEDEZA IN LATE FEBRUARY OR EARLY MARCH.

NOTE: USE THE TEMPORARY SEEDING SCHEDULE ONLY WHEN DATE IS NOT CORRECT TO USE THE PERMANENT SEEDING SCHEDULE.

PERMANENT SEEDING SCHEDULE

SEEDING DATE	SEEDING MIXTURE	APPLICATION RATE
AUG 25 - OCT (BEST)	TALL FESCUE	200 LBS/AC
	RYE (GRAIN)	50 LBS/AC
	GERMAN MILLET	50 LBS/AC
FEB - APR 15 (POSSIBLE)	TALL FESCUE	200 LBS/AC
	RYE (GRAIN)	50 LBS/AC
	GERMAN MILLET	50 LBS/AC

FOLLOW RECOMMENDATIONS OF SOIL TESTS OR APPLY 4,000 LB/AC GROUND AGRICULTURE LIMESTONE AND 1000 LB/AC 10-10-10

APPLY 4000 LB/AC STRAW. ANCHOR STRAW BY TACKING WITH ASPHALT, NETTING, OR A MULCH ANCHORING TOOL. A DISK WITH

BLADES SET NEARLY STRAIGHT CAN BE USED AS A MULCH ANCHORING TOOL.

INSPECT AND REPAIR MULCH FREQUENTLY. REFERTILIZE IN LATE WINTER OF THE FOLLOWING YEAR; USE SOIL TESTS OR APPLY 150 LB/AC 10-10-10 FERTLIZER. MOW REGULARLY TO A HEIGHT OF 2-4 INCHES.

SEEDBED PREPARATION

AREAS TO BE SEEDED TO BE SCARIFIED 4" DEEP. A FIRM, WELL PULVERIZED, UNIFORM SEEDBED SHOULD BE PROVIDED. FERTILIZER SHALL BE PLACED DURING SCARIFICATION AS FOLLOWS: LIME: 45 LBS / 1.000 SF

PHOSPHOROUS: 20 LBS / 1,000 SF FERTILIZER: 17 LBS / 1.000 SF

TEMPORARY SKIMMER BASIN SPECIFICATIONS:

- 1. CLEAR, GRUB, AND STRIP THE AREA UNDER THE EMBANKMENT OF ALL VEGETATION AND ROOT MAT, REMOVE ALL SURFACE SOIL CONTAINING HIGH AMOUNTS OF ORGANIC MATTER AND STOCKPILE OR DISPOSE OF IT PROPERLY. HAUL ALL OBJECTIONABLE MATERIAL TO THE DESIGNATED DISPOSAL AREA. PLACE TEMPORARY SEDIMENT CONTROL MEASURES BELOW BASIN AS NEEDED.
- 2. ENSURE THAT FILL MATERIAL FOR THE EMBANKMENT IS FREE OF ROOTS, WOODY VEGETATION, ORGANIC MATTER, AND OTHER OBJECTIONABLE MATERIAL. PLACE THE FILL IN LIFTS NOT THE EXCEED 9 INCHES, AND MACHINE COMPACT IT. OVER FILL THE EMBANKMENT 6 INCHES TO ALLOW FOR SETTLEMENT
- 3. SHAPE THE BASIN TO THE SPECIFIED DIMENSIONS. PREVENT THE SKIMMING DEVICE FROM SETTLING INTO THE MUD BY EXCAVATING A SHALLOW PIT UNDER THE SKIMMER OR PROVIDING A LOW SUPPORT UNDER THE SKIMMER OF STONE
- 4. PLACE THE BARREL (TYPICALLY 4-INCH SCHEDULE 40 PVC PIPE) ON A FIRM, SMOOTH FOUNDATION OF IMPERVIOUS SOIL. DO NOT USE PERVIOUS MATERIAL SUCH AS SAND, GRAVEL, OR CRUSHED STONE AS BACKFILL AROUND THE PIPE. PLACE THE FILL MATERIAL AROUND THE PIPE SPILLWAY IN 4-INCH LAYERS AND COMPACT IT UNDER AND AROUND THE PIPE TO AT LEAST THE SAME DENSITY AS THE ADJACENT EMBANKMENT. CARE MUST BE TAKEN NOT THE RAISE THE PIPE FROM THE FIRM CONTACT WITH ITS FOUNDATION WHEN COMPACTING UNDER THE PIPE HAUNCHES.
- 5. PLACE A MINIMUM DEPTH OF 2 FEET OF COMPACTED BACKFILL OVER THE PIPE SPILLWAY BEFORE CROSSING IT WITH CONSTRUCTION EQUIPMENT. IN NO CASE SHOULD THE PIPE CONDUIT BE INSTALLED BY CUTTING A TRENCH THROUGH THE DAM AFTER THE EMBANKMENT IS COMPLETE.
- 6. ASSEMBLE THE SKIMMER FOLLOWING THE MANUFACTURER'S INSTRUCTIONS, OR AS DESIGNED.
- 7. LAY THE ASSEMBLED SKIMMER ON THE BOTTOM OF THE BASIN WITH THE FLEXIBLE JOINT AT THE INLET OF THE BARREL PIPE. ATTACH THE FLEXIBLE JOINT TO THE BARREL PIPE AND POSITION THE SKIMMER OVER THE EXCAVATED PIT OR SUPPORT. BE SURE TO ATTACH A ROPE TO THE SKIMMER AND ANCHOR IT TO THE SIDE OF THE BASIN. THIS WILL BE USED TO PULL THE SKIMMER TO THE SIDE FOR MAINTENANCE
- 8. EARTHEN SPILLWAYS INSTALL THE SPILLWAY IN UNDISTURBED SOIL TO THE GREATEST EXTENT POSSIBLE. THE ACHIEVEMENT OF PLANNED ELEVATIONS, GRADE, DESIGN WIDTH, AND ENTRANCE AND EXIT CHANNEL SLOPES ARE CRITICAL TO THE SUCCESSEUL OPERATION OF THE SPILLWAY, THE SPILLWAY SHOULD BE LINED WITH LAMINATED PLASTIC OR IMPERMEABLE GEOTEXTILE FABRIC. THE FABRIC MUST BE WIDE AND LONG ENOUGH TO COVER THE BOTTOM AND SIDES AND EXTEND ONTO THE TOP OF THE DAM FOR ANCHORING IN A TRENCH. THE EDGES MAY BE SECURED WITH 8-INCH STAPLES OR PINS. THE FABRIC MUST BE LONG ENOUGH TO EXTEND DOWN THE SLOPE AND EXIT ONTO STABLE GROUND. THE WIDTH OF THE FABRIC MUST BE ONE PIECE. NOT JOINED OR SPLICED: OTHERWISE WATER CAN GET UNDER THE FABRIC. IF THE LENGTH OF THE FABRIC IS INSUFFICIENT FOR THE ENTIRE LENGTH OF THE SPILLWAY, MULTIPLE SECTIONS, SPANNING THE COMPLETE WIDTH, MAY BE USED. THE UPPER SECTION (S) SHOULD OVERLAP THE LOWER SECTION(S) SO THAT WATER CANNOT FLOW UNDER THE FABRIC, SECURE THE UPPER EDGE AND SIDES OF THE FABRIC IN A TRENCH WITH STAPLES OR PINS. (ADAPTED FROM "A MANUAL FOR DESIGNING, INSTALLING, AND MAINTAINING SKIMMER SEDIMENT BASINS." FEBRUARY, 1999. J. W. FAIRCLOTH & SON.).
- 9. INLETS DISCHARGE WATER INTO THE BASIN IN A MANNER TO PREVENT EROSION. USE TEMPORARY SLOPE DRAINS OR DIVERSIONS WITH OUTLET PROTECTION TO DIVERT SEDIMENT-LADEN WATER TO THE UPPER END OF THE POOL AREA TO IMPROVE BASIN TRAP EFFICIENCY (REFERENCES: RUNOFF CONTROL MEASURES AND OUTLET PROTECTION).
- 10. EROSION CONTROL CONSTRUCT THE STRUCTURE SO THAT THE DISTURBED AREA IS MINIMIZED. DIVERT SURFACE WATER AWAY FROM BARE AREAS. COMPLETE THE EMBANKMENT BEFORE THE AREA IS CLEARED. STABILIZE THE EMERGENCY SPILLWAY EMBANKMENT AND ALL OTHER DISTURBED AREAS ABOVE THE CREST OF THE PRINICIPAL SPILLWAY IMMEDIATELY AFTER CONSTRUCTION (REFERENCES: SURFACE STABILIZATION).
- 11. INSTALL POROUS BAFFLES AS SPECIFIED IN PRACTICE 6.65, POROUS BAFFLES.
- 12. AFTER ALL THE SEDIMENT-PRODUCING AREAS HAVE BEEN PERMANENTLY STABILIZED, REMOVE THE STRUCTURE AND ALL THE UNSTABLE SEDIMENT. SMOOTH THE AREA TO BLEND WITH THE ADJOINING AREAS AND STABILIZE PROPERLY (REFERENCES: SURFACE STABILIZATION)

REQUIRED GRO	OUND STABILIZ	ATION TIMEFRAMES		
SITE AREA DESCRIPTION	STABILIZE WITHIN THIS MANY CALENDAR DAYS AFTER CEASING LAND DISTURBANCE	TIMEFRAME VARIATIONS		
PERIMETER DIKES, SWALES, DITCHES AND SLOPES	7	NONE		
HIGH QUALITY WATER (HQW) ZONES	7	NONE		
SLOPES STEEPER THAN 3:1	7	IF SLOPES ARE 10' OR LESS IN LENGTH AND ARE NOT STEEPER THAN 2:1, 14—DAYS ARE ALLOWED		
		7-DAYS FOR SLOPES GREATER THAN 50 FEET IN LENGTH AND WITH SLOPES STEEPER THAN 4:1		
SLOPES 3:1 TO 4:1	14	7-DAYS FOR PERIMETER DIKES, SWALS, DITCHES, PERIMETER SLOPES AND HQW ZONES		
		10-DAYS FOR FALLS LAKE WATERSHED		
AREAS WITH SLOPES FLATTER THAN 4:1	14	7-DAYS FOR PERIMETER DIKES, SWALES, DITCHES, PERIMETER SLOPES AND HQW ZONES		
FLAIIER HAN 4:		10-DAYS FOR FALLS LAKE WATERSHED UNLESS THERE IS ZERO SLOPE		

BU	ILDING WASTES HANDLING
•	NO PAINT OR LIQUID WASTES IN STREAM OR STORM DRAINS
•	DEDICATED AREAS FOR DEMOLITION, CONSTRUCTION AND OTHER WASTES MUST BE LOCATED 50' FROM STORM DRAINS AND STREAMS UNLESS NO REASONABLE ALTERNATIVES AVAILABLE.
•	EARTHEN-MATERIAL STOCKPILES MUST BE LOCATED 50' FROM STORM DRAINS AND STREAMS UNLESS NO REASONABLE ALTERNATIVES AVAILABLE.

CONCRETE MATERIALS MUST BE CONTROLLED TO AVOID

CONTACT WITH SURFACE WATER, WETLANDS, OR BUFFERS.

TOTAL DISTURBED AREA: 1.67 AC

Drainage Area (AC.)	1.26
Disturbed Area (AC.)	1.26
Flow Q10 (CFS)	3.4
Bottom Elevation (FT)	289.00
Sediment Depth (FT)	2.00
Freeboard (from Sediment Depth)	1.50
Depth to Crest of Emergency Spillway (FT)	2.00
Side Slopes	2.0H:1V
Spillway Length (FT)	10
Height of Berm (FT)	3.50
Top of Trap Length (FT)	87
Top of Trap Width (FT)	36
_	

TEMPORARY SKIMMER BASIN/TRAP DESIGN TABLE

2,268 Storage Volume Required (FT³) Storage Volume Prov'd. (FT3) 1,090 diment Surface Area Reg'd (FT2) diment Surface Area Prov'd (FT2) 2,430 Number of Skimmers Skimmer Size (IN) 2.0 immer Orifice Size (IN) 0.9 Riser Diameter (IN)

N/A

ASE TO THE TOP OF BERM, 2H:1V ABOVE THAT SEE DETAILS ON SILT FENCE BAFFLE SPACING

SIDE SLOPES PERTAIN ONLY FOR THE VERTICAL HEIGHT FROM T

TEMPORARY DIVERSION SPECIFICATIONS:

- 1. REMOVE AND PROPERLY DISPOSE OF ALL TREES, BRUSH, STUMPS, AND OTHER OBJECTIONABLE MATERIAL IN THE LOCATIONS OF TEMPORARY DIVERSIONS PRIOR TO CONSTRUCTION OF DIVERSION CHANNELS AND/OR RIDGES.
- 2. ENSURE THAT THE MINIMUM CONSTRUCTED CROSS SECTION MEETS ALL DESIGN REQUIREMENTS. SEE TEMPORARY DIVERSION SWALE DESIGN SUMMARY TABLE. 3. ENSURE THAT THE TOP OF THE DIKE IS NOT LOWER AT ANY POINT THAN THE DESIGN ELEVATION PLUS THE SPECIFIED SETTLEMENT.
- 4. PROVIDE SUFFICIENT ROOM AROUND DIVERSIONS TO PERMIT MACHINE REGRADING AND CLEANOUT
- 5. VEGETATE THE RIDGE IMMEDIATELY AFTER CONSTRUCTION, UNLESS IT WILL REMAIN IN PLACE LESS THAN 30 WORKING DAYS.
- 6. MAINTENANCE INSPECT TEMPORARY DIVERSIONS ONCE A WEEK AND AFTER EVERY RAINFALL. IMMEDIATELY REMOVE SEDIMENT FROM THE FLOW AREA AND REPAIR THE DIVERSION RIDGE. CAREFULLY CHECK OUTLETS AND MAKE TIMELY REPAIRS AS NEEDED. WHEN THE AREA PROTECTED IS PERMANENTLY STABILIZED, REMOVE THE RIDGE AND THE CHANNEL TO BLEND WITH THE NATURAL GROUND LEVEL AND APPROPRIATELY STABILIZE IT.

TEMPORARY DIVERSION SWALE SUMMARY TABLE			
DIVERSION SWALE ID	TD-1	TD-2	
DRAINAGE AREA (AC.)	0.99	0.08	
APPROX. LONGITUDINAL SLOPE (%)	3.90	4.40	
SIDESLOPES (H:V)	3:1	3:1	
BOTTOM WIDTH (FT)	0	0	
TEMPORARY LINER (OR EQUIVALENT EQUAL)	ERONET S75	ERONET S75	
LINER LONGEVITY	12 MONTHS	12 MONTHS	
NOTES:			
1. SWALE LINER TO BE INSPECTED DURING TEMPORARY DIVERSION			

MAINTENANCE. REPAIR OR REPLACE LINER MATERIAL AS NECESSARY.

SWALE LINER TO BE FULLY REPLACED AT END OF LINER LONGEVITY

TEMPORARY DIVERSION SWALE REMAINS IN PLACE.

The John R. McAdams Company,

2905 Meridian Parkway Durham, NC 27713

phone 919. 361. 5000

fax 919. 361. 2269

license number: C-0293, C-187

www.mcadamsco.com

PLAN INFORMATION


PROJECT NO. RAL22005 FILENAME RAL22005-EC1.DWG

CHECKED BY DRAWN BY SCALE 1"=20' DATE 12.06.2023

TITLE

EROSION CONTROL

PRELIMINARY DRAWING - NOT RELEASED FOR CONSTRUCTION

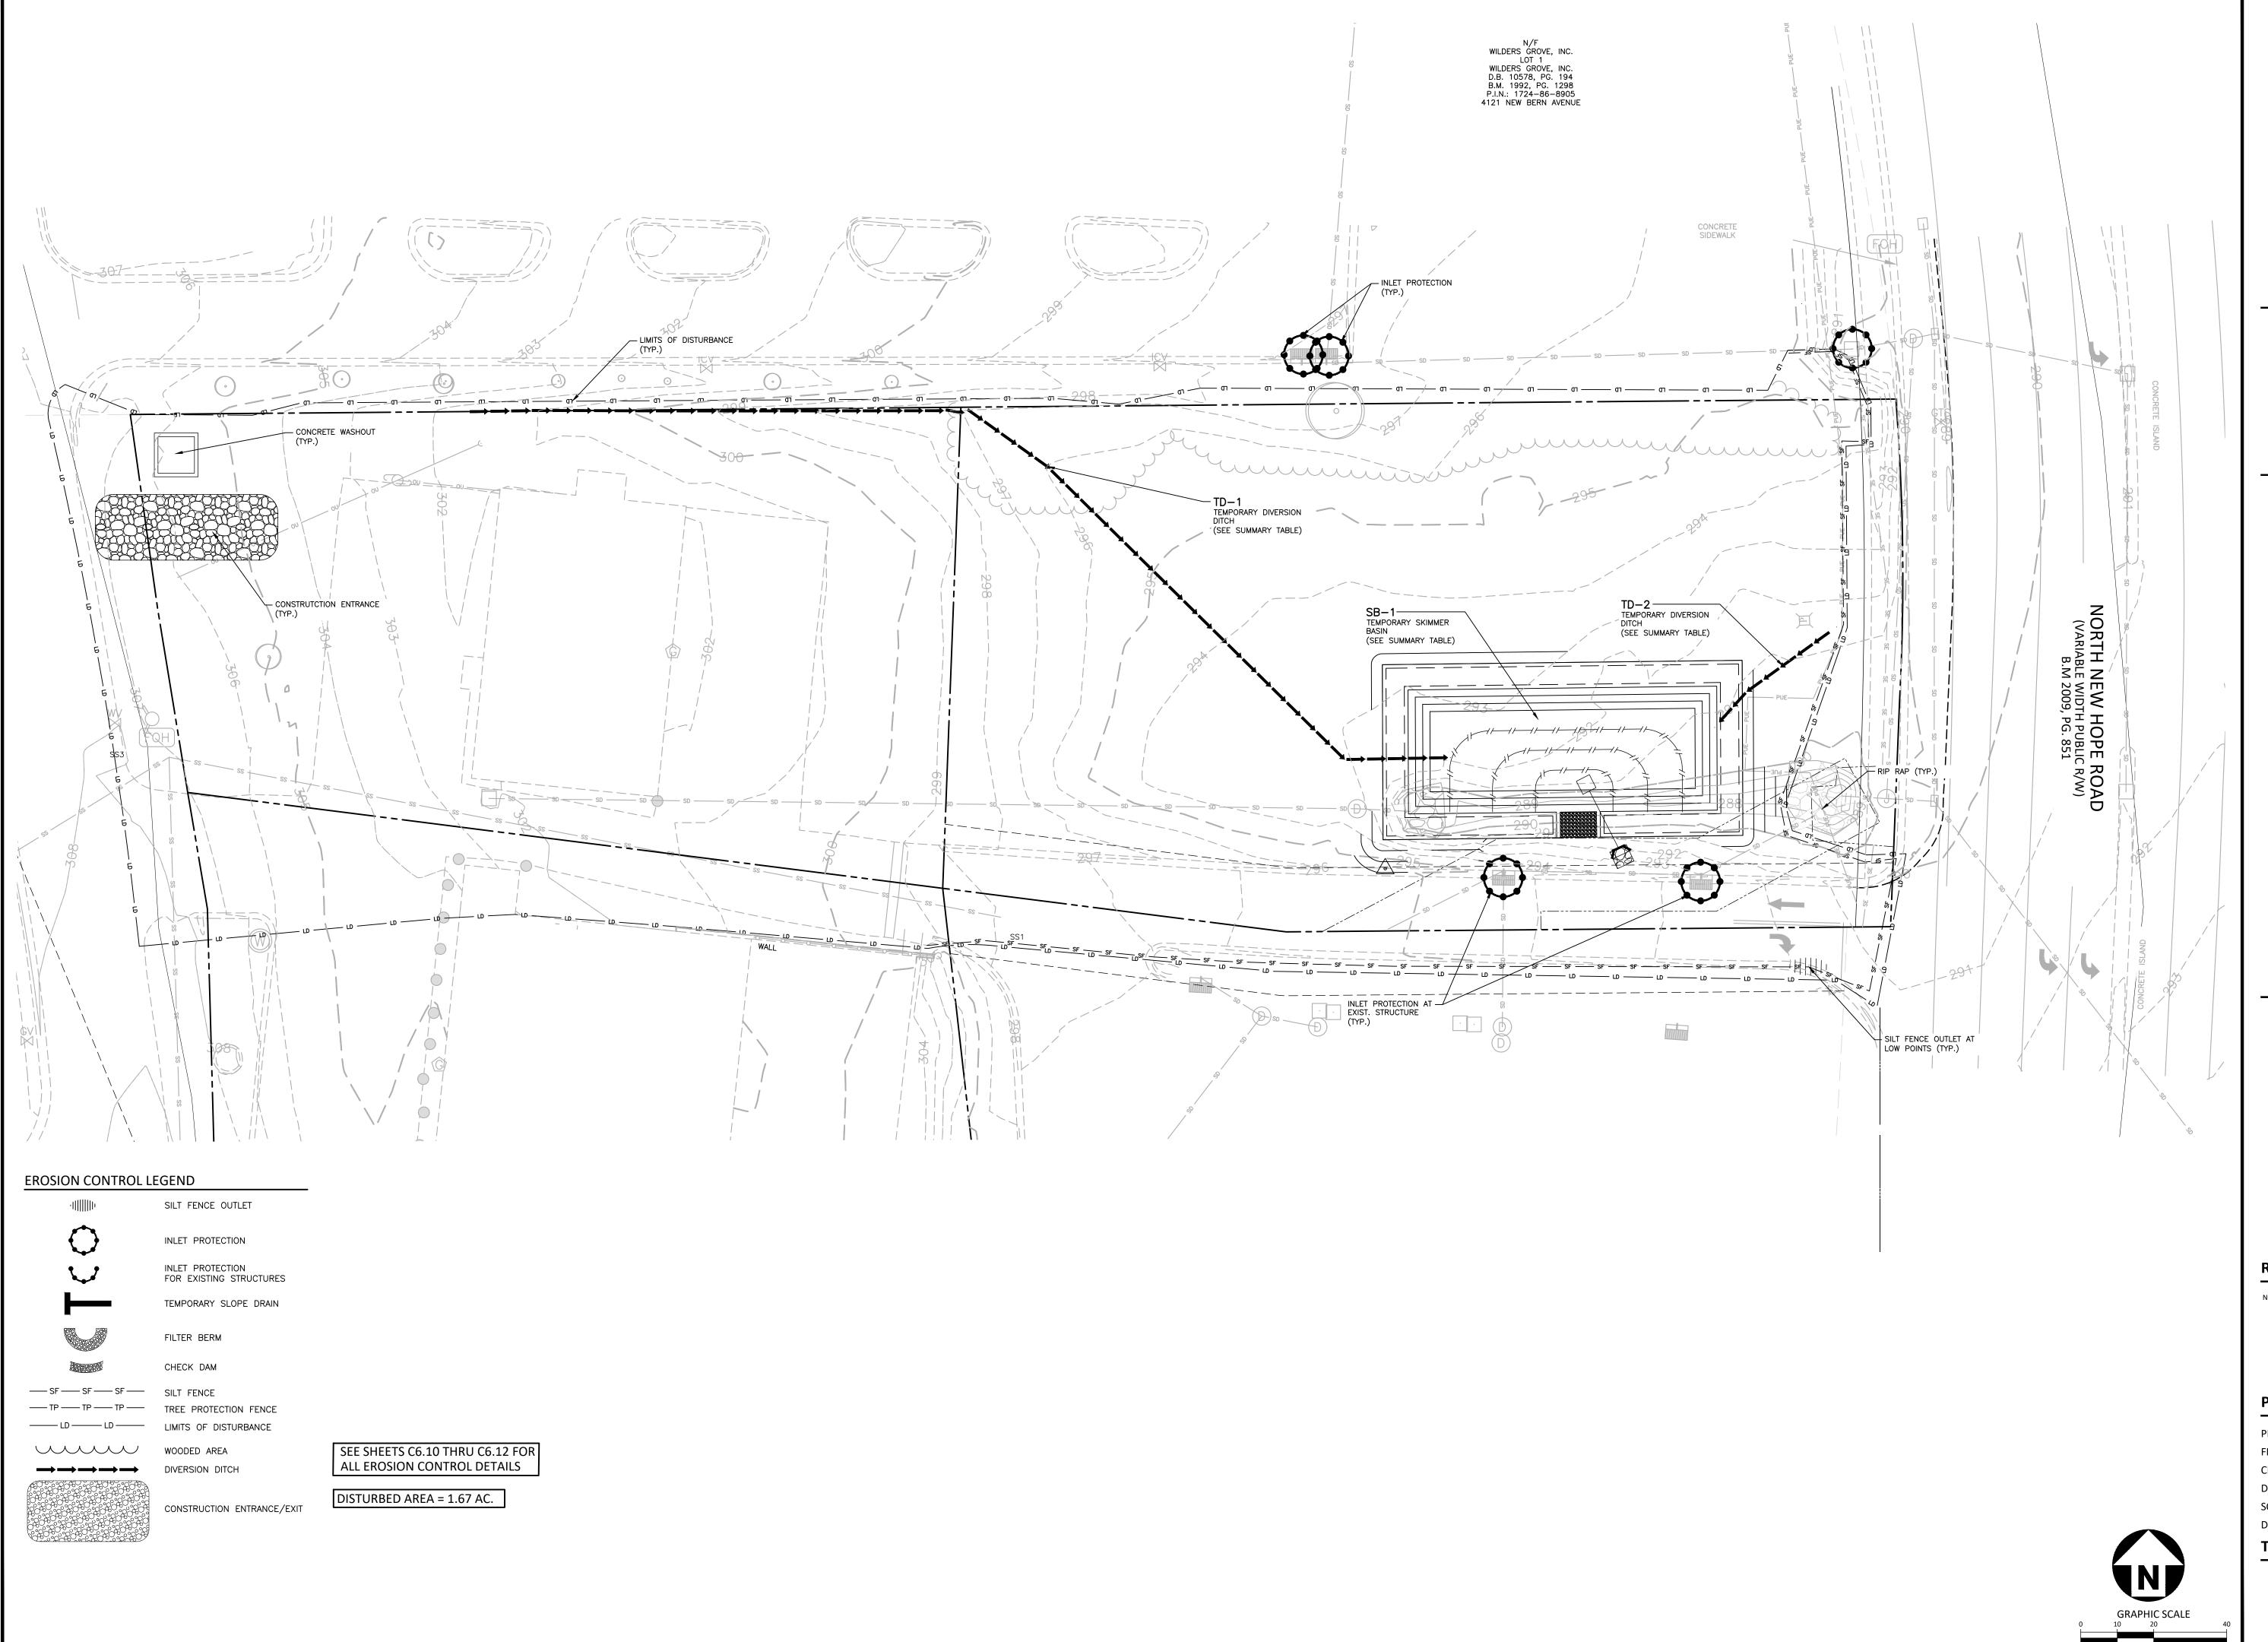



The John R. McAdams Company, Inc. 2905 Meridian Parkway Durham, NC 27713

phone 919. 361. 5000

fax 919. 361. 2269

license number: C-0293, C-187

www.mcadamsco.com

SITE DEVELOPMENT PLANS RALEIGH, NC



) DATE

PLAN INFORMATION

PROJECT NO. RAL22005

FILENAME RAL22005-EC1.DWG

CHECKED BY EMD

CHECKED BY EMD

DRAWN BY AAC

SCALE 1"=20'


DATE 12.06.2023

TITLE

PRELIMINARY DRAWING - NOT RELEASED FOR CONSTRUCTION

STAGE 1 EROSION CONTROL PLAN

C6.01

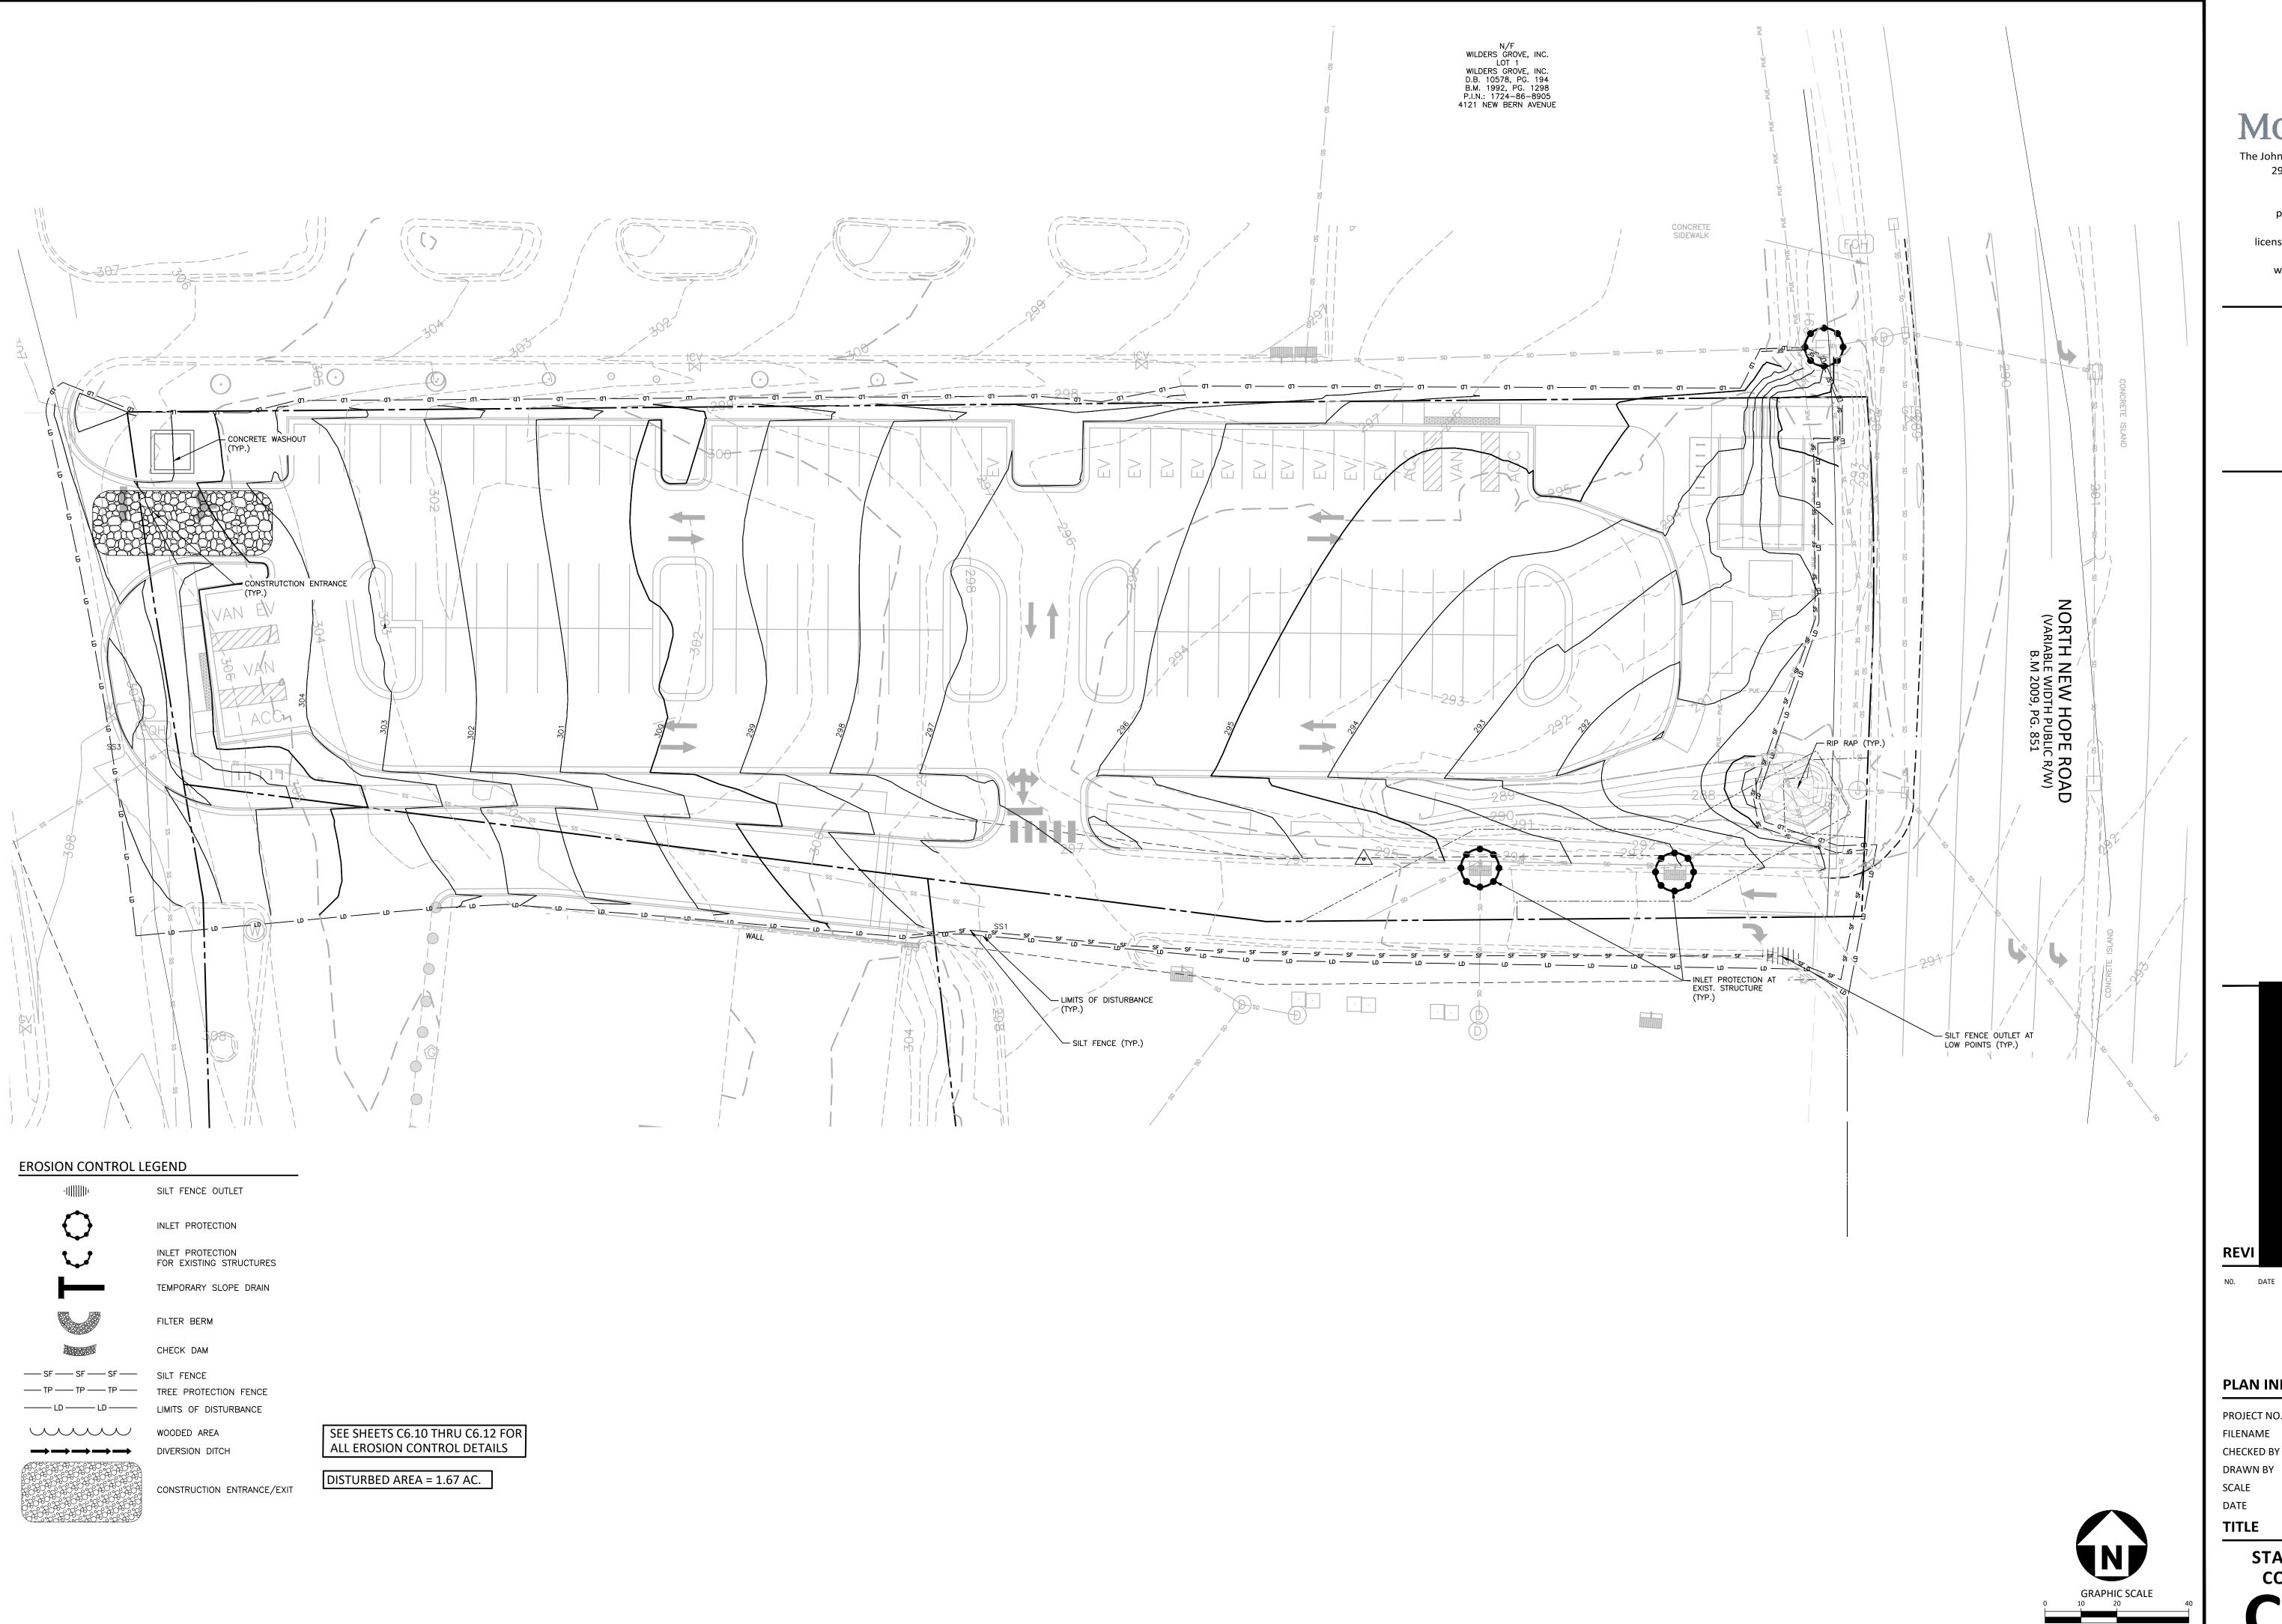




The John R. McAdams Company, Inc. 2905 Meridian Parkway Durham, NC 27713

phone 919. 361. 5000 fax 919. 361. 2269 license number: C-0293, C-187

www.mcadamsco.com

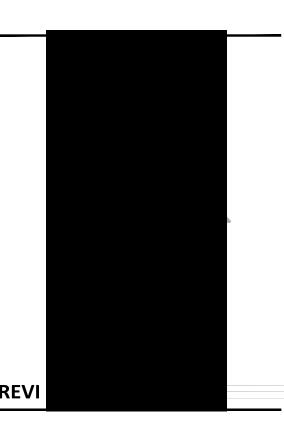

PLAN INFORMATION


PROJECT NO. RAL22005 RAL22005-EC1.DWG FILENAME CHECKED BY

DRAWN BY SCALE DATE 12.06.2023

TITLE

PRELIMINARY DRAWING - NOT RELEASED FOR CONSTRUCTION

STAGE 2 EROSION CONTROL PLAN

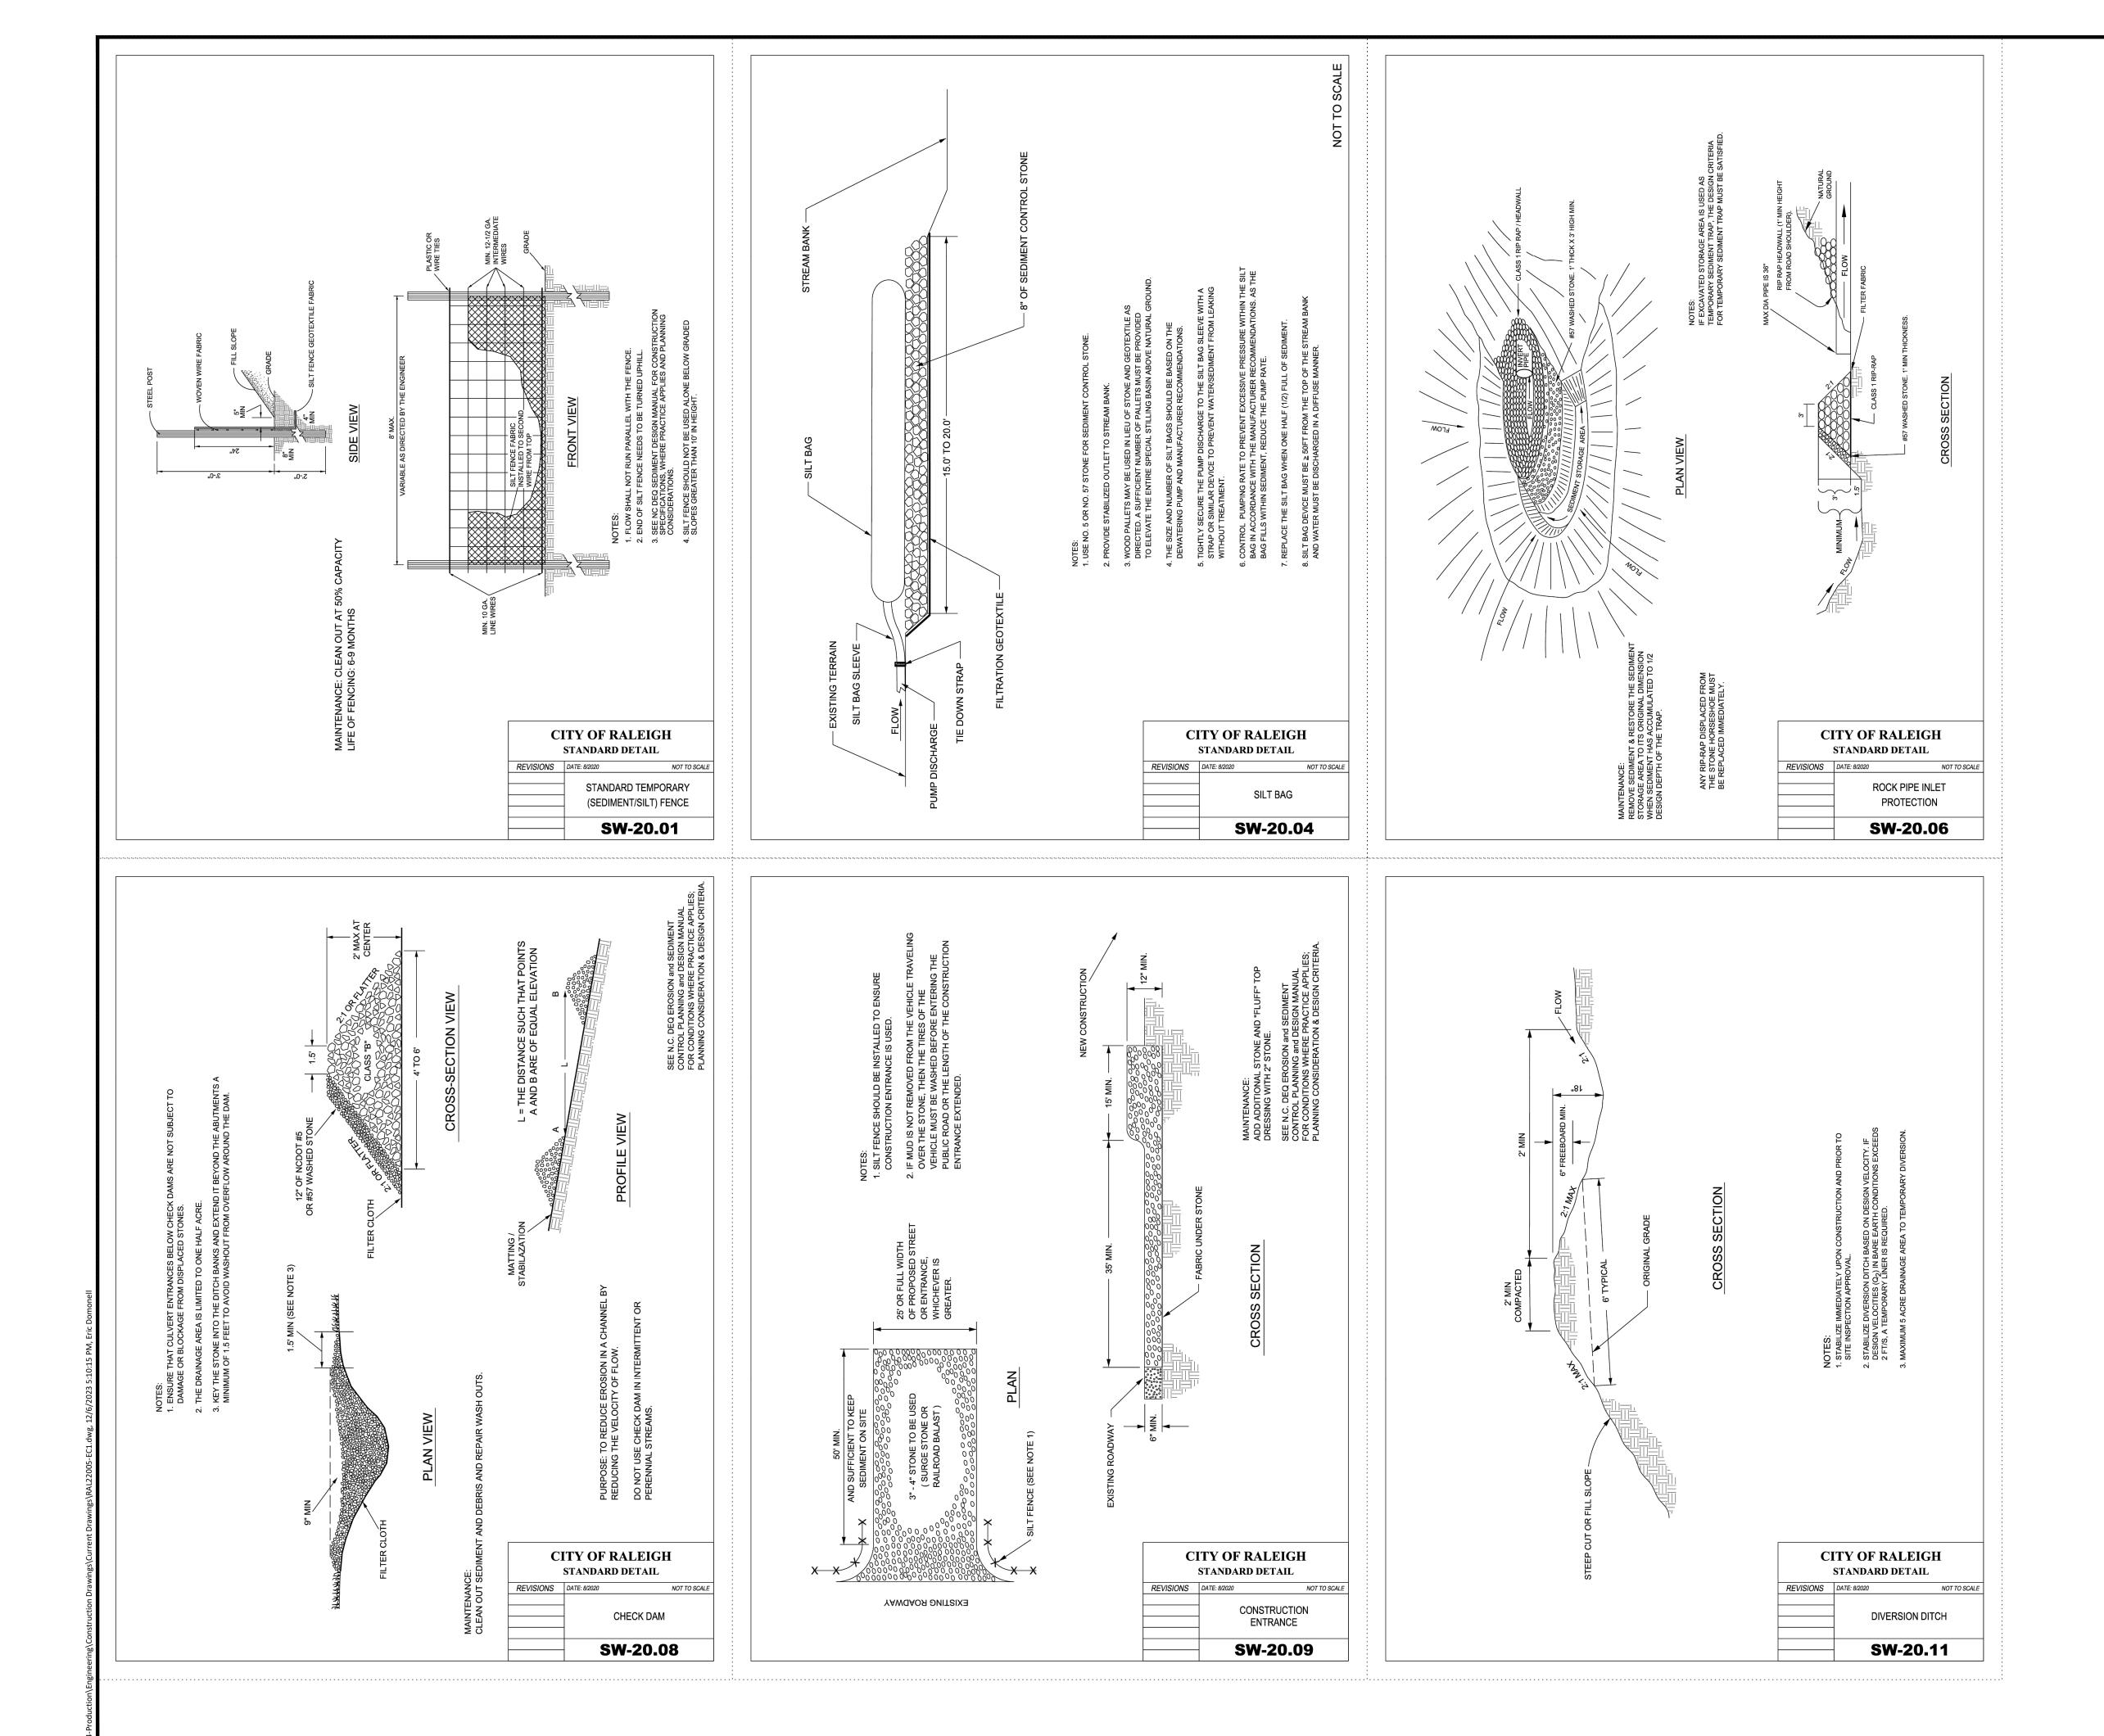



Durham, NC 27713 phone 919. 361. 5000 fax 919. 361. 2269

www.mcadamsco.com

license number: C-0293, C-187

S



PLAN INFORMATION


RAL22005-EC1.DWG FILENAME CHECKED BY


DRAWN BY SCALE DATE TITLE


1"=20' 12.06.2023


EROSION CONTROL DETAILS


C6.10

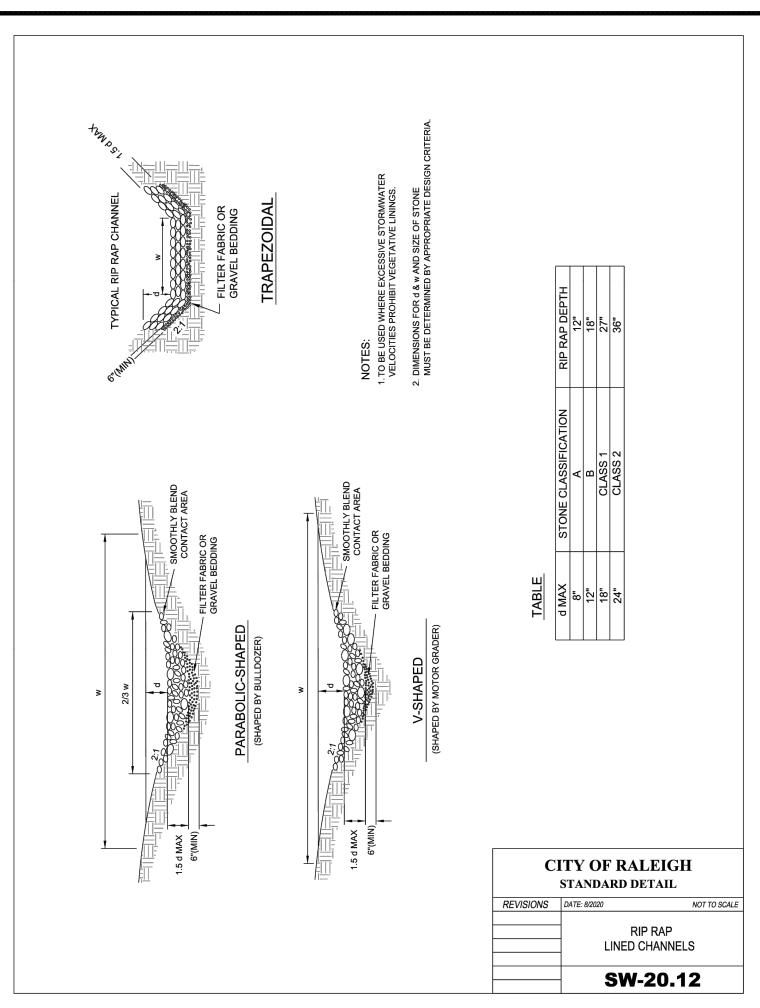


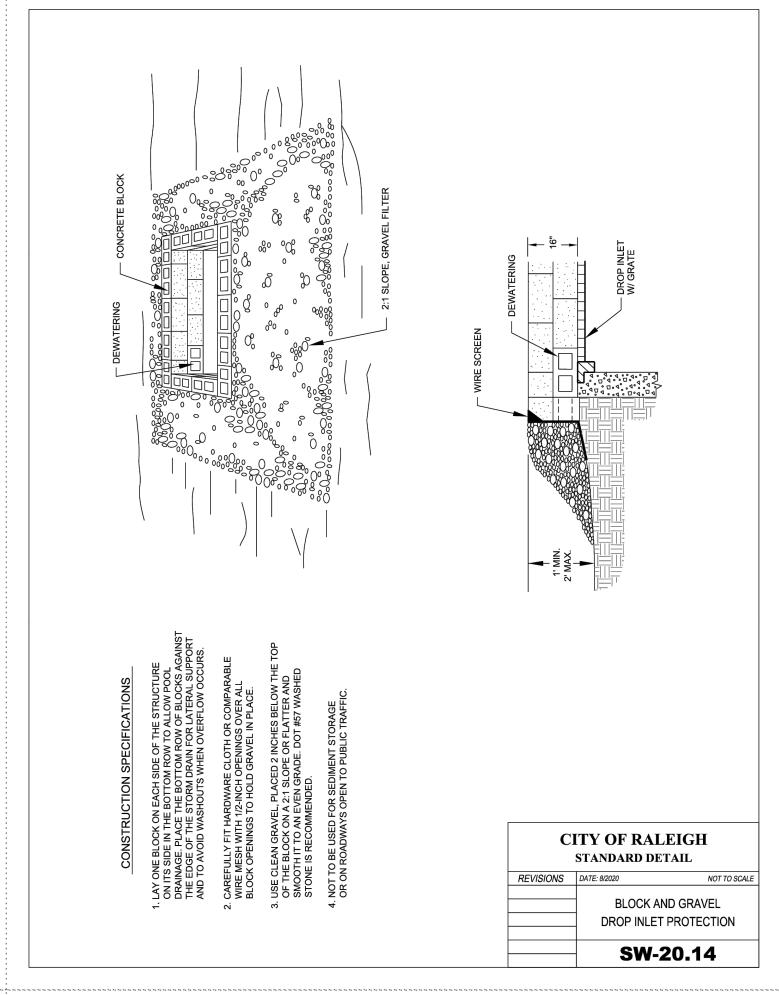

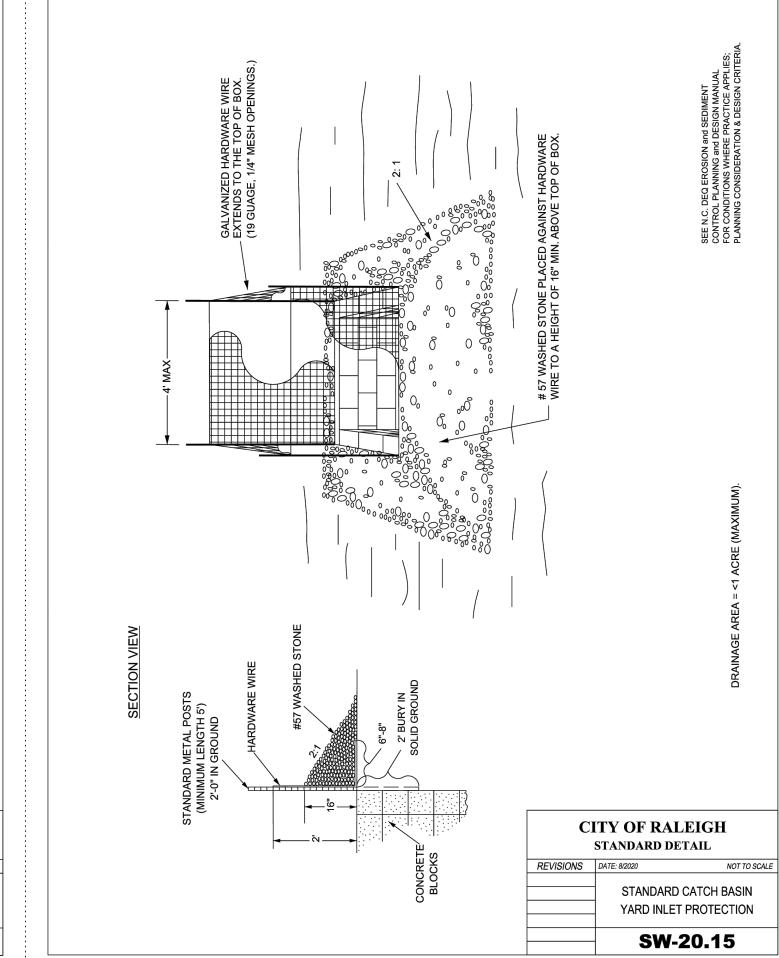

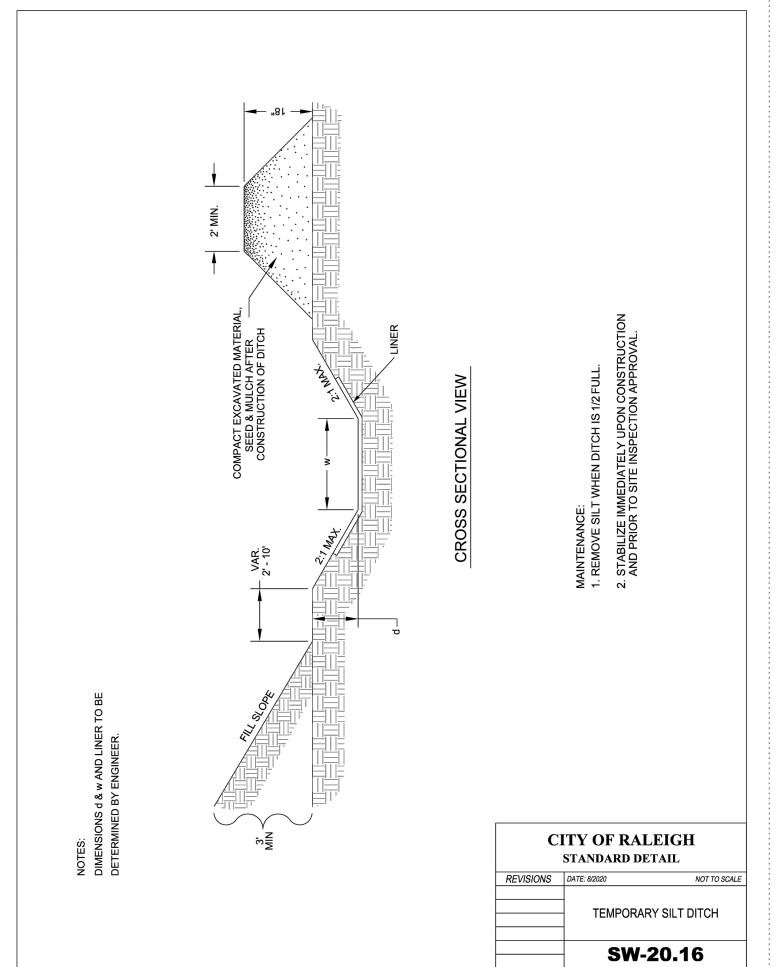

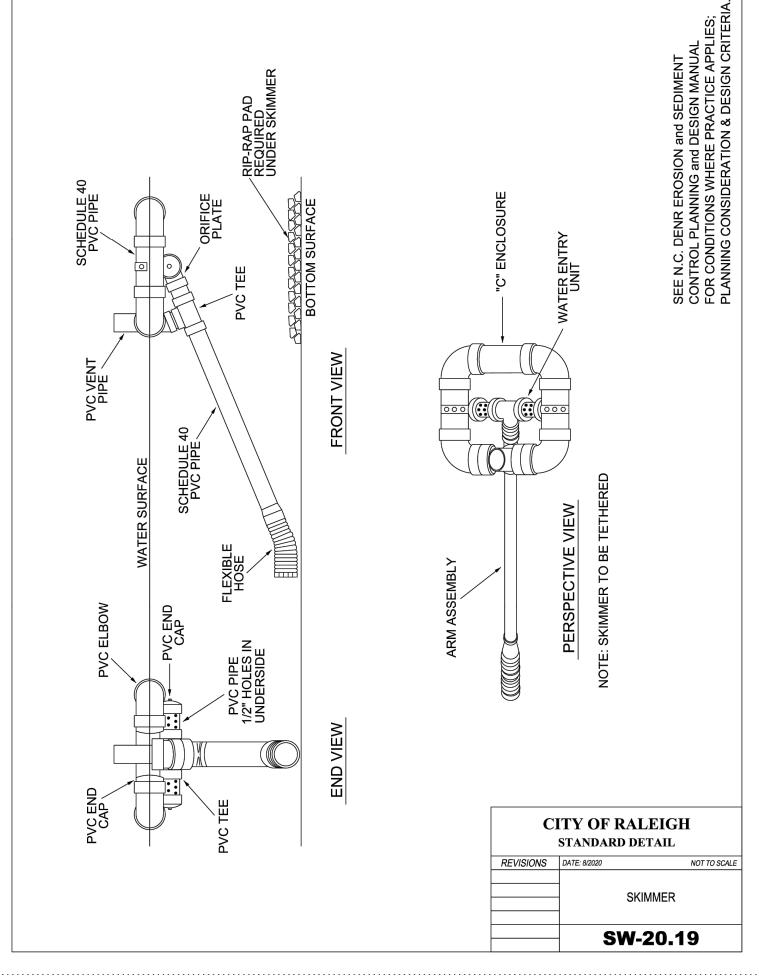

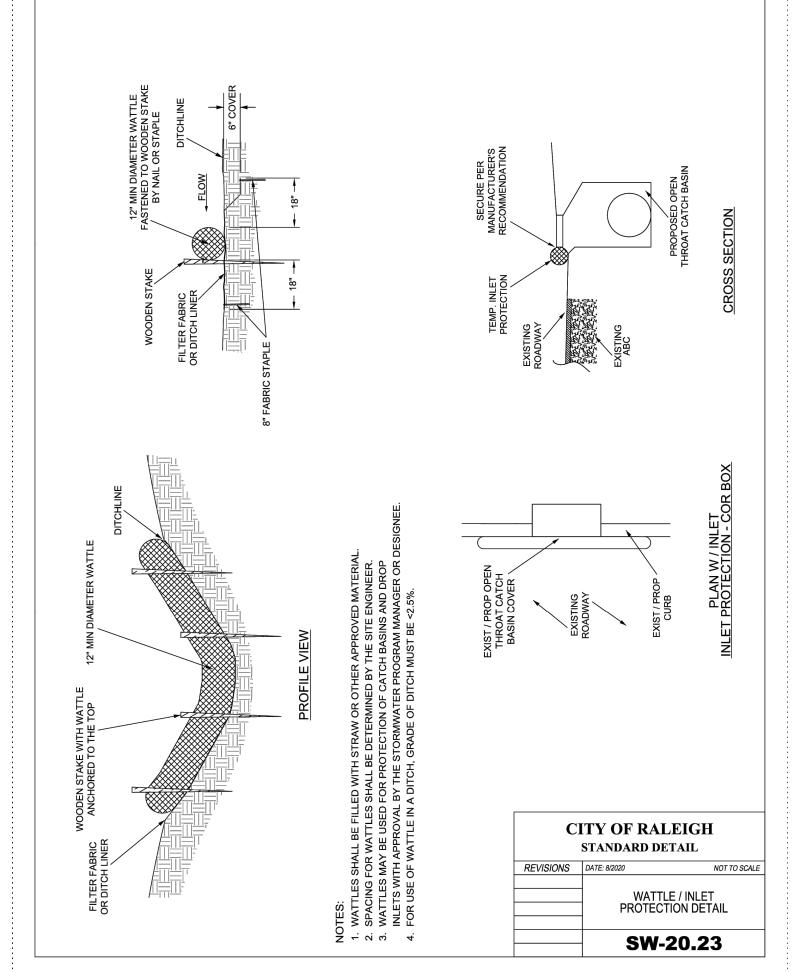



Durham, NC 27713 phone 919. 361. 5000 fax 919. 361. 2269

www.mcadamsco.com

license number: C-0293, C-187

S



PLAN INFORMATION


RAL22005-EC1.DWG CHECKED BY


SCALE 12.06.2023 DATE


TITLE


EROSION CONTROL DETAILS

C6.11

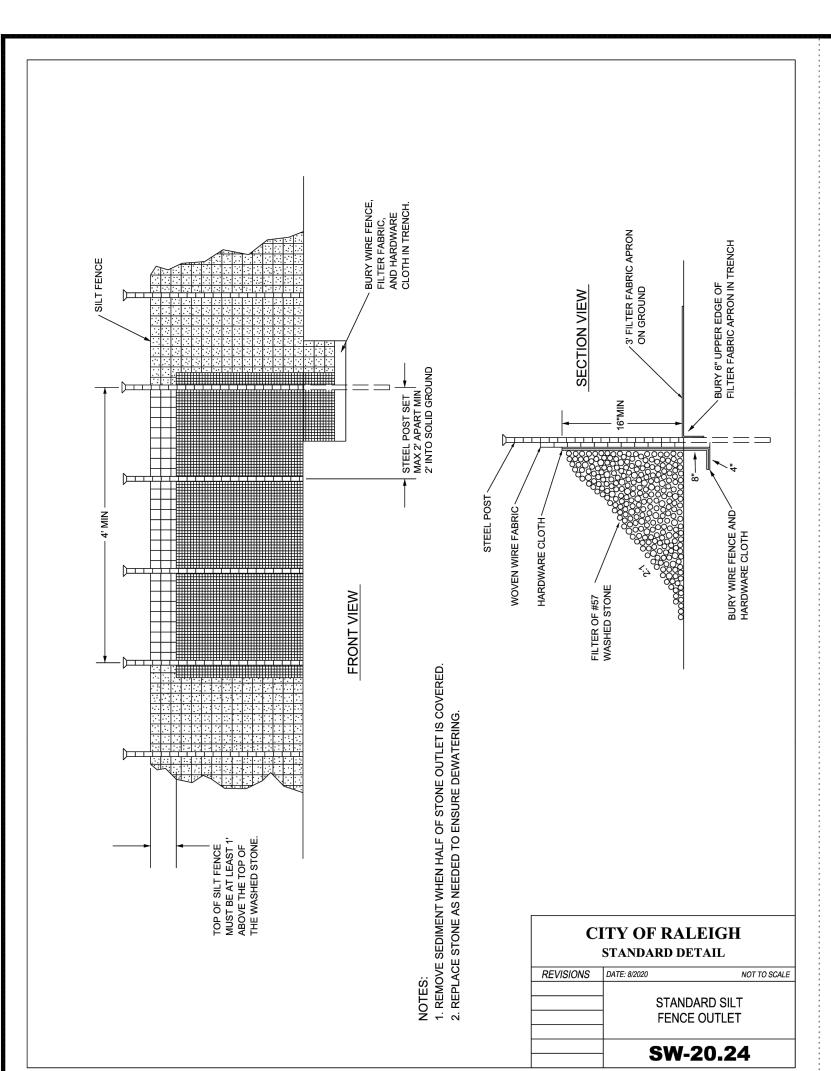


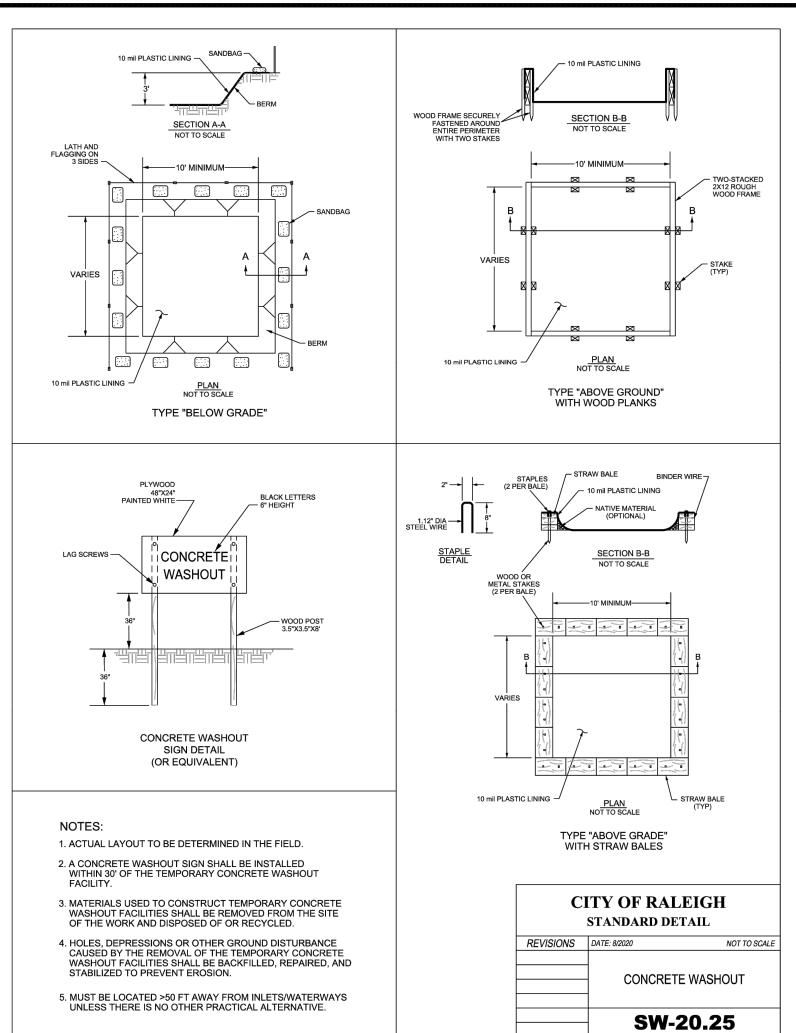

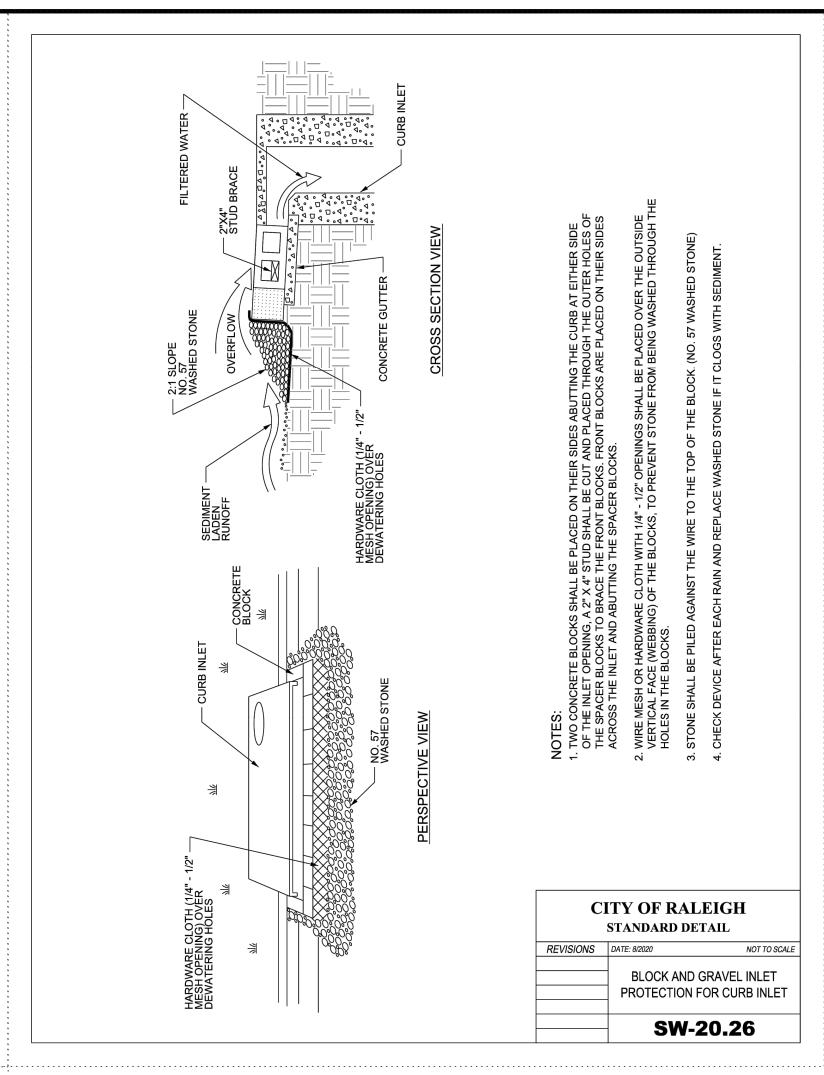

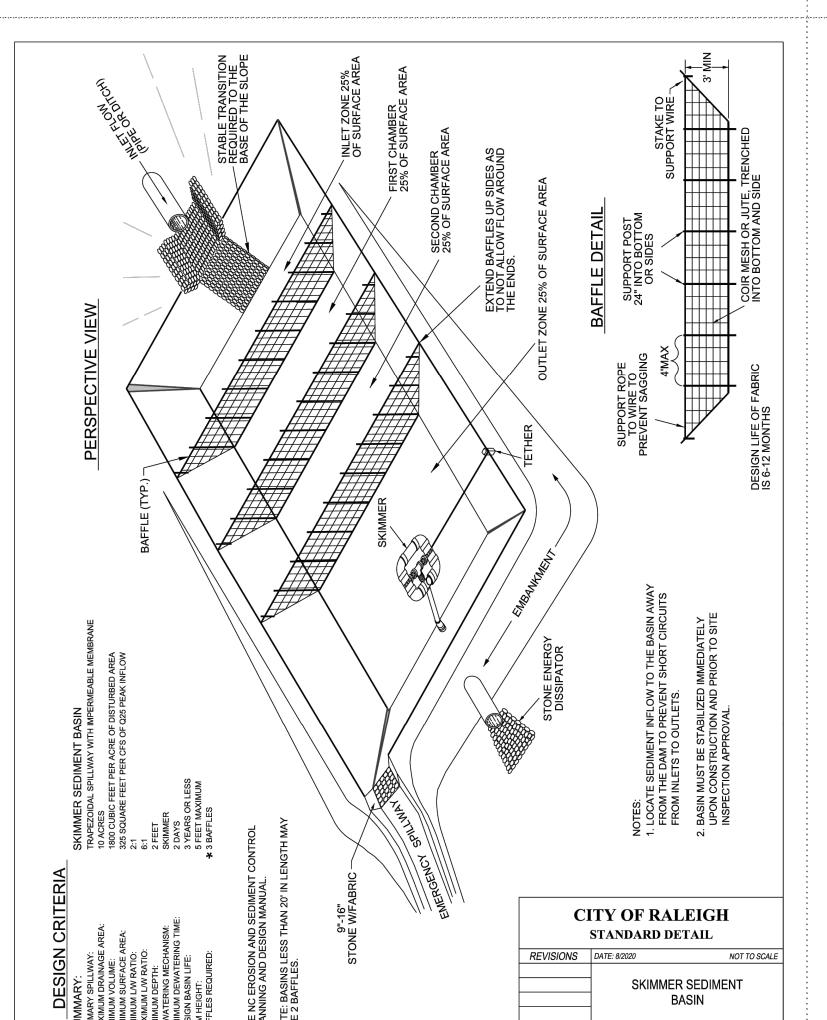

SW-20.28

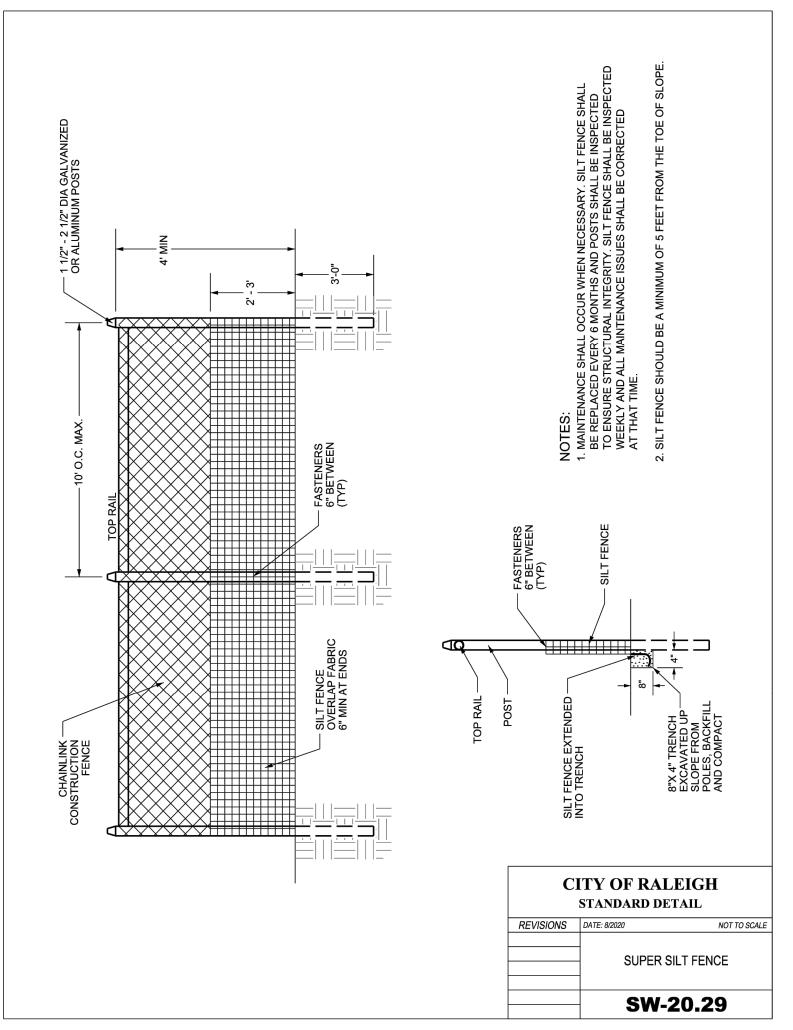



phone 919. 361. 5000 fax 919. 361. 2269 license number: C-0293, C-187

www.mcadamsco.com

S



PLAN INFORMATION


RAL22005-EC1.DWG CHECKED BY SCALE 1"=20'


DATE TITLE


12.06.2023


EROSION CONTROL DETAILS


C6.12

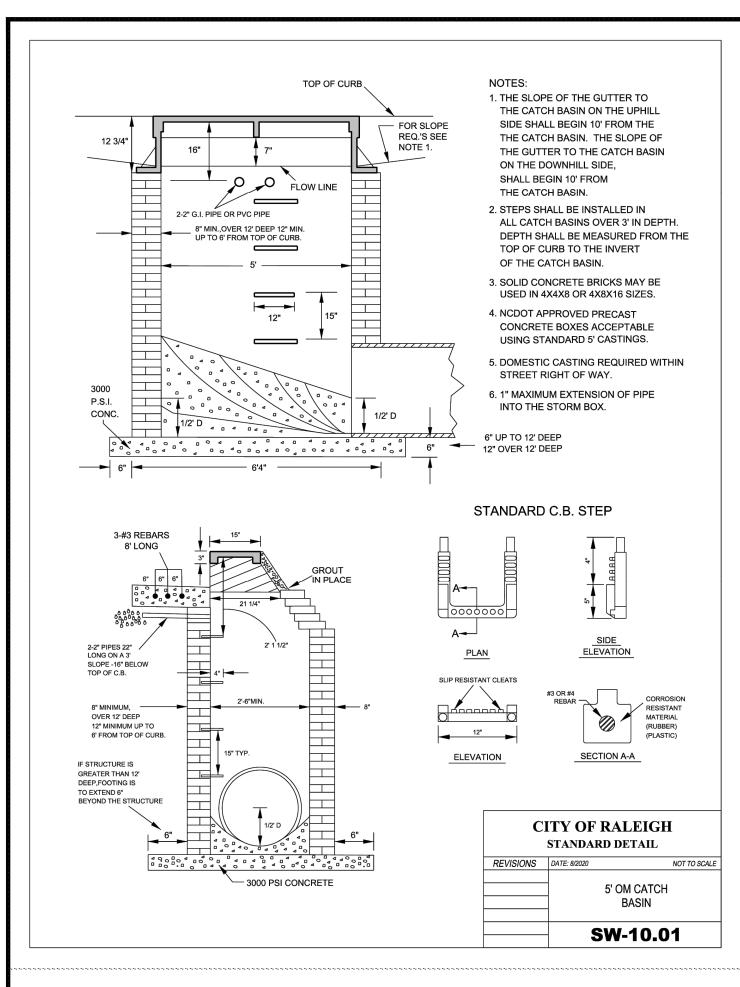


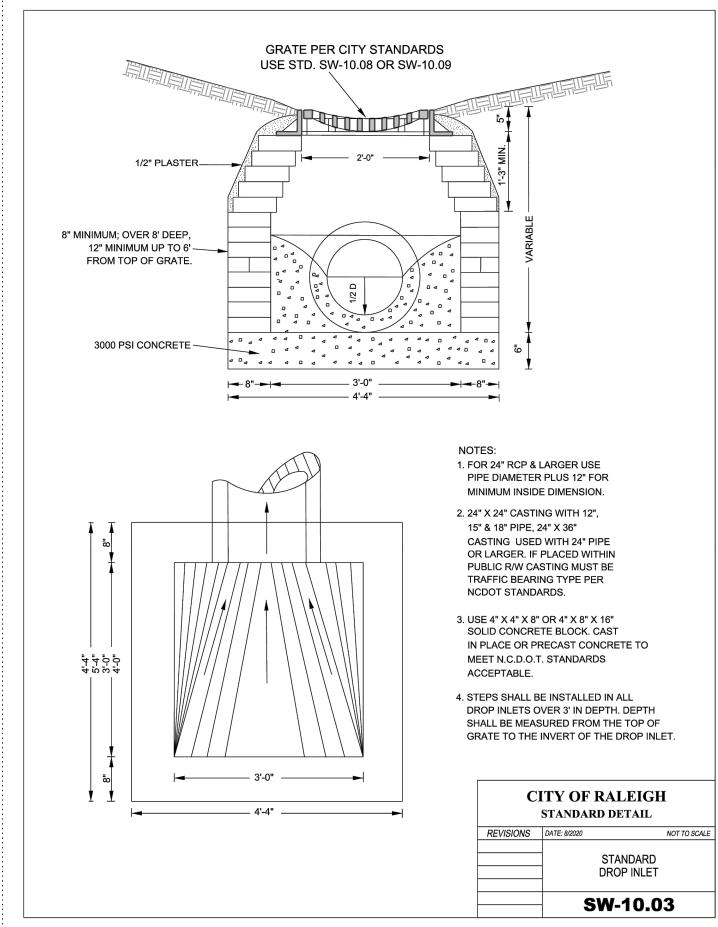


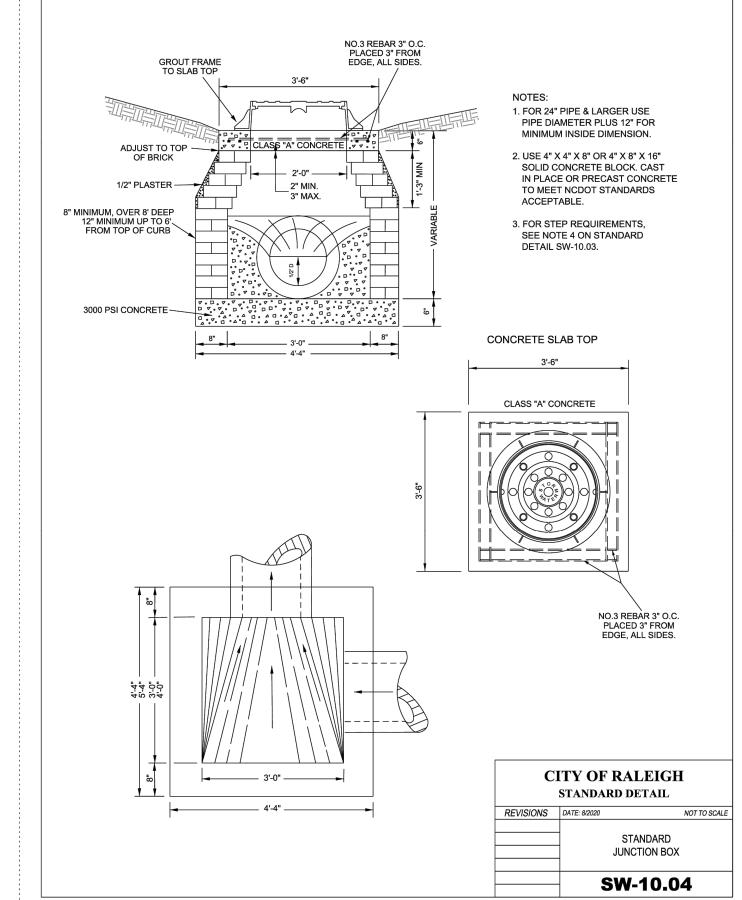


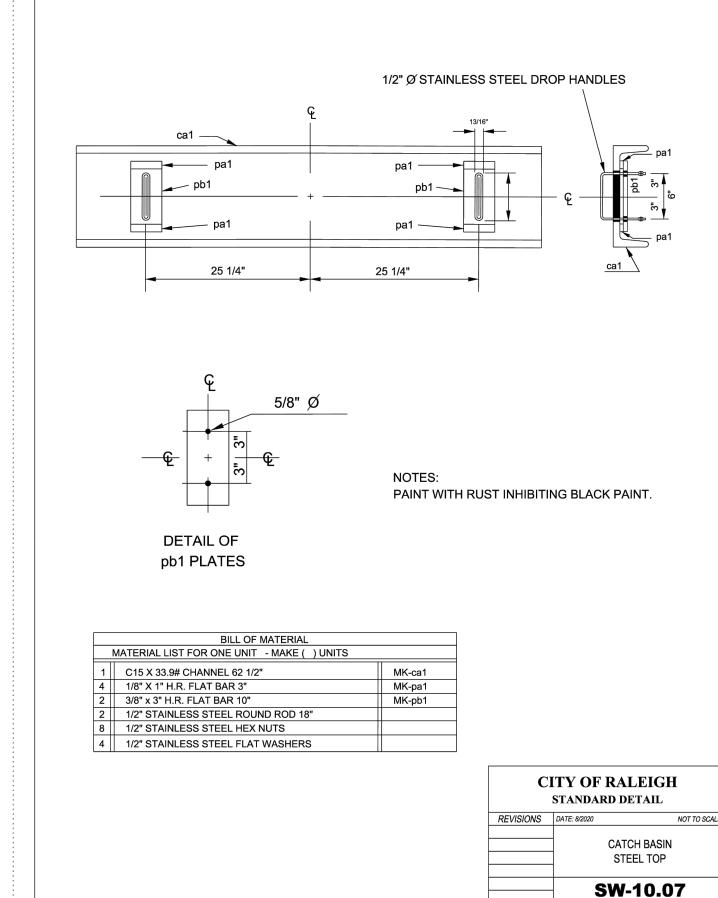

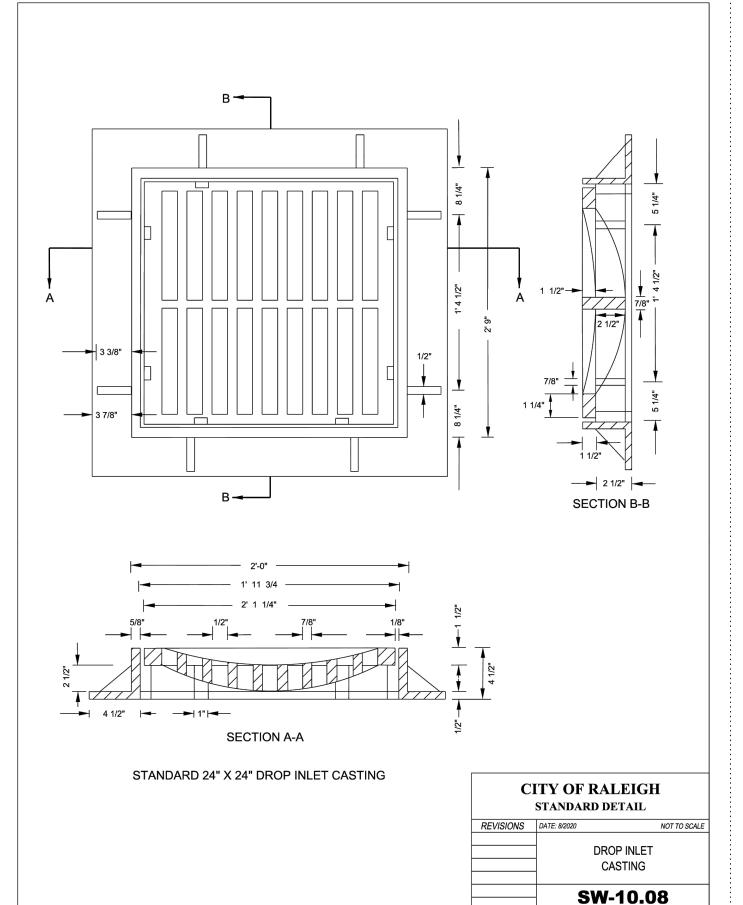

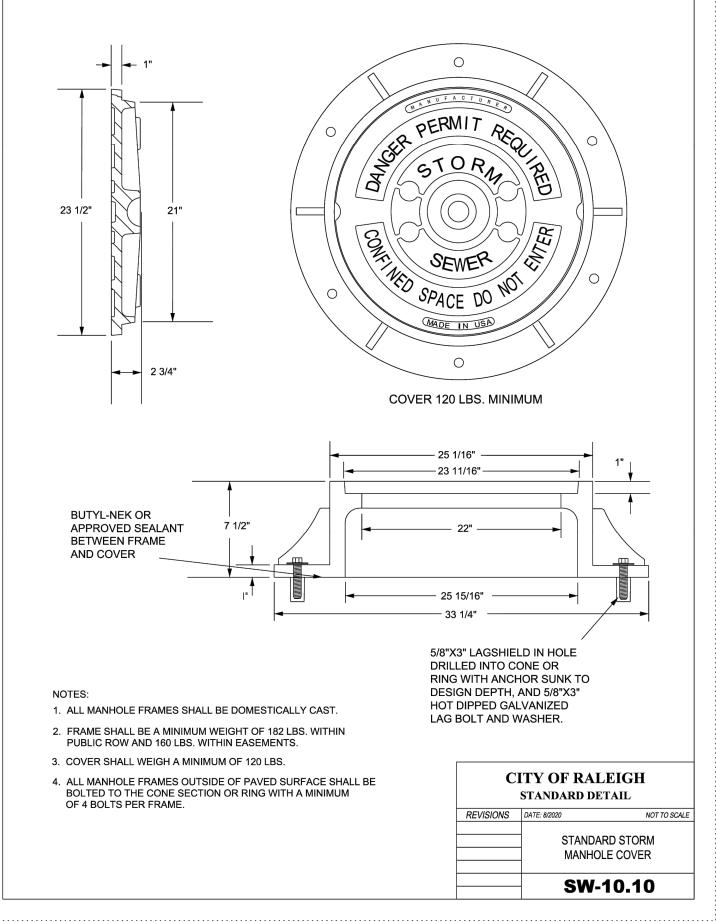

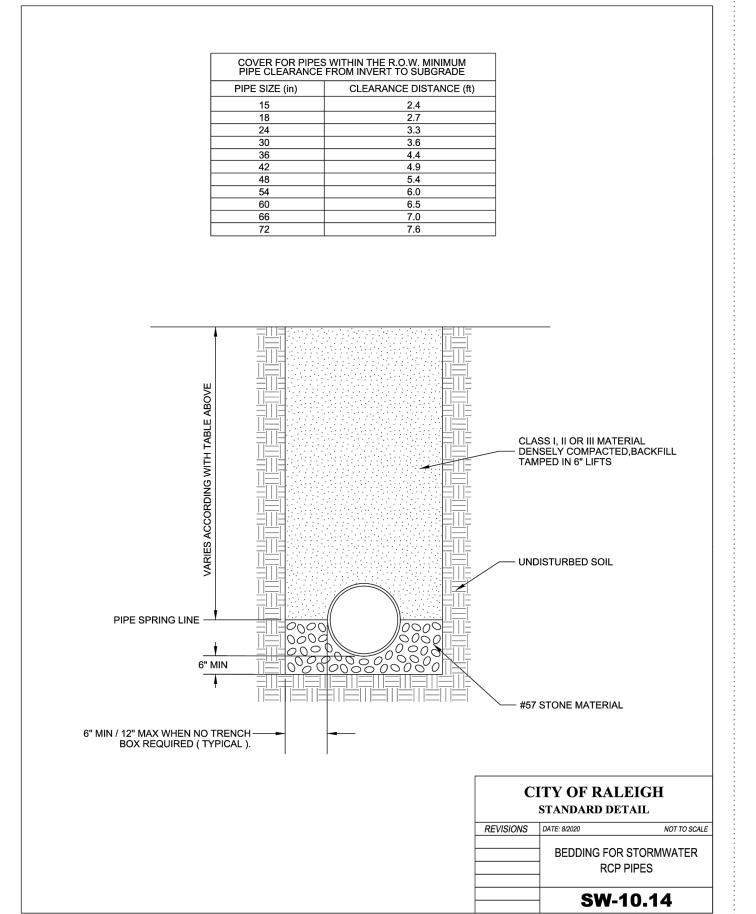

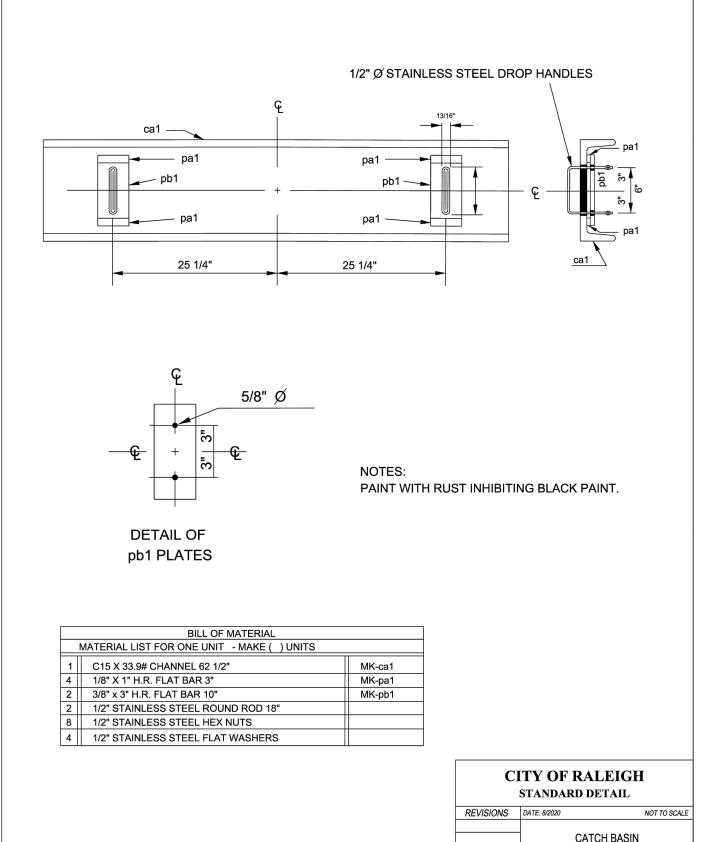

S

The John R. McAdams Company, Inc.

2905 Meridian Parkway


Durham, NC 27713

phone 919. 361. 5000

fax 919. 361. 2269

license number: C-0293, C-187

www.mcadamsco.com

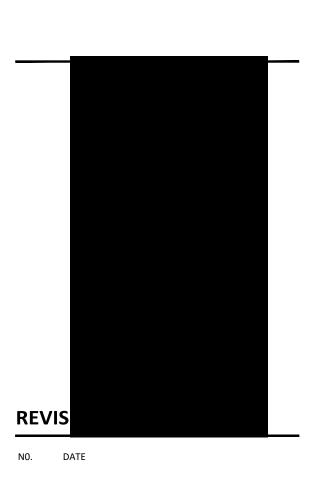


PLAN INFORMATION


PROJECT NO. RAL22005 RAL22005-D1.DWG FILENAME CHECKED BY DRAWN BY


SCALE 1"=20' DATE 12.06.2023


TITLE


STORMWATER DETAILS

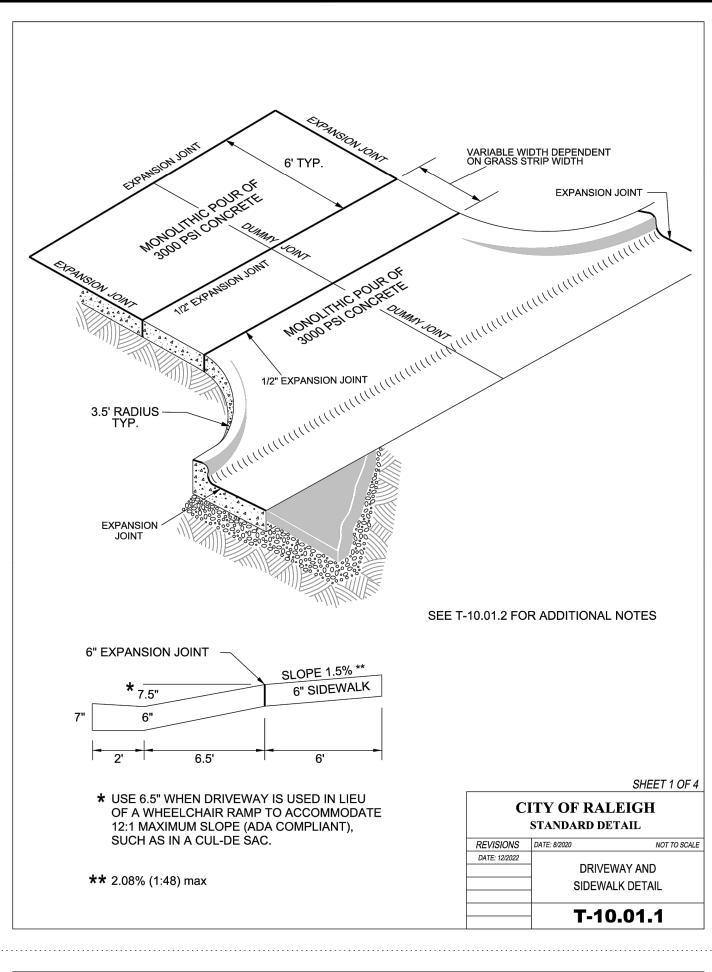

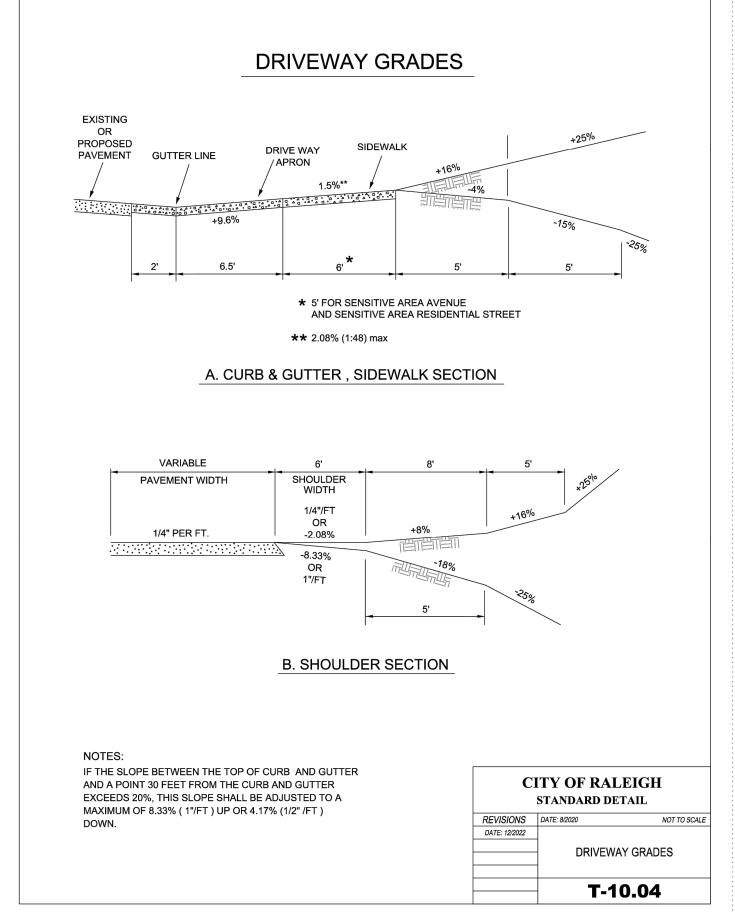

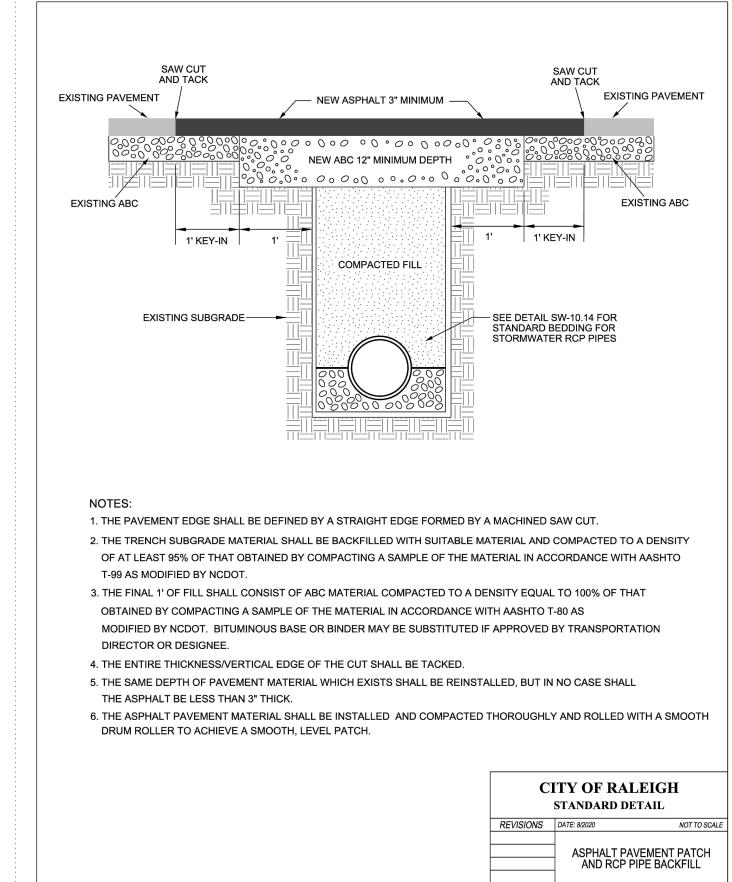


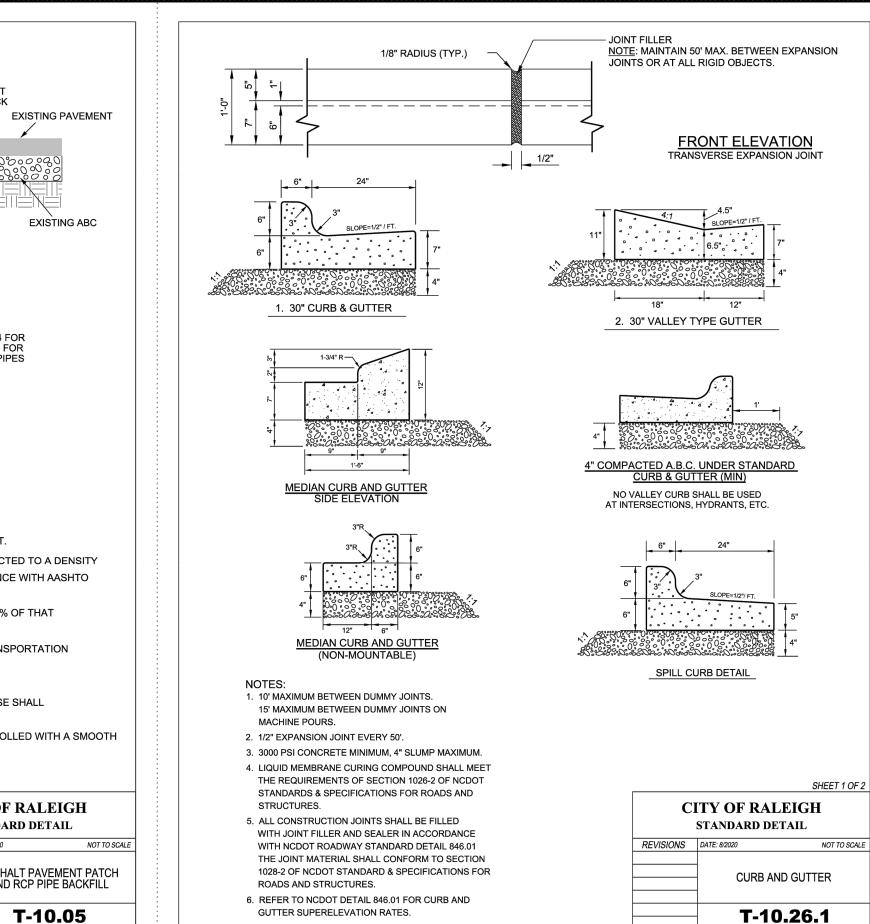


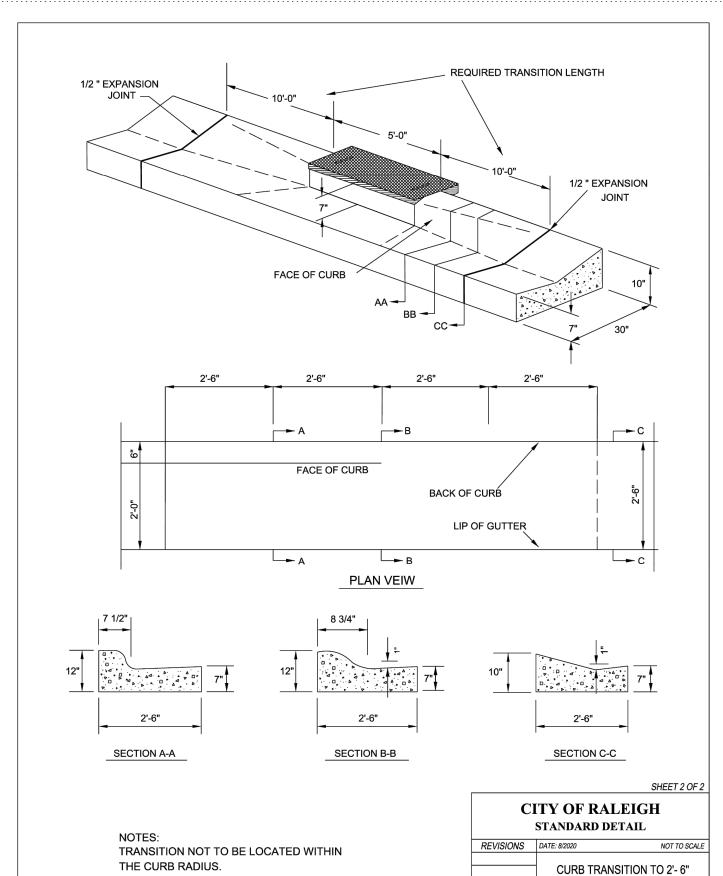

VALLEY GUTTER

T-10.26.2

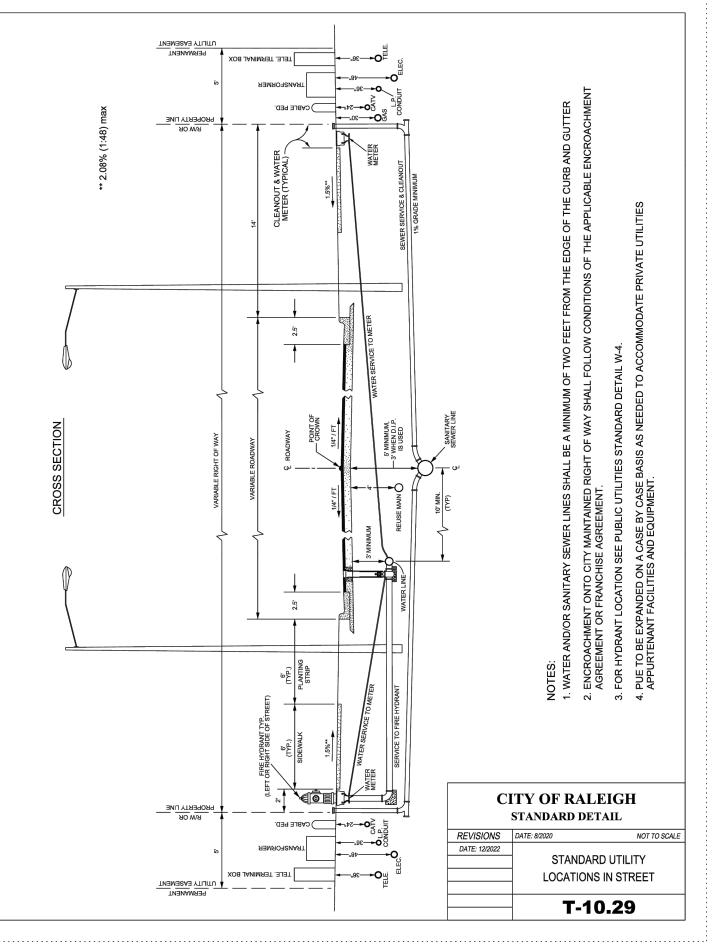

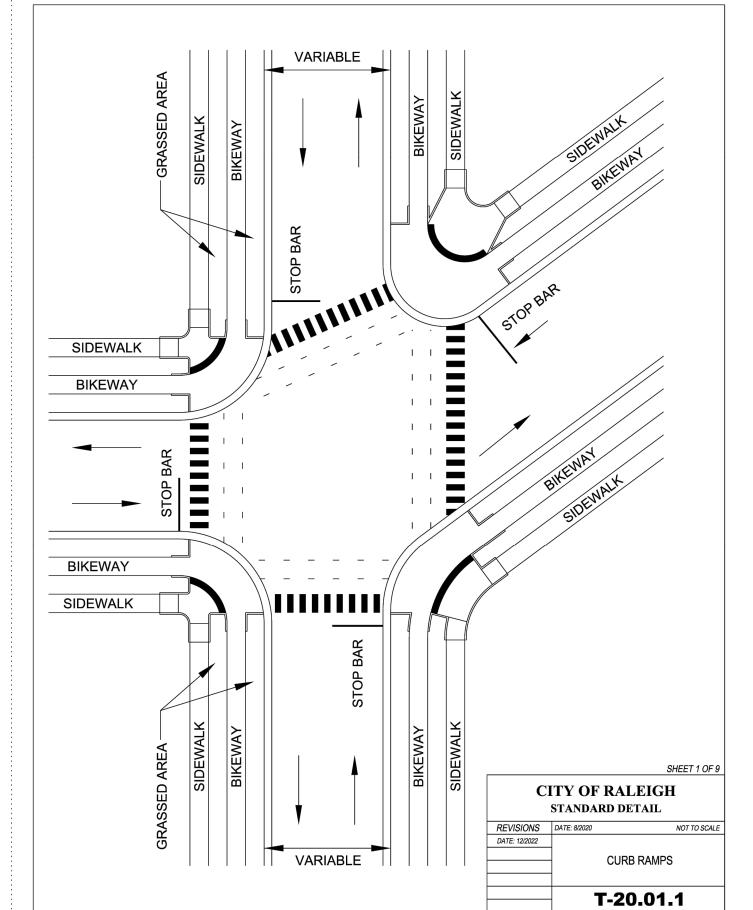



S

The John R. McAdams Company, Inc.


2905 Meridian Parkway Durham, NC 27713

phone 919. 361. 5000

fax 919. 361. 2269

license number: C-0293, C-187

www.mcadamsco.com

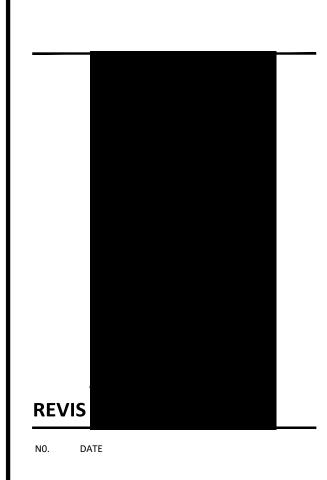

PLAN INFORMATION

PROJECT NO. RAL22005

FILENAME RAL22005-D1.DWG

CHECKED BY XXX

CHECKED BY XXX

DRAWN BY AAC


SCALE 1"=20'


DATE 12.06.2023


TITLE

TRANSPORTATION DETAILS

C8.01

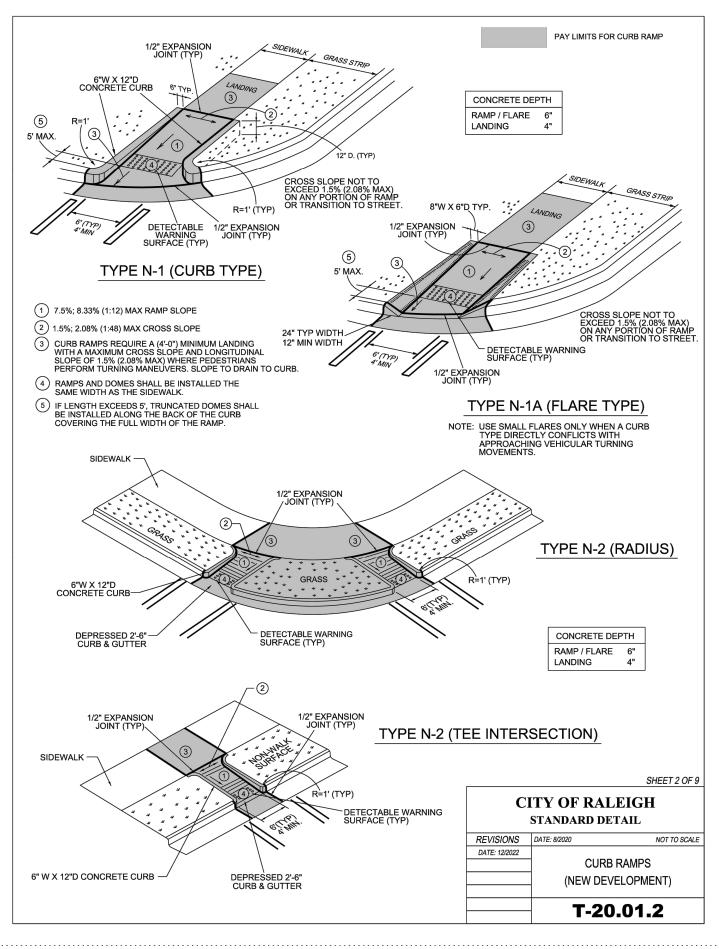

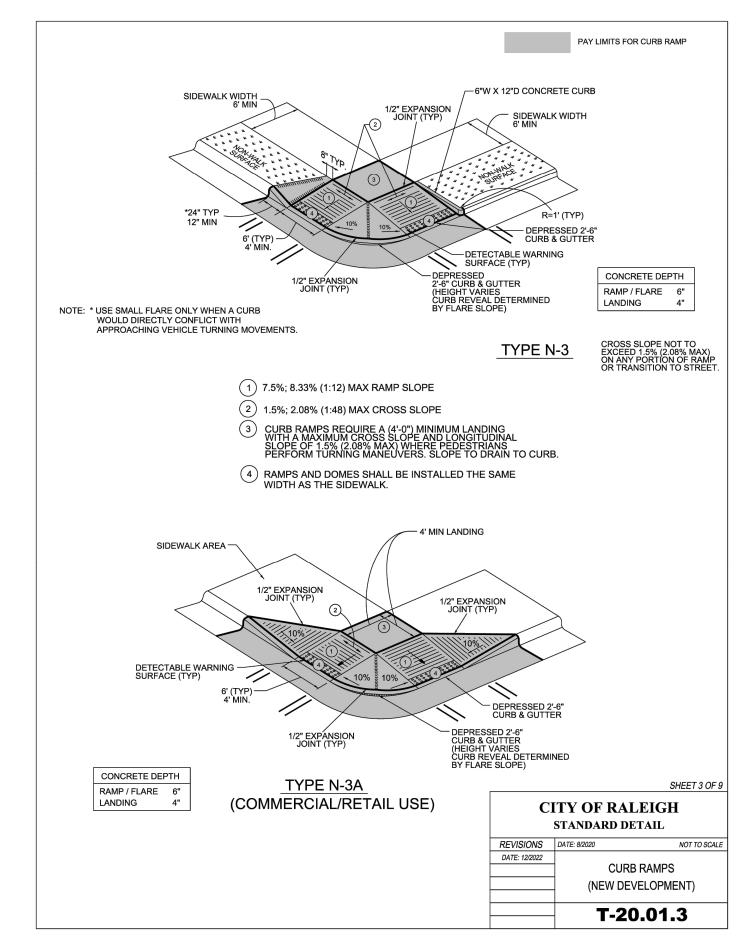


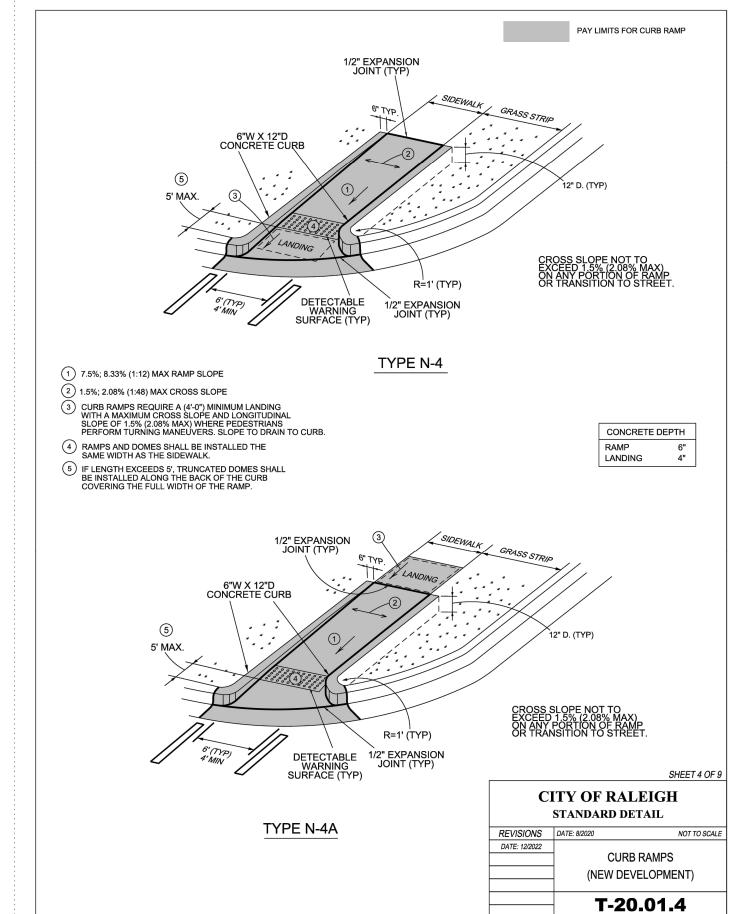


CITY OF RALEIGH CURB RAMPS GENERAL NOTES


- 1. CITY OF RALEIGH STANDARD CURB RAMPS HAVE BEEN DEVELOPED IN ACCORDANCE WITH THE AMERICANS WITH DISABILITIES ACT (ADA) AND PUBLIC RIGHT OF WAY ACCESS GUIDELINES (PROWAG).
- CURB RAMPS SHALL BE PROVIDED AT LOCATIONS AS SHOWN ON THE PLANS
 OR AS DIRECTED BY THE ENGINEER. SIDEWALK ACCESS RAMPS SHALL BE LOCATED AS
 INDICATED IN THE DETAIL, HOWEVER, THE LOCATION MAY BE ADJUSTED IN COORDINATION WITH
 THE CITY OF RALEIGH WHERE EXISTING LIGHT POLES, FIRE HYDRANTS, DROP INLETS, ETC. AFFECT
 PLACEMENT.
- 3. DOUBLE WHEELCHAIR RAMPS ARE TO BE INSTALLED AT ALL PUBLIC STREET INTERSECTIONS WHERE SIDEWALK IS REQUIRED.
- 4. THE WALKING SURFACE SHALL BE SLIP RESISTANT. THE COLOR FOR THE DETECTABLE WARNING AREA SHALL BE YELLOW FOR CONTRAST.
- 5. NO SLOPE ON THE SIDEWALK ACCESS RAMP SHALL EXCEED 1"/FT (12:1) IN RELATIONSHIP TO THE GRADE OF THE STREET.
- 6. IN NO CASE SHALL THE WIDTH OF THE SIDEWALK ACCESS RAMP BE LESS THAN 48" ALL RAMPS SHALL BE INSTALLED THE SAME WIDTH AS THE SIDEWALK.
- 7. USE CLASS A (3000 PSI) CONCRETE WITH A SIDEWALK FINISH IN ORDER TO OBTAIN A ROUGH NONSKID SURFACE.
- 8. A 1/2" EXPANSION JOINT INSTALLED FULL DEPTH WILL BE REQUIRED WHERE THE CONCRETE SIDEWALK ACCESS RAMP JOINS THE CURB AND ALSO WHERE NEW CONCRETE ABUTS EXISTING CONCRETE.
- 9. CURB RAMPS SHOULD BE PLACED PARALLEL TO THE DIRECTION OF TRAVEL.

	T-20	0.01.8
	CURB R	AMP NOTES
REVISIONS	DATE: 8/2020	NOT TO SC
	ITY OF RAI standard di	
		SHEET 8 OI

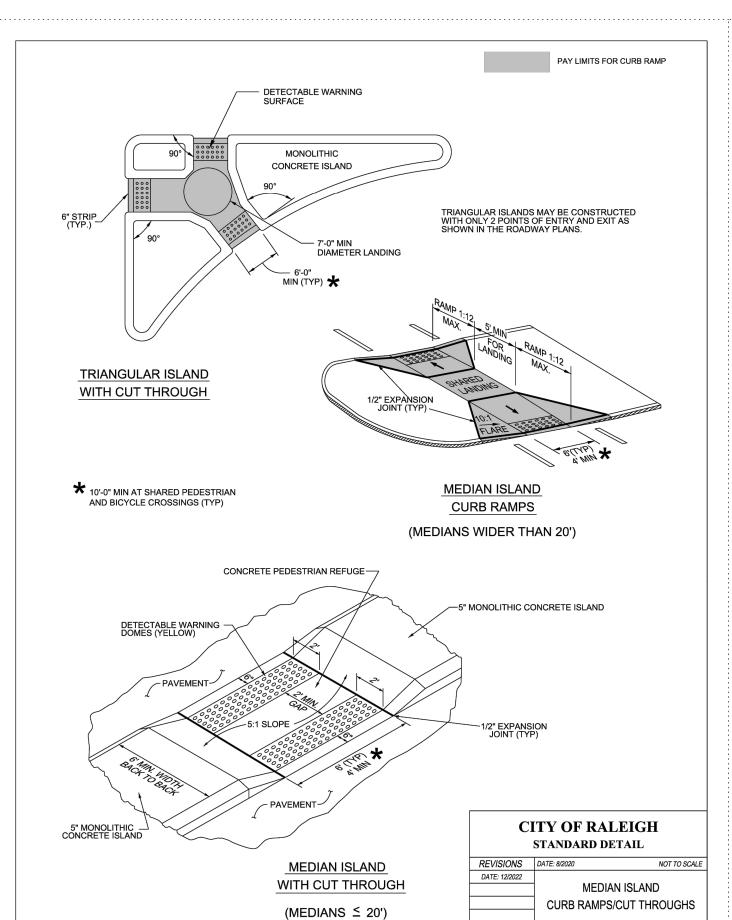

T-20.02

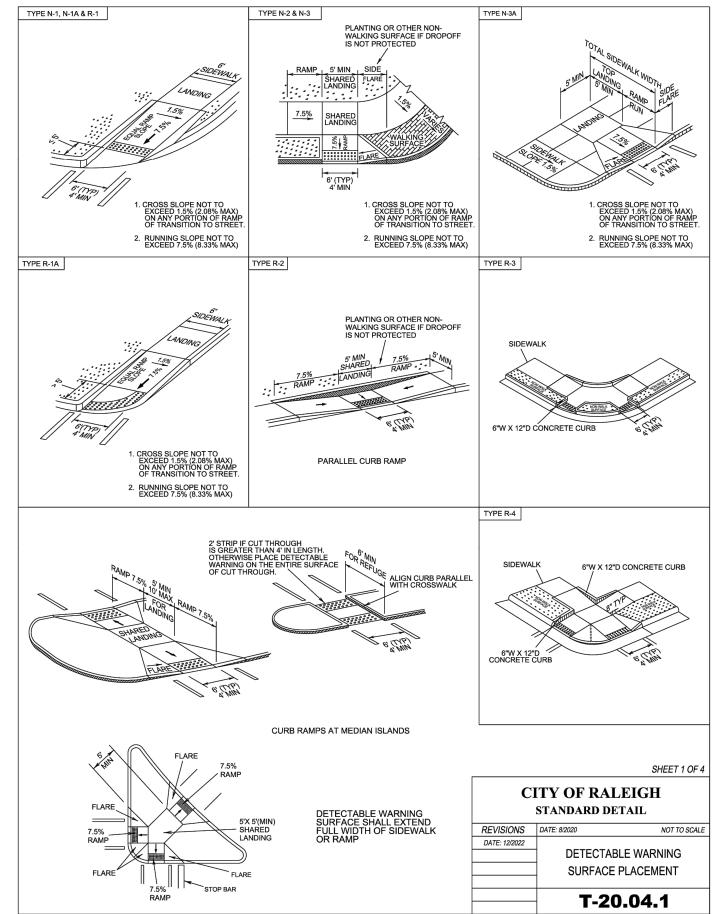

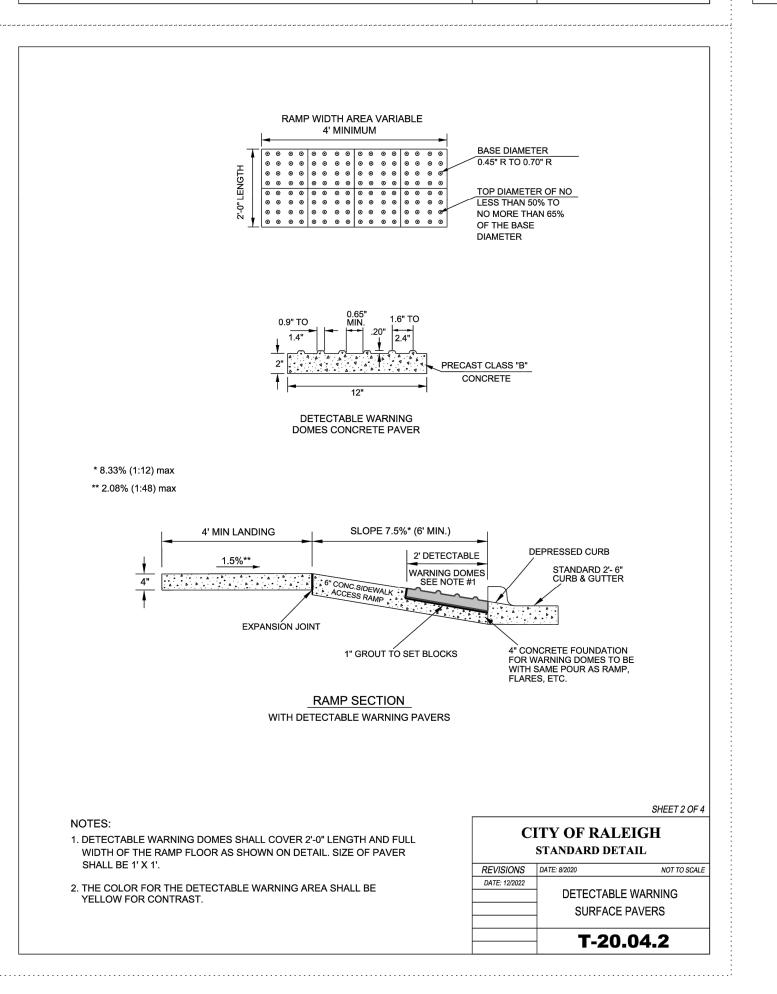



The John R. McAdams Company, Inc.


2905 Meridian Parkway Durham, NC 27713

phone 919. 361. 5000

fax 919. 361. 2269

license number: C-0293, C-187

www.mcadamsco.com

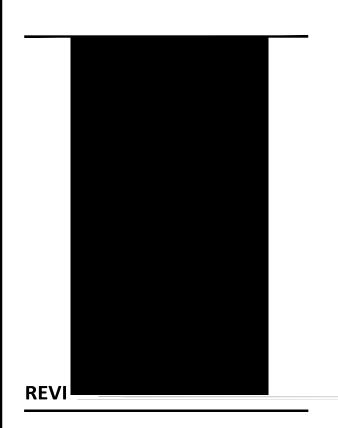

PLAN INFORMATION

PROJECT NO. RAL22005

FILENAME RAL22005-D1.DWG


CHECKED BY XXX


DRAWN BY AAC


DRAWN BY AAC
SCALE 1"=20'
DATE 12.06.2023


TITLE

TRANSPORTATION DETAILS

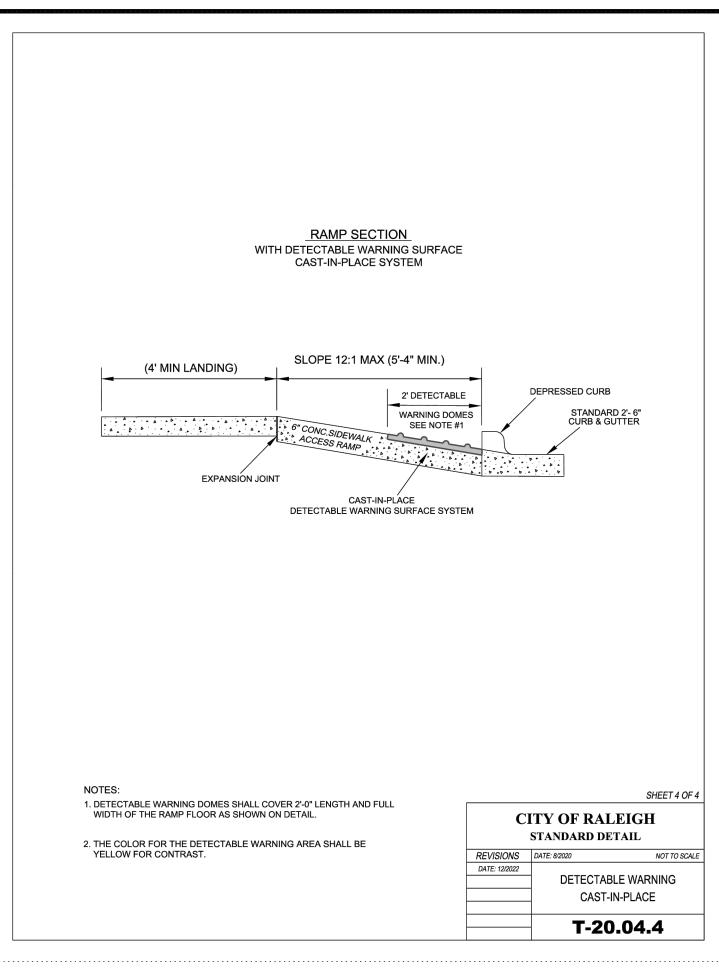

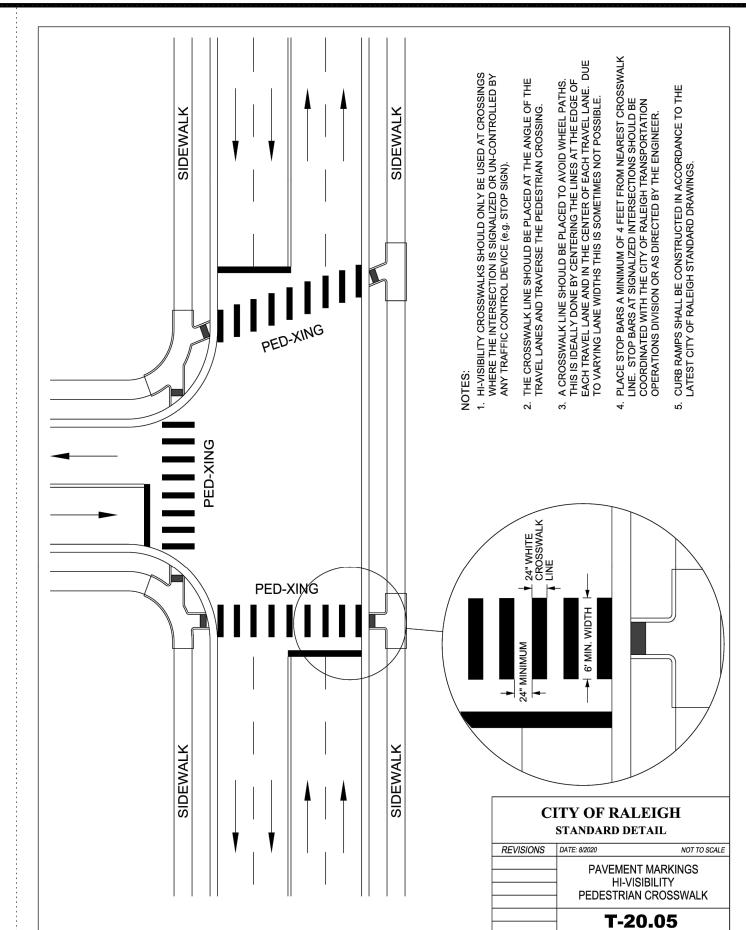

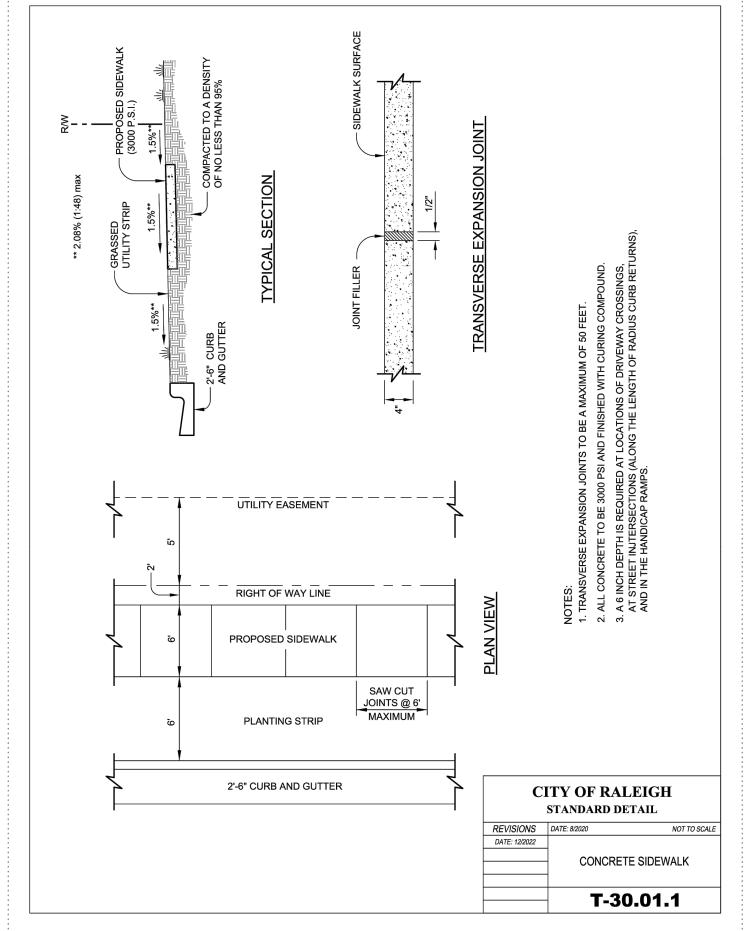

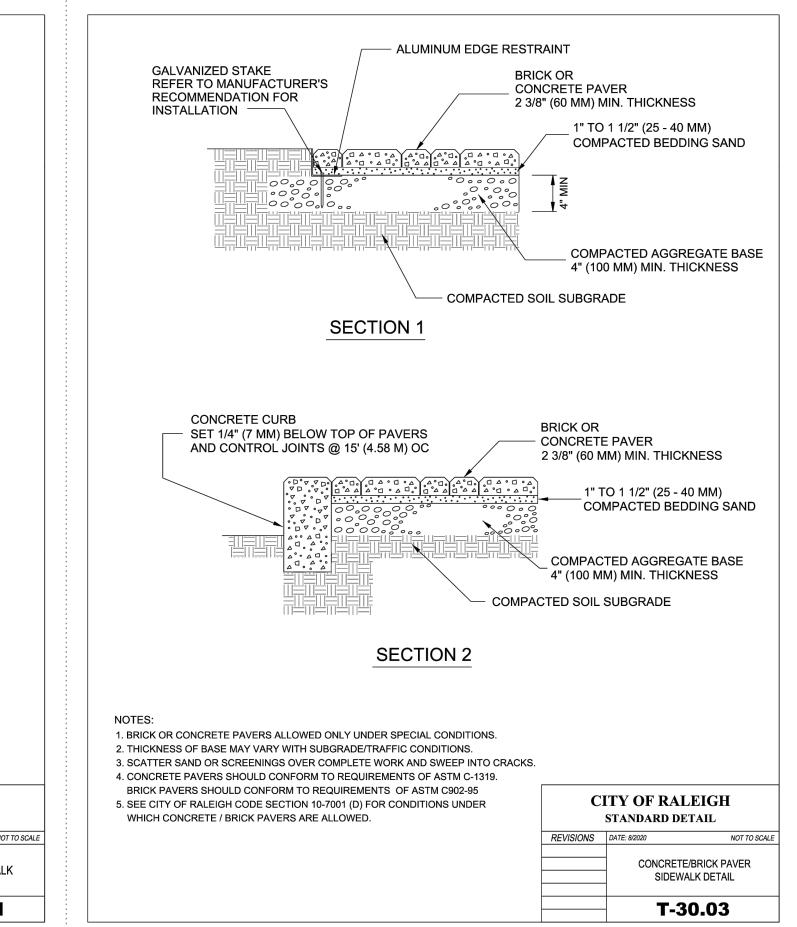



The John R. McAdams Company, Inc.


2905 Meridian Parkway

Durham, NC 27713

phone 919. 361. 5000

fax 919. 361. 2269 license number: C-0293, C-187

www.mcadamsco.com

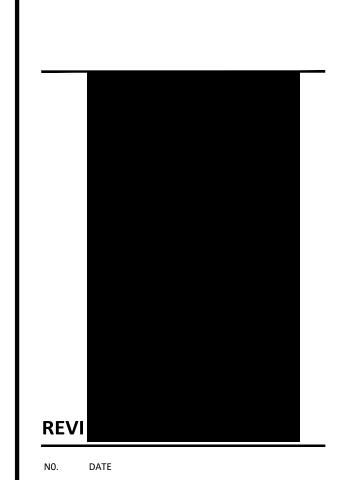

PLAN INFORMATION

PROJECT NO. RAI 22005

PROJECT NO. RAL22005

FILENAME RAL22005-D1.DWG

CHECKED BY XXX

CHECKED BY XXX

DRAWN BY AAC


SCALE 1"=20'


DATE 12.06.2023

TITLE


TRANSPORTATION

C8.03

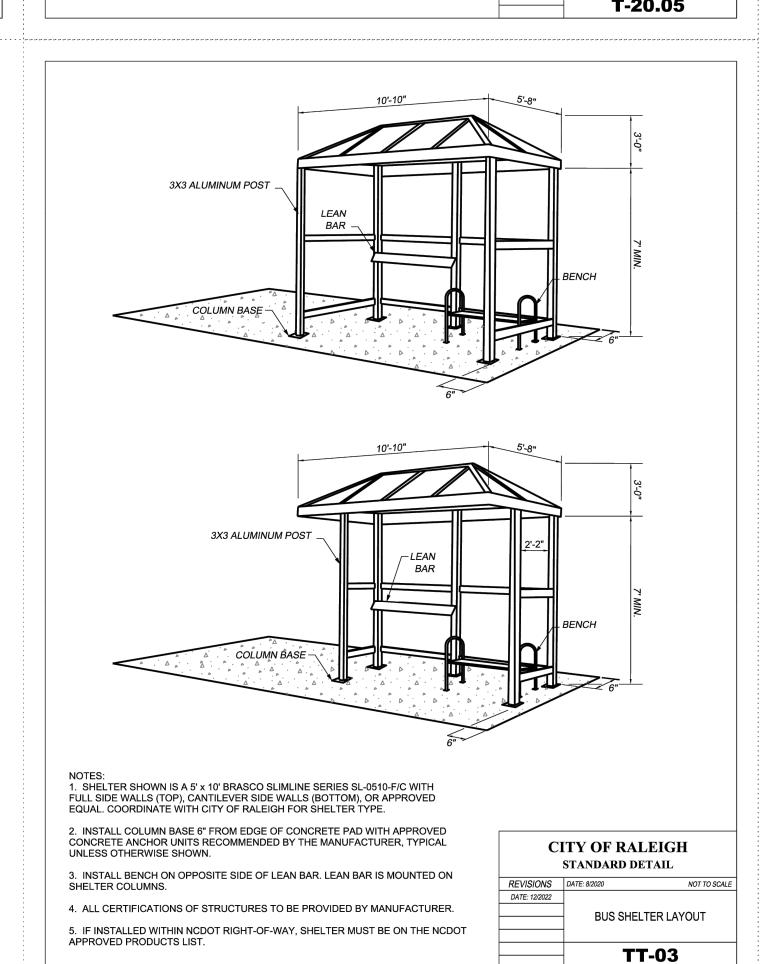

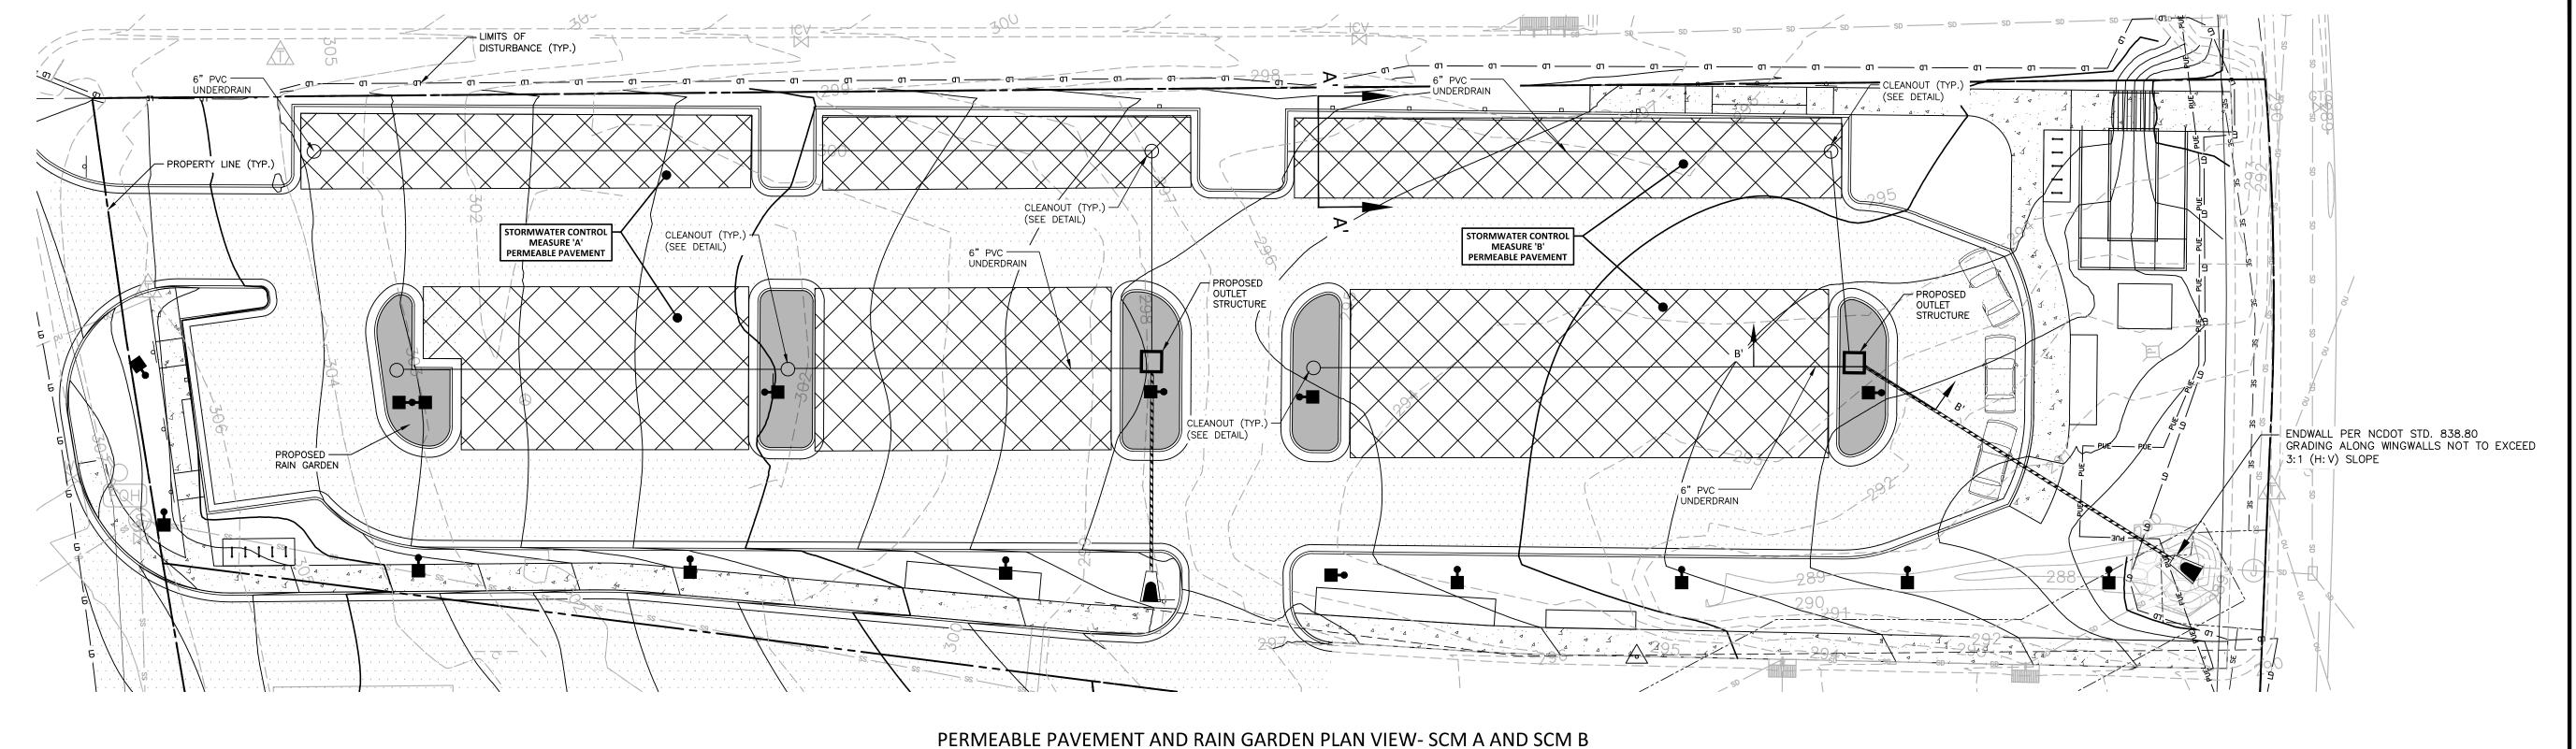

1" = 20'

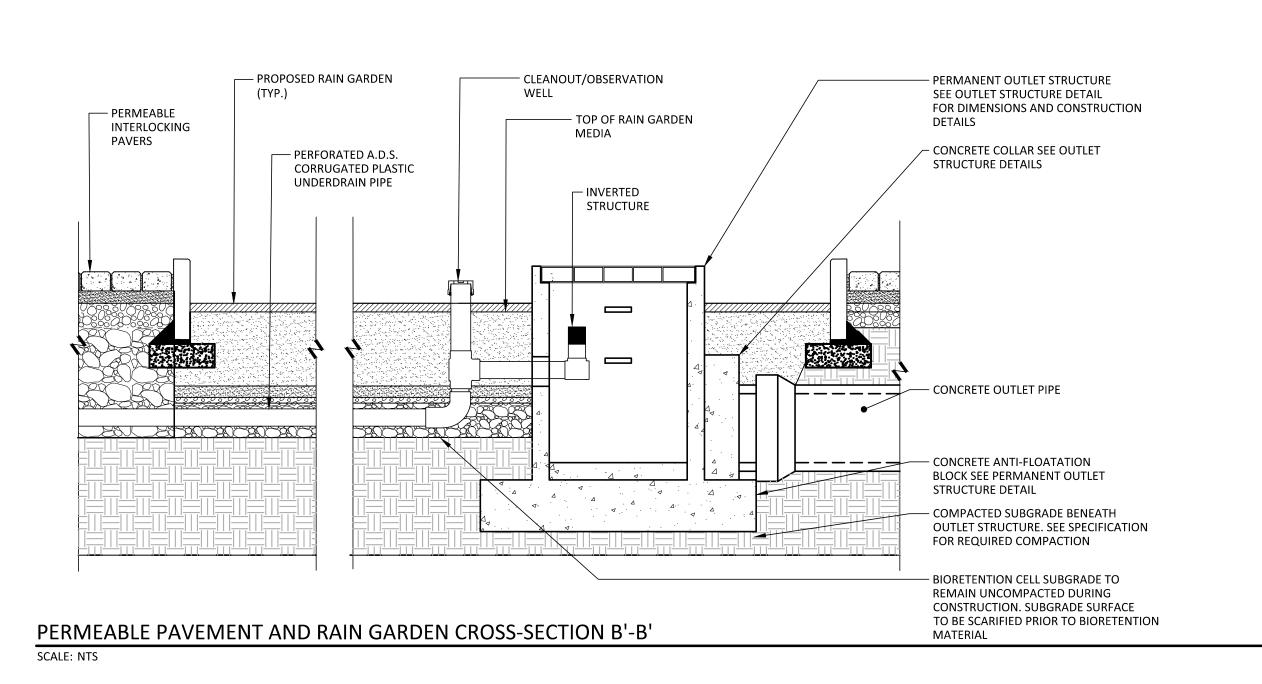

PERMEABLE PAVEMENT NOTES


- 1. CONTRACTOR TO INSTALL PERMEABLE PAVEMENT AFTER ASPHALT, CONCRETE, AND GRADING WORK IS COMPLETE AND THE CONTRIBUTING DRAINAGE AREA IS STABILIZED.
- 2. STONE SUBBASE AND BASE SHALL BE INSTALLED PRIOR TO OVERLAY OF PARKING. THE CONTRACTOR IS RESPONSIBLE TO PROTECT PERMEABLE PAVEMENT DURING OVERLAY PROCESS. DIG THE FINAL 9 TO 12 IN. BY USING THE TEETH OF THE EXCAVATOR BUCKET TO LOOSEN SOIL.
- 3. BEDDING COURSE PAVERS MAY NOT BE INSTALLED UNTIL UPSTREAM SURFACES ARE COMPLETE AND FULLY STABILIZED. PERMEABLE PAVEMENT AREAS SHALL BE IDENTIFIED AND SHALL NOT EXPERIENCE ANY LOADING BY VEHICLES FROM THE TIME THE SUBBASE IS EXCAVATED UNTIL FINAL PAVERS ARE PLACED. ADDITIONALLY, MINIMAL COMPACTION SHOULD BE PERFORMED ON THE SUBGRADE SOILS TO PRESERVE
- 4. ALL PLANT WASHED PERMEABLE PAVEMENT AGGREGATE (NO. 8, NO. 57, AND NO. 2) SHALL BE WASHED ONSITE PRIOR TO INSTALLATION. CONDUCT A DIRECT MEASUREMENT OF THE SOIL'S INFILTRATION RATE IMMEDIATELY AFTER EXCAVATION AND BEFORE THE AGGREGATE IS PLACED. INFILTRATION RATE TESTING SHALL BE CONDUCTED BY A SOIL SCIENTIST OR GEOTECHNICAL ENGINEER. IF THE SOIL INFILTRATION RATE IS LESS THAN 0.40 INCHES PER HOUR, THEN RIP OR TRENCH THE SUBGRADE FURTHER TO RESTORE THE ORIGINAL INFILTRATION RATE, AND RETEST.

INSPECTIONS AND CERTIFICATIONS NOTES

- 1. AN INFILTRATION TEST OF THE PERMEABLE PAVEMENT SURFACE SHALL BE CONDUCTED ONCE CONSTRUCTION IS COMPLETE AND THE RESULTS WILL BE PROVIDED TO THE CITY OF RALEIGH TO DEMONSTRATE COMPLIANCE WITH MINIMUM DESIGN CRITERIA.
- 1.1. TESTING THE PAVEMENT SURFACE PERMEABILITY SHOULD USE THE NCSU SIMPLE INFILTRATION TEST (SEE MAINTENANCE SECTION 18.6.4) OR OTHER APPROPRIATE TEST, SUCH AS ASTM C1701 STANDARD TEST METHOD FOR INFILTRATION RATE OF IN-PLACE PERVIOUS CONCRETE.

STATEMENT OF RESPONSIBILITY

ALL REQUIRED MAINTENANCE AND INSPECTIONS OF THIS FACILITY SHALL BE THE RESPONSIBILITY OF THE PROPERTY OWNER, PER THE EXECUTED OPERATION AND MAINTENANCE AGREEMENT FOR THIS FACILITY.

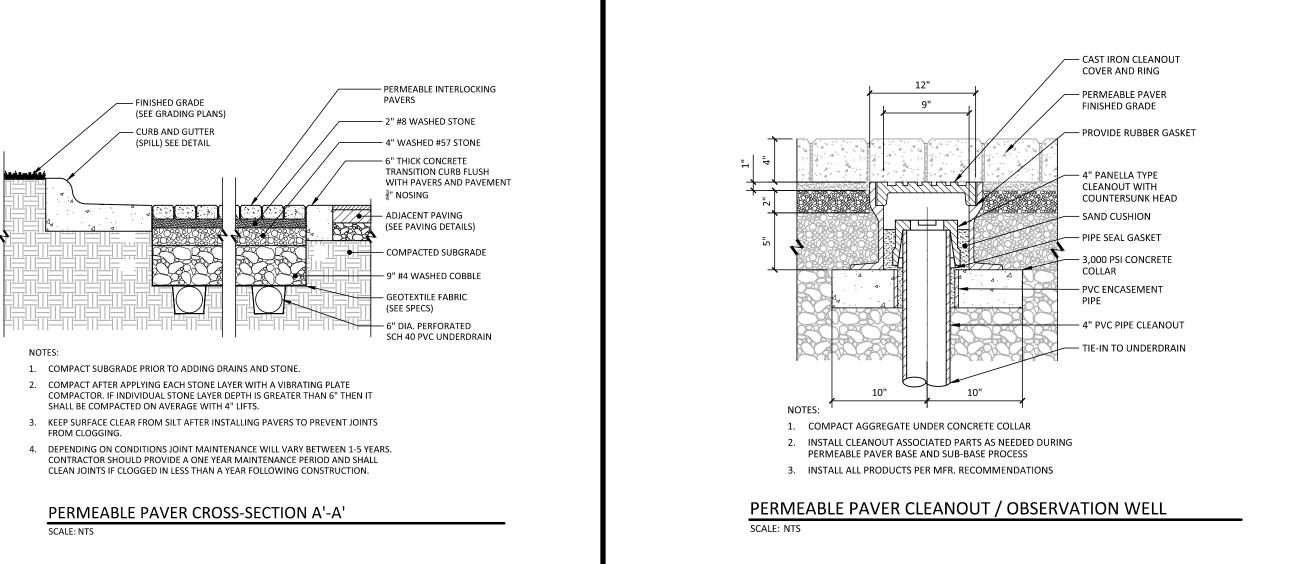

The John R. McAdams Company, Inc. 2905 Meridian Parkway Durham, NC 27713

fax 919. 361. 2269 license number: C-0293, C-187

phone 919. 361. 5000

www.mcadamsco.com

CLIENT



REVISIONS

NO. DATE

NO. DATE

PLAN INFORMATION

PROJECT NO. RAL22005 FILENAME PP AND RG.DWG CHECKED BY

DRAWN BY SCALE DATE 12.06.2023

TITLE

PRELIMINARY DRAWING - NOT RELEASED FOR CONSTRUCTION

SCM A AND SCM B