Administrative Site Review Application



Planning and Development Customer Service Center • One Exchange Plaza, Suite 400 | Raleigh, NC 27601 | 919-996-2500

This form is required when submitting site plans as referenced in Unified Development Ordinance (UDO) Section 10.2.8. Please check the appropriate building types and include the plan checklist document when submitting. Office Use Only: Case #: Planner (print): Please review UDO Section 10.2.8. to determine the site plan tier. If assistance determining a Site Plan Tier is needed a Site Plan Tier Verification request can be submitted online via the Permit and Development Portal. (Note: There is a fee for this verification service.) Site Plan Tier: Tier Two Site Plan Tier Three Site Plan **Building and Development Type Site Transaction History** (Check all that apply) Detached General Subdivision case #: Scoping/sketch plan case #: Attached Mixed use Certificate of Appropriateness #: Townhouse Civic Board of Adjustment #: Apartment Cottage Court Zoning Case #: Z-27B-2014 Tiny house Frequent Transit Design Alternate #: **Development Option** Open lot **GENERAL INFORMATION** Development name: GoRaleigh Operations and Maintenance Facility (Poole Rd) Expansion Yes V No Inside City limits? Property address(es): 4104 Poole Road, Raleigh, NC 27610 Site P.I.N.(s): 1723847317 Please describe the scope of work. Include any additions, expansions, and uses (UDO 6.1.4). Expansion of GoRaleigh's Poole Road Operations & Maintenance Facility to include an additional 11,241 sf of administrative office space and an additional 8,412 sf of maintenance space including 3 maintenance bays. Current Property Owner(s): City of Raleigh/ Richard L. Kelly, PE, Director of Engineering Services Company: Engineering Services Title: Director Address: PO Box 590, Raleigh, NC 27602-0590 Phone #: 919-996-5579 Email: richard.kelly@raleighnc.gov Applicant Name (If different from owner. See "who can apply" in instructions): Morven MacLean- WSP, Alex Shapiro- COR Relationship to owner: Lessee or contract purchaser Owner's authorized agent Easement holder Company: WSP USA Address: 434 Fayetteville Street, Suite 1500, Raleigh, NC 27601

Phone #: 919. 836. 4040	Email: morven.maclean@wsp.com; alexander.shapiro@raleighnc.gov		
NOTE: please attach purchase agreement or contract, lease or easement when submitting this form.			
Developer Contact:			
Company:		Title:	
Address:			
Phone #: Email:			
Applicant Name:			
Company:	Address:		
Phone #:	Email:		

DEVELOPMENT TYPE + SITE DATE TABLE (Applicable to all developments)		
SITE DATA	BUILDING DATA	
Zoning district(s) (please provide the acreage of each): IX-3 (22.87)	Existing gross floor area (not to be demolished): 82,937	
Gross site acreage: 22.87	Existing gross floor area to be demolished: 293	
# of parking spaces proposed: 0	New gross floor area: 19,653	
Max # parking permitted (7.1.2.C): No maximum	Total sf gross (to remain and new): 102,590	
Overlay District (if applicable): N/A	Proposed # of buildings: 2	
Existing use (UDO 6.1.4): Vehicle Repair (Commercial); Office	Proposed # of stories for each: 3 (Admin) - 1 (Maintenance)	
Proposed use (UDO 6.1.4): Vehicle Repair (Commercial); Office	Proposed # of basement levels (UDO 1.5.7.A.6)	

STORMWATER INFORMATION		
Imperious Area on Parcel(s): Existing (sf) 625,611 Proposed total (sf) 4,570	Impervious Area for Compliance (includes ROW):	
	Existing (sf) - Proposed total (sf) -	

RESIDENTIAL & OVERNIGHT LODGING DEVELOPMENTS			
Total # of dwelling units:			Total # of hotel bedrooms:
# of bedroom units: 1br _	2br	3br	4br or more
# of lots:			Is your project a cottage court? Yes No
			A frequent transit development? Yes No

Continue to Applicant Signature Block on Page 4.

APPLICANT SIGNATURE BLOCK

Pursuant to state law (N.C. Gen. Stat. § 160D-403(a)), applications for development approvals may be made by the landowner, a lessee or person holding an option or contract to purchase or lease land, or an authorized agent of the landowner. An easement holder may also apply for development approval for such development as is authorized by the easement.

Acting as an authorized agent requires written permission from the property owner for the purposes of making this development approval and/or permit application. Written permission from the property owner to act as an authorized agent must be made available to the City of Raleigh upon request.

By submitting this application, the undersigned applicant acknowledges that they are either the property owner or one of the persons authorized by state law (N.C.G.S. 160D-403(a)) to make this application, as specified in the application. The undersigned also acknowledges that the information and statements made in the application are correct and the undersigned understands that development approvals are subject to revocation for false statements or misrepresentations made in securing the development approval, pursuant to N.C. Gen. Stat. § 160D-403(f).

The undersigned indicates that the property owner(s) is aware of this application and that the proposed project described in this application will be maintained in all respects in accordance with the plans and specifications submitted herewith, and in accordance with the provisions and regulations of the City of Raleigh Unified Development Ordinance.

The undersigned hereby acknowledges that, pursuant to state law (N.C.G.S. 143-755(b1), if this permit application is placed on hold at the request of the applicant for a period of six consecutive months or more, or if the applicant fails to respond to comments or provide additional information requested by the City for a period of six consecutive months or more, then the application review is discontinued, and a new application is required to proceed and the development regulations in effect at the time permit processing is resumed shall apply to the new application.

- I girachack		
Signature:	Date: 11/1/2024	
Printed Name: Morven MacLean, VIce President, WSP USA Inc.		
Signature:	Date:	
Printed Name:		

1" = 2000'

GORALEIGH OPERATIONS AND MAINTENANCE FACILITY (POOLE ROAD) EXPANSION

SITE DATA		
PARCEL PIN NUMBER:		PIN 1723847317, REAL ESTATE ID: 0328912
EXISTING ZONING:		IX-3
OVERLAY DISTRICT:		N/A
WATERSHED:		NEUSE RIVER BASIN
FLOODPLAIN/FIRM PAI	NEL:	3720172300K
PROJECT AREA:		22.87 AC
EXISTING USE:		VEHICLE REPAIR (COMMERCIAL); OFFICE
PROPOSED USE:		VEHICLE REPAIR (COMMERCIAL); OFFICE
VEHICLE PARKING:	MAXIMUM	OFFICE: MAX 1 VEHICLE PER 200 SF OF GROSS FLOOR AREA VEHICLE SERVICE: NO MAXIMUM
	EXISTING	229 SPACES
	REMOVED	3 SPACES
	PROPOSED	0 SPACES
	TOTAL	226 SPACES
ACCESSIBLE PARKING:	REQUIRED	7 SPACES (2 VAN)
	EXISTING	8 SPACES (2 VAN)
	REMOVED	1 SPACE
	PROPOSED	0 SPACES
	TOTAL	7 SPACES (2 VAN)
BIKE PARKING:	MINIMUM	OFFICE SHORT-TERM: 4 SPACES LONG-TERM: 4 SPACES VEHICLE SERVICE SHORT-TERM: NONE LONG-TERM: NONE
	EXISTING	4 SHORT-TERM SPACES
	REMOVED	4 SHORT-TERM SPACES
	PROPOSED	8 SPACES (4 SHORT-TERM, 4 LONG-TERM)
	TOTAL	8 SPACES (4 SHORT-TERM, 4 LONG-TERM)
BUILDING HEIGHT:	MAXIMUM	3 STORIES OR 50'
	PROPOSED	ADMIN: 3-STORIES MAINTENANCE: 1-STORY
TREE CONSERVATION:	REQUIRED	MIN 10% SITE AREA (2.29 AC)
	EXISTING	2.54 AC
DISTURBED AREA	0.82 AC (35,537 SF)	

4104 POOLE ROAD RALEIGH, NC 27610

ADMINISTRATIVE SITE REVIEW

CITY OF RALEIGH ASR CASE #: ASR-XXXX-XXXX

PROJECT NUMBER: WSP24001 DATE: NOVEMBER 1, 2024

ZONING NOTES:

DEVELOPMENT AND DESIGN SHALL BE IN ACCORDANCE WITH THE CONDITIONS LISTED IN THE CITY OF RALEIGH APPROVED ORDINANCE REZONING CONDITIONS LISTED IN THE APPROVED ORDINANCE ADOPTED BY COUNCIL NOVEMBER 17, 2015, REZONING CASE #Z-27(B)-14.

GENERAL NOTES:

Administrative Site Review Application

Site Plan Tier: Tier Two Site Plan 🗸 Tier Three Site Plan 🗌

Frequent Transit

roperty address(es): 4104 Poole Road, Raleigh, NC 27610

Office Use Only: Case #: ___

Open lot

Site P.I.N.(s): 1723847317

Company: Engineering Services

Address: PO Box 590, Raleigh, NC 27602-0590

is form is required when submitting site plans as referenced in Unified Development Ordinance (UDO) Section

Planner (print):

Please review UDO Section 10.2.8. to determine the site plan tier. If assistance determining a Site Plan Tier is needed a Site Plan Tier Verification request can be submitted online via the Permit and Development Portal. (Note: There is a fee for this verification service.)

GENERAL INFORMATION

Expansion of GoRaleigh's Poole Road Operations & Maintenance Facility to include an additional

Current Property Owner(s): City of Raleigh/ Richard L. Kelly, PE, Director of Engineering Services

Applicant Name (If different from owner. See "who can apply" in instructions): Morven MacLean- WSP, Alex Shapiro- COR

Relationship to owner: Lessee or contract purchaser Owner's authorized agent Easement holder

Title: Director

Address: 434 Fayetteville Street, Suite 1500, Raleigh, NC 27601

Email: richard.kelly@raleighnc.gov

evelopment name: GoRaleigh Operations and Maintenance Facility (Poole Rd) Expansion

Please describe the scope of work. Include any additions, expansions, and uses (UDO 6.1.4)

Subdivision case #:

Certificate of Appropriateness #:

Board of Adjustment #: _____ Zoning Case #: Z-27B-2014

0.2.8. Please check the appropriate building types and include the plan checklist document when submitting.

BLOCK PERIMETER: PER UDO SECTION 8.3.2.A.1.B. IX: THE BLOCK PERIMETER MAXIMUMS SHALL NOT BE REQUIRED WHEN THE FOLLOWING CONDITIONS ARE MET: THE PROPERTY TO BE DEVELOPED OR THE ADJACENT PROPERTY TO WHICH ANY NEW STREET OR STUB STREET TO BE CONTINUED CONTAINS ONE OR MORE OF THE FOLLOWING LAND-USES: HISTORIC LANDMARK, CEMETERY, LANDFILL, HOSPITAL, SCHOOL (PUBLIC OR PRIVATE (K-12)), COLLEGE, COMMUNITY COLLEGE, UNIVERSITY, PLACES OF WORSHIP, POLICE STATION, FIRE STATION, EMS STATION, PRISON OR ANY RESIDENTIAL USE IN AN ATTACHED. TINY HOUSE, OR DETACHED BUILDING TYPE ON LOTS NO LARGER THAN 2 ACRES. SINCE THE ADJACENT PROPERTIES WHERE A STREET OR STUB WOULD CONNECT TO ARE PART OF THE NORTH CAROLINA STATE UNIVERSITY VETERINARY SCHOOL CAMPUS, THIS PROPERTY WOULD BE EXEMPT FROM THE REQUIREMENTS.

Email: morven.maclean@wsp.com; alexander.shapiro@raleighnc.gov

NOTE: please attach purchase agreement or contract, lease or easement when submitting this form.

DEVELOPMENT TYPE + SITE DATE TABLE

Existing use (UDO 6.1.4): Vehicle Repair (Commercial); Office Proposed # of stories for each: 3 (Admin) - 1 (Mainter

Continue to Applicant Signature Block on Page 4.

Proposed use (UDO 6.1.4): Vehicle Repair (Commercial); Office | Proposed # of basement levels (UDO 1.5.7.A.6)

Proposed # of buildings: 2

Existing (sf) -

4br or more

Impervious Area for Compliance

Is your project a cottage court? Yes No A frequent transit development? Yes No

Phone #: 919. 836. 4040

IX-3 (22.87)

Gross site acreage: 22.87

Max # parking permitted (7.1.2.C): No maximum

overlay District (if applicable): N/A

Imperious Area on Parcel(s):

ATTENTION CONTRACTORS

The Construction Contractor responsible for the extension of water, sewer, and/or reuse, as approved in these plans, is responsible for contacting the Public Works Department at (919) 996-2409, and the **Public Utilities Department** at (919) 996-4540 at least twenty four hours prior to beginning any of their construction.

Failure to notify both City Departments in advance of beginning construction, will result in the issuance of monetary fines, and require reinstallation of any water or sewer facilities not inspected as a result of this notification failure.

Failure to call for Inspection, Install a Downstream Plug, have Permitted Plans on the Jobsite, or any other Violation of City of Raleigh Standards will result in a Fine and Possible Exclusion from future work in the City of Raleigh.

Date: 11/1/2024

Pursuant to state law (N.C. Gen. Stat. § 160D-403(a)), applications for development approvals may be made by the landowner, a lessee or person holding an option or contract to purchase or lease land, or an authorized agent of the landowner. An easement holder may also apply for development approval for such development as is authorized by the easement.

By submitting this application, the undersigned applicant acknowledges that they are either the property owner or one of the persons authorized by state law (N.C.G.S. 160D-403(a)) to make this application, as specified in the application. The undersigned also acknowledges that the information and statements made in the application are correct and the undersigned understands that development approvals are subject to revocation for false statements or misrepresentations made in securing the development approval, pursuant to N.C. Gen. Stat. § 160D-403(f).

described in this application will be maintained in all respects in accordance with the plans and specifica submitted herewith, and in accordance with the provisions and regulations of the City of Raleigh Unified

The undersigned hereby acknowledges that, pursuant to state law (N.C.G.S. 143-755(b1), if this permit application is placed on hold at the request of the applicant for a period of six consecutive months or more, or if the applicant falls to respond to comments or provide additional information requested by the City for a period of six consecutive months or more, then the application reviews is discontinued, and a new application is required to proceed and the development regulations in effect at the time permit processing is resumed shall apply to the previously first the contraction.

apply to the new application.

MgMacLan

Printed Name: Morven MacLean, Vice President, WSP USA Inc.

C0.00	COVER SHEET
C0.01	PROJECT NOTES
C1.00	EXISTING CONDITIONS
C1.01	DEMOLITION PLAN - ADMIN & OPS
C1.02	DEMOLITION PLAN - MAINTENANCE
C2.00	SITE PLAN - ADMIN & OPS
C2.01	SITE PLAN - MAINTENANCE
C3.00	GRADING PLAN - ADMIN & OPS
C3.01	GRADING PLAN - MAINTENANCE
C4.00	UTILITY PLAN - ADMIN & OPS
C4.01	UTILITY PLAN - MAINTENANCE
C8.00	SITE DETAILS
C8.01	STORM DRAINAGE DETAILS
C8.02	STORM DRAINAGE DETAILS
C8.03	SEWER DETAILS
C9.00	SCM A PLAN
C9 N1	SCM A DETAILS

ADDITIONAL SHEETS FROM OTHERS

SITE LIGHTING PLAN

L1.00	OVERALL SITE PLAN
L1.01	PLANTING PLAN
L1.02	PLANTING DETAILS
A201A	ADMIN BUILDING ELEVATIONS ASR
A201B	ADMIN BUILDING ELEVATIONS ASR
A201C	ADMIN BUILDING ELEVATIONS ASR
A211A	MAINTENANCE BUILDING ELEVATIONS A
A211B	MAINTENANCE BUILDING ELEVATIONS A
A211C	MAINTENANCE BUILDING ELEVATIONS A



CONTRACTOR SHALL NOTIFY "NC811" (811) OR (1-800-632-4949) AT LEAST 3 FULL BUSINESS DAYS PRIOR TO BEGINNING CONSTRUCTION OR EXCAVATION TO HAVE EXISTING UTILITIES LOCATED. CONTRACTOR SHALL CONTACT ANY LOCAL UTILITIES THAT PROVIDE THEIR OWN LOCATOR SERVICES INDEPENDENT OF "NC811". REPORT ANY DISCREPANCIES TO THE ENGINEER IMMEDIATELY.

> ALL CONSTRUCTION SHALL BE IN ACCORDANCE WITH THE CURRENT CITY OF RALEIGH AND NCDOT ENGINEERING DESIGN AND CONSTRUCTION STANDARDS

Call before you dig.

ALL PRODUCTS PROVIDED ON THIS PROJECT MUST BE MANUFACTURED IN COMPLIANCE WITH THE BUY AMERICA PROGRAM FOR FEDERALLY FUNDED TRANSPORTATION PROJECTS PER CODE OF FEDERAL REGULATIONS 49 CFR 661 THESE REQUIREMENTS ARE DISTINCT AND DIFFERENT FROM

PRELIMINARY DRAWING - NOT RELEASED FOR CONSTRUCTION

BUY AMERICA PROGRAM REQUIREMENTS

THOSE OF THE BUY AMERICAN ACT OF 1933.

PROFESSIONAL SEAL

SHEET NAME **COVER SHEET**

DESIGNED BY: DRAWN BY **CHECKED BY** 11. 01. 2024

FULL SCALE SHEET SIZE= ANSI- D (22"x 34")

Administrative Site Review

The landowner (holder of the title in fee simple);

Mailed Notification Process (if applicable):

Mail or deliver notification letters to:

about the mailed notification requirements.

ATTN: Jeff Caines

. A lessee or person holding an option or contract to purchase or lease land

What to Submit:

Administrative Site Review Checklist Administrative Site Review Application
One digital copy of proposed plans and supporting documents.

One digital copy of proposed plans and supporting documents

o Original plans scanned to scale, in sequential order

o To engineering scale, example: 1"=20', 1"=100'

An authorized agent of the landowner; or
• An easement holder, for such development as is authorized by the easement.

Please review the Development Fee Schedule to estimate your fees. Payments can be made:

Email all documents with your ASR plans to SiteReview@raleighnc.gov.

(UDO) provisions are applicable in the review and approval of a site plan application. The Administrative Site Review (ASR) review process is for site plans that qualify as either a Tier Two or Tier Three Site Plan as specified in UDO Section 10.2.8.

Tier One Site Plans are reviewed under the Non-Residential Permit review process.
 If assistance determining a Site Plan Tier is needed a Site Plan Tier Verification request can be submitted onlin via the Permit and Development Portal. Please note you will need a registered account to submit an online portequest. There is also a fee for this verification services.

Note: Applicants seeking to revise an already approved site plan must follow the "Modifications to an Approved Site Plan"

In accordance with state law (N.C.G.S. § 160D-403(a)), applications for site plan approvals may be made by the following individuals:

Per UDO Section 10.2.8.D.1.d and 10.2.1.C, packaged Administrative Site Review (ASR) notifications letters must

be provided to the City of Raleigh prior to the approval the development plan. Please package and mail letters once an ASR case number has been assigned to the development. See UDO Section 10.2.1.C.1.c for information

· See the Mailed Notification Requirement section of the Administrative Site Review webpage for additional instructions

Online via the Permit and Development Portal (you must be a registered user) Over the phone via the Customer Service Center (919-996-2500)

Questions? We're here to help! Contact the Planning and Development Customer Service Center at 919-996-2500 or

Fees for Site Plans are based on the project scope as defined in the Development Fee Schedule. (Please note: The Site Plan Tier and the Site Plan Level defined in the fee schedule are independent of one another.)

Submittal Instructions

WARNING: THESE DRAWINGS THE PROPERTY OF THE RIGHEER SHALL AFFIX TO THEIR THE NOTATION OF THE ALTERATION OF A LICENSED ARCHITECT OR ENGINEER SHALL AFFIX TO THEIR THE NOTATION OF THE ALTERATION OF THE ALTERATION OF THE NOTATION OF THE LAW FOR ANY PERSON, UNLESS ACTING UNDER THE DIRECT OR ENGINEER SHALL AFFIX TO THEIR THE NOTATION OF THE ARCHITECT OR ENGINEER SHALL AFFIX TO THEIR THE NOTATION OF THE ALTERATION OF THE NOTATION OF THE LAW FOR ANY PERSON, UNLESS ACTING UNDER THE DIRECT OR ENGINEER SHALL AFFIX TO THEIR THE NOTATION OF THE ALTERATION OF THE ARCHITECT OR ENGINEER SHALL AFFIX TO THEIR THE NOTATION OF THE ARCHITECT OR ENGINEER SHALL AFFIX TO THEIR THE NOTATION OF THE ALTERATION OF THE ARCHITECT OR ENGINEER SHALL AFFIX TO THEIR THE NOTATION OF THE ALTERATION OF THE ARCHITECT OR ENGINEER SHALL AFFIX TO THEIR THE NOTATION OF THE ARCHITECT OR ENGINEER SHALL AFFIX TO THEIR THE NOTATION OF THE ARCHITECT OR ENGINEER SHALL AFFIX TO THEIR THE NOTATION OF THE ARCHITECT OR ENGINEER SHALL AFFIX TO THEIR THE NOTATION OF THE ARCHITECT OR ENGINEER SHALL AFFIX TO THE NOTATION OF THE ARCHITECT OR ENGINEER SHALL AFFIX TO THE NOTATION OF THE ARCHITECT OR ENGINEER SHALL AFFIX TO THE NOTATION OF THE ARCHITECT OR ENGINEER SHALL AFFIX TO THE NOTATION OF THE ARCHITECT OR ENGINEER SHALL AFFIX TO THE NOTATION OF THE ARCHITECT OR ENGINEER SHALL AFFIX TO THE NOTATION OF THE ARCHITECT OR ENGINEER SHALL AFFIX TO THE NOTATION OF THE ARCHITECT OR ENGINEER SHALL AFFIX TO THE NOTATION OF THE ARCHITECT OR ENGINEER SHALL AFFIX TO THE NOTATION OF THE ARCHITECT OR ENGINEER SHALL AFFIX TO THE NOTATION OF THE ARCHITECT OR ENGINEER SHALL AFFIX TO THE NOTATION OF THE ARCHITECT OR ENGINEER SHALL AFFIX TO THE ARCHITECT OR ENGINEER SHALL AFFIX T

- 3. PRIOR TO START OF WORK, A PRE CONSTRUCTION MEETING MUST BE SETUP WITH THE CONTRACTOR AND THE CITY OF RALEIGH TRANSPORTATION FIELD SERVICES STAFF. CONTACT ENGINEERING INSPECTIONS AT 919-996-2409 TO SET UP THE MEETING.
- 4. THE CONTRACTOR SHALL OBTAIN A RIGHT-OF-WAY OBSTRUCTION PERMIT FOR ANY WORK WHICH REQUIRES THE TEMPORARY CLOSURE OF A STREET, TRAVEL LANE, PARKING SPACE OR SIDEWALK FROM RIGHT-OF-WAY SERVICES AT LEAST 48 HOURS IN
- 5. A TEMPORARY STREET CLOSURE REQUEST MUST BE SUBMITTED AT LEAST A MINIMUM OF TWO WEEKS PRIOR TO THE START OF WORK. SEE "RIGHT-OF-WAY CLOSURES" ON WWW.RALEIGHNC.GOV. SEND THE RIGHT-OF-WAY OBSTRUCTION PERMIT REQUEST TO RIGHTOFWAYSERVICES@RALEIGHNC.GOV.
- 6. THE CONTRACTOR SHALL HAVE A COMPLETE SET OF CONTRACT DOCUMENTS AS WELL AS ALL PERMITS, APPROVALS AND EASEMENTS ON THE JOB SITE AT ALL TIMES.
- 7. THE CONTRACTOR SHALL REPAIR ALL DAMAGED DRIVEWAYS, DRIVEWAY PIPES, CURB AND GUTTER, SIDEWALKS AND STREETS TO EXISTING CONDITION OR BETTER.
- 8. SIDEWALKS MUST BE ACCESSIBLE TO PERSONS WHO ARE VISUALLY IMPAIRED AND PEOPLE WITH MOBILITY DISABILITIES. EXISTING PEDESTRIAN ROUTES AND ALTERNATE PEDESTRIAN ROUTES, DURING CONSTRUCTION, WILL BE REQUIRED TO BE COMPLIANT WITH THE PUBLIC RIGHTS OF WAY ACCESSIBILITY GUIDELINES (PROWAG), 2010 ADA STANDARDS FOR ACCESSIBLE DESIGN AND THE MANUAL ON UNIFORM TRAFFIC CONTROL DEVICES (MUTCD).

PAVEMENT MARKING NOTES

- 1. ALL PAVEMENT MARKINGS SHOWN IN THESE PLANS FOR CITY OF RALEIGH MAINTAINED STREETS ARE SUBJECT TO FINAL APPROVAL FROM PUBLIC WORKS TRANSPORTATION OPERATIONS DIVISION. CONTRACTOR SHALL CONTACT TRANSPORTATION OPERATIONS AT 919-996-3030 FOR COORDINATION AND FINAL APPROVAL PRIOR TO PLACEMENT OF ANY PAVEMENT MARKINGS. MARKINGS WITHIN NCDOT RIGHT-OF-WAYS SHALL BE IN COMPLIANCE WITH NCDOT STANDARDS AND SPECIFICATIONS.
- 2. ALL SIGNS & PAVEMENT MARKINGS ASSOCIATED WITH THE PUBLIC STREET SYSTEM WILL REQUIRE APPROVAL BY CITY COUNCIL TO BE ORDINANCED FOR ENFORCEMENT.
- 3. ALL PAVEMENT MARKINGS SHALL BE PLACED PER THE NCDOT DIVISION 12 STANDARD DETAILS, BICYCLE LANE MARKINGS SHALL BE PLACED PER CITY OF RALEIGH STANDARD BICYCLE FACILITIES DETAILS.

CITY OF RALEIGH PUBLIC UTILITIES STANDARD NOTES (AS APPLICABLE)

- 1. ALL MATERIALS & CONSTRUCTION METHODS SHALL BE IN ACCORDANCE WITH CITY OF RALEIGH DESIGN STANDARDS, DETAILS & SPECIFICATIONS (REFERENCE: CORPUD HANDBOOK, CURRENT EDITION).
- 2. UTILITY SEPARATION REQUIREMENTS:
 - a) A DISTANCE OF 100' SHALL BE MAINTAINED BETWEEN SANITARY SEWER & ANY PRIVATE OR PUBLIC WATER SUPPLY SOURCE SUCH AS AN IMPOUNDED RESERVOIR USED AS A SOURCE OF DRINKING WATER. IF ADEQUATE LATERAL SEPARATION CANNOT BE ACHIEVED. FERROUS SANITARY SEWER PIPE SHALL BE SPECIFIED & INSTALLED TO WATERLINE SPECIFICATIONS. HOWEVER, THE MINIMUM SEPARATION SHALL NOT BE LESS THAN 25' FROM A PRIVATE WELL OR 50' FROM A PUBLIC WELL.
 - b) WHEN INSTALLING WATER &/OR SEWER MAINS, THE HORIZONTAL SEPARATION BETWEEN UTILITIES SHALL BE 10'. IF THIS SEPARATION CANNOT BE MAINTAINED DUE TO EXISTING CONDITIONS, THE VARIATION ALLOWED IS THE WATER MAIN IN A SEPARATE TRENCH WITH THE ELEVATION OF THE WATER MAIN AT LEAST 18" ABOVE THE TOP OF THE SEWER & MUST BE APPROVED BY THE PUBLIC UTILITIES DIRECTOR. ALL DISTANCES ARE MEASURED FROM OUTSIDE DIAMETER TO OUTSIDE
 - c) WHERE IT IS IMPOSSIBLE TO OBTAIN PROPER SEPARATION, OR ANYTIME A SANITARY SEWER PASSES OVER A WATERMAIN, DIP MATERIALS OR STEEL ENCASEMENT EXTENDED 10' ON EACH SIDE OF CROSSING MUST BE SPECIFIED & INSTALLED TO WATERLINE SPECIFICATIONS
 - d) 5.0' MINIMUM HORIZONTAL SEPARATION IS REQUIRED BETWEEN ALL SANITARY SEWER & STORM SEWER FACILITIES, UNLESS DIP MATERIAL IS SPECIFIED FOR SANITARY SEWER.
 - e) MAINTAIN 18" MIN. VERTICAL SEPARATION AT ALL WATERMAIN & RCP STORM DRAIN CROSSINGS; MAINTAIN 24" MIN. VERTICAL SEPARATION AT ALL SANITARY SEWER & RCP STORM DRAIN CROSSINGS. WHERE ADEQUATE SEPARATIONS CANNOT BE ACHIEVED, SPECIFY DIP MATERIALS & A CONCRETE CRADLE HAVING 6" MIN. CLEARANCE (PER CORPUD DETAILS W-41 &
- f) ALL OTHER UNDERGROUND UTILITIES SHALL CROSS WATER & SEWER FACILITIES WITH 18" MIN. VERTICAL SEPARATION
- 3. ANY NECESSARY FIELD REVISIONS ARE SUBJECT TO REVIEW & APPROVAL OF AN AMENDED PLAN &/OR PROFILE BY THE CITY OF RALEIGH PUBLIC UTILITIES DEPARTMENT PRIOR TO CONSTRUCTION.
- CONTRACTOR SHALL MAINTAIN CONTINUOUS WATER & SEWER SERVICE TO EXISTING RESIDENCES & BUSINESSES THROUGHOUT CONSTRUCTION OF PROJECT. ANY NECESSARY SERVICE INTERRUPTIONS SHALL BE PRECEDED BY A 24 HOUR ADVANCE NOTICE TO THE CITY OF RALEIGH PUBLIC UTILITIES DEPARTMENT.
- 5. 3.0' MINIMUM COVER IS REQUIRED ON ALL WATER MAINS & SEWER FORCEMAINS. 4.0' MINIMUM COVER IS REQUIRED ON ALL
- 6. IT IS THE DEVELOPER'S RESPONSIBILITY TO ABANDON OR REMOVE EXISTING WATER & SEWER SERVICES NOT BEING USED IN REDEVELOPMENT OF A SITE UNLESS OTHERWISE DIRECTED BY THE CITY OF RALEIGH PUBLIC UTILITIES DEPARTMENT. THIS INCLUDES ABANDONING TAP AT MAIN & REMOVAL OF SERVICE FROM ROW OR EASEMENT PER CORPUD HANDBOOK PROCEDURE.
- 7. INSTALL 3/4" COPPER* WATER SERVICES WITH METERS LOCATED AT ROW OR WITHIN A 2'X2' WATERLINE EASEMENT IMMEDIATELY ADJACENT. NOTE: IT IS THE APPLICANT'S RESPONSIBILITY TO PROPERLY SIZE THE WATER SERVICE FOR EACH CONNECTION TO
- 8. INSTALL 4" PVC* SEWER SERVICES @ 1.0% MINIMUM GRADE WITH CLEANOUTS LOCATED AT ROW OR EASEMENT LINE & SPACED EVERY 75 LINEAR FEET MAXIMUM.
- 9. PRESSURE REDUCING VALVES ARE REQUIRED ON ALL WATER SERVICES EXCEEDING 80 PSI; BACKWATER VALVES ARE REQUIRED ON ALL SANITARY SEWER SERVICES HAVING BUILDING DRAINS LOWER THAN 1.0' ABOVE THE NEXT UPSTREAM MANHOLE.
- 10. ALL ENVIRONMENTAL PERMITS APPLICABLE TO THE PROJECT MUST BE OBTAINED FROM NCDWQ, USACE &/OR FEMA FOR ANY
- RIPARIAN BUFFER, WETLAND &/OR FLOODPLAIN IMPACTS (RESPECTIVELY) PRIOR TO CONSTRUCTION.
- 11. NCDOT / RAILROAD ENCROACHMENT AGREEMENTS ARE REQUIRED FOR ANY UTILITY WORK (INCLUDING MAIN EXTENSIONS & SERVICE TAPS) WITHIN STATE OR RAILROAD ROW PRIOR TO CONSTRUCTION.
- 12. GREASE INTERCEPTOR / OIL WATER SEPARATOR SIZING CALCULATIONS & INSTALLATION SPECIFICATIONS SHALL BE APPROVED BY THE CORPUD FOG PROGRAM COORDINATOR PRIOR TO ISSUANCE OF A BUILDING PERMIT. CONTACT STEPHEN CALVERLEY AT (919) 996-2334 OR STEPHEN.CALVERLEY@RALEIGHNC.GOV FOR MORE INFORMATION.
- 13. CROSS-CONNECTION CONTROL PROTECTION DEVICES ARE REQUIRED BASED ON DEGREE OF HEALTH HAZARD INVOLVED AS LISTED IN APPENDIX-B OF THE RULES GOVERNING PUBLIC WATER SYSTEMS IN NORTH CAROLINA. THESE GUIDELINES ARE THE MINIMUM REQUIREMENTS. THE DEVICES SHALL MEET AMERICAN SOCIETY OF SANITARY ENGINEERING (ASSE) STANDARDS OR BE ON THE UNIVERSITY OF SOUTHERN CALIFORNIA APPROVAL LIST. THE DEVICES SHALL BE INSTALLED AND TESTED (BOTH INITIAL AND PERIODIC TESTING THEREAFTER) IN ACCORDANCE WITH THE MANUFACTURER'S RECOMMENDATIONS OR THE LOCAL CROSS-CONNECTION CONTROL PROGRAM, WHICHEVER IS MORE STRINGENT. CONTACT JOANIE HARTLEY AT (919) 996-5923 OR JOANIE.HARTLEY@RALEIGHNC.GOV FOR MORE INFORMATION.

ADDITIONAL UTILITY NOTES:

- 1. ALL WATER MAINS, SERVICES AND FIRE SERVICES GREATER THAN 2" DIAMETER ARE TO BE DUCTILE IRON PIPE. 2" & SMALLER DOMESTIC SERVICES MUST BE TYPE K SOFT COPPER (WITHOUT FITTINGS) TO THE WATER METER. PRIVATE WATER SYSTEMS MAY USE C-900 PIPE. APPROVED BACKFLOW PREVENTERS ARE REQUIRED TO SEPARATE PUBLIC WATER SYSTEMS FROM PRIVATE
- 2. ALL SEWER MAINS SHALL BE EITHER PVC OR DUCTILE IRON PIPE AS SHOWN ON THE PLANS. ALL PIPE MATERIAL SHALL MEET CITY OF RALEIGH STANDARDS AND SPECIFICATIONS AS DEFINED IN THE LATEST ISSUE OF THE PUBLIC UTILITIES HANDBOOK AND/OR UNIFIED DEVELOPMENT ORDINANCE (UDO).
- 3. ALL FIRE HYDRANTS ALONG PUBLIC R/W LINES SHALL HAVE A 5'Wx5'L CITY OF RALEIGH WATERLINE EASEMENT ONTO ADJACENT
- 4. ALL SANITARY SEWER INTERCEPTOR LINES (12" AND LARGER), AS WELL AS MANHOLES AND FITTINGS ASSOCIATED WITH THE INTERCEPTOR LINE, SHALL BE INTERNALLY LINED WITH PROTECTO 401 OR APPROVED EQUAL TO PREVENT HYDROGEN SULFIDE CORROSION. SEE THE CURRENT CITY OF RALEIGH PUBLIC UTILITIES DEPARTMENT HANDBOOK FOR APPROVED COATINGS AND **APPLICATION METHODS**
- 5. IN ACCORDANCE WITH GENERAL STATUTE 87-121(G), ALL UNDERGROUND UTILITIES INSTALLED AFTER OCTOBER 1, 2014 SHALL BE ELECTRONICALLY LOCATABLE. CONTRACTOR SHALL COORDINATE DIRECTLY WITH THE CITY OF RALEIGH PUBLIC UTILITIES DEPARTMENT FOR DETAILS AND SPECIFICATIONS FOR MEETING THESE REQUIREMENTS.
- 6. EXISTING UTILITIES SHOWN ARE BASED ON FIELD SURVEYS AND THE BEST AVAILABLE RECORD DRAWINGS. THE CONTRACTOR SHALL VERIFY CONDITIONS PRIOR TO BEGINNING CONSTRUCTION. ANY DISCREPANCIES BETWEEN ACTUAL FIELD CONDITIONS AND THE PLANS SHALL BE REPORTED TO THE ENGINEER IMMEDIATELY.
- 7. ALL WATER AND SEWER MAINS WITHIN PUBLIC EASEMENTS OR RIGHTS-OF-WAY TO BE OWNED, OPERATED, AND MAINTAINED BY THE CITY OF RALEIGH.
- 8. ALL WATER AND SEWER MAINS NOT WITHIN PUBLIC EASEMENTS OR RIGHTS-OF-WAY TO BE PRIVATELY OWNED, OPERATED, AND MAINTAINED BY THE PROPERTY OWNER.
- 9. ALL UTILITY SLEEVES SHALL BE SCHEDULE 40 PVC AND INSTALLED WITH 2' MINIMUM COVER. BOTH ENDS SHALL BE CAPPED AND
- 10. VIDEO SURVEILLANCE OF ALL SANITARY SEWER MAINS AND LATERALS IS REQUIRED PRIOR TO USE.

GRADING NOTES

- ALL DIMENSIONS AND GRADES SHOWN ON THE PLANS SHALL BE FIELD VERIFIED BY THE CONTRACTOR PRIOR TO CONSTRUCTION. CONTRACTOR SHALL NOTIFY THE ENGINEER IF ANY DISCREPANCIES EXIST PRIOR TO PROCEEDING WITH CONSTRUCTION, FOR NECESSARY PLAN OR GRADE CHANGES. NO EXTRA COMPENSATION SHALL BE PAID TO THE CONTRACTOR FOR ANY WORK DONE DUE TO DIMENSIONS OR GRADES SHOWN INCORRECTLY ON THESE PLANS IF SUCH NOTIFICATION HAS NOT BEEN GIVEN.
- OCCUPATIONAL SAFETY AND HEALTH ADMINISTRATION (OSHA) STANDARDS FOR EXCAVATIONS; FINAL RULE 29CFR PART 1926, SUBPART "P" APPLIES TO ALL EXCAVATIONS EXCEEDING FIVE (5) FEET IN DEPTH. EXCAVATION EXCEEDING TWENTY (20) FEET IN DEPTH REQUIRES THE DESIGN OF A TRENCH SAFETY SYSTEM BY A REGISTERED PROFESSIONAL ENGINEER, PROVIDED BY CONTRACTOR RESPONSIBLE FOR EXCAVATION.
- ALL CONSTRUCTION SHALL BE IN ACCORDANCE WITH THE CITY OF RALEIGH AND/OR NCDOT STANDARDS AND SPECIFICATIONS AS
- 4. CONSTRUCTION, MAINTENANCE AND REMOVAL OF ALL EROSION CONTROL DEVICES ARE THE RESPONSIBILITY OF THE GENERAL CONTRACTOR. TIMING OF REMOVAL SHALL BE COORDINATED WITH THE EROSION CONTROL INSPECTOR.
- EXISTING UTILITIES AND STRUCTURES SHOWN, BOTH UNDERGROUND AND ABOVE GROUND, ARE BASED ON A FIELD SURVEY AND THE BEST AVAILABLE RECORD DRAWINGS. THE CONTRACTOR SHALL VERIFY FIELD CONDITIONS PRIOR TO BEGINNING RELATED CONSTRUCTION. ANY DISCREPANCIES SHALL BE REPORTED TO THE ENGINEER IMMEDIATELY
- SOIL UNDER BUILDINGS. PAVED AREAS AND WITHIN SLOPES GREATER THAN 3:1 (H:V) SHALL BE APPROVED, PLACED AND COMPACTED AS RECOMMENDED BY THE GEOTECHNICAL ENGINEER.
- CONTRACTOR SHALL DETERMINE LOCATIONS FOR SPILL CURB TO PROVIDE POSITIVE DRAINAGE TO STORM STRUCTURES HROUGHOUT THE SITE. NO "BIRDBATHS" SHALL BE CREATED WITHIN THE CURB AND GUTTER OR ASPHALT PAVED AREAS.

STORM DRAINAGE NOTES

- 1. ALL STORM DRAINAGE PIPES SHOWN SHALL BE CLASS III REINFORCED CONCRETE (RCP) UNLESS NOTED OTHERWISE
- 2. ALL STORM DRAINAGE CONSTRUCTION SHALL BE IN ACCORDANCE WITH THE CITY OF RALEIGH STANDARDS
- 3. ALL CONCRETE SHALL MEET A MINIMUM 3000 PSI COMPRESSIVE STRENGTH.
- 4 ALL PIPE IN STORM DRAIN STRUCTURES SHALL BE STRUCK EVEN WITH INSIDE WALL.
- 5. ALL PIPE JOINTS SHALL BE MADE WITH PREFORMED JOINT SEALER, WHICH CONFORMS TO AASHTO SPECIFICATION M-198 FOR TYPE B FLEXIBLE PLASTIC GASKETS UNLESS OTHERWISE NOTED.
- 6. THE INTERIOR SURFACES OF ALL STORM DRAINAGE STRUCTURES SHALL BE POINTED UP AND SMOOTHED TO AN ACCEPTABLE STANDARD. USING MORTAR MIXED TO MANUFACTURER'S SPECIFICATIONS.
- 7 ALL BACKFILL SHALL BE NON-PLASTIC IN NATURE FREE FROM ROOTS, VEGETATION MATTER, WASTE CONSTRUCTION MATERIAL OR OTHER OBJECTIONABLE MATERIAL. SAID MATERIAL SHALL BE CAPABLE OF BEING COMPACTED BY MECHANICAL MEANS AND SHALL HAVE NO TENDENCY TO FLOW OR BEHAVE IN A PLASTIC MANNER UNDER THE TAMPING BLOWS OR PROOF ROLLING.
- 8. MATERIALS DEEMED BY THE OWNER'S REPRESENTATIVE OR GEOTECH AS UNSUITABLE FOR BACKFILL PURPOSES SHALL BE REMOVED AND REPLACED WITH SUITABLE MATERIAL
- 9. BACKFILLING OF TRENCHES SHALL BE ACCOMPLISHED IMMEDIATELY AFTER PIPE IS LAID. THE FILL AROUND THE PIPE SHALL BE THOROUGHLY COMPACTED TO 95 % OF THE MAXIMUM DRY DENSITY OBTAINABLE WITH THE STANDARD PROCTOR TEST. THE TOP EIGHT (8) INCHES SHALL BE COMPACTED TO 100 PERCENT STANDARD PROCTOR.
- 10. UNDER NO CIRCUMSTANCES SHALL WATER BE ALLOWED TO RISE IN UNBACKFILLED TRENCHES AFTER PIPE HAS BEEN PLACED.
- 11. ALL CONCRETE PIPE AND PRECAST STORM STRUCTURES SHALL MEET NCDOT STANDARDS AND STAMPED ACCORDINGLY BY
- 12. CONTRACTOR SHALL BE RESPONSIBLE FOR CHECKING ALL PIPE AND STRUCTURES FOR CRACKS OR BREAKS, PRIOR TO INSTALLATION. ANY DAMAGED ITEMS SHALL NOT BE INSTALLED.
- 13. "KNOCK-OUT" BOXES OR HDPE PIPE SHALL NOT BE ALLOWED WITHIN PUBLIC RIGHT-OF-WAYS UNLESS APPROVED IN WRITING BY CITY OF RALEIGH STORMWATER DEPARTMENT.
- 14. ALL PRIVATE STORM DRAINAGE EASEMENTS AND STORMWATER MEASURES WILL BE MAINTAINED BY THE PROPERTY OWNER(S)
- 15. CONTRACTOR TO COORDINATE THE LOCATION OF CONDUIT WITH STORM DRAINAGE

ALL CONSTRUCTION SHALL BE IN ACCORDANCE WITH THE CURRENT CITY OF RALEIGH AND NCDOT ENGINEERING DESIGN AND CONSTRUCTION STANDARDS

BUY AMERICA PROGRAM REQUIREMENTS

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PRELIMINARY DRAWING - NOT RELEASED FOR CONSTRUCTION


PRIME CONSULTANT 434 Favetteville Street

SUBCONSULTANT: The John R. McAdams Company, In phone 919. 823. 4300 license number: C-0293, C-183

MCADAMS www.mcadamsco.com DESCRIPTION

PROJECT NOTES

SHEET NAME

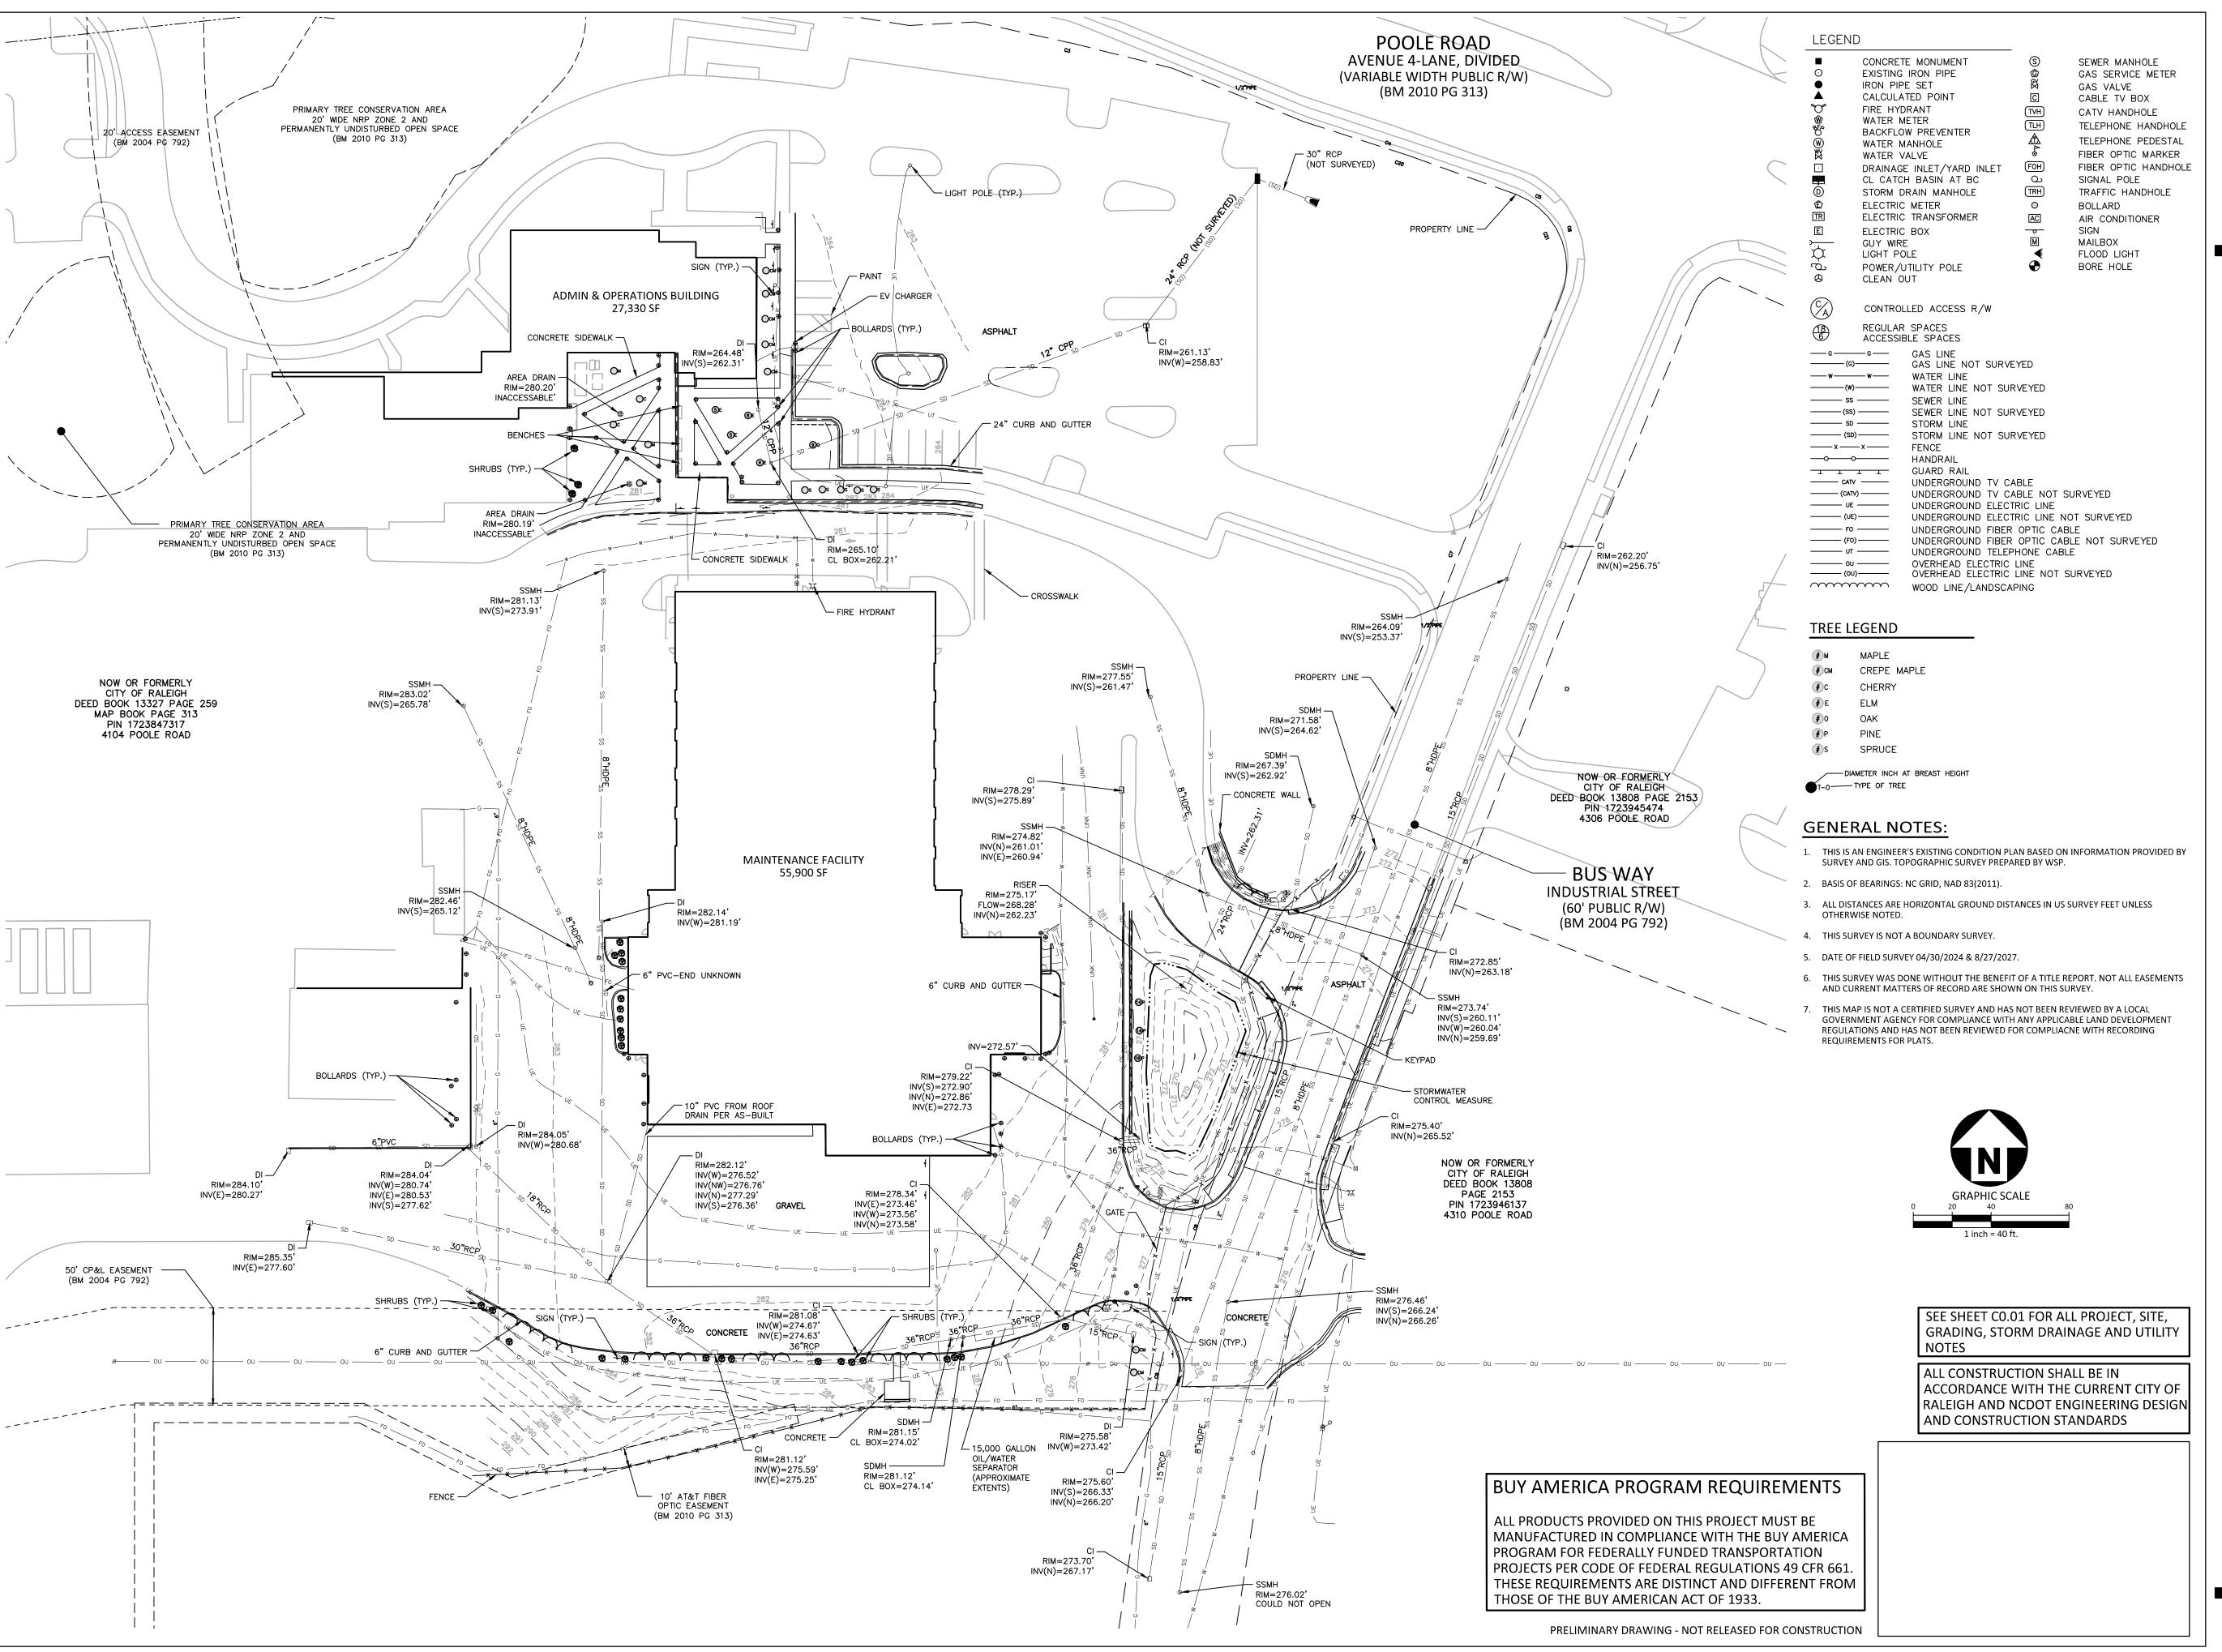



PRIME CONSULTANT:

434 Fayetteville Street Raleigh, NC 27604 Tel.: +1 919 836 4040 wsp.com

SUBCONSULTANT:

The John R. McAdams Company, Inc 621 Hillsborough St Suite 500 Raleigh, NC 27603 phone 919. 823. 4300

license number: C-0293, C-187

MCADAMS www.mcadamsco.com DESCRIPTION

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PROFESSIONAL SEAL

T

SHEET NAME **EXISTING CONDITIONS**

DESIGNED BY: DRAWN BY: CHECKED BY 11. 01. 2024





4040 wsp.com

DESCRIPTION

PROFESSIONAL SEAL

SHEET NAME

DEMOLITION PLAN - ADMIN & OPS

DESIGNED BY: DRAWN BY: 11. 01. 2024

FULL SCALE SHEET SIZE= ANSI- D (22"x 34")

 $\underline{WARNING:}$ THESE DRAWINGS THE PROPERTY OF THE PRIME CONSULTANT NOTED HEREWITHIN. ANY RE-USE OF THIS WORK WITHOUT WRITTEN CONSENT IS AN INFRINGEMENT OF THE ALTERATION OF T





DESCRIPTION

PROFESSIONAL SEAL

SHEET NAME

DEMOLITION PLAN - MAINTENANCE

DESIGNED BY: DRAWN BY: 11. 01. 2024

FULL SCALE SHEET SIZE= ANSI- D (22"x 34")

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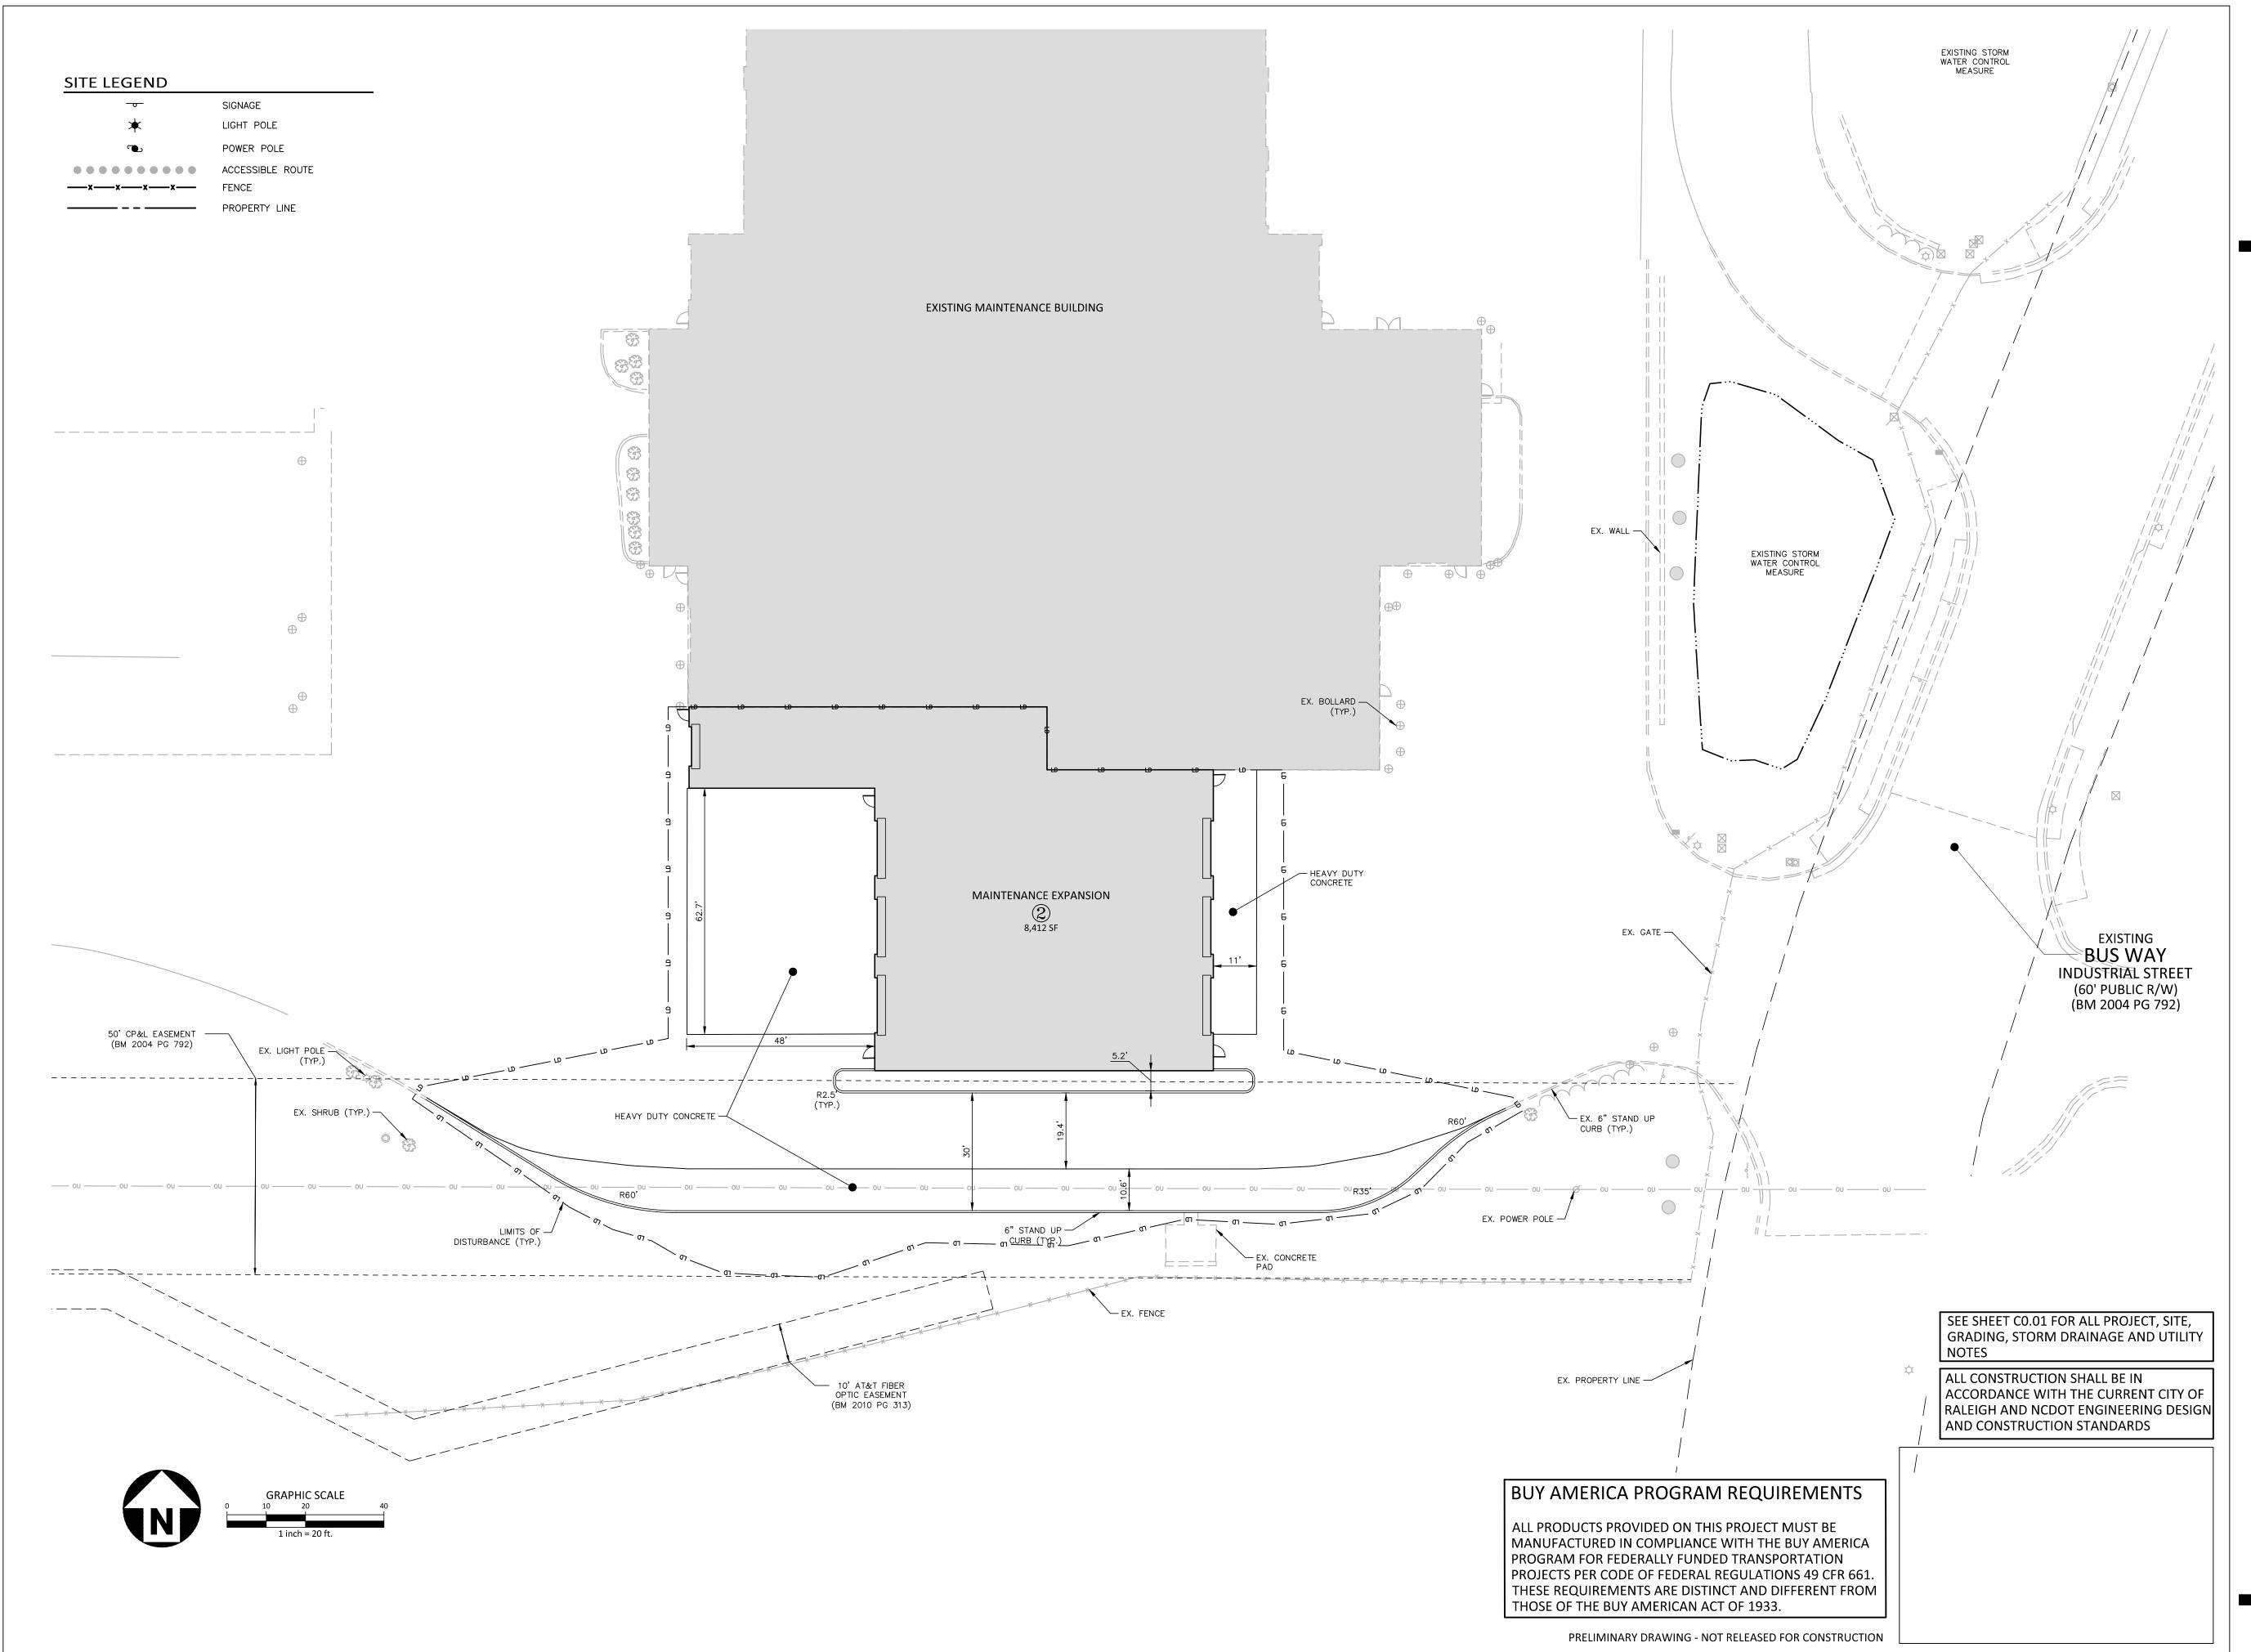
SUBCONSULTANT: phone 919. 823. 4300 fax 919. 361. 2269

MCADAMS www.mcadamsco.com DESCRIPTION

PROFESSIONAL SEAL

SHEET NAME SITE PLAN - ADMIN & OPS


DESIGNED BY: DRAWN BY: 11. 01. 2024





SUBCONSULTANT: phone 919. 823. 4300 fax 919. 361. 2269 license number: C-0293, C-187

MCADAMS www.mcadamsco.com DESCRIPTION

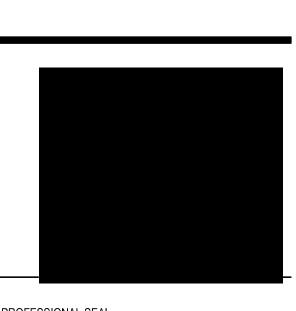

PROFESSIONAL SEAL

SHEET NAME SITE PLAN - MAINTENANCE

DESIGNED BY: DRAWN BY: 11. 01. 2024



SUBCONSULTANT:

The John R. McAdams Company
621 Hillsborrough St
Suite 500
Raleigh, NC 27603
phone 919. 823. 4300
fax 919. 361. 2269
license number: C-0293, C-18

MCADAMS

www.mcadamsco.com

REV DESCRIPTION DATE

FROAD) EXPANSI
104 POOLE ROAD
ALEIGH, NC 27610

GORALE MAIN (POOL



PROFESSIONAL SEAL

SHEET NAME
GRADING PLAN - ADMIN & OPS

DESIGNED BY: SJC

DRAWN BY: WHM

CHECKED BY: LAW

DATE: 11. 01. 2024

SCALE: 1"=20'

HEET NUMBER C3.0



SUBCONSULTANT: phone 919. 823. 4300 fax 919. 361. 2269

license number: C-0293, C-187 MCADAMS www.mcadamsco.com

DESCRIPTION

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PROFESSIONAL SEAL

SHEET NAME

GRADING PLAN - MAINTENANCE

DESIGNED BY: DRAWN BY: 11. 01. 2024

FULL SCALE SHEET SIZE= ANSI- D (22"x 34")


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4040 wsp.com

DESCRIPTION



PROFESSIONAL SEAL

SHEET NAME UTILITY PLAN - ADMIN & OPS

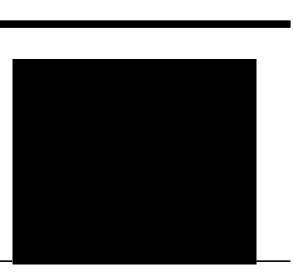DESIGNED BY: DRAWN BY: 11. 01. 2024 FULL SCALE SHEET SIZE= ANSI- D (22"x 34")



SUBCONSULTANT: phone 919. 823. 4300 fax 919. 361. 2269 license number: C-0293, C-187

MCADAMS www.mcadamsco.com DESCRIPTION




PROFESSIONAL SEAL

SHEET NAME

UTILITY PLAN - MAINTENANCE

DESIGNED BY: DRAWN BY: 11. 01. 2024

STANDARD 24" CURB AND GUTTER

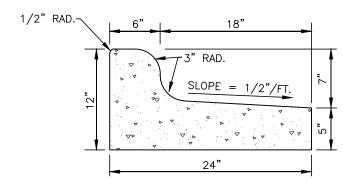


24" SPILL CURB AND GUTTER


1. 10' MAXIMUM BETWEEN DUMMY JOINTS. 15' MAXIMUM BETWEEN DUMMY JOINTS ON MACHINE POURS.

- 2. 1/2" EXPANSION JOINT EVERY 50'.
- 3. 3000 PSI CONCRETE MINIMUM, 4" SLUMP MAXIMUM.
- 4. LIQUID MEMBRANE CURING COMPOUND SHALL MEET THE REQUIREMENTS OF SECTION 1026-2 OF NCDOT STANDARDS AND SPECIFICATIONS FOR ROADS AND STRUCTURES.
- 5. ALL CONSTRUCTION JOINTS SHALL BE FILLED WITH FILLER AND SEALER IN ACCORDANCE WITH NCDOT ROADWAY STANDARD DETAIL 846.01. THE JOINT MATERIAL SHALL CONFORM TO SECTION 1028-2 OF THE NCDOT STANDARDS AND SPECIFICATIONS FOR ROADS AND STRUCTURES.
- 6. REFER TO NCDOT DETAIL 846.01 FOR CURB AND GUTTER SUPERELEVATION RATES.

24" CURB AND GUTTER
N.T.S.

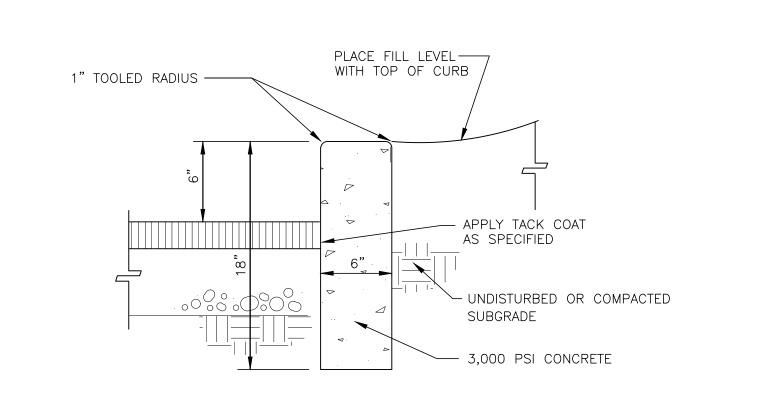

CONCRETE HEADER CURB DETAIL N.T.S.

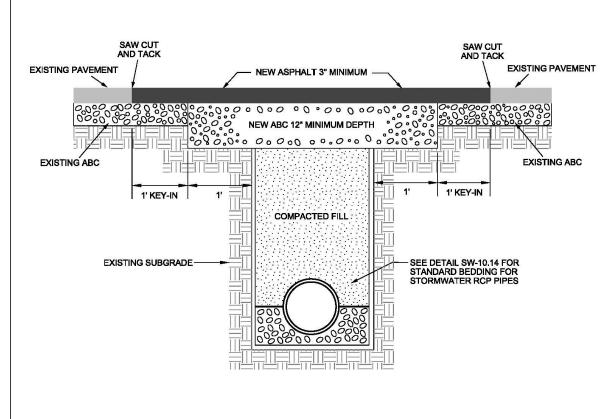



- 1. THE PAVEMENT EDGE SHALL BE DEFINED BY A STRAIGHT EDGE FORMED BY A MACHINED SAW CUT.
- 2. THE TRENCH SUBGRADE MATERIAL SHALL BE BACKFILLED WITH SUITABLE MATERIAL AND COMPACTED TO A DENSITY OF AT LEAST 95% OF THAT OBTAINED BY COMPACTING A SAMPLE OF THE MATERIAL IN ACCORDANCE WITH AASHTO T-99 AS MODIFIED BY NCDOT.

3. THE FINAL 1' OF FILL SHALL CONSIST OF ABC MATERIAL COMPACTED TO A DENSITY EQUAL TO 100% OF THAT

- OBTAINED BY COMPACTING A SAMPLE OF THE MATERIAL IN ACCORDANCE WITH AASHTO T-80 AS
- MODIFIED BY NCDOT. BITUMINOUS BASE OR BINDER MAY BE SUBSTITUTED IF APPROVED BY TRANSPORTATION DIRECTOR OR DESIGNEE.
- 4. THE ENTIRE THICKNESS/VERTICAL EDGE OF THE CUT SHALL BE TACKED. 5. THE SAME DEPTH OF PAVEMENT MATERIAL WHICH EXISTS SHALL BE REINSTALLED, BUT IN NO CASE SHALL
- THE ASPHALT BE LESS THAN 3" THICK. 6. THE ASPHALT PAVEMENT MATERIAL SHALL BE INSTALLED AND COMPACTED THOROUGHLY AND ROLLED WITH A SMOOTH
- DRUM ROLLER TO ACHIEVE A SMOOTH, LEVEL PATCH.

C	CITY OF RALEIGH STANDARD DETAIL	
REVISIONS	DATE: 8/2020 NOT TO SCALE	
	ASPHALT PAVEMENT PATCH AND RCP PIPE BACKFILL	
	T-10.05	

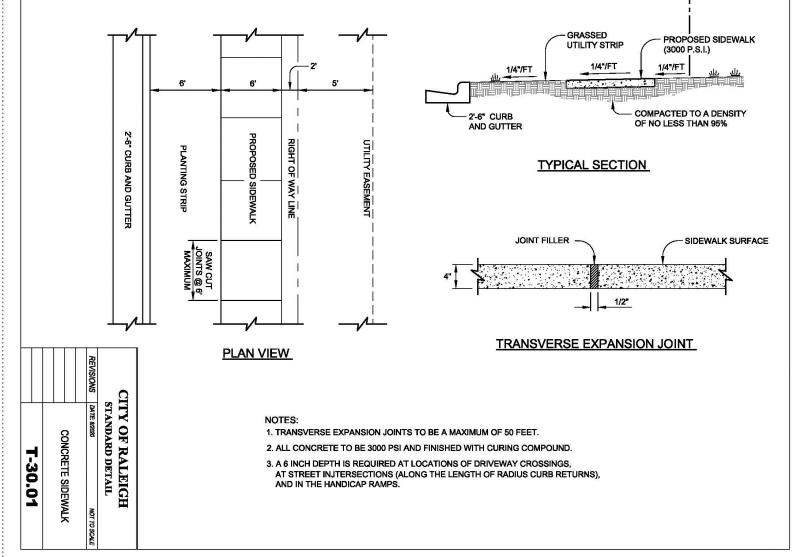

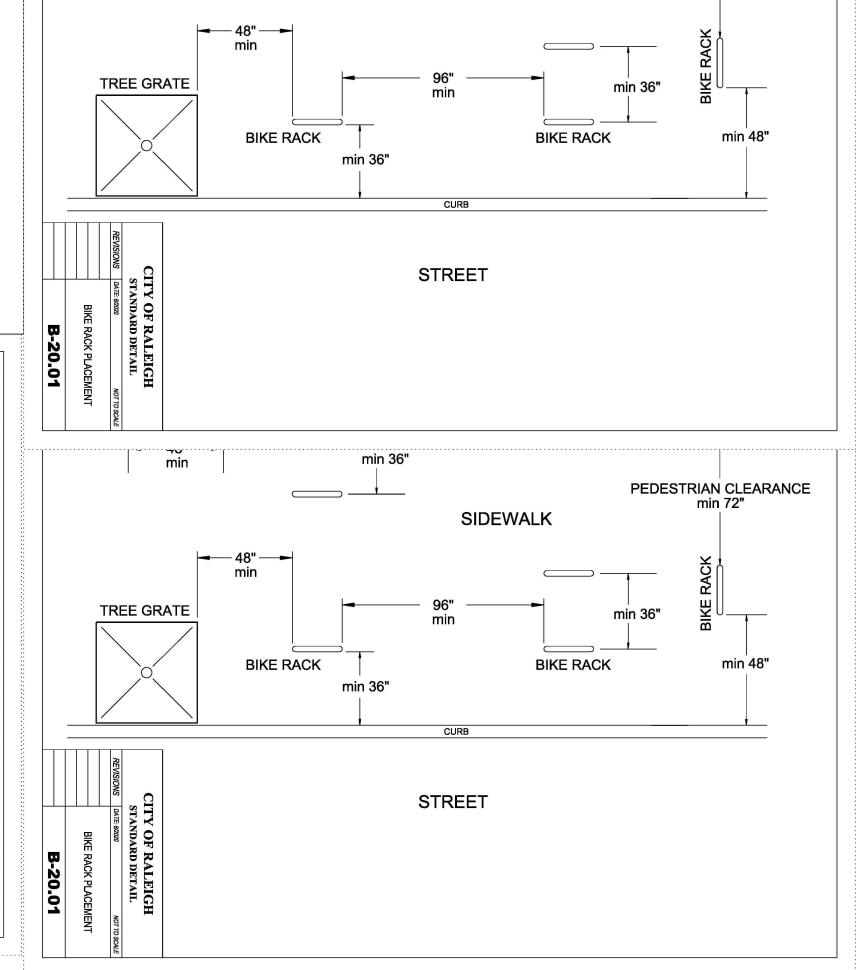

SEE SHEET CO.01 FOR ALL PROJECT, SITE, GRADING, STORM DRAINAGE AND UTILITY NOTES

ALL CONSTRUCTION SHALL BE IN ACCORDANCE WITH THE CURRENT CITY OF RALEIGH AND NCDOT ENGINEERING DESIGN AND CONSTRUCTION STANDARDS

BUY AMERICA PROGRAM REQUIREMENTS

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PRELIMINARY DRAWING - NOT RELEASED FOR CONSTRUCTION

BUILDING OR WALL

SIDEWALK

PEDESTRIAN CLEARANCE min 72"


PRIME CONSULTANT: 434 Fayetteville Street Raleigh, NC 27604

4040 wsp.com SUBCONSULTANT:

Tel.: +1 919 836


phone 919. 823. 4300 license number: C-0293, C-187 MCADAMS www.mcadamsco.com


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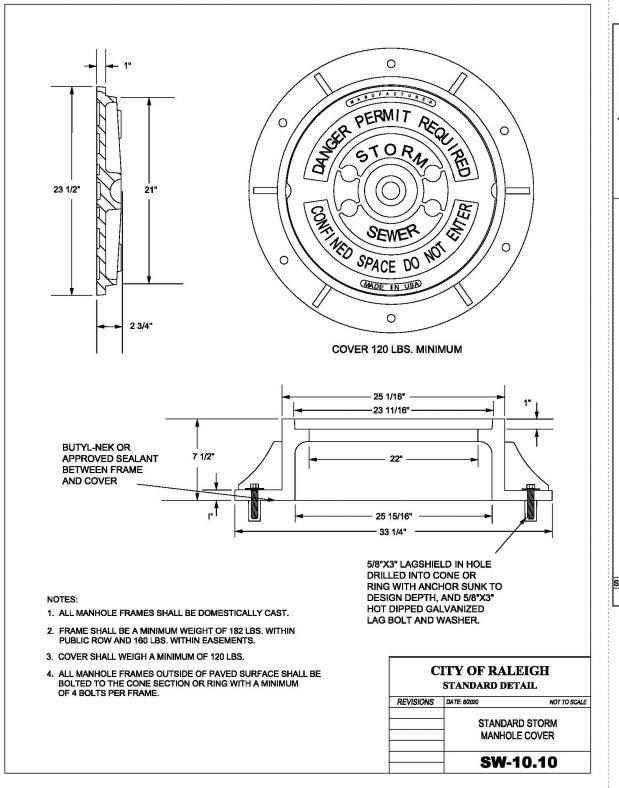


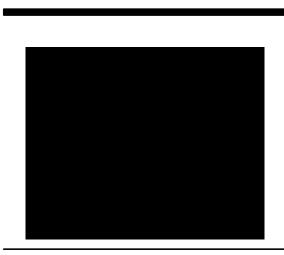
PROFESSIONAL SEAL SHEET NAME SITE DETAILS

DESIGNED BY: DRAWN BY: CHECKED BY: 11. 01. 2024



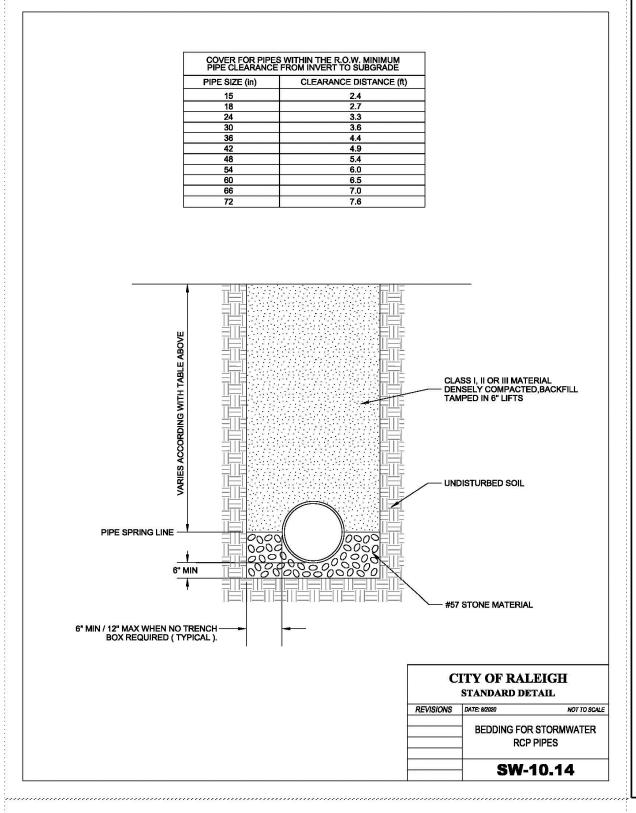

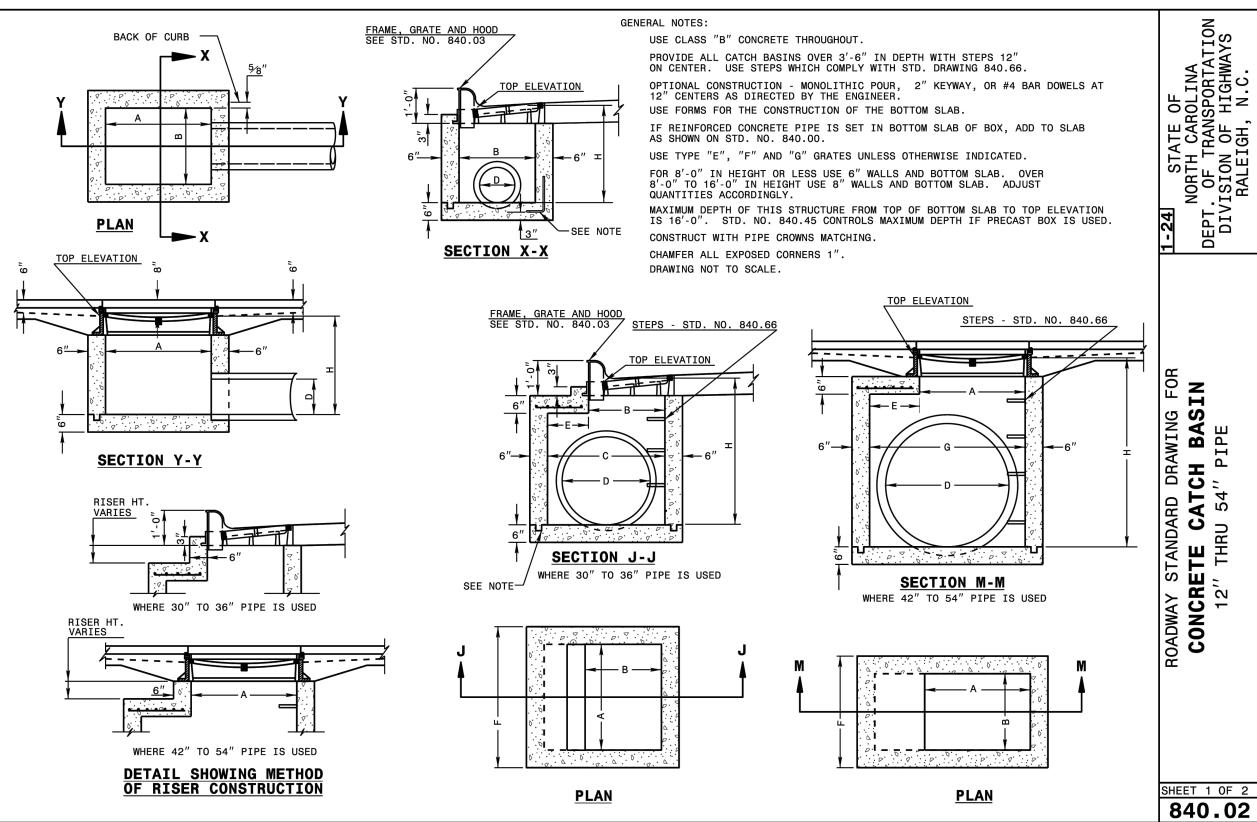

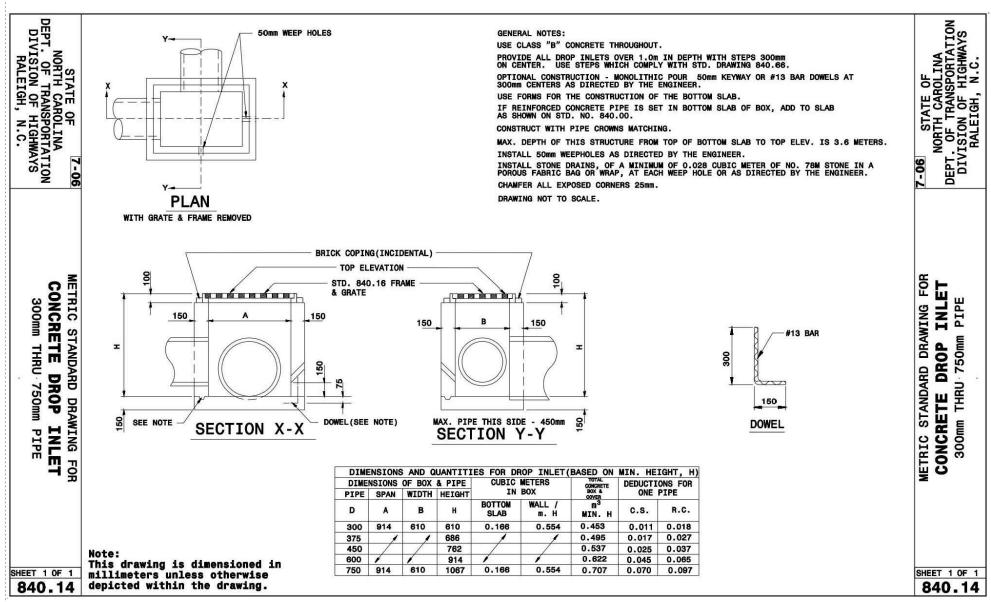

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PRELIMINARY DRAWING - NOT RELEASED FOR CONSTRUCTION

SEE SHEET CO.01 FOR ALL PROJECT, SITE, GRADING, STORM DRAINAGE AND UTILITY

ALL CONSTRUCTION SHALL BE IN ACCORDANCE WITH THE CURRENT CITY OF RALEIGH AND NCDOT ENGINEERING DESIGN AND CONSTRUCTION STANDARDS

PRIME CONSULTANT: 434 Fayetteville Street Raleigh, NC 27604 Tel.: +1 919 836 4040 wsp.com

> SUBCONSULTANT: The John R. McAdams Company, Inc. 621 Hillsborough St Suite 500 Raleigh, NC 27603 phone 919, 823, 4300 fax 919. 361. 2269

license number: C-0293, C-187 MCADAMS www.mcadamsco.com


DESCRIPTION

PROFESSIONAL SEAL

SHEET NAME STORM DRAINAGE DETAILS

DESIGNED BY: DRAWN BY: CHECKED BY 11. 01. 2024



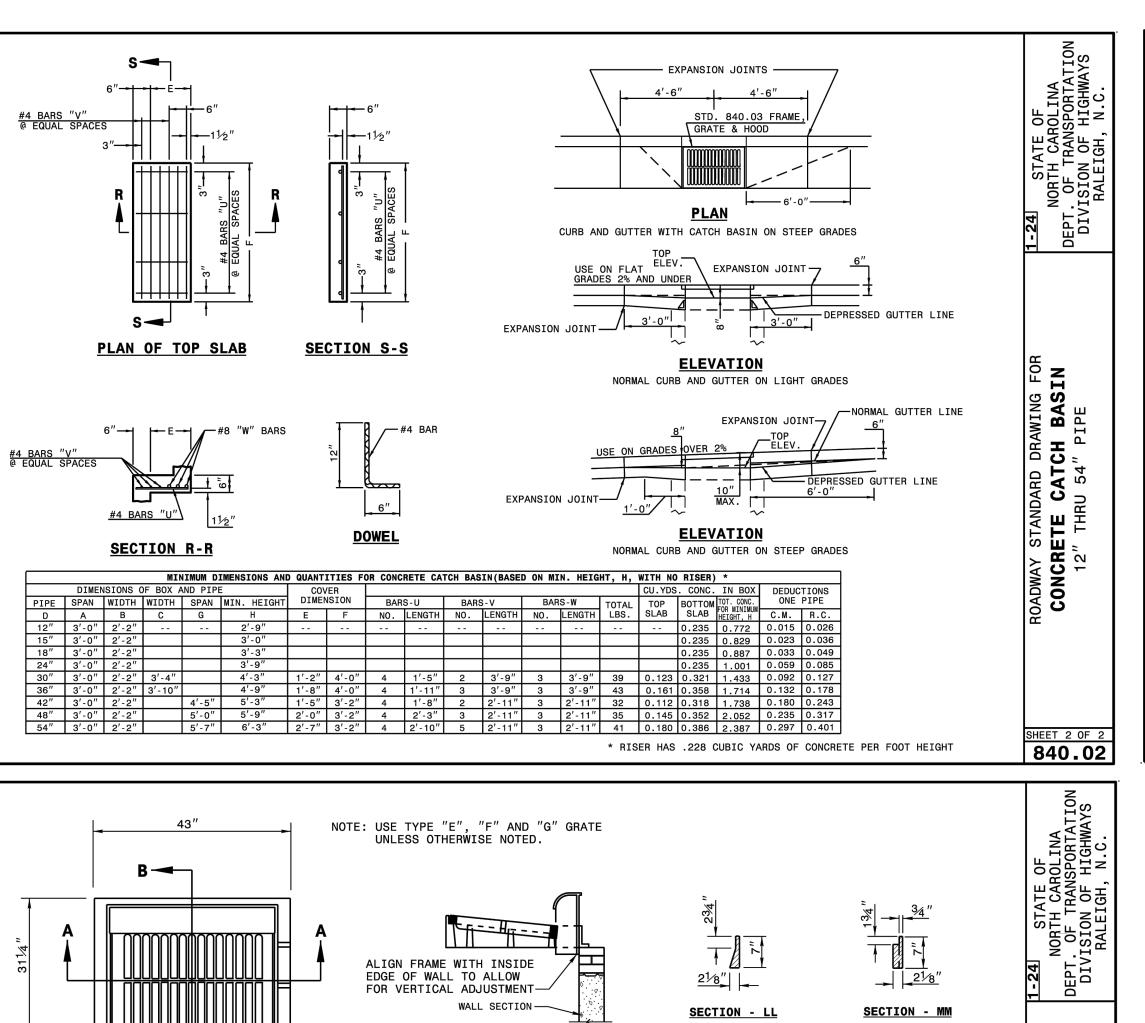



SECTION - BB

HOOD ELEVATION

FRAME, GRATE, & HOOD ASS'Y

SECTION - AA

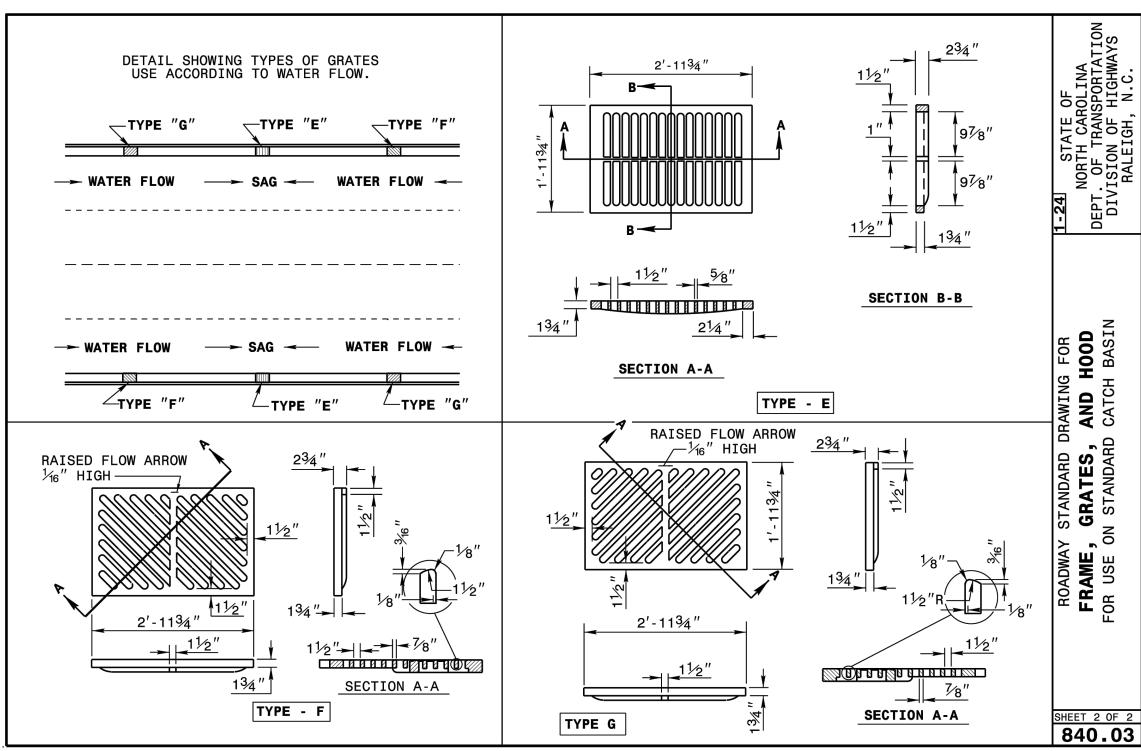

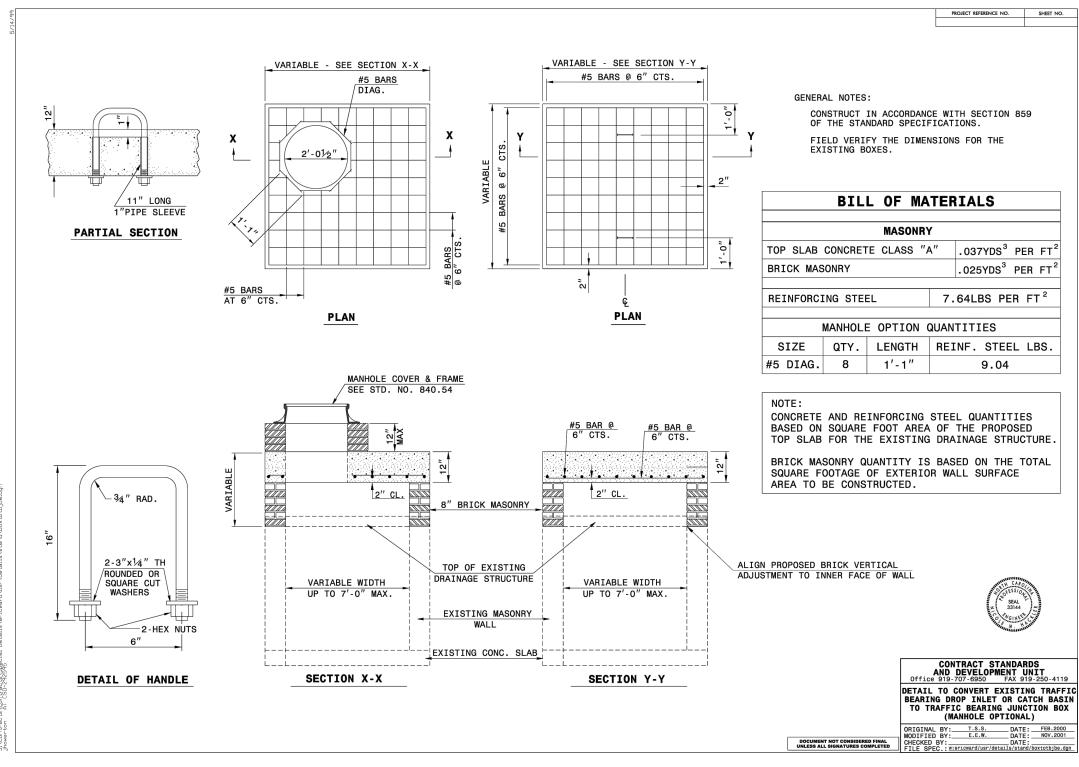

SEE SHEET CO.01 FOR ALL PROJECT, SITE, GRADING, STORM DRAINAGE AND UTILITY NOTES

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PROGRAM FOR FEDERALLY FUNDED TRANSPORTATION

PRELIMINARY DRAWING - NOT RELEASED FOR CONSTRUCTION




SUBCONSULTANT: phone 919. 823. 4300

license number: C-0293, C-187 MCADAMS www.mcadamsco.com

4040 wsp.com

DESCRIPTION

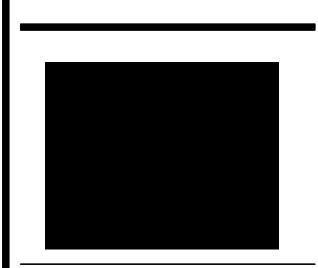

PROFESSIONAL SEAL

SHEET NAME STORM DRAINAGE DETAILS


DESIGNED BY: DRAWN BY: CHECKED BY: 11. 01. 2024


FULL SCALE SHEET SIZE= ANSI- D (22"x 34")


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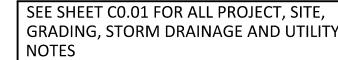
SECTION - RR





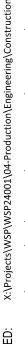

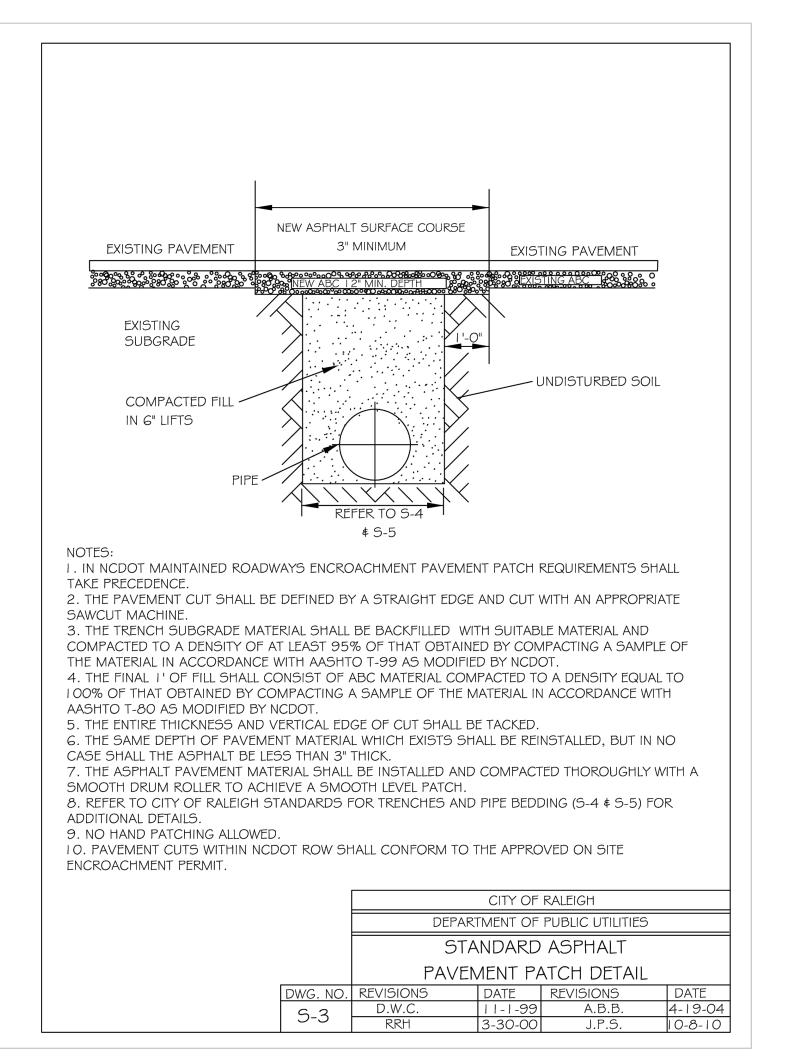

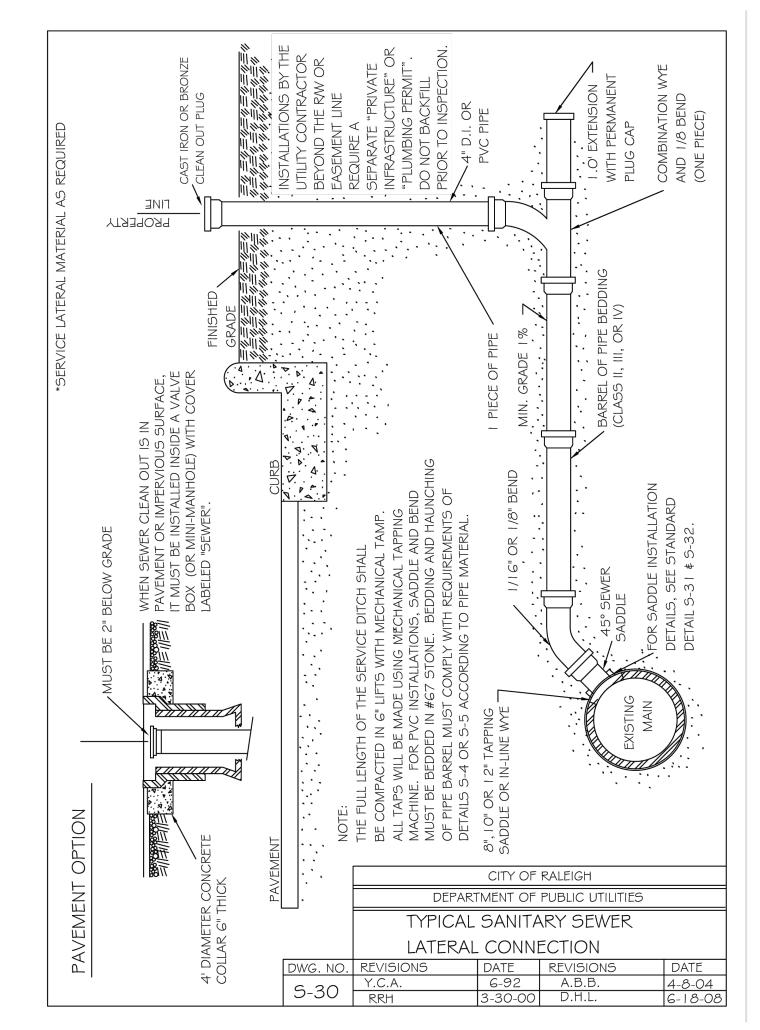

ALL CONSTRUCTION SHALL BE IN ACCORDANCE WITH THE CURRENT CITY OF RALEIGH AND NCDOT ENGINEERING DESIGN

BUY AMERICA PROGRAM REQUIREMENTS

ALL PRODUCTS PROVIDED ON THIS PROJECT MUST BE MANUFACTURED IN COMPLIANCE WITH THE BUY AMERICA PROGRAM FOR FEDERALLY FUNDED TRANSPORTATION PROJECTS PER CODE OF FEDERAL REGULATIONS 49 CFR 661. THESE REQUIREMENTS ARE DISTINCT AND DIFFERENT FROM THOSE OF THE BUY AMERICAN ACT OF 1933.

PRELIMINARY DRAWING - NOT RELEASED FOR CONSTRUCTION

GRADING, STORM DRAINAGE AND UTILITY

AND CONSTRUCTION STANDARDS

WARNING: THESE DRAWINGS THE PROPERTY OF THE PRIME CONSULTANT NOTED HEREWITHIN. ANY RE-USE OF THIS WORK WITHOUT WRITTEN CONSENT IS AN INFRINGEMENT OF THE ARCHITECT OR ENGINEER, TO ALTER AN ITEM BEARING THE DRIVE OR SUCH ALTERATION AND A SPECIFIC DESCRIPTION OF THE ALTERATION AND THE NOTATION OF THE LAW FOR ANY PERSON, UNLESS ACTING UNDER THE DIRECT SUPERVISION OF A LICENSED ARCHITECT OR ENGINEER, TO ALTER AN ITEM BEARING THE DRIVE OR SUCH ALTERATION AND THE DRIVE OR SUCH ALTER AN ITEM BEARING THE DRIVE OR SUCH AND THE DRIVE OR SU

PRIME CONSULTANT:

SUBCONSULTANT:

434 Fayetteville Street Raleigh, NC 27604

4040 wsp.com

621 Hillsborough St Suite 500 Raleigh, NC 27603 phone 919. 823. 4300

license number: C-0293, C-187

MCADAMS www.mcadamsco.com

DESCRIPTION

PROFESSIONAL SEAL

SHEET NAME SEWER DETAILS

DESIGNED BY: DRAWN BY: 11. 01. 2024

GENERAL NOTES

- PRIOR TO CONSTRUCTION, ANY DISCREPANCIES IN THE PLANS AND NOTES SHALL BE BROUGHT TO THE DESIGN ENGINEER'S ATTENTION IMMEDIATELY. IF THE CONTRACTOR, IN THE COURSE OF WORK, FINDS ANY DISCREPANCIES IN THE PLANS OR NOTES GIVEN BY THE PROJECT ENGINEER, IT SHALL BE THEIR DUTY TO IMMEDIATELY INFORM THE PROJECT ENGINEER IN WRITING. ANY WORK DONE AFTER SUCH A DISCOVERY, UNTIL AUTHORIZED, WILL
- THE CONTRACTOR SHALL OBTAIN ALL NECESSARY LICENSES AND PERMITS REQUIRED TO COMPLETE THE WORK INCLUDED IN THE CONTRACT
- 3. IT IS THE CONTRACTOR'S RESPONSIBILITY TO VERIFY THAT THEY AND THEIR SUBCONTRACTORS HAVE THE CORRECT AND MOST UP-TO-DATE PLANS
- 4. THE PROJECT WILL MEET ALL RELEVANT DESIGN REQUIREMENTS IN THE NCDEQ MANUAL AND THE [LOCAL JURISDICTION] REGULATIONS AND
- ALL OSHA REQUIREMENTS FOR EXCAVATIONS (SHORING, DEPTH, ETC.) ARE THE RESPONSIBILITY OF THE CONTRACTOR. IF REQUIRED, THE CONTRACTOR SHALL PROVIDE AN EXCAVATION PLAN TO BE SEALED BY A NC P.E. IT IS THE RESPONSIBILITY OF THE CONTRACTOR TO DETERMINE IF AN EXCAVATION PLAN IS REQUIRED. THE JOHN R. MCADAMS COMPANY ASSUMES NO RESPONSIBILITY FOR ANY EXCAVATION DESIGN RELATED TO SAFETY
- MANUFACTURER OR AUTHORIZED SUPPLIER TO SUBMIT SHOP DRAWINGS FOR FILTERRA SYSTEM FOR APPROVAL. DRAWINGS SHALL INCLUDE PRINCIPAL DIMENSIONS, ENGINEERED BIOFILTRATION MEDIA PLACEMENT, LOCATION OF PIPING AND UNIT FOUNDATION.
- a. MANUFACTURER OR AUTHORIZED SUPPLIER SHALL SUBMIT INSTALLATION INSTRUCTIONS TO THE CONTRACTOR.
- b. MANUFACTURER OR AUTHORIZED SUPPLIER SHALL SUBMIT OPERATIONS AND MAINTENANCE MANUAL TO THE ENGINEER. c. BEFORE INSTALLATION OF THE FILTERRA SYSTEM, CONTRACTOR SHALL OBTAIN THE WRITTEN APPROVAL OF THE ENGINEER OF RECORD FOR THE
- THE DESIGN ENGINEER OR THEIR REPRESENTATIVE SHALL BE ON SITE FOR THE INSTALLATION OF ESSENTIAL ELEMENTS OF STORMWATER CONTROL MEASURE INCLUDING BUT NOT LIMITED TO THE FLOW SPLITTERS, UNDERDRAIN CONNECTIONS, VAULT, AND TREE/PLANTINGS. THE CONTRACTOR SHALL NOTIFY THE DESIGN ENGINEER 72 HOURS PRIOR TO INSTALLATION OF THESE ITEMS TO ENSURE THAT A REPRESENTATIVE CAN BE ON SITE. PHOTOGRAPHS OF THESE ITEMS MUST BE TAKEN PRIOR TO BACKFILLING FOR USE IN THE AS-BUILT PHASE. IF THE CONTRACTOR INSTALLS THESE ITEMS WITHOUT THE ENGINEER OR ENGINEER'S REPRESENTATIVE ON SITE, THEN THE ELEMENTS SHALL BE UNCOVERED FOR INSPECTION AT THE CONTRACTOR'S EXPENSE.
- 8. KEY MEASUREMENTS FOR EACH STORMWATER CONTROL ARE LISTED BELOW
- A. SCM A A.1. FILTERRA MEDIA SURFACE AREA: 24 SF A.2. VAULT SIZE:
- A.3. RCP INLET PIPE SIZE: A.4.RCP OUTLET PIPE SIZE:

/ CONSTRUCTION AREAS

- ALL CONSTRUCTION ACTIVITY RELATED TO THE PROPOSED STORMWATER CONTROL MEASURE SHALL BE PER THE DETAILS AND SPECIFICATIONS SHOWN IN THESE DRAWINGS. IF ANY DEVIATIONS ARE REQUIRED, THE DESIGN ENGINEER SHALL BE NOTIFIED OF TO APPROVE ANY PROPOSED MODIFICATIONS PRIOR TO IMPLEMENTATION
- 10. THE CONTRACTOR SHALL NOTIFY THE DESIGN ENGINEER WHEN INSTALLATION IS COMPLETE SO A SYSTEM "ACTIVATION" INSPECTION CAN BE SCHEDULED. "ACTIVATION" OF THE FILTERRA WILL BE PROVIDED BY CONTECH ENGINEERED SOLUTIONS WHEN CONSTRUCTION IS COMPLETE AND ADJOINING PAVEMENTS AND LANDSCAPING HAVE BEEN INSTALLED.
- 11. THE FILTERRA SYSTEM SHALL NOT BE USED AS A TEMPORARY EROSION CONTROL DEVICE DURING CONSTRUCTION.
- 12. IT IS ANTICIPATED THAT DEWATERING MAY BE NECESSARY IN THE EXCAVATION AREAS (E.G. SUB GRADE, INTERIOR PORTIONS OF THE STORMWATER CONTROL MEASURE, ETC.). THEREFORE, THE CONTRACTOR SHALL FURNISH, INSTALL, OPERATE, AND MAINTAIN ANY PUMPING EQUIPMENT, ETC. NEEDED FOR REMOVAL OF WATER FROM VARIOUS PARTS OF THE STORMWATER CONTROL MEASURE SITE. A. DURING PLACEMENT OF FILL WITHIN THESE AREAS, THE CONTRACTOR SHALL KEEP THE WATER LEVEL BELOW THE BOTTOM OF THE EXCAVATION
- B. THE MANNER IN WHICH THE WATER IS REMOVED SHALL BE SUCH THAT THE EXCAVATION BOTTOM AND SIDE SLOPES ARE STABLE, WITH NO SEDIMENT DISCHARGED FROM THE SITE (I.E. PUMPED WATER SHALL BE DIRECTED TO AN APPROVED EROSION CONTROL DEVICE PRIOR TO DISCHARGE).

CONSTRUCTION SEQUENCE FOR BIORETENTION AREA

- 1. PRIOR TO CONSTRUCTION AS APPLICABLE, THE OWNER SHALL OBTAIN A LAND DISTURBING (GRADING OR EROSION CONTROL) PERMIT AND AN "APPROVAL TO CONSTRUCT" FROM THE ILOCAL JURISDICTION OR STATE DEPENDING AND ALL OTHER NECESSARY PERMITS FROM APPLICABLE AGENCIES (E.G. 404/401 PERMITS).
- 2. INSTALL ALL SEDIMENT AND EROSION CONTROL MEASURES PER THE APPROVED SEDIMENT AND EROSION CONTROL PLAN. THE CONTRACTOR SHALL MAINTAIN ALL APPROVED SEDIMENT AND EROSION CONTROL MEASURES THROUGHOUT THE ENTIRE PROJECT SITE AND DURATION, AS REQUIRED. THE CONTRACTOR SHALL RECEIVE APPROVAL FROM THE EROSION CONTROL INSPECTOR, AS REQUIRED BY GOVERNING AGENCIES, PRIOR TO ANY CLEARING
- 3. THE AREAS ON WHICH ANY FILL IS TO BE PLACED SHALL BE CLEARED AND STRIPPED OF TOPSOIL, TREES, ROOTS, VEGETATION, AND OTHER OBJECTIONABLE MATERIAL GREATER THAN 6-IN IN SIZE. THE AREAS ON WHICH FILL IS TO BE PLACED SHALL BE SCARIFIED AT LEAST 6 IN DEEP PRIOR TO PLACEMENT OF NEW FILL.
- 4. FOUNDATION AREAS MAY REQUIRE UNDERCUTTING OF COMPRESSIBLE AND/OR UNSUITABLE SOILS IN ADDITION TO THAT INDICATED ON THE PLANS. ALL SUCH UNDERCUTTING SHALL BE PERFORMED AT THE DISCRETION OF THE GEOTECHNICAL ENGINEER AND SHALL BE MONITORED AND DOCUMENTED. IN NO CASE SHALL THERE BE AN ATTEMPT TO STABILIZE ANY PORTIONS OF THE FOUNDATION SOILS WITH
- 5. TREATMENT OF SEEPAGE AREAS, SUBGRADE PREPARATION, FOUNDATION DEWATERING AND ROCK FORMATION PREPARATION (I.E., TREATMENT WITH SLUSH GROUTING, DENTAL CONCRETE, ETC.) MAY BE REQUIRED AT THE DISCRETION OF THE GEOTECHNICAL ENGINEER. ALL SUCH ACTIVITIES SHALL BE CLOSELY MONITORED AND DOCUMENTED BY THE GEOTECHNICAL ENGINEER.
- 6. THE FILTERRA INSTALLATION, AND OUTLET CONNECTIONS WILL BE CONSTRUCTED ONCE THE EROSION CONTROL PHASE IS COMPLETE.
- 7. ONCE THE UPSTREAM DRAINAGE AREA IS STABILIZED AND THE EROSION CONTROL INSPECTOR APPROVES THE REMOVAL OF EROSION CONTROL MEASURES, THE CONTRACTOR SHALL REMOVE ALL SEDIMENT, TRASH, ETC. FROM THE FILTERRA AREA, WHICH SHALL BE DISPOSED OF PROPERLY (I.E. -PLACED IN A LANDFILL) AND NOT STOCKPILED IN AN AREA WHERE WATER QUALITY COULD BE ADVERSELY IMPACTED.
- 8. ONCE THE FILTERRA AREA IS CLEANED OUT, THE FINAL EXCAVATION TO THE BOTTOM OF THE OUTLET PIPE OR OTHER LOWEST ELEVATION WITHIN THE FILTERRA AREA MAY BE COMPLETED
- PRIOR TO SCHEDULING FILTERRA "ACTIVATION", THE CONTRACTOR SHALL REQUEST AN ON-SITE MEETING WITH THE DESIGN ENGINEER'S REPRESENTATIVE AND THE EROSION CONTROL INSPECTOR TO ENSURE THE UPSTREAM DRAINAGE AREA IS COMPLETELY STABILIZED (I.E. GOOD
- 10. CONTRACTOR SHALL REQUEST AN ON-SITE INSPECTION FOR "ACTIVATION" OF THE FILTERRA.
- 11. IF THE CONTRACTOR INSTALLS THE FILTERRA PRIOR TO APPROVAL FROM THE DESIGN ENGINEER AND THE EROSION CONTROL INSPECTOR, AND THE FILTERRA FAILS TO FUNCTION PROPERLY (I.E. IT WILL NOT DRAIN DUE TO SEDIMENT DEPOSITION) DUE TO AN UNSTABILIZED UPSTREAM DRAINAGE AREA, THE FILTERRA MEDIA SHALL BE REPLACED AT THE CONTRACTOR'S EXPENSE.

STATEMENT OF RESPONSIBILITY


ALL REQUIRED MAINTENANCE AND INSPECTIONS OF THIS FACILITY SHALL BE THE RESPONSIBILITY OF THE PROPERTY OWNER, PER THE EXECUTED OPERATION AND MAINTENANCE AGREEMENT FOR THIS FACILITY.

LANDSCAPE SPECIFICATIONS

THE GRADES SHOWN ON THIS PLAN ARE FINISHED GRADES. IF AFTER CONSTRUCTION/COMPACTION THE SOILS ADJACENT TO THE FILTERRA ARE NOT DETERMINED SUITABLE FOR PLANTING BY A LANDSCAPE PROFESSIONAL, THE CONTRACTOR SHALL AMEND THE SOIL AS DIRECTED BY A LANDSCAPE

COMPACTION OF SUBGRADE IN-SITU SOIL

1. IN ORDER TO PREVENT DAMAGE TO THE PIPE, NO COMPACTION EQUIPMENT SHALL CROSS ANY PIPE UNTIL MINIMUM COVER IS ESTABLISHED ALONG THE PIPE. CONTRACTOR SHALL COMPACT THE IN-SITU SOIL TO AT LEAST 95% OF THE STANDARD PROCTOR MAXIMUM DRY DENSITY (ASTM D-698). THE FILL SOILS SHALL BE COMPACTED AT A MOISTURE CONTENT WITHIN -1 TO +3 PERCENT OF ITS OPTIMUM MOISTURE CONTENT. COMPACTION TESTS SHALL BE PERFORMED BY THE ON-SITE GEOTECHNICAL ENGINEER DURING CONSTRUCTION TO VERIFY THAT THE PROPER COMPACTION LEVEL HAS BEEN REACHED. THE FILL SHOULD BE COMPACTED USING A SHEEPSFOOT TYPE COMPACTOR. MEDIA WITHIN THE FILTERRA SHALL NOT BE COMPACTED.

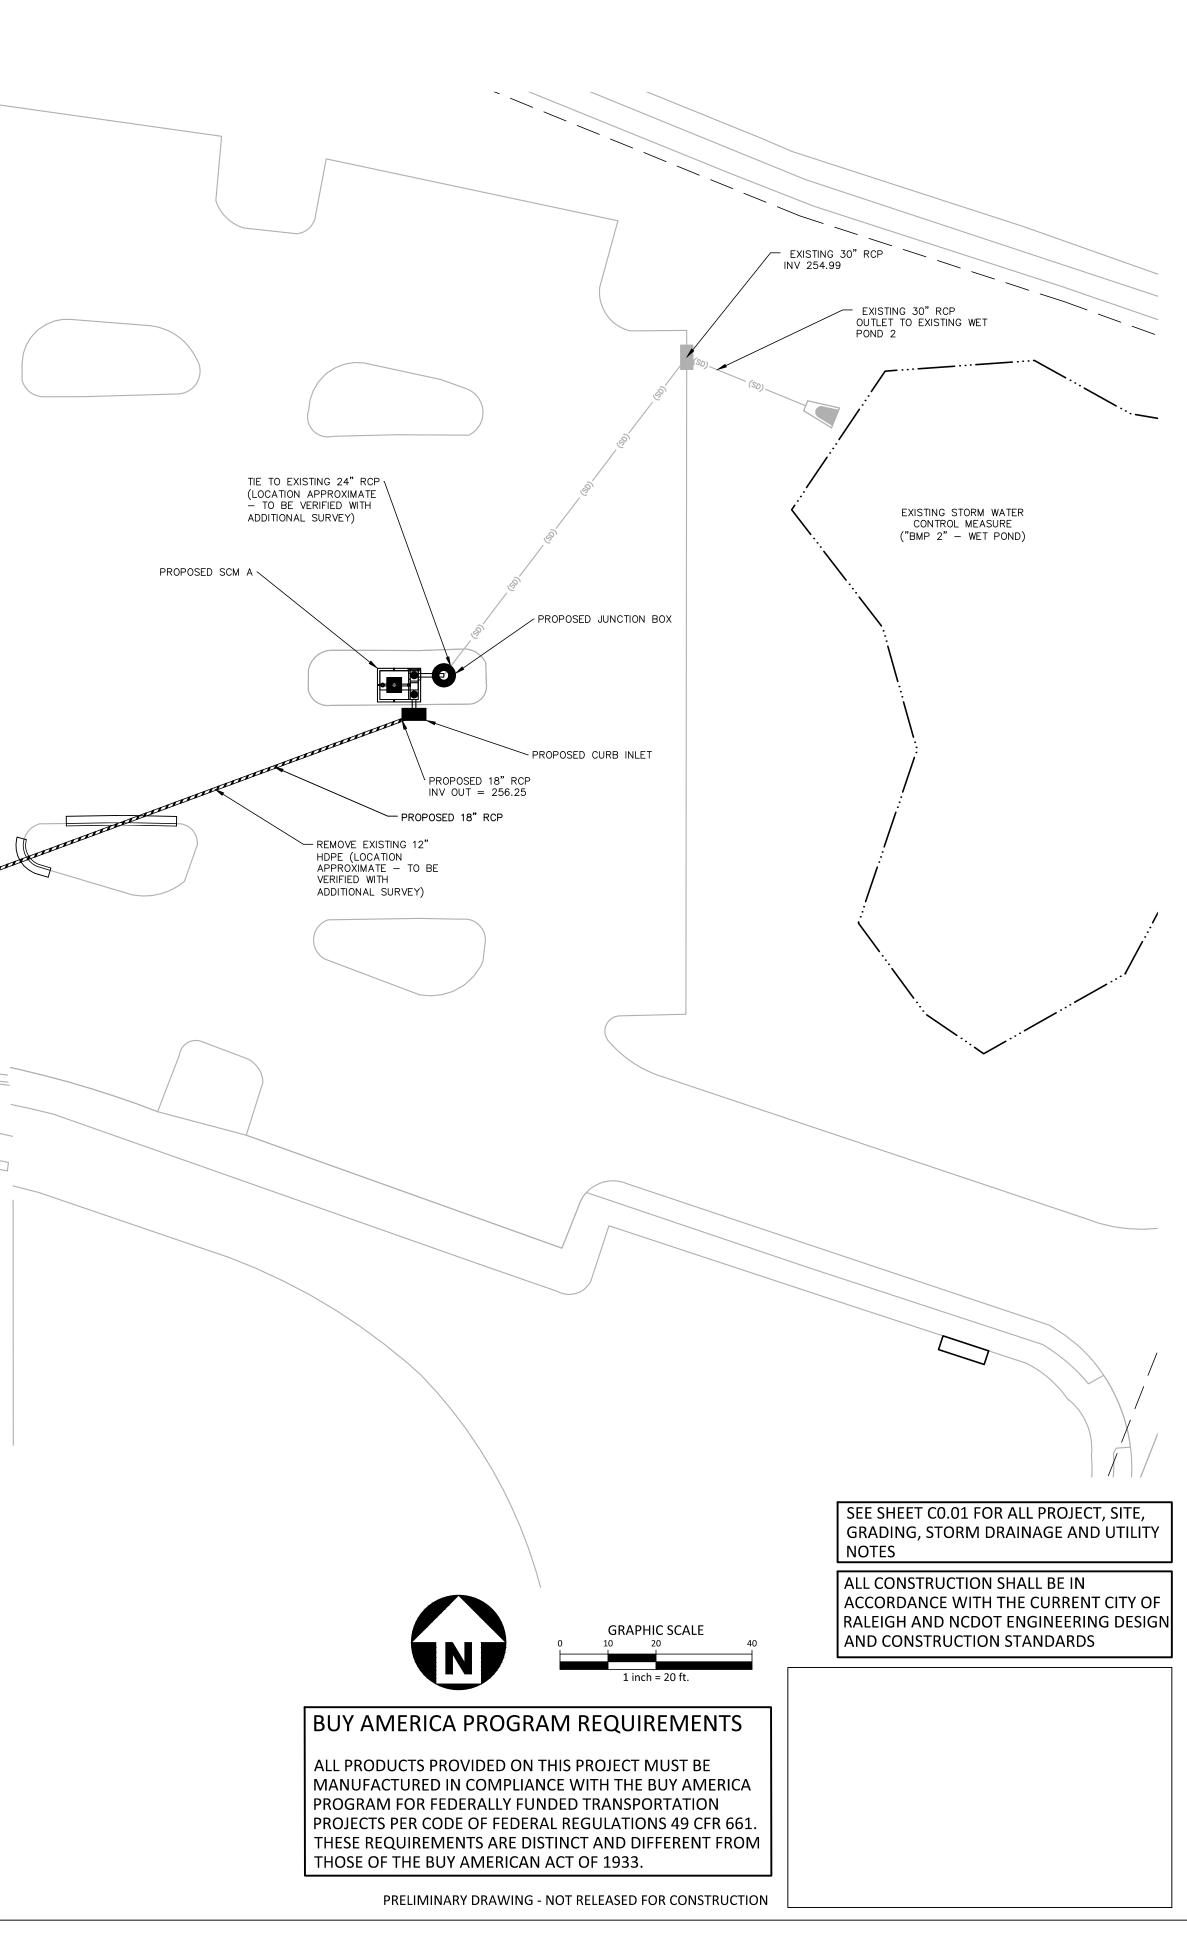



SUBCONSULTANT: The John R. McAdams Company, Inc phone 919. 823. 4300

license number: C-0293, C-183 ACADAMS www.mcadamsco.com


DESCRIPTION



PROFESSIONAL SEAL


SHEET NAME SCM A - PLAN


DESIGNED BY: DRAWN BY: KEB/RMB 11. 01. 2024

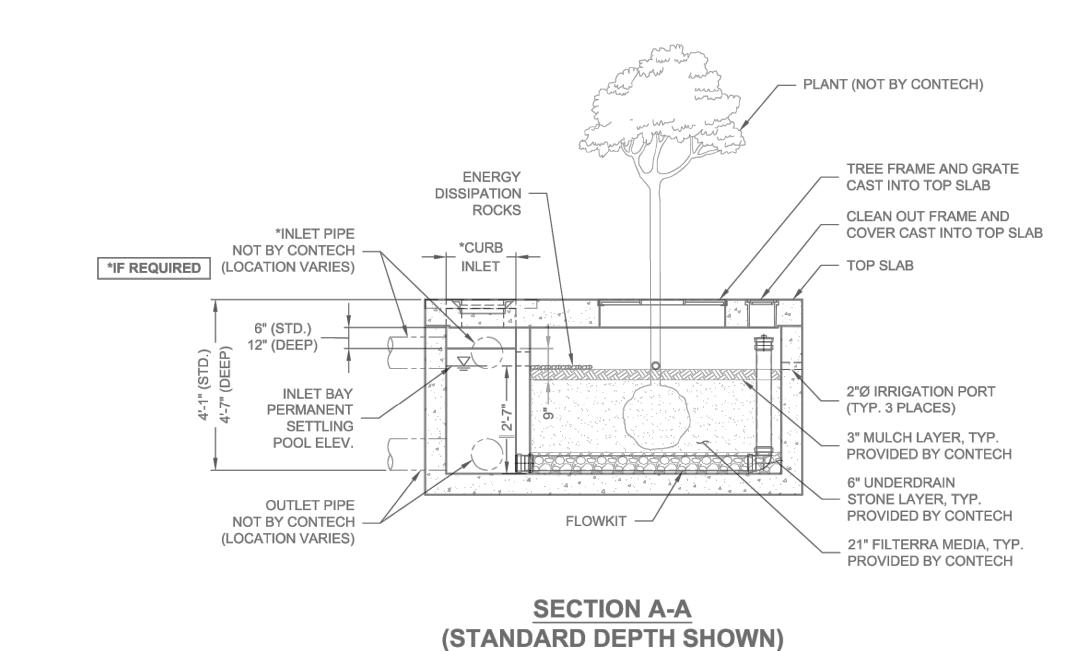

FTPD CONFIGURATION (OPTIONS: DEEP "-D", THROAT INLET "-T", PIPE INLET "-P", PIPE AND THROAT INLET "-PT') TREE INLET/ **BYPASS MEDIA MEDIA VAULT GRATE** LENGTH/ MODEL PART **OUTLET FLOW** BAY **AREA** SIZE **AVAILABILITY** MAX. NUMBER **ACCESS** NAME (CFS) (SF) SIZE $(W \times L)$ CURB AND **OPENING** SIZE STD / DEEP FTPD 4x4 (1) 3' x 3' ALL 4 x 4 4 x 6 1'-8" 1.4 / 4.6 12"/12" FTPD0404 (4x6 VAULT) FTPD 4x6 FTPD0406 24 4 x 6 4 x 8 1'-8" 1.4 / 4.6 12"/12" (1) 3' x 3' (4x8 VAULT) (EXCEPT DE, MD, NJ, PA, VA, WV) FTPD 6x4 ALL (1) 3' x 3' 24 12"/12" 6 x 4 6 x 6 1'-8" 1.4 / 4.6 (6x6 VAULT) (EXCEPT CA, TX) FTPD 4.5x5.8 DE, MD, NJ, PA, VA, FTPD045058 26 4.5 x 5.83 4.5 x 7.83 1'-8" 1.4 / 4.6 12"/12" (1) 3' x 3' (4.5x7.8 VAULT) WV ONLY FTPD 6x6 (1) 3' x 3' ALL 6 x 6 6 x 8 1'-8" 12"/12" FTPD0606 1.4 / 4.6 (6x8 VAULT) FTPD 6x8 ALL (1) 4' x 4' FTPD0608 48 6 x 8 6 x 10 1'-8" 1.4 / 4.6 12"/12" (6x10 VAULT) (EXCEPT CA, TX) FTPD 8x7 CA, TX ONLY 56 8 x 10 $(1) 4' \times 4'$ FTPD0807 8 x 7 2'-6" 2.1 / 6.8 24"/24" (8x10 VAULT) FTPD 6x10 6 x 12 12"/12" (1) 4' x 4' FTPD0610 60 6 x 10 1'-8" 1.4 / 4.6 (6x12 VAULT) (EXCEPT CA, TX) FTPD 7x10 7 x 13 (1) 4' x 4' FTPD0710 70 7 x 10 2'-6" 2.1 / 6.8 24"/24" (7x13 VAULT) (EXCEPT CA, TX) FTPD 8x9 FTPD0809 CA, TX ONLY 72 8 x 9 8 x 12 2' -6" 24"/24" (1) 4' x 4' 2.1 / 6.8 (8x12 VAULT) FTPD 8x10.5 FTPD08105 84 8 x 14 3'-0" 24"/24" (1) 4' x 4' ALL 8 x 10.5 2.5 / 8.2 (8x14 VAULT) FTPD 8x12.5 FTPD08125 100 8 x 12.5 8 x 16 3'-0" 24"/24" (2) 4' x 4' 2.5 / 8.2 (8x16 VAULT) (EXCEPT OR, WA) FTPD 9x11.5 OR, WA ONLY 103 (2) 4' x 4' FTPD09115 9 x 11.5 9 x 15 3'-0" 24"/24" 2.5 / 8.2

*MAX. BYPASS FLOW IS INTERNAL WEIR FLOW. CAPACITIES SHOWN ARE FOR STANDARD DEPTH AND DEEP (-D), RESPECTIVELY. SITE SPECIFIC ANALYSIS IS REQUIRED TO DETERMINE CURB INLET FLOW CAPACITY.

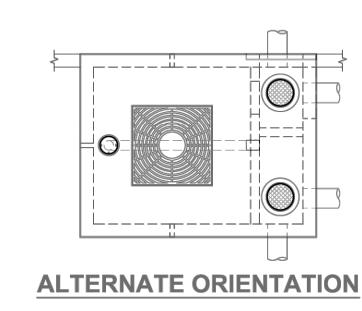

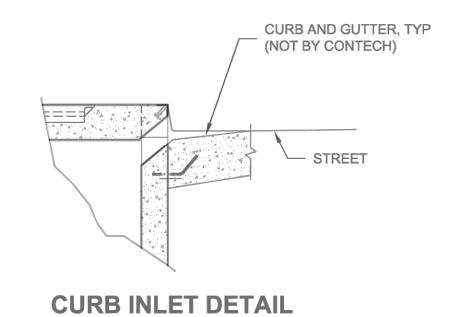

HIGH-FLOW PASS-TROUGH TREATMENT SCM DETAIL

(9x15 VAULT)

SEE SHEET CO.01 FOR ALL PROJECT, SITE, GRADING, STORM DRAINAGE AND UTILITY

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BUY AMERICA PROGRAM REQUIREMENTS

PRELIMINARY DRAWING - NOT RELEASED FOR CONSTRUCTION

PRIME CONSULTANT: 434 Fayetteville Street Raleigh, NC 27604

> SUBCONSULTANT: phone 919. 823. 4300 license number: C-0293, C-183

MCADAMS www.mcadamsco.com DESCRIPTION

NOT FOR CONSTRUCTION


PROFESSIONAL SEAL

SHEET NAME SCM A - DETAILS


DESIGNED BY: DRAWN BY: KEB/RMB

11. 01. 2024 FULL SCALE SHEET SIZE= ANSI- D (22"x 34")

INTERNAL PIPE CONFIGURATION MAY VARY DEPENDING UPON OUTLET LOCATION

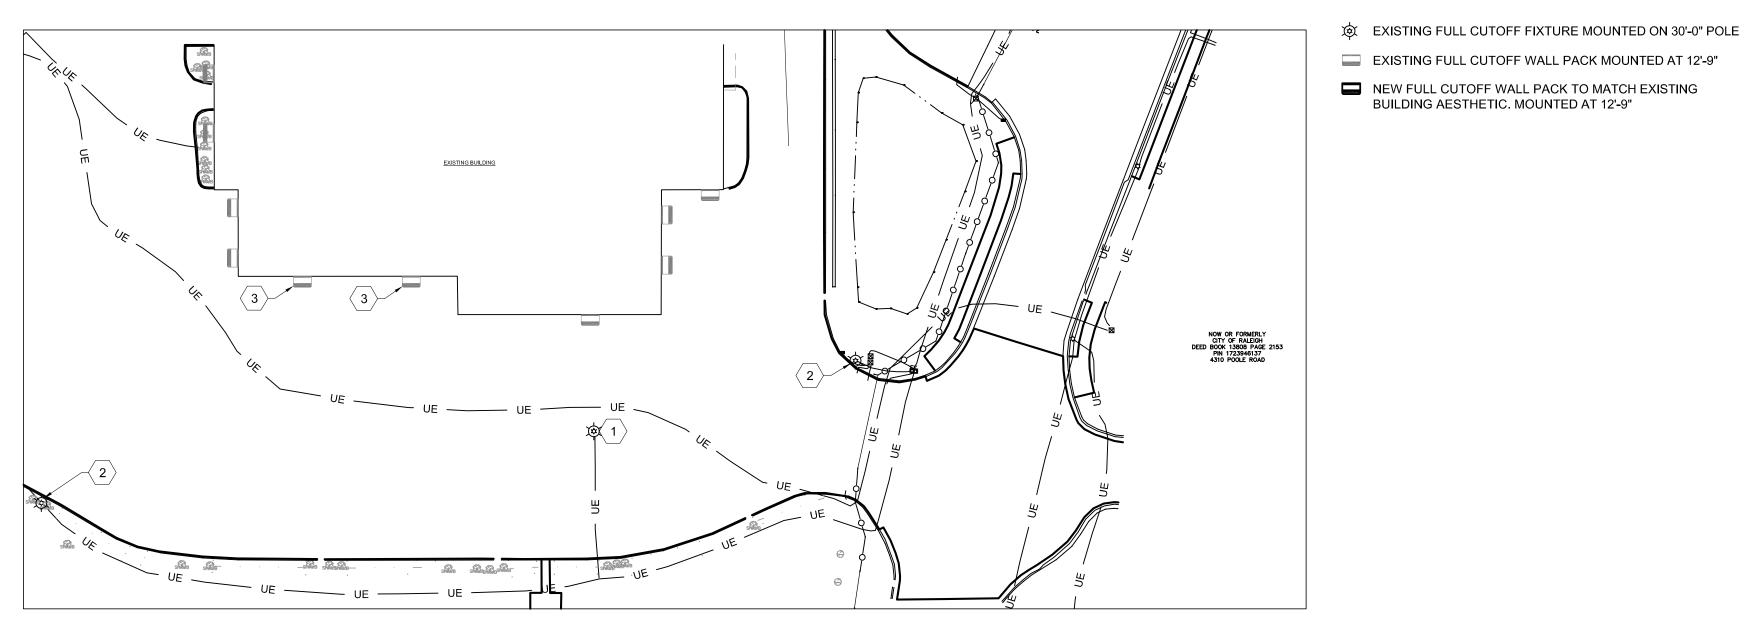


ELECTRICAL SITE PLAN - EXISTING SCALE:: 1"=40'-0"

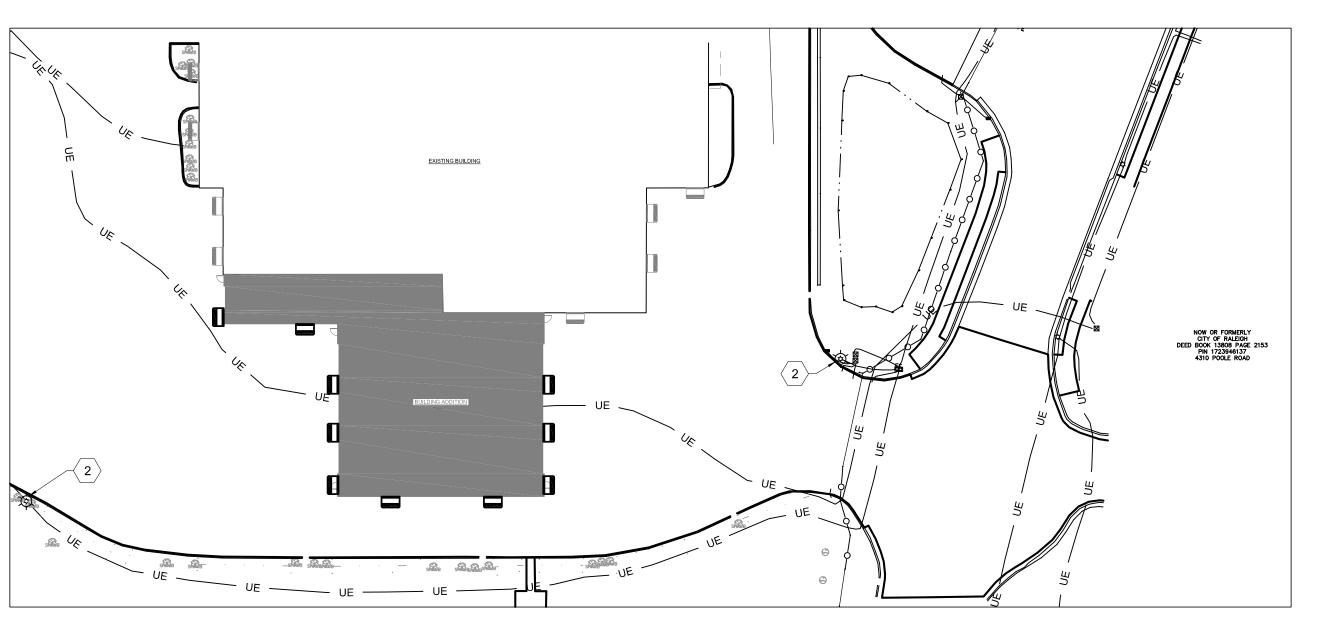

ELECTRICAL SITE PLAN - NEW WORK



NEW FULL CUTOFF WALLPACKS TO MATCH BUILDING ASTHETIC ES101 SCALE: NO SCALE

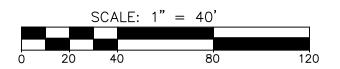

GENERAL NOTES:

KEYED NOTES:

SOURCE.

BUILDING AESTHETIC. MOUNTED AT 12'-9"

- THERE ARE NO NEW POLE LIGHTS WITHIN THE SCOPE OF THIS PROJECT. THE ONLY NEW LIGHTING IS BUILDING MOUNTED.
- SEE BUILDING ELECTRICAL FLOOR
 PLANS FOR ADDITIONAL
 INFORMATION RELATED TO THE
 CIRCUITING AND CONTROL OF THE NEW FIXTURES.

EXISTING POLE MOUNTED FIXTURE TO BE DEMOLISHED. DEMOLISH FIXTURE, POLE, AND

2 EXISTING POLE MOUNTED FIXTURE TO REMAIN.

CONCRETE BASE. DEMOLISH CIRCUIT BRANCH BACK TO

EXISTING WALLPACK TO BE DEMOLISHED. DEMOLISH CIRCUIT BACK TO NEAREST FIXTURE ON THE SAME CIRCUIT TO REMAIN.

CIRCUIT TO BE EXTENDED FOR NEW WALL MOUNTED FIXTURES

DURING NEW CONSTRUCTION.



• ENGINEERED DESIGNS INC.

PRIME CONSULTANT:

1151 SE Cary Parkway, Suite 200 Cary, North Carolina 27518

P 919.051.040	l	esigns.com
REV	DESCRIPTION	DATE

FOR REVIEW ONLY

Not for Construction

Preliminary Plans


PROFESSIONAL SEAL

SHEET NAME SITE LIGHTING PLAN

DESIGNED BY:	CJB
DRAWN BY:	CJB
CHECKED BY:	CJB
DATE:	10-25-2024
SCALE:	1" = 40'-0"
	FULL SCALE SHEET SIZE= ANSI- D (22"x 34")

ES101

 $\underline{WARNING:}$ THESE DRAWINGS THE PROPERTY OF THE PRIME CONSULTANT NOTED HEREWITHIN. ANY RE-USE OF THIS WORK WITHOUT WRITTEN CONSENT IS AN INFRINGEMENT OF THE ARCHITECT OR ENGINEER'S WORK. IT IS A VIOLATION OF THE LAW FOR ANY PERSON, UNLESS ACTING UNDER THE DIRECT SUPERVISION OF A LICENSED ARCHITECT OR ENGINEER'S WORK. IT IS A VIOLATION OF THE LAW FOR ANY PERSON, UNLESS ACTING UNDER THE DIRECT SUPERVISION OF A LICENSED ARCHITECT OR ENGINEER'S WORK. IT IS A VIOLATION OF THE LAW FOR ANY PERSON, UNLESS ACTING UNDER THE DIRECT SUPERVISION OF THE ALTERATION.

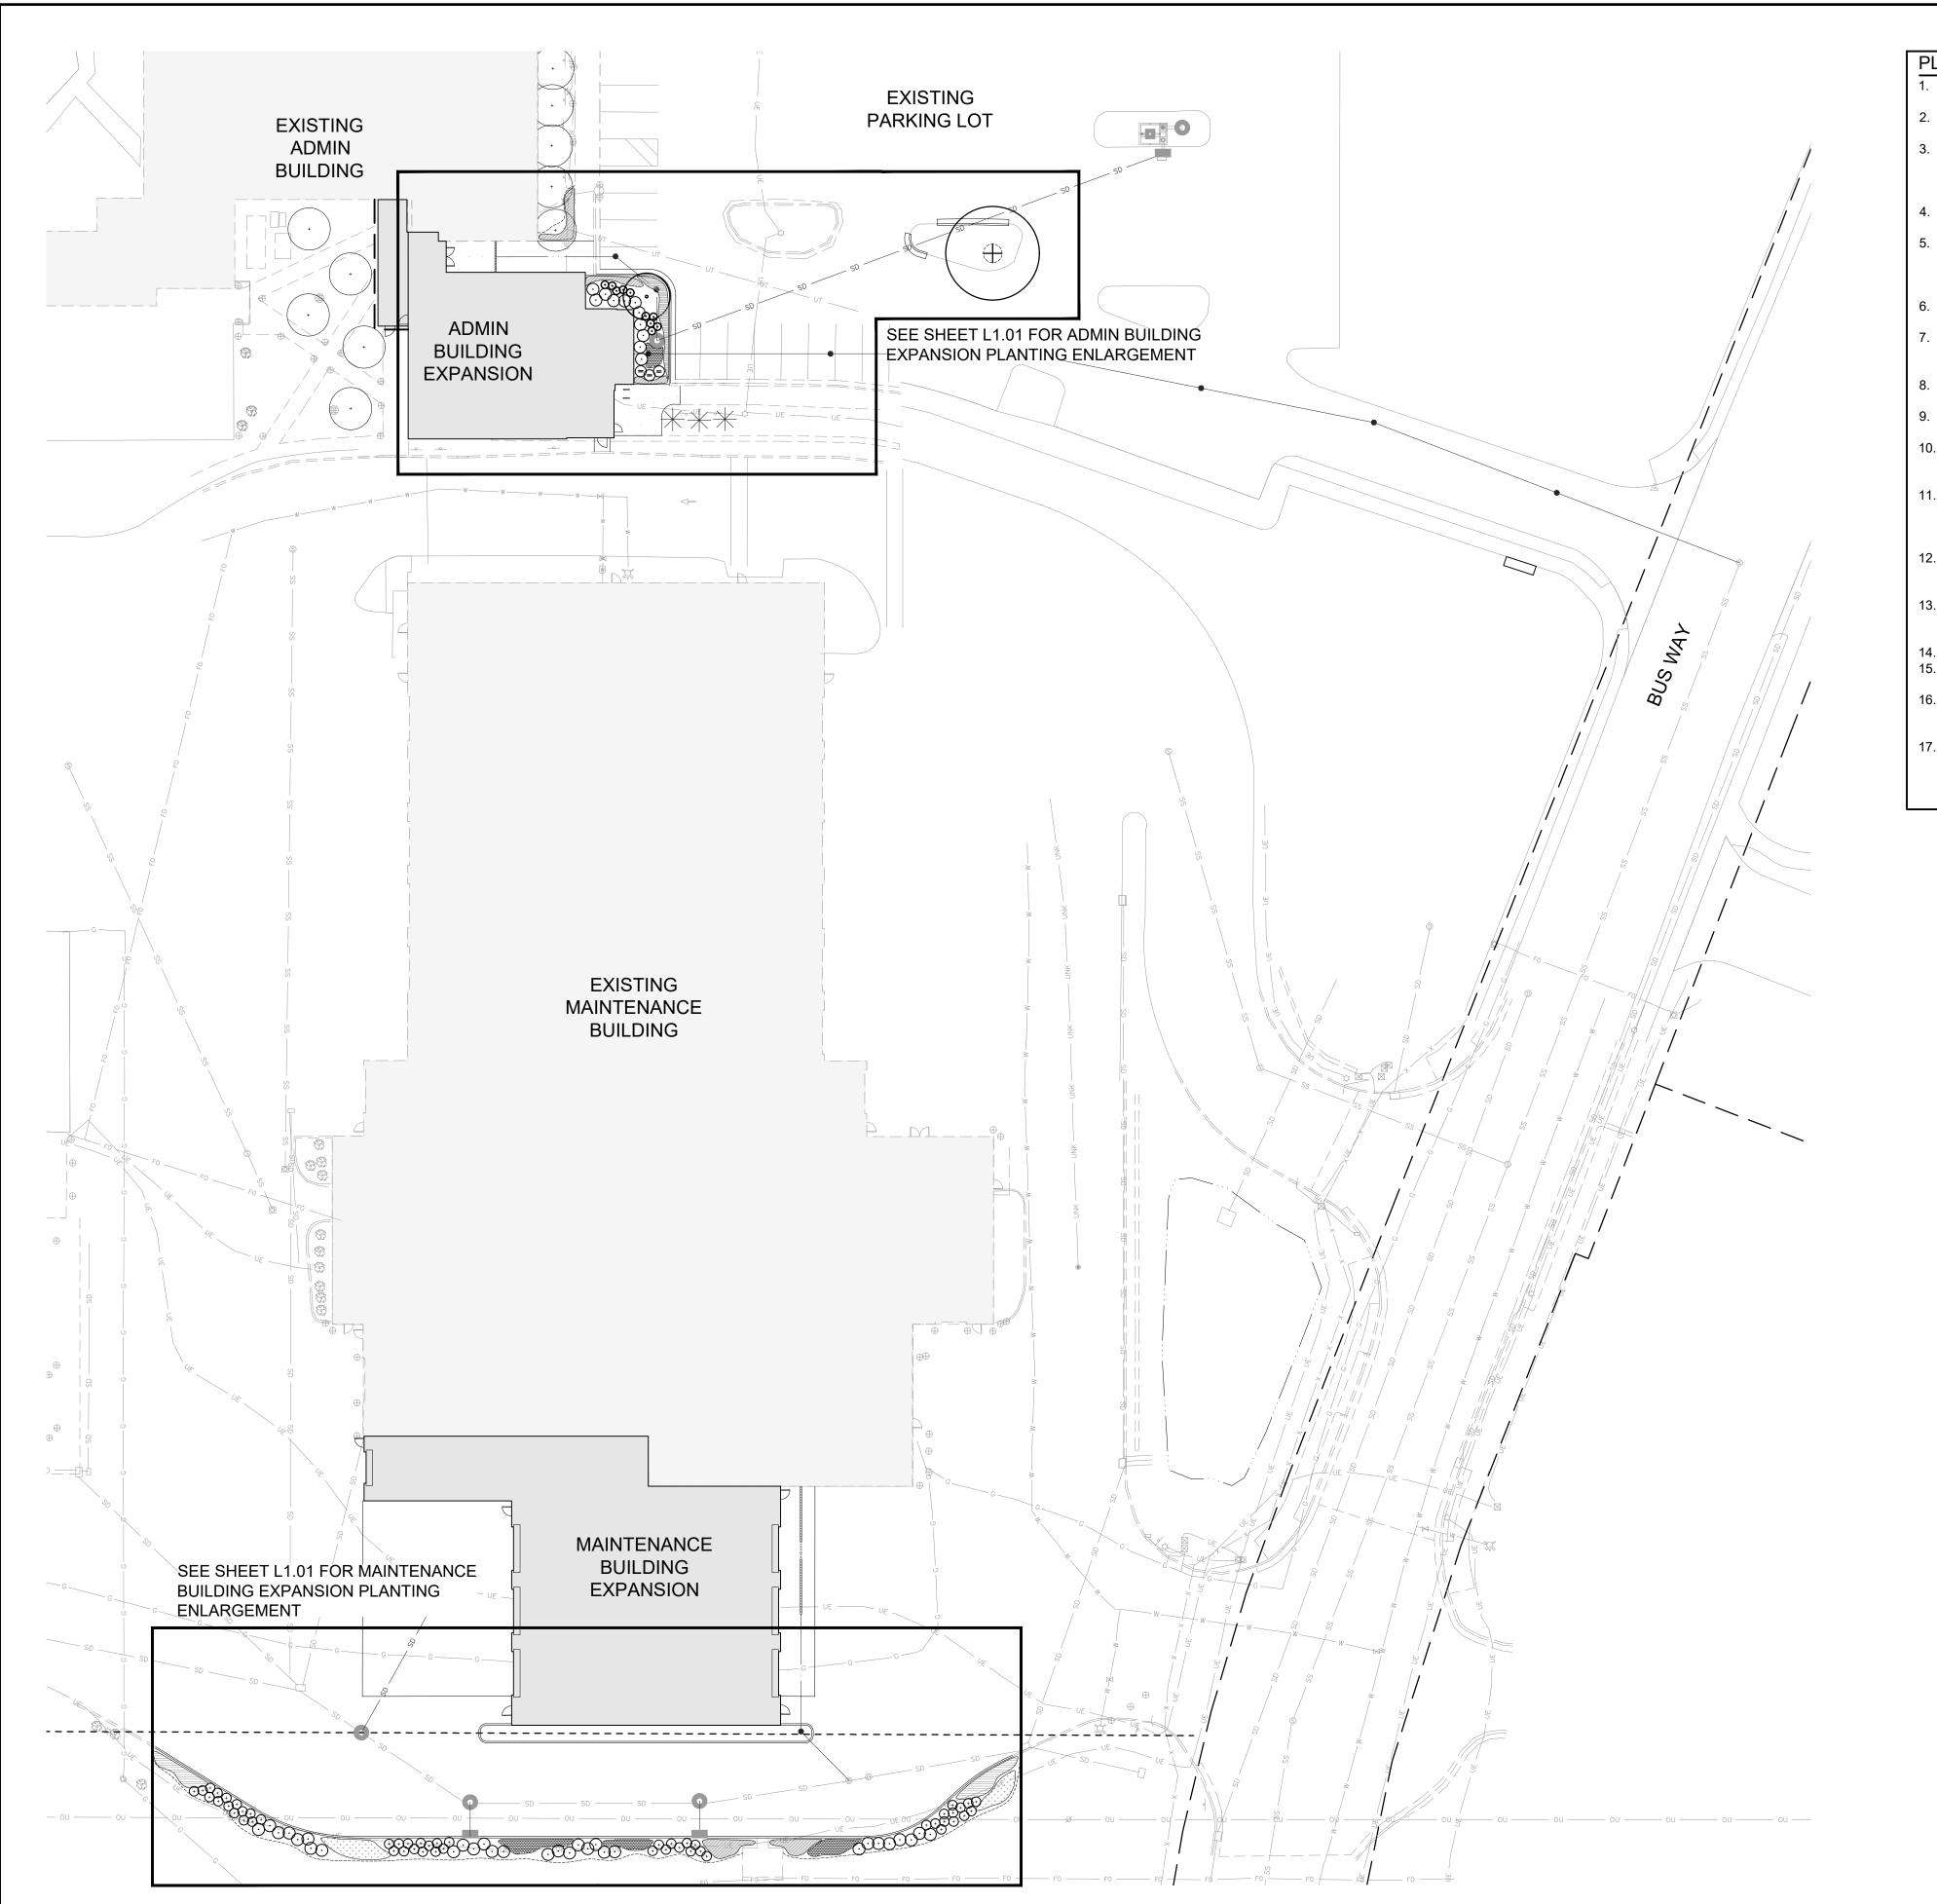


WARNING: THESE DRAWINGS THE PROPERTY OF THE PROPERTY OF THE PROPERTY OF THE PROMED BY THEIR SIGNATURE AND THE NOTATION AND THE ARCHITECT OR ENGINEER, TO ALTER AN ITEM BEARING THE SEAL OF AN ARCHITECT OR ENGINEER SHOULT WITHOUT WRITTEN CONSULT ANT THE ARCHITECT OR ENGINEER SHOULT AND THE ARCHITECT OR ENGINEER SHOULT AND THE ARCHITECT OR ENGINEER, TO ALTER AN ITEM BEARING THE PROPERTY OF THE PROPERTY OF THE ARCHITECT OR ENGINEER, TO ALTER AN ITEM BEARING THE SEAL OF AN ARCHITECT OR ENGINEER, TO ALTER AND THE ARCHITECT OR ENGINEER, TO ALTER AN ITEM BEARING THE SEAL AND THE ARCHITECT OR ENGINEER, TO ALTER AND THE ARCHITECT OR ENGINEER, TO ALTER AN ITEM BEARING THE SEAL AND THE ARCHITECT OR ENGINEER, TO ALTER AND THE ARCHITECT OR ENGINEER AN

PLANTING NOTES:


- 1. THE LANDSCAPE PLANTING CONTRACTOR SHALL BE A LICENSED LANDSCAPE
- CONTRACTOR IN NC, AND SHALL PROVIDE PROOF OF LICENSE AFTER BIDDING. CONTRACTOR SHALL FIELD VERIFY ALL DIMENSIONS, DEPTHS, QUANTITIES, DISTANCES, ANGLES AND SLOPES PRIOR TO ORDERING MATERIALS OR INSTALLING PROJECT.
- CONTRACTOR SHALL ACCEPT ACTUAL CONDITIONS AT THE SITE AND PERFORM THE WORK SPECIFIED WITHOUT ADDITIONAL COMPENSATION FOR POSSIBLE VARIATION FROM GRADES AND CONDITIONS SHOWN WHETHER SURFACE OR SUBSURFACE, EXCEPT AS PROVIDED FOR BY THE CONTRACT DOCUMENTS.
- CONTRACTOR SHALL OBTAIN WRITTEN APPROVAL FROM LANDSCAPE ARCHITECT FOR ANY PLANT SUBSTITUTIONS OF SPECIES, SIZES, OR TYPE OF CONTAINER.
- CONTRACTOR SHALL LOCATE ALL UNDERGROUND UTILITIES PRIOR TO CONSTRUCTION, AND SHALL BE RESPONSIBLE FOR THE PROTECTION OF THESE UTILITIES DURING THE CONSTRUCTION OF THE PROJECT, AND SHALL PROMPTLY REPAIR AND RESTORE SERVICES AT NO ADDITIONAL COST TO THE OWNER.
- THE CONTRACTOR SHALL VISIT THE SITE. FAMILIARIZE HIMSELF WITH ACTUAL CONDITIONS AND VERIFY EXISTING CONDITIONS IN THE FIELD.
- CONTRACTOR SHALL MAINTAIN CAREFULLY ALL BENCH MARKS, MONUMENTS AND OTHER REFERENCED POINTS. IF DISTURBED OR DESTROYED, THE CONTRACTOR SHALL REPLACE AS DIRECTED AT NO ADDITIONAL COST TO THE OWNER.
- CONTRACTOR SHALL BECOME THOROUGHLY FAMILIAR WITH THE FULL SET OF CONSTRUCTION DRAWINGS AND SPECIFICATIONS FOR COORDINATION WITH UTILITIES.
- CONTRACTOR WILL LEAVE DISTURBED AREAS LEVEL AND RAKED SMOOTH, REMOVING ALL ROCKS AND DEBRIS.
- 10. IF FORMAL ARRANGEMENTS OR CONSECUTIVE ORDER OF TREES OR SHRUBS IS SHOWN, SELECT STOCK FOR UNIFORM HEIGHT AND SPREAD FROM SAME SOURCE TO ASSURE SYMMETRY IN PLANTING.
- 11. IF ANY EXISTING CONDITIONS OUTSIDE THE CONTRACT LIMITS, CURBS, SIDEWALKS, TURF AREAS AND PAVING ARE DAMAGED IN PERFORMANCE OF THIS WORK, THEY SHALL BE RESTORED WITHOUT EXTRA COST TO THE OWNER IN THE MANNER PRESCRIBED BY AUTHORITIES HAVING JURISDICTION.
- 12. CONTRACTOR SHALL REPORT ALL DISCREPANCIES TO LANDSCAPE ARCHITECT. IN CASE OF DISCREPANCY BETWEEN THE QUANTITY OF PLANTS ON THE PLANS COMPARED TO THE PLANT LIST, THE CONTRACTOR SHALL SUPPLY QUANTITIES AS DRAWN ON PLANS.
- 13. CONTRACTOR SHALL SEED ALL AREAS DISTURBED DURING INSTALLATION NOT SPECIFIED TO BE COVERED BY MULCH. AREAS DAMAGED FROM ACTIVITIES OF CONTRACTOR TO BE RESEEDED AND ESTABLISHED AT NO ADDITIONAL COST TO THE OWNER.
- 14. CONTRACTOR TO PREPARE PLANTING BEDS PER THE SPECIFICATIONS. 15. CONTRACTOR IS RESPONSIBLE FOR IMPORTING. TESTING AND PREPARING THE SOIL ON
- SITE PER THE SPECIFICATIONS. 16. ALL SIX FOOT MULCH RINGS AND STAND ALONE MULCH AREAS SHALL BE BE MULCHED WITH TRIPLE SHREDDED HARDWOOD MULCH UNLESS OTHERWISE NOTED ON THE
- 17. MULCH WILL BE A 3" LAYER OF TRIPLE SHREDDED HARDWOOD MULCH. ALL AREAS WITHIN PROJECT LIMITS SHALL BE EITHER PAVED, SEEDED, SODDED OR MULCHED. SUBMIT SAMPLES FOR APPROVAL.

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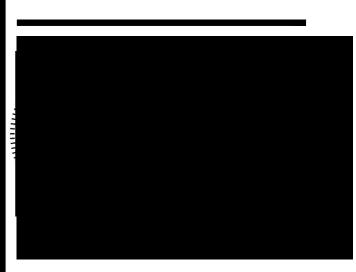


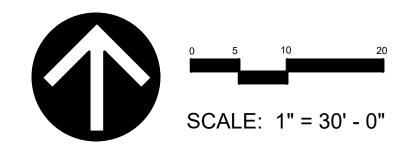

SUBCONSULTANT: Susan

Architecture, PLLC 711 W. North Street Raleigh, NC 27603 Tel.: +1 919 838 9600

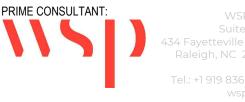
Landscape Architecture, PLLC DESCRIPTION




PROFESSIONAL SEAL

SHEET NAME OVERALL SITE PLAN

DESIGNED BY: CHECKED BY: FULL SCALE SHEET SIZE= ANSI- D (22"x 34")

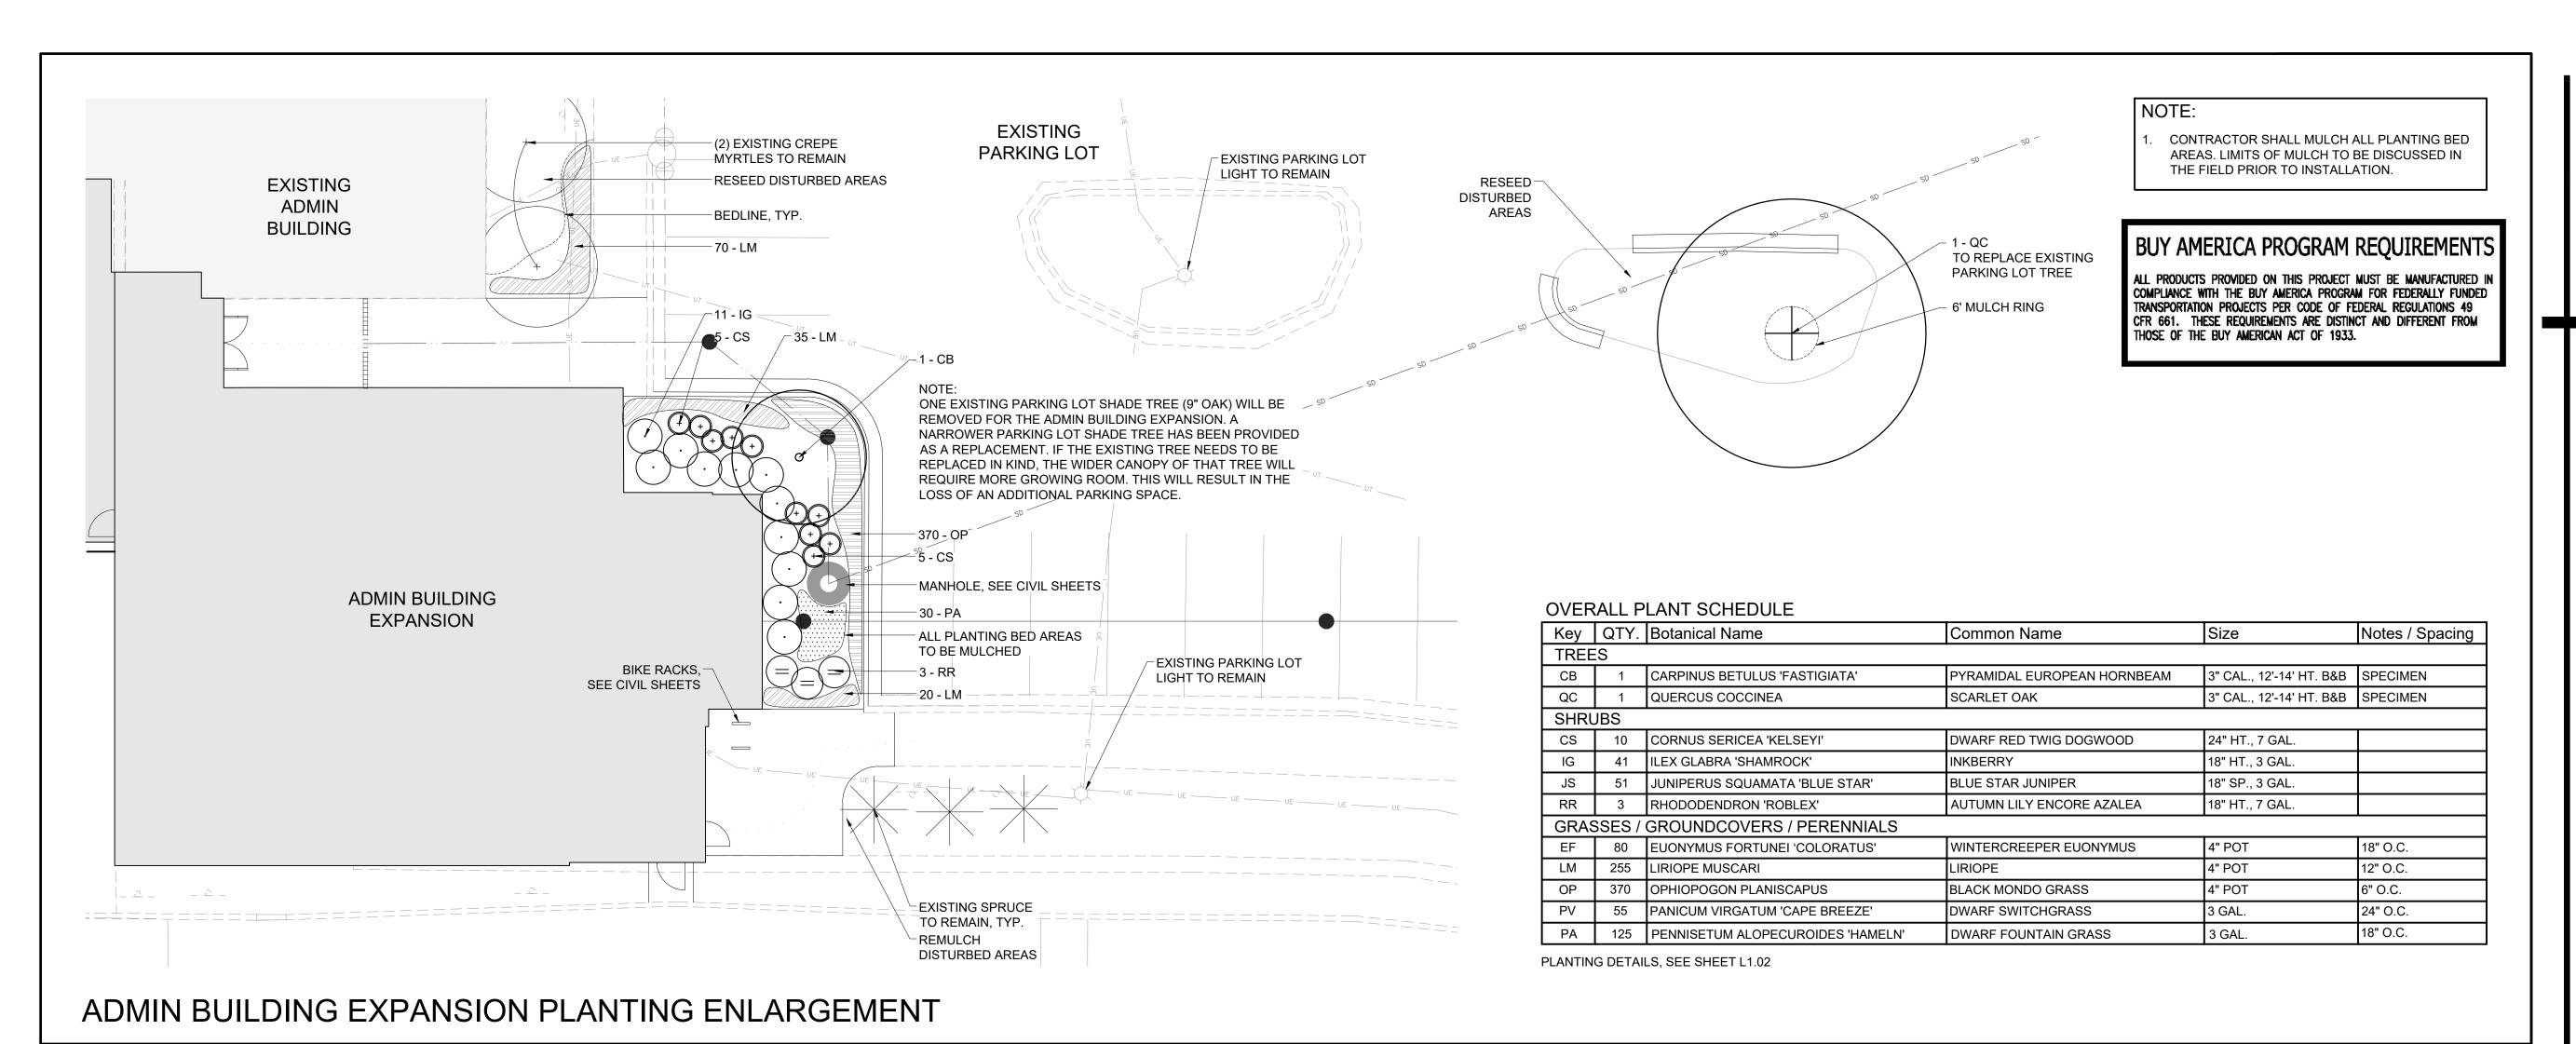

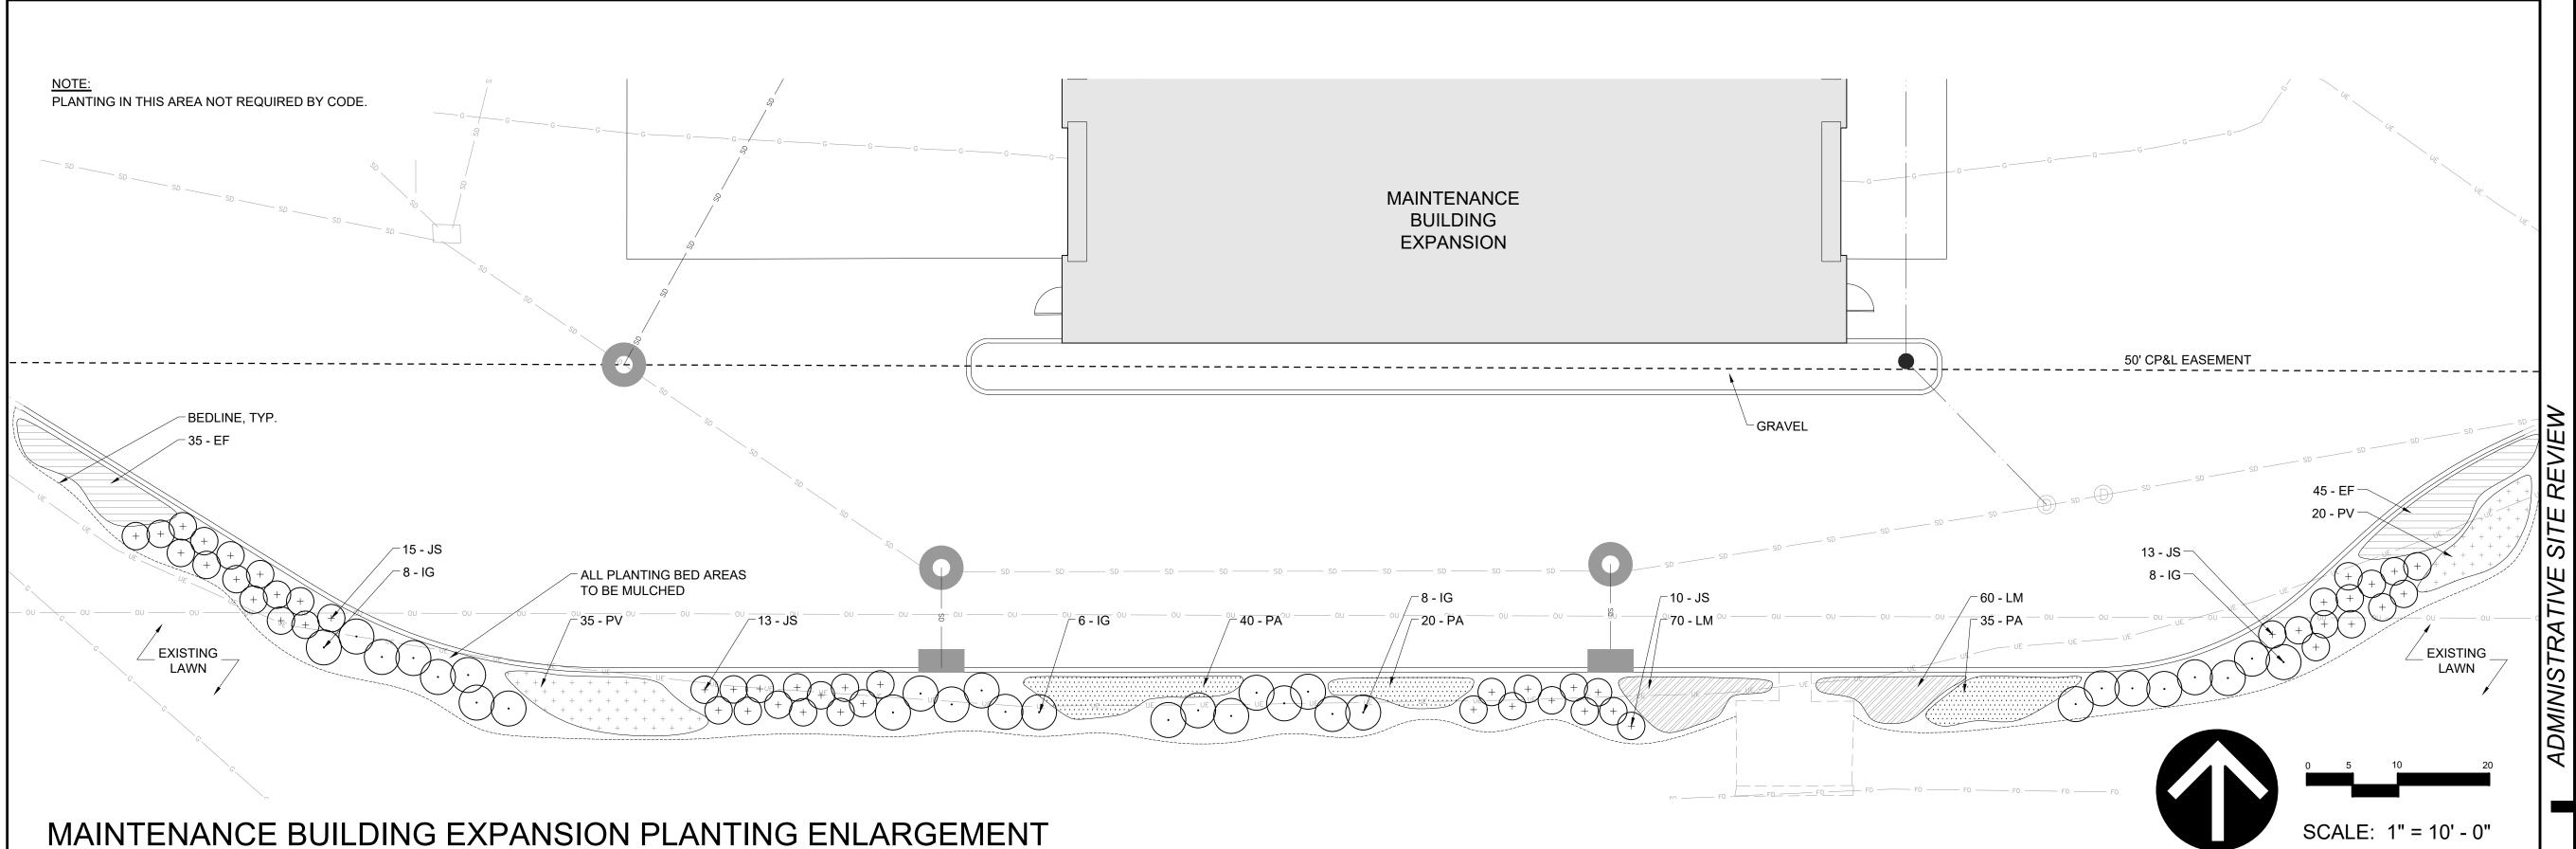








SUBCONSULTANT: Architecture, PLLC 711 W. North Street Raleigh, NC 27603 Tel.: +1 919 838 9600

DESCRIPTION


PLANTING PLAN

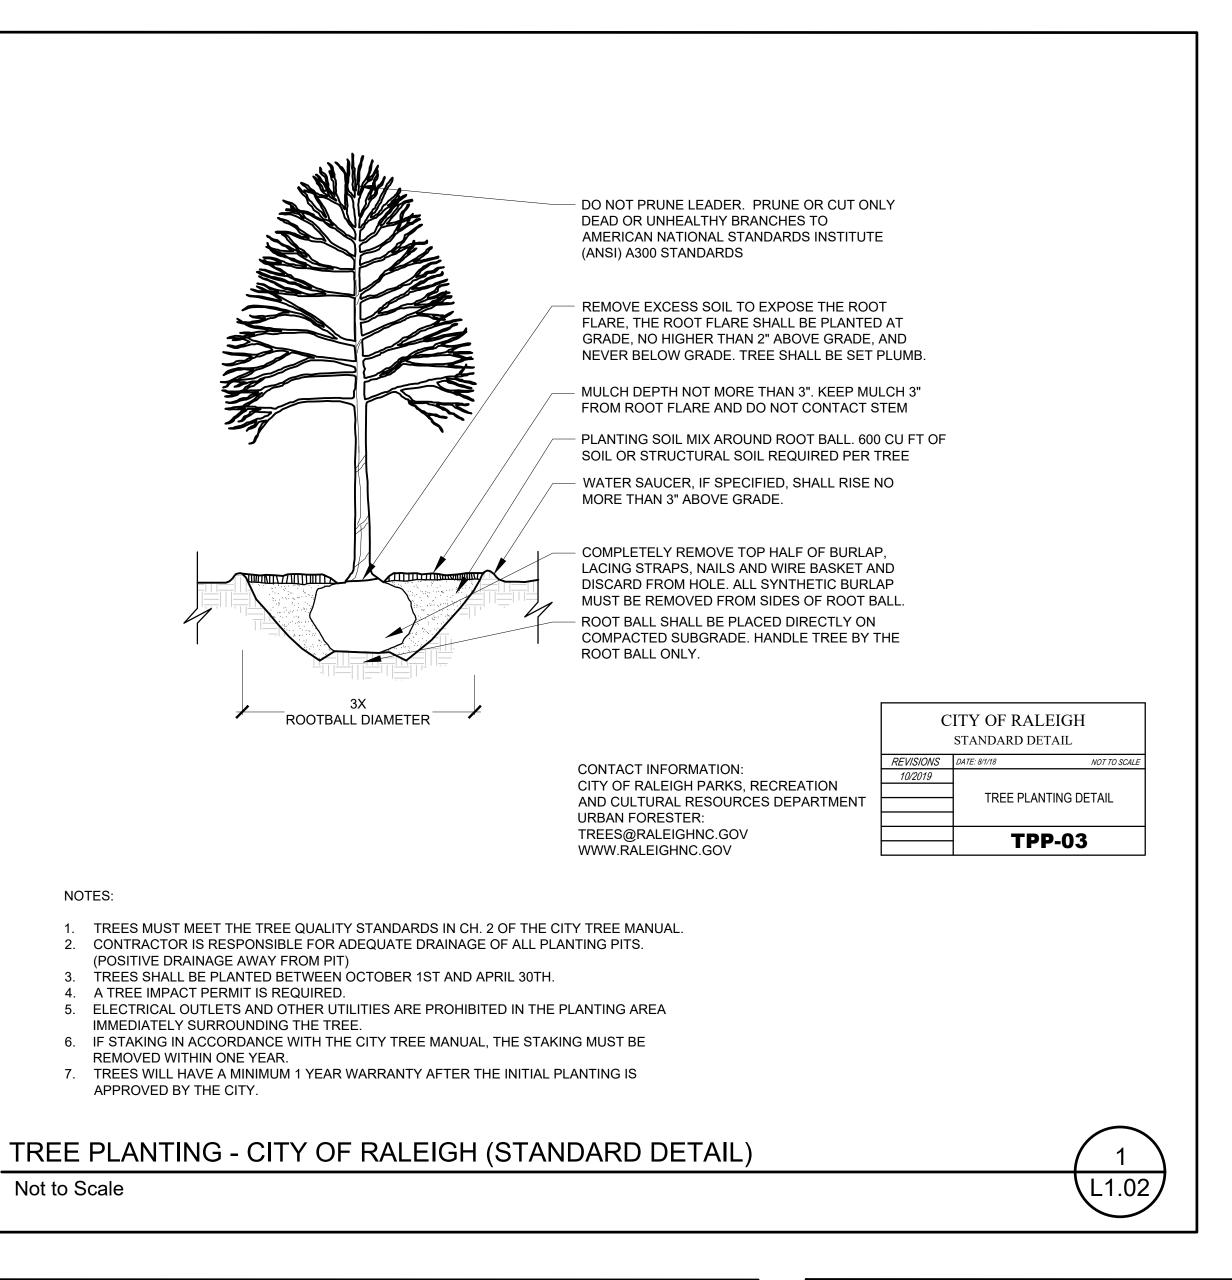

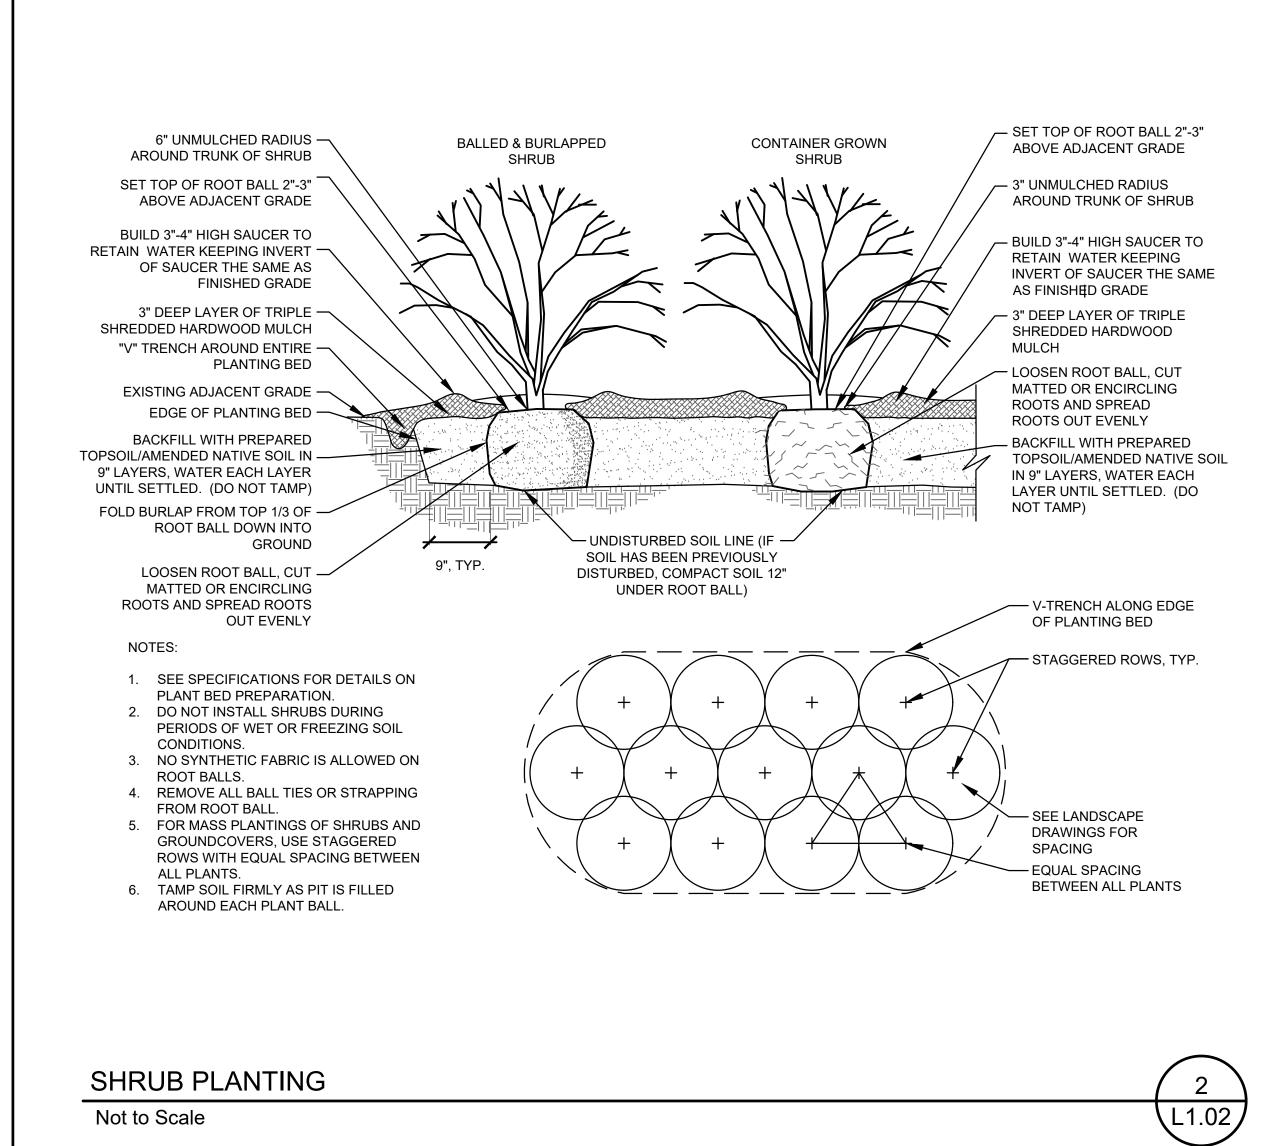

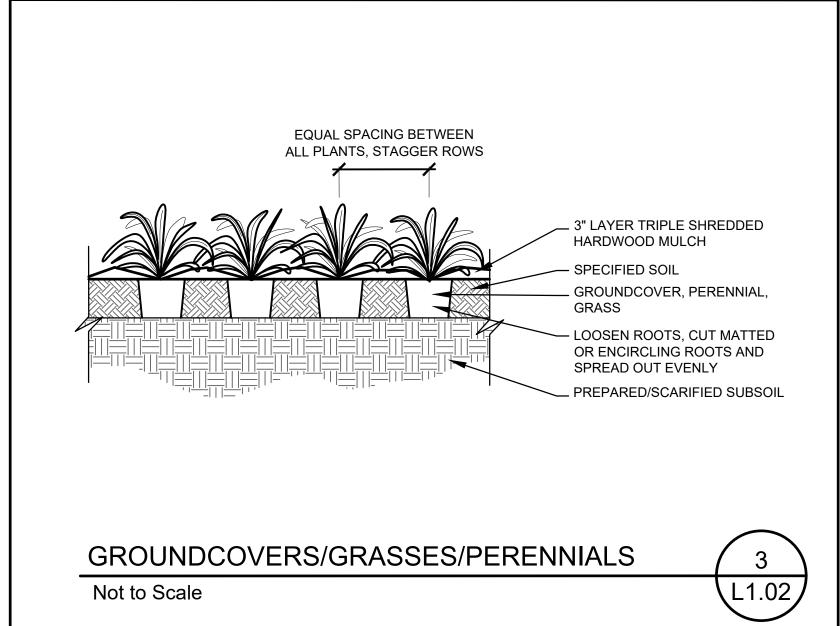

NOTES:

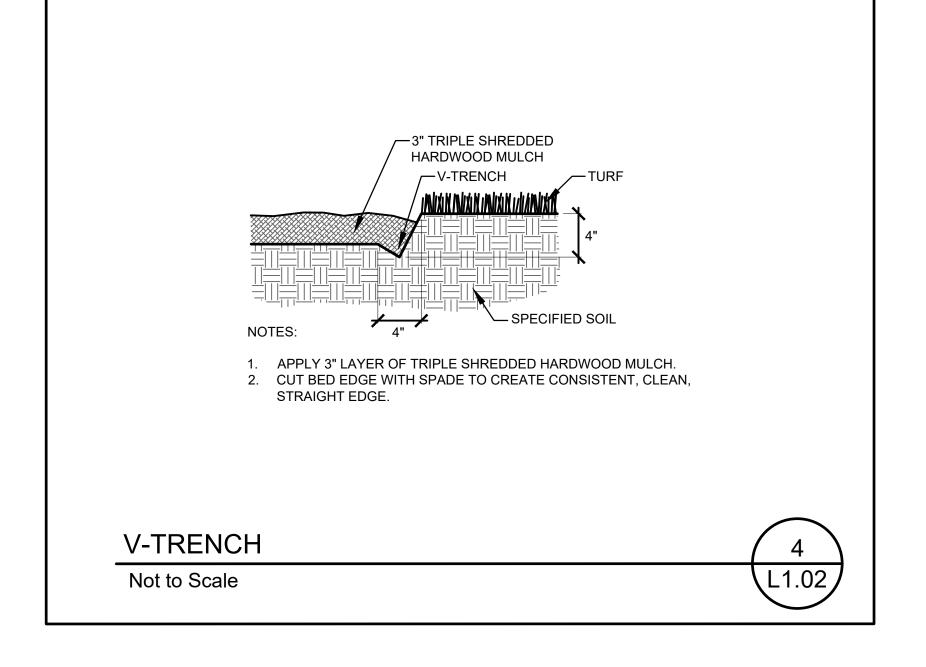

BUY AMERICA PROGRAM REQUIREMENTS

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SUBCONSULTANT: Susan Hatchell Landscape

Raleigh, NC 27603 Tel.: +1 919 838 9600 Landscape Architecture, PLLC

Architecture, PLLC

711 W. North Street

DESCRIPTION

PROFESSIONAL SEAL

SHEET NAME PLANTING DETAILS

DESIGNED BY: CHECKED BY:

FULL SCALE SHEET SIZE= ANSI- D (22"x 34")

L1.02

SHEET NUMBER




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WSP USA Suite 1500

DATE

10/25/2024 As indicated


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DATE

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SUBCONSULTANT:

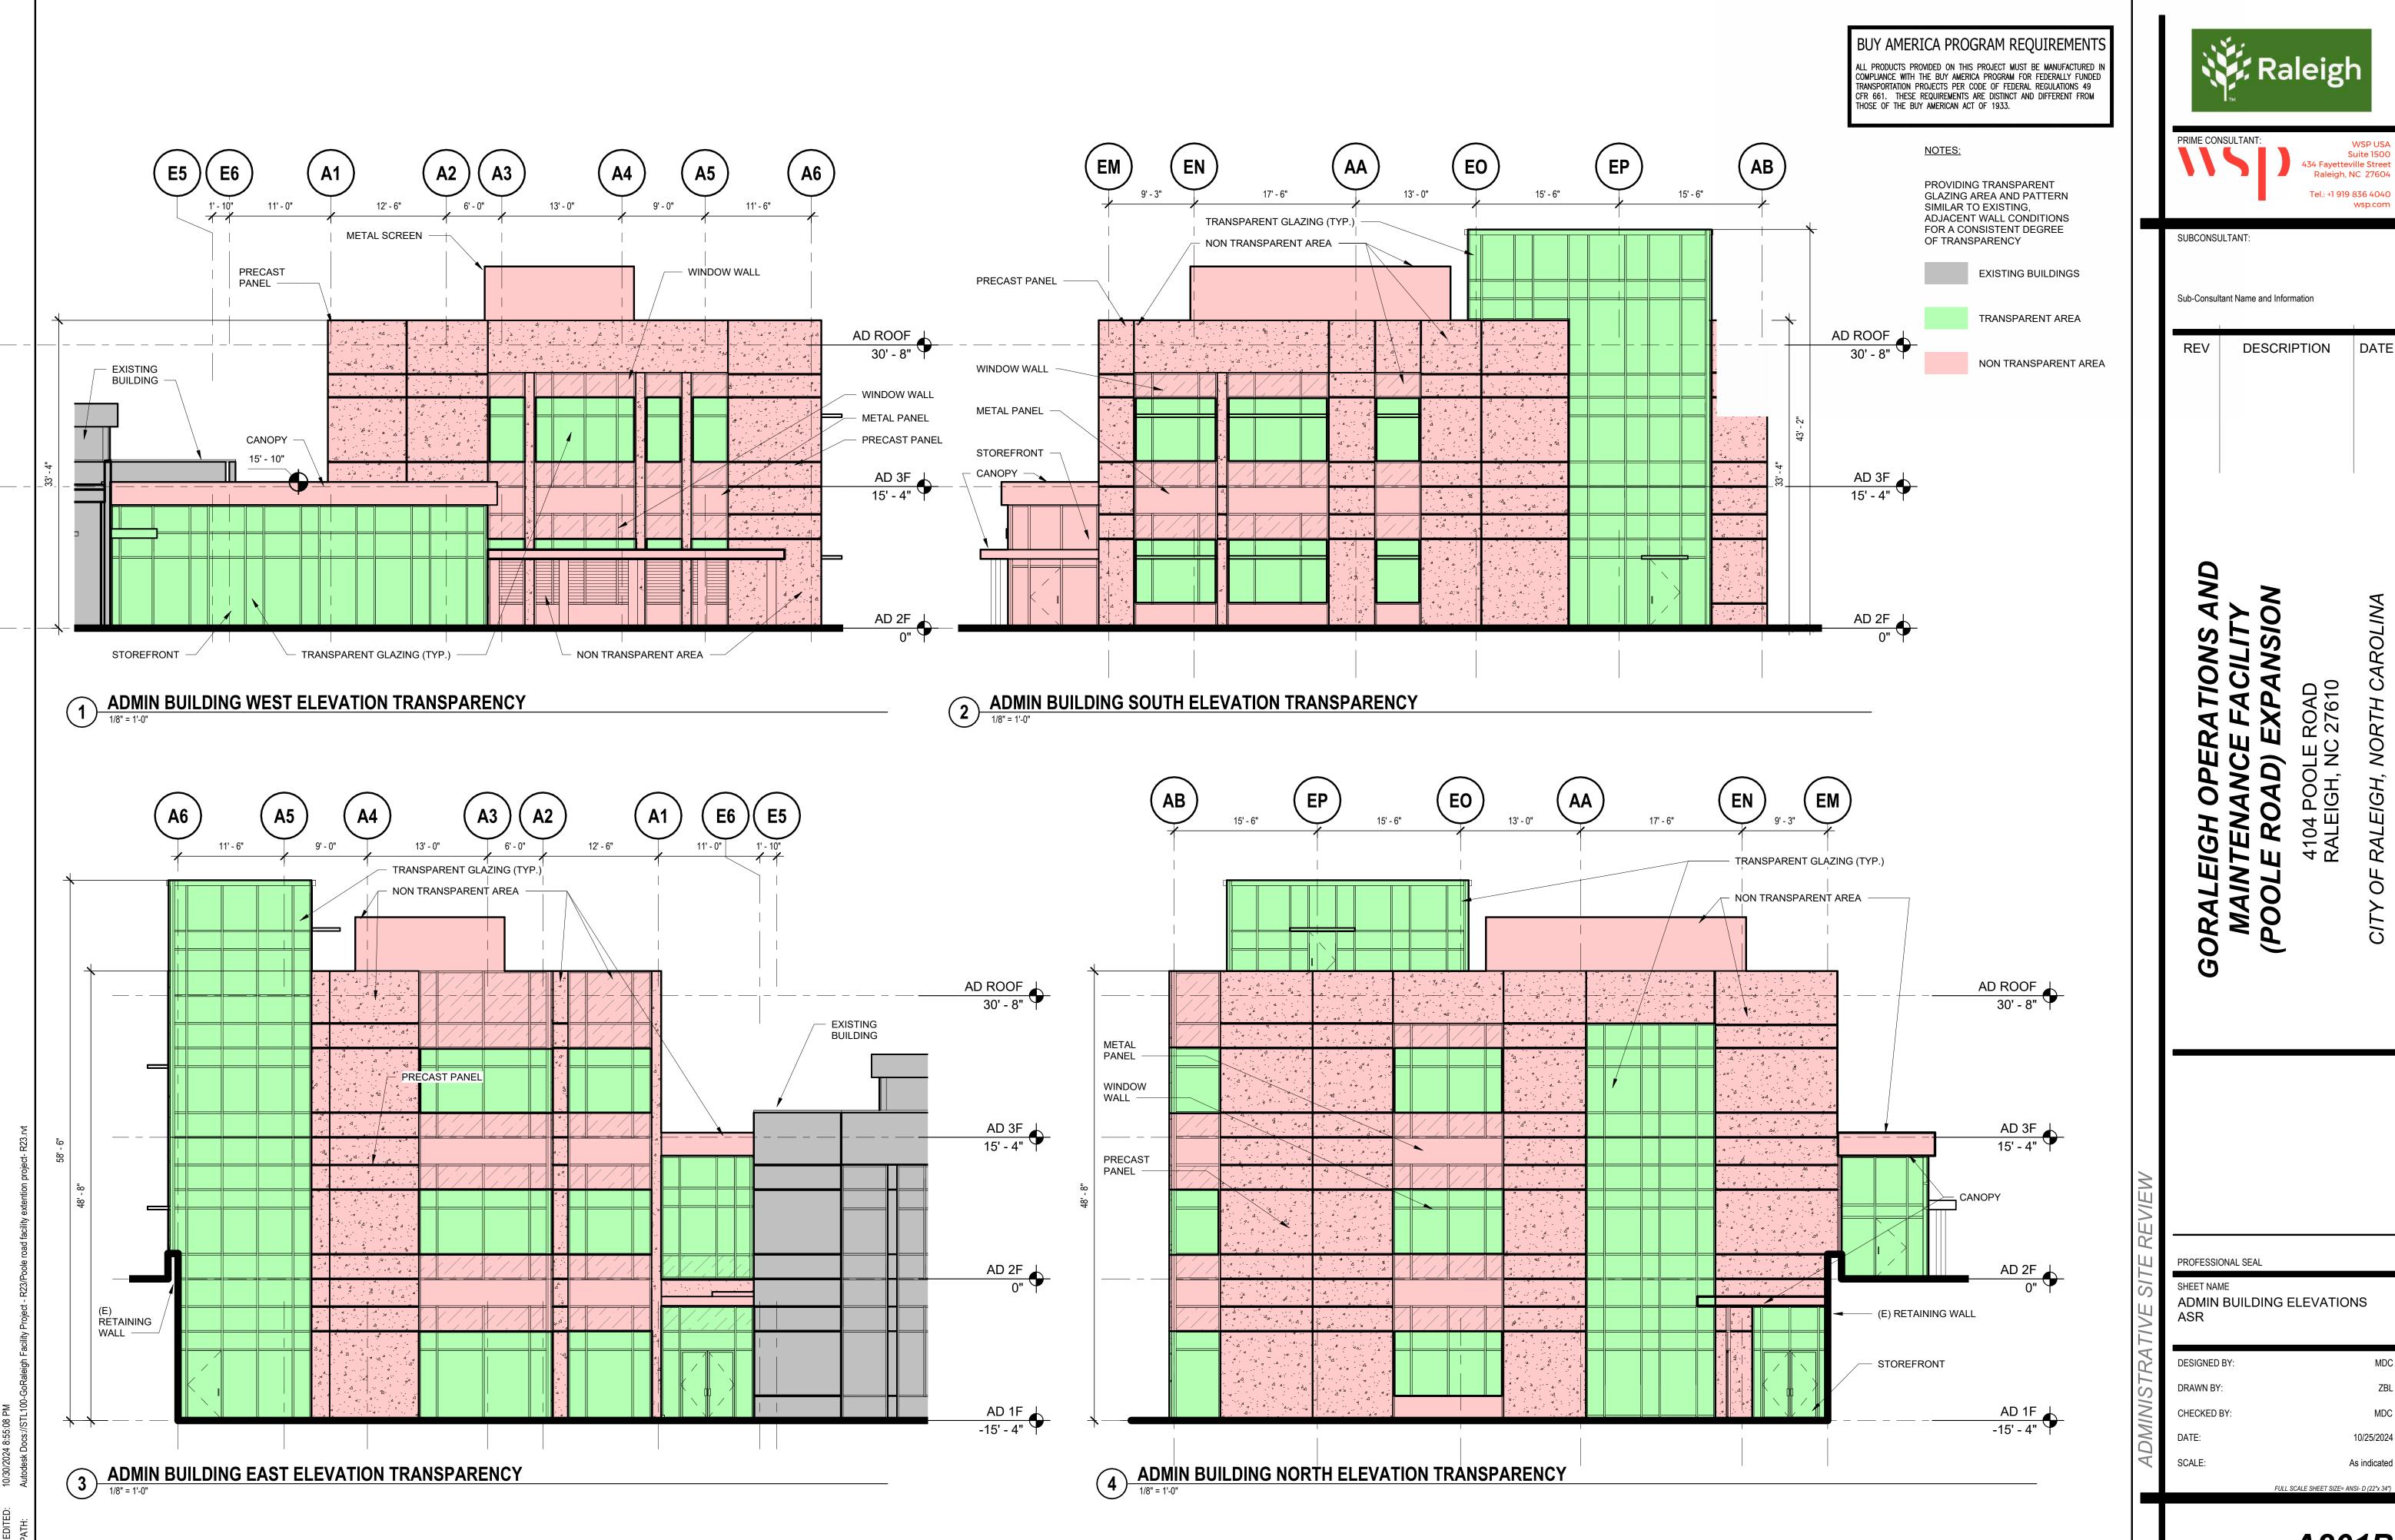Sub-Consultant Name and Information

DESCRIPTION DATE


PROFESSIONAL SEAL

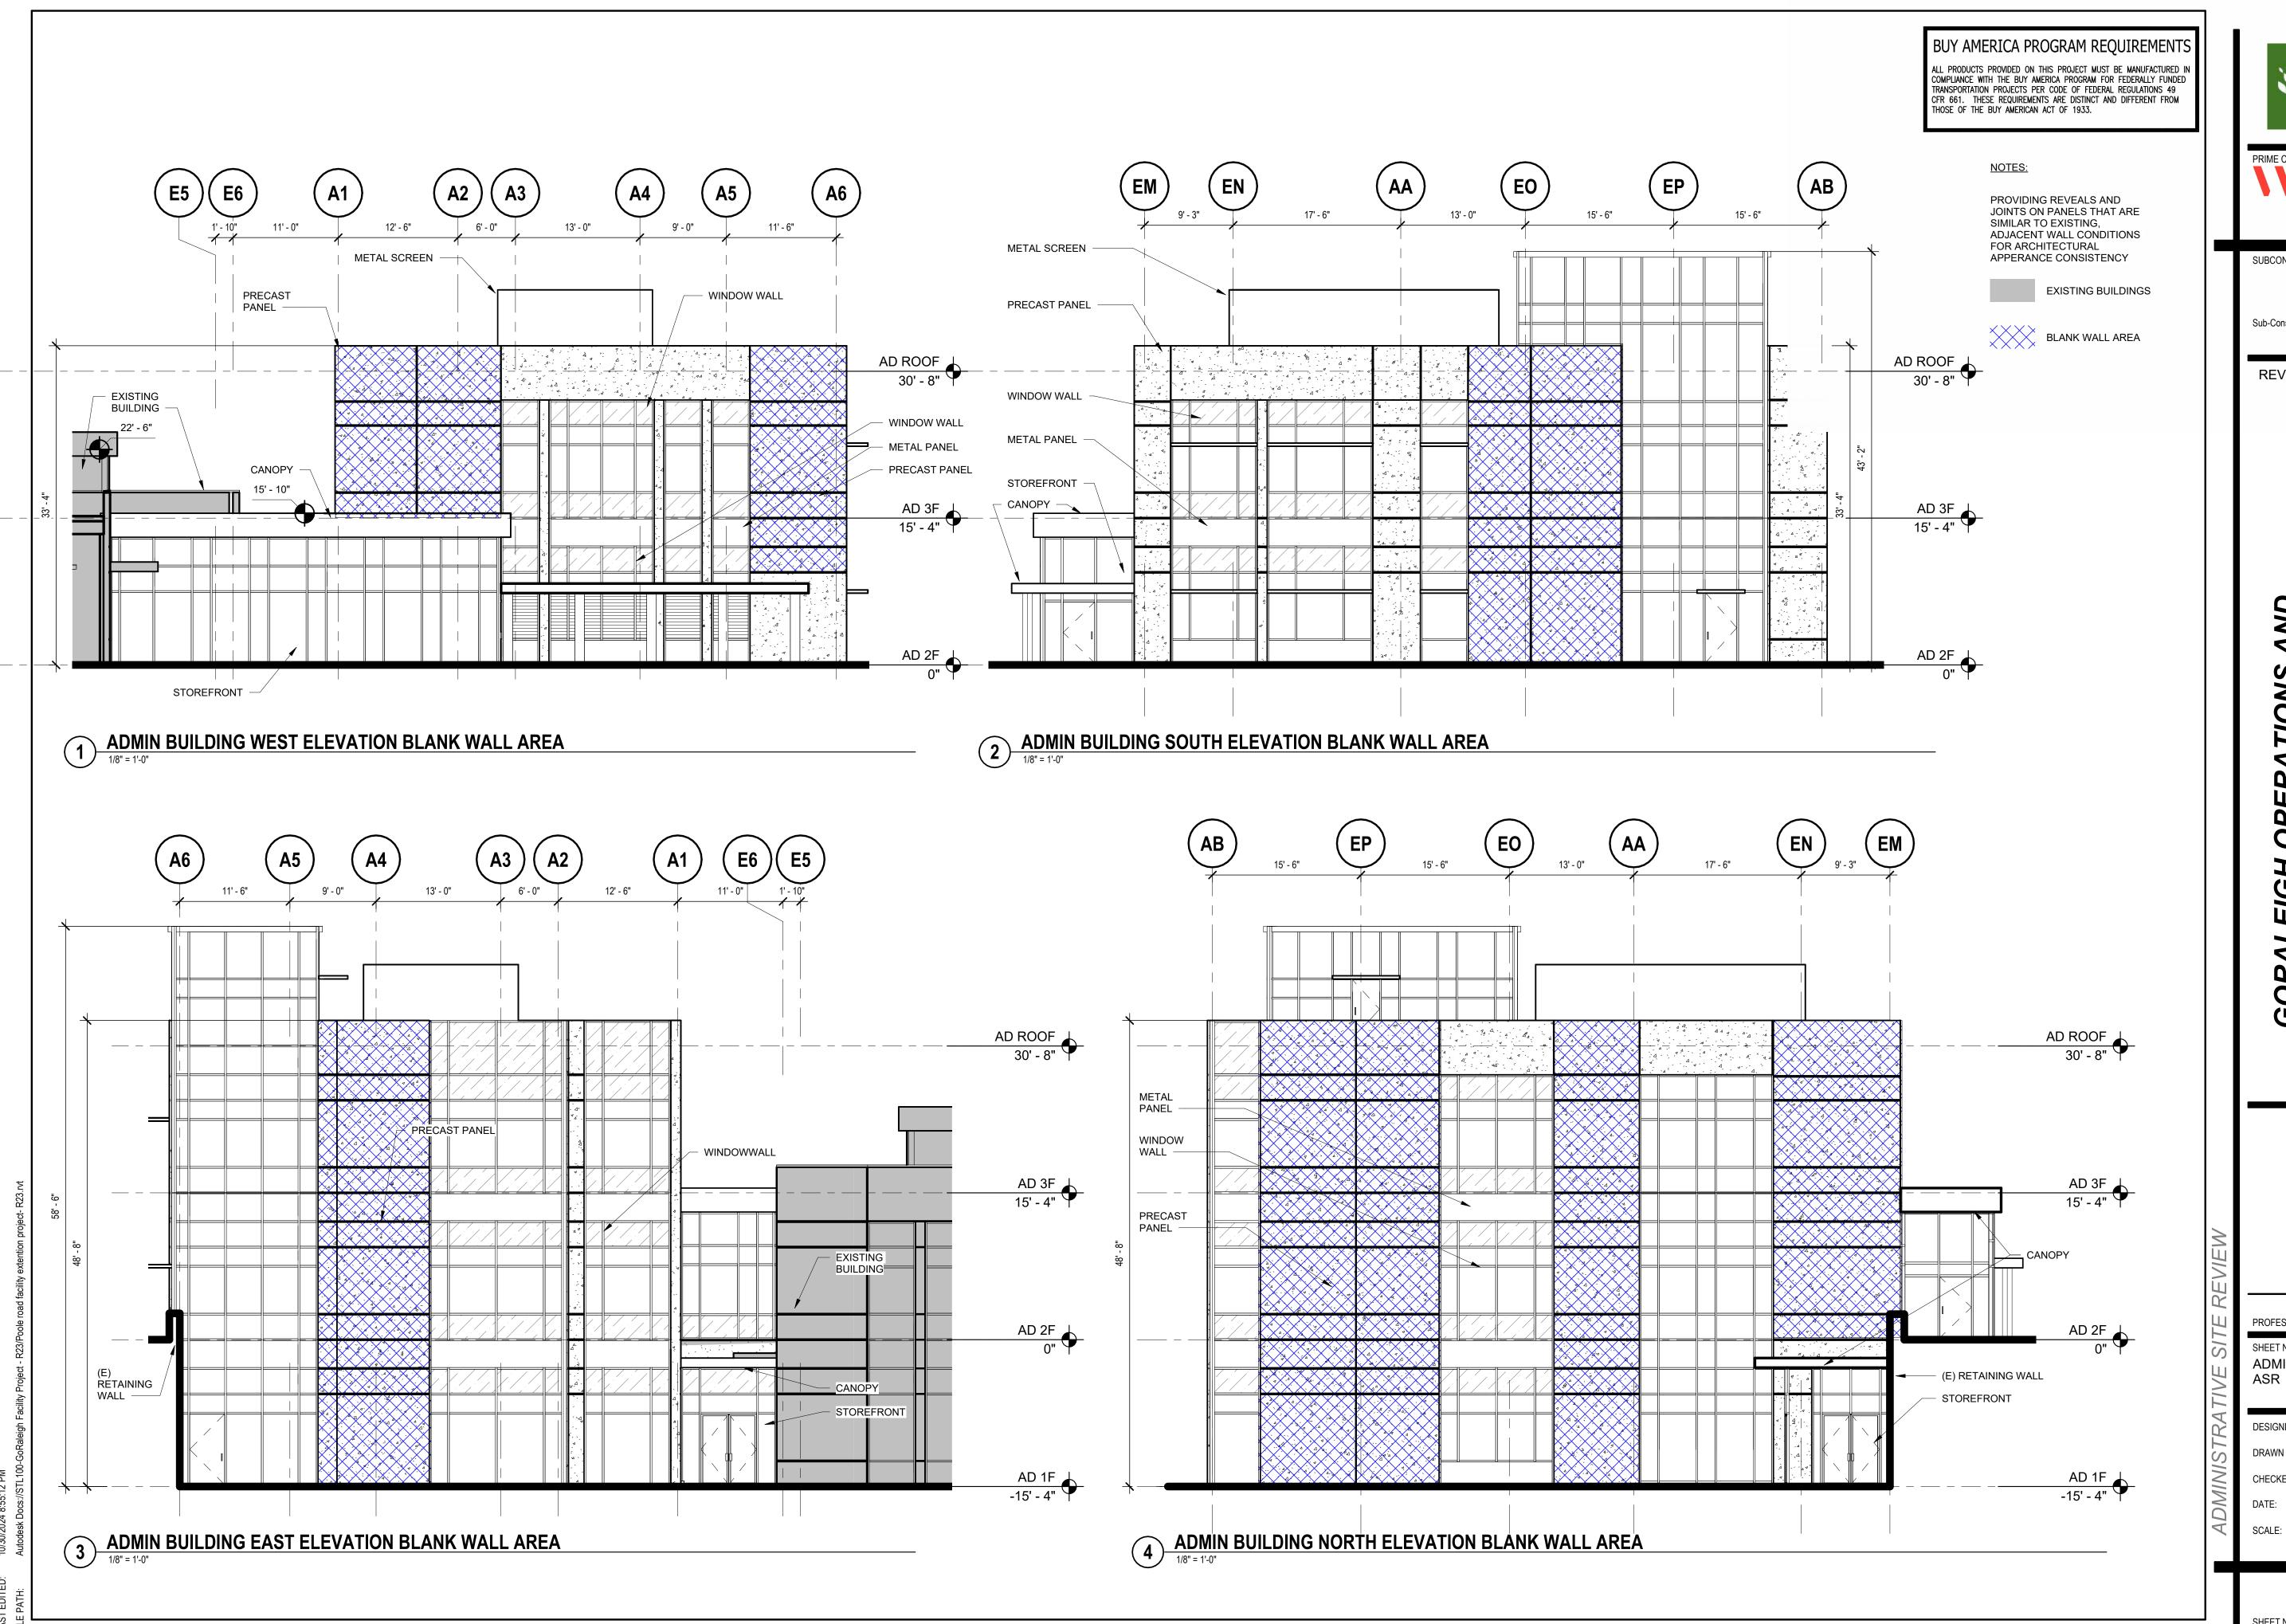SHEET NAME ADMIN BUILDING ELEVATIONS

DESIGNED BY: DRAWN BY: CHECKED BY:

FULL SCALE SHEET SIZE= ANSI- D (22"x 34")

A201C

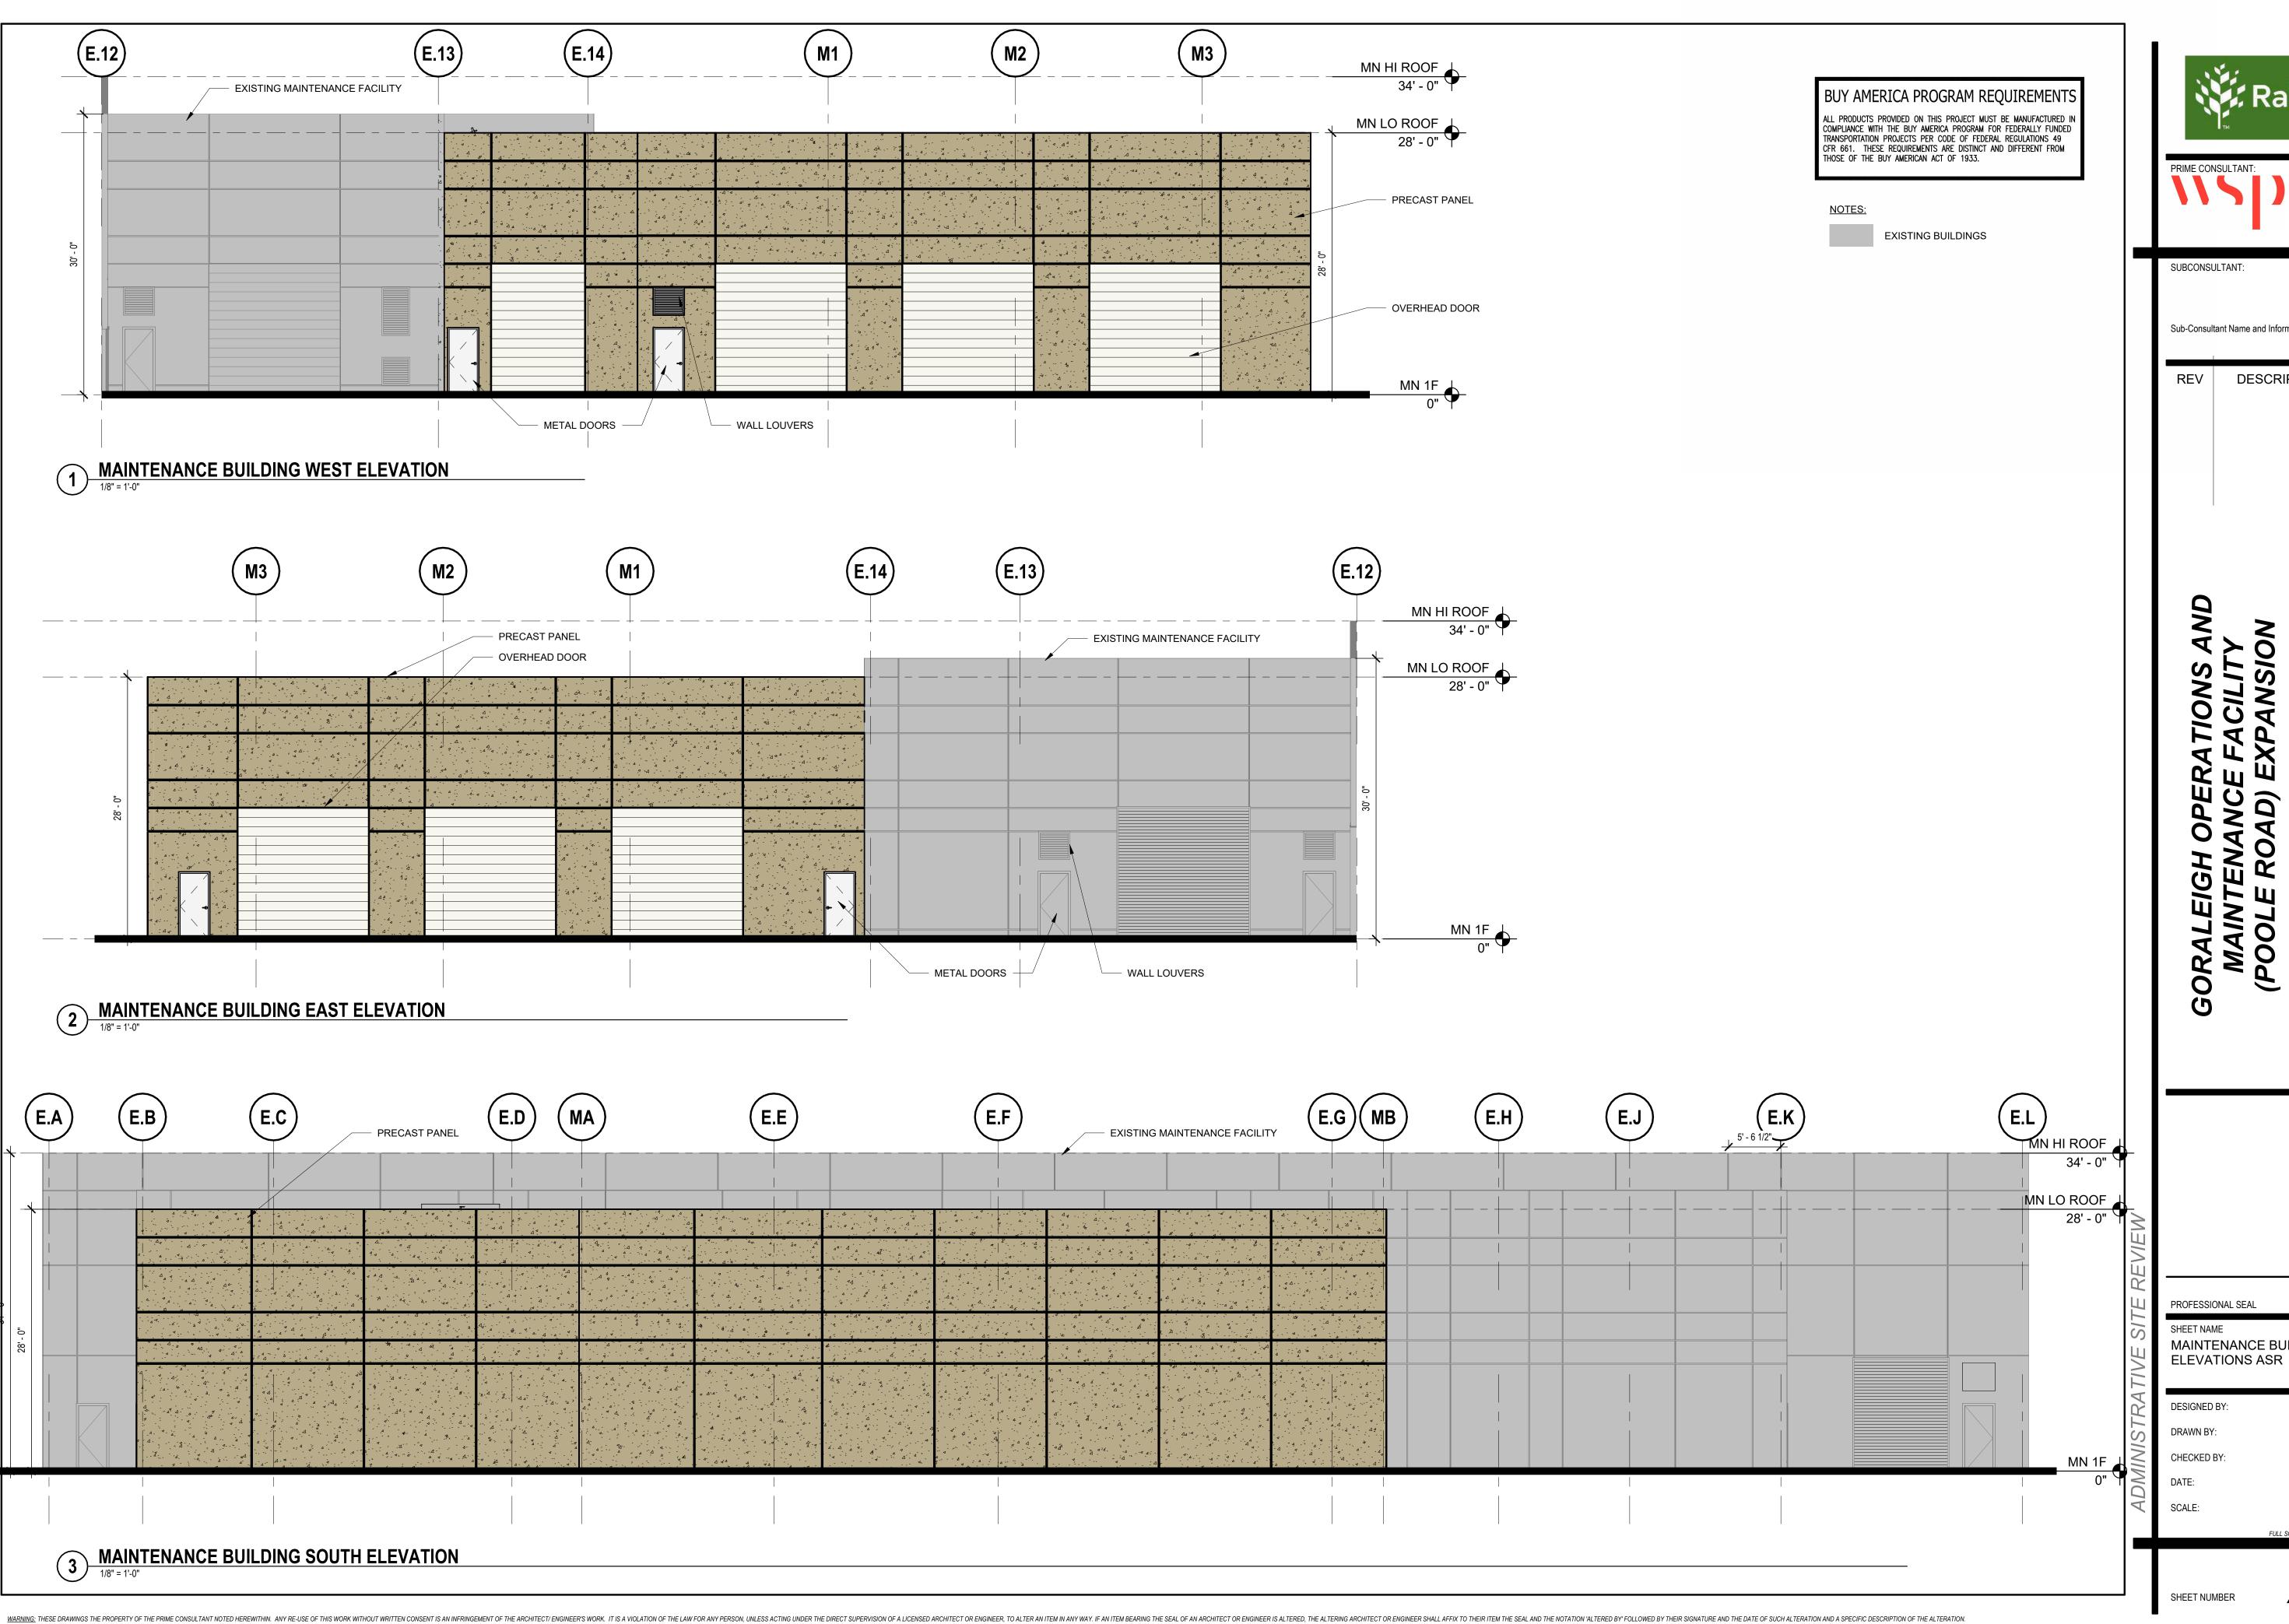

PRIME CONSULTANT: 434 Fayetteville Street

Sub-Consultant Name and Information

REV DESCRIPTION DATE

WSP USA Suite 1500

Raleigh, NC 27604


Tel.: +1 919 836 4040

MAINTENANCE BUILDING

10/25/2024 As indicated

FULL SCALE SHEET SIZE= ANSI- D (22"x 34")

A211A

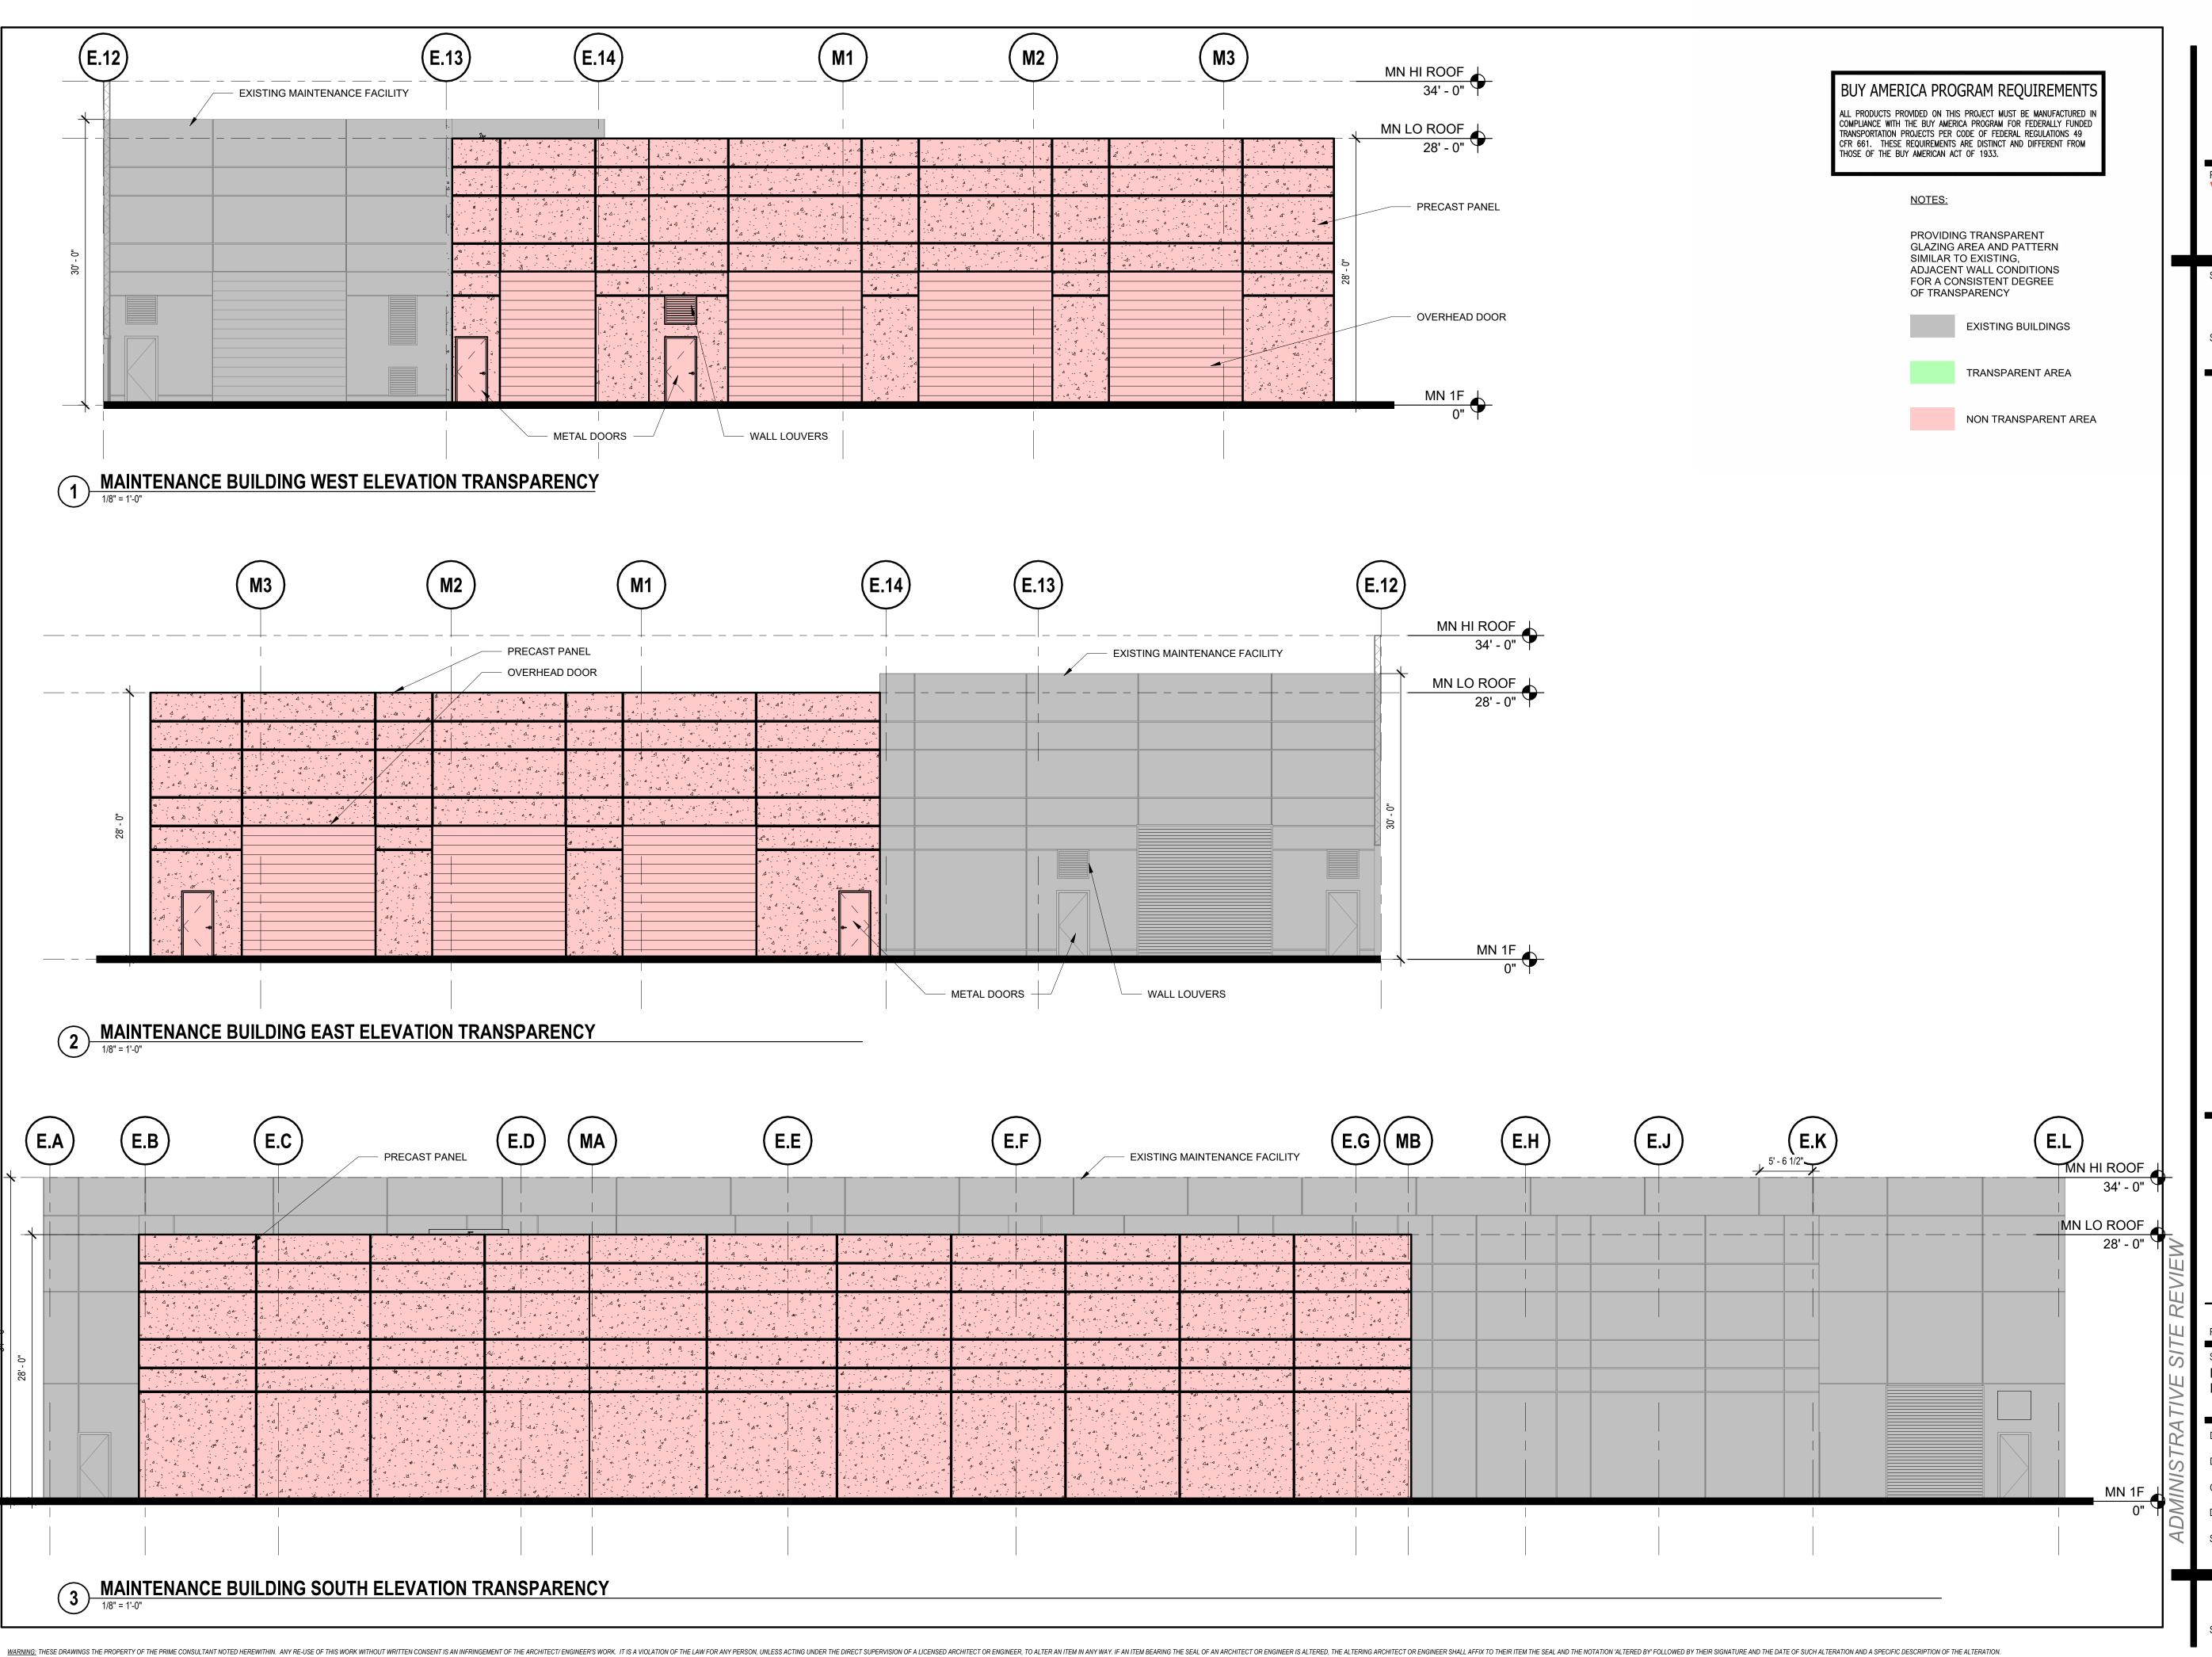



PRIME CONSULTANT:

WSP USA Suite 1500 Raleigh, NC 27604 Tel.: +1 919 836 4040

SUBCONSULTANT:


Sub-Consultant Name and Information

REV DESCRIPTION

PROFESSIONAL SEAL

SHEET NAME MAINTENANCE BUILDING **ELEVATIONS ASR**

DESIGNED BY: DRAWN BY: FULL SCALE SHEET SIZE= ANSI- D (22"x 34")

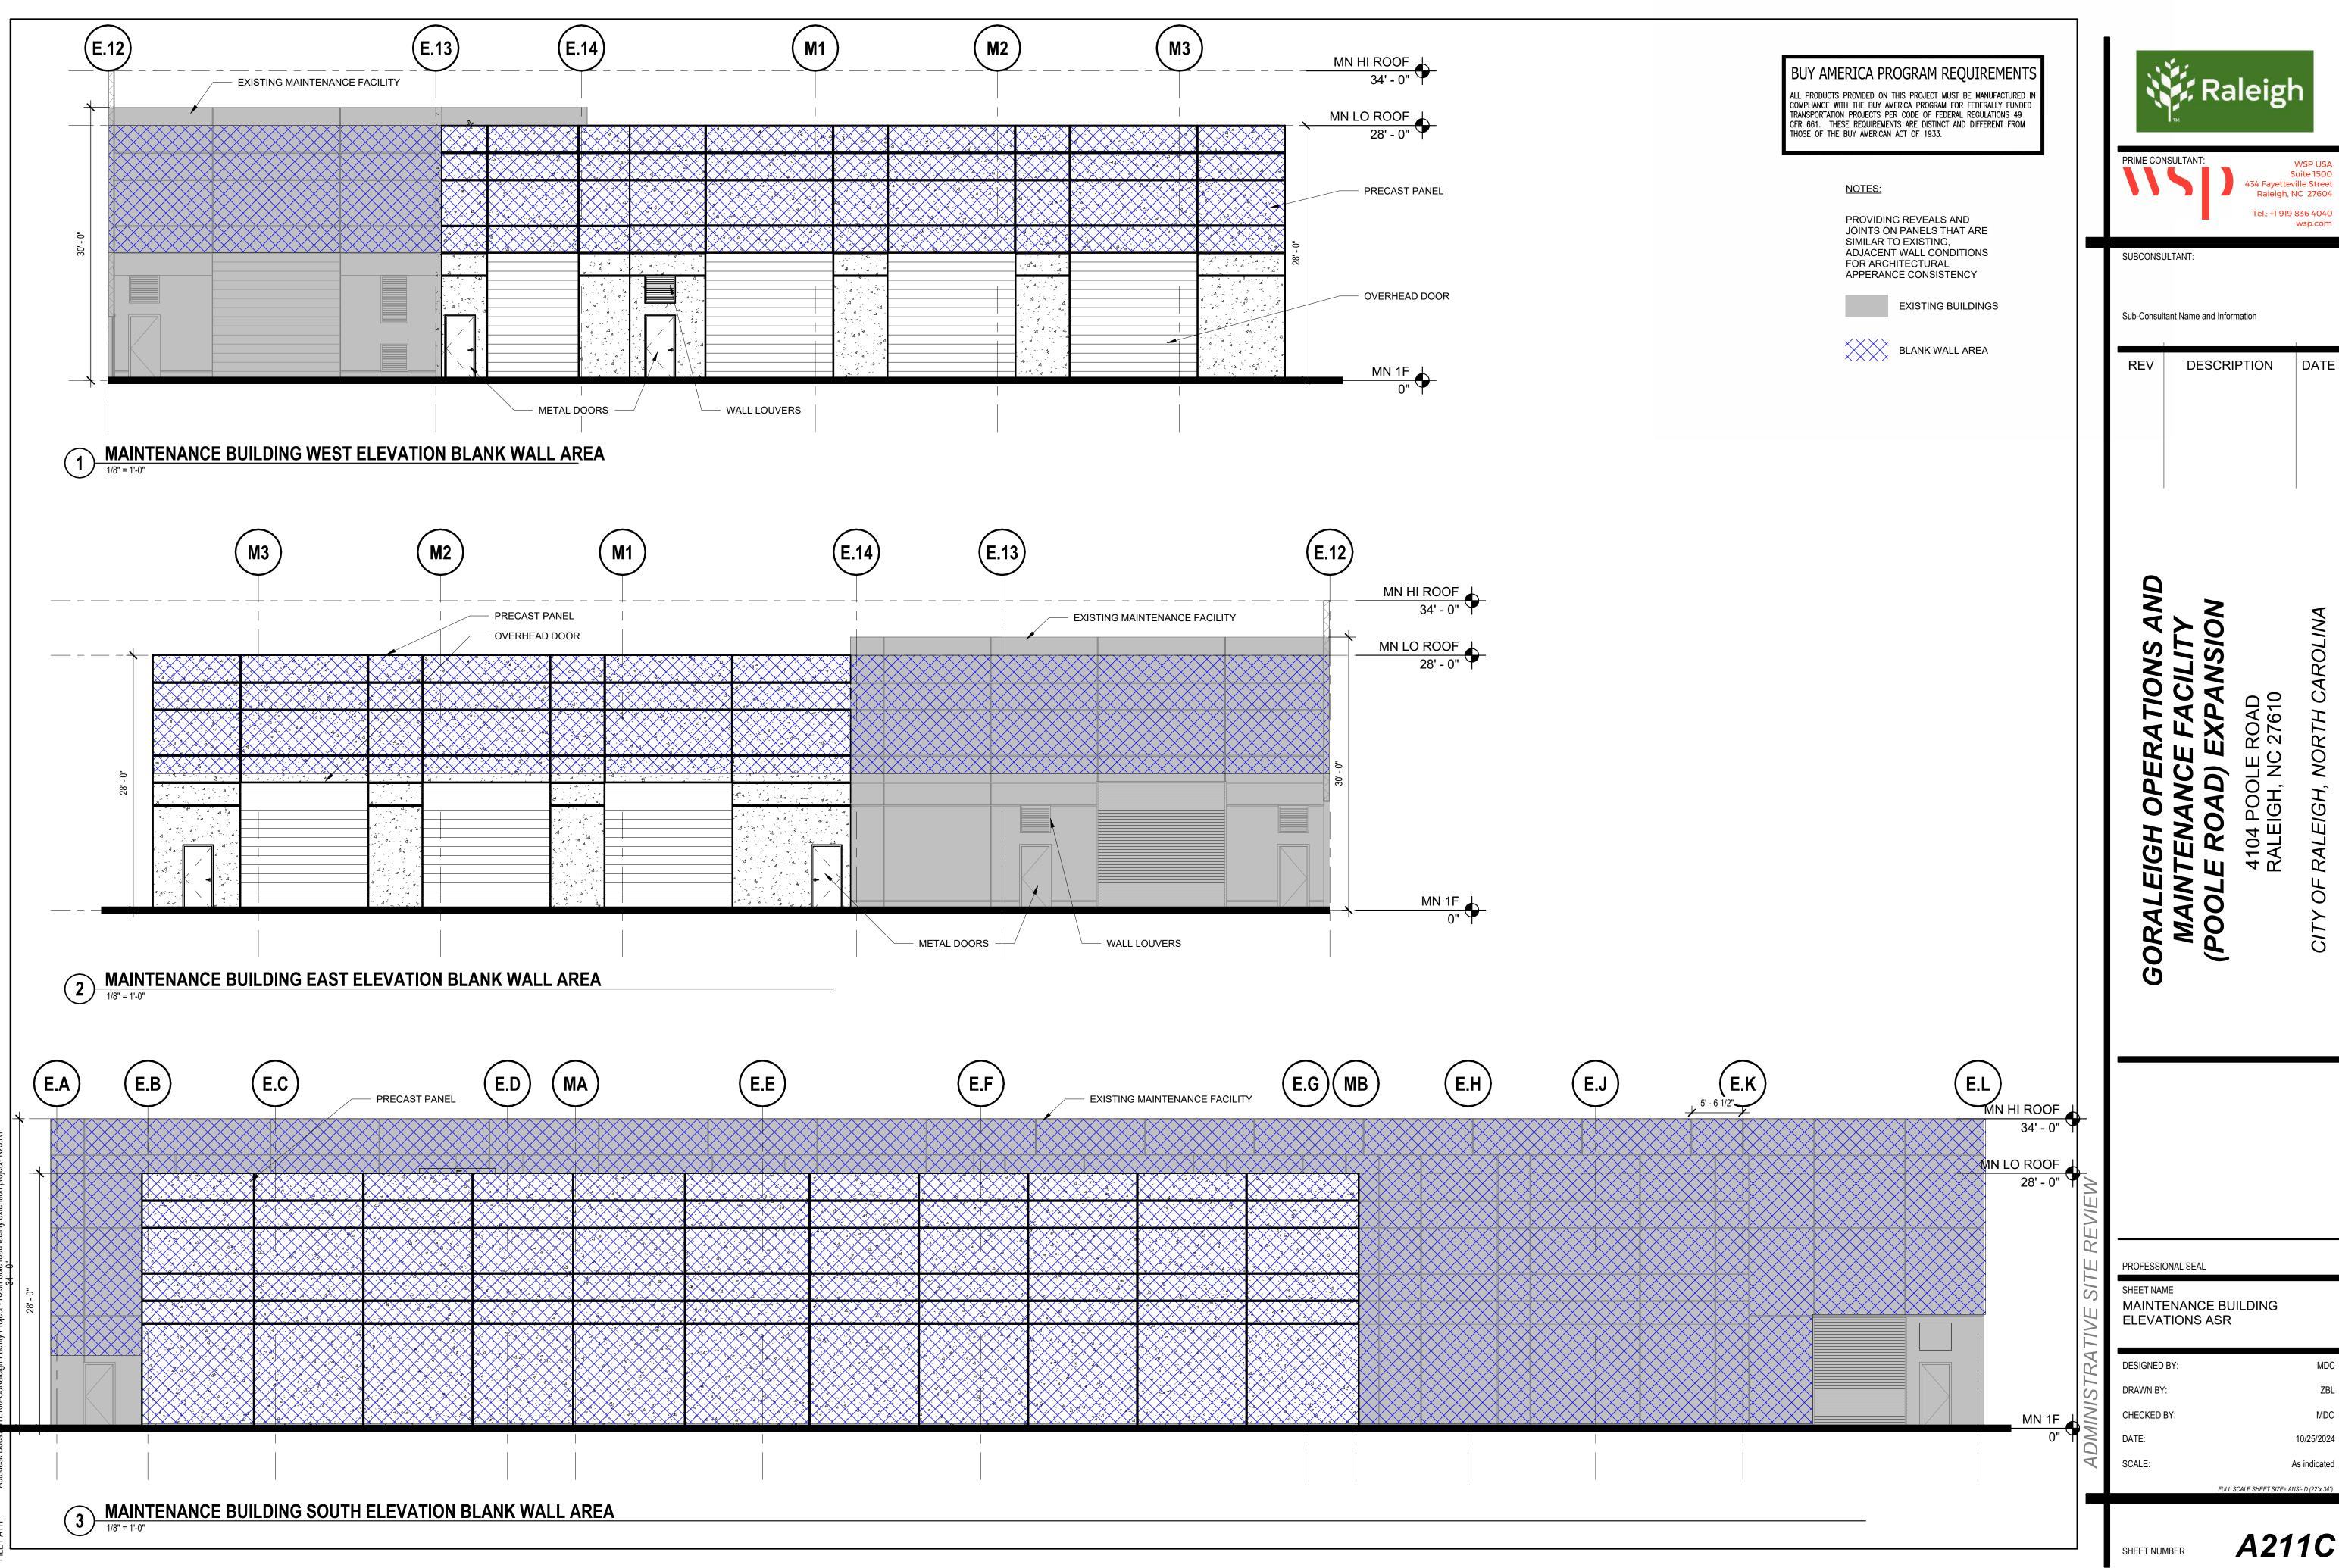

WSP USA Suite 1500