

Administrative Approval Action

Case File / Name: ASR-0092-2024 DSLC - 1335 & 1341 Chester Road

City of Raleigh
Development Services Department
One Exchange Plaza
Raleigh, NC 27602
(919) 996-2492
currentplanning@raleighnc.gov
www.raleighnc.gov

LOCATION: This 0.92 acre site composed of two parcels zoned R-6 CU (Z-62-21) is located on

the west side of Chester Road on the southwest corner of the intersection of Chester Road and Grant Avenue at 1335 and 1341 Chester Road. There are two

houses on the site.

REQUEST: The proposed development is for four three-unit townhome style condominium

buildings utilizing the Frequent Transit Development Option. The buildings will be three stories in height and have a gross floor area size of 53,868 square feet. The existing houses on site will be demolished and the two lots will be recombined into

one.

DESIGN

ADJUSTMENT(S)/

ALTERNATES, ETC: N/A

FINDINGS: City Administration finds that this request, with the below conditions of

approval being met, conforms to the Unified Development Ordinance. This approval is based on a preliminary plan dated April 15, 2025 by Wilson

Blount Development.

CONDITIONS OF APPROVAL and NEXT STEPS:

This document must be applied to the second sheet of all future submittals except for final plats. This is a preliminary plan and as such no permits have been issued with this approval. To obtain permits and/or completion of the project, the following steps are required:

☑ <u>SITE PERMITTING REVIEW</u> - For land disturbance of 12,000 square feet or greater, public or private infrastructure, shared stormwater devices, etc. Site Permitting Review may be submitted upon receipt of this signed approval document.

The following items are required prior to approval of Site Permitting Review plans:

General

- 1. As Grant Ave was selected as the "primary" street, the southern lot border would constitute the rear of the lot (see 1.5.4 B diagram). Please revise and show the rear (southern border) setback dashed line (to 15') (2.7.1 D3). FYI Porches, decks, patios, terraces, and stoops greater than 1 foot in height may extend 12 feet into a required side or rear setback, provided that such extension is at least 3 feet from the vertical plane of any side or rear property line. (1.5.4 D1). Please dimension this encroachment demonstrating compliance.
- 2. For clarification (on all elevation sheets) Please add a note/description describing the use of what appears to be a rooftop accessory structure providing clarification that this would not constitute a story. (1.5.7 D)
- 3. Demonstrate compliance with requirements for decorative and/or retaining walls (as applicable) set forth in UDO Section 7.2.8. for the proposed wall along the perimeter of the site.

Stormwater



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- A stormwater control plan with a stormwater operations and maintenance manual and budget shall be approved (UDO 9.2).
- 5. A surety equal to of the cost of clearing, grubbing and reseeding a site, shall be paid to the City (UDO 9.4.4).
- 6. A nitrogen offset payment must be made to a qualifying mitigation bank (UDO 9.2.2.B).

☑ <u>LEGAL DOCUMENTS</u> - Email to legaldocumentreview@raleighnc.gov. Legal documents must be approved, executed, and recorded prior to or in conjunction with the recorded plat on which the associated easements are shown. Copies of recorded documents must be returned to the City within one business day of recording to avoid withholding of further permit issuance.

Ø	Right of Way Deed of Easement Required
Ø	Utility Placement Deed of Easement Required

☑	Sidewalk Deed of Easement Required

☑ <u>RECORDED MAP(S)</u> - Submit plat to record new property lines, easements, tree conservation areas, etc.). Plats may be submitted for review when the Site Permitting Review plans, if required, have been deemed ready for mylar signature.

The following items must be approved prior to recording the plat:

General

1. A demolition permit shall be issued and this building permit number shown on all maps for recording.

Engineering

2. A 5' utility placement easement deed of easement, in addition to a plat showing the location of the easement, shall be submitted to the Planning and Development Services Department for review, and if acceptable, approved for recordation. Approved plats must be recorded at the Wake County Register of Deeds Office on or before the 14th day following approval by the City. The 14-day expiration date shall be clearly indicated on the plat. By the end of the next business day following recordation of the plat, all required legal instruments (including deeds of easement) shall be recorded, and recorded copies of the plat and all legal instruments required by the City in association with development approval shall be provided to the City. (Reference: UDO 8.1.7.A; 10.2.5.F.4.d)



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3. A public street right-of-way deed of easement, in addition to a plat showing the location of the easement, shall be submitted to the Planning and Development Services Department for review, and if acceptable, approved for recordation. Approved plats must be recorded at the Wake County Register of Deeds Office on or before the 14th day following approval by the City. The 14-day expiration date shall be clearly indicated on the plat. By the end of the next business day following recordation of the plat, all required legal instruments (including deeds of easement) shall be recorded, and recorded copies of the plat and all legal instruments required by the City in association with development approval shall be provided to the City. (Reference: UDO 8.1.7.A; 10.2.5.F.4.d)

Stormwater

- 4. If demolition causes a land disturbance of more than 12,000 sf, a mass grading permit will be required. (UDO 9.4.6)
- All stormwater control measures and means of transporting stormwater runoff to and from any nitrogen and stormwater runoff control measures shall be shown on all plats for recording as private drainage easements (UDO 9.2).

☑ <u>BUILDING PERMITS</u> - For buildings and structures shown on the approved plans. Commercial building permit plans must include the signed, approved Site Permitting Review plans attached, if applicable. Permit sets may be reviewed prior to the recordation of required plats, but cannot be approved.

The following items must be approved prior to the issuance of building permits:

General

1. A recombination map shall be recorded to recombine the existing lots into a single tract.

Engineering

2. A public infrastructure surety shall be provided to City of Raleigh Transportation – Development Engineering Division (UDO 8.1.3) in the amount of 100% of the improvement cost for the NCDOT portion and 125% of the improvement cost for the City of Raleigh infrastructure.

Stormwater

3. A surety equal to 125% of the cost of the construction of a stormwater device shall be paid to the Engineering Services Department (UDO 9.2.2.D.1.d).

Urban Forestry

4. A tree impact permit must be obtained for the approved streetscape tree installation in the right-of-way. This development proposes (6) street trees along Chester Rd. and (8) street trees along Grant Ave. for a total of (14) street trees.



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5. A public infrastructure surety for (14) street trees shall be provided to City of Raleigh Transportation Development Engineering Division (UDO 8.1.3) in the amount of 125% of the improvement cost for the City of Raleigh infrastructure.

The following are required prior to issuance of building occupancy permit:

General

1. Final inspection of all right-of-way street trees by Urban Forestry Staff.

Stormwater

- 2. As-built impervious survey is accepted by the Engineering Services Department (UDO 9.2).
- 3. As-built drawings and associated forms for all Stormwater infrastructure are accepted by the Engineering Services Department.
- 4. As-built drawings and associated forms for all Stormwater devices are accepted by the Engineering Services Department (UDO 9.2.2.D.3).

EXPIRATION DATES: The expiration provisions of UDO Section 10.2.8 E, including the ability to request extensions in the expiration date, apply to this site plan. If significant construction has not taken place on a project after administrative site review approval, that approval may expire and be declared void, requiring re-approval before permits may be issued. To avoid allowing this plan approval to expire the following must take place by the following dates:

3-Year Expiration Date: June 13, 2028

Obtain a valid building permit for the total area of the project, or a phase of the project.

4-Year Completion Date:

Within four years after issuance of the first building permit for the site plan, the construction of the entire site plan must be completed unless an applicant has been granted vested rights. Failure to complete construction within this specified time frame shall automatically void the approved site plan for which no building permits have been issued.

	hereb	y certif	y this	ad	minis	trat	ive o	decision.
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Signeu.	Development Services Dir/Designee	Date.	00/13/2023	_
Signed: _	Keegan.McDonald@raleighnc.gov No.Ei-Keegan.McDonald@graleighnc.gov No.Ei-Keegan.McDonald@graleighnc.gov No.Ei-Keegan.McDonald@graleighnc.gov No.Ei-Keegan.McDonald@graleighnc.gov No.Ei-Keegan.McDonald@graleighnc.gov	Date:	06/13/2025	

Staff Coordinator: Michael Walters



1335 & 1341 CHESTER ROAD

4 - 3 UNIT CONDO TOWNHOME STYLE BUILDINGS IN FREQUENT TRANSIT DEVELOPMENT

ASR-0092-2024

RALEIGH, NORTH CAROLINA

NOVEMBER, 2024; FEBRUARY, 2025 LAST REVISED: APRIL, 2025

	CABLE TO ENTIRE PLAN SET
AC.	ACRE
PROX	APPROXIMATE
B-B	BACK-TO-BACK
вм	BOOK OF MAPS
СВ	CATCH BASIN
C P	CAST IRON PIPE
CL	CENTERLINE
co	CLEANOUT
COR	CITY OF RALEIGH
CP	COMPUTED POINT
DB	DEED BOOK
DI	DROP NLET
DIP	DUCTILE IRON PIPE
DTL	DETAIL
ECM	EX CONC MONUMENT
EIP	EX JRON PJPE
ER	EX IRON ROD
LEC	ELECTRIC ELEVATION
EOP	ELEVATION EDGE OF PAVEMENT
ISMT	EASEMENT
EX	EXISTING
FDC	FIRE DEPARTMENT CONNECTION
EMA	FEDERAL EMERGENCY MANAGEMENT AGENCY
FH	MANAGEMENT AGENCY FIRE HYDRANT
FM	FORCE MAIN
FP	FLOODPLAIN
GBS .	GEOGRAPHIC INFORMATION SYSTEM
GM	SYSTEM GAS METER
GP.	GALVANIZED PIPE
GW	GUY ANCHOR
нв	HOT BOX
HDPE	HIGH DENSITY POLYETHYLENE
IPS	IRON PIPE SET
LF	LINEAR FEET
LP	LIGHT POLE
Loc	LOCATION
MH	MAG NAIL SET MANHOLE
N/F	NOW OR FORMERLY
CDOT	NORTH CAROLINA DEPARTMENT OF TRANSPORTATION
PG PP	PAGE POWER POLE
ROP	PROPOSED PROPOSED
PVC	POLYVINYL CHLORIDE
RCP	REINFORCED CONC PIPE
ROW	
R/W	RIGHT-OF-WAY
RSDM	RALEIGH STREET DESIGN MANUAL
SF	SQUARE FEET
55	SANITARY SEWER
твк	SETBACK
STD	STANDARD
SWM	STORMWATER MANAGEMENT
TBD	TO BE DETERMINED
TBR	TO BE REMOVED
TBRL	TO BE RELOCATED
	ELECTRIC TRANSFORMER
TF	
TP	TELEPHONE PEDESTAL
TP TYP	TYPICAL
TP TYP UNK	TYPICAL
TP	TYPICAL

OWNER:

THE PULLIAM OF RALEIGH, LLC 3347 ALLEGHANY DR Raleigh, N.C. 27609-6903

OWNER:

CETINALE, LLC 3347 ALLEGHANY DR Raleigh, N.C. 27609-6903

DEVELOPER:

WILSON I BLOUNT DEVELOPMENT

2626 Glenwood Ave. Ste 350 Raleigh, N.C. 27608 919-659-3293

ARCHITECT:

NEW CITY DESIGN GROUP

1304 Hillsborough St Raleigh, N.C. 27605 919-831-1308

CIVIL ENGINEER:

JAECO

Consulting Engineers NC License F-0289 333 Wade Ave., Raleigh, N.C. 27605 Phone: (919) 828-4428 Fax: (919) 828-4711

E-mail: info@jaeco.com

SITE DATA

	1335 CHESTER ROAD & 13	41 CHESTER ROAD
SITE ADDRESS:	RALEIGH, NC 27608	
WAKE COUNTY PINE:	1704077038 & 1704077148	
ZONING:	R-6-CU	
OVERLAY DISTRICT:	NIA	
EXISTING AREA:		
1335 CHESTER (PORTION OF LOT 50)	15,819 SF (0.36 AC)	
1341 CHESTER (LOT 51)	24,179 SF (0.55 AC)	
TOTAL	39,998 SF (0.92 AC)	
AREA TO BE DEDICATED:	- 4,290 SF (0.10 AC)	
NET SITE AREA:	35,708 SF (0,82 AC)	
existing use:	RESIDENTIAL	
PROPOSED USE:	CONDO - TOWNHOUSE	
	REQUIRED	PROVIDED
VEHICLE PARKING:	NO MAXIMUM	24 SPACES (24 GARAGE)
BJCYCLE PARKING:	NONE	NONE
BUILT UPON AREA	EXISTING	PROPOSED
ON-SITE	10,907 SF (0.25 AC)	28,773 SF (0.62 AC)
OFF-SITE	267 SF (0.01 AC)	463 SF (0.01 AC)

DEVELOPMENT IS EXEMPT FROM BLOCK PERIMETER REQUIREMENTS PER TABLE FOUND IN UDO 8,3,2A,2 b (R-6 DISTRICT


DEVELOPMENT IS EXEMPT FROM CRC
ACCESS REQUIREMENTS PER UDO
0.2 E D E W :

CONTAINERS TO BE STORED AT THE DWELLINGS AND COLLECTED ALONG CHESTER DRIVE BY PRIVATE HAULER OWNERS WILL BE RESPONSIBLE FOR LABELING THEIR ASSIGNED CONTAINERS.

HORIZONTAL DATUM:	NAD83
VERTICAL DATUM:	NAVD88
ALL CONSTRUCTION SI	HALL BE IN
ACCORDANCE WITH CI	TY OF RALEIGH

SHEET INDEX				
CE-0 COVER SHEET				
CE-1	EXISTING CONDITIONS PLAN			
CE-2	DEMOLITION PLAN			
CE-3	SITE PLAN			
CE-4	STREET TREE PLAN			
CE-5	UTILITY PLAN			
CE-6	GRADING / STORMWATER PLAN			
CE-7	FIRE DEPARTMENT PLAN			
A201a - A202a	EXTERIOR ELEVATIONS BUILDING A			
A201b - A202b	EXTERIOR ELEVATIONS BUILDING B			
A201c - A202c	EXTERIOR ELEVATIONS BUILDING C			
1004 1000	DOTTOLOGIC CI CI (ATTOLIO DI III DILIO D			

FREQUENT TRANSIT D	EVELOPMENT	f (UDO 2.7)	
REQUIRED/ALLOWED	PROVIDED/PROPOSED		
THE FREQUENT TRANSF DEVLOPMENT OPTION ALLOWS FOR ADDITIONAL HOUSING IN LOCATIONS WERE CURRENT AND PLANSED THROUGHT TRANSIC MEANS CAUTHOR TRANSIC TRANSIC TRANSIC STATES AND SECOND THE TRANSF SERVICE WHERE THE MEDICAL SECTION AND SECOND THE TIME SERVICE WHERE THE SERVICE WHERE A REQUILITIES OF A THE SECTION OF THE TIME SECTION OF THE SECTION OF TH	PER THE CITY OF BALIGHT 2000 COMPRESSIONE FLAND UNDER CONCESSION SCHOOL STATEMENT TRANSPER FAREOURT TRANSPER FAREOURT TO MAKE THE OFFICE AS THE AREA AND COMPRESSION SCHOOL STATEMENT OF THE AND THE AREA OFFI COMPRESSION SCHOOL STATEMENT OF THE AREA OFFI COMPRESSION SCHOOL STATEMENT OF THE AREA OFFI COMPRESSION SCHOOL STATEMENT OF THE AREA OFFI COMPRESSION SCHOOL SCHOOL STATEMENT OF THE AREA OFFI COMPRESSION SCHOOL STATEMENT OF THE AREA OFFI COMPRESSION SCHOOL S		
	REQUIRED/ALLOWED	PROVIDED.PROPOSED	
A. Building Types			
A1 Applicable Building Types	Tirry House Detached House, Attached House, Townhouse, Apartment	Townhouse	
B. Lot Dimensions			
B1 Area(min)	4,000 SF	35,708 SF	
B2 Width (min)	50'	220.90'	
B3 Depth(min)	80'	161,35"	
B4 Density(max)	N/A	-	
B5 Outdoor Amenity Area(min) for Townhouse (3+ units) and Apartment	10% = 3,571 SF	3,683 SF (10.3%)	
C. Lot Area Required per Unit 1			
C1 Single-unit Eving(min)	4,000 SF	N/A	
C2 Two-unit living(min)	1,500 SF	5,905 SF	
C3 Multi-unit living(min)	1,200 SF/UNIT = 14,400 SF	35,708 SF	
D. Principal Building Setbacks			
D1 From primary street (min)	10'	23,76	
D2 From side street (min)	10'	23,04"	
D3 From side lot line (min) ²	5"	15,90"	
D4 From rear ot line (min) ²	15'	N/A	
D5 From alley (min) ⁴	4" or 20"	4'	
D6 Residential infill rules may apply (see Sec. 2.2.7.)	yes "	yes.	
E. Height			
E1 Detached(Attached Principal Building(max)	4073 stories	-	
E2 Townhouse/Apartment Principal Building(max)	4573 stories	33'-9 5/8" (3 STORIES)	
E3 Tiny House(max)	26/12 stories	-	
E4 Accessory structure(max)	26"	-	
E5 Residential Infill rules may apply (see Sec. 2.2.7)	No	N/A	
F. Parking Setbacks ⁶			
F1 From Primary Street(min)	10'	N/A (GARAGE)	
F2 From Side Street(min)	10'	N/A (GARAGE)	
F3 From Side Lot Line(min)	0"	N/A (GARAGE)	
F4 From Rear Lot Line(min)	3'	N/A	
F5 From Alley(min)	4' or 20' min	4"	
F6 Residential Infill rules may apply (see Sec 2.2.7)	No	N/A	
G. Additional Requirements			
G1 ADU Regulations	There shall be no more than one ADU on the same lot as principal building unless it is located in a frequent transit area, only one ADU can be attached or internal to the principal building, in the case of a townhome development only one ADU is permitted per principle dwelling. See Sec 2.4.3 for additional regulations.		

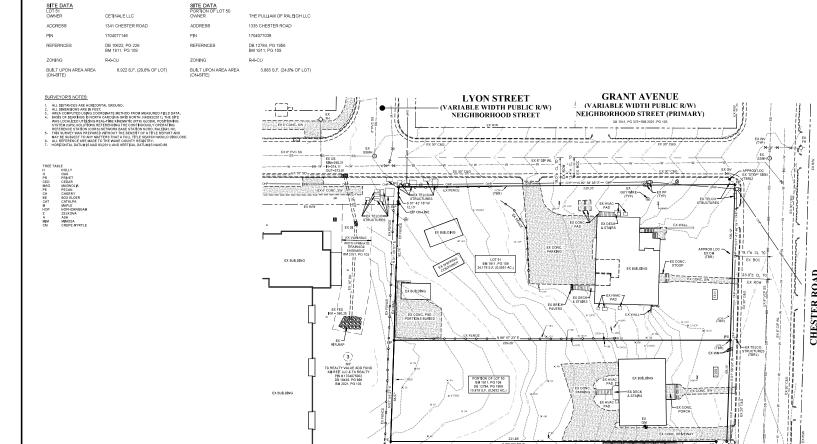



DHN A. EDWARDS & COMPAN' Consulting Engineers and Land Surveyors

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1335 & 1341 CHESTER ROAD RALEIGH, NC 27608

WILSON BLOUNT 821 WAKE FOREST RD RALEIGH , NC 27604

EXISTING CONDITIONS PLAN


Number	Description	Date
1	PER CITY COMMENTS	01.XX/

 Drawn By
 ZCS / BF


 Checked By
 CLP

 Date Issued
 11/22/2024

GRAPHIC SCALE

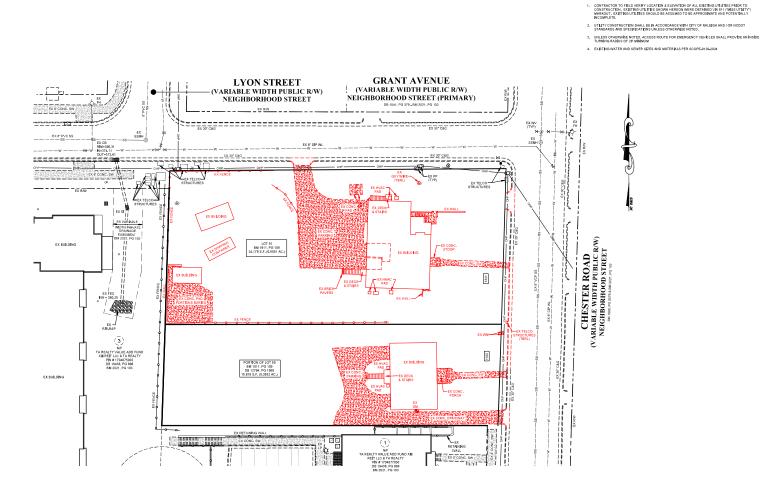

NOTE: **DEMOLITION OF ALL ITEMS SHOWN IN (RED)**

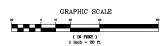

GENERAL NOTES



JAECO Consulting Engineers and Land Surveyors

NC License F-0289 333 Wade Ave., Raleigh, N.C. 27605 Phone: (919) 828-4428 Fax: (919) 828-4711 E-mail: info@jaeco.com

1335 & 1341 CHESTER ROAD RALEIGH, NC 27608

WILSON BLOUNT 821 WAKE FOREST RD RALEIGH , NC 27604

DEMOLITION PLAN

Number	Description	Date
1	PER CITY COMMENTS	02/10/
2	PER CITY COMMENTS	04/15/

Drawing Scale	1" =20"	
Drawn By	BF	_ ೧೯ ೧
Checked By	JRC	— CE-2
Date Issued	11/22/2024	of

GENERAL NOTES


- CONTRACTOR TO FIELD VERIFY LOCATION & ELEVATION OF ALL EXISTING UTILITIES PRIOR TO CONSTRUCTION, EXISTING UTILITIES SHOWN HEREON WERE OBTAINED VIA 811 (WASS UTILITY MARKOUT, EXISTING UTILITIES SHOULD BE ASSUMED TO BE APPROXIMATE AND POTENTIALLY NCOMPLETE.
- 2. UTILITY CONSTRUCTION SHALL BE IN ACCORDANCE WITH CITY OF RALEIGH AND / OR NODOT
- UNLESS OTHERWISE NOTED, ACCESS ROUTE FOR EMERGENCY VEHICLES SHALL PROVIDE AN INSIDE TURNING RADIUS OF 28' MINIMUM
- 4. EXISTING WATER AND SEWER SIZES AND MATERIALS PER SCOPE-0129-2024

CONSTRUCTION NOTES:

- 1. ALL CONSTRUCTION SHALL BE IN ACCORDANCE WITH CITY OF RALEISH AND/OR NODOT STANDARDS.
- THE CONTRACTOR SHALL CONDUCT THE WORK IN A SAFE MANNER AND WITH A MINIMUM AMOUNT OF INCONVENIENCE TRAFFIC.
- THE CONTRACTOR SHALL BE RESPONSIBLE FOR ALL TRAFFIC CONTROL AND SHALL ADHERE TO THE PROVISIONS OF MUTCH MARK CURRENT EDITION.
- PRIOR TO START OF WORK, A PRE-CONSTRUCTION MEETING MUST BE SET UP WITH THE CONTRACTOR AND CITY OF RALEIGH TRANSPORTATION FIELD SERVICES STAFF. CONTACT ENGINEERING INSPECTIONS AT (819) 996-2409 TO SET UP TI MEETING
- 5. THE CONTRACTOR SHALL ORTAN A BRIEFLO-FAWN OBSTRUCTION PERMITTOR ANY WORK WHICH REQUIRES THE TEMPORARY CLOSURE OF A STREET, TRAVEL LAWE, PARKING SPACE OR SIDEMALK FROM RIGHT-G-MAY SERVICES AT LEAST 48 HOURS IN ADVANCE. ANY TEMPORARY STREET CLOSURE MUST BE SUBMITTED 2 WEEKE PRIOR. SEE "RIGHT-G-MAY CLOSURES" OF WINIVERLEPHING-OWN AND SERVIN HE RIGHT-FOR WAY OBSTRUCTION PERMIS "RIGHT-G-MAY CLOSURES" OF WINIVERLEPHING-OWN AND SERVIN HE RIGHT-FOR WAY OBSTRUCTION PERMIS AND THE PRIOR OF THE PRIO
- 6. PRIOR TO CONSTRUCTION BEGINNING, ALL SIGNAGE AND TRAFFIC CONTROL SHALL BE IN PLACE.
- THE CONTRACTOR SHALL REPAIR ANY DAMAGED INFRASTRUCTURE IN THE RIGHT-OF-WAY AND RESTORE IT TO PREVIOUS OR BETTER CONDITION.
- THE CONTRACTOR SHALL REPAIR ANY DAMAGES TO ADJACENT PROPERTIES AND RESTORE IT TO PREVIOUS OR BETTER CONDITION.
- 8. ALL SIDEWANKS MUST BE ACCESSIBLE TO PERSONS WHO ARE VISUALLY IMPAIRED AND PEOPLE MTH MOBELTY BEARLIFIES. PROESTRING ENTIME ROUTES AND ALTERNATE PEOPLETHAN ROUTES DUBBIG CONSTRUCTION WILL BE REQUIRED TO BE COMPLIAIT WITH THE PUBLIC RICHTS OF MAY ACCESSIBILITY OF IDELECT PROVINCIA, 2910 ADA STANDARDS FOR ACCESSIBLE DESIGN AND THE MANUAL ON UNIFORM TRAFFE CONTROL DEVICES MUSTOR.


$\underline{TRANSPORTATION\ NOTES:}$

- RIGHT-OF-WAY SHALL BE CLEARED AND GRUBBED WITHIN 50 FEET OF ALL RESIDENTIAL OR RESIDENTIAL COLLECTOR INTERSECTIONS, RIGHT-OF-WAY SHALL BE CLEARED AND GRUBBED WITHIN 100 FEET OF ALL OTHER STREET INTERSECTIONS.
- HANDICAPPED RAMPS TO BE CONSTRUCTED AT ALL INTERSECTIONS IN ACCORDANCE WITH CITY OF BALEIGH ENGINEERING STANDARD DETAIL T-20.01.2.
- SIGHTTRIMGLES TO BE LOCATED AT ALL INTERSECTIONS IN ACCORDANCE WITH CITY OF RALEIG STANDARDS, AREAS WHERE SIGHT TRIMGLE ARE LOCATED DUTSIDE THE RIGHT-OF-WAY SHALL B RECORDED AS SIGHT EASEMENTS. FINAL LAYOUT OF SIGHT TRIMGLES TO BE APPROVED WITH CONSTRUCTION DRAWING.
- 4. NO SIGHT OBSTRUCTING OR PARTIALLY OBSTRUCTING WALL, FENCE, FOLIAGE, BERM, PARKED VEHICLES, SIGN OR OTHER OBJECTS BETWENT THE HEIGHTS OF 5 FEET AND 8 FEET ABOVE THE CURB LINE ELEVATION, OR NEAREST TRAVELED WAY IF NO CURBING EXISTS, SHALL BE PLACED WITHIN A SIGHT TRIBAUCH.
- ALL STREET SECTIONS SHALL MEET OR EXCEED SPECIFICATIONS DETAILED IN CITY OF RALEISH ENGINEERING STANDARDS T-10.10, T-10.12, AND T-10.14 AS NOTED.
- ALL STREETS AND RIGHT-OF-WAYS WITHIN AND ADJACENT TO THE PROJECT ARE CONSISTENT WIT THE RALEIGH COMPREHENSIVE PLAN WITH REGARD TO PROPOSED ROADWAY LOCATIONS AND RIGHT-OF-WAY REQUIREMENTS.
- UNLESS OTHERWISE SHOWN, TURNOUT RADII TO BE MINIMUM OF 35' AT ALL PUBLIC STREE INTERSECTIONS AND DRIVEWAY TURNOUTS TO BE A MINIMUM OF 26'

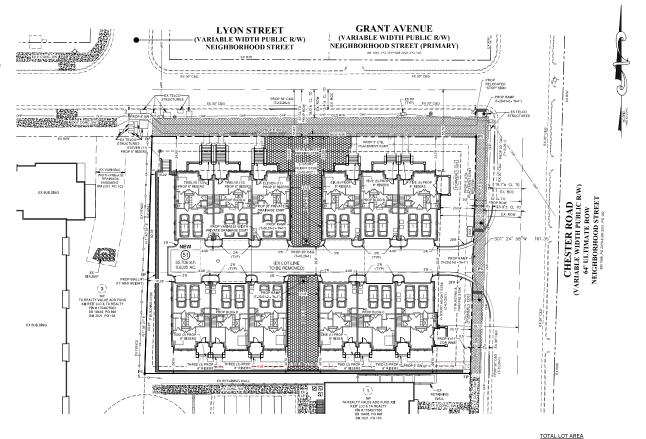



DRIVEWAY SIGHT DISTANCE EXHIBIT

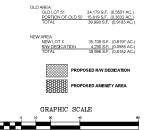



and Land Surveyors

NC License F-0289
333 Wade Ave., Raleigh, N.C. 27605
Phone: (919) 828-4428
Fax: (919) 828-4711

E-mail: info@jaeco.com www.jaeco.com



1335 & 1341 CHESTER R0AD RALEIGH, NC 27608

WILSON BLOUNT 821 WAKE FOREST RD RALEIGH , NC 27604

SITE PLAN

vision	5	
mber	Description	Date
1	PER CITY COMMENTS	02/10/25
2	PER CITY COMMENTS	04/15/25
awing	Scale AS SHOWN	
awn B	v BF	

PLANT LIST MATURE MATURE KEY QUAN, BOTANICAL NAME COMMON NAME TREES SINGLE STEM Chinese Pistache 15-20 STREETSCAPE (UDO 8.5.5.B, UDO 8.5.9.G)

NOTE: STREET TREES SHALL BE INSTALLED AND MAINTAINED IN ACCORDANCE WITH THE REQUIREMENTS OF CHAPTER 2 OF THE CITY TREE MANUAL.

GENERAL NOTES

- CONTRACTOR TO FIELD WERIPY LOCATION & ELEVATION OF ALL EXISTING UTILITIES PRIOR TO CONSTRUCTION, EXISTING UTILITIES SHOWN HEREON WERE OBTAINED VIA BIT ("MISS UTILITIES SHOULD BE ASSUMED TO BE APPROXIMATE AND POTENTIALLY NOOMERTE."
- UNLESS OTHERWISE NOTED, ACCESS ROUTE FOR EMERGENCY VEHICLES SHALL PROVIDE AN INSIDE TURNING RADLIS OF 26 MINIMUM
- 4. EXISTING WATER AND SEWER SIZES AND MATERIALS PER SCOPE-0129-2024

CHESTER ROAD (NEIGHBORHOOD STREET) - 161.35 LF - 20 LF (DRIVEWAY) = 141.35 LF TREES REQUIRED: 7 UNDERSTORY TREES ZIZ OO - EX OVERHEAD POWER LINES) TREES PROMODED: 0 UNDERSTORY TREES - FEE IN LIEU REQUESTED FOR ONE (1) STREET TREE CONSTRUCTION NOTES:

- 1. ALL CONSTRUCTION SHALL BE IN ACCORDANCE WITH CITY OF RALEISH AND/OR NODOT STANDARDS.
- 2. THE CONTRACTOR SHALL CONDUCT THE WORK IN A SAFE MANNER AND WITH A MINIMUM AMOUNT OF INCONVENIENCE TO TRAFFIC.


GRANT AVENUE (NEIGHBORHOOD STREET) - 220.9 LF
TREES RECUIRED: 11 UNDERSTORY TREES (20 OC - EX OVERHEAD POWER LINES)
TREES PROVIDED: 8 UNDERSTORY TREES - FEE IN LIEU REQUESTED FOR THREE (3) STREET TREES


- THE CONTRACTOR SHALL BE RESPONSIBLE FOR ALL TRAFFIC CONTROL AND SHALL ADHERE TO THE PROVISIONS OF THE MUTCO (MOST CURRENT EQITION).
- 4. PRIOR TO START OF WORK, A PRE-CONSTRUCTION MEETING MUST BE SET UP WITH THE CONTRACTOR AND CITY OF RALEIGH TRANSPORTATION FIELD SERVICES STAFF. CONTACT ENGINEERING INSPECTIONS AT (919) 999-2409 TO SET UP THE
- 5. THE DONTRACTOR SHALL OBTAIN A RIGHT-OF-WAY OBSTRUCTION PERMIT FOR MAY WORK WHICH RECURRES THE TEMPORAYY CLOSURE OF A STREET, TRAVEL LINE, PARKIN DISPACE OR SIDEMALK FROM RIGHT-OF-WAY SERVICES AT LEAST 44 HOURS IN ADMINIST, ANY THOROMAY STREET CLOSURE BUSINES SUBMITTED VIEWES RIGHT SERVICE OF THE PROPERTY OF THE
- PRIOR TO CONSTRUCTION BEGINNING, ALL SIGNAGE AND TRAFFIC CONTROL SHALL BE IN PLACE.
- THE CONTRACTOR SHALL REPAIR ANY DAMAGED INFRASTRUCTURE IN THE RIGHT-OF-WAY AND RESTORE IT TO PREVIOUS OR BETTER CONDITION.
- A. A. SIDEYMANS MUST BE ACCESSIBLE TO PERSONS WHO MAR VISUALLY MEPAIRED AND PEOPLE WITH MOBILITY BRANGHIERS. PREDESTRIAN STATION INCLUDING THE AND THE MORE PEOPLETAIN ROUTES DURING CONSTRUCTION WILL BE REQUIRED TO BE COMPLIANT WITH THE UNILC RIGHTS OF MAY ACCESSIBILITY OF DELIVES PROVINCING, 2016 AND STANDARDS FOR ACCESSIBLE DESIGN AND THE MANUAL ON UNIFORM TRAFFE CONTROL DEVICES MUSTORS.

TRANSPORTATION NOTES:

- RIGHT-OF-WAY SHALL BE CLEARED AND GRUBBED WITHIN 50 FEET OF ALL RESIDENTIAL OR RESIDENTIAL COLLECTOR INTERSECTIONS, RIGHT-OF-WAY SHALL BE CLEARED AND GRUBBED WITHIN 100 FEET OF ALL OTHER STREET INTERSECTIONS.
- HANDICAPPED RAMPS TO BE CONSTRUCTED AT ALL INTERSECTIONS IN ACCORDANCE WITH CITY OF RALEIGH ENGINEERING STANDARD DETAIL T-20.01.2.

- ALL STREET SECTIONS SHALL MEET OR EXCEED SPECIFICATIONS DETAILED IN CITY OF RALEISH ENGINEERING STANDARDS T-10-10, T-10-12, AND T-10-14 AS NOTED.
- UNLESS OTHERWISE SHOWN, TURNOUT RADII TO BE MINIMUM OF 35' AT ALL PUBLIC STREET INTERSECTIONS AND DRIVEWAY TURNOUTS TO BE A MINIMUM OF 28'.

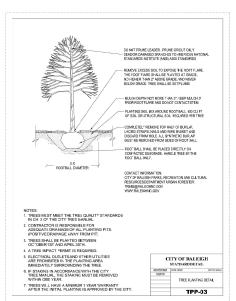

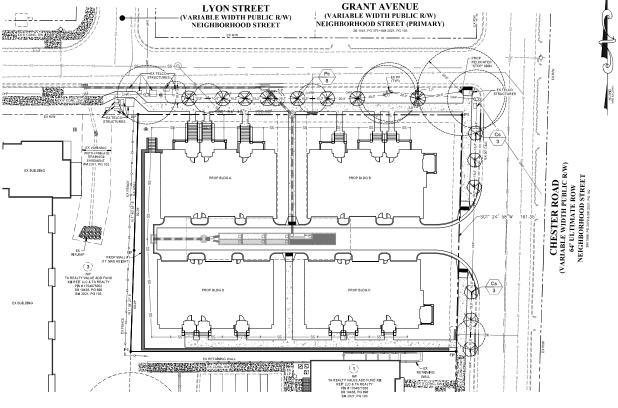

UTILITY CONSTRUCTION SHALL BE IN ACCORDANCE WITH CITY OF RALEIGH AND / OR NODOT STANDARDS AND SPECIFICATIONS UNLESS OTHERWISE NOTED.

and Land Surveyors NC License F-0289 333 Wade Ave., Raleigh, N.C. 27605 Phone: (919) 828-4428 Fax: (919) 828-4711 E-mail: info@jaeco.com

JOHN A FOWARDS & COMPANY Consulting Engineers

www.jaeco.com




1335 & 1341 CHESTER ROAD RALEIGH, NC 27608

WILSON BLOUNT 821 WAKE FOREST RD RALEIGH, NC 27604

STREET TREE PLAN

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mber	Description	Date
1	PER CITY COMMENTS	02/10/25
2	PER CITY COMMENTS	04/15/25

	1 -20	
an By	BF	CE 4
cked By	JRC	CE-4
Issued	11/22/2024	of

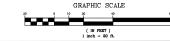

STANDARD UTILITY NOTES

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- Affirming his permiter is required selected at some years a source was a finite of the permitted as a source of the permitted as a source permitted as a content of a solected, peech QTP material A a content A permitted as a source permitted as a content as a source permitted as a source perm

- And there interpreted uffects and attention of a sevent willed as the 1 Fear, a vertical regarded on the process.

 Any operation of price of the pri
- The device and installation shall meet the guidelines of Appendix A Outdelines and Requirements for the Corea Connection Programs. Heighty's Service American Service and Service American Service Service
- undergo the pulpe triology access.


 Finale sub-metering—No reside of water shall occur without approval of the North Carolina Utility Commission. Sub-metering shall be in accordance with Section 1400 of the "SAFE DRINKING WATER ACT".



GENERAL NOTES

- CONTRACTOR TO FIELD VERIEY LOCATION & ELEVATION OF ALL EXISTING UTILITIES PRIOR TO CONSTRUCTION. EXISTING UTILITIES SHOWN HEREON WERE OBTAINED VIA 911 ("MISS UTILITY") MARKOUT. EXISTING UTILITIES SHOULD BE ASSUMED TO BE APPROXIMATE AND POTENTIALLY NO COMPLETE.
- UTILITY CONSTRUCTION SHALL BE IN ACCORDANCE WITH CITY OF RALEIGH AND / OR NODOT STANDARDS AND SPECIFICATIONS UNLESS OTHERWISE NOTED.
- UNLESS OTHERWISE NOTED, ACCESS ROUTE FOR EMERGENCY VEHICLES SHALL PROVIDE AN INSIDE TURNING RADLIS OF 26 MINIMUM

4. EXISTING WATER AND SEWER SIZES AND MATERIALS PER SCOPE-0129-2024

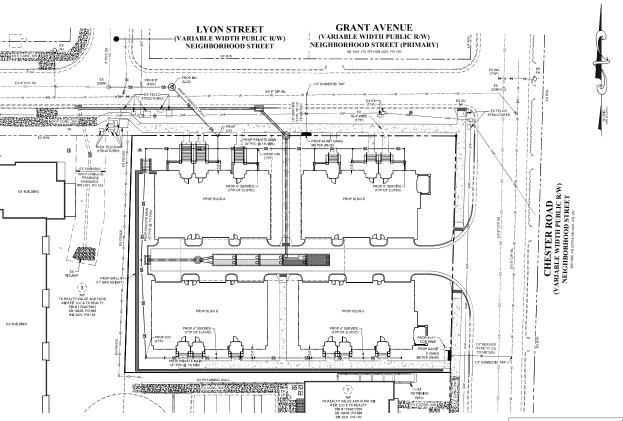

ALL WATER METERS, CLEAN-OUTS & FIRE HYDRANTS LOCATED OUTSIDE OF THE PUBLIC RIGHT-OF-WAY TO BE LOCATED IN A 5' x 5' UTILITY EASEMENT.

ATTENTION CONTRACTORS

The Contractor responsible for the extension of water, sever, and andor rause, as approved in these plans, in responsible for contacting the Infrastructural Inspections Division to schedule and Perconstruction meeting on the Development Portal prior to beginning any construction.

Reading Water must be contacted at (119) 996-1540 at least treenly-down forces prior to beginning any work activity around critical water and even infrastructure.

Failure to notify City Departments in advance of beginning construction, will result in the issuance of monetary fines, and require re-installation of any water or sewer facilities not inspected as a result of this notification failure.

Failure to call for inspection, install a downstream plug, have permitted plans on the jobsite, or any other violation of Raleigh Water Standard will result in a fine and possible exclusion from future work in the City of Raleigh.





Consulting Engineers and Land Surveyors

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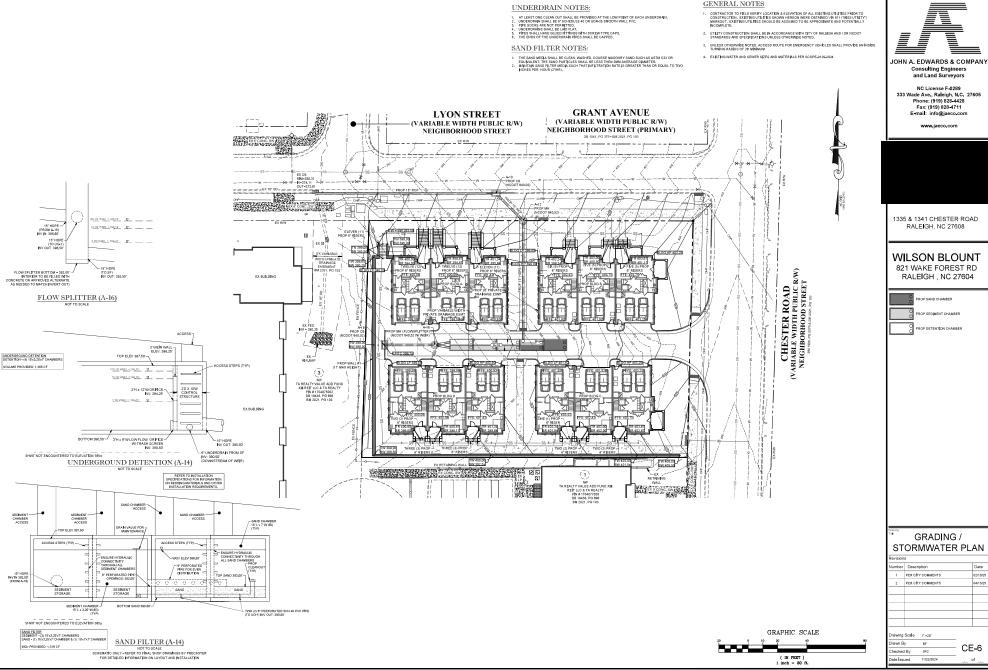
1335 & 1341 CHESTER ROAD RALEIGH, NC 27608

WILSON BLOUNT 821 WAKE FOREST RD RALEIGH, NC 27604

UTILITY PLAN

umber Description 1 PER CITY COMMENTS 2 PER CITY COMMENTS Drawing Scale 1" =20"

rawn By BF CE-5 hecked By JRC te Issued 11/22/2024



GENERAL NOTES

and Land Surveyors NC License F-0289 333 Wade Ave., Raleigh, N.C. 27605 Phone: (919) 828-4428 Fax: (919) 828-4711 E-mail: info@jaeco.com

Consulting Engineers

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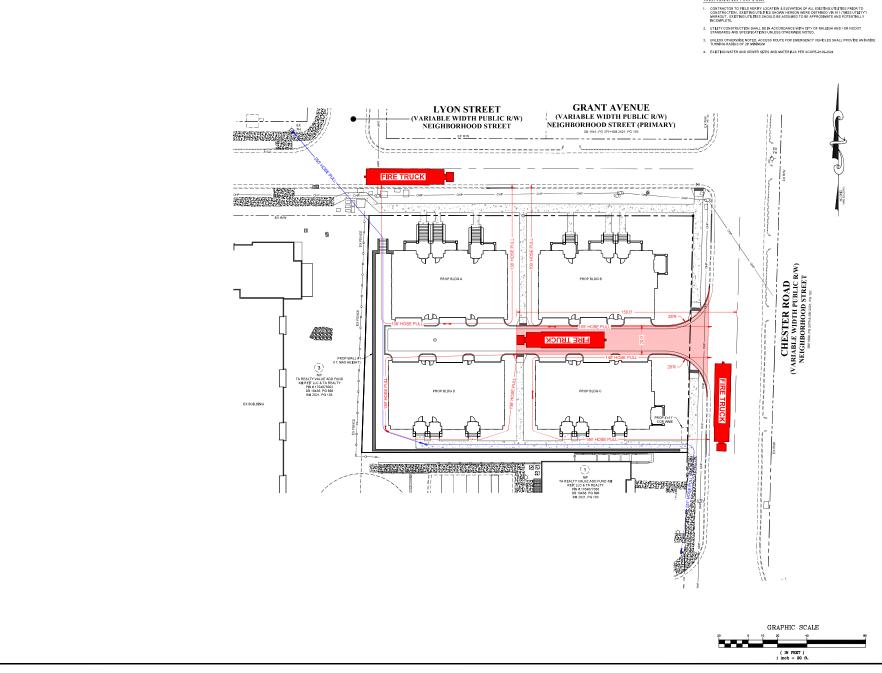




GRADING / STORMWATER PLAN

mber	Description	Date
1	PER CITY COMMENTS	02/10/25
2	PER CITY COMMENTS	04/15/25

Drawn By CE-6 hecked By JRC





JOHN A. EDWARDS & COMPANY
Consulting Engineers
and Land Surveyors


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1335 & 1341 CHESTER ROAD RALEIGH, NC 27608


WILSON BLOUNT 821 WAKE FOREST RD RALEIGH , NC 27604



FIRE DEPARTMENT PLAN

Number	Description	Date
1	PER CITY COMMENTS	02/10/
2	PER CITY COMMENTS	04/15/

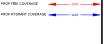Drawn By Checked By

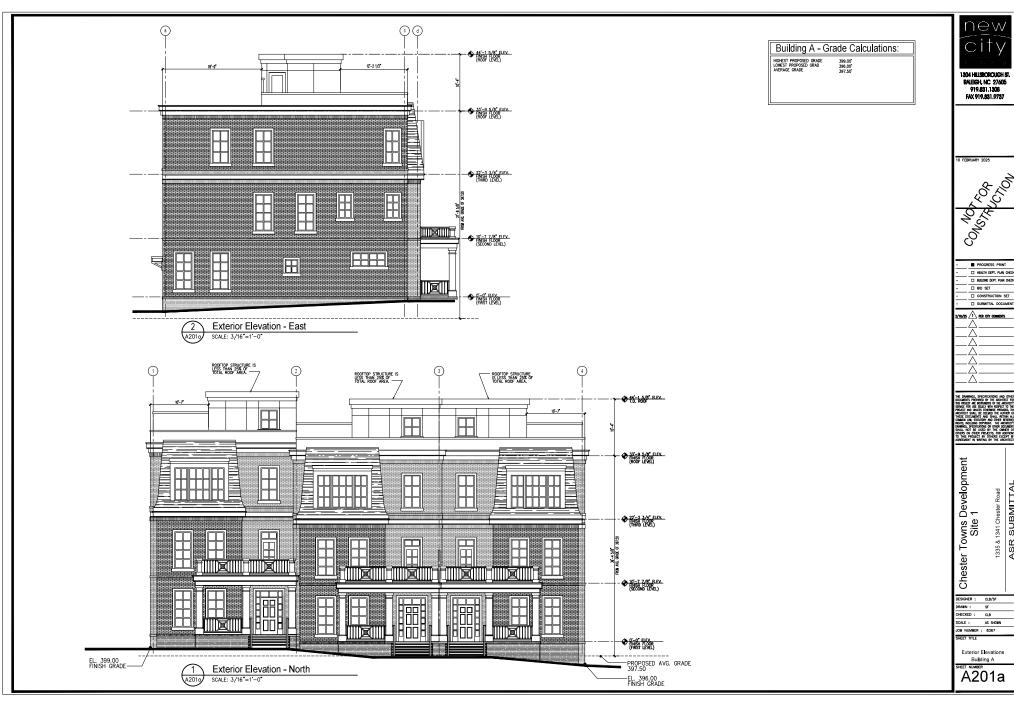




PROGRESS PRINT ☐ HEALTH DEPT, PLAN CHECH

BUILDING DEPT. PLAN CHECK CONSTRUCTION SET

1335 & 1341 Chester Road
ASR SUBMITTAL

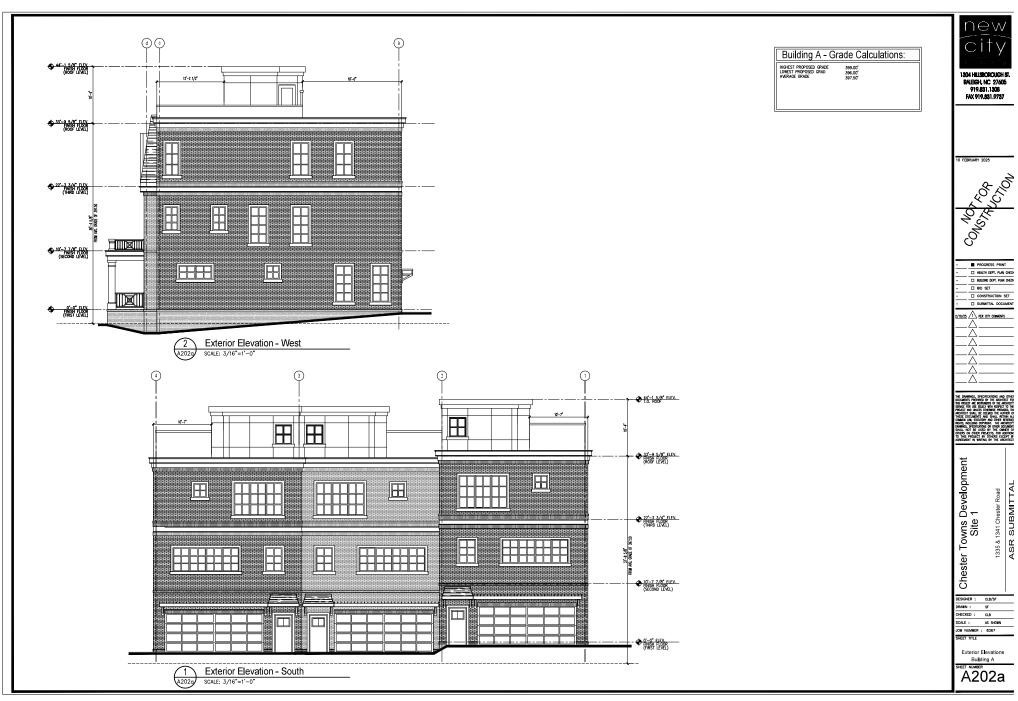

1304 HILSBOROUGH ST. RALEIGH, NC 27605 919.831.1308 FAX 919.831.9787



PROGRESS PRINT HEALTH DEPT, PLAN CHECK

BUILDING DEPT. PLAN CHECK ☐ BID SET

☐ CONSTRUCTION SET

2/10/25 1 PER CITY COMMENTS

DESIGNER : CLB/SF SCALE : AS SHOWN

Exterior Elevations

A202a








•	PROGRESS PRINT
	HEALTH DEPT. PLAN CHECK
	BUILDING DEPT. PLAN CHECK
	BID SET
	CONSTRUCTION SET
	SUBMITTAL DOCUMENT
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1335 & 1341 Chester Road
ASR SUBMITTAL

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1804 HILISBOROUGH ST. RALEIGH, NC 27605 919.831.1308 FAX 919.831.9737

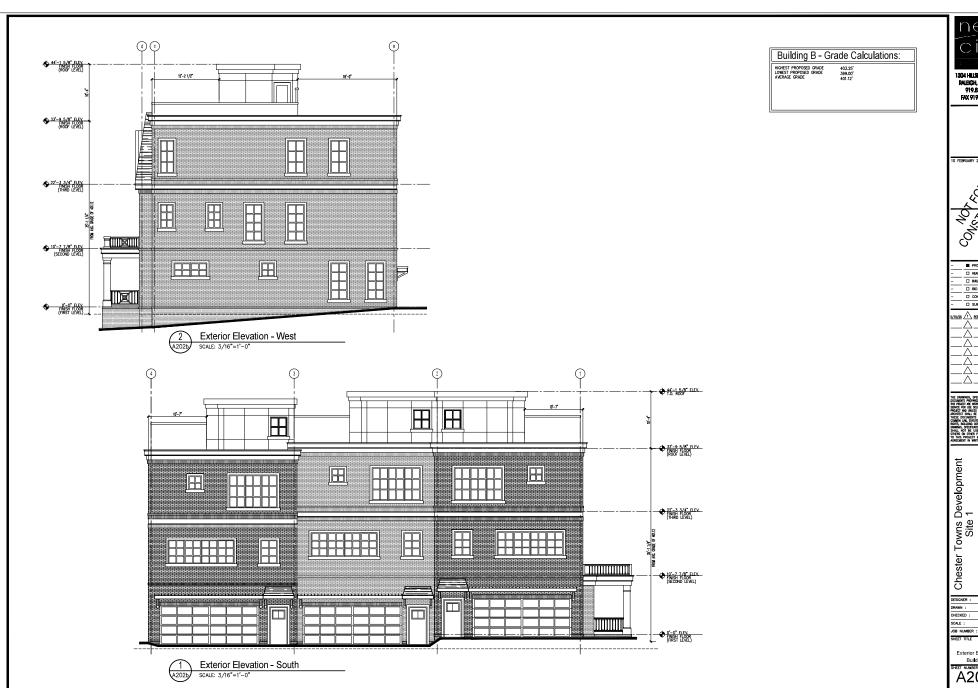

	PROGRESS PRINT
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	BUILDING DEPT. PUN CHECK
_	☐ BID SET
_	☐ CONSTRUCTION SET
_	SUBMITTAL DOCUMENT

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1335 & 1341 Chester Road
ASR SUBMITTAL

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SIGNER :	CLB/SF
RAWN :	SF
HECKED :	CLB
CALE :	AS SHOWN

Exterior Elevations
Building B
SHEET NUMBER
A202b





1304 HILSBOROUGH ST. RALEIGH, NC 27605 919.831.1308 FAX 919.831.9787



PROGRESS PRINT HEALTH DEPT. PLAN CHECK

BULDING DEPT. PLAN CHECK ☐ BID SET ☐ CONSTRUCTION SET


2/10/25 1 PER CITY COMMENTS

1335 & 1341 Chester Road
ASR SUBMITTAL

DESIGNER : CLB/SF SF CHECKED : CLB SCALE: AS SHOWN JOB NUMBER: 8367

Exterior Elevations Building C

A201c

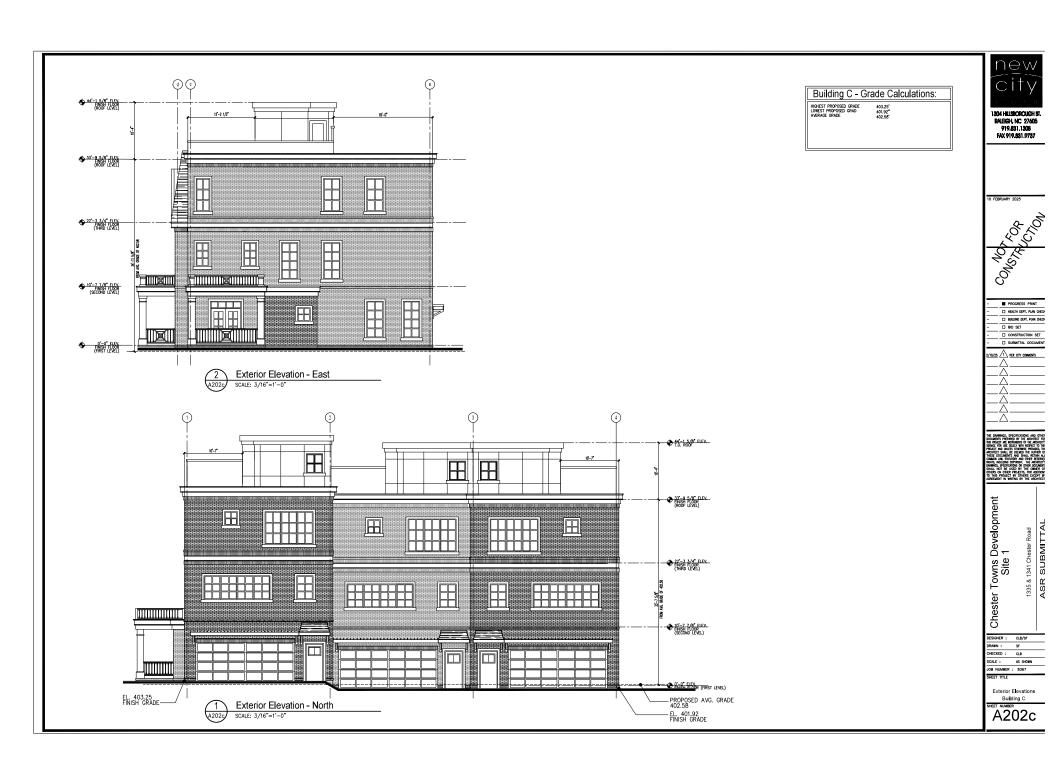



1304 HILSBOROUGH ST. RALEIGH, NC 27605 919.831.1308 FAX 919.831.9787



PROGRESS PRINT HEALTH DEPT. PLAN CHECK

BULDING DEPT. PLAN CHECK ☐ BID SET ☐ CONSTRUCTION SET


2/10/25 1 PER CITY COMMENTS

1335 & 1341 Chester Road
ASR SUBMITTAL

DESIGNER : CLB/SF RAWN: SF CHECKED : CLB SCALE : AS SHOWN JOB NUMBER: 8367

Exterior Elevations Building D

A201d

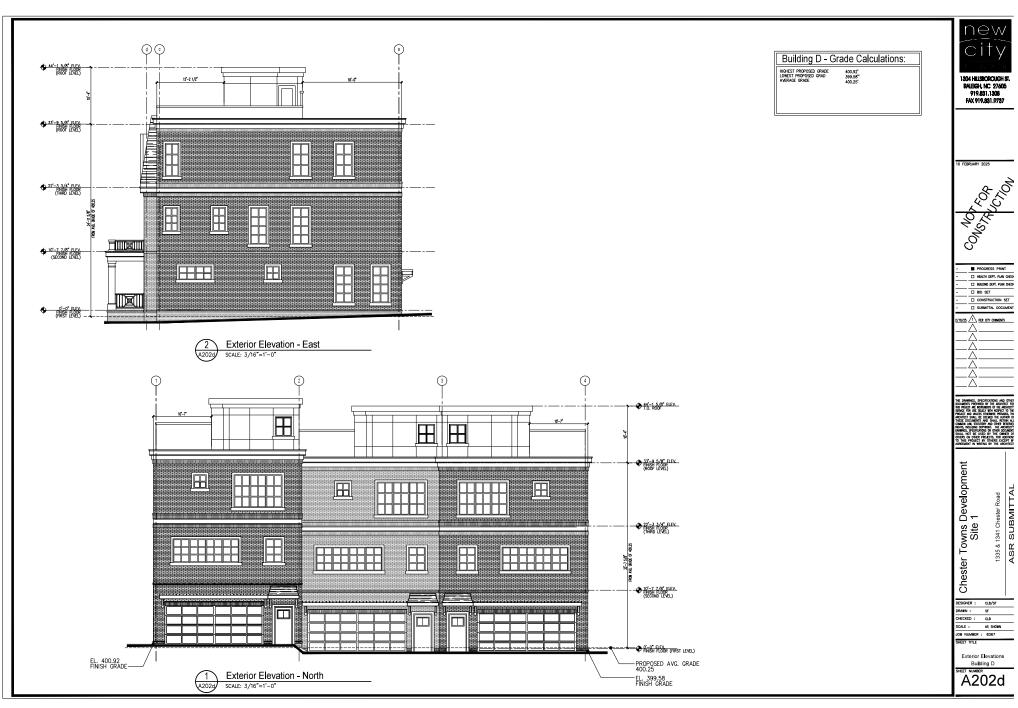



PROGRESS PRINT HEALTH DEPT, PLAN CHECK

BULDING DEPT. PLAN CHECK

CONSTRUCTION SET

2/10/25 1 PER CITY COMMENTS

Exterior Elevations