

Case File / Name: ASR-0098-2022 DSLC - Collegeview Student Housing City of Raleigh
Development Services Department
One Exchange Plaza
Raleigh, NC 27602
(919) 996-2492
currentplanning@raleighnc.gov
www.raleighnc.gov

**LOCATION:** This site is composed of 16 parcels located on the north side of Avent Ferry Road,

west of Varsity Drive (between Varsity Drive, Crest Road, and Collegeview Avenue)

at 1406 Varsity Drive.

**REQUEST:** Development of a 4.14 acre/180,206 sf site zoned RX-7-UL with a total right-of-way

dedication along Varsity Dr. (1,729 sf), Crest Rd (1,400 sf) and Collegeview Ave. (4,761 sf), totaling .18 acres/7,890 sf leaving a net area of 3.95 acres/172,130 sf. A proposed 226 multi-units apartment structure, 349,007 sf gross floor area (42 1-bedroom; 61 2-bedrooms; 11 3-bedrooms; 98 4-bedrooms & 14 5-bedrooms), and an enclosed parking garage of 136,158 sf, for a total gross area of 485,165 sf.

Z- 35-22 - Rezoning Varsity Dr. & Collegeview Ave - Prohibited Uses. Adopted

10/4/22. Effective 10/9/22.

DESIGN

ADJUSTMENT(S)/

ALTERNATES, ETC: SUR-0896-2022: DSENG - Surety/Infrastructure

FINDINGS: City Administration finds that this request, with the below conditions of

approval being met, conforms to the Unified Development Ordinance. This approval is based on a preliminary plan dated June 16, 2023 by Mcadams.

## **CONDITIONS OF APPROVAL and NEXT STEPS:**

This document must be applied to the second sheet of all future submittals except for final plats. This is a preliminary plan and as such no permits have been issued with this approval. To obtain permits and/or completion of the project, the following steps are required:

☑ <u>SITE PERMITTING REVIEW</u> - For land disturbance of 12,000 square feet or greater, public or private infrastructure, shared stormwater devices, etc. Site Permitting Review may be submitted upon receipt of this signed approval document.

The following items are required prior to approval of Site Permitting Review plans:

### **Public Utilities**

1. A Downstream Sewer Capacity Study in compliance with the City of Raleigh Public Utilities Department Handbook shall be submitted by the Project Engineer for review and approval.

### **Stormwater**

- 2. A surety equal to of the cost of clearing, grubbing and reseeding a site, shall be paid to the City (UDO 9.4.4).
- 3. A stormwater control plan with a stormwater operations and maintenance manual and budget shall be approved (UDO 9.2).
- 4. A nitrogen offset payment must be made to a qualifying mitigation bank (UDO 9.2.2.B).



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☑ <u>LEGAL DOCUMENTS</u> - Email to legaldocumentreview@raleighnc.gov. Legal documents must be approved, executed, and recorded prior to or in conjunction with the recorded plat on which the associated easements are shown. Copies of recorded documents must be returned to the City within one business day of recording to avoid withholding of further permit issuance.

V	Right of Way Deed of Easement	V	Utility Placement Deed of Easement
	Required		Required

☑ <u>RECORDED MAP(S)</u> - Submit plat to record new property lines, easements, tree conservation areas, etc.). Plats may be submitted for review when the Site Permitting Review plans, if required, have been deemed ready for mylar signature.

The following items must be approved prior to recording the plat:

### General

1. A demolition permit shall be issued and this building permit number shown on all maps for recording.

### **Engineering**

- 2. A pedestrian and bicycle deed of easement, in addition to a plat showing the location of the easement, shall be submitted to the Planning and Development Services Department for review, and if acceptable, approved for recordation. Approved plats must be recorded at the Wake County Register of Deeds Office on or before the 14th day following approval by the City. The 14-day expiration date shall be clearly indicated on the plat. By the end of the next business day following recordation of the plat, all required legal instruments (including deeds of easement) shall be recorded, and recorded copies of the plat and all legal instruments required by the City in association with development approval shall be provided to the City. (Reference: UDO 8.1.7.A; 10.2.5.F.4.d)
- 3. A sight distance easement shall be approved by the Transportation Department for recording in the Wake County Registry and shown on a plat approved for recordation.
- 4. A public infrastructure surety shall be provided to City of Raleigh Transportation Development Engineering Division (UDO 8.1.3) in the amount of 100% of the improvement cost for the NCDOT portion and 125% of the improvement cost for the City of Raleigh infrastructure.
- 5. A public street right-of-way deed of easement, in addition to a plat showing the location of the easement, shall be submitted to the Planning and Development Services Department for review, and if acceptable, approved for recordation. Approved plats must be recorded at the Wake County Register of Deeds Office on or before the 14th day following approval by the City. The 14-day expiration date shall be clearly indicated on the plat. By the end of the next business day following recordation of the plat, all required legal instruments (including deeds of easement) shall be recorded, and recorded copies of the plat and all legal instruments required by the City in association with development approval shall be provided to the City. (Reference: UDO 8.1.7.A; 10.2.5.F.4.d)



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6. A 5' utility placement easement deed of easement, in addition to a plat showing the location of the easement, shall be submitted to the Planning and Development Services Department for review, and if acceptable, approved for recordation. Approved plats must be recorded at the Wake County Register of Deeds Office on or before the 14th day following approval by the City. The 14-day expiration date shall be clearly indicated on the plat. By the end of the next business day following recordation of the plat, all required legal instruments (including deeds of easement) shall be recorded, and recorded copies of the plat and all legal instruments required by the City in association with development approval shall be provided to the City. (Reference: UDO 8.1.7.A; 10.2.5.F.4.d)

### **Urban Forestry**

7. A tree conservation plat shall be recorded with metes and bounds showing the designated tree conservation areas (UDO 9.1). This development proposes .14 acres of tree conservation area.

☑ <u>BUILDING PERMITS</u> - For buildings and structures shown on the approved plans. Commercial building permit plans must include the signed, approved Site Permitting Review plans attached, if applicable. Permit sets may be reviewed prior to the recordation of required plats, but cannot be approved.

### The following items must be approved prior to the issuance of building permits:

### General

- 1. A demolition permit shall be obtained.
- 2. A recombination map shall be recorded recombining the existing lots into a single tract.
- 3. Comply with all conditions of Z-35-22.
- 4. A recombination map shall be recorded prior to or in conjunction with the recording of lots, recombining the existing lot into a single tract.

### **Engineering**

5. A public infrastructure surety shall be provided to City of Raleigh Transportation – Development Engineering Division (UDO 8.1.3) in the amount of 100% of the improvement cost for the NCDOT portion and 125% of the improvement cost for the City of Raleigh infrastructure.

### **Public Utilities**

6. A plat must be recorded at the Wake County Register of Deeds office for all utility easement dedications.

### **Stormwater**

7. A surety equal to 125% of the cost of the construction of a stormwater device shall be paid to the Engineering Services Department (UDO 9.2.2.D.1.d).



Case File / Name: ASR-0098-2022 **DSLC - Collegeview Student Housing** 

City of Raleigh **Development Services Department** One Exchange Plaza Raleigh, NC 27602 (919) 996-2492 currentplanning@raleighnc.gov www.raleighnc.gov

- 8. A payment equal to twenty-four percent (24%) of the estimated cost of constructing all stormwater control facilities shown on the development plans shall be paid by the developer to the City stormwater facility replacement fund (UDO 9.2.2.G.3).
- 9. All stormwater control measures and means of transporting stormwater runoff to and from any nitrogen and stormwater runoff control measures shall be shown on all plats for recording as private drainage easements (UDO 9.2).

### **Urban Forestry**

- 10. A tree impact permit must be obtained for the approved streetscape tree installation in the right of way. This development proposes 12 street trees along Crest Rd, 4 street trees along Varsity Dr, and 11 street trees along Collegeview Sr.
- 11. A tree conservation plat shall be recorded with metes and bounds showing the designated tree conservation areas (UDO 9.1).
- 12. A public infrastructure surety for the 27 required street trees shall be provided to City of Raleigh Transportation - Development Engineering Division (UDO 8.1.3) in the amount of 125% of the improvement cost for the City of Raleigh infrastructure.

### The following are required prior to issuance of building occupancy permit:

### General

- 1. All Water, Sanitary Sewer and Reuse facilities shall be installed, inspected, tested and accepted by the City of Raleigh Public Utilities Department for operations and maintenance.
- 2. All street lights and street signs required as part of the development approval are installed.
- Final inspection of all tree conservation areas and right of way street trees by Urban Forestry Staff

### **Stormwater**

- 4. As-built drawings and associated forms for all Stormwater devices are accepted by the Engineering Services Department (UDO 9.2.2.D.3).
- As-built impervious survey is accepted by the Engineering Services Department (UDO 9.2).

EXPIRATION DATES: The expiration provisions of UDO Section 10.2.8 E, including the ability to request extensions in the expiration date, apply to this site plan. If significant construction has not taken place on a project after administrative site review approval, that approval may expire and be declared void, requiring re-approval before permits may be issued. To avoid allowing this plan approval to expire the following must take place by the following dates:



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3-Year Expiration Date: July 19, 2026

Obtain a valid building permit for the total area of the project, or a phase of the project.

### 4-Year Completion Date:

Within four years after issuance of the first building permit for the site plan, the construction of the entire site plan must be completed unless an applicant has been granted vested rights. Failure to complete construction within this specified time frame shall automatically void the approved site plan for which no building permits have been issued.

I hereby certify this administrative decision.				
Signed:	Daniel L Stegall	Date:	07/19/2023	
	Development Services Øir/Designee	_		
Staff Coordinator:	Jermont Purifoy			

# Administrative Site Review Application Yes No ... Existing (sf) 69,490 Proc Continue to Applicant Signature Block on Page Three Page 2 of

# COLLEGEVIEW MULTIFAMILY APARTMENTS

1406 VARSITY DRIVE RALEIGH, NORTH CAROLINA 27606 **ADMINISTRATIVE SITE REVIEW** 

CITY OF RALEIGH CASE# ASR-0098-2022 PROJECT NUMBER: SPEC-22179

**DATE: OCTOBER 18, 2022** 

PHYSICAL ADDRESS:			TY DR., 1400, 1402, 1404, 140	
DARCEL DIM-		RD., 1409, 1423, 1419, 1411, 1501, 1427 COLLEGEVIEW AVE 0793386406, 0793386421, 0793386395, 0793386401, 0793386207, 0793386147, 0793385138, 07933861228, 0793386322, 0793386322, 0793385100, 0793385144, 0793383179, 0793386510, 0793386204		
		0793383144, 0793383179, 0	793384554, 0793383027, 079: 793386510, 0793384204	3586322, 0793383010,
ZONING:		RX-7-UL		
OVERLAY DISTRICT:		NONE		
WATERSHED: SITE AREA		BUSHY AND WALNUT		
RIGHT-OF-WAY DEDICATIO	N.	VARGITY DRIVE-	NET: 172,130 SF / 3.95 ACF 1,729 SF (0.040 AC)	lES .
NIGHT-OF-MAT DEDICATIO	in:	CREST ROAD: COLLEGEVIEW AVENUE: TOTAL ROW DEDICATION:	1,729 SF (0.090 AC) 1,400 SF (0.092 AC) 4,761 SF (0.109 AC) 7,890 SF (0.181 AC)	
FLOODWAY/FLOODPLAIN:		NONE		
BUILDING DATA:		RESIDENTIAL: TOTAL NO. OF UNITS:	349,007 SF 42 (1)-BEDROOM 61 (2)-BEDROOM 11 (3)-BEDROOM 98 (4)-BEDROOM 14 (5)-BEDROOM 226 UNITS	
		PARKING DECK:	136,158 SF	
		TOTAL GROSS SF:	485.165 SF	
PARKING DATA:	VEHICLE PARKING	REQUIRED:		IMAXI PER UDO SEC. 7.1.2.
		1-BEDROOM: 2-BEDROOM: 3-BEDROOM: 4-BEDROOM: 5-BEDROOM: TOTAL MAXIMUM ALLOW	42 * 1.5 PER UNIT = 6 61 * 2.25 PER UNIT = 11 * 3 PER UNIT = 33 98 * 4 PER UNIT = 39 14 * 5 PER UNIT = 70	G SPACES 138 SPACES SPACES 1 SPACES SPACES SPACES
			10 ADA SPACES (2 VA 390 TOTAL SPACES	N SPACES INCLUDED)
	ACCESSIBLE PARKING	2 V.		21440
	BIKE PARKING		PACES (8 STANDARD SPACES 8 DNG TERM SPACES: 12 SHORT	
		RESIDENTIAL LON	G TERM: 95 SPACES (1/7 RT TERM: 12 SPACES (1/2)	BEDROOMS)
		105	ONG TERM SPACES; 12 SHORT SPACES TOTAL	TERM SPACES
BUILDING + PARKING BUILD-TO SETBACKS		REQUIRED VARSITY DRIVE (PRIMAR COLLEGEVIEW AVERUE () 30% REDUCTION AMENITY AREA (R CREST ROAD (SECONDAR PROVIDED VARSITY DRIVE (PRIMAR COLLEGEVIEW AVERUE ) CREST ROAD (SECONDAR	ECONDARY STREET): 80 O 25% BUILD-TO PERCENTAG ER UDO SECTION 1.5.6.C.A) ' STREET): 11  STREET): 14 ECONDARY STREET]: 87	6 LF (25% OF 462') 4.7 LF (144.7'/173'+83.6%) 4 LF (87.4'/456'+19.2%)
	PARKING SETBACK	VARSITY DRIVE (PRIMARY ST COLLEGEVIEW AVENUE (SEC CREST ROAD (SECONDARY S REAR & SIDE LOT UNE:	REET): 10 DNDARY STREET]: 10 'REET]: 10	2 LF (302'/462'=65.4%)  (PER UDO SEC. 3.2.4.A.B.C.) (PER UDO SEC. 3.2.4.A.B.C.) (PER UDO SEC. 3.2.4.A.B.C.)
EXISTING IMPERVIOUS:		1.60 AC. (69,490 SF)		
PROPOSED IMPERVIOUS A BUILDING HEIGHT	LLOCATION:	2.87 AC. (124,907 SF) MAXIMUM ALLOWED: 7 S	ORY	
TREE CONSERVATION		PROPOSED: 5 S'	ORY CU, AND REQUIRES BUILDING	TO FRONT STREET FLIGIBLE
		TCA IS IN CONFLICT WITH FR REQUIRED.	INTAGE REQUIREMTNS PER U	DO 9.1.3.A.2 TCA IS NOT
REQUIRED BUILDING SETBACKS  REQUIRED PARKING SETBACKS  REQUIRED BUILD TO -UL URBAN LIMITED		PROVIDED: 0.401 ACR	:S (17,213 SF) :S (17,463 SF)	
		PRIMARY STREET (MIN): SIDE STREET (MIN): SIDE LOT LINE (MIN):	5' (PER UI	00 SEC. 3.2.4.A.B.C.) 00 SEC. 3.2.4.A.B.C.) ER UDO SEC. 3.2.4.A.B.C.)
		PRIMARY STREET (MIN): SIDE STREET (MIN): REAR AND SIDE LOT LINE (MI	10' (PER L 10' (PER L	(DO SEC. 3.2.4.A.B.C.) (DO SEC. 3.2.4.A.B.C.) (DO SEC. 3.2.4.A.B.C.)
		PRIMARY STREET (MIN/MAX) BUILDING WITHIN PRIMARY SECONDARY STREET (MIN/M BUILDING WITHIN PRIMARY)	UILD TO (MIN): 509	80' (PER UDO SEC. 3.4.7.C) 6 (PER UDO SEC. 3.4.7.C) 80' (PER UDO SEC. 3.4.7.C) 6 (PER UDO SEC. 3.4.7.C)



CONTRACTOR SHALL NOTIFY "NC811" (811) OR (1-800-632-4949)
AT LEAST 3 FULL BUSINESS DAYS PRIOT 10 BEGINNING
CONSTRUCTION ON EXCAVATION TO HAVE EXISTING UTILITIES
LOCATED. CONTRACTOR SHALL CONTRACT ANY LOCAL UTILITIES
THAT PROVIDE THEIR OWN LOCATOR SERVICES INDEPENDENT OF
"NC811", REPORT ANY DISCREPANCIES TO THE ENGINEER

ZONING CONDITIONS (REZONING CASE Z-35-22)

1. THE TOLLOWING PRINCIPAL USES AS LISTED IN UDO SECTION 6.1.4. THAT ARE PROMETED. (I) CLIMITED, OR SPECULA USES IN THE RE- DISTRICT SHALL BE PROMETED. (I) CLIMITED'S THE USE IS NOT PROPOSED WITHIN THIS SITE PLAN.

### NOTES:

THE MINIMUM CORNER CLEARANCE FOR A DRIVEWAY FROM THE CURB LINE OF INTERSECTING STREETS SHALL BE AT LEAST 20 FEET FROM THE POINT OF TANGENCY OF THE CURB. NO DRIVEWAYS SHALL ENCROACH ON THIS MINIMUM CORNER CLEARANCE. RSDM SECTION 6.5.2.D.

2. WITHIN THE APEA OF A DETRIED SIGHT TRANQUE, THERE SHALL BE NO SIGHT DESTRUCTING OR PARTLY DESTRUCTING WALL, FENCE, SIGN, FOLIAGE, BETMING OR PARKED VEHICLES BETWEEN THE HEIGHTS OF TWENTY-FOUR (24) INCHES AND LOGHT (6) FEET ABOVE THE CUSTS. BLEVATION OF THE NEAREST TRAVELED WAY, IF NO CUBBIND EXISTS.

I. PER TC-5A-18 & SEC. 1.5.4.C, THE PRIMARY DESIGNATION SHALL BE: VARSITY DRIVE.

### SOLID WASTE COMPLIANCE STATEMENT:

- THE DEVELOPER ACKNOWLEDGES THAT THEY HAVE REVIEWED AND ARE IN COMPLIANCE WITH THE REQUIREMENTS SET FORTH IN THE SOLID WASTE DESIGN MANUAL.
- THE SOLID WASTE REMOVAL FOR THIS PROJECT WILL BE HANDLED BY A
- REFUSE WILL BE COLLECTED IN ROLL—OUT TRASH AND RECYCLING CAR. THAT WILL BE BROUGHT OUT CURB SIDE FOR PICKUP, PICKUP WILL BE

### SHEET INDEX

 C0.00
 PROJECT NOTES

 C0.01
 APPROVAL FORMS

 2-2
 ALTA/NSPS LAND TITLE SURVEY

 C1.01
 DEMOLITION PLAN

C2.00 OVERALL SITE PLAN
C2.01 SIGHT DISTANCE TRIANGLE PLAN

C2.01 SIGHT DISTANCE TRIANGLE PLAN C2.02 AMENITY AREA PLAN

C3.00 OVERALL GRADING AND STORM DRAINAGE PLAN

C4.00 OVERALL UTILITY PLAN
C8.00 SITE DETAILS
C8.01 SITE DETAILS

C8.02 SITE DETAILS
C8.03 STORM DRAINAGE DETAILS

C8.04 SANITARY SEWER DETAILS
C8.05 WATER DETAILS

C8.06 WATER DETAILS
C9.00 SCM PLAN VIEW AND NOTES

C9.00 SCM PLAN VIEW AND NOTES
C9.01 SCM PROFILE VIEW
L5.00 LANDSCAPE PLAN

L8.00 TREE CONSERVATION PLAN

BY OTHERS

01 SITE PLAN/LEVEL 1 03 LEVEL 4-5 04 ROOF PLAN 05 FLEVATIONS 06 ELEVATIONS SCHEMATIC SECTIONS Ω7 BUILDING SECTIONS 08 SOLID WASTE ENCLOSURE A-500

SL1 ROOF AMENITY/PARKING DECK PHOTOMETRIC PLAN

SL2 LIGHTING DETAILS



### VICINITY MAP



### ATTENTION CONTRACTORS

The Construction Contractor responsible for the extension of water, sever, and/or reuse, as approved in these plans, is responsible for contacting the Public Works Department of (919) 986-2450, and the Public Utilities Department of (919) 986-24540 at least the public value of the public Version of the Public Utilities Department of (919) 986-24540 at least the public value of the public value of the value of value o

Failure to notify both City Departments in advance of beginning construction, will result in the issuance of monetary fines, and require reinstallation of any water or sewer facilities not inspected as a result of this notification failure.

Failure to call for Inspection, Install a Downstream Plug, have Permitted Plans on the Jobsite, or any other Violation of City of Raleigh Standards will result in a <u>Fine and Possible Exclusion</u> fror luture work in the City of Raleigh.

> SEE SHEET CO.00 FOR ALL PROJECT, SITE, GRADING, STORM DRAINAGE AND UTILITY NOTES

ALL CONSTRUCTION SHALL BE IN
ACCORDANCE WITH THE CURRENT CITY OF
RALEIGH ENGINEERING DESIGN AND
CONSTRUCTION STANDARDS
MINARY DRAWING - NOT BE FASED FOR CONSTRUCTIO



The John R. McAdams Company, In

phone 919. 823. 4300 fax 919. 361. 2269 license number: C-0293, C-187

### CONTACT

JONATHAN BALDERSON balderson@mcadamsco.com PHONE: 919, 287, 0815

### CLIENT

FD STONEWATER 1001 19TH STREET N, SUITE 1401 ARLINTON, VA 22203

### PROJECT DIRECTORY

DEVELOPER



Digitally signed by Jermont.Purifoy@raleight.gov Date: 2023.07.12 15:06:17-04'00' Jermant Purifay Raleigh

### REVISIONS

| NO. DATE | 1 22. 22. 2022. | RESPONSE TO EST ASK REVIEW | 2 00. 15. 2023. | RESPONSE TO 2ND ASK REVIEW | 3 05. 30. 2023. | RESPONSE TO 2ND ASK REVIEW | 4 05. 16. 2023. | RESPONSE TO 2ND ASK REVIEW | 4 05. 16. 2023. | RESPONSE TO 2ND ASK REVIEW |

### PLAN INFORMATION

PROJECT NO. SE FILENAME CHECKED BY DRAWN BY SCALE DATE .

### SHEET

### ADMINISTRATIVE SITE REVIEW FOR:

COLLEGEVIEW MULTIFAMILY APARTMENTS 1406 VARSITY DRIVE RALEIGH, NC 27606 PROJECT NUMBER: SPEC-22179

- ALL CONSTRUCTION SHALL CONFORM TO THE LATEST CITY OF RALEIGH AND/OR NCDOT STANDARDS AND SPECIFICATIONS.
- ALL DIMENSIONS SHOWN ON SITE PLAN ARE TO FACE OF CURB UNLESS OTHERWISE NOTED.
- OCCUPATIONAL SALETY AND REAL IN JOHN PROFIT OF COURT WALLS OT HERWISE NOT INCOURT OF THE COURT OF THE COURT

- EGSTING IMPROVEMENTS DAMAGED DURING CONSTRUCTION SHALL BE REPLACED/RESTORED TO THEIR ORIGINAL CONDITION OR TO THE SATISFACTION OF THE OWNER BY THE CONTRACTOR RESPONSIBLE FOR THE DAMAGE.
- CONTRACTOR IS RESPONSIBLE FOR COORDINATING CONSTRUCTION ACTIVITIES WITH THE APPROPRIATI URLUT COMPANIES FOR ANY REQUIRED RELOCATION (I.E. POWER POLES, TELEPHONE PEDESTALS, WATER METERS, ETC.).

### GENERAL NOTES:

- OWNER RESERVES RIGHT TO ADJUST SITE IMPROVEMENTS AND MODIFY BUILDING FOOTPRINTS FROM THOSE SHOWN ON THIS PLAN.
- PRIOR TO BEGINNING CONSTRUCTION, THE GENERAL CONTRACTOR SHALL SCHEDULE AND ATTEND A
  PRE-CONSTRUCTION CONFERENCE WITH THE CITY OF RALEIGH PUBLIC WORKS, ENGINEERING INSPECTIONS
  DEPARTMENT (1919) 996-5824, AND A REPRESENTATIVE OF THE REMINEER AND OWNER.
- CONSTRUCTION, MAINTENANCE AND REMOVAL OF ALL EROSION CONTROL DEVICES ARE THE RISPONSIBILITY OF THE SITE CONTRACTOR, AFTER PERMISSION BY EROSION CONTROL INSPECTOR.
- 4. EXISTING UTILITIES AND STRUCTURES SHOWN, BOTH UNDERGROUND AND ARON GROUND, ARE RASED ON A FIELD SURVEY AND THE BEST AVAILABLE RECORD DOKAMINGS. THE CONTRACTOR SHALL VISIBLY FIELD CONDITIONS PROFIT DISGINATIONS GRATED CONSTRUCTORS, AND TO RESERVENCE STRUCK AND THE PLANS SHALL BE REPORTED TO THE OWNER'S REPRESENTATIVE AND ENGINEER.

### STORM DRAINAGE NOTES:

- ALL STORM DRAINAGE PIPES SHOWN ARE TO BE CLASS III REINFORCED CONCRETE (RCP) UNLESS NOTED OTHERWISE.
- 2. ALL STORM DRAINAGE CONSTRUCTION SHALL BE IN ACCORDANCE WITH THE LATEST CITY OF RALEIGH AND
- 3. ALL CONCRETE SHALL MEET A MIMMUM 3000 PSI COMPRESSIVE STRENGTH.
- 4 ALL PIPE IN STORM DRAIN STRUCTURES SHALL RESTRUCK EVEN WITH INSIDE WALL
- ALL PIPE JOINTS SHALL BE MADE WITH PREFORMED JOINT SEALER, WHICH CONFORMS TO AASHTO SPECIFICATION M-198 FOR TYPE B FLEXIBLE PLASTIC GASKETS UNLESS OTHERWISE NOTED.
- THE INTERIOR SURFACES OF ALL STORM DRAINAGE STRUCTURES SHALL BE POINTED UP AND SMOOTHED TO AN ACCEPTABLE STANDARD USING MORTAR MIXED TO MANUFACTURER'S SPECIFICATIONS.
- ALL BACKFILL SHALL BE NON-PLASTIC IN NATURE, FREE FROM ROOTS, VEGETATION MATTER, WASTE
  CONSTRUCTION MATERIAL OR OTHER OBJECTIONABLE MATERIAL. SAID MATERIAL SHALL BE CAPABLE OF
  BEING COMPACTE OF INECCHANICAL MORNS AND SHALL HAVE NO TRINDING'T TO FLOW OR BEHAVE IN A
  PLASTIC MAINTER UNDER THE TRAPPING BLOWS OR PROOF ROLLING.
- MATERIALS DEEMED BY THE OWNER'S REPRESENTATIVE OR GEOTECHNICAL ENGINEER AS UNSUITABLE FOR BACKFILL PURPOSES SHALL BE REMOVED AND REPLACED WITH SUITABLE MATERIAL.
- BACKFILLING OF TRENCHES SHALL BE ACCOMPLISHED IMMODITELY ATTER PIPE IS JUID. THE FEL AROUND THE PIPE SHALL BE THORROUGHET COMPACTED TO 35% OF THE MAXMAM MEN' DESITY OBTAINABLE WITH THIS ARRANGE PROCESS. THE TOP ERGHT (B) MONES SHALL BE COMPACTED TO 300 PERCENT STANDARD PROCESS.
- UNDER NO CIRCUMSTANCES SHALL WATER BE ALLOWED TO RISE IN UNBACKFILLED TRENCHES AFTER PIPE HAS BEEN PLACED.

### DEMOLITION NOTES:

- THE INFORMATION SHOWN WAS TAKEN FROM DESIGN DRAWINGS AND FIELD SURVEY WHEREVER POSSIBLE ANY DISCREPANCY IN THIS PLAN AND ACTUAL FIELD CONDITIONS SHALL BE REPORTED TO THE ENGINEER PRIOR TO STATE OF CONSTRUCTION, GENERAL CONTRACTOR SHALL BE REPORTED TO THE ENGINEER ALL SETBACKS, EASEMENTS, AND DIMENSIONS SHOWN HEREON BEFORE BEGINNING CONSTRUCTION.
- THE LOCATIONS OF ALL UTILITIES SHOWN ON THIS PLAN ARE BASED ON THE BEST AVAILABLE INFORMATION
  THE CONTRACTOR SHALL VERIFY THE EXACT LOCATION OF UTILITIES WITH THE UTILITY OWNERS PRIOR TO
  COMMINICATENET OF CONSTRUCTION.
- ALL DEMOLITION MATERIAL WILL BE REMOVED FROM THE SITE AND DISPOSED OF IN A PROPER LOCATION AND METHOD AS DESIGNATED BY THE LOCAL AUTHORITIES.
- CONTRACTOR SHALL NOTHY ACCELL (BLL OR BOOGSE) 4949) AT LEAST 3 FULL BUSINESS DAYS PROR TO BEIGNAMIC CONSTRUCTION OR DOCUMENTON TO HAVE EXISTING UTILITIES LOCATED, CONTRACTOR TO CONTRACT ANY LOCAL UTILITIES THAT PROVIDE THER OWN LOCATOR SERVICES INDEPENDENT OF "INCESSI". REPORT ANY DISCREPANCES TO THE INSTRUCT HAMICIANTEX.
- CONTRACTOR IS RESPONSIBLE FOR COORDINATING CONSTRUCTION ACTIVITIES WITH THE APPROPRIATE UTILITY COMPANIES FOR MAY REQUIRED RELOCATION (I.E. POWER POLES, TELEPHONE PEDESTALS, WATER METERS, ETC.).

### GRADING NOTES:

- ALL DIMENSIONS AND GRADES SHOWN ON THE PLANS SHALL BE FIELD VERRIFIED BY THE CONTRACTOR PRIOR TO CONSTRUCTION, CONTRACTOR SHALL MOTIFY THE ENGINEER IF AM DISCREPANCIES SIZE FRIOR TO OPPOCEEDING WITH CONSTRUCTION, FOR INCESSARY PLAN OR GRADE CHANNESS, NO EXTRA COMPRISATION SHALL BE PAID TO THE CONTRACTOR FOR AMY WORK DONE DUE TO DIMENSIONS OR GRADES SHOWN INCORRECTLY ON THIS PLANS IT SUCK INTERFECTION FOR THE CONTRACTOR FOR AMY WORK DONE DUE TO DIMENSIONS OR GRADES SHOWN INCORRECTLY ON THIS PLANS IT SUCK INTERFECTION.
- OCCUPATIONAL, SAFETY AND HEALTH ADMINISTRATION (OSHA) STANDARDS FOR EXCAVATIONS; FINAL RULE
  29CR PART 1926, SUBBAT "P" APPLIES TO ALL EXCAVATIONS DECEMBING PIVE (5) FEET IN DEPTH.
  EXCAVATION DECEMBENT TWENTY (20) FEET IN DEPTH.
  BY A REGISTERED PROFESSIONAL ENGINEER, PROVIDED BY CONTRACTOR RESPONSIBLE FOR EXCAVATION.
- 4. CONTRACTOR SHALL NOTIFY "NC811" (811) OR (1-800-632-64H9) AT LEAST 3 FULL BUSINESS DAYS PRIOR TO BERNNING CONSTRUCTION OR EXCALATION TO HAVE EMSTING UTILITIES LOCATED, CONTRACTOR SHALL CONTACT ANY LOCAL UTILITIES THAT PROVIDE THE OWN LOCATOR SERVICES INOPPENDENT OF "NC811". REPORT ANY DISCREPANCIES TO THE ENGINEER IMMEDIATELY.
- PRIOR TO BEGINNING CONSTRUCTION, THE GENERAL CONTRACTOR SHALL SCHEDULE AND ATTEND A PRE-CONSTRUCTION CONFERENCE WITH THE CITY OF RALEIGH STORMWATER AND EROSION CONTROL DEPARTMENT, THE ENRISHER AND A REPRESENTATIVE OF THE OWNER.
- SOIL UNDER BUILDINGS, PAYED AREAS AND WITHIN SLOPES GREATER THAN 8.1 (H-V) SHALL BE APPROVED,
  PLACED AND COMPACTED AS RECOMMENDED BY THE GEOTECHNICAL ENGINEER. THESE SOILS SHALL BE
  COMPACTED TO THE STANDARD PROCTOR MAXIMUM DRY DENSITY UNLESS OTHERWISE RECOMMENDED BY
  THE GEOTECHNICAL ENGINEER.

### RALEIGH STANDARD UTILITY NOTES:

- ALL SEWER CONSTRUCTION SHALL BE IN ACCORDANCE WITH THE CITY OF RALEIGH PUBLIC UTILITIES DEPARTMENT HANDBOOK, CURRENT EDITION (INCLUDING STANDARDS AND SPECIFICATIONS).
- DEPARTMENT HANDOOG, CURRENT ESTIMA (INCLUMENT SYNAMERS AND PERCENTATIONS).

  2.1. A DOTAMICO OF DOMAIN MANTHER MEDITATION STATES AND ANY PROVIDED OF PRIVATE OF PURILEY CONTINUED AND ANY PROVIDED ANY PROVIDED AND ANY PROVIDED ANY

- ANY NECESSARY FIELD REVISIONS ARE SUBJECT TO REVIEW AND APPROVAL OF AN AMENDED PLAN AND OR PROPILE BY THE CORPUD PRIOR TO CONSTRUCTION.
- 4. CONTRACTOR SHALL MAINTAIN CONTINUOUS WATER AND SEWER SERVICE TO EXISTING RESIDENCES AND BUSINESSES THROUGHOUT CONSTRUCTION OF PROJECT. ANY INCESSARY SERVICE INTERRUPTIONS SHALL BE PRECEDED BY A 24-HOUR ADVANCE NOTICE TO THE CORPUD.
- 3.0' MINIMUM COVER IS REQUIRED ON ALL WATER MAINS AND SEWER FORCEMAINS. 4.0' MINIMUM COVER IS REQUIRED ON ALL RE-USE MAINS.
- IT IS THE DEVELOPER'S RESPONSIBILITY TO ABANDOM OR REMOVE EXISTING WATER AND SEWER SERVICES NOT BEING USED IN REDEVELOPMENT OF A SITE UNLESS OTHERWISE DIRECTED BY THE CORPUD. THIS INCLUDES ABADDONING TAP AT MAIN AND REMOVAL FROM R.O.W. OR EASEMENT PER CORPUD HANDBOOK PROCEDURE.
- INSTALL 4" PVC SEWER SERVICES AT 1.0% MINIMUM GRADE WITH CLEANOUTS LOCATED AT R.O.W. OR EASTMENT LINE AND SPACED EVERY 100 LF MAX.
- PRESSURE REDUCING VALVES ARE REQUIRED ON ALL WATER SERVICES EXCEEDING 80 PSI; BACKWATER VALVES ARE REQUIRED ON ALL SEWER SERVICES HAVING BUILDING DRAINS LOWER THAN 1.0' ABOVE THE NEXT UPSTREAM MARHADEL.
- ALL ENVIRONMENTAL PERMITS APPLICABLE TO THE PROJECT MUST BE OBTAINED FROM NODWO, USACE AND/OR FEMA FOR ANY RIPARIAN BUFFER, WETLAND AND/OR FLOODPLAIN IMPACTS (RESPECTIVELY) PRIOR TO CONSTRUCTION.
- 11. NCDOT ENCROACHMENT AGREEMENTS ARE REQUIRED FOR ANY UTILITY WORK (INCLUDING MAIN EXTENSIONS AND SERVICE TAPS) WITHIN STATE R.O.W. PRIOR TO CONSTRUCTION.
- GREASE INTERCEPTOR/OIL WATER SEPARATOR SIZING CALCULATIONS AND INSTALLATION SPECHCATION.
  SHALL BE APPROVED BY THE CORPUD FOG PROGRAM COORDINATOR PRIOR TO SSUANCE OF A BUILDING
  PERMIT. CONTACT THE BEASE 9 919-996-2334 OR TIMOTHE BEASE Y/BRALEIGHING GOV FOR MORE
  INFORMATION.
- 12. 6005.COMECTION CONTROL REPORTED AND EXPLORED BASES OF GORRES OF HEATH HANDS WORKERS AS INTO MARRINGO OF THE BASES CONSISTING FACE WITHOUT STATE OF HEATH HANDS CARRINGO THE STATE OF THE WORKERS OF SOCIETIES AND EXPLORED STATE OF THE WORKERS OF SOCIETIES AND EXPLORED AND EXPLORED SHALL BE CODE-CONFECTION OF THE WORKERS OF SOCIETIES AND EXPLORED AND EXPLO

### SANITARY SEWER NOTES:

- 1. ALL SEWER SERVICES IN PUBLIC R.O.W. SHALL BE INSTALLED BY A LICENSED UTILITY CONTRACTOR.
- 2. BEFORE COMMERCING ANY DISCOVATION IN ANY HIGHWAY THE TRANSPERS OF IN AN A REASHENT, THE WORTH CARGINAL UNREFINEDUCED ONANCE REVENTION ACT REQUIRES MOTIFICATION OF EACH AND THE TRANSPERS AND THE ANY THE A
- 3. ANY EXISTING UTILITY APPURTENANCES SHALL NOT BE REUSED ON PROPOSED IMPROVEMENTS
- 4. ALL PROPOSED SEWER ON THIS SITE IS TO BE PRIVATE.
- 5. ALL 8" SEWER SHALL BE PVC SDR-35 AND ALL 6" SEWER SHALL BE PVC SCH.40 UNIESS OTHERWISE SPECIFIED ON THE PLANS.
- MINIMUM COVER TO FINISHED GRADE OF 5 FEET IN TRAFFIC AREAS TO BE PROVIDED FOR ALL COLLECTOR LINES 4 INCHES AND LARGER. IF LESS THAN 5 FEET OR DEFERT THAN 127, DUCTILE IRRON PIPE SHALL BE REQUIRED WITH THYE 1 BERDING TO A COVER 17 A IAM IO 8 1 FEM.
- MINIMUM SLOPE FOR THE 8 INCH SANITARY SEWER COLLECTION LINE IS 0.50% AND THE MINIMUM SLOPE FOR THE 6 INCH SANITARY SEWER SHALL BE NO LESS THAN 1.0% (WITH CLEANOUTS EVERY 100 LINEAL FEET).
- SEWER CLEANOUTS ARE NOT ALLOWED IN DRIVEWAYS, SIDEWALKS AND PARKING LOTS UNLESS SHOWN OTHERWISE. CLEANOUTS WITHIN ASPHALT PAVED TRAFFIC AREAS SHALL BE INSTALLED IN TRAFFIC RATED MINI-MANHOLIS, DOMESTICALLY CAST.
- ALL EXISTING UTILITIES ARE SHOWN AT APPROXIMATE LOCATIONS. CONTRACTOR SHALL VERIFY ACTUAL LOCATION AND DEPTHS IN FIELD PRIOR TO BEGINNING CONSTRUCTION.
- 10. UTILITY SLEEVES SHALL BE PVC (SCH. 40), INSTALL WITH 2' MINIMUM COVER, CAP AND MARK BOTH ENDS

### WATER NOTES:

- WATER TO BE USED DURING CONSTRUCTION SHALL EITHER HAVE A PERMANENT TAP INSTALLED THROUGH A NEW SERVICE TAP PERMIT, OR A RENTAL OF A HYDRANT METER SHALL BE SECURED TEMPORARILY; THROUGH THE CITY OF RALIGH PUBLIC UTILITIES DEPARTMENT.
- WATER DESIGN
   "DUBLIC WATER SYSTEMS SHALL CONFORM TO PUBLIC DISTRIBUTION SYSTEM STANDARDS.
   "PUBLIC WATER SYSTEMS SHALL CONFORM TO PUBLIC DISTRIBUTION SYSTEMS SHALL HAVE A MASTER METER AND MASTER BACK FLOW DEVICE.
- ALL 6" 8.8" WATERLINES, SHALL BE DUCTILE IRON PRESSURE CLASS 350 PER CITY OF RALEIGH STANDARDS.
   ALL 2" WATERLINE SHALL BE TYPE K-COPPER.
- 4 ATT MAINS SHALL HAVE A MINIBULA 36" COVER
- ALL MAINS SHALL HAVE A TYPE 1 LAYING CONDITIONS (GEOTECHNICAL EVALUATION AND COMPACTION REPORTS SHALL BE PROVIDED TO ENGINEER WITH AS-BUILT SUBMITTAL)
- 6. ALL MAINS SHALL HAVE A WORKING PRESSURE OF 150 PSI AND A SURGE PRESSURE OF 300 PSI.
- SERVICE CONNECTIONS CAN ONLY BE MADE TO A PRESSURIZED PIPE UP TO 12" PER CORPUD HANDBOOK.
- 8. REFER TO CORPUD HANDBOOK FOR TESTING AND APPROVAL PROCEDURE PRIOR TO ACCEPTANCE.
- 9. PRESSURE REDUCING VALVES ARE REQUIRED ON ALL WATER SERVICES EXCEEDING 80 PSI. ALL EXISTING UTILITIES ARE SHOWN AT APPROXIMATE LOCATIONS, CONTRACTOR SHALL VERIFY ACTUAL LOCATION AND DEPTHS IN FIELD PRIOR TO BEGINNING CONSTRUCTION.



MCADAMS The John R. McAdams Company, Inc

One Glenwood Avenue Suite 201 Raleigh, NC 27603 phone 919, 823, 4300 fay 919 361 2269 license number: C-0293, C-187

www.mcadamsco.com

### CLIENT

ED STONEWATER 1001 19TH STREET N. SUITE 1401 ARLINTON, VA 22203

# MULTIFAMILY OLLEGEVIEW MULTIFAMII APARTMENTS ADMINISTRATIVE SITE REVIEW CREST ROAD ASSEMBLAGE RALEIGH, NG 27507 COLLEC



### REVISIONS

1 12.12.2022 RESPONSE TO 15T ASR REVIEW
2 03.15.2023 RESPONSE TO 2ND ASR REVIEW
3 05.10.2023 RESPONSE TO RRD ASR REVIEW
4 05.10.2023 RESPONSE TO RRD ASR REVIEW

### PLAN INFORMATION

PROJECT NO. SPEC-22179 FILENAME CHECKED BY DRAWN BY SCALE DATE

PRELIMINARY DRAWING - NOT RELEASED FOR CONSTRUCTION

10. 18. 2022 SHEET

PROJECT NOTES

C0.00



CONTRACTOR SHALL NOTIFY "NC811" (811) OR (1-800-632-4949) AT LEAST 3 FULL BUSINESS DAYS PRIOR TO BEGINNING CONSTRUCTION OR EXCAVATION TO HAVE EXISTING UTILITIES LOCATED. CONTRACTOR SHALL CONTACT ANY LOCAL UTILITIES THAT PROVIDE THEIR OWN LOCATOR SERVICES INDEPENDENT OF "NC811". REPORT ANY DISCREPANCIES TO THE ENGINEER IMMEDIATELY.



2-23-23

Re: COLLEGEVIEW STUDENT HOUSING Atten: GRIFFIN HORNYAK c/o FD STONEWATER

This is a letter of support for trash and recycling services for your new facility being planned for <u>COLLEGEVIEW STUDENT HOUSING at 1423 COLLEGVIEW AVE RALEIGH NC 27606</u>. We have reviewed the plans and have found that <u>REPUBLIC SERVICES</u> will be able to safely perform all needed services.

If the event that the project design changes, this letter is void and a new letter must be issued. Additionally, this letter is non-transferable.

We want to visit the site during the initial phases of construction to ensure that the site will continue to be safe for us to provide service.

We look forward to providing waste and recycling services at your new property once it has been completed and ready to be serviced.

Please feel free to contact me directly 919-519-9739 or email tvolk@republicservices.com Service days and hours: Monday-Friday 7am. to 5pm.

Best Regards,

Timothy M. Volk

Sr. Account Executive: Raleigh Metro
Republic Services
919-519-9739





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CLIENT

FD STONEWATER 1001 19TH STREET N, SUITE 1401 ARLINTON, VA 22203

COLLEGEVIEW MULTIFAMILY
APARTMENTS
ADMINISTRATIVE SITE REVIEW
CREST ROAD ASSEMBLAGE
RALEIGH, NC 27507



### REVISIONS

-		
	DATE	
	12.12.2022	RESPONSE TO 1ST ASR REVIEW
	03.15.2023	RESPONSE TO 2ND ASR REVIEW
	05.10.2023	RESPONSE TO 3RD ASR REVIEW
	06.16.2023	RESPONSE TO ATH ASR REVIEW

### PLAN INFORMATION


PROJECT NO. SPEC-22179 FILENAME CHECKED BY DRAWN BY SCALE DATE

PRELIMINARY DRAWING - NOT RELEASED FOR CONSTRUCTION

10. 18. 2022 SHEET

APPROVAL FORMS

C0.01

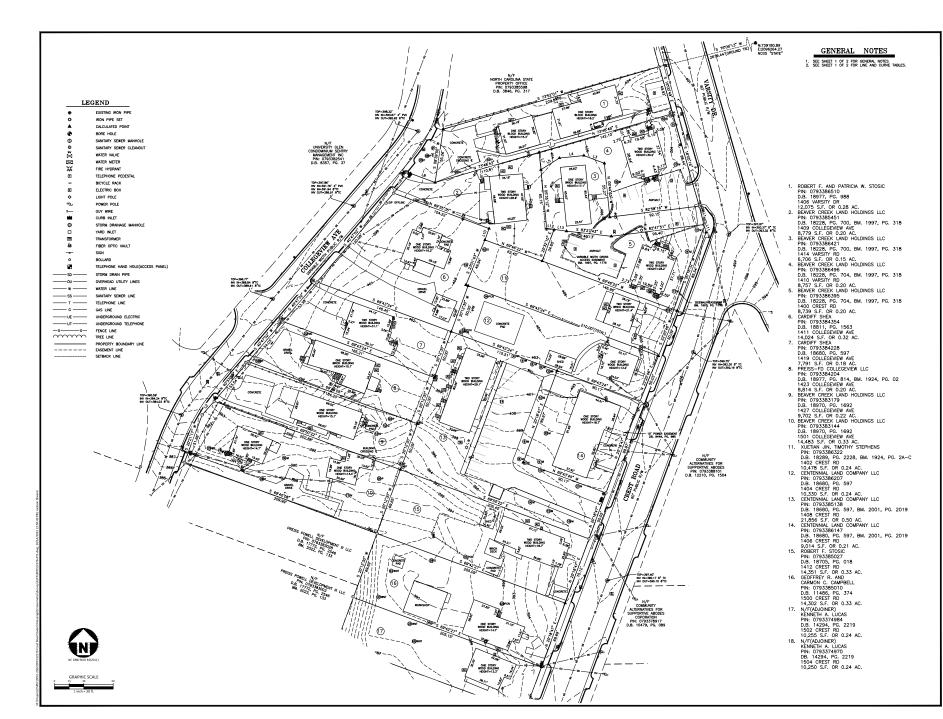



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### CLIENT

FD STONEWATER 1001 19TH STREET N, SUITE 1401 ARLINGTON, VA 22203

# CREST ROAD ASSEMBLAGE ALTA/NSPS LAND TITLE SURVEY CREST ROAD AND COLLEGE VIEW AVENUE RAEGIGH TOWNSHIP, WAKE COUNTY, NORTH CAROLINA



### PLAN INFORMATION

PROJECT NO. SPEC22179 CHECKED BY IRT DRAWN BY 09.14.2022

SCALE DATE SHEET

ALTA/NSPS LAND TITLE SURVEY

2-2



TREE OR OTHER VEGETATION TO BE REMOVED



UNDERGROUND UTILITY TO BE REMOVED

NOTE: SEE PLAN FOR DETAILED DEMOLITION PROCEDURES, SEQUENCING AND SPECIFICATIONS.



### **DEMOLITION NOTES:**

- DEVELOPER TO REMOVE BUILDING WITHIN TREE CONSERVATION AREA USING NO MOTORIZED OR HEAVY EQUIPMENT WITH TIRES OR TRACKS AND NO DISTURBANCE TO THE AREA.




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### CLIENT

ED STONEWATER 1001 19TH STREET N, SUITE 1401 ARLINTON, VA 22203

COLLEGEVIEW MULTIFAMILY
APARTMENTS
ADMINISTRATIVE SITE REVIEW
CREST ROAD ASSEMBLAGE
RALEIGH, NC 27807



### REVISIONS

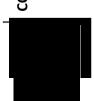
1 12.12.2022 RESPONSE TO 1ST ASR REVIEW
2 03.15.2023 RESPONSE TO 2ND ASR REVIEW
3 05.10.2023 RESPONSE TO 3RD ASR REVIEW
4 06.16.2023 RESPONSE TO 4TH ASR REVIEW

### PLAN INFORMATION

PROJECT NO. SPEC-22179 FILENAME CHECKED BY DRAWN BY SCALE DATE 10. 18. 2022

SHEET DEMOLITION PLAN

C1.01

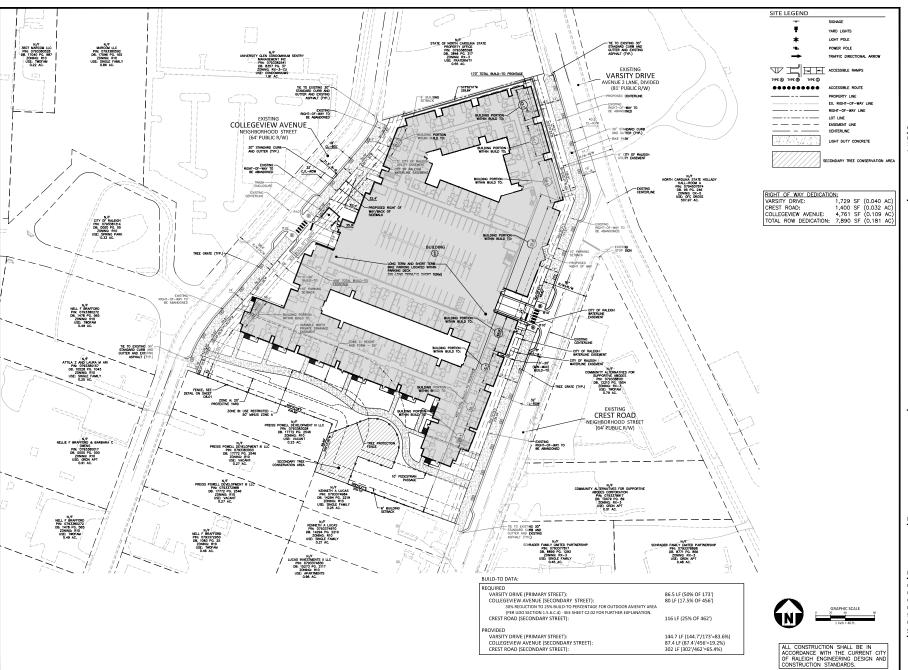



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COLLEGEVIEW MULTIFAMILY
APARTMENTS
ADMINISTRATIVE SITE REVIEW
CREST ROAD ASSEMBLAGE
RALEIGH, NC 27807



### REVISIONS


### PLAN INFORMATION

PROJECT NO. SPEC-22179 FILENAME CHECKED BY DRAWN BY SCALE DATE

10. 18. 2022 SHEET

OVERALL SITE PLAN

C2.00

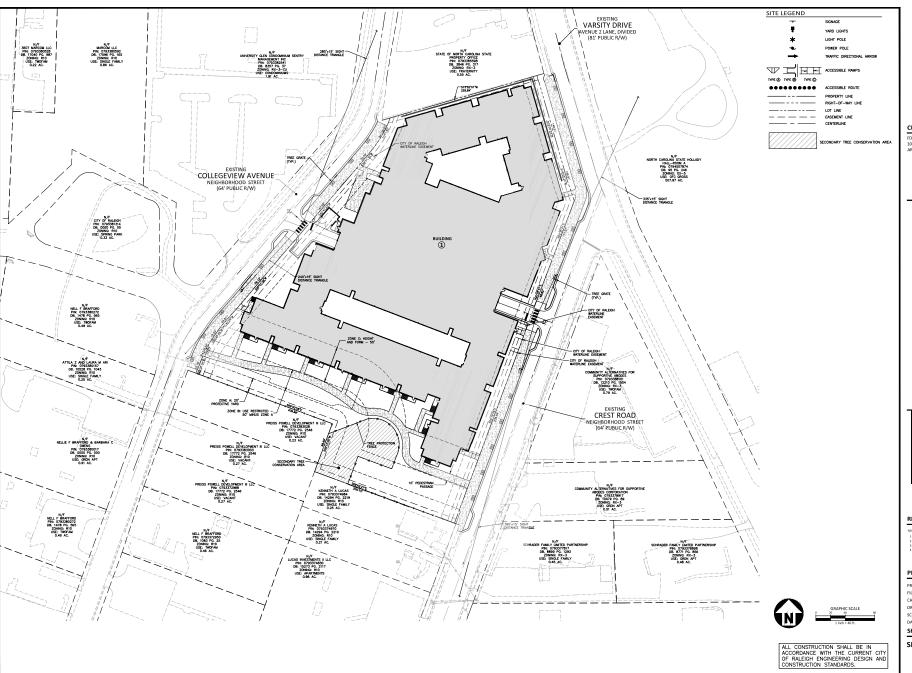



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COLLEGEVIEW MULTIFAMILY
APARTMENTS
ADMINISTRATIVE SITE REVIEW
CREST ROAD ASSEMBLAGE
RALEIGH, NC 27807



### REVISIONS


### PLAN INFORMATION

PROJECT NO. SPEC-22179 FILENAME CHECKED BY DRAWN BY SCALE

DATE 10. 18. 2022 SHEET

SITE DISTANCE TRIANGLE

C2.01

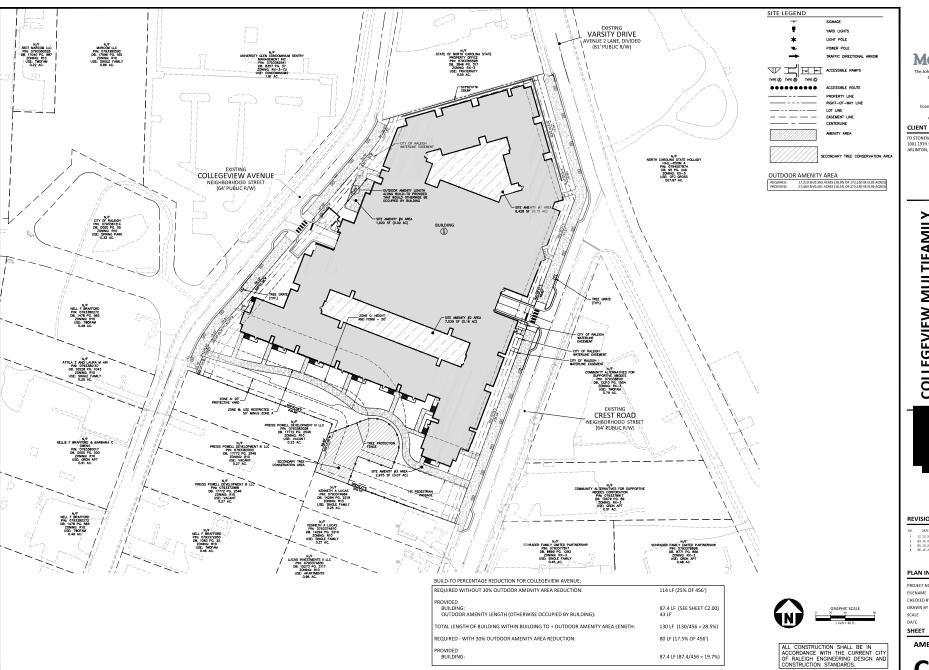



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FD STONEWATER 1001 19TH STREET N, SUITE 1401 ARLINTON, VA 22203

# COLLEGEVIEW MULTIFAMILY APARTMENTS ADMINISTRATIVE SITE REVIEW CREST ROAD ASSEMBLAGE RALEIGH, NC 27807



### REVISIONS


### PLAN INFORMATION

PROJECT NO. SPEC-22179 FILENAME CHECKED BY DRAWN BY

10. 18. 2022

AMENITY AREA PLAN

C2.02

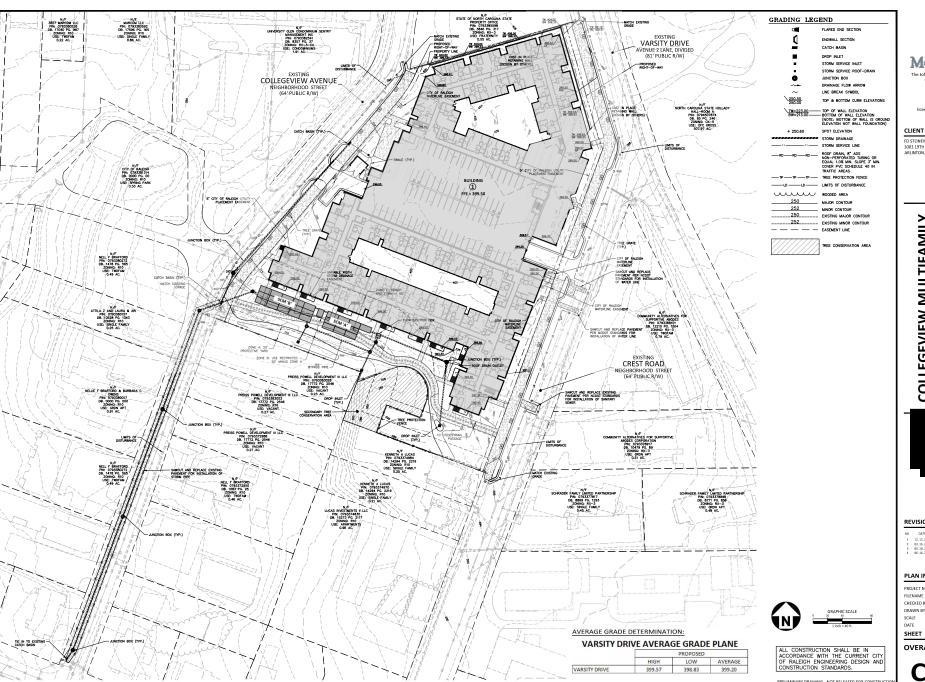



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ED STONEWATER

CLIENT

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COLLEGEVIEW MULTIFAMILY
APARTMENTS
ADMINISTRATIVE SITE REVIEW
CREST ROAD ASSEMBLAGE
RALEIGH, NC 27807



REVISIONS


1 12.12.2022 RESPONSE TO 1ST ASR REVIEW 2 03.15.2023 RESPONSE TO 2ND ASR REVIEW 3 05.10.2023 RESPONSE TO 3RD ASR REVIEW A 06.6.2023 RESPONSE TO 3RD ASR REVIEW

PLAN INFORMATION PROJECT NO.

CHECKED BY DRAWN BY 10. 18. 2022

**OVERALL GRADING PLAN** 

C3.00

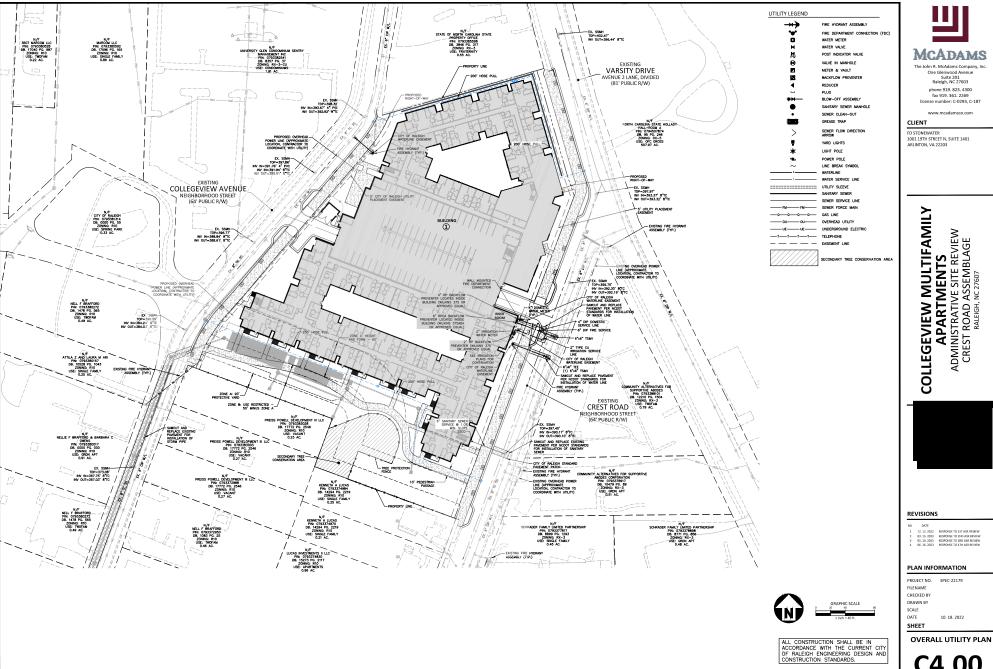



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FD STONEWATER

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COLLEGEVIEW MULTIFAMILY
APARTMENTS
ADMINISTRATIVE SITE REVIEW
CREST ROAD ASSEMBLAGE
RALEIGH, NC 27807

### REVISIONS


1 12.12.2022 RISPONSE TO 151 ASR REVIEW
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3 05.10.2023 RISPONSE TO 3RD ASR REVIEW
4 06.16.2023 RISPONSE TO 3RD ASR REVIEW

PLAN INFORMATION

PROJECT NO. SPEC-22179 FILENAME CHECKED BY DRAWN BY SCALE

10. 18. 2022 SHEET

C4.00

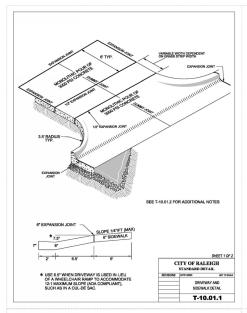

1/8" RADIUS (TYP.)

MEDIAN CURB AND GUTTER

JOINT FILLER NOTE: MAINTAIN 50 MAX. BETWEEN EXPANSION JOINTS OR AT ALL RIGID OBJECTS.

4" COMPACTED A.B.C. UNDER STANDARD CURB & GUTTER (MIN)

NO VALLEY CURB SHALL BE USED AT INTERSECTIONS, HYDRANTS, ETC.

SPILL CURB DETAIL

CITY OF RALEIGH

STANDARD DETAIL

CURB AND GUTTER


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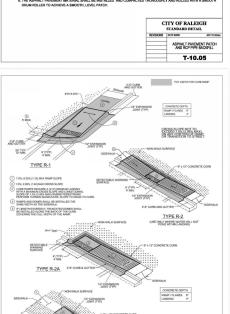
DETECTABLE

TYPE R-2B

1/2" EXPANSION


FRONT ELEVATION



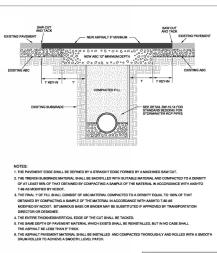

CITY OF RALEIGH

T-20.01.5

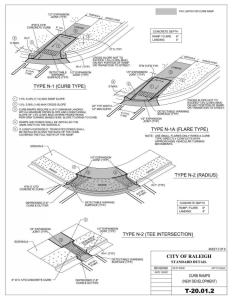



- CITY OF RALEIGH STANDARD CURB RAMPS HAVE BEEN DEVELOPED IN ACCORDANCE WITH THE AMERICANS WITH DISABILITIES ACT (ADA) AND PUBLIC RIGHT OF WAY ACCESS GUIDELINES (PROWAG).
- CURB RAMPS SHALL BE PROVIDED AT LOCATIONS AS SHOWN ON THE PLANS
  OR A DIRECTED BY THE ENDINEER. SIDEWAK ACCESS FAMPS SHALL BE LOCATED AS
  NIDICATED IN THE EPTIAL, HOWEVER, THE LOCATION WAY BE ADJUSTED IN COORDINATION WITH
  THE CITY OF PLALEGH WHERE EXISTING LIGHT POLES, FIRE HYDRANTS, DROP PILETS, ETC. AFFECT
  PLACEMENT.
- 3. DOUBLE WHEELCHAIR RAMPS ARE TO BE INSTALLED AT ALL PUBLIC STREET INTERSECTIONS WHERE SIDEWALK IS REQUIRED.
- THE WALKING SURFACE SHALL BE SLIP RESISTANT. THE COLOR FOR THE DETECTABLE WARNING AREA SHALL BE YELLOW FOR CONTRAST.
- 5. NO SLOPE ON THE SIDEWALK ACCESS RAMP SHALL EXCEED 1"/FT (12:1) IN RELATIONSHIP TO THE GRADE OF THE STREET.
- 6. IN NO CASE SHALL THE WIDTH OF THE SIDEWALK ACCESS RAMP BE LESS THAN 48" ALL RAMPS SHALL BE INSTALLED THE SAME WIDTH AS THE SIDEWALK.
- USE CLASS A (3000 PSI) CONCRETE WITH A SIDEWALK FINISH IN ORDER TO OBTAIN A ROUGH NONSKID SURFACE.
- A 1/2" EXPANSION JOINT INSTALLED FULL DEPTH WILL BE REQUIRED WHERE THE CONCRETE SIDEWALK ACCESS RAMP JOINS THE CURB AND ALSO WHERE NEW CONCRETE ABUTS EXISTING CONCRETE.
- 9. CURB RAMPS SHOULD BE PLACED PARALLEL TO THE DIRECTION OF TRAVEL.

CITY OF RALEIGH STANDARD DETAIL		
REVISIONS	DATE NODE	NOT TO SCALE
	CURB RA	MP NOTES
	T-20	.01.8



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CLIENT

FD STONEWATER 1001 19TH STREET N, SUITE 1401 ARLINTON, VA 22203

# COLLEGEVIEW MULTIFAMILY APARTMENTS ADMINISTRATIVE SITE REVIEW CREST ROAD ASSEMBLAGE RALEIGH, NC.27607



### REVISIONS


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1	12.12.2022	RESPONSE TO 15T ASR REVI
2	03.15.2023	RESPONSE TO 2ND ASR REV
3	05.10.2023	RESPONSE TO JRD ASR REVI
4	06.16.2023	RESPONSE TO 4TH ASR REVI


### PLAN INFORMATION


PROJECT NO. SPEC-22179
FILENAME
CHECKED BY
DRAWN BY
SCALE
DATE 10. 18. 2022


SHEET

SITE DETAILS

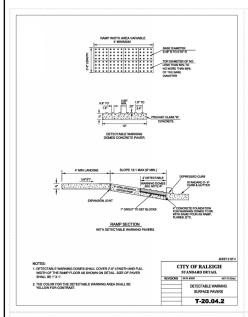


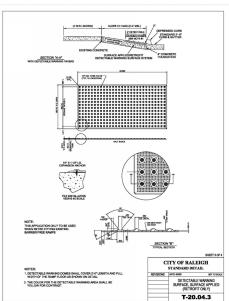


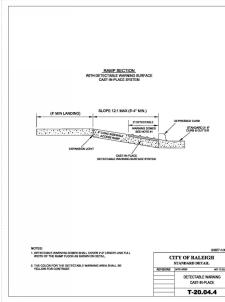


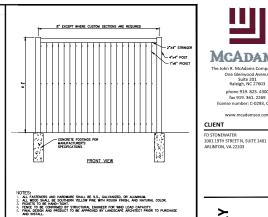

20' ZONE A NEIGHBORHOOD TRANSITIONAL PROTECTIVE YARD FENCING DETAIL

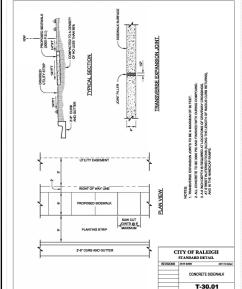

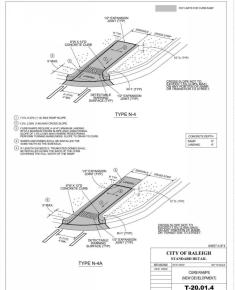

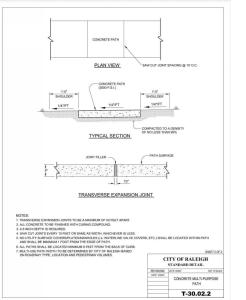



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phone 919, 823, 4300 fax 919, 361, 2269 license number: C-0293, C-187 www.mcadamsco.com

### REVISIONS


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### PLAN INFORMATION

PROJECT NO. SPEC-22179 FILENAME CHECKED BY DRAWN BY SCALE 10. 18. 2022 DATE

SHEET

SITE DETAILS

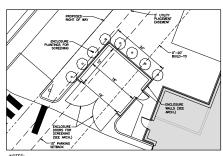

NOTES:

1. DURSTER PIO AND APPROACH PAO SHOULD BE 6" THEK CONCRETE MEMOREDE WITH REMAY FOR EXCITENANCE, DOMERES A COCAMANANTON 2. CLASS OR BAMERS AT THE FEMA OF DAM DURSTER ARE REQUIRED. TO INCLUDIBLE MILES SHALL BE A MANNE OF THEMER THAN THE DURSTERS AND COMPACTOR, BUT NO LESS THAN 6" HIGH.

SOLID WASTE ENCLOSURE



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CLIENT

FD STONEWATER 1001 19TH STREET N, SUITE 1401 ARLINTON, VA 22203

COLLEGEVIEW MULTIFAMILY
APARTMENTS
ADMINISTRATIVE SITE REVIEW
CREST ROAD ASSEMBLAGE
RALEIGH, NC 27807



### REVISIONS


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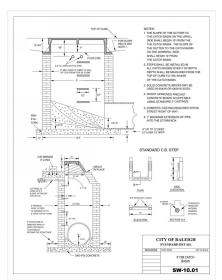
### PLAN INFORMATION

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SHEET

SITE DETAILS




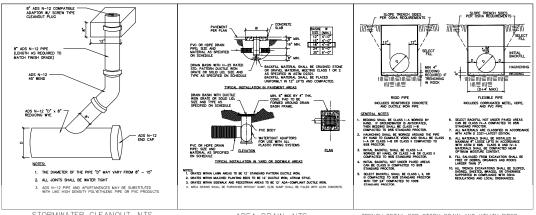



STORMWATER CLEANOUT, NTS


AREA DRAIN, NTS

TRENCH DETAIL FOR STORM DRAIN AND UTILITY PIPES

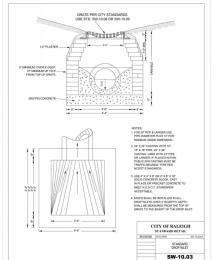

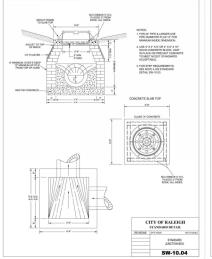

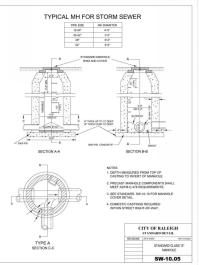

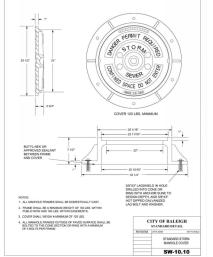



The John R. McAdams Company, Inc

One Glenwood Avenue Suite 201 Raleigh, NC 27603 phone 919. 823. 4300 fax 919. 361. 2269

license number: C-0293, C-187

CLIENT ED STONEWATER

1001 19TH STREET N, SUITE 1401 ARLINTON, VA 22203

COLLEGEVIEW MULTIFAMILY
APARTMENTS
ADMINISTRATIVE SITE REVIEW
CREST ROAD ASSEMBLAGE
RALEIGH, NC 27807



### REVISIONS


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3 05.10. 2023 RESPONSE TO 3RD ASR REVIEW
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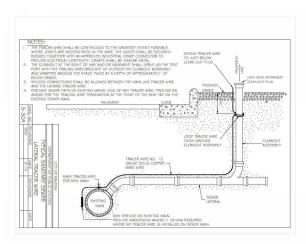
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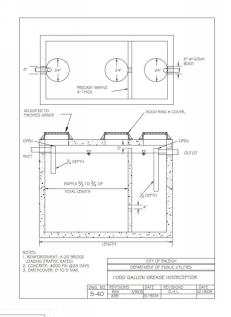
PROJECT NO. SPEC-22179 FILENAME CHECKED BY DRAWN BY SCALE

DATE 10. 18. 2022 SHEET


STORM DRAINAGE C8.03







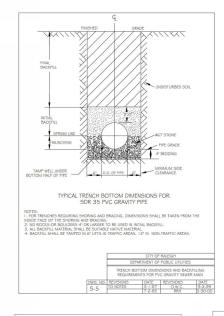



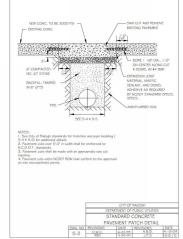

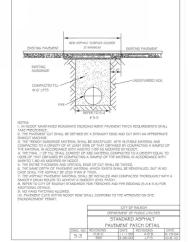

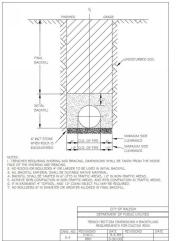



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### REVISIONS


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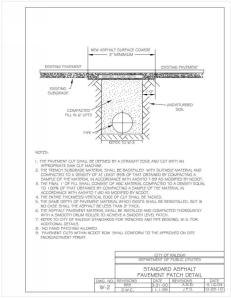
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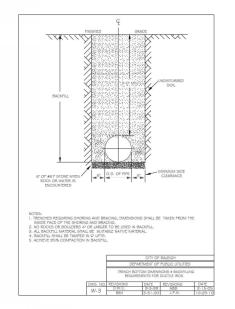
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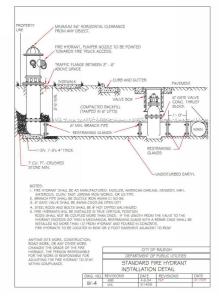
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SCALE
DATE 10. 18. 2022


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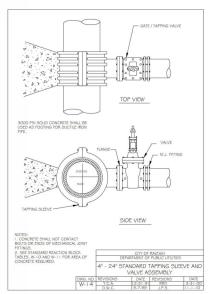








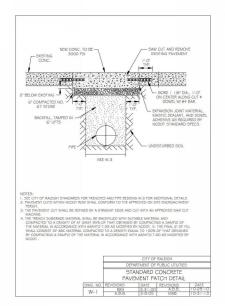

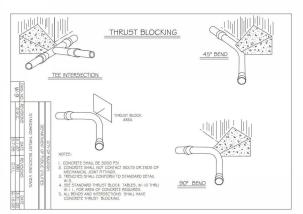



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### REVISIONS


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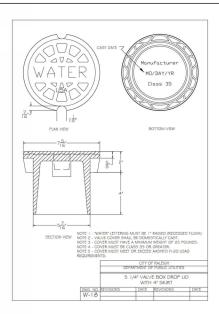
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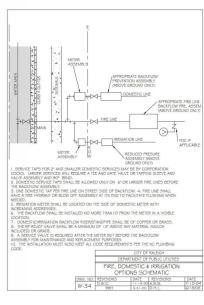
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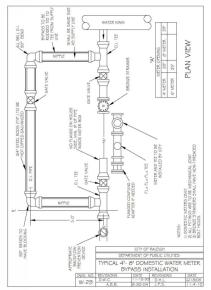
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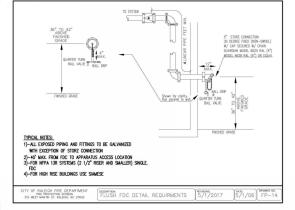
WATER DETAILS









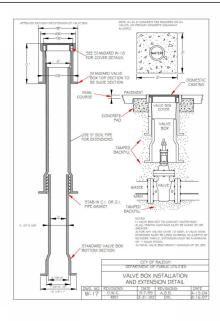



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CREST ROAD ASSEMBLAGE
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### REVISIONS


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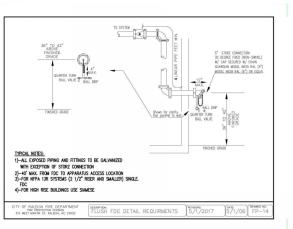
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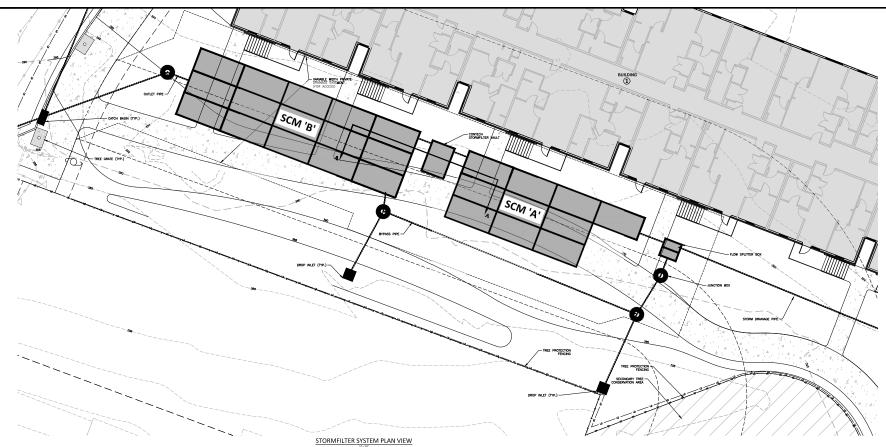
FILENAME CHECKED BY DRAWN BY SCALE DATE 10. 18. 2022

SHEET

WATER DETAILS





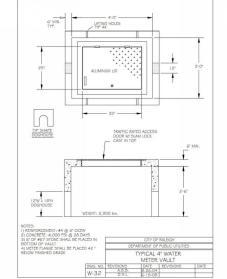

### GENERAL NOTES

- PRIOR TO CONSTRUCTION, ANY DISCREPANCIES IN THE PLANS AND NOTES SHALL BE BROUGHT TO THE ENGINEER'S ATTENTION
- THE FACILITY SHALL NOT BE USED AS A TEMPORARY EROSION CONTROL DEVICE (I.E. SEDIMENT TRAP OR SEDIMENT BASIN) DURING CONSTRUCTION
- THE TRANSPORT OF A CONSTRUCTION OF THE TRANSPORT OF THE T
- ONCE CONSTRUCTED, THE STORMFILTER CARTRIDGES SHALL NOT RECEIVE STORMWATER RUNOFF UNTIL THE ENTIRE CONTRIBUTING DRAINAGE AREA TO THE UNDERGROUND SYSTEM HAS BEEN COMPLETELY STABILIZED AND SITE CONSTRUCTION IS COMPLETE.
- ALL COMPONENTS OF THE UNDERGOUND SCAN SYSTEM LIOHT / RISER CONNECTIONS, ENG-CAPS, ACCESS MANINGLES, ETC.] SHALL BE DESIGNED BY OTHERS ANY VARIATIONS OF CHANGES MAD OF ROOM THESE SPECIFICATIONS AND DRAWINGS DURINGS THE ORDERING AND OR ROSTALIZATION OF ALL COMPONENTIAL THIS APPROPRIED THE ECONOMINATION, STATE APPROPRIED THE ECONOMINATION OF ALL COMPONENTIAL STATE OF THE ACCOUNT OF
- ALL PIPE/RISER CONNECTIONS AND JOINTS ASSOCIATED WITH THE STORM FILTER SYSTEM AND UNDERGROUND DETENTION PIPE SHALL BE WATER TIGHT. THE MECHANISM FOR ACHIEVING THIS SHALL BE SUBMITTED TO THE DESIGN ENGINEER FOR REVIEW.
- 8. THE CONTRACTOR SHALL FURNISH, INSTALL, OPERATE, AND MAINTAIN ANY PUMPING EQUIPMENT, ETC. NEEDED FOR BETMOVAL OF WATER FROM VARIOUS SARTS OF 19 SAND FITTER SYSTAM SITE. IT IS ANTICOSED TOAT PUMPINGS WILL BE RECESSARY IN THE EXCAVATION AREAS, DURING VARIOUS AREAS, DURING VARIOUS AND SYSTAM SOURCE STATES. THE SECOND STATES AND STATES AND STATES AND STATES AND STATES AND STATES. THE MAINTER IN WHICH THE WATER IN STATES IS REMOVED SHALL BE SUCH THAT THE EXCAVATION STOTICS AND SUIS SLOWES ARE STARKE.
- . IT SHALL BE THE RESPONSIBILITY OF THE CONTRACTOR TO ADHERE TO ALL CURRENT OSHA REGULATIONS FOR CONFINED SPACE ENTRY AND PROVIDE SUCH DURING ENGINEER WALK-THROUGH/INSPECTION.
- ALL PIPE PENETRATIONS THROUGH A CONCRETE OR CMP STRUCTURE (I.E. STORMFILTER CARTRIDGE / DETENTION SYSTEM, STORM DRAINAGE MANHOLES, ETC.) SHALL BE MADE WATERTIGHT USING NON-SHRINK CEMENTIOUS GROUT.
- 11. ACCES MANIFOLDS MALL BOULDT LADDIES OR MANIFOLS (TIES. III. A TAW ACCESS FORM, AMANIFOLS TIES WOULD BESUET MA. 9° OR ROSE).

  OFFISE IA ALDDIE SMALL BE PROPORTION. AS SUCH ALDDIES MALL BE REQUIREDED AND ALMANIFOLS ACCESS FORM'S TO THE STORMANTEW VALUADORS SHALL BRULLDE AND ETRINGHOME AND RETAINED ASSETTION THAT ALLOWS THE LADDERTO BE EXTENDED ABOVE THE ACCESS LID THAT ALLOWS THE LADDERTO BE EXTENDED ABOVE THE ACCESS LID THAT ALLOWS THE LADDERTO BE EXTENDED ABOVE THE ACCESS LID THAT ALLOWS THE LADDERTO BE EXTENDED ABOVE THE ACCESS LID THAT ALLOWS THE LADDERTO BE EXTENDED ABOVE THE ACCESS LID THAT ALLOWS THE LADDERTO BE EXTENDED ABOVE THE ACCESS LID THAT ALLOWS THE LADDERTO BE EXTENDED ABOVE THE ACCESS LID THAT ALLOWS THE LADDERTO BE EXTENDED ABOVE THE ACCESS LID THAT ALLOWS THE LADDERTO BE EXTENDED ABOVE THE ACCESS LID THAT ALLOWS THE LADDERTO BE EXTENDED ABOVE THE ACCESS LID THAT ALLOWS THE LADDERTO BE EXTENDED ABOVE THE ACCESS LID THAT ALLOWS THE LADDERTO BE EXTENDED ABOVE THE ACCESS LID THAT ALLOWS THE LADDERTO BE EXTENDED ABOVE THE ACCESS LID THAT ALLOWS THE LADDERTO BE EXTENDED ABOVE THE ACCESS LID THAT ALLOWS THE LADDERTO BE EXTENDED ABOVE THE ACCESS LID THAT ALLOWS THE LADDERTO BE EXTENDED ABOVE THE ACCESS LID THAT ALLOWS THE LADDERTO BE EXTENDED ABOVE THE ACCESS LID THAT ALLOWS THE LADDERTO BE EXTENDED ABOVE THE ACCESS LID THAT ALLOWS THE LADDERTO BE EXTENDED ABOVE THE ACCESS LID THAT ALLOWS THE ALDOWS THE ACCESS LID THAT ALLOWS THE ALLOWS THE ACCESS LID THAT ALLOWS THE ALLOWS THE ACCESS LID THAT ALLOWS THE ALLOWS THE ALLOWS THE ACCESS LID THAT ALLOWS THE ALLOWS THE ACCESS LID THAT ALLOWS THE ALLOWS TH

### FOUNDATION NOTES

- OCC THE EXAMINATION COUNTED ARE PROVED TO PERFECT ONLY OF THE IMPRESSION CAN STYLE. THE OWNER CONTINUES, REPORTED THE AREA OF THE THE OWNER OF THE THE THE OWNER OF THE THE OWNER OF THE THE OWNER OF THE OWNER OWNER OF THE OWNER O
- IF THE FOUNDATION SUBGRADE WILL BE EXPOSED FOR AN EXTENDED PERIOD DURING CONSTRUCTION, THEN IT SHOULD BE GRADED TO A SUGHT SLOPE SUCH THAT SATURATION OF THE SUBGRADE DOES NOT OCCUR.
- THE CAST GOTCHMICAL INSIGHER SHALL DETERMINE IF CONDATION DAWAS ARE REQUIRED FOR THE UNDERBROWNO SAY SYTEM. THE DESIGN OWNER OF THE PROPERTY OF THE PROGRAMMENT OF TH

### BEDDING NOTES

- THE EXCAVATION SUB-GRADE MUST BE TRANSIT LEVEL.
- THE EXCAVATION PIT SHALL BE LINED (ON THE BOTTOM AND ALL FOUR SIDES) WITH A NON-WOVEN GEO-TEXTILE (GEOTEX 401 OR APPROVED EQUIVALENT). THE ONSITE GEOTECHNICAL ENGINEER SHALL APPROVE FABRIC FOR USE.
- THE SUBGRADE FOR THE DETENTION SYSTEM CAN BE A CONCRETE SLAB, OR CLEAN GRANULAR MATERIAL WITH A MAXIMUM AS THE BEDDING SHALL BE FREE FROM ROCK FORMATIONS, PROTRUDING STONES, PROZEN LUMPS, ROOTS, AND OTHER FOREIGN M

### STORMFILTER VAULT CONSTRUCTION NOTES

- ABSOLUTELY NO RUNOFF SHALL ENTER THE STORMFILTER CONTROL MEASURE UNTIL ALL CONTRIBUTING DRAINAGE AREAS HAVE BEEN STABILIZED.
- AMBHORE SECSS SHALL BE PROVIDED FOR THE STORMFILTRE CONTROL MEASURE. MANHOLES SHALL BE IN COMPLIANCE INTH CIT OF RADBHIS STANDARD DETAILS BUT SHALL BE A RANIBALM OF A INCRESS IN DIAMPETER TO COMPLY WITH CHAP CONFIRMED SHACE REQUIREMENTS JOR MINIMAN OF AN EQUIREMENTS APPLICABLE AT TIME OF CONSTRUCTIONS, CONTRACTOR SHALL PROVIDE ACCESS LADDRES FOR ACCESS BELDOW ALL MANHOLES. MANHOLES CONTROL SHALL ALLOW FOR PROFER HYBILLATION.

### STORMWATER SYSTEM MATERIAL SPECIFICATIONS

- THE UNDERGROUND SCM UNITS ARE TO BE DESIGNED BY OTHERS. ANY CHANGES TO THE APPROVED PLANS SHALL BE PROVIDED TO THE DESIGNEE PRIOR TO INSTALLATION FOR REVIEW.
- ACCESS RISERS SHALL BE INSTALLED PER MANUFACTURE SPECIFICATIONS. ACCESS STEPS / LADDERS SHALL BE ATTACHED TO THE RISERS TO ALLOW FOR ACCESS INTO THE UNDERGROUND SCM SYSTEM.
- DAMAGNIM OF THE STUMBLES CATEGOR SEA AND TITLETON POTENTS IN THAT OF THE OWNER THE PAUL SHALL BE A AND STRESS FOR THE ADMAGNIM THE WAY OF THE ADMAGNIM THAT ADMAGNIM THE ADMAG
- THE RCP OUTLET BARREL SHALL BE CLASS III RCP, MODIFIED BELL AND SPIGOT, MEETING THE REQUIREMENTS OF ASTM C76-LATEST. THE PIPE SHALL
  HAVE CONFINED O-RING RUBBER GASKET JOINTS MEETING ASTM C-443-LATEST. THE PIPE JOINTS SHALL BE TYPE R-4.
- GEOTECTILE FABRIC FOR THE OUTLET BARRELJOINTS SHALL BE MIRAFI 180N OR ENGINEER APPROVED EQUAL (NON-WOVEN FABRIC). THE ONSITE GEOTECHNICAL ENGINEER SHALL APPROVE FABRIC FOR USE.
- 6. ALL POURED CONCRETE SHALL BE MINIMUM 3000 PSI (28 DAY) UNLESS OTHERWISE NOTED.
- THE CONTRACTOR SHALL INSTALL THE UNDERGROUND SCM UNITS PER MANUFACTURERS' SPECIFICATIONS. CONTRACTOR TO PROVIDE A LETTER FROM MATERIAL SUPPLIERS STATING MATERIALS MEET THE SPECIFIC STANDARDS PRIOR TO INSTALLATION.

### BACKFILL MATERIAL NOTES

- 1. THE ON-SITE GEOTECHNICAL ENGINEER SHALL SPECIFY THE BACKFILL MATERIAL FOR THE UNDERGROUND SCM SYSTEM.
- THE BACKFILL MATERIAL SHOULD BE FREE OF ROCKS, FROZEN LIUMPS, AND OTHER FOREIGN MATTER THAT COULD CAUSE HARD SPOTS WITHIN THE BACKFILL MATERIAL, OR THAT COULD DECOMPOSE AND CREATE VOIDS.
- 3. HIGHLY PLASTIC SILTS, HIGHLY PLASTIC CLAYS, ORGANIC SILTS, ORGANIC CLAYS, AND PEATS SHOULD NOT BE USED AS A BACKFILL MATERIAL
- THE BACKFILL MATERIAL SHOULD BE PLACED IN 6" LOOSE LIFTS AND COMPACTED TO 95% OF THE STANDARD PROCTOR MAXIMUM DRY DENSITY (ASTM-0698). THE FILL SOILS SHOULD BE COMPACTED AT A MOISTURE CONTENT WITHIN 4/- TWO PERCINT OF ITS OPTIMUM MOISTURE CONTENT. 5. ANY MATERIAL STOCKPILING ON TOP OF THE UNDERGROUND SCM SYSTEM SHALL BE APPROVED BY THE STRUCTURAL DESIGN ENGINEER.
- STATEMENT OF RESPONSIBILITY
- ALL REQUIRED MAINTENANCE AND INSPECTIONS OF THIS FACILITY SHALL BE THE RESPONSIBILITY OF THE PROPERTY OWNER, PER THE
  EXECUTED OPERATION AND MAINTENANCE ACREEMENT FOR THIS FACILITY.







SCM CERTIFICATIONS AND AS-BUILT PLANS MUST BE PROVIDED TO STORMWATER CONTROL INSPECTOR, FOR REVIEW, 7 DAYS PRIOR TO FINAL INSPECTION. CERTIFICATIONS AND AS-BUILT PLANS MUST BE ACCEPT PRIOR TO FINAL INSPECTION.

ALL CONSTRUCTION SHALL BE IN ACCORDANCE WITH THE CURRENT CITY OF RALEIGH ENGINEERING DESIGN AND CONSTRUCTION STANDARDS.

PRELIMINARY DRAWING - NOT RELEASED FOR CONSTRUCT

The John R. McAdams Company, In One Glenwood Avenue Suite 201 Raleigh, NC 27603

phone 919, 823, 4300 fay 919 361 2269 license number: C-0293, C-187

CLIENT

ED STONEWATER 1001 19TH STREET N. SUITE 1401 ARLINTON, VA 22203

> MULTIFAMILY COLLEGEVIEW MULTIFAMII APARTMENTS ADMINISTRATIVE SITE REVIEW CREST ROAD ASSEMBLAGE RALEIGH, NC27607



### REVISIONS


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### PLAN INFORMATION

PROJECT NO. SPEC-22179 FILENAME CHECKED BY DRAWN BY SCALE DATE

10. 18. 2022 SHEET

STORMWATER CONTROL MEASURE PLAN VIEW AND NOTES C9.00

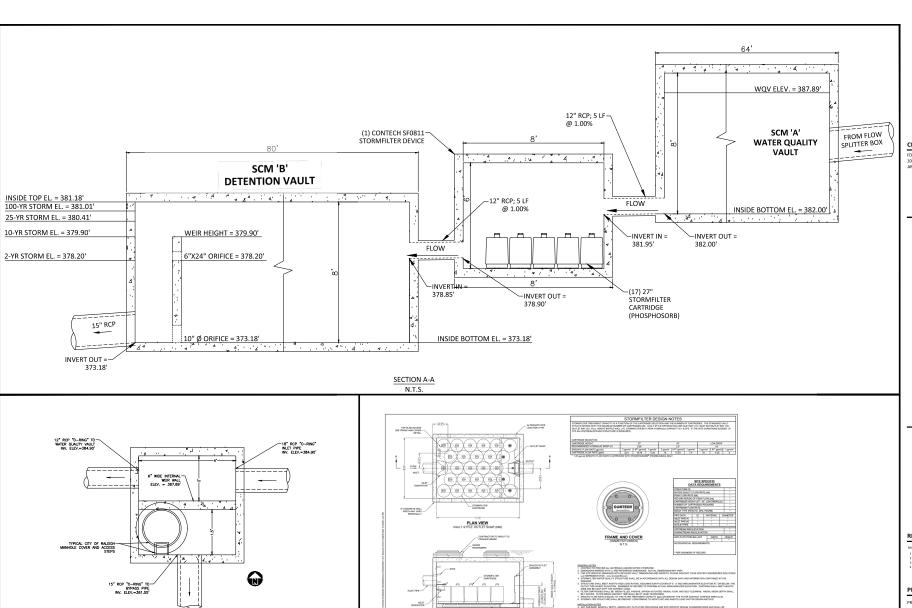

SECTION A-A

StormFilter\*

CONTECH

PLOW SPLITTER BOX "FSB-A" PLAN VIEW

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### REVISIONS

### PLAN INFORMATION

PROJECT NO. SPEC-22179 FILENAME CHECKED BY DRAWN BY

SCALE DATE 10. 18. 2022 SHEET

SCM CERTIFICATIONS AND AS-BUILT PLANS MUST BE PROVIDED TO STORMWATER CONTROL INSPECTOR, FOR REVIEW, 7 DAYS PRIOR TO FINAL INSPECTION. CERTIFICATIONS AND AS-BUILT PLANS MUST BE


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PRELIMINARY DRAWING - NOT RELEASED FOR CONSTRUCT

ACCEPT PRIOR TO FINAL INSPECTION.

STORMWATER CONTROL MEASURE DETAILS

C9.01



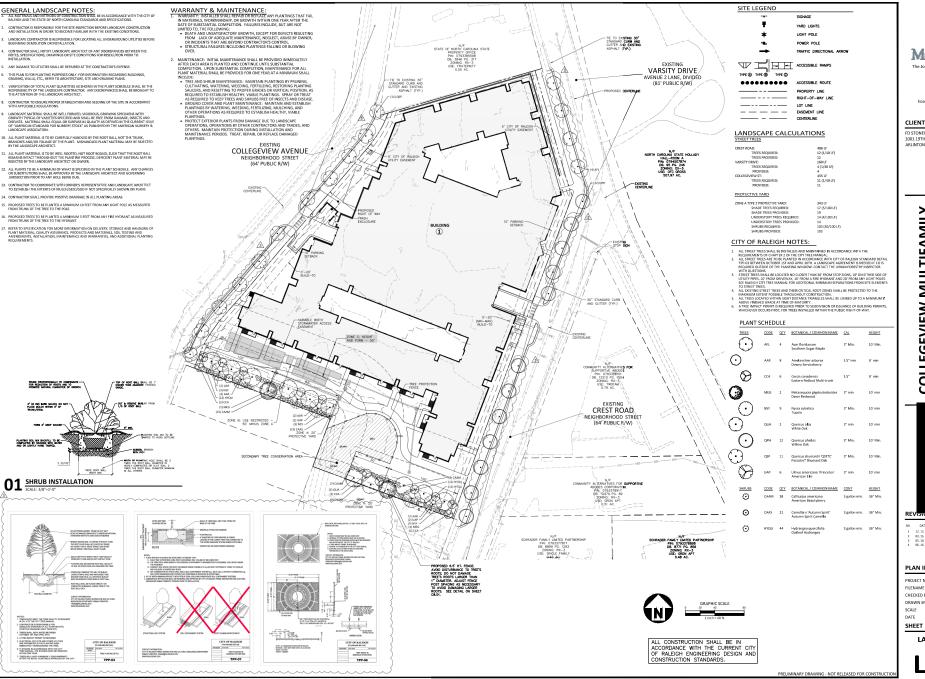

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1001 19TH STREET N. SUITE 1401

ARLINTON, VA 22203

MULTIFAMILY

COLLEGEVIEW MULTIFAMII APARTMENTS ADMINISTRATIVE SITE REVIEW CREST ROAD ASSEMBLAGE RALEIGH, NC 27607



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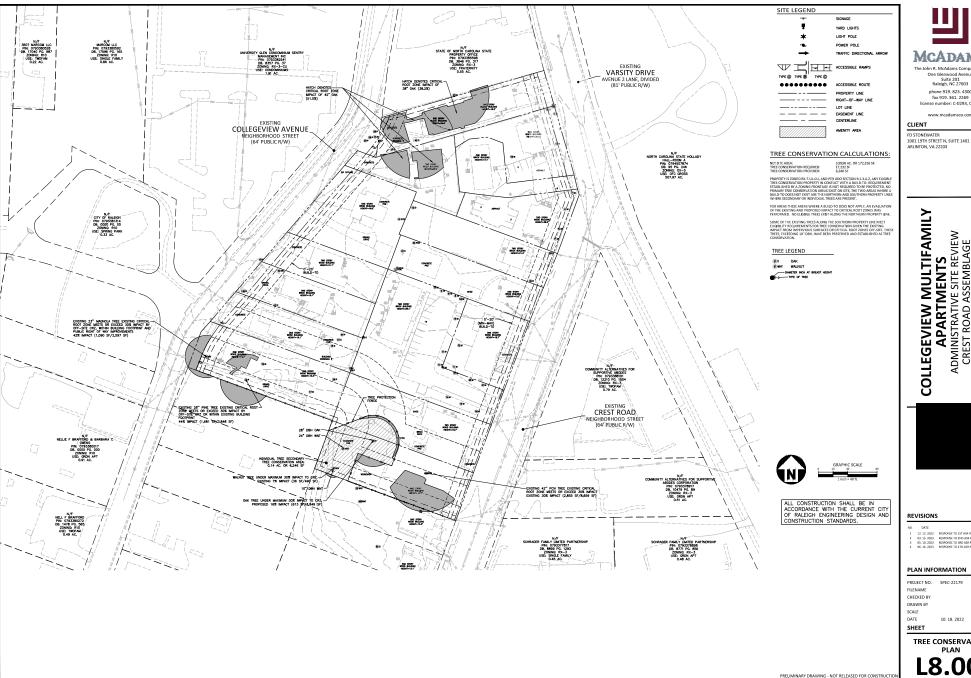
PLAN INFORMATION

FILENAME SPEC22179x-LS1 CHECKED BY SRD DRAWN BY

15-40 10. 14. 2022

LANDSCAPE PLAN

L5.00





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phone 919. 823. 4300 fax 919. 361. 2269 license number: C-0293, C-187

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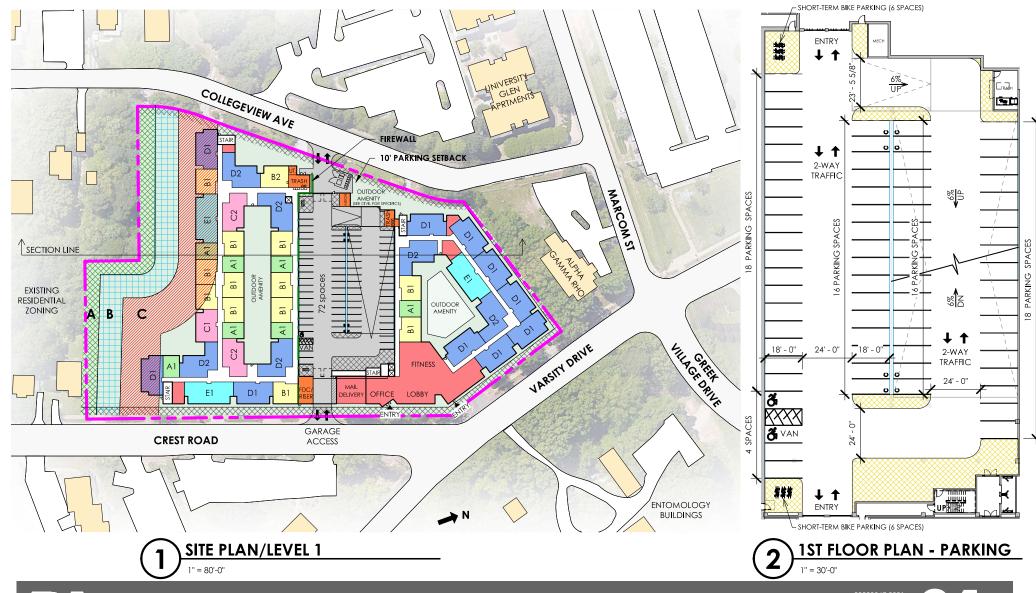
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03 . 15 . 2023 RESPONSE TO 2ND ASR REVIEW
05 . 10 . 2023 RESPONSE TO 18D ASR REVIEW
06 . 16 . 2023 RESPONSE TO 17D ASP REVIEW

### PLAN INFORMATION

PROJECT NO. SPEC-22179 FILENAME CHECKED BY DRAWN BY SCALE DATE 10. 18. 2022

TREE CONSERVATION

L8.00




PASSERO ASSOCIATES engineering architecture


**COLLEGEVIEW STUDENT HOUSING** 

JUNE 12, 2023
RALEIGH, NORTH CAROLINA


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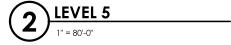


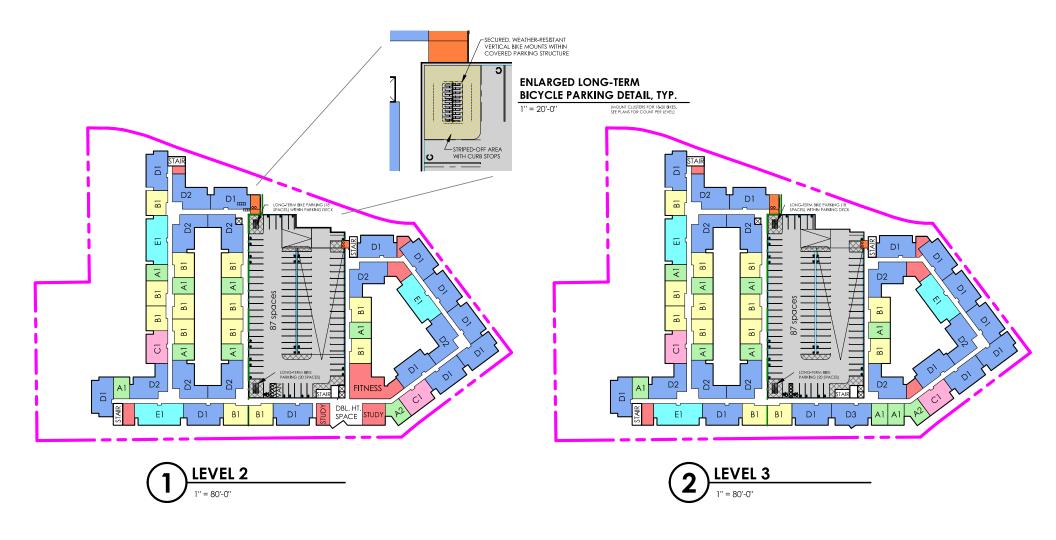




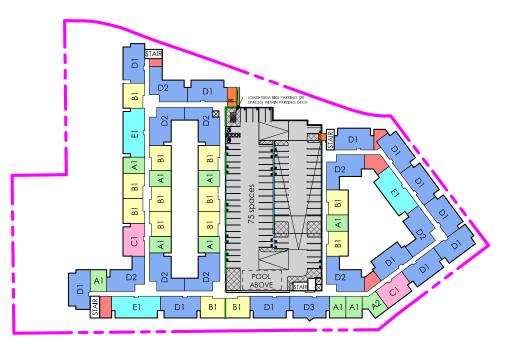



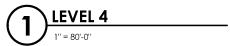




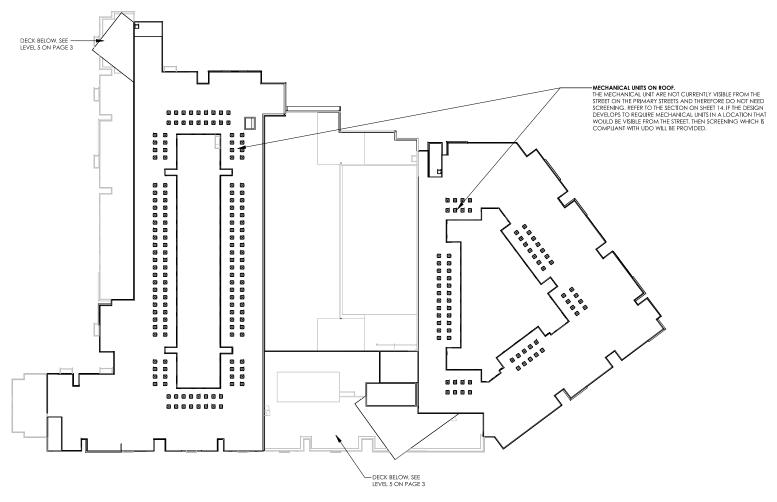





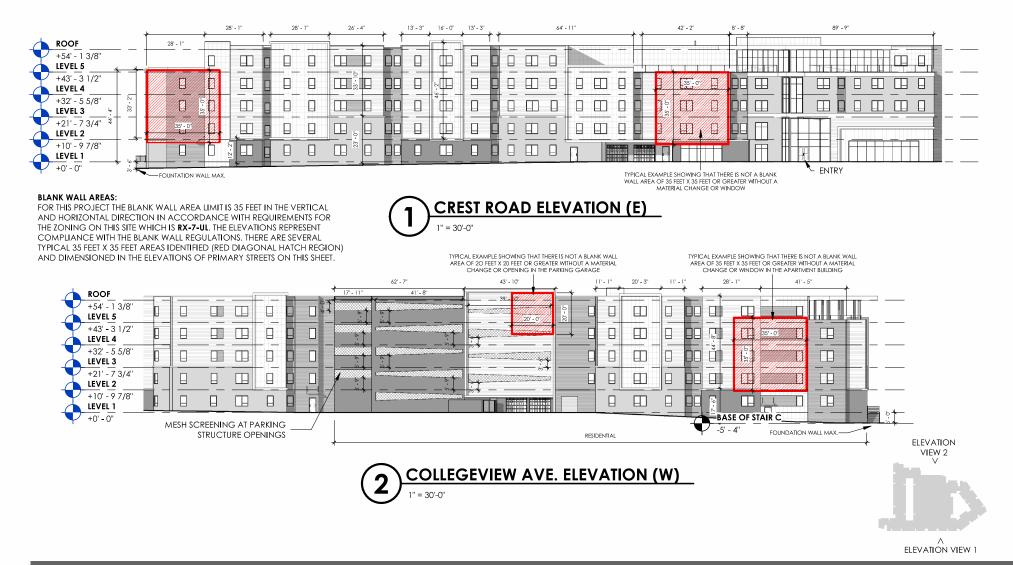




**COLLEGEVIEW STUDENT HOUSING** 

JUNE 12, 2023

RALEIGH, NORTH CAROLINA

05

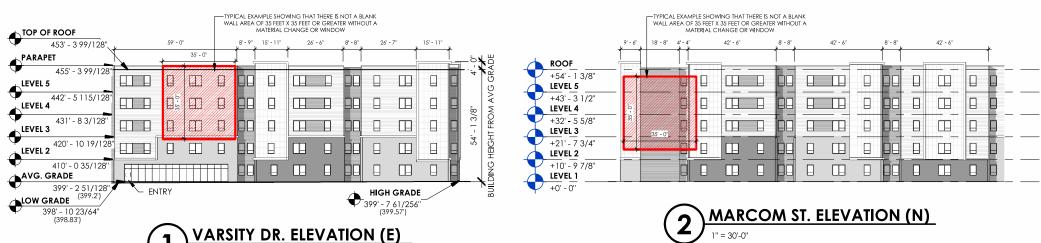

**BLANK WALL AREAS:** 

FOR THIS PROJECT THE BLANK WALL AREA LIMIT IS 35 FEET IN THE VERTICAL AND HORIZONTAL DIRECTION IN ACCORDANCE WITH REQUIREMENTS FOR THE ZONING ON THIS SITE WHICH IS **RX-7-UL**. THE ELEVATIONS REPRESENT COMPLIANCE WITH THE BLANK WALL REGULATIONS. THERE ARE SVERAL TYPICAL 35 FEET X 35 FEET AREAS IDENTIFIED (RED DIAGONAL HATCH REGION) AND DIMENSIONED IN THE ELEVATIONS OF PRIMARY STREETS ON THIS SHEET.



PEDESTRIAN PASSAGE ELEVATION (S)

1" = 30'-0"






COLLEGEVIEW STUDENT HOUSING

JUNE 12, 2023

06

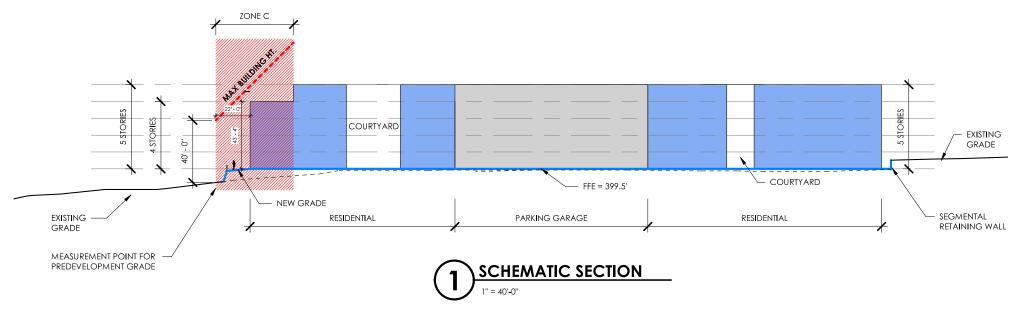

### EXCERPT FROM THE RALEIGH UNIFIED DEVELOPMENT ORDINANCE (UDO)

### Sec. 3.5.5. Zone C: Height and Form

### A. Permitted Activity


All structures and uses allowed in the zoning district are permitted in Zone C.


### B. Heigh

- No structure can be more than 40 feet in height at the Zone C line, as measured from the average pre-development grade measured along the Zone C line.
- Height can increase subject to a 45 degree height plane measured from a height of 40 feet at the Zone C line, extending upward one foot for every additional foot of setback into the site.
- 3. The height plane applies up to 100 feet from the district boundary line.


### C. Wall Articulation

The rear facade of the building that faces the residential property as described in Sec. 3.5.1.A. is subject to a maximum blank wall area of 30 feet as calculated in Sec. 1.5.10. The blank wall area provisions are not subject to an Administrative Alternate.

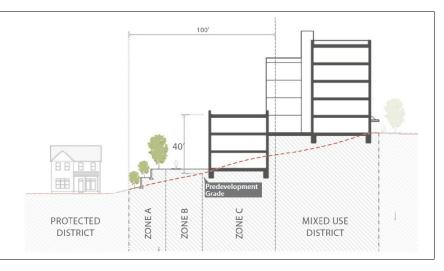

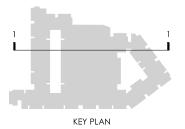





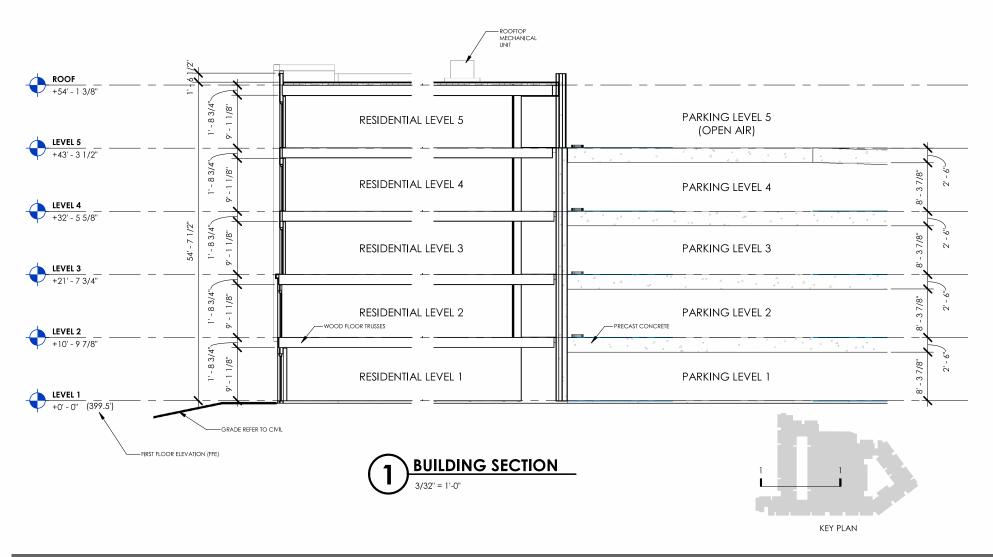








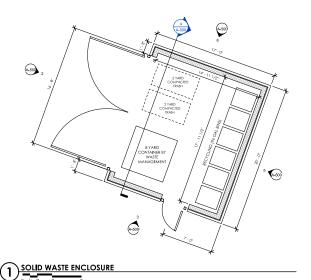


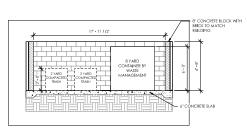


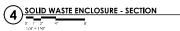

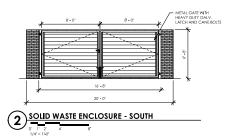

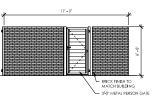

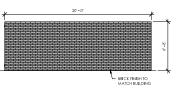

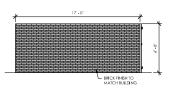

OLID WASTE ENCLOSURE - EAST	SOLID WASTE ENCLOSURE - NORTH
1' 2' 4' 8'	3
= 1500	1/4" = 1'40"

SOLID WASTE ENCLOSURE - WEST

CLIENT:
PREISS CO/ FD STONEWATER
1700 HILLSBOROUGH STREET
RALEIGH, NORTH CAROLINA

Passero Associates

INSTRUMENT OF THE PROPERTY OF THE PROPERTY

UNDRIZED ALTERATIONS OR ADDITIONS TO THIS DEPAYMENT
IN VIOLATION OF STATE EDUCATION LAW ARTICLE LAS
TION 7509 AND ARTICLE LAY SECTION 7307, THESE PLANS
COPYRIGHT PROTECTED. 60

SOLID WASTE ENCLOSURE

1406 VARSITY DRIVE

COLLEGEVIEW STUDENT HOUSING TOWN/CITY: RALEIGH OUNTY: WAKE STATE: NORTH CAROLIN.

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A-500

JUNE 12, 2023

