

Administrative Approval Action

Case File / Name: ASR-0100-2022 DSLC - F AND B City of Raleigh
Development Services Department
One Exchange Plaza
Raleigh, NC 27602
(919) 996-2492
currentplanning@raleighnc.gov
www.raleighnc.gov

LOCATION: This 1.57. acre tract zoned PD is located on the southwest corner of the

intersection of St Albans Drive and Hardimont Road Extension at 560 St Albans

Drive.

REQUEST: A 5,614 square foot retail/restaurant building with an outdoor plaza area and

associated infrastructure.

DESIGN

ADJUSTMENT(S)/

ALTERNATES, ETC: N/A

FINDINGS: City Administration finds that this request, with the below conditions of

approval being met, conforms to the Unified Development Ordinance. This approval is based on a preliminary plan dated March 31, 2023 by Mcadams.

CONDITIONS OF APPROVAL and NEXT STEPS:

This document must be applied to the second sheet of all future submittals except for final plats. This is a preliminary plan and as such no permits have been issued with this approval. To obtain permits and/or completion of the project, the following steps are required:

☑ <u>SITE PERMITTING REVIEW</u> - For land disturbance of 12,000 square feet or greater, public or private infrastructure, shared stormwater devices, etc. Site Permitting Review may be submitted upon receipt of this signed approval document.

The following items are required prior to approval of Site Permitting Review plans:

General

1. A discussion in detail is needed regarding the potential for a roundabout vs the signal as discussed in previous conversations. Staff is awaiting response to discuss further.

Engineering

2. A Traffic Control and Pedestrian (TCPED) Plan must be approved and a right-of-way occupancy permit must be obtained from Right-of-way Services for any construction activities within the right-of-way.

Public Utilities

construction of sewerline abandonment (per SPR-0051-2020) across lot 6 must be substantially complete

Stormwater

- 4. The State of North Carolina shall approve any proposed disturbance within the riparian buffer prior to the issuance of any grading or site permit (UDO 9.2.3.E).
- 5. A surety equal to of the cost of clearing, grubbing and reseeding a site, shall be paid to the City (UDO 9.4.4).

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- 6. A stormwater control plan with a stormwater operations and maintenance manual and budget shall be approved (UDO 9.2).
- 7. A nitrogen offset payment must be made to a qualifying mitigation bank (UDO 9.2.2.B).
- 8. A 100-year floodplain analysis shall be submitted and approved by the Engineering Services Department prior to the issuance of any grading or site permit (UDO 9.3).
- 9. A design exception will need to be granted for the retaining wall in the drainage easement for the outfall pipe of the SCM per UDO 7.2.8.B.4.

Urban Forestry

10. Tree protection fence must be inspected by Urban Forestry staff prior to the issuance of a grading permit.

☑ <u>RECORDED MAP(S)</u> - Submit plat to record new property lines, easements, tree conservation areas, etc.). Plats may be submitted for review when the Site Permitting Review plans, if required, have been deemed ready for mylar signature.

The following items must be approved prior to recording the plat:

Public Utilities

- 1. Infrastructure Construction Plans (concurrent submittal) must be approved by the City of Raleigh Public Utilities Department for all public water, public sewer and/or private sewer extensions.
- 2. CORSSE associated with sewerline abandonment (per SPR-0051-2020) across lot 6 must be abandoned by separate instrument

Stormwater

- The riparian buffers, in accordance with the preliminary plan and the State of North Carolina regulations, shall be shown on plats for recording along with required buffer statement (Recorded Map Checklist).
- All stormwater control measures and means of transporting stormwater runoff to and from any nitrogen and stormwater runoff control measures shall be shown on all plats for recording as private drainage easements (UDO 9.2).

Urban Forestry

Any changes to recorded tree conservation areas as a result of proposed Greenway Easement and trail construction shall be recorded with metes and bounds showing the designated tree conservation areas (UDO 9.1).

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☑ <u>BUILDING PERMITS</u> - For buildings and structures shown on the approved plans. Commercial building permit plans must include the signed, approved Site Permitting Review plans attached, if applicable. Permit sets may be reviewed prior to the recordation of required plats, but cannot be approved.

The following items must be approved prior to the issuance of building permits:

Public Utilities

1. A plat must be recorded at the Wake County Register of Deeds office for all utility easement dedications.

Stormwater

- 2. A surety equal to 125% of the cost of the construction of a stormwater device shall be paid to the Engineering Services Department (UDO 9.2.2.D.1.d).
- All stormwater control measures and means of transporting stormwater runoff to and from any nitrogen and stormwater runoff control measures shall be shown on all plats for recording as private drainage easements (UDO 9.2).
- 4. A payment equal to twenty-four percent (24%) of the estimated cost of constructing all stormwater control facilities shown on the development plans shall be paid by the developer to the City stormwater facility replacement fund (UDO 9.2.2.G.3).

Urban Forestry

- 5. A public infrastructure surety for 5 street trees along Hardimont Road and 5 street trees along St Albans Drive shall be provided to City of Raleigh Transportation – Development Engineering Division (UDO 8.1.3) in the amount of 100% of the improvement cost for the NCDOT portion and 125% of the improvement cost for
- A tree impact permit must be obtained for the approved streetscape tree installation in the right of way. This development proposes 5 street trees along Hardimont Road and 5 street trees along St Albans Drive.

The following are required prior to issuance of building occupancy permit:

General

- 1. Final inspection of all tree conservation areas and right of way street trees by Urban Forestry Stafl
- 2. Required public right-of-way infrastructure improvements shall be, at a minimum, sufficiently completed to provide the necessary, safe emergency and vehicular access.

Stormwater

ASR-0100-2022 DSLC - F AND B



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Case File / Name: ASR-0100-2022 **DSLC - F AND B**

City of Raleigh **Development Services Department** One Exchange Plaza Raleigh, NC 27602 (919) 996-2492 currentplanning@raleighnc.gov www.raleighnc.gov

3. As-built drawings and associated forms for all Stormwater devices are accepted by the Engineering Services Department (UDO 9.2.2.D.3).

Staff Coordinator: Michael Walters

EXPIRATION DATES: The expiration provisions of UDO Section 10.2.8 E, including the ability to request extensions in the expiration date, apply to this site plan. If significant construction has not taken place on a project after administrative site review approval, that approval may expire and be declared void, requiring re-approval before permits may be issued. To avoid allowing this plan approval to expire the following must take place by the following dates:

3-Year Expiration Date: May 3, 2026

Obtain a valid building permit for the total area of the project, or a phase of the project.

4-Year Completion Date:

Within four years after issuance of the first building permit for the site plan, the construction of the entire site plan must be completed unless an applicant has been granted vested rights. Failure to complete construction within this specified time frame shall automatically void the approved site plan for which no building permits have been issued.

I hereby o	ertify this administrative decision.		
Signed:	Daniel L. Stegall	Date:	05/03/2023
	Development Services Dir/Designee		

ASR-0100-2022 DSI C - F AND B

F&B

Administrative Site Ro				Raleigh
This form is required when submitting sile p 0.2.6. Please check the appropriate building	tons as raterent ig types and ind	ed in Unifie lade the pla	d Development Ordinance (UDO in offecklist document when subm	Section offing.
Office Use Only: Case #:		Planner (print):	
Seaso review UDO Section 10.2.6. as area fan Sec. If assistance determining a Sife Period and Development Port	tain Tilor is needs	sd a Sile Pi	an Tier Verliigation reguest can b	mina the site se submitted
Site Plan Tier: Tier Two Site Plan	Tier Tiree S	itie Plan		
Building Type			Site Transaction History	
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Affected:	Mired ine		Reich plan case #1	
Assertment			of Appropriateness #:	
=	. Open ox	Zorino Ci	ese e; PD (MP-0-16)	-
Townhouse	,Gare	Administr	ative Alternate III	
	GENERAL IN	FORMATI	DN	
Development name: F&B				
Iriside City limits? Yes 🗸 No				
Property address(lest) 560 ST A	LBAN	SDR		
58s P.I.N.(s): 1705987709	-			
Please describe the scope of work. Include Construction of single story retail build				
Current Property Owner/Developer Contact NOTE: please attack purchase agreeme				
Company: KANE REALTY CORPO	RATION	Tille: DE	VELOPMENT ANALYST	
Address: 4321 Lassiter at North Hil	ts Ave, Sub	250, R	aleigh, NC 27609	
Phone #: 919-833-7755		@kaner	ealtycorp.com	
Applicant Nome: Jonathan Balderson				
Company: McAdams	Address:62	1 Hillsba	rough St, Suite 500, Rale	igh 27606
Phone # 919-823-4300			ncadamsco.com	

			PE + SITE DATE TABLE all developments)			
	ITE DATA	Appricates to		ULDING DAT		-
Zoring district (if more than one, please provide the acreage of each): PD		Existing gross floor area (not to be demolished):		1		
		Existing gross floor area to be demolished; 0				
Gross sito acreage: 1,5	57 .		New gross foor area	See Site D	ata Tabi	9
Maximum # of parking s	spaces:		Total of gross (to rem	ain and new/c	See Site D	ata Table
# of parking spaces pro	posed:3		Proposed P of building	gs:1		
Overley District (if appli	iosbio): m/a		Proposed # of stories	for each: 1		
Existing use (UDD 6.1,4	4: Vacant					
Proposed use (UDO 6.1	A): Commerci	al	1			
-	- 10000	STORWWATE	RINFORMATION			
Existing Impervious Sur Acres: 0	Square Peol	0	Proposed Imperator Acres: 0.55		et: 24,132	
				-		
FEMA Map Ponel #:	Yes 🗸	Na 🗀	Wetlands	Yes	No 🗹	
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PERIA May Penel 6: Nogae River Baffer Total 8 of dynaling units 6 of badooin units: 1be 8 of badooin units: 1be 8 of bad- the subersigned infilinate described in this applicate beneath, and in accordan- table and accordance Jonathan Batidenso and report to accelerate	r n/ax 2br 2br 1 field the property too vell be maintel ros with the provid- on hit allow contracts, a seding regarding th	SIGNATU SIGNATU FORMATION SIGNATU FORMATION FO	DEVELOPMENTS Total stof hostel unit 60 or more Is your project a col is your project a col is your project a col is experiment of the application and in a gooddines with the interest of this application and in a good for Raileig serve as the application do unit in a good source of the interest of the source of the interest of the source of the interest of the first intere	serals Sage count? If that the proper plans and ope in Unified Dear Sing This application, and will re-	Yes	ubmilled Scance. I receive property



ST ALBANS DRIVE

RALEIGH, NORTH CAROLINA 27609 **ADMINISTRATIVE SITE REVIEW**

RALEIGH CASE NUMBER: ASR-0100-2022 PROJECT NUMBER: KAN-19100

DATE: OCTOBER 19, 2022

SIT	E DATA
PHYSICAL ADDRESS:	560 ST. ALBANS DRIVE RALEIGH, NORTH CAROLINA
OWNER:	ST. ALBANS LLC
DEVELOPER/APPLICANT	KANE REALTY CORP 4321 LASSITER AT NORTH HILLS AVE SUTE 230 RALEIGH, NC 27609
PN:	1705967709
ZONING	PD
OVERLAY DISTRICT:	NONE
WATERSHED:	NEUSE RIVER
SITE AREA	LOT 6: 68,357 SF / 1.57 AC
AREA IN FLOODWAY/FLOODPLAIN:	NONE
BUILDING SQUARE FOOTAGE:	RESTARAUNT (BUILDING 1) RESTAURANT: 5,614 SF
PARKING SUMMARY MAXIMUM PARKING (MN. UDO 7.1.2): PROVIDED PARKING:	100 SPACES MAX. (1.0/100 SF) 3 SPACES
ACCESSIBLE PARKING REQUIRED: ACCESSIBLE PARKING PROVIDED:	1 SPACE; 1 VAN SPACE REQUIRED 1 SPACES; 1 VAN SPACE
BICYCLE PARKING:	REQUIRED LOT 4: 8 SPACES 4 LONG TERM; 4 SHORT TERM PROPOSED: 8 SPACES
PROPOSED IMPERVIOUS:	0.61 AC. (38.9% OF PROJECT AREA)
DENUDED AREA:	0.67 AC (29,296 SF)
BUILDING SETRACKS TO PUBLIC STREETS PRIMARY (ST. ALBAINS STREET): SDE (HARDMONT ROAD): REAR: AGOREGATE: FRONT MAXIMUM:	32" FROM BACK OF EXISTING CURB O" (MIN) O" (MIN) O" (MIX)
MAX. BUILDING HEIGHT REFERENCE APPROVED PD (MP-3-16) MAX. BUILDING HEIGHT PROPOSED	75' (TRACT S) 28'
MIN. SIDEWALK WIDTH WIDTH PROVIDED	10"
OPEN SPACE REQUIRED OPEN SPACE	REQUIRED: 10,254 (15% PER MP-3-16) EXISTING: 0 SF PROVIDED: 12,219 SF / 0.28 AC (17.9%)
AVENITY AREA REQUIRED AMENITY AREA	REQUIRED: 3,418 SF (0.078 AC) (5% OF 68,357 PER MP-3- PROVIDED: 3,580 SF (0.082 AC)

SHEET INDEX

20.00	PROJECT NOTES
0.01	APPROVED FORMS
21.00	EXISTING CONDITIONS
21.01	DEMOLITION PLAN
22.00	OVERALL SITE PLAN
22.01	SITE PLAN
22.02	SIGHT DISTANCE TRIANGLE PLAN
22.03	OVERALL DEVELOPMENT TRACKING PLAN
22.04	OVERALL DEVELOPMENT TRACKING PLAN
23.00	GRADING AND STORM DRAINAGE PLAN
1 00	LITILITY DI ANI

SITE DETAILS SITE DETAILS C8 00 C8.01 SITE DETAILS C8.02 C8.03 WATER DETAILS

WATER DETAILS WATER DETAILS

C8.06 SANITARY SEWER DETAILS

STORMWATER CONTROL MEASURE PLAN VIEW C9.00 C9.01 STORMWATER CONTROL MEASURE DETAILS

L5.00 LANDSCAPE PLAN BUILDING ELEVATIONS

NOTES

RIGHT-OF-WAY OBSTRUCTION NOTES

- STREET, LANE, AND SIDEWALK CLOSURES OR DETOURS: PRIOR TO ANY WORK THAT IMPACTS THE RIGHT-OF-WAY OR CLOSING OF ANY STREET. LANE. OR SIDEWALK. THE CONTRACTOR MUST APPLY FOR A PERMIT WITH RIGHT-OF-WAY SERVICES.
- A PERMIT REQUEST WITH A TRAFFIC CONTROL AND/OR PEDESTRIAN PLAN SHALL BE SUBMITTED TO rightofwayservices@raleighnc.gov_AT www.releighnc.gov_XEYWORD "RIGHT-OF-WAY SERVICES.
- PRIOR TO THE START OF WORK, THE CLIENT SHALL SCHEDULE A PRE-CONSTRUCTION MEETING WITH THE ENGINEERING INSPECTIONS COORDINATOR TO REVIEW THE SPECIFIC COMPONENTS OF THE APPROVED PLAN, AND ENSURE ALL PERMITS ARE

- 7. ALL PERMITS MUST BE AVAILABLE AND VISIBLE ON SITE DURING THE OPERATION

SOLID WASTE INSPECTION STATEMENT:

THE DEVELOPER ACKNOWLEDGES THAT THEY HAVE REVIEWED AND ARE IN COMPI WITH THE REQUIREMENTS SET FORTH IN THE SOLID WASTE DESIGN MANUAL.

Call before you dig.

ALL CONSTRUCTION SHALL CONFORM WITH THE LATEST VERSION OF THE CITY OF RALEIGH AND NCDOT STANDARD: SPECIFICATIONS AND DETAILS.

CONTRACTOR SHALL NOTIFY "NC811" (811) OR (1-800-632-4949) AT EAST 3 FULL BUSINESS DAYS PRIOR TO BEGINNING CONSTRUCTE EASTS FULL BUSINESS DATS PRIOR TO BEGINNING COMBINESS DATS PRIOR TO BE EXCAVATION TO HAVE EXISTING UTILITIES LOCATED. SONTRACTOR SHALL CONTACT ANY LOCAL UTILITIES THAT PROVIDINEIR OWN LOCATOR SERVICES INDEPENDENT OF "ROS11".

REPORT ANY DISCREPANCIES TO THE ENGINEER IMMEDIATELY.





phone 919, 361, 5000 fox 919 361 2269

CONTACT

JONATHAN BALDERSON PHONE: 919, 287, 0815

CLIENT

KANE REALTY CORPORATION 4321 LASSITER AT NORTH HILLS RALEIGH, NORTH CAROLINA 27609 PHONE: 919. 719. 3573



PROJECT DIRECTORY



REVISIONS

ADMINISTRATIVE SITE REVIEW FOR:

F&B 560 ST. ALBANS DRIVE, RALEIGH, NORTH CAROLINA 27609 PROJECT NUMBER: KAN-19100

GRADING NOTES

- OCCUPATIONAL SAFETY AND HEALTH ADMINISTRATION (DOING STANDARDS FOR EXCAVATIONS; FINAL JULE 20CF PART 120C SUPPART OF A PRINT TO ALL DOCATIONS OF OCCIDENT PROEST SET IN 1997. LOCAVATION DOCESIONE WAVENTY 20CF RET DEPTH REQUIRES THE DISSON OF A TRENCH SAFETY SYSTEM BY A REGISTERED PROFESSIONAL INGINIER, PROVIDED BY CONTRACTOR RESPONSIBLE FOR EXCAVATION.
- ALL CONSTRUCTION SHALL BE IN ACCORDANCE WITH THE CITY OF RALEIGH AND/OR NODOT STANDARDS AND SPECIFICATIONS AS APPLICABLE.
- 4. CONTRACTOR SHALL MOTHY "NICEL" (BLI) OR 1.8 00-02-3.409) AT LIAST 3 FULL BUSINESS DAYS PRIOR TO REGINATING OBSTRUCTION ON DE ECONATION TO HAVE EXISTING UTURIES I LOCATED. CONTRACTOR SHALL CONTRACT ANY IDECOMPTION THE PROVIDE THEIR OWN LOCATOR SERVICES INDEPENDENT OF "NICELL". REPORT ANY DISCREPANCES TO THE ENGINEER MIMERIATELY.
- PRIOR TO BEGINNING CONSTRUCTION, THE GENERAL CONTRACTOR SHALL SCHEDULE AND ATTEND A PRE-CONSTRUCTION
 CONFERENCE WITH THE CITY OF RALESH'S TORNIWATER AND EROSION CONTROL DEPARTMENT, THE ENGINEER AND A
 REPRESENTATIVE OF THE CONVER.
- CONSTRUCTION, MAINTENANCE AND REMOVAL OF ALL PROSION CONTROL DEVICES ARE THE RESPONSIBILITY OF THE GENERAL
 CONTRACTOR. TIMING OF REMOVAL SHALL BE COORDINATED WITH THE EROSION CONTROL INSPECTOR.
- EXISTING UTILITIES AND STRUCTURES SHOWN, BOTH UNDERGROUND AND ABOVE GROUND, ARE BASED ON A FIELD SURVEY AND THE BEST AVAILABLE RECORD DRAWINGS. THE CONTRACTOR SHALL VERIFY FIELD CONDITIONS PRIOR TO BEGINNING RELATED CONSTRUCTION. ANY DISCREPANCIES SHALL BE REPORTED TO THE BROWNERS RIMERER IMMEDIATELY.
- SOIL UNDER BUILDINGS, PAVED AREAS AND WITHIN SLOPES GREATER THAN 3:1 (H-V) SHALL BE APPROVED, PLACED AND COMPACTED AS RECOMMENDED BY THE GEOTECHNICAL ENGINEER.

RETAINING WALL NOTES

- 2. THE RETURNING WALL ALGEMENT SHOWN ON THESE PLANS PRINCE THE LOCATION OF THE FERMY FACE OF THE RECLARMING WALL AT THE TOP OF THE WALL. THE CONTRIVENTS OF SERVINGIAIS FOR THIS WALL SER FOR TOCKNISH STEELED STREAM BUFFRES, AND THEIR CONSTRUCTION DOES NOT ENCOGNED ANY ADJACENT PROPERTIES DUE TO ANY BATTER OCCOPROPATED TO THE UNILLS.
- RETAINING WALLS SHALL BE ASSUMED TO BE BACKFILLED WITH OFF-SITE BORROW MATERIAL OR PROCESSED FILL, UNIESS THE CONTRACTOR CAN PROVIDE TO THE OWNER WITH CONTRACTION FROM THE GEOTECHNICAL ENGINEER AND THE RETAINING WALL DES
- THE TOP AND BOTTOM OF WALL ELEVATIONS SHOWN ON THESE PLANS IDENTIFY FINISHED GRADE ELEVATIONS ONLY. THE EXTEXT THAT THE RETAINING WALL WILL BE EXTENDED BELOW GRADE TO THE FOOTING OR ABOVE GRADE TO THE TOP OF THE CAP BLOCK COURSE SHALL BE IDENTIFIED ON THE RETAINING WALL CONSTRUCTION DENAMINGS.
- 5. ALL RETAINING WALLS OVER 30" HIGH SHALL HAVE A SAFETY FENCE (DESIGN BY OTHERS).
- ANY PART OF ANY RETAINING WALL THAT EXTENDS INTO THE RIGHT-OF-WAY WILL REQUIRE AN ENCROACHMENT AGREEMENT ENCROACHMENT AGREEMENTS FOR RETAINING WALLS SHALL BE APPROVED PRIOR TO CONSTRUCTION DRAWING APPROVAL.
- 7. ANY TIEBACK SYSTEMS FOR THE RETAINING WALLS SHALL NOT BE ALLOWED WITHIN PUBLIC RIGHT-OF-WAY.
- STORMWATER RUN-OFF SHALL BE DIRECTED AWAY FROM RETAINING WALLS, ANY RUN-OFF FLOWING TO AND OVER A
 RETAINING WALL SHALL BE KEPT TO AN ABSOLUTE MINIMUM AND BROUGHT TO THE ATTENTION OF THE WALL DESIGNER PRIOR

SITE PLAN NOTES

- NOM-ALLEY LOADED DRIVEWAYS MAY INTESSECT A STREET NO CLOSER THAN 20 FEET FROM THE INTERSECTION OF TWO STREET BIGHT O-WARS. THE MINIMAL CORRUS CLOSEMAN FROM CLOSE DID OF DEDUCE OF PAVIMENT OR INTERSECTION OF BIGHT LOSS OF DEPENDANCE OF TO TRANSCENCE OT THE AUXILIARY OF THE TRANSCENCE OF CORRES CLARANCE, REFER TO SECTION 6.5 OF THE LATEST VERSION OF THE RALEGHISTREET DESIGN MANUAL FOR ADDITIONAL DEFAULT.
- RIGHT-OF-WAY SHALL BE CLEARED AND GRUBBED WITHIN 50' OF ALL MINOR RESIDENTIAL, RESIDENTIAL, AND RESIDENTIAL
 COLLECTOR RITERSECTIONS. THE FULL LENGTH OF THE RIGHT-OF-WAY SHALL BE CLEARED AND GRADED ALONG ALL MAJOR,
 MINOR, & SHASTIVE AREA. THOROGOGIFFARED.
- WITHER THE AREA REPRESED GRITT TRANSICES SHOWN, ON THESE STANS, THESE STANS, ISSUE MY SHIFT GRISTIALITHING OR PARTY
 OSSTRUCTIVE WALK, THESE, GOS, COLOGGE BERNE, OR PARED VENEZES SETWENT THE HEIGHTS OF ALTHOUS SHOW BE TEST
 ABOUT THE CARB LINE ELEVATION OR THE HEARST TRAVE, WAY FIN OLDS LINE EXISTS, REFER TO SICTION 6.12 OF THE LATEST
 VESSION OF THE ALZBERS THESE COSSESS MANUAL, OR ADDITIONAL DETITION.
- MULTIWAY STOP CONTROL WILL NOT BE USED AT ANY PUBLIC STREET INTERSECTION WITHOUT AN ENGINEERING STUDY TO
 PROVIDE DATA TO CITY OF RALEBH TRANSPORTATION DIVISION THAT THE MULTIWAY STOP INSTALLATION WARRANTS CAN BE
 MET AND DORINANCE BY CITY COLINCIA LAPPROVIAL.
- 5. ALL CONSTRUCTION SHALL CONFORM TO THE LATEST CITY OF RALEIGH AND/OR NCDOT STANDARDS AND SPECIFICATIONS AS APPLICABLE.
- 6. ALL DIMENSIONS SHOWN ON SITE PLAN ARE MEASURED TO FACE OF CURB UNLESS OTHERWISE NOTED.
- CONTRACTOR SHALL MAINTAIN AN "AS-BUILT" SET OF DRAWINGS TO RECORD THE EXACT LOCATION OF ALL PIPING PRIOR TO CONCLAIMENT, DRAWINGS SHALL BE GIVEN TO THE ENGINEER UPON COMPLETION OF THE PROJECT WITH A COPY OF THE TRANSMITTAL LETTER TO THE OWNER.
- EXISTING IMPROVEMENTS DAMAGED DURING CONSTRUCTION SHALL BE REPLACED/BESTORED TO THEIR ORIGINAL CONDITION
 AND TO THE SATISFACTION OF THE OWNER, BY THE CONTPACTOR RESPONSIBLE FOR THE DAMAGE.
- THE CONTRACTOR SHALL NOTE THAT THE DRAWINGS MAY NOT SHOW EVERY OFFSET, TRANSITION, FITTING, ETC. THAT MAY BE REQUIRED. THE CONTRACTOR SHALL INSTALL SUCH STANDARD APPURTENANCES AS REQUIRED TO CLOSELY FOLLOW THE GRADES AND ALLIMINENTS DEFICTED ON THE PLANS.
- CONTRACTOR IS RESPONSIBLE FOR COORDINATING CONSTRUCTION ACTIVITIES WITH THE APPROPRIATE UTILITY COMPANIES FOR ANY REQUIRED RELOCATIONS (I.E. POWER POLES, TELEPHONE PEDESTALS, WATER METERS, ETC.).
- 12. PRIOR TO BEGINNING CONSTRUCTION BEYOND EROSON CONTROL MEASURES, THE GENERAL CONTRACTOR SHALL SCHEDULE AN ATTERNO A PRE-CONSTRUCTION CONFERENCE WITH THE CITY OF PARLIGHT PUBLIC WORKS DEPARTMENT 1931/998-2489, AND A TENDER OF THE CONTRACTOR OF
- 18. ALL DRIFFLESING AND GRADES SHOWN OR THE FLAME SHALL SET HILD VERFILD BY THE CONTRACTOR FROM TO CONSTRUCTION CONTRACTOR SHALL OTHET "THE SEGMENTER IF ANY DISCREPANCES DEFER FROM TO PROCEEDING WHICH CONSTRUCTION ON NECESSARY FLAM DISCREPANCES, TO EXTRA COMPRISATION SHALL BE FAID TO CONTRACTOR FOR ANY YORK DONE DUE TO DIMITIONS OR GRADES SHOWN HICKORECTLY ON THESE PLAME IS SULF INTERPLATION TO THE REPORT OF THE
- 14. ACCESSIBLE RAMPS SHALL BE CONSTRUCTED IN ACCORDANCE WITH THE CITY OF RALEIGH UNIFIED DEVELOPMENT ORDINANCE (UDO) DETAILS.
- 15. ALL SIDEWALKS THAT COMMECT TO THE PUBLIC RIGHT-OF-WAY MUST BE ACCESSIBLE TO PERSONS WHO ARE BLIND, HAVE LOW VISION AND PROPER WHITH MOBILITY DISCREDILLS. PROSSTRIAN SISSTIMS RODITES AND ATTERNATE PROSSTRIAN RODITES SURPING CONSTRUCTION WILL BE REQUISED FOR COMPAINT WITH THE PUBLIC RIGHTS OF WAY ACCESSIBLE TO INDICINES PROVINCING, 2010 ADD STANDARDS FOR ACCESSIBLE DESIGN AND THE MANUAL ON UNFORM TRAFFIC CONTROL DEVICES (MUTCO).
- 16. TYPICAL PAVEMENT SECTION DETAILS ARE SHOWN WITHIN THIS SET AND INTENDED TO BE A MINIMUM PAVEMENT SECTION BEQUIREMENT. THE CURRENT, GEOFCHINCAL ISPORT SHALL OVER-RIDE ALL TYPICAL PAVEMENT SECTIONS SHOWN, IF THE GEOTECHINICAL PRINTER DETAINS A HEAVIER SECTION IS REQUIRED.
- EQLIPMENT AND PRODUCTS OTHER THAN THOSE SPECIFIED MAY BE USED PROVIDED APPROVAL HAS BEEN OBTAINED FROM THO
 OWNER IN WRITING PRIOR TO ORDERING OR INSTALLATION, THE CONTRACTOR SHALL WAIVE MAY CLAIM FOR ADDITIONAL COST
 RELATED TO SUBSTITUTION OF ALTERNATE EQUIPMENT.
- IF UNFORESEEN CONDITIONS DEVELOP DUBING CONSTRUCTION, REFER TO THE LATEST VERSION OF THE RALEIGH STREET DESIGN MANUAL AND CONTACT PUBLIC WORKS STAFF FOR FURTHER GUIDANCE.
- 19. ALL SIGNAGE ASSOCIATED WITH THE PUBLIC STREET SYSTEM SHALL ADHERE TO MUTCO STANDARDS AND SPECIFICATIONS
- ANY TRANSIT STOP LOCATIONS SHOWN ARE PRELIMINARY ONLY. FINAL LOCATION SHALL BE DETERMINED ONCE THE CITY OF RALEIGH TRANSIT ROUTE HAS BEEN FINALIZED. ALL TRANSIT STOPS SHALL HAVE A 10°x20′x6° (3000 PSI) CONCRETE PAD.

ADDITIONAL UTILITY NOTES

- ALL WATER MAINS, SERVICES AND FIRE SERVICES GREATER THAN 2" DIAMETER ARE TO BE DUCTILE IRON P.P.E. 2" & SMALLER DOMESTIC SERVICES MUST BE TYPE K SOFT COPPER (WITHOUT FITTINGS) TO THE WATER METER.
- ALL SEWER MAINS SHALL BE EITHER PVC OR DUCTLE IRON PIPE AS SHOWN ON THE PLANS, ALL PIPE MATERIAL SHALL MEET CITO
 OF RALEIGH STANDARDS AND SPECIFICATIONS AS DEFINED IN THE LATEST ISSUE OF THE PUBLIC UTILITIES HANDBOOK AND/OR
 UNIFIED DEVLOPMENT CORDINANCE (UDO).
- 3. ALL FIRE HYDRANTS ALONG PUBLIC R/W LINES SHALL HAVE A 5'WAS'L CITY OF RALEIGH WATERLINE EASEMENT ONTO ADJACENT BRIDGERTY
- 4. ALS SANTANY STAVE INTERCEPTOR LINES (12" AND LABORED, SA VELLAS AMANINO IS AND INTERCES ASSOCIATED WITH THE INTERCEPTOR UNE, SHALL BE INTERNALLY LAND UNITH PROTECTOR 401 OF AMPROVIDE OLQUE, TO PREVIOUS TRYONGRIS SULBEST CORROSSON, SET THE CURRENT CITY OF BALESCH PUBLIC UTILITIES DEPARTMENT HANDROOK FOR APPROVED COATINGS AND APPLICATION METHODS.
- EXISTING UTILITIES SHOWN ARE BASED ON FIELD SURVEYS AND THE BEST AVAILABLE RECORD DRAWINGS. THE CONTRACTOR SHALL VIRRIEY CONDITIONS PRIOR TO BEGINNING CONSTRUCTION. ANY DISCREPANCIES BETWEEN ACTUAL FIELD CONDITIONS AND THE PLANS SHALL BE REPORTED TO THE ENGINEER IMMEDIATELY.
- 7. ALL WATER AND SEWER MAINS WITHIN PUBLIC EASEMENTS OR RIGHTS-OF-WAY TO BE OWNED, OPERATED, AND MAINTAINED BY THE CITY OF BALEIGH.
- ALL WATER AND SEWER MAINS NOT WITHIN PUBLIC EASEMENTS OR RIGHTS-OF-WAY TO BE PRIVATELY OWNED, OPERATED, AND MAINTAINED BY THE PROPERTY OWNER.
- WHERE SANTIARY SERVICES ARE SERVING A BUILDING INSTALLED ON A FLOOR WITH A FINISHED FLOOR ELEVATION BELOW THE ELEVATION OF THE RAMPOLE COVER OF THE RICH USTREAM MANIOLU. IN THE PUBLIC SERVES, SUCH PIXTURES SHALL BY PROTICTION AS ABOVARIAT WAITE PASKLID BY THE SERVIC RUIS, SANTIARS REPORKED SERVING ABOVARIA WHAT BROSHED HOOD ELEVATION ABOVE THE ELEVATION OF THE MANIFOLE COVER OF THE RICH USTREAM MANIFOLE IN THE PUBLIC SERVING SHALL NOT DOCKMENT (FROM THE MAGNATERY NAVE.)
- CONTRACTOR SHALL NOTIFY "NC811" (811) OR (1-800-632-69/9) AT LEAST 3 FULL BUSINESS DAYS PRIOR TO REGINNING ONSTRUCTION ON BEAVAITOM TO HAVE SESSING URLITES LOCATED. CONTRACTOR SHALL CONTRACT ANY LOCAL UTILITIES ON THE PRIOR WITH LOCATION SERVICES INSPERIENCENT OF "NC111", "REFORM ANY DESCRIPANCES" OF THE CHINETER MANIFESTED."
- 11. ALL UTILITY SLEEVES SHALL BE SCHEDULE 40 PVC AND INSTALLED WITH 2' MINIMUM COVER, BOTH ENDS SHALL BE CAPPED AND

STORM DRAINAGE NOTES

- ALLSTORM DRAINAGE PIPES SHOWN SHALL BE REINFORCED CONCRETE (RCP) (MINIMUM CLASS III) UILLES NOTED
 OTHERWISE. CONTRACTION TO COCROBINATE WITH THE GEOTTECH TO VERHEY TYPE IR BEDTOM REQUIRES MAKED ON SOIL
 MINIMUM CHAPTER THE ASSOCIATIONS GUIDELINGS. OF PIPE MAKED ON IDEPTH OF PIPE AND EXCORDING PORTION.
- 2. ALL STORM DRAINAGE CONSTRUCTION SHALL BE IN ACCORDANCE WITH THE CITY OF RALEICH STANDARDS.
- 3. ALL CONCRETE SHALL MEET A MINIMUM 3000 PSI COMPRESSIVE STRENGTH.
- 4 ALL PIPE IN STORM DRAIN STRUCTURES SHALL BE STRUCK EVEN WITH INSIDE WALL

- . ALL BACKFILL SHALL BE NON-PLASTIC IN NATURE, FREE FROM ROOTS, VEGETATION MATTER, WASTE CONSTRUCTION MATERIAL OR OTHER ORIENTOMABLE MATERIAL. SUID MATERIAL SHALL BE CAPABLE OF BRING COMPACTED BY MICHANICAL MEMAS AND SHALL HAVE NOT ENDENCY TO FLOW OR BEHAVE IN A PLASTIC MANNER UNDER THE TRANSING BOXYD OF ROOTS ORLING.
- BACKFILLING OF TRENCHES SHALL BE ACCOMPLISHED IMMEDIATELY AFTER PIPE IS JUID. THE FILL AROUND THE PIPE SHALL BE
 THOROUGHLY COMPACTED TO 95 % OF THE MAXIMUM DRY DENSITY OBTAINABLE WITH THE STANDARD PROCTOR TEST. THE TOP
 EIGHT 18) WHOLES SHALL BE COMPACTED TO 10 OF PIREM TISTANDARD PROCTOR.
- 11. ALL CONCRETE PIPE AND PRECAST STORM STRUCTURES SHALL MEET NODOT STANDARDS BY MANUFACTURER

RALEIGH STANDARD UTILITY NOTES:

- 5. 3.0" MINIMUM COVER IS REQUIRED ON ALL WATER MAINS AND SEWER FORCEMAINS, 4.0" MINIMUM COVER IS REQUIRED ON ALL RE-USE MAINS.
- INSTALL PROPERLY SIZED WATER SERVICES WITH METERS LOCATED AT R.O.W. WITHIN A 2'X2' (OR APPROPRIATE SIZED EASEMENT)
 IMMEDIATELY ADJACENT, IT IS THE APPLICANT'S RESPONSIBILITY TO PROPERLY SIZE THE WATER SERVICE FOR EACH CONNECTION TO
 SEQUENCE ADJIVITATE LITIM AND JURISH SIZE OF THE WATER SERVICE FOR EACH CONNECTION TO
- 8. INSTALL 4" PYC SEWER SERVICES AT 1.0% MINIMUM GRADE WITH CLEANOUTS LOCATED AT R.O.W. OR EASEMENT LINE AND SPACED EVERY 100 IF MAX.
- PRESSURE REDUCING VALVES ARE REQUIRED ON ALL WATER SERVICES EXCEEDING 80 PSI; BACKWATER VALVES ARE REQUIRED ON ALL SEVER SERVICES HAVING BUILDING DRAINS LOWER THAN 1.07 ABOVE THE NEXT UPSTREAM MANHOLE.

- 5. ALL PIPE JOINTS SHALL BE MADE WITH PREFORMED JOINT SEALER, WHICH CONFORMS TO AASHTO SPECIFICATION M-198 FOR TYPE B FLEXIBLE PLASTIC GASKETS UNILSS OTHERWISE NOTED.
- THE INTERIOR SURFACES OF ALL STORM DRAININGE STRUCTURES SHALL BE POINTED UP AND SMOOTHED TO AN ACCEPTABLE STANDARD, USING MORTAR MIXED TO MANUFACTURER'S SPECIFICATIONS.
- MATERIALS DEEMED BY THE OWNER'S REPRESENTATIVE OR GEOTECH AS UNSUITABLE FOR BACKFILL PURPOSES SHALL BE REMOVED AND REPLACED WITH SUITABLE MATERIAL.

- CONTRACTOR SHALL BE RESPONSIBLE FOR CHECKING ALL PIPE AND STRUCTURES FOR CRACKS OR BREAKS, PRIOR TO INSTALLATION
 ANY DAMAGED ITEMS SHALL NOT BE INSTALLED.
- "KNOCK OUT" BOXES OR HOPE PIPE SHALL NOT BE ALLOWED WITHIN PUBLIC RIGHT-OF-WAYS UNLESS APPROVED IN WRITING BY CITY OF RALEICH STORMWATER DEPARTMENT.

- ALL SEWER CONSTRUCTION SHALL BE IN ACCORDANCE WITH THE CITY OF RALEIGH PUBLIC UTILITIES DEPARTMENT HANDBOOK, CURRENT EDITION (INCLUDING STANDARDS AND SPECIFICATIONS).

- 3. ANY NECESSARY FIELD REVISIONS ARE SUBJECT TO REVIEW AND APPROVAL OF AN AMENDED PLAN AND OR PROFILE BY THE CORPUD PRIOR TO CONSTRUCTION.
- CONTRACTOR SHALL MAINTAIN CONTINUOUS WATER AND SEWER SERVICE TO EXISTING RESIDENCES AND BUSINESSES THROUGHOUT CONSTRUCTION OF PROJECT. ANY NECESSARY SERVICE INTERRUPTIONS SHALL BE PRECEDED BY A 24-HOUR ADVANCE NOTICE TO THE CORPLID.
- It is the developer's responsibility to abandon or remove existing water and sever services not being used in redevelopment of a site unless otherwise directed by the comput. This includes arandoming tap at main and removal from R.O.V. or existence the corpul-mandoox proclodure.

- ALL ENVIRONMENTAL PERMITS APPLICABLE TO THE PROJECT MUST BE OBTAINED FROM INCOUND, USACE AND/OR FEMA FOR ANY RIPARIAN BUFFER, WETLAND AND/OR FLOODPLAIN IMPACTS (RESPECTIVELY) PRIOR TO CONSTRUCTION. NCDOT ENCROACHMENT AGREEMENTS ARE REQUIRED FOR ANY UTILITY WORK (INCLUDING MAIN EXTENSIONS AND SERVICE TAPS)
 WITHIN STATE R.O.W. PRIOR TO CONSTRUCTION.
- GREASE INTERCEPTOR/OIL WATER SEPARATOR SIZING CALCULATIONS AND INSTALLATION SPECIFICATIONS SHALL BE APPROVED BY THE
 CORPUD FOG PROGRAM COCROBINATION PROCY TO ISSUANCE OF A BUILDING PLEMIT. CONTACT TIM BEASLEY 919.996.2334 OR
 TRANSTITUSEASLEY/BEAUGRACK, COV FOR NOBEL INFORMATION.

CONTRACTOR SHALL NOTIFY "NC811" (811) OR (1-800-632-4949) AT

ALL CONSTRUCTION SHALL CONFORM WITH THE LATEST VERSION OF THE CITY OF RALEIGH AND NCDOT STANDARD SPECIFICATIONS AND DETAILS.

EAST 3 FULL BUSINESS DAYS PRIOR TO BEGINNING CONSTRUCTION LEAST 3 FULL BUSINESS DATS PHONT TO BEGINNING CONSTRUCTION ON EXCAVATION TO HAVE EXISTING UTILITIES LOCATED. CONTRACT OR SHALL CONTACT ANY LOCAL UTILITIES THAT PROVIDE THEIR OWN LOCATOR SERVICES INDEPENDENT OF "NC811". REPORT ANY DISCREPANCIES TO THE ENGINEER IMMEDIATELY. McAdams The John R. McAdams Company, Inc. 2905 Meridian Parkway

Durham, NC 27713 phone 919, 361, 5000 fax 919. 361. 2269 license number: C-0293, C-187

CLIENT KANE REALTY CORPORATION

4321 LASSITER AT NORTH HILLS AVENUE SUITE 250 RALFIGH, NORTH CAROLINA 27609



S DRIVE SITE PLAN DLINA, 27609 F & B 640 ST ALBANS C ADMINISTRATIVE SI RALEIGH, NORTH CAROLIN



REVISIONS

1 12. 22. 2022 RESPONSE TO 151 ASR COMMENTS
2 02. 27. 2023 RESPONSE TO 2ND ASR COMMENTS
5 03. 31. 2023 RESPONSE TO 3ND ASR COMMENTS

PLAN INFORMATION

PROJECT NO. FILENAME KAN19010-ASR-N1 CHECKED BY DRAWN BY JCS SCALE N/A

SHEET

DATE

PRELIMINARY DRAWING - NOT RELEASED FOR CONSTRUCTION

PROJECT NOTES C0.00

10. 19. 2022



DocuSign Envelope ID: A9F86845-6391-4258-A7F4-216239FDEF5B



December 8, 2022

Dillon Pitts
Kane Realty Corporation
4321 Lassiter at North Hills Ave, #250
Raleigh, NC 27609

RE: "Will Serve" Letter for Solid Waste and Recycling Services at F&B

In response to your request, this letter serves as confirmation that GFL Environmental is able to provide waste and recycling services for the proposed F&B project, located at 560 St. Albans Drive, Raleigh, North Carolina

We have reviewed the current proposed site plan and have no safety or collection concerns. If the project design changes, this letter is void and a new letter must be issued. Additionally, this letter is non-transferable.

Sincerely,

Melissa Dipon

Melissa Dixon
National Accounts Sales Executive
GFL Environmental
melissa dixon@gflenv.com

3301 Benson Drive, Suite 601, Raleigh, NC 27609 Tel: 919-325-3000 | gflenv.com

Know what's below. Call before you dig.

ALL CONSTRUCTION SHALL CONFORM WITH THE LATEST VERSION OF THE CITY OF RALEIGH AND NCDOT STANDARDS SPECIFICATIONS AND DETAILS.

CONTRACTOR SHALL NOTIFY 'NC811" (811) OR (1-900-432-4949) AT LEAST 3 FULL BUSINESS DAYS PRIOR TO BEGINNING CONSTRUCTION OR EXCAVATION TO HAVE EXISTING UTILITIES LOCATED. CONTRACTOR SHALL CONTACT ANY LOCAL UTILITIES THAT PROVIDE THEIR OWN LOCATOR SERVICES INDEPENDENT OF 'NC611'. REPORT ANY DISCREPANCIES TO THE ENGINEER IMMEDIATELY.



phone 919. 361. 5000 fax 919. 361. 2269 license number: C-0293, C-187

CLIENT

KANE REALTY CORPORATION
4321 LASSITER AT NORTH HILLS AVENUE
SUITE 250
RALEIGH, NORTH CAROLINA 27609



F&B 640 ST ALBANS DRIVE ADMINISTRATIVE SITE PLAN RALEIGH, NORTH CAROLINN, 27609



REVISIONS


NO.	DATE	
1	12. 22. 2022	RESPONSE TO 1st ASR COMMENTS
2	02, 27, 2023	RESPONSE TO 2ND ASR COMMENTS
3	03.31.2023	RESPONSE TO SRD ASR COMMENTS

PLAN INFORMATION

PROJECT NO. KAN-19100 FILENAME KAN19010-ASR-N1 CHECKED BY DRAWN BY SCALE N/A DATE 10. 19. 2022 SHEET

APPROVAL FORMS

C0.01

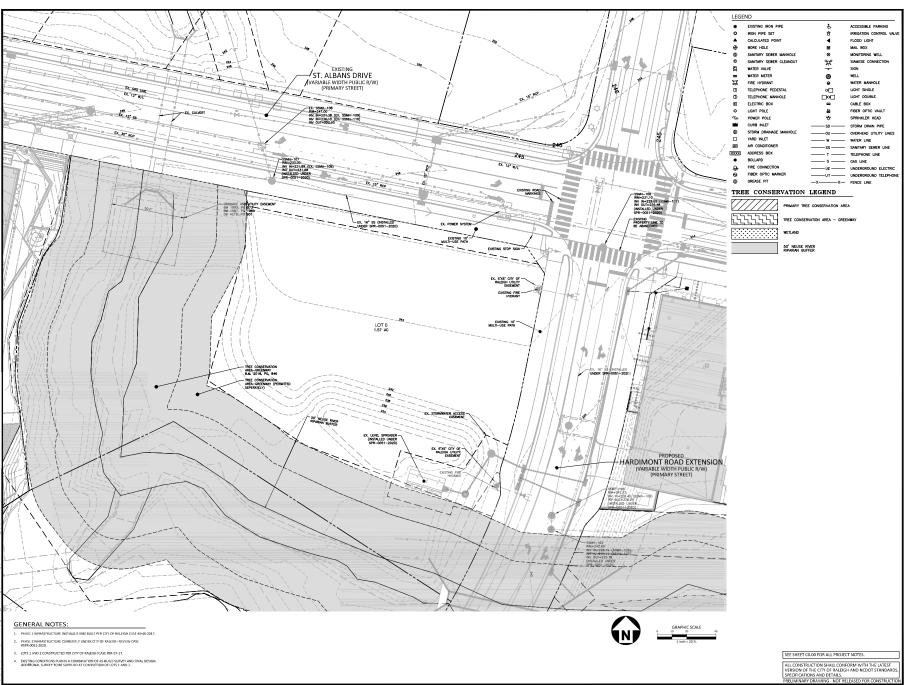



phone 919. 361. 5000 fax 919. 361. 2269 license number: C-0293, C-187

CLIENT

KANE REALTY CORPORATION
4321 LASSITER AT NORTH HILLS AVENUE
SUITE 250
RALEIGH. NORTH CAROLINA 27609

KANE REALTY CORPORATION

> **F & B** 640 ST ALBANS DRIVE ADMINISTRATIVE SITE PLAN RALEIGH, NORTH CAROLINA, 27609



REVISIONS

 NO.
 DATE

 1
 12, 22, 2022
 RESPONSE TO 1st ASR COMMENTS

 2
 02, 27, 2023
 RESPONSE TO 3ND ASR COMMENTS


 3
 03, 31, 2023
 RESPONSE TO 3ND ASR COMMENT

PLAN INFORMATION

PROJECT NO. KAN-19100
FILENAME KAN19010-ASR-XC1
CHECKED BY JB
DRAWN BY JCS
SCALE 1"=20"
DATE 10. 19. 2022
SHFFT

EXISTING CONDITIONS

C1.00

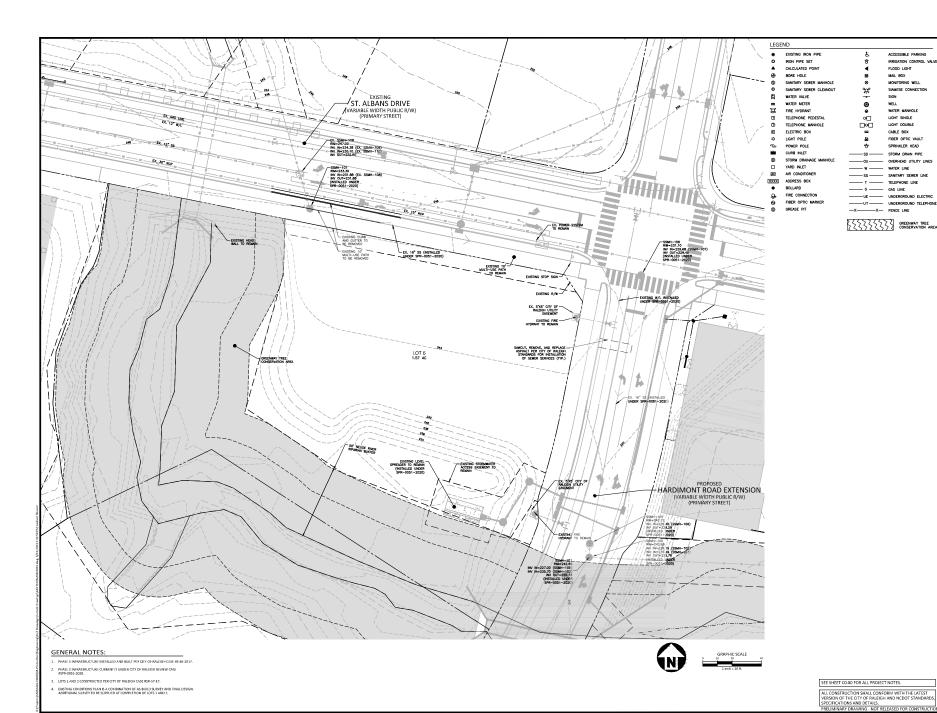

The John M. McAdams Company, Inc.
290s Meridian Parkway
Durham, N. C. 27733
phone 919. 361. 2600
fax 919. 361. 2600
license number: C. 0293, C-187
www.mcadamsco.com

CLIENT

KANE REALTY CORPORATION
4321 LASSITER AT NORTH HILLS AVENUE
SUITE 250
RALFIGH. NORTH CAROLINA 27609

KANE REALTY CORPORATION

> **F & B** 640 ST ALBANS DRIVE ADMINISTRATIVE SITE PLAN RALEIGH, NORTH CAROLINA, 27609



REVISIONS

ND. DATE

1 12, 22, 2022 RESPONSE TO 1st ASR COMMENTS
2 02, 27, 2023 RESPONSE TO 2ND ASR COMMENTS
3 03, 31, 2023 RESPONSE TO 3RD ASR COMMENTS


PLAN INFORMATION

PROJECT NO. KAN-19100
FILENAME KAN19010-ASR-DM1
CHECKED BY JB
DRAWM BY JCS
SCALE 1"=20"
DATE 10. 19. 2022

SHEET

DEMOLITION PLAN

C1.01

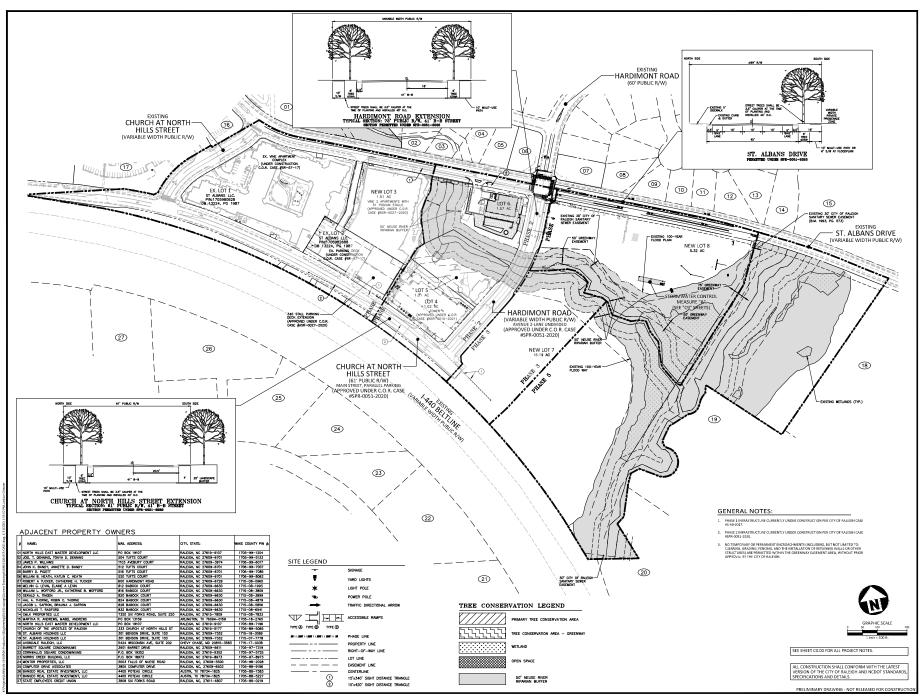



The John R. McAdams Company, Inc. 2905 Meridian Parkway Durham, NC 27713

phone 919. 361. 5000 fax 919. 361. 2269 license number: C-0293, C-187

CLIENT

LIENI

KANE REALTY CORPORATION
4321 LASSITER AT NORTH HILLS AVENUE
SUITE 250
RALEIGH, NORTH CAROLINA 27609



F&B 640 ST ALBANS DRIVE ADMINISTRATIVE SITE PLAN RALEIGH, NORTH CAROLINA, 27509



REVISIONS

NO. DATE

1. 12, 22, 2022 RESPONSE TO BY ASK COMMENTS
2. 02, 27, 2023 RESPONSE TO DATA ASK COMMENTS
2. 02, 31, 3023 RESPONSE TO AND ASK COMMENTS
2. 02, 31, 3023 RESPONSE TO AND ASK COMMENTS


PLAN INFORMATION

PROJECT NO. KAN-19100
FILENAME KAN19010-ASR-DAS1
CHECKED BY JB
DRAWN BY JCS
CALE 1"=100"
DATE 10. 19. 2022

SHEET

OVERALL SITE PLAN

C2.00

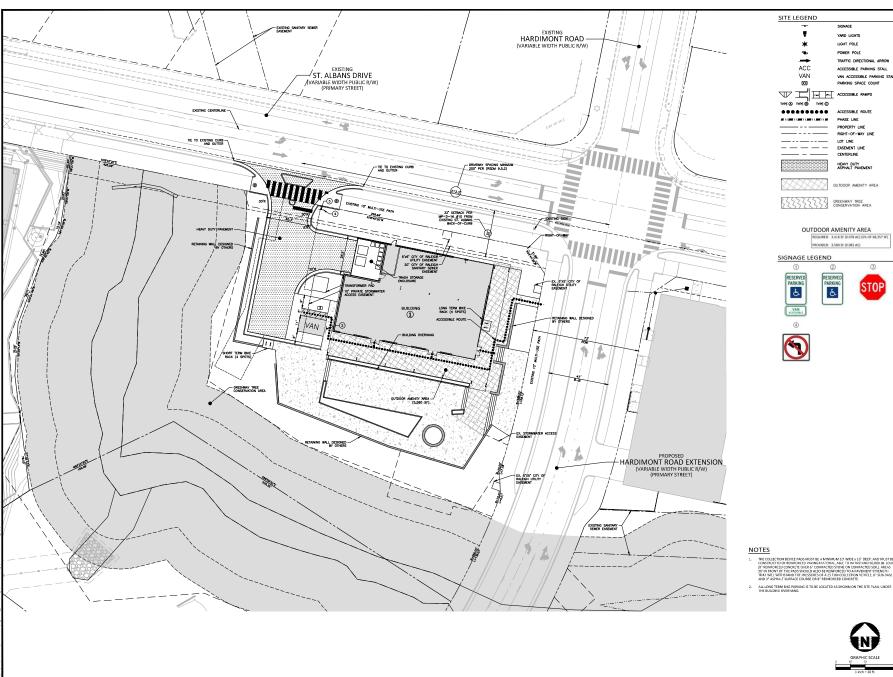



KANE REALTY CORPORATION 4321 LASSITER AT NORTH HILLS AVENUE

CLIENT

SUITE 250 RALFIGH. NORTH CAROLINA 27609

VAN ACCESSIBLE PARKING STALL PARKING SPACE COUNT

TRAFFIC DIRECTIONAL ARROW

ACCESSIBLE PARKING STALL

LIGHT POLE POWER POLE

TYPE ® TYPE ® ******** PHASE LINE PROPERTY LINE RIGHT-OF-WAY LINE

LOT UNE EASEMENT LINE HEAVY DUTY ASPHALT PAVEMENT

OUTDOOR AMENITY AREA

SIGNAGE LEGEND

SITE LEGEND

ACC

VAN

XX





PRELIMINARY DRAWING - NOT RELEASED FOR CONSTRUC







F & B 640 ST ALBANS DRIVE ADMINISTRATIVE SITE PLAN RALEIGH, NORTH CAROLINA, 27609


REVISIONS

PLAN INFORMATION

PROJECT NO. FILENAME KAN19010-ASR-S1 CHECKED BY DRAWN BY SCALE 1"=20" DATE 10. 19. 2022 SHEET

SITE PLAN

C2.01

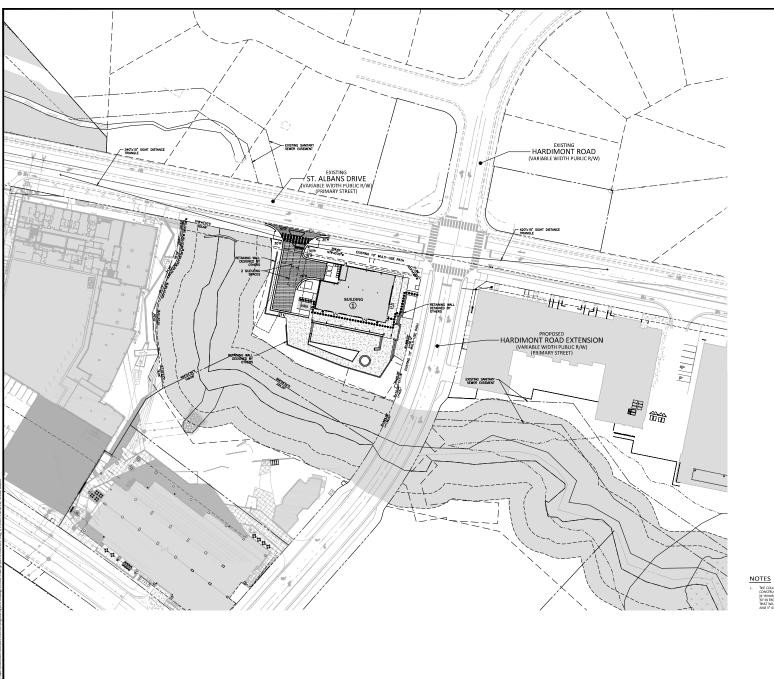

The John R. McAdams Company, Inc. 2905 Meridian Parkway Durham, NC 27713 VAN ACCESSIBLE PARKING STALL

CLIENT

phone 919. 361. 5000 fax 919. 361. 2269 license number: C-0293, C-187

KANE REALTY CORPORATION
4321 LASSITER AT NORTH HILLS AVENUE
SUITE 250
RALEIGH, NORTH CAROLINA 27609

PARKING SPACE COUNT

LIGHT POLE POWER POLE

TRAFFIC DIRECTIONAL ARROY ACCESSIBLE PARKING STALL

TYPE ® TYPE ® ********

SITE LEGEND

ACC

VAN

XX

PHASE LINE PROPERTY LINE RIGHT-OF-WAY LINE LOT UNE EASEMENT LINE HEAVY DUTY ASPHALT PAVEMENT

OUTDOOR AMENITY AREA REQUIRED: 6,836 SF (0.16 AC) PROVIDED: 7,000 SF (0.16 AC)

SIGNAGE LEGEND







KANE REALTY CORPORATION **F & B** 640 ST ALBANS DRIVE ADMINISTRATIVE SITE PLAN RALEIGH, NORTH CAROLINA, 27609



REVISIONS


PLAN INFORMATION

SHEET

FILENAME KAN19010-ASR-S1 CHECKED BY DRAWN BY JCS SCALE 1"=40" DATE 10. 19. 2022

SITE DISTANCE TRIANGLE PLAN



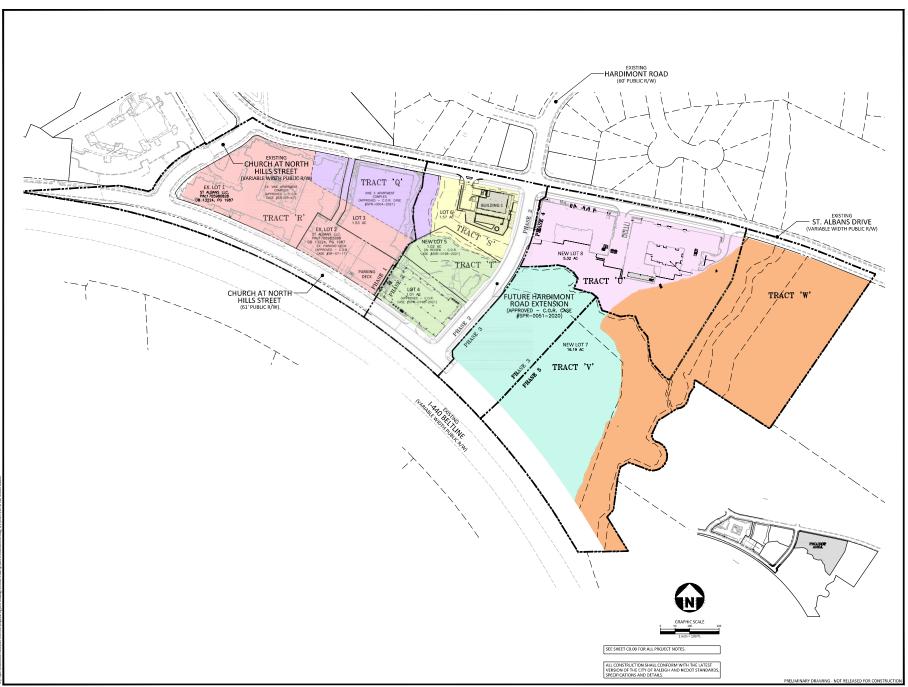



The John R. McAdams Company, Inc. 2905 Meridian Parkway Durham, NC 27713

phone 919. 361. 5000 fax 919. 361. 2269 license number: C-0293, C-187

CLIENT

KANE REALTY CORPORATION
4321 LASSITER AT NORTH HILLS AVENUE
SUITE 250
RALEIGH, NORTH CAROLINA 27609

ALEIGH, NORTH CAROLINA 27609

KANE REALTY CORPORATION

> **F & B** 640 ST ALBANS DRIVE ADMINISTRATIVE SITE PLAN RALEIGH, NORTH CAROLINA, 27609



REVISIONS


| NO. DATE | | 1 | 12, 22, 2022 | RESPONSE TO 1st ASR COMMENT: | 2 | 02, 27, 2023 | RESPONSE TO 3ND ASR COMMENT: | 3 | 03, 31, 2023 | RESPONSE TO 3ND ASR COMMENT: |

PLAN INFORMATION

PROJECT NO. KAN-19100
FILENAME KAN19100-ASR-OAS2
CHECKED BY AP
DRAWN BY CGH
SCALE 1"=100'
DATE 10.19.2022

SHEET
OVERALL DEVELOPMENT
TRACKING PLAN

C2.03

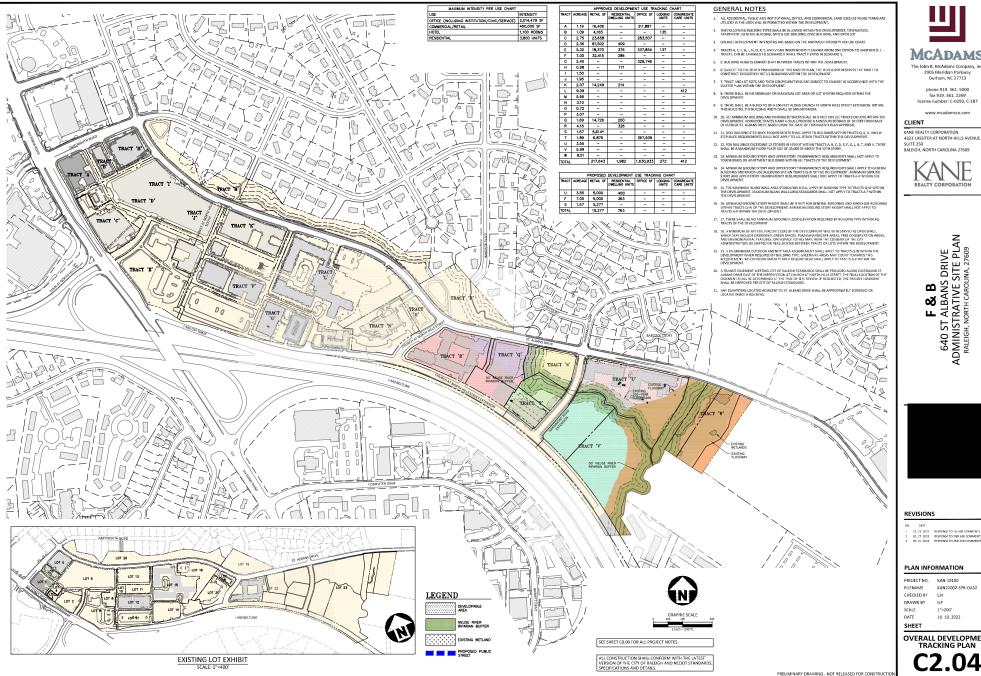



The John R. McAdams Company, Inc. 2905 Meridian Parkway Durham, NC 27713

phone 919, 361, 5000 fax 919. 361. 2269 license number: C-0293, C-187

KANE REALTY CORPORATION

F&B 640 ST ALBANS DRIVE ADMINISTRATIVE SITE PLAN RALEIGH, NORTH CAROLINA, 27609



REVISIONS


PLAN INFORMATION

PROJECT NO. FILENAME KAN22002-SPR-OAS2 CHECKED BY ЦV DRAWN BY SCALE 1"=200'

10. 19. 2022 SHEET

OVERALL DEVELOPMENT TRACKING PLAN

C2.04

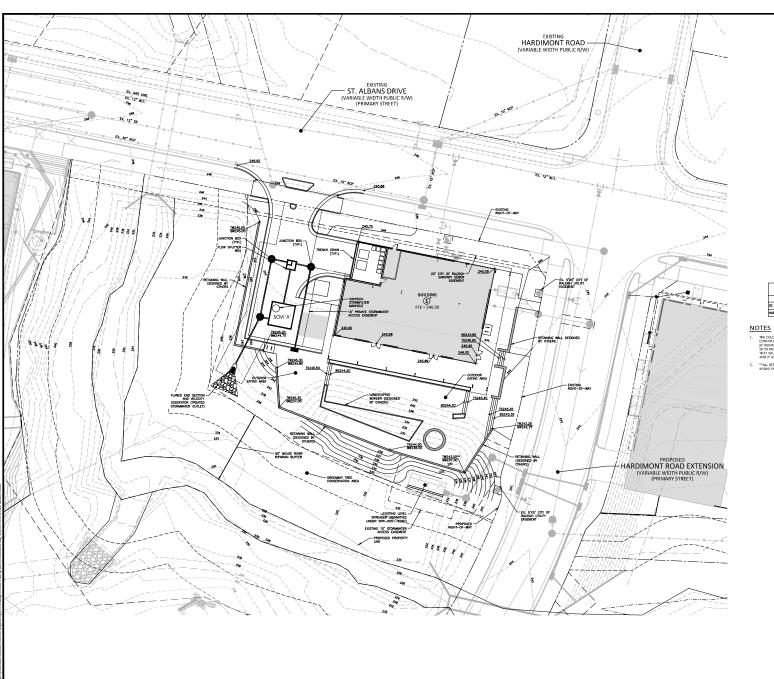

FLARED END SECTION ENDWALL SECTION CATCH BASIN DROP INLET STORM SERVICE INLET STORM SERVICE ROOF-DR The John R. McAdams Company, Inc. 2905 Meridian Parkway Durham, NC 27713 JUNCTION BOX DRAINAGE FLOW ARRO LINE BREAK SYMBOL phone 919. 361. 5000 fax 919. 361. 2269 license number: C-0293, C-187 TOP & BOTTOM CURB ELEVATION

TW-223.00 TOP OF WALL ELEVATION
BW-213.00 BOTTOM OF WALL ELEVATION
(NOTE: BOTTOM OF WALL IS GROUN
ELEVATION NOT WALL FOUNDATION) RD— ROOF DRAIN, 8" ADS NON-PERFORATED TUBING OR EQUAL 1.0% MIN, SLOPE 3' MIN, COVER PVC SCHEDULE 40 IN TRAFFIC AREAS

-LD---- LIMITS OF DISTURBANCE

WOODED AREA 250 MAJOR CONTOUR MINOR CONTOUR

EXISTING MAJOR CONTOUR 252 250 252 EXISTING MINOR CONTOUR — — — — EASEMENT LINE

ACCESSIBLE PARKING AREA (2% MAX, SLOPE IN ALL DIRECTK

GREENWAY TREE CONSERVATION AREA

GRADING LEGEND

250.50 250.00

AVERAGE GRADE TABLE - BUILDING 1			
	HIGH ELEV.	LOW ELEV.	AVERAGE
ST. ALBANS DRIVE	245.70	245.09	245.40
HARDIMONT ROAD	246.00	245.09	245.55

- **ALL RETAININGS WALLS WITHIIN 30' OF RIGHT-OF-WAY SHALL BE LESS THAN 10' IN HEIGHT PER UDO 7.2.8.D.1

CLIENT

KANE REALTY CORPORATION 4321 LASSITER AT NORTH HILLS AVENUE SUITE 250 RALFIGH. NORTH CAROLINA 27609

KANE REALTY CORPORATION

F & B 640 ST ALBANS DRIVE ADMINISTRATIVE SITE PLAN RALEIGH, NORTH CAROLINA, 27609



REVISIONS

PLAN INFORMATION


PROJECT NO. FILENAME KAN19010-ASR-G1 CHECKED BY DRAWN BY SCALE 1"=20" DATE 10. 19. 2022

SHEET

GRADING AND STORM DRAINAGE PLAN

C3.00

PRELIMINARY DRAWING - NOT RELEASED FOR CONSTRUCT

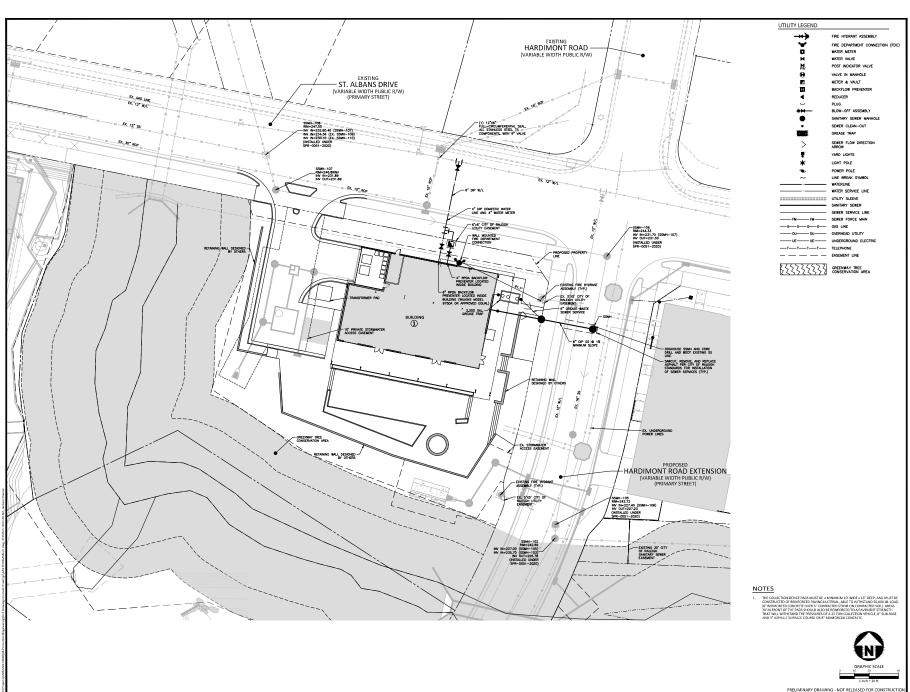



phone 919. 361. 5000 fax 919. 361. 2269 license number: C-0293, C-187

CLIENT

KANE REALTY CORPORATION 4321 LASSITER AT NORTH HILLS AVENUE SUITE 250 RALEIGH, NORTH CAROLINA 27609

KANE REALTY CORPORATION

> **F & B** 640 ST ALBANS DRIVE ADMINISTRATIVE SITE PLAN RALEIGH, NORTH CAROLINA, 27609



REVISIONS

| NO. DATE | | 1 | 12, 22, 2022 | RESPONSE TO 1st ASK COMMENT | 2 | 02, 27, 2023 | RESPONSE TO 200 ASK COMMEN | 3 | 03, 31, 2023 | RESPONSE TO 200 ASK COMMEN |


PLAN INFORMATION


PROJECT NO. KAN-19100
FILENAME KAN19010-ASR-U3
CHECKEB BY JB
DRAWN BY JCS
SCALE 1"=20"
DATE 10.19.2022


SHEET


UTILITY PLAN


C4.00

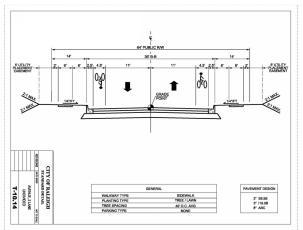


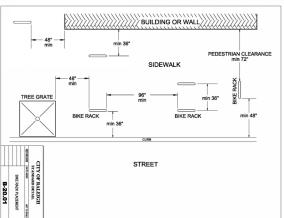

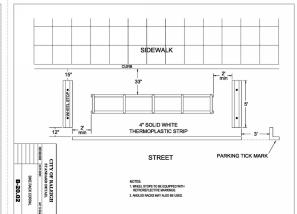

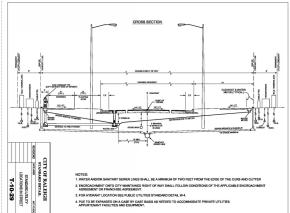

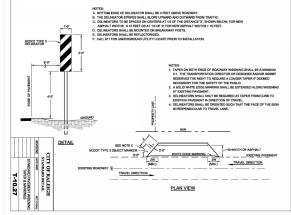

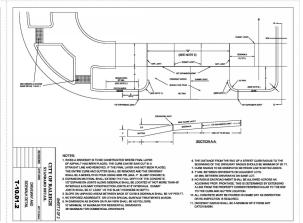

ALL CONSTRUCTION SHALL CONFORM WITH THE LATEST VERSION OF THE CITY OF RALEIGH AND NODOT STANDARDS SPECIFICATIONS AND DETAILS.

The John R. McAdams Company, Inc. 2905 Meridian Parkway Durham, NC 27713

phone 919. 361. 5000 fax 919. 361. 2269 license number: C-0293, C-187

CLIENT KANE REALTY CORPORATION 4321 LASSITER AT NORTH HILLS AVENUE RALFIGH. NORTH CAROLINA 27609

SLIITE 250

KANE REALTY CORPORATION

F & B 640 ST ALBANS DRIVE ADMINISTRATIVE SITE PLAN RALEIGH, NORTH CAROLINA, 27609




REVISIONS

PLAN INFORMATION

FILENAME KAN19010-ASR-D1 CHECKED BY DRAWN BY SCALE 10. 19. 2022 DATE SHEET

SITE DETAILS

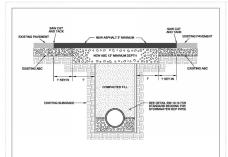

- The Private of Transport Ideal (Incl. But Owners of a Transport Ideal Private Order Private Order Orde

- DRECTION OF DEBIDIORS.


 AT HE ENTIRE PROCREEMENTATION, EDGE OF THE CUT SHALL, BE TAKED.

 3. THE SAME ENTIRE OF PROCREEMENT AND ENTIRE, WHICH ENTER SHALL BE RENETALLED, BUT IN NO CASE SHALL.


 5. THE SAME ENTIRE PROTRICES THE SHALL BE RESILLED, AND COMPACTED THOROUGHLY AND ROLLED WITH A SMOOTHSHALLED CHARLED OF SHARLED, AND ENTIRE SHALLED. AND COMPACTED THOROUGHLY AND ROLLED WITH A SMOOTHSHALLED CHARLED OF SHARLED SHOOTH, LEGISLE, AND ENTIRE SHALLED.


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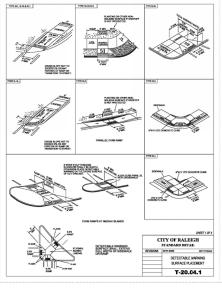


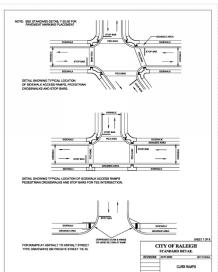



CITY OF RALEIGH CURB RAMPS GENERAL NOTES

- CITY OF RALEIGH STANDARD CURB RAMPS HAVE BEEN DEVELOPED IN ACCORDANCE WITH THE AMERICANS WITH DISABILITIES ACT (ADA) AND PUBLIC RIGHT OF WAY ACCESS GUIDELNES (PROWAG).
- CURB RAMPS SHALL BE PROVIDED AT LOCATIONS AS SHOWN ON THE PLANS OR A DIRECTED BY THE ENGINEER. SIDEMUL ACCESS RAMPS SHALL BE LOCATED AS INDICATED IN THE DETAIL, HOWEVER, THE LOCATION MAY BE ADJUSTED IN CORDINATION WITH THE CITY OF PALBIGHYMERE ENSTING LIGHT POLES, FIRE HYDRANTS, DROP INLETS, ETC, AFFECT PLACEMENT.
- DOUBLE WHEELCHAIR RAMPS ARE TO BE INSTALLED AT ALL PUBLIC STREET INTERSECTIONS WHERE SIDEWALK IS REQUIRED.
- THE WALKING SURFACE SHALL BE SLIP RESISTANT. THE COLOR FOR THE DETECTABLE WARNING AREA SHALL BE YELLOW FOR CONTRAST.
- NO SLOPE ON THE SIDEWALK ACCESS RAMP SHALL EXCEED 1°FT (12:1) IN RELATIONSHIP TO THE GRADE OF THE STREET.
- IN NO CASE SHALL THE WIDTH OF THE SIDEWALK ACCESS RAMP BE LESS THAN 48° ALL RAMPS SHALL BE INSTALLED THE SAME WIDTH AS THE SIDEWALK.
- USE CLASS A (3000 PSI) CONCRETE WITH A SIDEWALK FINISH IN ORDER TO OBTAIN A ROUGH NONSKID SURFACE.
- A 1/2" EXPANSION JOINT INSTALLED FULL DEPTH WILL BE REQUIRED WHERE THE CONCRETE SIDEWALK ACCESS RAMP JOINS THE CURB AND ALSO WHERE NEW CONCRETE ABUTS EXISTING CONCRETE.
- 9. CURB RAMPS SHOULD BE PLACED PARALLEL TO THE DIRECTION OF TRAVEL

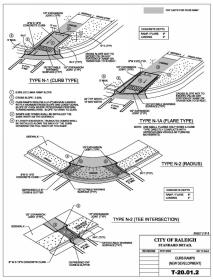

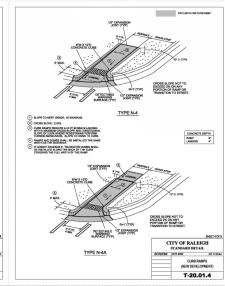

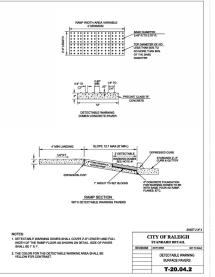

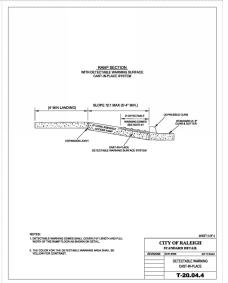

ALL CONSTRUCTION SHALL CONFORM WITH THE LATEST VERSION OF THE CITY OF RALEIGH AND NCDOT STANDARDS SPECIFICATIONS AND DETAILS.

MCADAMS The John R. McAdams Company, Inc. 2905 Meridian Parkway

Durham, NC 27713 phone 919, 361, 5000 fax 919, 361, 2269 license number: C-0293, C-187

CLIENT KANE REALTY CORPORATION

4321 LASSITER AT NORTH HILLS AVENUE SUITE 250 RALFIGH, NORTH CAROLINA 27609



F & B 640 ST ALBANS DRIVE ADMINISTRATIVE SITE PLAN RALEIGH, NORTH CAROLINA, 27609





REVISIONS


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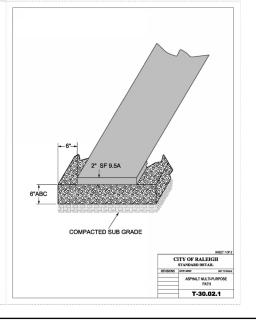
PROJECT NO. FILENAME KAN19010-ASR-D1 CHECKED BY DRAWN BY SCALE 10. 19. 2022 DATE SHEET

SITE DETAILS



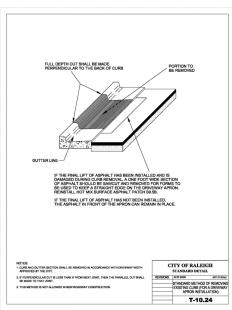

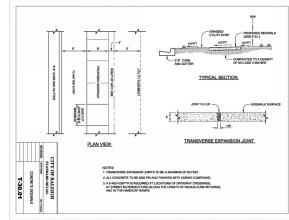

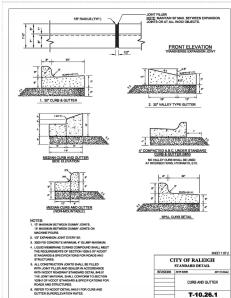

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CLIENT

KANE REALTY CORPORATION 4321 LASSITER AT NORTH HILLS AVENUE SUITE 250 RALEIGH, NORTH CAROLINA 27609



F & B640 ST ALBANS DRIVE
ADMINISTRATIVE SITE PLAN
RALEIGH, NORTH CAROLINA, 27609





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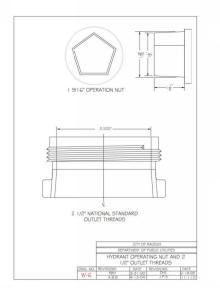
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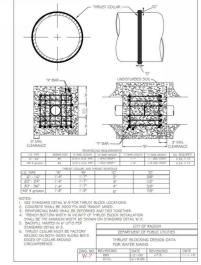
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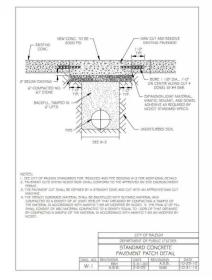
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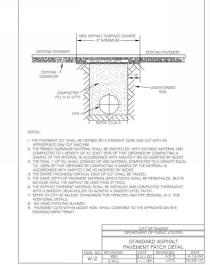










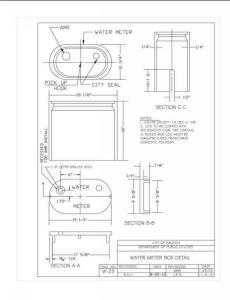

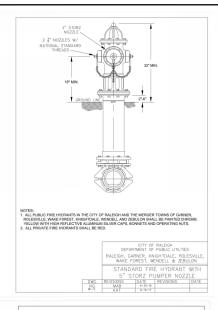

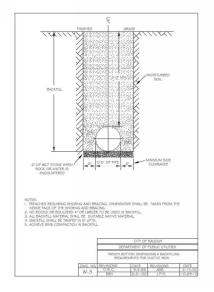

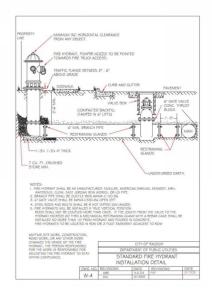

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CLIENT

KANE REALTY CORPORATION
4321 LASSITER AT NORTH HILLS AVENUE
SUITE 250
RALEIGH, NORTH CAROLINA 27609



F & B 640 ST ALBANS DRIVE ADMINISTRATIVE SITE PLAN RALEIGH, NORTH CAROLINA, 27609



REVISIONS


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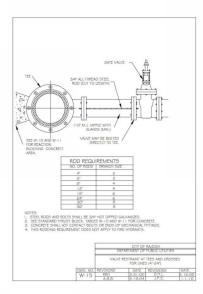
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3 03. 31. 2023 RESPONSE TO 3RD ASR COM


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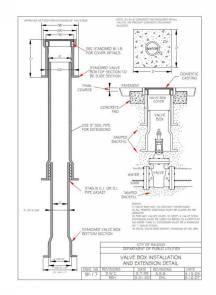
PROJECT NO. KAN-19100
FILENAME KAN19010-ASR-D1
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DRAWN BY JCS
SCALE N/A
DATE 10. 19. 2022
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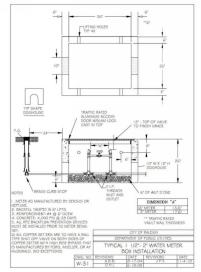
WATER DETAILS










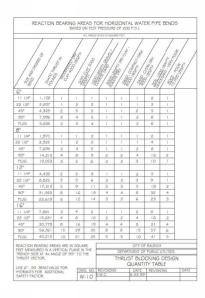

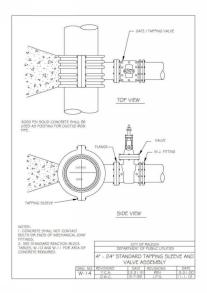

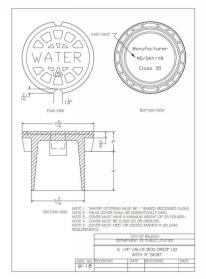

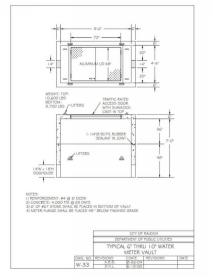

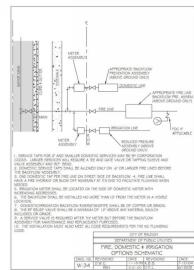

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CLIENT

KANE REALTY CORPORATION 4321 LASSITER AT NORTH HILLS AVENUE SUITE 250 RALEIGH, NORTH CAROLINA 27609



F & B 640 ST ALBANS DRIVE ADMINISTRATIVE SITE PLAN RALEIGH, NORTH CAROLINA, 27609



REVISIONS


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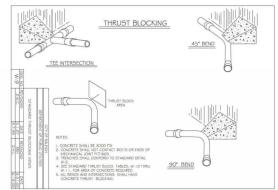
1 12, 22, 2022 RESPONSE TO 1st ASR COMMI 2 02, 27, 2023 RESPONSE TO 2ND ASR COMM 3 03, 31, 2023 RESPONSE TO 3RD ASR COMM


PLAN INFORMATION

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FILENAME KAN19010-ASR-D1
CHECKED BY JB
DRAWN BY JCS
SCALE N/A
DATE 10. 19. 2022
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WATER DETAILS





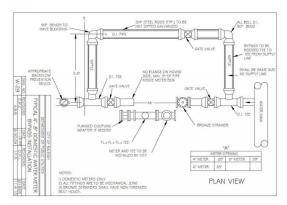
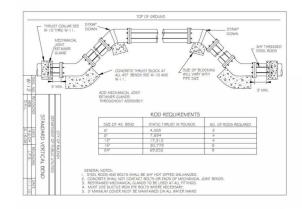
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F & B 640 ST ALBANS DRIVE ADMINISTRATIVE SITE PLAN RALEIGH, NORTH CAROLINA, 27609



REVISIONS


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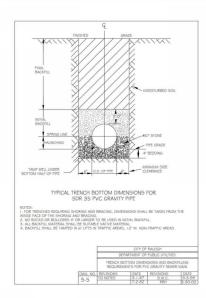
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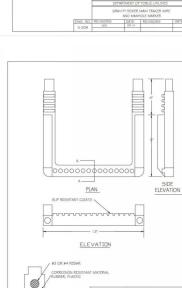
SHEET WATER DETAILS

C8.05

ALL CONSTRUCTION SHALL CONFORM WITH THE LATEST VERSION OF THE CITY OF RALEIGH AND NCDOT STANDARDS, SPECIFICATIONS AND DETAILS.







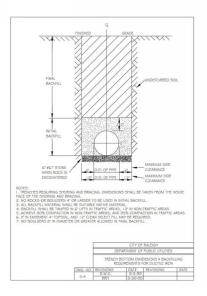



STANDARD SLIP RESISTANT

MANHOLE STEP DETAIL

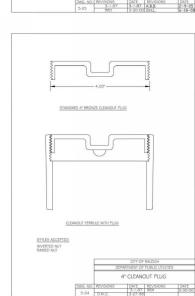

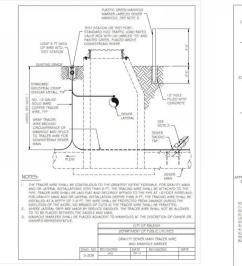

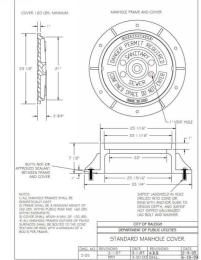

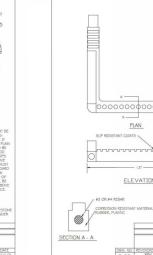





phone 919, 361, 5000 fax 919. 361. 2269 license number: C-0293, C-187

CLIENT KANE REALTY CORPORATION

4321 LASSITER AT NORTH HILLS AVENUE SUITE 250 RALFIGH, NORTH CAROLINA 27609



F & B 640 ST ALBANS DRIVE ADMINISTRATIVE SITE PLAN RALEIGH, NORTH CAROLINA, 27609



REVISIONS

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п	2	02. 27. 2023	RESPONSE TO 2ND ASR COMME
	3	03, 31, 2023	RESPONSE TO 3RD ASR COMMEN

PLAN INFORMATION


PROJECT NO. FILENAME KAN19010-ASR-D1 CHECKED BY DRAWN BY SCALE 10. 19. 2022 DATE SHEET

SANITARY SEWER DETAILS

C8.06

PRELIMINARY DRAWING - NOT RELEASED FOR CONSTRUCTIO

ALL CONSTRUCTION SHALL CONFORM WITH THE LATEST VERSION OF THE CITY OF RALEIGH AND NCDOT STANDARDS, SPECIFICATIONS AND DETAILS.

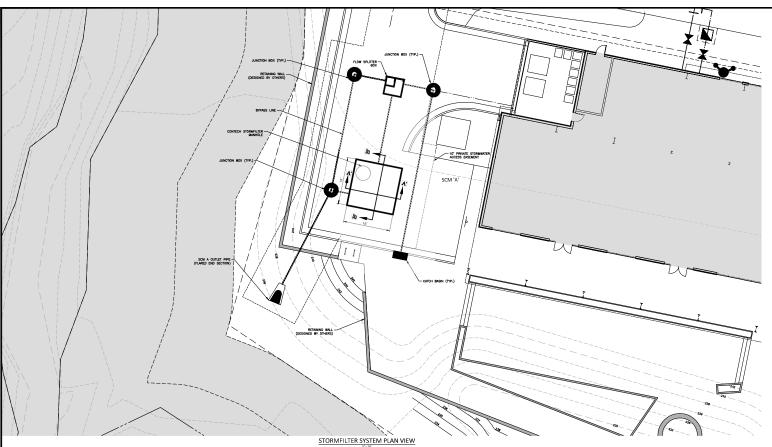

GENERAL NOTES

- PRIOR TO CONSTRUCTION, ANY DISCREPANCIES IN THE PLANS AND NOTES SHALL BE BROUGHT TO THE ENGINEER'S ATTENTION
- THE FACILITY SHALL NOT BE USED AS A TEMPORARY EROSION CONTROL DEVICE (I.E. SEDIMENT TRAP OR SEDIMENT BASIN) DURING CONSTRUCTION.
- THE TOTAL AND AS CLOSE AS TERMONED PRODUCT OF THE TOTAL PRODUCT OF THE T
- ONCE CONSTRUCTED, THE STORMFILTER CARTRIDGES SHALL NOT RECEIVE STORMWATER RUNOFF UNTIL THE ENTIRE CONTRIBUTING DRAINAGE AREA TO THE UNDERGROUND SYSTEM HAS BEEN COMPLETELY STABILIZED AND SITE CONSTRUCTION IS COMPLETE.
- ALL COMPONENTS OF THE UNDERGROUND SCAN SYSTEM (DON'T, RISHE CONNECTIONS, FINCAPS, ACCESS MARHOLES, ETC.) SHALL BE DESIGNED BY OTHERS ANY WARRATIONS OR CHANGES MADE FROM THESE SPECIFICATIONS AND DRAWNINGS DURINGS THE ORDERING AND/OR INSTALLATION OF ALL COMPONENTS HIS MASS PROPRIOT OF THE COMPONENTS HIS MASS FINCAPING, DISSING OF THE UNDERGROUND COSA, AND WARTH SANSAMER TO COMPONENT HIS MASS FOR THE COST OF THE COST AND ANY OTHER STANDARD AND AND ANY OTHER STANDARD AND ANY OTHER
- ALL PPE/RISER CONNECTIONS AND JOINTS ASSOCIATED WITH THE STORM FILTER SYSTEM AND UNDERGROUND DETENTION PIPE SHALL BE WATER TIGHT. THE MECHANISM FOR ACHIEVING THIS SHALL BE SUBMITTED TO THE DESIGN ENGINEER FOR REVIEW.
- 8. THE CONTRACTOR SHALL FURNISH, INSTALL, OPERATE, AND MAINTAIN ANY PUMPING EQUIPMENT, ETC. NEEDED FOR REMOVAL OF WATER FROM VARIOUS PARTS OF THE SAMO RITHER SYSTAM SIRE. IT IS ARTHURFURD TO HET PUMPING WILL BE RECESSARY IS THE EXCLARATION AREAS, DURING THE PUMPING HER PUMPING H
- . IT SHALL BE THE RESPONSIBILITY OF THE CONTRACTOR TO ADHERE TO ALL CURRENT OSHA REGULATIONS FOR CONFINED SPACE ENTRY AND PROVIDE SUCH DURING ENGINEER WALK-THROUGH/INSPECTION.
- ALL PIPE PENETRATIONS THROUGH A CONCRETE OR CMP STRUCTURE (I.E. STORMPILTER CARTRIDGE / DETENTION SYSTEM, STORM DRAINAGE MAMHOLES, ETC.) SHALL BE MADE WATERTIGHT USING NON-SHRINK CEMENTIOUS GROUT.
- 13. ACCES INMEDIAS FOLL RECLIFIC LIBERGE OF MANNOL STEPS, IF, IT MAY ACCES FOR TAMBORS STEPS WOULD SIGN THAT I'VE GRAFTE OFFER IT ALDERS WHILE PROPRIORS IN SUCH, ALDERS SHALL BE GRAEFED AT IL, MARKERS ACCESS FORMS THE STEP SHALL RELIGIOUS AND ALL LIBERGE SHALL RECLIFE AT INTERFERENCE AND STEELENING SECTION THAT ALLOHOS THE LLODGE TO BE DYTERIED ADDREST DISCHAUST. ALL LIBERGE TO BE DYTERIED ADDREST TO SHOW AN AVERAGE PROPRIOR.

FOUNDATION NOTES

- IF THE FOUNDATION SUBGRADE WILL BE EXPOSED FOR AN EXTENDED PERIOD DURING CONSTRUCTION, THEN IT SHOULD BE GRADED TO A SLIGHT SLOPE SLICH THAT SATURATION OF THE SUBGRADE DOES NOT OCCUR.
- THE CONTRACTOR SHALL PURBLISH, BISTALL, OPERATE, AND MAINTAIN ANY PUMPING EQUIPMENT, ETC. MEDIET POR REMOVAL OF WATER FROM THE SECANATION. IT IS BEST TO BEIGN THE CONSTRUCTION OF THE SAND RETREFERENTION SYSTEMS AT THE DOWNSTREAM END WITH THE OUTLET ALREADY CONSTRUCTED TO ALLOW A DOUTLET OR WATER TO SECAPE.
- THE CHIEF CONTECNING A INSMITE SMALL BETTEMBER IF FORWARDS BORNE ARE REQUIRED FOR THE MINERICOURD SMALL SETTIME. HE SCORE
 SMALL SOFTER FORWARDS HE FOR TERROMATION FOR REQUIRED, THE FORWARDS SMALL SOFTER FOR SMALL SMALL SMALL STEEP
 ONSITE GENT-CHIEF CONTECTION FOR SMALL SMALL

- . THE EXCAVATION SUB GRADE MUST BE TRANSIT LEVEL.
- THE EXCAVATION PIT SHALL BE UNED (ON THE BOTTOM AND ALL FOUR SIDES) WITH A NON-WOVEN GEO-TEXTILE (GEOTEX 401 OR APPROVED EQUIVALENT). THE ONSITE GEOTECHNICAL ENGINEER SHALL APPROVE FARRIC FOR USE.
- THE SUBGRADE FOR THE DETENTION SYSTEM ON BE A CONCRETE SLAB, OR CLEAN GRANULAR MATERIAL WITH A MAXIMUM AGGREGATHE BEDDING STALL BE FREE FROM ROCK FORMATIONS, PROTIKUDING STONES, PROZEN LUMPS, RODTS, AND OTHER FOREIGN MATERIA
- PREPARE THE SUBGRADE PER THE ONSITE GEOTECHNICAL ENGINEER'S DIRECTION (APPROXIMATELY 5-6" BELOW GRADE ON WHICH SLAB WILL SET). THE BEDDING MATERIAL SHOULD BE GRADED SUCH THAT A SMOOTH UNIFORM GRADE IS ESTABLISHED TO ALLOW FOR OPTIMUM PLACEMENT OF THE SANCE.

STORMFILTER VAULT CONSTRUCTION NOTES

- ASSOLUTELY NO RUNOFF SHALL ENTER THE STORMFREE CONTROL MEASURE UNTIL ALL CONTRIBUTING DRAINAGE AREAS HAVE BEEN STABILIZED.
- MANINCE ACCESS SHALL BE PROVIDED FOR THE STORMFILTER CONTROL MEAGURE MANINCLES SHALL BE IN COMPLIANCE INTH CIT OF RAIL FOR STANDARD DETAILS BET SHALL BE A MANILAUD OF A INCHES IN POMERTER TO COMEN' WITH COHAC CONTROL SHACL REQUIREMENTS (OR MANIAUM CHAN REQUIREMENTS APPLICABLE AT TIME OF CONSTRUCTING CONTRACTOR SHALL PROVIDE ACCESS LAGGRES FOR ACCESS BELOW ALL MANINCLES. MANIFOLD CONTROL SHALL ALLOW FOR PROFER WHILL ARROW.

STORMWATER SYSTEM MATERIAL SPECIFICATIONS

- THE UNDERGROUND SOM UNITS ARE TO BE DESIGNED BY OTHERS, ANY CHANGES TO THE APPROVED PLANS SHALL BE PROVIDED TO THE DESIGN ENGINEER PRIOR TO INSTALLATION FOR REVIEW.
- ACCESS RISERS SHALL BE INSTALLED PER MANUFACTURE SPECIFICATIONS. ACCESS STEPS / LADDERS SHALL BE ATTACHED TO THE RISERS TO ALLOW FOR ACCESS INTO THE UNDERGROUND SCM SYSTEM.
- DANGOWIN OF THE STEMMENT EXAMPLES OF SEC. AND DITTET THE VIOLET IS AN ANY OF THE OLD ASSETT THE CALLES CARLE AS AND ASSETT THE OLD ASSETT THE CALLES CARLE AS AND ASSETT THE CALLES CARLES CARL
- THE RCP OUTLET BARREL SHALL BE CLASS BITRCP, MODIFIED BELL AND SPIGOT, MEETING THE REQUIREMENTS OF ASTM C76-LATEST. THE PIPE SHALL MAVE CONFINED O-RING RUBBER GASKET JOINTS MEETING ASTM C-449-LATEST. THE PIPE JOINTS SHALL BE TYPE R-4.
- GEOTECTILE FABRIC FOR THE OUTLET BARRELIOINTS SHALL BE MIRAFI 180N OR ENGINEER APPROVED EQUAL (NON-WOVEN FABRIC). THE ONSITE GEOTECHNICAL ENGINEER SHALL APPROVE FABRIC FOR USE.
- 6. ALL POURED CONCRETE SHALL BE MINIMUM 3000 PSI (28 DAY) UNLESS OTHERWISE NOTED.
- THE CONTRACTOR SHALL INSTALL THE UNDERGROUND SCM UNITS PER MANUFACTURERS' SPECIFICATIONS. CONTRACTOR TO PROVIDE A LETTER FROM MATERIAL SUPPLIERIS STATING MATERIALS MEET THE SPECIFIC STANDARDS PRIOR TO INSTALLATION.

- 1. THE ON-SITE GEOTECHNICAL ENGINEER SHALL SPECIFY THE BACKFILL MATERIAL FOR THE UNDERGROUND SCM SYSTEM.
- THE BACKFILL MATERIAL SHOULD BE FREE OF ROCKS, FROZEN LUMPS, AND OTHER FOREIGN MATTER THAT COULD CAUSE HARD SPOTS WITHIN THE BACKFILL MATERIAL, OR THAT COULD DECOMPOSE AND CREATE VOIDS.
- 3. HIGHLY PLASTIC SILTS, HIGHLY PLASTIC CLAYS, ORGANIC SILTS, ORGANIC CLAYS, AND PEATS SHOULD NOT BE USED AS A BACKFILL MATERIAL. THE BACKFILL MATERIAL SHOULD BE PLACED IN 6" LOOSE LIFTS AND COMPACTED TO 95% OF THE STANDARD PROCTOR MAXIMUM DRY DENSITY (ASTM-0608). THE FILL SOILS SHOULD BE COMPACTED AT A MOISTURE CONTENT WITHIN 4/- TWO PERCENT OF ITS OPTIMUM MOISTURE CONTENT.
- 5. ANY MATERIAL STOCKPILING ON TOP OF THE UNDERGROUND SCM SYSTEM SHALL BE APPROVED BY THE STRUCTURAL DESIGN ENGINEER.

STATEMENT OF RESPONSIBILITY

ALL REQUIRED MAINTENANCE AND INSPECTIONS OF THIS FACILITY SHALL BE THE RESPONSIBILITY OF THE PROPERTY OWNER, PER THE
EXPORTED OPERATION AND MAINTENANCE ACREEMENT FOR THIS FACILITY



CLIENT

KANE REALTY CORPORATION 4321 LASSITER AT NORTH HILLS AVENUE SUITE 250 RALFIGH, NORTH CAROLINA 27609

KANE

S DRIVE SITE PLAN DLINA, 27609 F & B 640 ST ALBANS D ADMINISTRATIVE SI RALEIGH, NORTH CAROLIN



REVISIONS

PLAN INFORMATION

PROJECT NO. KAN-19100 FILENAME CHECKED BY

DRAWN BY SCALE 10. 19. 2022

DATE SHEET

ALL CONSTRUCTION SHALL BE IN ACCORDANCE WITH THE CURRENT CITY OF RALEIGH ENGINEERING DESIGN AND CONSTRUCTION STANDARDS.


SCM CERTIFICATIONS AND AS-BUILT PLANS MUST BE PROVIDED TO STORMWATER CONTROL INSPECTOR, FOR REVIEW, 7 DAYS PRIOR TO FINAL INSPECTION.


CERTIFICATIONS AND AS-BUILT PLANS MUST BE

ACCEPT PRIOR TO FINAL INSPECTION.

PRELIMINARY DRAWING - NOT RELEASED FOR CONSTRUCT

STORMWATER CONTROL MEASURE PLAN VIEW AND NOTES C9.00

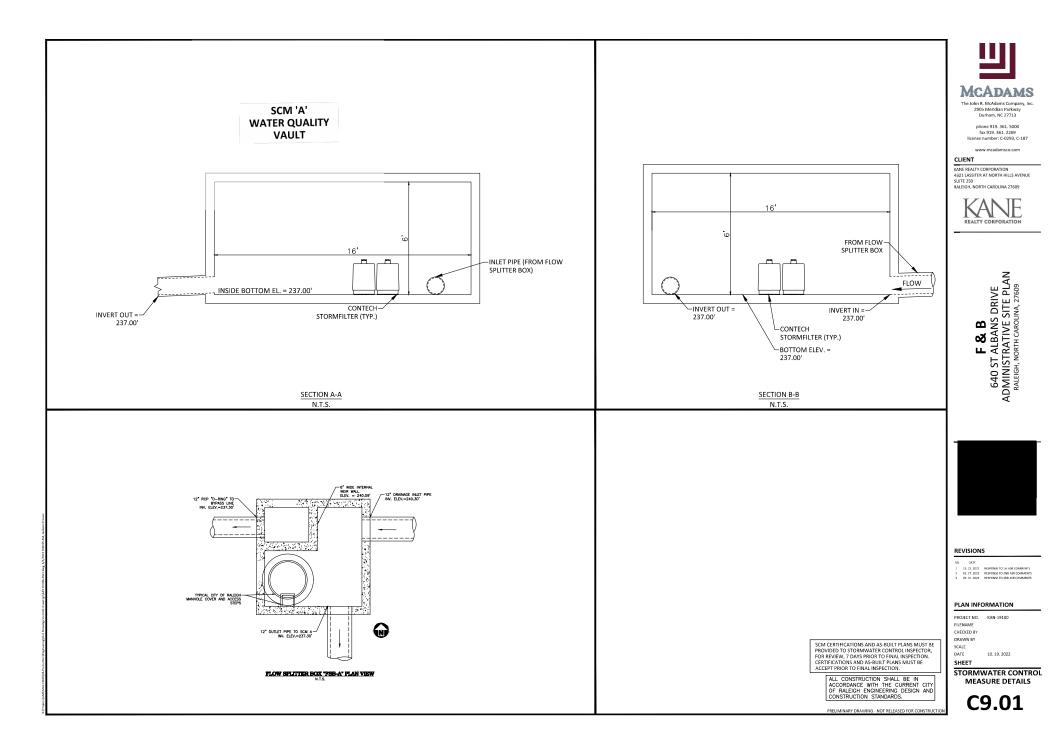

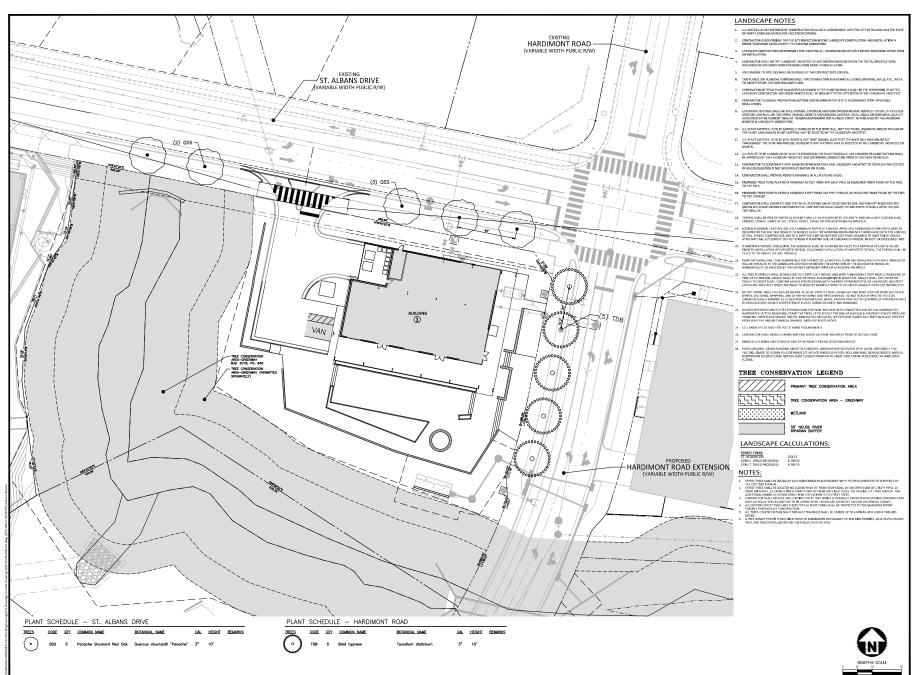

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phone 919. 361. 5000 fax 919. 361. 2269 license number: C-0293, C-187

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F & B640 ST ALBANS DRIVE
ADMINISTRATIVE SITE PLAN
RALEIGH, NORTH CAROLINA, 27609

REVISIONS

PLAN INFORMATION

PROJECT NO. FILENAME KAN19010-ASR-LS1 CHECKED BY

DRAWN BY SCALE 1"=20" 10. 19. 2022

DATE SHEET

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LANDSCAPE PLAN

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