



Administrative Approval Action

Case File / Name: ASR-0105-2022
DSLCL - SOLIS BUFFALO RD MULTIFAMILY

City of Raleigh
Development Services Department
One Exchange Plaza
Raleigh, NC 27602
(919) 996-2492
currentplanning@raleighnc.gov
www.raleighnc.gov

LOCATION: This 20.32 acre site zoned RX-3 CU (Z-39-22) is located on the northeast corner of the intersection of Forestville Road and Buffalo Roads at 5017 Forestville Road, outside the city limits.

REQUEST: This is a multifamily housing development consisting of ten apartment buildings with 322 dwelling units, a clubhouse, and associated infrastructure of approximately 360,894 square feet of space total.

**DESIGN
ADJUSTMENT(S)/
ALTERNATES, ETC:** SPR-0075-2023: DSLCL - Site Permitting Review/Major [Signature Set]

FINDINGS: City Administration finds that this request, with the below conditions of approval being met, conforms to the Unified Development Ordinance. This approval is based on a preliminary plan dated May 25, 2023 by Matt Murphy.

CONDITIONS OF APPROVAL and NEXT STEPS:

This document must be applied to the second sheet of all future submittals except for final plats. This is a preliminary plan and as such no permits have been issued with this approval. To obtain permits and/or completion of the project, the following steps are required:

☒ **SITE PERMITTING REVIEW** - For land disturbance of 12,000 square feet or greater, public or private infrastructure, shared stormwater devices, etc. Site Permitting Review may be submitted upon receipt of this signed approval document.

The following items are required prior to approval of Site Permitting Review plans:

General

1. The site plan shall be revised to verify conformance with UDO Section 7.1.7 D requiring all interior parking lot landscape islands to be a minimum of 8 feet in width and be a minimum of 300 square feet in area.

Engineering

2. Required NCDOT encroachment and/or driveway permits must be approved and copies provided to the City of Raleigh Transportation Department – Mobility Strategy and Infrastructure Division prior to Site Permit review approval.
3. A public infrastructure surety shall be provided to City of Raleigh Transportation – Development Engineering Division (UDO 8.1.3) in the amount of 100% of the improvement cost for the NCDOT portion and 125% of the improvement cost for the City of Raleigh infrastructure.

Public Utilities

4. A Downstream Sewer Capacity Study in compliance with the City of Raleigh Public Utilities Department Handbook shall be submitted by the Project Engineer for review and approval.

Stormwater



Administrative Approval Action

Case File / Name: ASR-0105-2022
DSLC - SOLIS BUFFALO RD MULTIFAMILY

City of Raleigh
Development Services Department
One Exchange Plaza
Raleigh, NC 27602
(919) 996-2492
currentplanning@raleighnc.gov
www.raleighnc.gov

5. A surety equal to of the cost of clearing, grubbing and reseeding a site, shall be paid to the City (UDO 9.4.4).
6. A stormwater control plan with a stormwater operations and maintenance manual and budget shall be approved (UDO 9.2).
7. A nitrogen offset payment must be made to a qualifying mitigation bank (UDO 9.2.2.B).
8. Runoff compliance per UDO 9.2.2.E must be demonstrated for the proposed roadway improvements prior to SPR approval.
9. NPDES construction permit is required. Application should be made to NC DEQ for coverage.

Urban Forestry

10. Submit a final tree conservation plan that includes metes and bounds descriptions of all tree conservation areas and tree protection fencing as required (UDO 9.1.5).
11. Tree protection fence must be inspected by Urban Forestry staff prior to the issuance of a grading permit.

☒ **RECORDED MAP(S)** - Submit plat to record new property lines, easements, tree conservation areas, etc.). Plats may be submitted for review when the Site Permitting Review plans, if required, have been deemed ready for mylar signature.

The following items must be approved prior to recording the plat:

General

1. A demolition permit shall be issued and this building permit number shown on all maps for recording.
2. The public bicycle & pedestrian access easement, as shown on the preliminary plan, shall be dedicated prior to, or in conjunction with the recording of a map in any phase affected by the asphalt multi-use trail.

Engineering

3. The required right of way for proposed and/or existing streets shall be dedicated to the City of Raleigh and shown on the map approved for recordation. (prior to recorded map).

Public Utilities

4. Infrastructure Construction Plans (concurrent submittal) must be approved by the City of Raleigh Public Utilities Department for all public water, public sewer and/or private sewer extensions.



Administrative Approval Action

Case File / Name: ASR-0105-2022
DSLCL - SOLIS BUFFALO RD MULTIFAMILY

City of Raleigh
Development Services Department
One Exchange Plaza
Raleigh, NC 27602
(919) 996-2492
currentplanning@raleighnc.gov
www.raleighnc.gov

5. A Petition for Annexation into the City limits shall be submitted in accordance with City Council policy for extension of utility service to properties currently outside of the City limits. This voluntary annexation in no way obligates the City to extend utility services to the property.

Stormwater

6. All stormwater control measures and means of transporting stormwater runoff to and from any nitrogen and stormwater runoff control measures shall be shown on all plats for recording as private drainage easements (UDO 9.2).

Urban Forestry

7. A tree conservation plat shall be recorded with metes and bounds showing the designated tree conservation areas (UDO 9.1). This development proposes 2.06 acres of tree conservation area.

☒ **BUILDING PERMITS** - For buildings and structures shown on the approved plans. Commercial building permit plans must include the signed, approved Site Permitting Review plans attached, if applicable. Permit sets may be reviewed prior to the recordation of required plats, but cannot be approved.

The following items must be approved prior to the issuance of building permits:

General

1. Comply with all conditions of Z-39-2022
2. Street names for this development shall be approved by the Raleigh GIS Division and by Wake County.
3. A demolition permit shall be issued and this building permit number shown on all maps for recording.
4. A Petition for Annexation into the City limits shall be submitted in accordance with City Council policy for extension of utility service to properties currently outside of the City limits. This voluntary annexation in no way obligates the City to extend utility services to the property.

Engineering

5. A Traffic Control and Pedestrian (TCPED) Plan must be approved and a right-of-way occupancy permit must be obtained from Right-of-way Services for any construction activities within the right-of-way.

Public Utilities

6. A plat must be recorded at the Wake County Register of Deeds office for all utility easement dedications.

Stormwater



Administrative Approval Action

Case File / Name: ASR-0105-2022
DSLC - SOLIS BUFFALO RD MULTIFAMILY

City of Raleigh
Development Services Department
One Exchange Plaza
Raleigh, NC 27602
(919) 996-2492
currentplanning@raleighnc.gov
www.raleighnc.gov

7. A surety equal to 125% of the cost of the construction of a stormwater device shall be paid to the Engineering Services Department (UDO 9.2.2.D.1.d).
8. A payment equal to twenty-four percent (24%) of the estimated cost of constructing all stormwater control facilities shown on the development plans shall be paid by the developer to the City stormwater facility replacement fund (UDO 9.2.2.G.3).

Urban Forestry

9. A tree conservation plat shall be recorded with metes and bounds showing the designated tree conservation areas (UDO 9.1).

The following are required prior to issuance of building occupancy permit:

General

1. All Water, Sanitary Sewer and Reuse facilities shall be installed, inspected, tested and accepted by the City of Raleigh Public Utilities Department for operations and maintenance.
2. Final inspection of all tree conservation areas by Urban Forestry Staff.

Stormwater

3. As-built drawings and associated forms for all Stormwater devices are accepted by the Engineering Services Department (UDO 9.2.2.D.3).


EXPIRATION DATES: The expiration provisions of UDO Section 10.2.8 E, including the ability to request extensions in the expiration date, apply to this site plan. If significant construction has not taken place on a project after administrative site review approval, that approval may expire and be declared void, requiring re-approval before permits may be issued. To avoid allowing this plan approval to expire the following must take place by the following dates:

3-Year Expiration Date: June 28, 2026

Obtain a valid building permit for the total area of the project, or a phase of the project.

4-Year Completion Date:

Within four years after issuance of the first building permit for the site plan, the construction of the entire site plan must be completed unless an applicant has been granted vested rights. Failure to complete construction within this specified time frame shall automatically void the approved site plan for which no building permits have been issued.

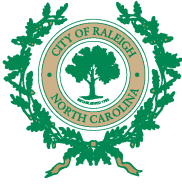


Administrative Approval Action

Case File / Name: ASR-0105-2022
DSLC - SOLIS BUFFALO RD MULTIFAMILY

City of Raleigh
Development Services Department
One Exchange Plaza
Raleigh, NC 27602
(919) 996-2492
currentplanning@raleighnc.gov
www.raleighnc.gov

I hereby certify this administrative decision.

Signed: *Daniel L. Stegall* Date: 06/28/2023
Development Services Dir/Designee
Staff Coordinator: Michael Walters

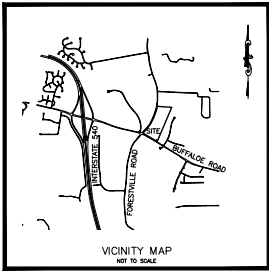

To: TERWILLIGER PAPPAS MULTI FAMILY, LLC & METRO TITLE COMPANY;

THIS IS TO CERTIFY THAT THIS MAP OR PLAT AND THE SURVEY ON WHICH IT IS BASED WERE MADE IN ACCORDANCE WITH THE 2021 MINIMUM STANDARD DETAIL REQUIREMENTS FOR ALTA/NSPS LAND TITLE SURVEYS, JOINTLY ESTABLISHED AND ADOPTED BY ALTA AND NSPS, AND INCLUDES ITEMS 1, 2, 3, 4, 6(A), 6(B), 7(A), 7(B), 7(C), 8, 9, 13, 14, 17, 18, AND 19 OF TABLE A THEREOF. THE FIELD WORK WAS COMPLETED ON JUNE 3, 2022.

DATE OF PLAT OR MAP: SEPTEMBER 23, 2022
JAY B. JORDAN, P.L.S. L-5472



WILLIAM C. TRUSTEE, YOUNG LIVING TRUST
PIN174443292
DB 16831, PG. 2074
4929 FORESTVILLE RD

DIANE C. NOBLE, PHYLLIS L. NOBLE AND HEIRS
PIN1744608906
DB 6622, PG. 526
4929 FORESTVILLE RD

N/T
CITY OF RALEIGH
PIN1744548112
DB 11043, PG. 707
4909 FORESTVILLE RD



GENERAL NOTES

1. THIS IS A SURVEY OF AN EXISTING PARCEL(S) OF LAND, THIS IS A NSPS LAND TITLE SURVEY.
2. BEARINGS FOR THIS SURVEY ARE BASED ON NC GRID NAD 83(2011).
3. ALL DISTANCES ARE HORIZONTAL GROUND DISTANCES.
4. ZONING: R-4
5. AREA BY COORDINATE GEOMETRY.
6. FLOOD NOTES: THIS PROPERTY IS NOT LOCATED IN A SPECIAL FLOOD HAZARD ZONE. IT IS LOCATED IN ZONE "X" AS DEFINED BY F.E.M.A. F.I.E.M. COMMUNITY PANEL #370374600 DATED MAY, 02, 2006. THIS IS THE CURRENT FLOOD ZONE MAP FOR SUBJECT PROPERTY.
7. REFERENCES: BM, 1978, PG. 15; DB, 18737, PG. 025 OF THE NIMS COUNTY REGISTRY.
8. UTILITY STATEMENT:
THE UNDERGROUND UTILITIES SHOWN HAVE BEEN LOCATED FROM FIELD SURVEY INFORMATION AND EXISTING DRAWINGS. THE SURVEYOR MAKES NO GUARANTEE THAT THE UNDERGROUND UTILITIES SHOWN COMPRISE ALL SUCH UTILITIES IN THE AREA, EITHER IN SERVICE OR ABANDONED. THE SURVEYOR FURTHER DOES NOT WARRANT THAT THE UNDERGROUND UTILITIES SHOWN ARE IN THE EXACT LOCATION INDICATED ALTHOUGH HE DOES FROM INFORMATION AVAILABLE.
9. NO LAND MONUMENTS FOUND WITHIN 2000' OF SITE.
10. NO LAND SURVEY COMPLETED BY NATURAL RESOURCE CONSULTANTS DATED APRIL 6, 2022.

TITLE COMMITMENT


METRO TITLE COMPANY
COMMITMENT NUMBER: MET2022-00707
COMMITMENT DATE: APRIL 05, 2022 AT 08:00 AM

SCHEDULE B, PART II EXCEPTIONS

1. Any defect, lien, encumbrance, adverse claim, or other matter that appears for the first time in the Public Records or is created, disclosed, or is disclosed between the Commitment Date and the date on which all of the Schedule B, Part I-Requirements are met.
-NOT A SURVEY MATTER
2. Taxes and assessments for the year 2022 and subsequent years, not yet due and payable.
-NO A SURVEY MATTER
3. Rights of tenants in possession under unrecorded lease(s). (TO BE DELETED UPON RECEIPT OF A SATISFACTORY AFFIDAVIT AS TO TENANTS AS REFERENCED IN THE REQUIREMENT STATEMENT)
-NOT A SURVEY MATTER
4. Easements, setback lines and any other matters shown on plot recorded in Book of Maps 1978, Page 15, Wake County Registry.
-SHOWN HEREIN
5. Easement(s) in favor of Carolina Power & Light Company as recorded in Book 4269, Page 84, Wake County Registry.
-SHOWN HEREIN
6. Deed of Easement with General Warranty for Temporary Construction Easement to City of Raleigh, recorded in Book 13000, Page 2067, Wake County Registry.
-TEMPORARY CONSTRUCTION EXPIRED UPON COMPLETION OF THE PROJECT
7. Deed for Highway Right of Way to Department of Transportation recorded in Book 12301, Page 1430, and Book 17378, Page 696, Wake County Registry.
-DOCUMENTS ESTABLISH RIGHT OF WAY AND EASEMENTS FOR BUFFALO ROAD AND FORESTVILLE ROAD, NEED RIGHT OF WAY PLANS REFERENCED IN DOCUMENTS TO ACCURATELY PLOT.
8. Title to that portion of the land lying within the bounds of any roads or highways and/or rights of the public and others entitled thereto in and to the use of that portion of the insured premises within the bounds of street or roadway, if any.
-NOT A SURVEY MATTER
9. The creation or loss of land by natural or artificial changes along water forming part of the boundary of the land and/or due to land lying below the higher of the mean high water mark and/or the normal bounds of any body of water; and/or riparian and/or littoral rights incident to any branches, creeks, streams, lakes, ponds, or other waters bounding or abutting or located on the land.
-NOT A SURVEY MATTER
10. No coverage is provided as to the amount of acreage or square footage of the land.
-NOT A SURVEY MATTER
11. Any discrepancy, conflict, matter affecting access, shortage in area or boundary lines, encroachment, encumbrance, violation, variation, overlap, setback, easement or claims of easement, riparian rights, and title to land within roads, ways, railroads, watercourses, burial grounds, highways, dredged or filled areas or land below the mean high-water mark or within the bounds of any adjoining body of water, or other adverse circumstance affecting the title that would be disclosed by an accurate and complete land survey of the land.
-SURVEY SHOWN HEREIN
12. NOTE: NO CLOSING SERVICES INSURANCE/PROTECTION - As to the transaction for which this commitment is issued, the Company does not afford insured closing protection to the Proposed Insured(s) identified in Schedule A of this Commitment. Any closing protection coverage or letter which hereinafter may have been or hereafter may be provided shall not be effective and is hereby rescinded as to this transaction absent revision of this commitment to specifically provide for said coverage
-NOT A SURVEY MATTER

PROPERTY DESCRIPTION

Being all of Tract 1, containing 7.00 acres, more or less; Tract 2, containing 14.65 acres, more or less, as shown on map entitled Property Survey for Minnie Clyde Heater Estate, dated 12-8-77, and recorded in Book of Maps 1978 Volume 1, Page 15, Wake County Registry.

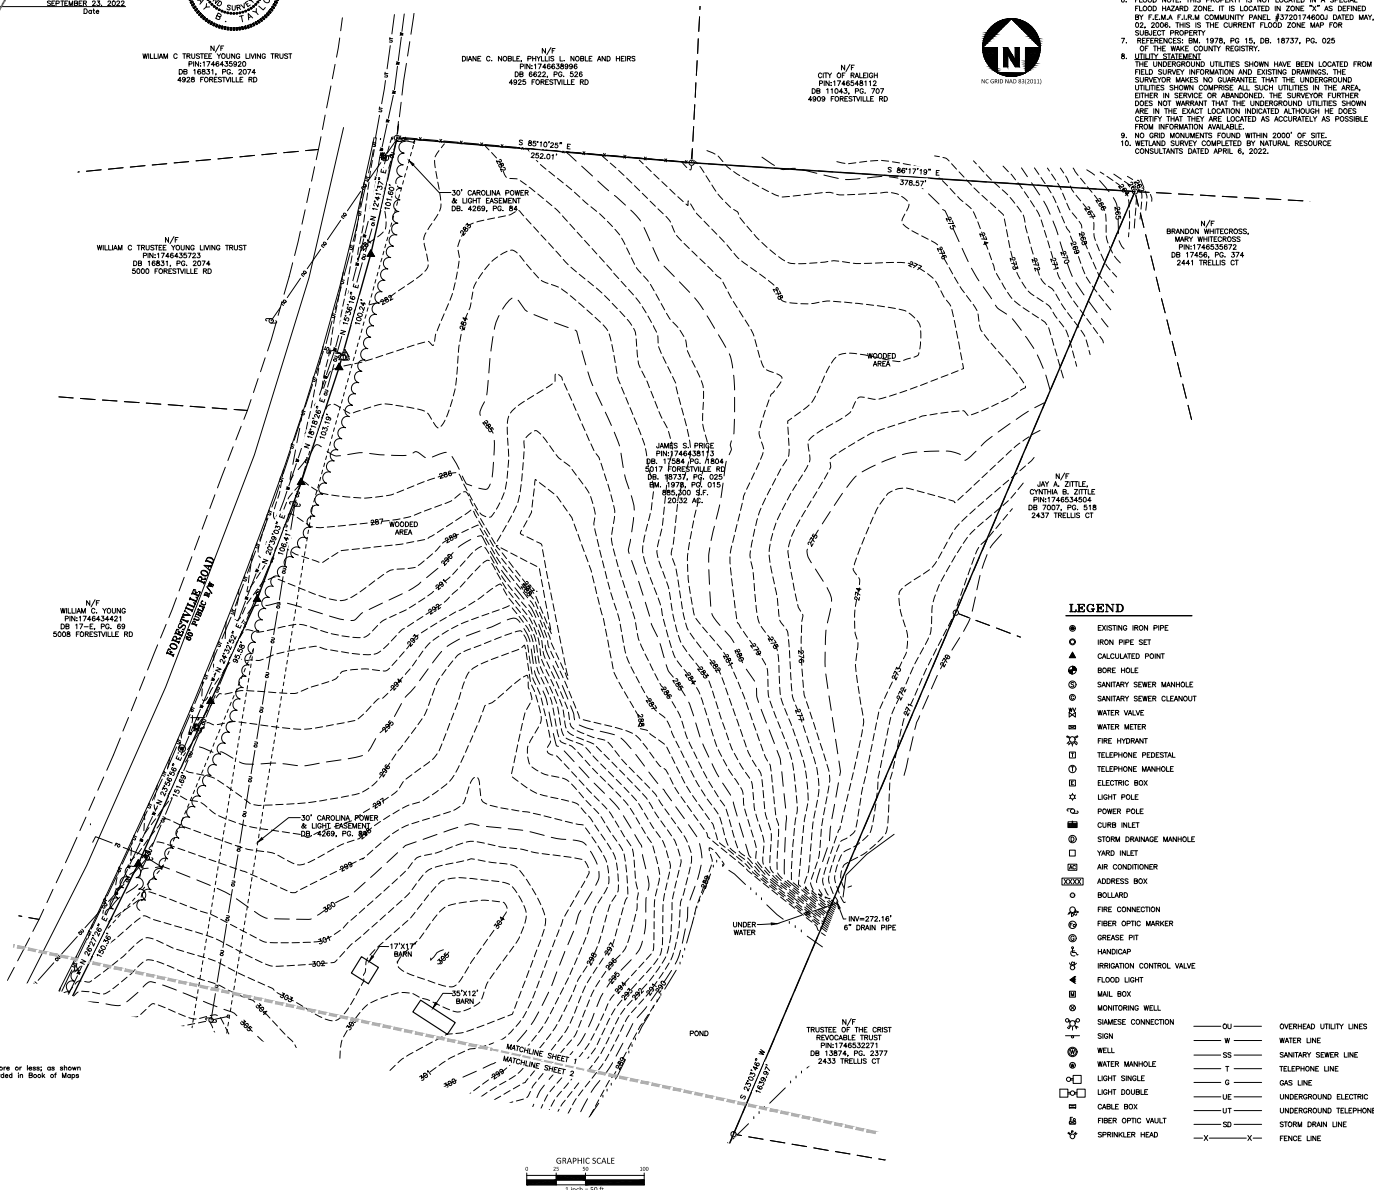

LEGEND

- EXISTING IRON PIPE
- IRON PIPE SET
- ▲ CALCULATED POINT
- BORE HOLE
- ⊙ SANITARY SEWER MANHOLE
- ⊙ SANITARY SEWER CLEANOUT
- ⊙ WATER VALVE
- ⊙ WATER METER
- ⊙ FIRE HYDRANT
- ⊙ TELEPHONE PEDESTAL
- ⊙ TELEPHONE MANHOLE
- ⊙ ELECTRIC BOX
- ⊙ LIGHT POLE
- ⊙ POWER POLE
- ⊙ CURB INLET
- ⊙ STORM DRAINAGE MANHOLE
- ⊙ YARD INLET
- ⊙ AIR CONDITIONER
- ⊙ ADDRESS BOX
- BOLLARD
- ⊙ FIRE CONNECTION
- ⊙ FIBER OPTIC MARKER
- ⊙ GREASE PIT
- ⊙ HANDCAP
- ⊙ IRRIGATION CONTROL VALVE
- ⊙ FLOOD LIGHT
- ⊙ MAIL BOX
- ⊙ MONITORING WELL
- ⊙ SIAMENSE CONNECTION
- ⊙ SIGN
- ⊙ WELL
- ⊙ WATER MANHOLE
- ⊙ LIGHT SINGLE
- ⊙ LIGHT DOUBLE
- ⊙ CABLE BOX
- ⊙ FIBER OPTIC VAULT
- ⊙ SPRINKLER HEAD
- OU— OVERHEAD UTILITY LINES
- W— WATER LINE
- SS— SANITARY SEWER LINE
- T— TELEPHONE LINE
- G— GAS LINE
- UE— UNDERGROUND ELECTRIC
- UT— UNDERGROUND TELEPHONE
- SD— STORM DRAIN LINE
- X— FENCE LINE



McADAMS
The John R. McAdams Company, Inc.
2905 Meridian Parkway
Durham, NC 27713
phone 919.361.5000
fax 919.361.2269
license number: C-0293, C-187
www.mcadamsco.com

CLIENT

TERWILLIGER PAPPAS
510 GLENWOOD AVE.
SUITE 317
RALEIGH, NORTH CAROLINA 27603

BUFFALO ROAD APARTMENTS
ALTA/NSPS LAND TITLE SURVEY
5017 FORESTVILLE ROAD
ST. MATTHEWS TOWNSHIP, WAKE COUNTY, NORTH CAROLINA

REVISIONS

NO. DATE COMMENTS
1 09.01.2022 COMMENTS

PLAN INFORMATION

PROJECT NO. SPEC-22122
FILENAME SPEC-22122-AT2
SURVEYED BY RTE
DRAWN BY JBT
SCALE 1"=50'
DATE 06.08.2022
SHEET

ALTA/NSPS
LAND TITLE SURVEY
1-2

GENERAL NOTES

1. SEE SHEET 1 FOR GENERAL NOTES



McADAMS

The John R. McAdams Company, Inc.
2905 Meridian Parkway
Durham, NC 27713

phone 919.361.5000
fax 919.361.2269
license number: C-0293, C-187

www.mcadamsco.com

CLIENT

TERWILLIGER PAPPAS
5310 GLENWOOD AVE.
SUITE 317
RALEIGH, NORTH CAROLINA 27603

BUFFALO ROAD APARTMENTS ALTA/NSPS LAND TITLE SURVEY 5017 FORESTVILLE ROAD ST. MATTHEWS TOWNSHIP, WAKE COUNTY, NORTH CAROLINA

REVISIONS

NO.	DATE	COMMENTS
1	09.01.2022	

PLAN INFORMATION

PROJECT NO.	SPEC-22122
FILENAME	SPEC-22122-AT2
SURVEYED BY	RTT
DRAWN BY	JBT
SCALE	1"=50'
DATE	06.08.2022

SHEET

ALTA/NSPS
LAND TITLE SURVEY

2-2

LEGEND

- EXISTING IRON PIPE
- IRON PIPE SET
- ▲ CALCULATED POINT
- BORE HOLE
- SANITARY SEWER MANHOLE
- SANITARY SEWER CLEANOUT
- W WATER VALVE
- W WATER METER
- W FIRE HYDRANT
- W TELEPHONE PEDISTAL
- W TELEPHONE MANHOLE
- W ELECTRIC BOX
- W LIGHT POLE
- W POWER POLE
- W CURB INLET
- W STORM DRAINAGE MANHOLE
- W YARD INLET
- W AIR CONDITIONER
- W ADDRESS BOX
- W BOLLARD
- W FIRE CONNECTION
- W FIBER OPTIC MARKER
- W GREASE PIT
- W HANDCAP
- W IRRIGATION CONTROL VALVE
- W FLOOD LIGHT
- W MAIL BOX
- W MONITORING WELL
- W SHAMOSE CONNECTION
- W SIGN
- W WELL
- W WATER MANHOLE
- W LIGHT SINGLE
- W LIGHT DOUBLE
- W CABLE BOX
- W FIBER OPTIC VAULT
- W SPRINKLER HEAD

- OU— OVERHEAD UTILITY LINES
- W— WATER LINE
- SS— SANITARY SEWER LINE
- T— TELEPHONE LINE
- G— GAS LINE
- UE— UNDERGROUND ELECTRIC
- UT— UNDERGROUND TELEPHONE
- SD— STORM DRAIN LINE
- X— FENCE LINE




DEMOLITION NOTES

1. CONTRACTOR IS RESPONSIBLE FOR THE COORDINATION AND SEQUENCING OF DEMOLITION AS DESCRIBED BY THESE DOCUMENTS AND SPECIFICATIONS. CONTRACTOR IS TO OBTAIN ALL PERMITS.
2. THE CONTRACTOR SHALL VERIFY THE EXISTENCE, LOCATION, AND DEPTH OF ALL BURIED UTILITIES (ELECTRICAL, MECHANICAL, WATER, SEWER, TELECOMMUNICATION, GAS, ETC.) WITHIN THE CONSTRUCTION AREA PRIOR TO ANY EXCAVATION. UTILITIES ARE ILLUSTRATED FOR INFORMATION PURPOSES ONLY. THE OMISSION OF, OR INCLUSION OF, UTILITY LOCATIONS ON THE PLANS IS NOT TO BE CONSIDERED AS THE NON-EXISTENCE OR DEFINITE LOCATION OF EXISTING UNDERGROUND UTILITIES. PRIOR TO CONSTRUCTION, THE CONTRACTOR SHALL NOTIFY AND MEET WITH ALL UTILITY OWNERS WHOSE FACILITIES WILL BE AFFECTED TO DETERMINE UTILITY LOCATIONS. THE CONTRACTOR SHALL PROTECT ALL UTILITIES FROM DAMAGE CAUSED BY HIS OPERATIONS OR THOSE OF HIS AGENTS. ANY DAMAGE TO EXISTING UNDERGROUND UTILITIES SHALL BE REPAIRED AT THE CONTRACTOR'S EXPENSE.
3. CONTRACTOR IS RESPONSIBLE FOR COORDINATION OF ANY REQUIRED UTILITY DEMOLITION OR RELOCATION WITH THE APPLICABLE UTILITY OWNER. THE CONTRACTOR SHALL COORDINATE THIS WORK WITH THE RESPECTIVE UTILITY OWNERS SO AS NOT TO ADVERSELY AFFECT THE PROJECT SCHEDULE.
4. ALL MATERIAL GENERATED BY THE DEMOLITION WILL BE HAULED FROM THE SITE AND DISPOSED OF PER LOCAL ORDINANCES.
5. INSTALL 6" CHAIN LINK FENCE AROUND PERIMETER OF PROPERTY DURING DEMOLITION AND CONSTRUCTION.
6. ALL EXISTING ASPHALT PAVEMENT SHALL BE SAW-CUT AT THE LIMIT OF DEMOLITION WHERE CONSTRUCTION PLANS SHOW TIE-INS. SAW-CUT JOINT SHALL BE ONE FOOT FROM THE EXISTING EDGE OF PAVEMENT, MINIMUM.
7. ALL EXISTING CONCRETE PAVEMENT, SIDEWALK AND/OR CURB AND GUTTER SHALL BE REMOVED TO THE NEAREST EXISTING CONTROL JOINT BEYOND THE LIMIT OF DEMOLITION SHOWN ON THE PLAN. WHERE NO EXISTING CONTROL JOINTS ARE PRESENT WITHIN FIVE FEET OF THE LIMIT OF DEMOLITION, CONCRETE PAVEMENTS SHALL BE SAW-CUT.
8. FORESTVILLE ROAD AND BUFFALO ROAD SHALL REMAIN OPEN AND UNOBSTRUCTED TO TRAFFIC AT ALL TIMES.
9. CONTRACTOR IS RESPONSIBLE FOR TRAFFIC CONTROL DURING CONSTRUCTION PER WORK AREA TRAFFIC CONTROL HANDBOOK STANDARDS. (M.A.T.C.H.)
10. CONTRACTOR SHALL COORDINATE ALL DEMOLITION OR INSTALLATION WORK ALONG FORESTVILLE ROAD AND BUFFALO ROAD WITH NCDOT.
11. DEMOLITION OF STORM DRAINAGE AND SANITARY SEWER SYSTEM(S) BY CONTRACTOR SHALL ALLOW FOR CONTINUOUS USE OF THE SYSTEM(S).
12. CONTRACTOR SHALL REPAIR OR REPLACE ANY ADJACENT CONCRETE CURBING AND/OR SIDEWALK DAMAGED AS PART OF DEMOLITION PROCESS.
13. FOR THE RENOVATION OR DEMOLITION OF BUILDINGS OR OTHER STRUCTURES, FEDERAL AND/OR LOCAL REGULATIONS REQUIRE THAT A THOROUGH INSPECTION BE CONDUCTED FOR ASBESTOS-CONTAINING MATERIALS, PRIOR TO CONDUCTING A RENOVATION OR DEMOLITION ACTIVITY. THE ASBESTOS INSPECTION MUST BE CONDUCTED BY A NORTH CAROLINA ACCREDITED ASBESTOS INSPECTOR. ALL REGULATED AND/OR FRAGILE ASBESTOS-CONTAINING MATERIALS IDENTIFIED DURING THE SURVEY, WHICH WILL BE DISTURBED, MUST BE PROPERLY REMOVED BY ACCREDITED INDIVIDUALS BEFORE BEGINNING THE RENOVATION OR DEMOLITION ACTIVITY.
14. EXISTING WELLS, IF ANY, SHALL BE ABANDONED IN ACCORDANCE WITH NORTH CAROLINA ADMINISTRATIVE CODE 15A NCAC 02C.0113.

LEGEND

	CONCRETE TO BE REMOVED	-/-
	ASPHALT TO BE REMOVED	-/-
	BUILDING TO BE REMOVED	-/-
	EXISTING EASEMENT	-/-
	VEGETATION TO BE REMOVED	-/-
	TREE TO BE REMOVED	-/-
	LIGHT FIXTURE TO BE REMOVED	-/-
	SILT FENCE	-/-
	TREE PROTECTION FENCING	-/-
	PROJECT LIMIT	-/-
	CONSTRUCTION FENCE	-/-
	WATER LINE TO BE REMOVED	-/-
	SEWER LINE TO BE REMOVED	-/-
	STORM LINE TO BE REMOVED	-/-
	GAS LINE TO BE REMOVED	-/-

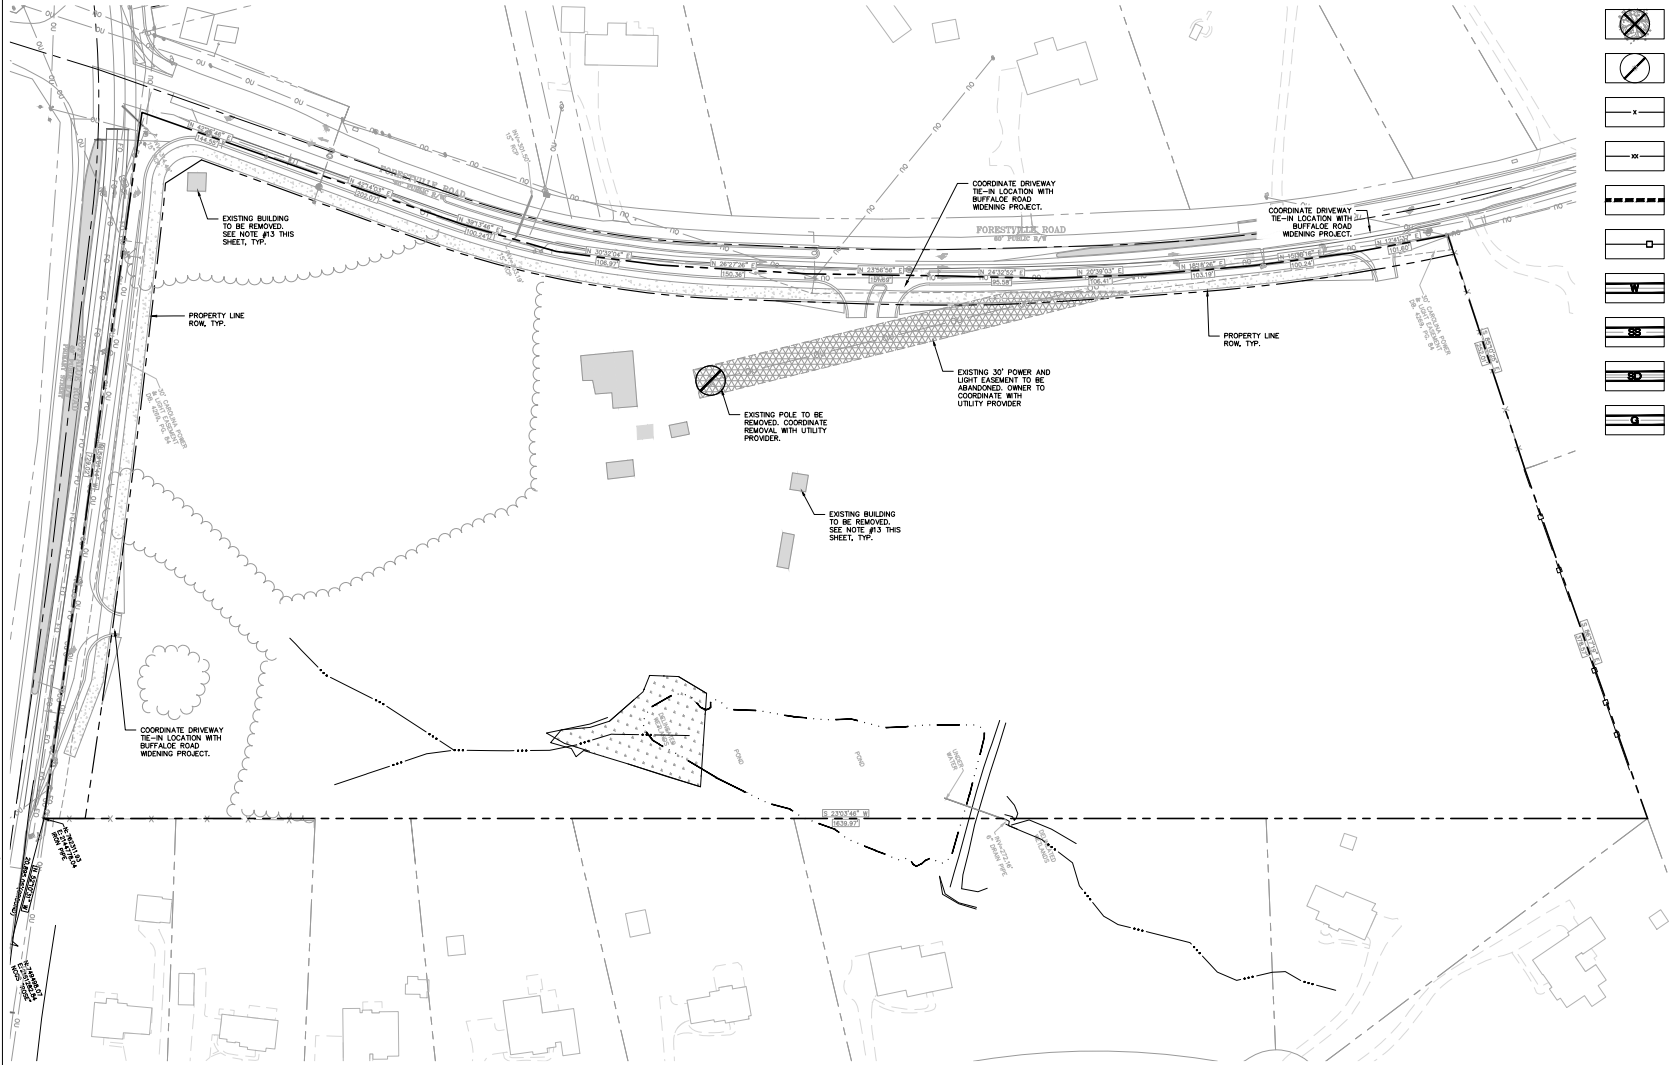


Cole Jensen & Stone
BOLTON & MENK, INC.
418 S DAWSON STREET
RALEIGH, NORTH CAROLINA 27601
Phone: (919) 719-1800
Email: raleigh@bolton-menk.com
www.bolton-menk.com

TERWILLIGER PAPPAS
510 GLENWOOD AVE
SUITE 317
RALEIGH, NC 27603
**SOLIS BUFFALO RD
MULTIFAMILY**
5017 FORESTVILLE RD
RALEIGH, NC 27616

DEMOLITION PLAN

PROJECT NO:	50645
REVISIONS:	
0. A/R Submittal	11/09/2022
1. 1st A/R Plan Review	01/12/2023
2. 2nd A/R Plan Review	02/23/2023
3. 3rd A/R Plan Review	04/28/2023
4. 4th A/R Plan Review	05/25/2023

SCALE: 1"=60'
0 30' 60' 120'
SCALE: 1"=60'
DATE: 05/25/2023
DESIGNED BY: AH
DRAWN BY: AH
CHECKED BY: RB, BL, TH

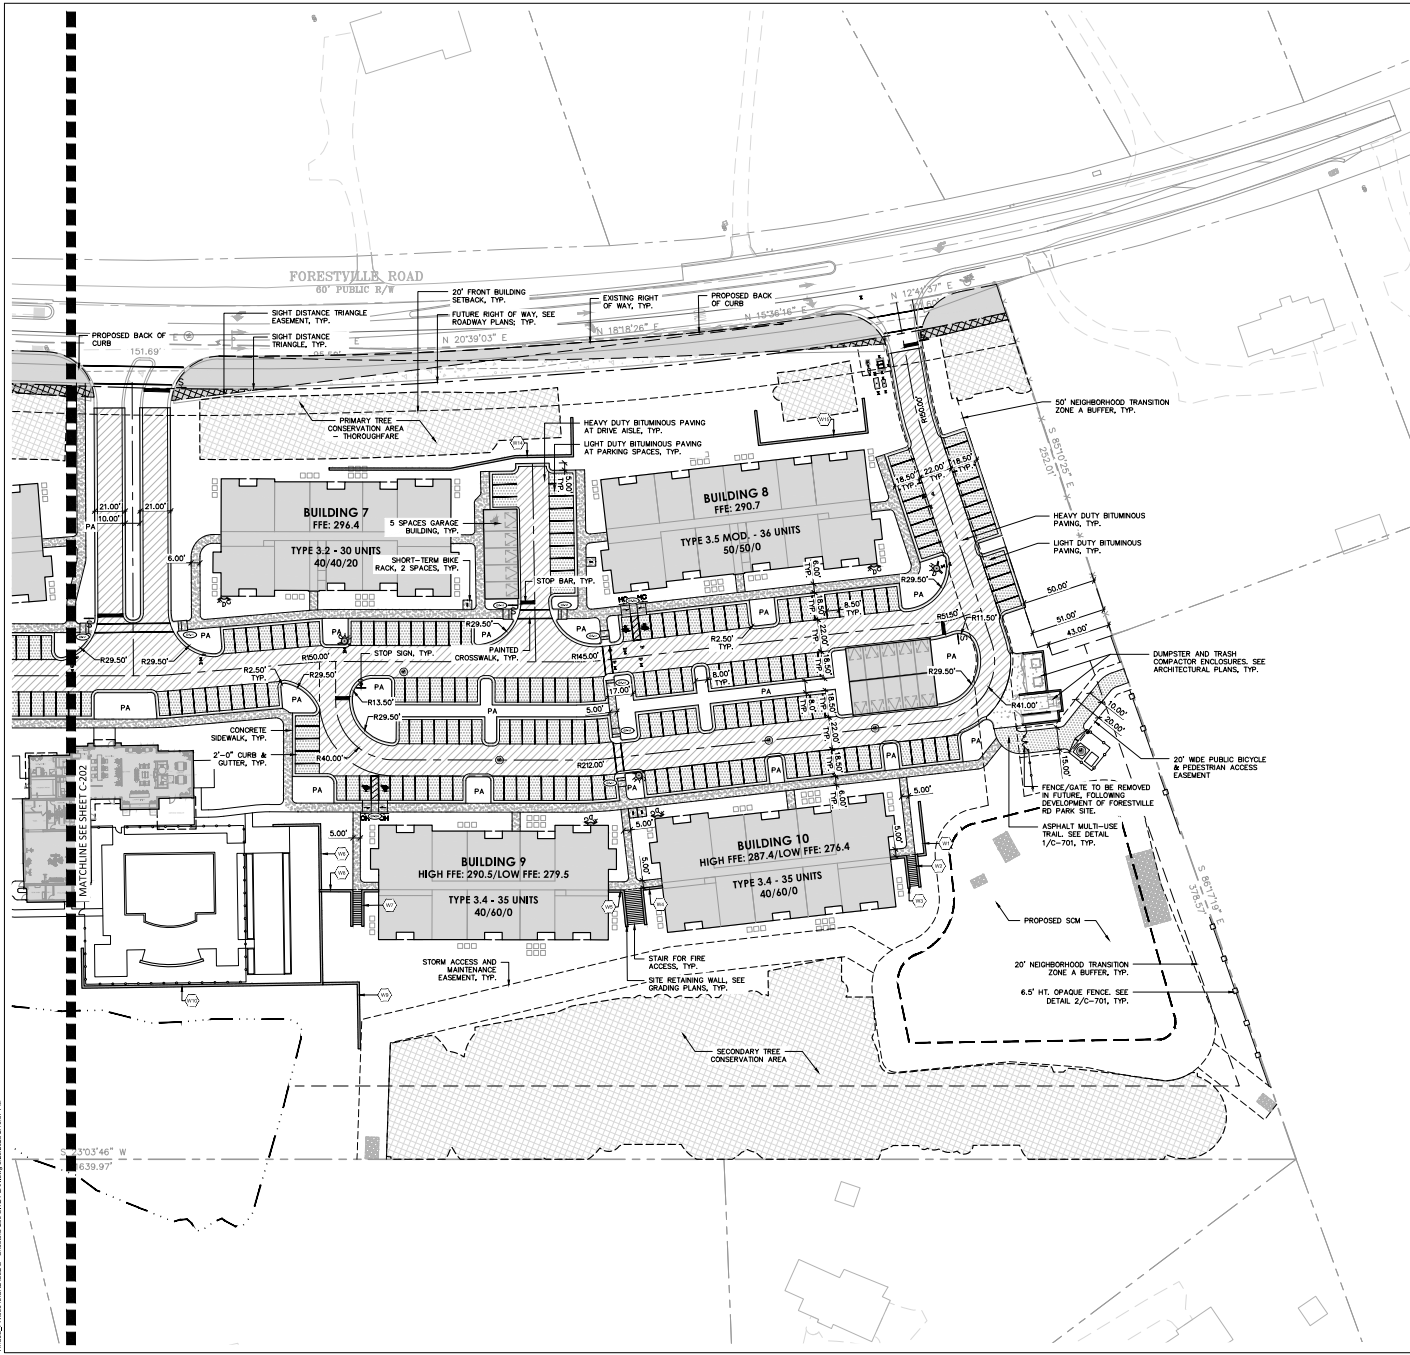

LEGEND

SYMBOL	DETAIL
	PROPOSED SIDEWALK -/-
	PROPOSED ACCESSIBLE RAMP -/-
	PROPOSED ACCESSIBLE SPACE -/-
	PROPOSED ACCESSIBLE VAN SPACE -/-
	PROPOSED ACCESSIBLE SIGN -/-
	PROPOSED STOP SIGN -/-
	CURB RAMP TYPE, SEE CURB RAMP SCHEDULE -/-
	HEAVY DUTY CONCRETE -/-
	HEAVY DUTY BITUMINOUS CONCRETE -/-
	LIGHT DUTY BITUMINOUS CONCRETE -/-
	REINFORCED TURF -/-
	PROPOSED 2'-0" CURB & GUTTER -/-
	PROPOSED LIGHTING -/-

SITE WALL SCHEDULE

WALL #	WALL TYPE
1	SEGMENTAL BLOCK
2	C.I.P. CONCRETE
3	C.I.P. CONCRETE
4	C.I.P. CONCRETE
5	C.I.P. CONCRETE
6	SEGMENTAL BLOCK
7	C.I.P. CONCRETE
8	C.I.P. CONCRETE
9	SEGMENTAL BLOCK
10	SEGMENTAL BLOCK
11	SEGMENTAL BLOCK
12	SEGMENTAL BLOCK
13	SEGMENTAL BLOCK
14	SEGMENTAL BLOCK

TYPICAL RETAINING WALL NOTES
#1 SEE GRADING PLANS FOR TOP AND BOTTOM OF WALL ELEVATIONS.
#2 SEE STRUCTURAL PLANS FOR C.I.P. CONCRETE RETAINING WALL DESIGN.
CONTRACTOR SHALL PROVIDE SHOP DRAWINGS SEALED BY A NC LICENSED ENGINEER FOR ALL SEGMENTAL BLOCK RETAINING WALLS.

CURB RAMP SCHEDULE

SYMBOL	RAMP TYPE	DETAIL
	TYPE N-1	10/C-700
	DEPRESSED SIDEWALK	11/C-700



Cole Jones & Stone
BOLTON & MENK, INC.

418 S DAWSON STREET
RALEIGH, NORTH CAROLINA 27601
Phone: (919) 719-1800
Email: raleigh@bolton-menk.com
www.bolton-menk.com

TERWILLIGER PAPPAS

510 GLENWOOD AVE
SUITE 317
RALEIGH, NC 27603



SOLIS BUFFALO RD MULTIFAMILY

5017 FORESTVILLE RD
RALEIGH, NC 27615

SITE PLAN - NORTH ENLARGEMENT

PROJECT NO:
50645


REVISIONS:
0. AIR Submittal 11/09/2022
1. 1st AIR Plan Review 01/12/2023
2. 2nd AIR Plan Review 02/23/2023
3. 3rd AIR Plan Review 04/20/2023
4. 4th AIR Plan Review 05/25/2023

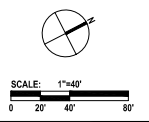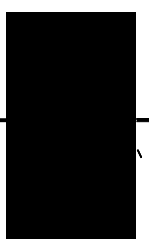

SCALE:	1"=40'
DATE:	05/25/2023
DESIGNED BY:	HL/PK
DRAWN BY:	PK
CHECKED BY:	RB

C-201

FILE NO:

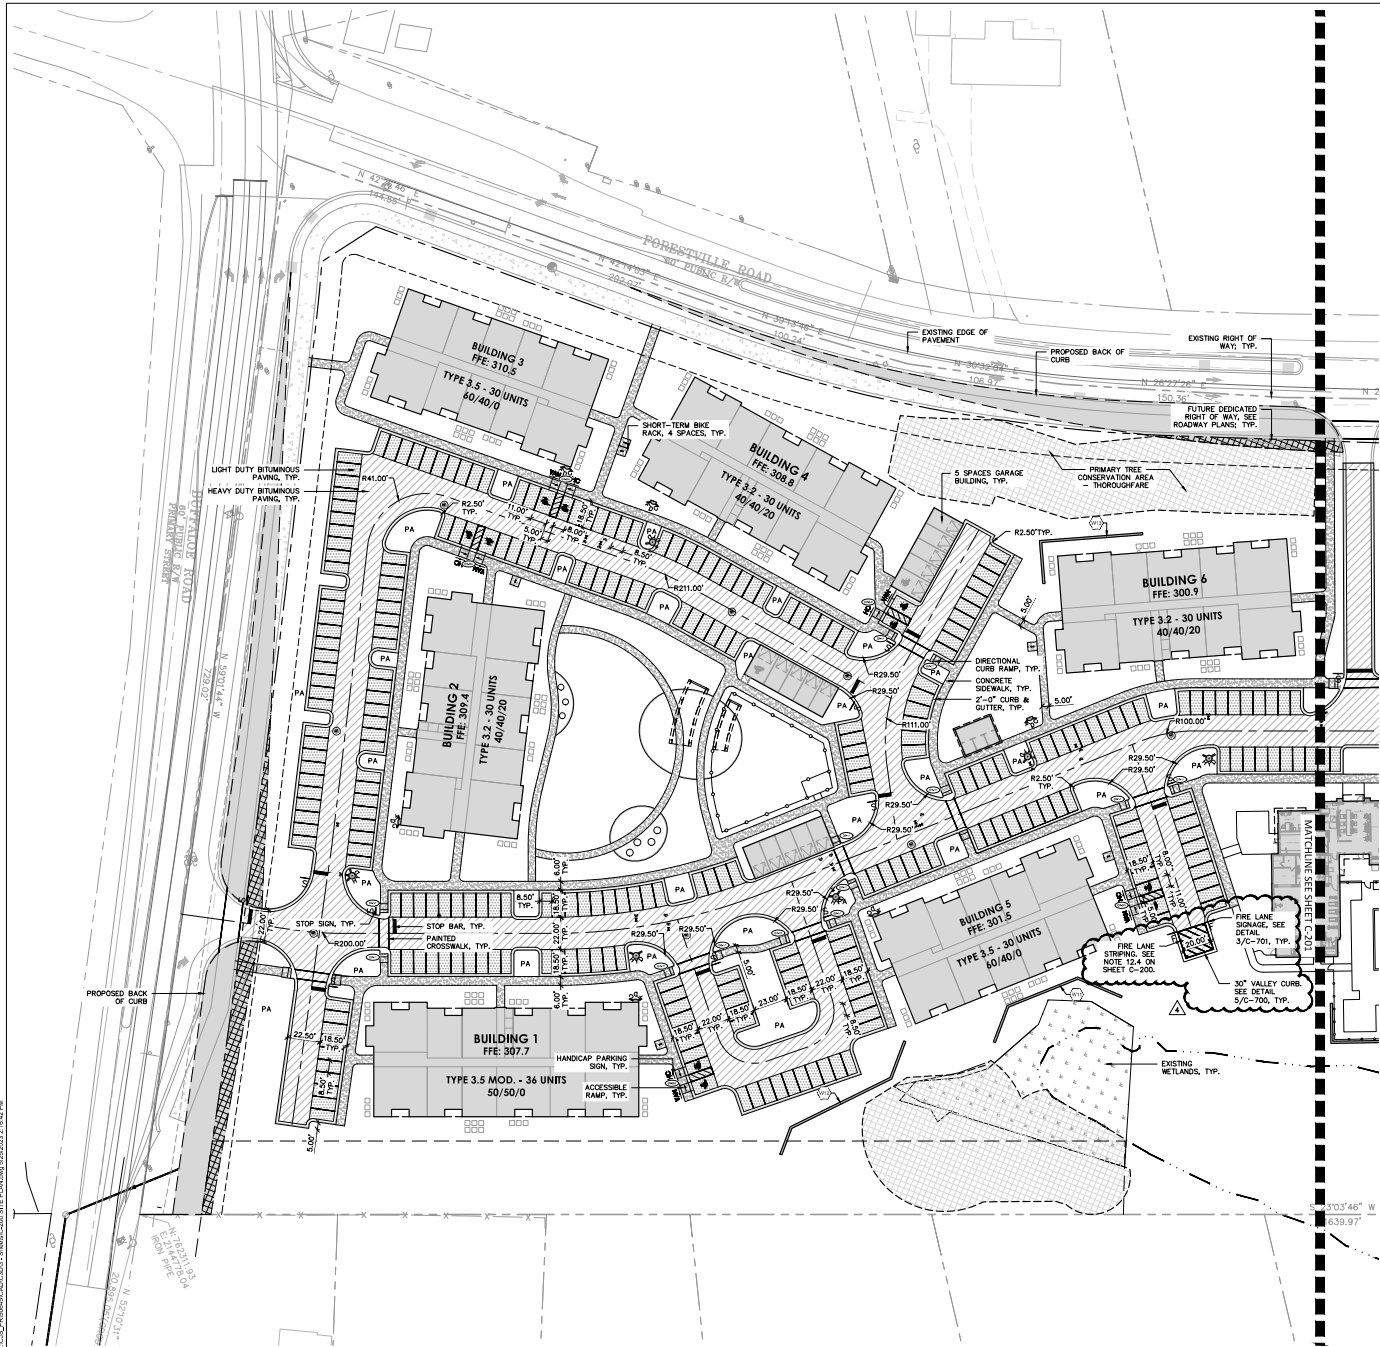

LEGEND

SYMBOL		DETAIL
	PROPOSED SIDEWALK	-/-
	PROPOSED ACCESSIBLE RAMP	-/-
	PROPOSED ACCESSIBLE SPACE	-/-
	PROPOSED ACCESSIBLE VAN SPACE	-/-
	PROPOSED ACCESSIBLE SIGN	-/-
	PROPOSED STOP SIGN	-/-
	CURB RAMP TYPE, SEE CURB RAMP SCHEDULE	-/-
	HEAVY DUTY CONCRETE	-/-
	HEAVY DUTY BITUMINOUS CONCRETE	-/-
	LIGHT DUTY BITUMINOUS CONCRETE	-/-
	REINFORCED TURF	-/-
	PROPOSED 2'-0" CURB & GUTTER	-/-
	PROPOSED LIGHTING	-/-

SITE WALL SCHEDULE

WALL #	WALL TYPE
1	SEGMENTAL BLOCK
2	C.I.P. CONCRETE
3	C.I.P. CONCRETE
4	C.I.P. CONCRETE
5	C.I.P. CONCRETE
6	SEGMENTAL BLOCK
7	C.I.P. CONCRETE
8	SEGMENTAL BLOCK
9	C.I.P. CONCRETE
10	SEGMENTAL BLOCK
11	SEGMENTAL BLOCK
12	SEGMENTAL BLOCK
13	SEGMENTAL BLOCK
14	SEGMENTAL BLOCK
15	SEGMENTAL BLOCK

TYPICAL RETAINING WALL NOTES
#1 SEE GRADING PLANS FOR TOP AND BOTTOM OF WALL ELEVATIONS.
#2 SEE STRUCTURAL PLANS FOR C.I.P. CONCRETE RETAINING WALL DESIGN.
#3 CONTRACTOR SHALL PROVIDE SHOP DRAWINGS SEALED BY A NC LICENSED ENGINEER FOR ALL SEGMENTAL BLOCK RETAINING WALLS.

CURB RAMP SCHEDULE

SYMBOL	RAMP TYPE	DETAIL
	TYPE N-1	10/C-700
	DEPRESSED SIDEWALK	11/C-700



Cole Jones & Stone
BOLTON & MENK, INC.

418 S DAWSON STREET
SUITE 317
RALEIGH, NC 27601
Phone: (919) 719-1800
Email: raleigh@bolton-menk.com
www.bolton-menk.com

TERWILLIGER PAPPAS



510 GLENWOOD AVE
SUITE 317
RALEIGH, NC 27603

**SOLIS BUFFALO RD
MULTIFAMILY**

5017 FORESTVILLE RD
RALEIGH, NC 27615

SITE PLAN - SOUTH
ENLARGEMENT

PROJECT NO:	50645
REVISIONS:	
1.	ASR Submittal 11/09/2022
2.	1st ASR Plan Review 01/12/2023
3.	2nd ASR Plan Review 02/23/2023
4.	3rd ASR Plan Review 04/20/2023
5.	4th ASR Plan Review 05/25/2023

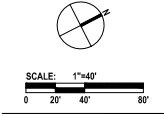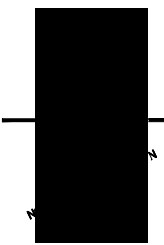

SCALE:	1"=40'
DATE:	05/25/2023
DESIGNED BY:	HB/PK
DRAWN BY:	PK
CHECKED BY:	HB

STORM DRAIN SCHEDULE NOTES

- "CB" STRUCTURES TO BE CATCH BASINS (NCDOT STD. 840.02).
- "CO" STRUCTURES TO BE CLEAN-OUTS.
- "DI" STRUCTURES TO BE DRAIN INLETS (NCDOT STD. 840.14).
- "FE" STRUCTURES TO BE FLARED END SECTION.
- "JB" STRUCTURES TO BE JUNCTION BOXES (NCDOT STD. 840.31 WITH MANHOLE).
- "MH" STRUCTURES TO BE MANHOLES (NCDOT STD. 840.02).
- "SD" TO BE STORMWATER OUTLET CONTROL STRUCTURE.
- "HDPE" TO BE HIGH-DENSITY POLYETHYLENE PIPE (AASHTO M252 AND AASHTO M294, TYPE S; DUAL WALL WITH SMOOTH INTERIOR).
- "RCP" TO BE REINFORCED CONCRETE PIPE (ASTM C 76), CLASS III UNLESS NOTED OTHERWISE.
- US GRATE ELEVATION FOR CB IS AT EDGE OF PAVEMENT.
- US GRATE ELEVATION FOR DI IS AT CENTER OF GRATE.
- US GRATE ELEVATION FOR MH OR JB IS AT TOP OF LID.
- US GRATE ELEVATION FOR CO IS AT TOP OF CAP.

GENERAL NOTES

- CONTRACTOR TO FIELD VERIFY LOCATION & ELEVATION OF ALL EXISTING UTILITIES PRIOR TO CONSTRUCTION.
- UTILITY CONSTRUCTION SHALL BE IN ACCORDANCE WITH CITY OF RALEIGH STANDARDS AND SPECIFICATIONS UNLESS OTHERWISE NOTED.
- STORM DRAINAGE INSTALLATION SHALL BE IN ACCORDANCE WITH CITY OF RALEIGH STANDARDS AND SPECIFICATIONS.
- SEE STORM DRAINAGE SCHEDULE ON SHEET C-403 FOR LOCATION OF WATER-TIGHT JOINTS.
- SEE GRADING AND EARTHWORK AND BUILDING AVERAGE GRADE CALCULATIONS ON SHEET C-403.

RETAINING WALL NOTES

- THE CONTRACTOR SHALL BE RESPONSIBLE FOR RETAINING THE SERVICES OF A QUALIFIED ENGINEER TO COMPLETE THE DESIGN AND PERMITTING OF ALL PROPOSED SEGMENTAL CONCRETE BLOCK RETAINING WALLS SHOWN ON THE DRAWINGS. THE DESIGN OF ALL RETAINING WALLS IS TO BE CONDUCTED IN ACCORDANCE WITH THE NORTH CAROLINA STATE BUILDING CODE, SECTION 1807. DETAILED RETAINING WALL DESIGN DRAWINGS SEALED BY A NORTH CAROLINA LICENSED ENGINEER, SHALL BE SUBMITTED TO THE LOCAL PLAN REVIEW AUTHORITY PRIOR TO CONSTRUCTION. A NORTH CAROLINA LICENSED ENGINEER MUST PERFORM CONSTRUCTION OBSERVATION, VERIFYING IN A SEALED LETTER TO THE LOCAL JURISDICTION AUTHORITY THAT THE RETAINING WALLS WERE CONSTRUCTED IN ACCORDANCE WITH THE APPROVED ENGINEERED DRAWINGS, IN COMPLIANCE WITH SECTION 1704 OF THE NORTH CAROLINA STATE BUILDING CODE.
- BOTTOM OF WALL ELEVATIONS (BW) REFERENCE THE BOTTOM OF WALL AT FINISHED GRADE. TYPICAL IN ALL AREAS REFER TO WALL STRUCTURAL PLANS BY OTHERS FOR TOP AND BOTTOM OF FOOTING ELEVATIONS.
- ALL RETAINING WALLS GREATER THAN 4 FT (RESIDENTIAL) OR 5 FT (COMMERCIAL) IN HEIGHT REQUIRE A BUILDING PERMIT PRIOR TO CONSTRUCTION.

LEGEND

SYMBOL		
	PROPOSED CONTOUR	-/-
	PROPOSED INDEX CONTOUR	-/-
	PROPOSED SPOT ELEVATION	-/-
	PROPOSED STORM DRAINAGE	-/-
	PROPOSED CURB INLET	-/-
	PROPOSED DROP INLET	-/-
	PROPOSED AREA DRAIN	-/-
	PROPOSED MANHOLE	-/-
	PROPOSED JUNCTION BOX	-/-
	PROPOSED GRAVEL AND RIPRAP APPROACH	-/-
	PROPOSED FLARED END SECTION	-/-

DETAIL

-/-	
-/-	
Cole Jensen & Stone
BOLTON & MENK, INC.

418 S DAWSON STREET
RALEIGH, NORTH CAROLINA 27601
Phone: (919) 719-1800
Email: raleigh@bolton-menk.com
www.bolton-menk.com

TERWILLIGER PAPPAS

510 GLENWOOD AVE
SUITE 317
RALEIGH, NC 27603
**SOLIS BUFFALO RD
MULTIFAMILY**

5017 FORESTVILLE RD
RALEIGH, NC 27618


**OVERALL GRADING
AND DRAINAGE PLAN**

PROJECT NO:

50645

REVISIONS:


D.	ASR Submittal 11/09/2022
1.	1st ASR Plan Review 01/12/2023
2.	2nd ASR Plan Review 02/23/2023
3.	3rd ASR Plan Review 04/28/2023
4.	4th ASR Plan Review 05/25/2023

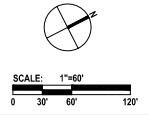


SCALE:	1"=60'
DATE:	05/25/2023
DESIGNED BY:	AH
DRAWN BY:	AH
CHECKED BY:	BL TH

C-400

FILE NO:

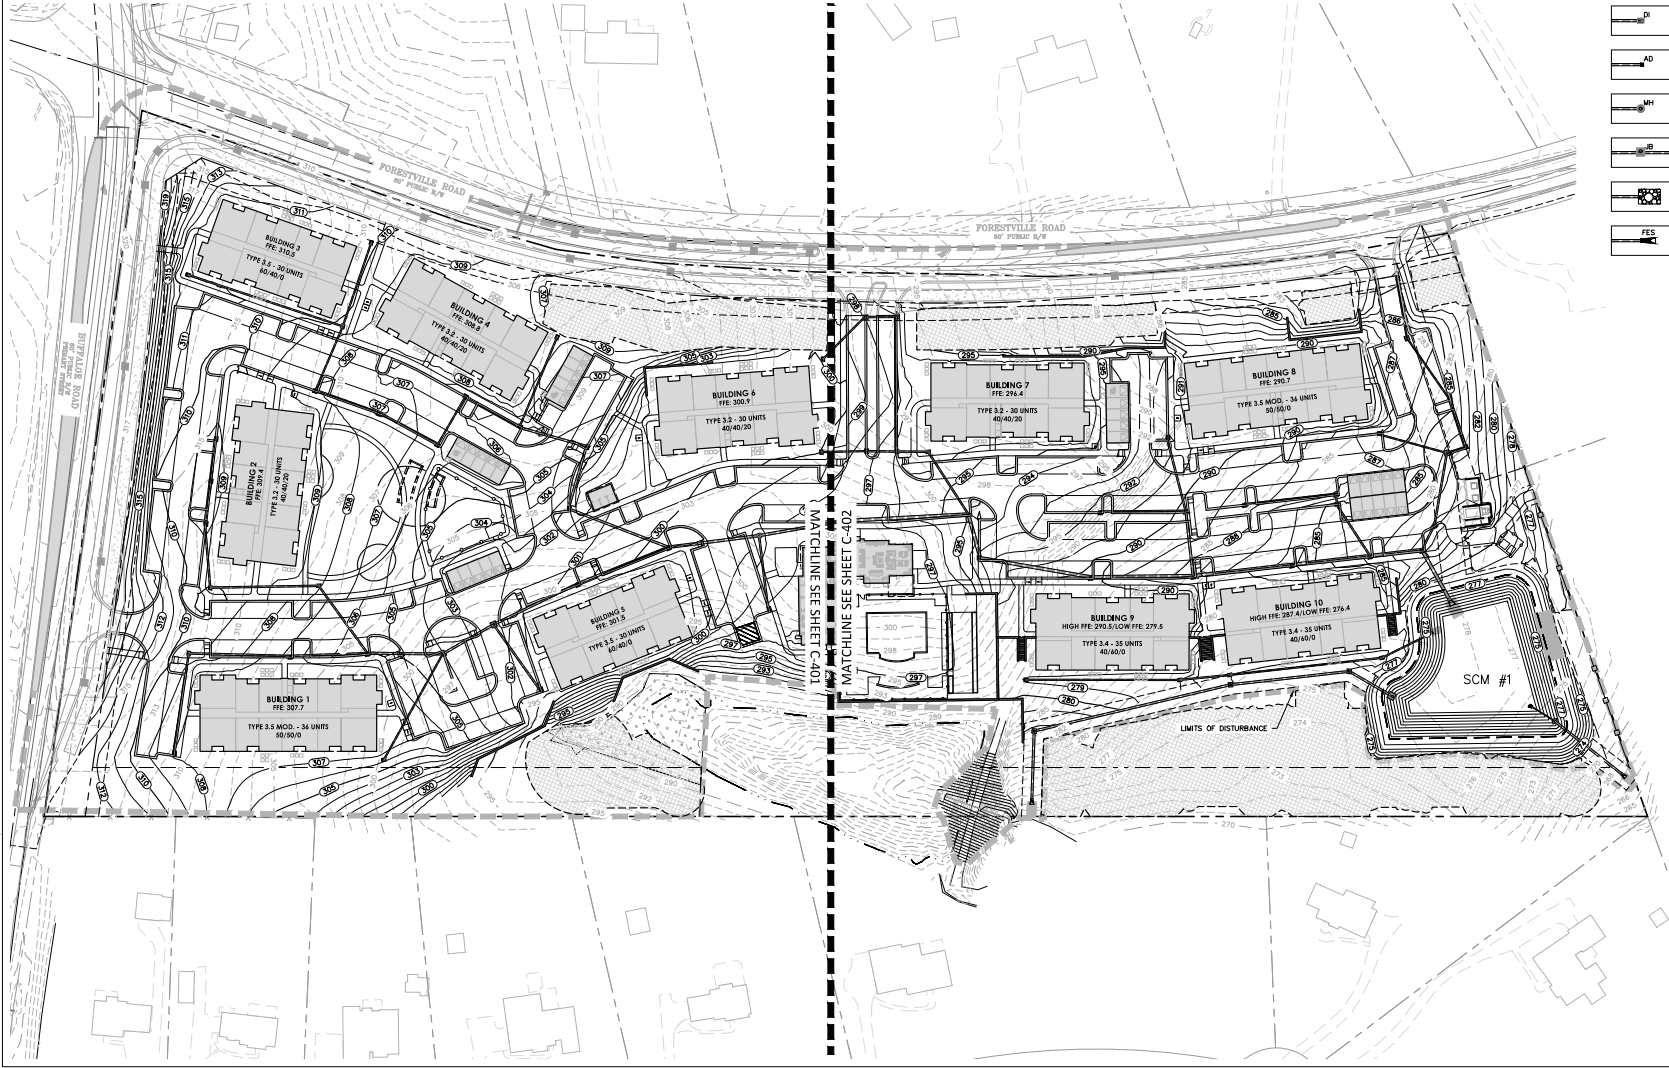

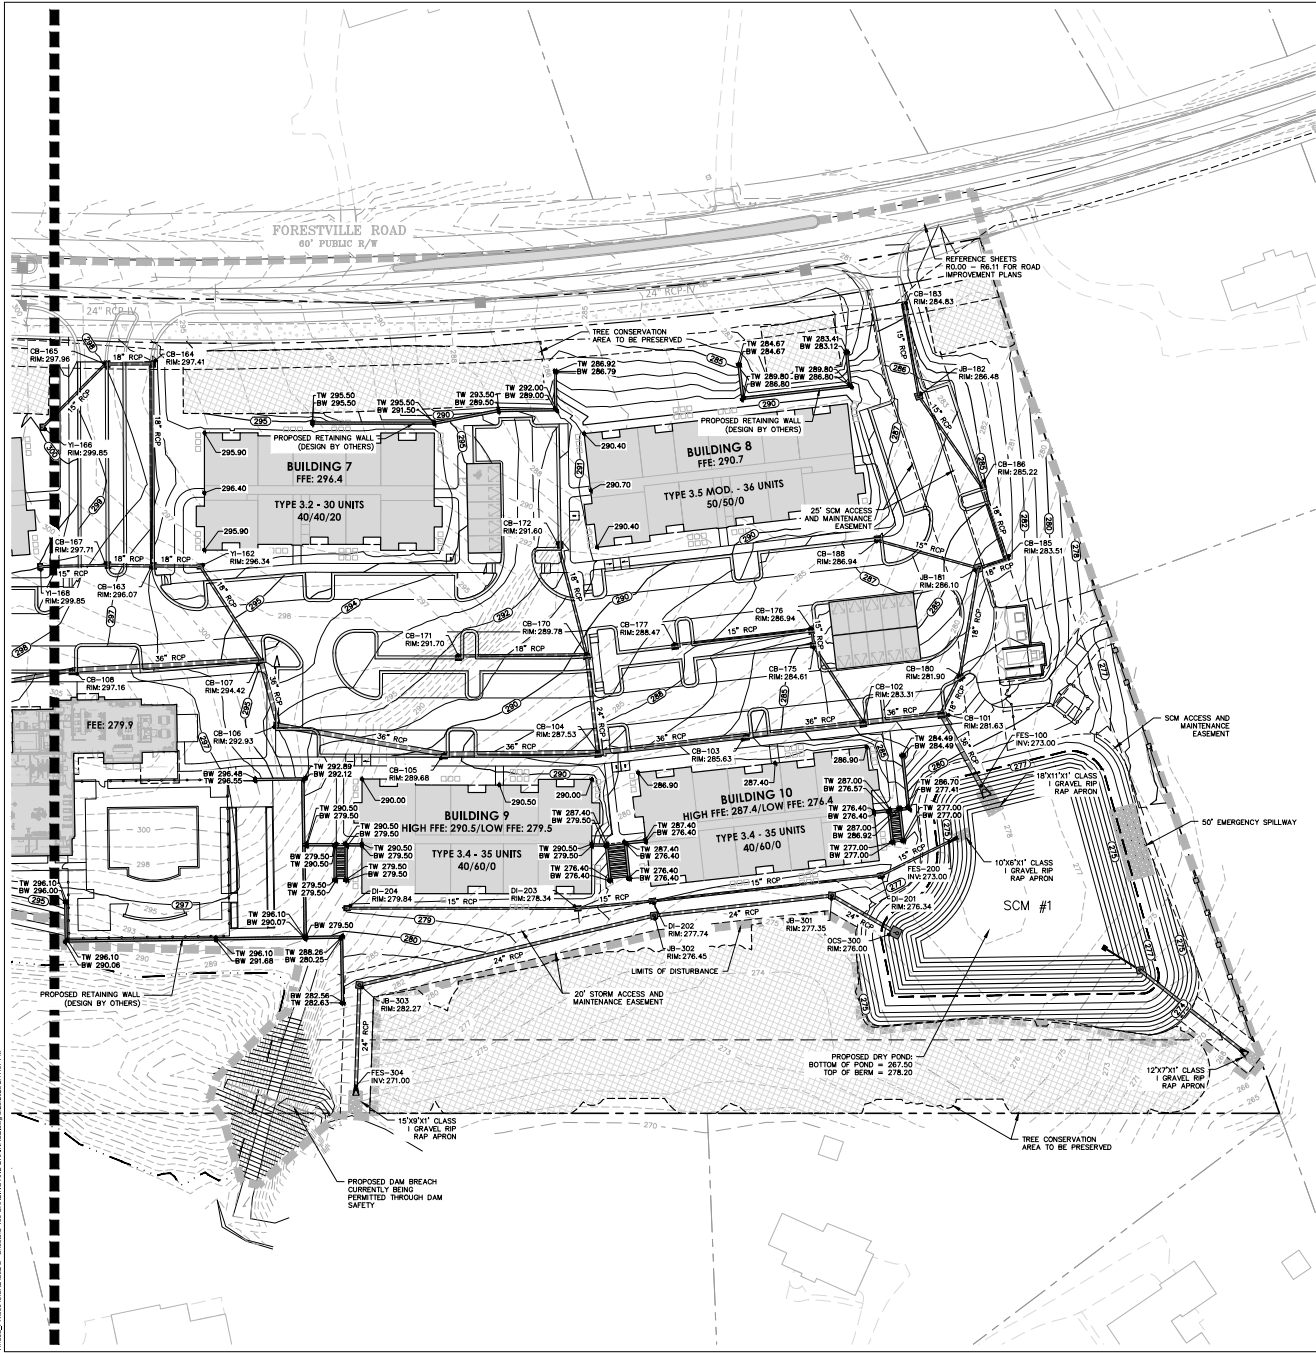

LEGEND

- | | |
|--|----------------------------------|
| | PROPOSED CONTOUR |
| | PROPOSED INDEX CONTOUR |
| | PROPOSED SPOT ELEVATION |
| | PROPOSED STORM DRAINAGE |
| | PROPOSED CURB INLET |
| | PROPOSED DROP INLET |
| | PROPOSED AREA DRAIN |
| | PROPOSED MANHOLE |
| | PROPOSED JUNCTION BOX |
| | PROPOSED GRAVEL AND RIPRAP APRON |
| | PROPOSED FLARED END SECTION |

DETAIL

- | | |
|--|-----|
| | -/- |
| | -/- |
Cole Jones & Stone
BOLTON & MENK, INC.

418 S DAWSON STREET
RALEIGH, NORTH CAROLINA 27601
Phone: (919) 719-1800
Email: raleigh@bolton-menk.com
www.bolton-menk.com

TERWILLIGER PAPPAS

510 GLENWOOD AVE
SUITE 317
RALEIGH, NC 27603

SOLIS BUFFALO RD
MULTIFAMILY


5017 FORESTVILLE RD
RALEIGH, NC 27616

GRADING AND DRAINAGE - NORTH ENLARGEMENT

PROJECT NO:
50645

REVISIONS:

- | | |
|----|--------------------------------|
| 1. | 1st ASR Plan Review 01/12/2023 |
| 2. | 2nd ASR Plan Review 02/23/2023 |
| 3. | 3rd ASR Plan Review 04/20/2023 |
| 4. | 4th ASR Plan Review 05/25/2023 |

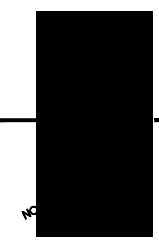


SCALE: 1"=40'
0 20' 40' 80'

SCALE:	1" = 40'
DATE:	05/25/2023
DESIGNED BY:	AH
DRAWN BY:	AH
CHECKED BY:	BL TH

C-401

FILE NO:

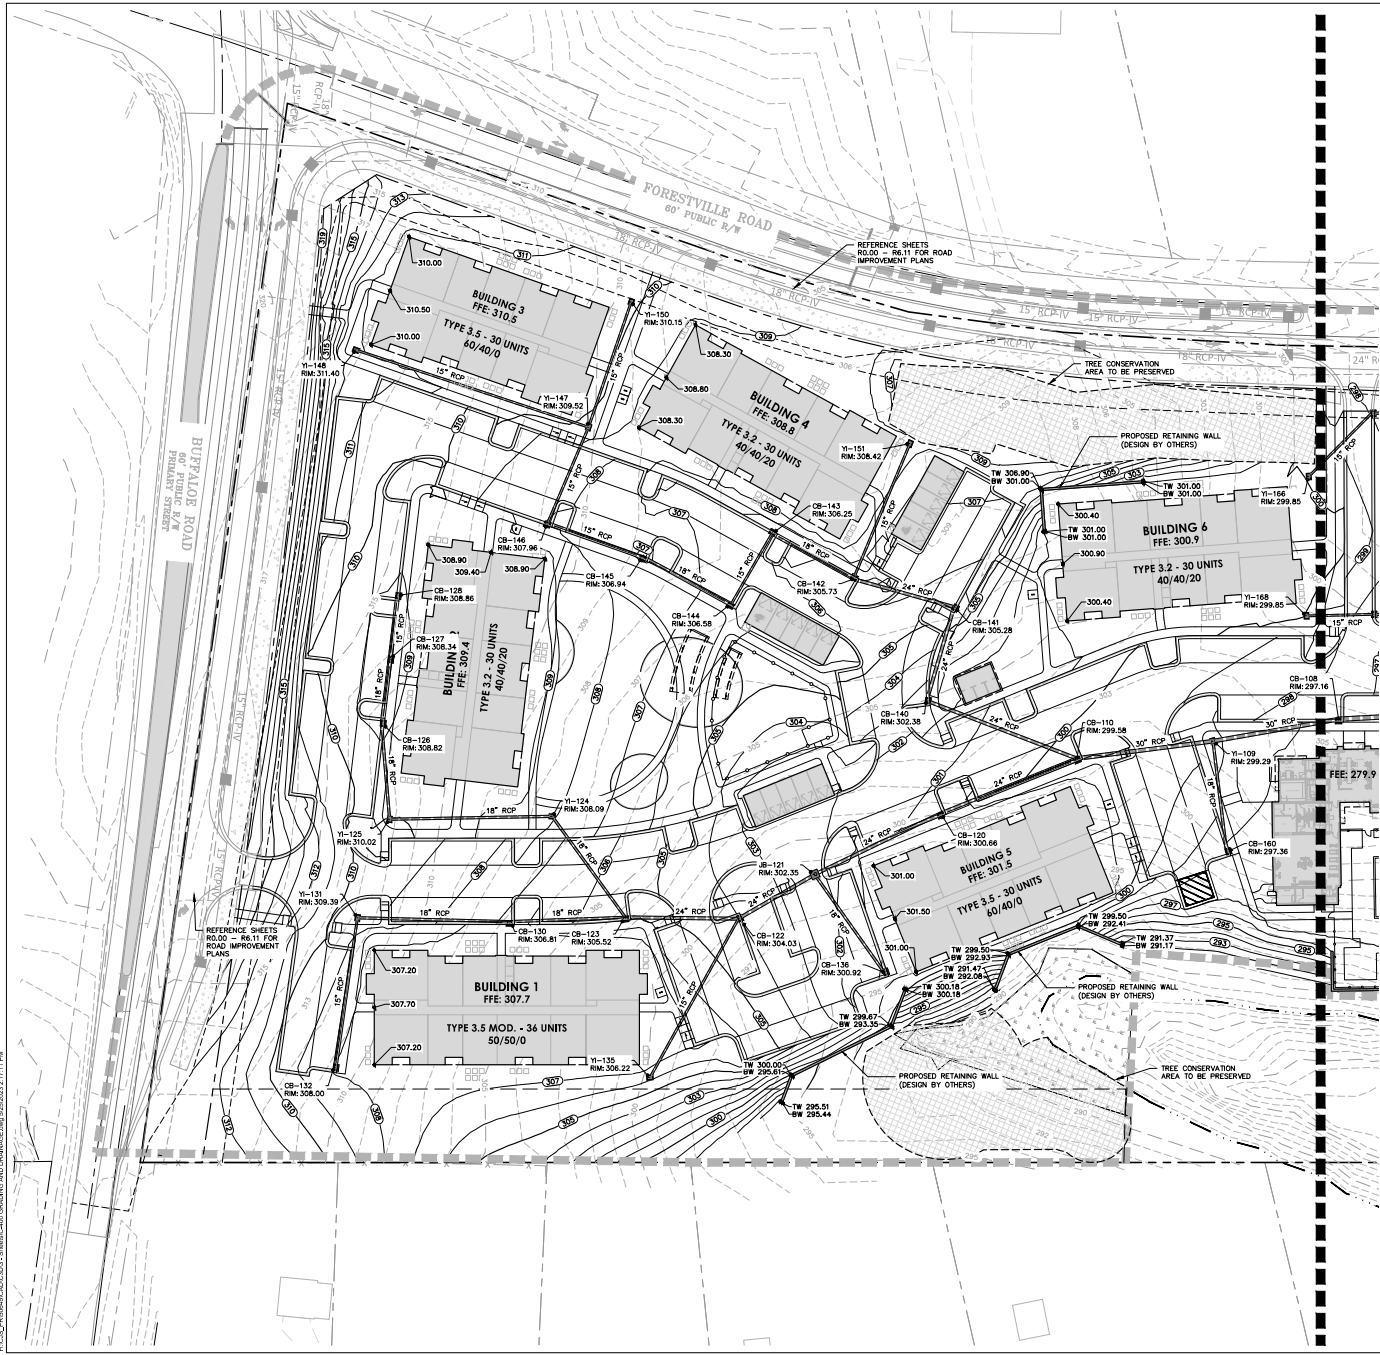

LEGEND

- | | |
|--|----------------------------------|
| | PROPOSED CONTOUR |
| | PROPOSED INDEX CONTOUR |
| | PROPOSED SPOT ELEVATION |
| | PROPOSED STORM DRAINAGE |
| | PROPOSED CURB INLET |
| | PROPOSED DROP INLET |
| | PROPOSED AREA DRAIN |
| | PROPOSED MANHOLE |
| | PROPOSED JUNCTION BOX |
| | PROPOSED GRAVEL AND RIPRAP APRON |
| | PROPOSED FLARED END SECTION |

DETAIL

- | | |
|--|-----|
| | -/- |
| | -/- |
Cole Jones & Stone
BOLTON & MENK, INC.

418 S DAWSON STREET
RALEIGH, NORTH CAROLINA 27601
Phone: (919) 719-1800
Email: raleigh@bolton-menk.com
www.bolton-menk.com

TERWILLIGER PAPPAS

510 GLENWOOD AVE
SUITE 317
RALEIGH, NC 27603


SOLIS BUFFALO RD
MULTIFAMILY

5017 FORESTVILLE RD
RALEIGH, NC 27615

GRADING AND DRAINAGE - SOUTH
ENLARGEMENT

PROJECT NO:
50645

REVISIONS:
1. 1st ASR Plan Review 01/09/2022
2. 2nd ASR Plan Review 01/12/2023
3. 3rd ASR Plan Review 02/23/2023
4. 4th ASR Plan Review 02/25/2023

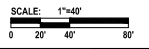

SCALE:	1"=40'
DATE:	05/25/2023
DESIGNED BY:	AH
DRAWN BY:	AH
CHECKED BY:	BL, TH

C-402

FILE NO:

STORM DRAINAGE SCHEDULE									
FROM	TO	SIZE (IN)	MATERIAL	LENGTH (FT)	SLOPE (F/T)	INV OUT (FT)	INV IN (FT)	PIPE	
CB-128	CB-127	15 Inch	Reinforced Concrete Pipe	44	0.0114	304.30	303.80	P-84	
CB-132	YI-131	15 Inch	Reinforced Concrete Pipe	103	0.0097	304.00	303.00	P-83	
YI-135	CB-122	15 Inch	Reinforced Concrete Pipe	124	0.0218	302.70	300.00	P-82	
CB-144	CB-143	15 Inch	Reinforced Concrete Pipe	55	0.0109	301.20	300.60	P-81	
YI-150	YI-147	15 Inch	Reinforced Concrete Pipe	90	0.0111	307.00	306.00	P-80	
YI-151	CB-142	15 Inch	Reinforced Concrete Pipe	100	0.0150	304.50	303.00	P-79	
CB-165	YI-166	15 Inch	Reinforced Concrete Pipe	61	0.0115	295.50	294.80	P-78	
CB-167	YI-168	15 Inch	Reinforced Concrete Pipe	45	0.0111	295.00	294.50	P-77	
JB-182	CB-183	15 Inch	Reinforced Concrete Pipe	61	0.0114	277.50	276.80	P-76	
JB-301	JB-302	24 Inch	Reinforced Concrete Pipe	122	0.0057	273.50	272.80	P-75	
OCS-310	FES-311	24 Inch	Reinforced Concrete Pipe	87	0.0058	267.50	267.00	P-74	
YI-148	YI-147	15 Inch	Reinforced Concrete Pipe	167	0.0102	306.00	304.30	P-73	
JB-303	FES-304	24 Inch	Reinforced Concrete Pipe	69	0.0058	271.40	271.00	P-72	
JB-302	JB-303	24 Inch	Reinforced Concrete Pipe	206	0.0053	272.70	271.60	P-71	
OCS-300	JB-301	24 Inch	Reinforced Concrete Pipe	50	0.0060	273.90	273.60	P-69	
DI-201	FES-200	15 Inch	Reinforced Concrete Pipe	52	0.0058	273.30	273.00	P-68	
DI-202	DI-201	15 Inch	Reinforced Concrete Pipe	157	0.0083	274.70	273.40	P-67	
DI-203	DI-202	15 Inch	Reinforced Concrete Pipe	51	0.0098	275.30	274.80	P-66	
DI-204	DI-203	15 Inch	Reinforced Concrete Pipe	157	0.0095	276.90	275.40	P-65	
CB-101	FES-100	36 Inch	Reinforced Concrete Pipe	56	0.0106	273.60	273.00	P-64	
CB-180	CB-181	18 Inch	Reinforced Concrete Pipe	29	0.0105	274.10	273.80	P-63	
CB-188	JB-181	15 Inch	Reinforced Concrete Pipe	71	0.0141	264.00	263.00	P-62	
JB-181	CB-180	18 Inch	Reinforced Concrete Pipe	75	0.0107	275.00	274.20	P-61	
CB-185	JB-181	18 Inch	Reinforced Concrete Pipe	19	0.0156	280.10	279.80	P-60	
CB-186	CB-185	18 Inch	Reinforced Concrete Pipe	63	0.0132	281.00	280.30	P-59	
JB-182	CB-186	15 Inch	Reinforced Concrete Pipe	74	0.0175	276.50	275.20	P-58	
CB-102	CB-101	36 Inch	Reinforced Concrete Pipe	63	0.0374	276.00	274.00	P-57	
CB-176	CB-175	15 Inch	Reinforced Concrete Pipe	12	0.0250	280.50	280.20	P-56	
CB-177	CB-176	15 Inch	Reinforced Concrete Pipe	94	0.0319	284.00	281.00	P-55	
CB-103	CB-102	36 Inch	Reinforced Concrete Pipe	81	0.0310	280.50	278.00	P-54	
CB-171	CB-170	18 Inch	Reinforced Concrete Pipe	87	0.0172	287.50	286.00	P-53	
CB-172	CB-170	18 Inch	Reinforced Concrete Pipe	77	0.0259	288.00	286.00	P-47	
CB-170	CB-104	24 Inch	Reinforced Concrete Pipe	67	0.0269	285.80	284.00	P-46	
CB-175	CB-102	18 Inch	Reinforced Concrete Pipe	61	0.0325	280.00	278.00	P-45	
CB-104	CB-103	36 Inch	Reinforced Concrete Pipe	101	0.0108	281.80	280.70	P-43	
CB-105	CB-104	36 Inch	Reinforced Concrete Pipe	105	0.0219	284.30	282.00	P-42	
CB-106	CB-105	36 Inch	Reinforced Concrete Pipe	115	0.0297	287.90	284.50	P-41	
CB-107	CB-106	36 Inch	Reinforced Concrete Pipe	46	0.0108	288.60	288.10	P-40	
CB-167	CB-163	18 Inch	Reinforced Concrete Pipe	31	0.0161	294.50	294.00	P-39	
YI-162	CB-107	18 Inch	Reinforced Concrete Pipe	76	0.0105	290.90	290.10	P-38	
CB-163	YI-162	18 Inch	Reinforced Concrete Pipe	33	0.0151	291.60	291.10	P-37	
CB-164	CB-163	18 Inch	Reinforced Concrete Pipe	138	0.0160	294.00	291.80	P-36	
CB-165	CB-164	18 Inch	Reinforced Concrete Pipe	31	0.0129	294.60	294.20	P-35	
CB-108	CB-107	36 Inch	Reinforced Concrete Pipe	129	0.0101	290.10	288.80	P-34	
YI-109	CB-108	30 Inch	Reinforced Concrete Pipe	87	0.0103	291.20	290.30	P-33	
CB-160	YI-109	18 Inch	Reinforced Concrete Pipe	76	0.0105	293.00	292.20	P-32	
CB-110	YI-109	30 Inch	Reinforced Concrete Pipe	94	0.0107	292.40	291.40	P-31	
CB-120	CB-110	24 Inch	Reinforced Concrete Pipe	100	0.0100	293.60	292.60	P-30	
CB-140	CB-110	24 Inch	Reinforced Concrete Pipe	110	0.0146	296.60	295.00	P-29	
CB-141	CB-140	24 Inch	Reinforced Concrete Pipe	67	0.0105	297.50	296.80	P-28	
CB-142	CB-141	24 Inch	Reinforced Concrete Pipe	71	0.0252	299.50	297.70	P-27	
CB-143	CB-142	18 Inch	Reinforced Concrete Pipe	63	0.0110	300.40	299.70	P-26	
CB-145	CB-144	18 Inch	Reinforced Concrete Pipe	68	0.0103	302.10	301.40	P-25	
CB-146	CB-145	15 Inch	Reinforced Concrete Pipe	69	0.0101	303.00	302.30	P-24	
YI-147	CB-146	15 Inch	Reinforced Concrete Pipe	71	0.0113	304.10	303.30	P-23	
JB-121	CB-120	24 Inch	Reinforced Concrete Pipe	95	0.0105	294.80	293.80	P-22	
CB-136	JB-121	18 Inch	Reinforced Concrete Pipe	82	0.0110	296.00	295.10	P-21	
CB-122	JB-121	24 Inch	Reinforced Concrete Pipe	60	0.0100	298.60	298.00	P-20	
CB-123	CB-122	24 Inch	Reinforced Concrete Pipe	77	0.0104	299.60	298.80	P-19	
CB-130	CB-123	18 Inch	Reinforced Concrete Pipe	79	0.0101	301.50	300.70	P-18	
YI-124	CB-123	18 Inch	Reinforced Concrete Pipe	85	0.0106	300.70	299.80	P-17	
YI-125	YI-124	18 Inch	Reinforced Concrete Pipe	111	0.0108	302.10	300.90	P-16	
CB-128	YI-125	18 Inch	Reinforced Concrete Pipe	66	0.0106	303.00	302.30	P-15	
CB-127	CB-126	15 Inch	Reinforced Concrete Pipe	44	0.0114	303.70	303.20	P-14	
YI-131	CB-130	18 Inch	Reinforced Concrete Pipe	104	0.0106	302.80	301.70	P-13	

BUILDING 1 AVERAGE GRADE CALCULATION					
FORESTVILLE RD FRONTAGE			BUFFALO RD FRONTAGE		
HIGHEST	LOWEST	AVERAGE	HIGHEST	LOWEST	AVERAGE
N/A	N/A	N/A	307.70	307.20	307.45

BUILDING 2 AVERAGE GRADE CALCULATION					
FORESTVILLE RD FRONTAGE			BUFFALO RD FRONTAGE		
HIGHEST	LOWEST	AVERAGE	HIGHEST	LOWEST	AVERAGE
308.40	308.80	308.15	N/A	N/A	N/A

BUILDING 3 AVERAGE GRADE CALCULATION					
FORESTVILLE RD FRONTAGE			BUFFALO RD FRONTAGE		
HIGHEST	LOWEST	AVERAGE	HIGHEST	LOWEST	AVERAGE
N/A	N/A	N/A	316.50	316.00	316.25

BUILDING 4 AVERAGE GRADE CALCULATION					
FORESTVILLE RD FRONTAGE			BUFFALO RD FRONTAGE		
HIGHEST	LOWEST	AVERAGE	HIGHEST	LOWEST	AVERAGE
N/A	N/A	N/A	308.80	308.20	308.50

BUILDING 5 AVERAGE GRADE CALCULATION					
FORESTVILLE RD FRONTAGE			BUFFALO RD FRONTAGE		
HIGHEST	LOWEST	AVERAGE	HIGHEST	LOWEST	AVERAGE
N/A	N/A	N/A	301.00	301.00	301.25

BUILDING 6 AVERAGE GRADE CALCULATION					
FORESTVILLE RD FRONTAGE			BUFFALO RD FRONTAGE		
HIGHEST	LOWEST	AVERAGE	HIGHEST	LOWEST	AVERAGE
N/A	N/A	N/A	303.90	303.40	303.65

BUILDING 7 AVERAGE GRADE CALCULATION					
FORESTVILLE RD FRONTAGE			BUFFALO RD FRONTAGE		
HIGHEST	LOWEST	AVERAGE	HIGHEST	LOWEST	AVERAGE
N/A	N/A	N/A	296.40	295.90	296.15

BUILDING 8 AVERAGE GRADE CALCULATION					
FORESTVILLE RD FRONTAGE			BUFFALO RD FRONTAGE		
HIGHEST	LOWEST	AVERAGE	HIGHEST	LOWEST	AVERAGE
N/A	N/A	N/A	299.70	299.20	299.45

BUILDING 9 AVERAGE GRADE CALCULATION					
FORESTVILLE RD FRONTAGE			BUFFALO RD FRONTAGE		
HIGHEST	LOWEST	AVERAGE	HIGHEST	LOWEST	AVERAGE
290.50	290.00	290.25	N/A	N/A	N/A

BUILDING 10 AVERAGE GRADE CALCULATION					
FORESTVILLE RD FRONTAGE			BUFFALO RD FRONTAGE		
HIGHEST	LOWEST	AVERAGE	HIGHEST	LOWEST	AVERAGE
287.40	286.90	287.15	N/A	N/A	N/A

GRADING AND EARTHWORK NOTES

- CONTRACTOR SHALL CONTACT INSPECTOR 48 HOURS BEFORE CONSTRUCTION.
- REFER TO EROSION CONTROL PLAN FOR CONSTRUCTION SEQUENCE REQUIREMENTS.
- ON-SITE BURIAL RITS REQUIRE A PERMIT.
- ANY GRADING BEYOND THE DEDICATED LINES INDICATED ON THE CONSTRUCTION DOCUMENTS IS A VIOLATION OF EROSION CONTROL ORDINANCES AND IS SUBJECT TO A FINE.
- GRADING MORE THAN ONE ACRE WITHOUT AN APPROVED EROSION CONTROL PLAN IS A VIOLATION OF EROSION CONTROL ORDINANCES AND IS SUBJECT TO A FINE.
- APPROVAL OF THIS PLAN IS NOT AN AUTHORIZATION TO GRADE ON ADJACENT PROPERTIES. WHEN FIELD CONDITIONS WARRANT OFF-SITE GRADING, PERMISSION MUST BE OBTAINED FROM THE AFFECTED PROPERTY OWNER(S).
- THE CONTRACTOR SHALL IMMEDIATELY REPORT TO OWNER ANY DISCREPANCIES FOUND BETWEEN ACTUAL FIELD CONDITIONS AND CONSTRUCTION DOCUMENTS AND SHALL WAIT FOR INSTRUCTION PRIOR TO PROCEEDING.
- CONTRACTOR SHALL VERIFY LOCATION OF ALL EXISTING UTILITIES IN THE FIELD PRIOR TO BEGINNING CONSTRUCTION.
- LIMITS OF CLEARING SHOWN ON GRADING PLAN ARE BASED UPON THE APPROXIMATE CUT AND FILL SLOPE LIMITS, OR OTHER GRADING REQUIREMENTS.
- ALL ELEVATIONS ARE IN REFERENCE TO THE SITE BENCHMARK. CONTRACTOR SHALL VERIFY THE BENCHMARK PRIOR TO GROUND BREAKING.
- THE PROPOSED CONTOURS AND SPOT ELEVATIONS SHOWN WITHIN ROADWAYS, PARKING LOTS, AND SIDEWALK AREAS REFLECT FINISHED ELEVATIONS INCLUDING PAVEMENT. REFER TO PAVEMENT CROSS SECTION DATA TO ESTABLISH CORRECT SUBBASE OR AGGREGATE BASE COURSE ELEVATIONS TO BE COMPLETED UNDER THIS CONTRACT.
- GRADES SHALL BE ESTABLISHED TO PROVIDE A SMOOTH SURFACE, FREE FROM IRREGULAR SURFACE CHANGES. GRADING SHALL COMPLY WITH COMPACTION REQUIREMENTS AND GRADE CROSS SECTIONS, LINES, AND ELEVATIONS INDICATED. WHERE NO SPOT GRADES ARE INDICATED, THE GRADE SHALL BE ESTABLISHED BASED ON INTERPOLATION OF THE ELEVATIONS BETWEEN ADJACENT SPOT GRADES WHILE MAINTAINING APPROPRIATE TRANSITION AT STRUCTURES AND PAVING, AND UNLESS OTHERWISE SPECIFIED, A FIVE FOOT INLET.
- CONTRACTOR SHALL ENSURE FLOODING DRAINAGE SUCH THAT RUNOFF WILL DRAIN BY GRAVITY FLOW ACROSS NEW GRADED AREAS TO NEW OR EXISTING DRAINAGE INLETS OR SHEET OVERLAND.
- ALL SIDEWALKS, STOOPS, TERRACES AND OTHER PAVED AREAS SHALL SLOPE AWAY FROM BUILDINGS AT 2:20R MAXIMUM.
- COLEJENETT AND STONE, P.A., HAS NOT PERFORMED ANY GEOTECHNICAL EVALUATIONS OF THE SUBJECT PROPERTY AND HAS NOT MADE ANY DETERMINATIONS AS TO THE SUITABILITY OF SITE SOILS FOR USE AS FILL BENEATH PROPOSED BUILDINGS, DRIVEWAYS, PARKING AREAS, OR FOR OTHER USES. ALL EARTHWORK SHALL BE COMPLETED IN ACCORDANCE WITH THE RECOMMENDATIONS OF A QUALIFIED GEOTECHNICAL ENGINEER WHO SHALL BE RETAINED BY THE OWNER.
- ALL FILL SHALL BE PLACED IN MAXIMUM 8-INCH LIFTS AND COMPACTED. ALL FILL WITHIN LIMITS OF BUILDING AND PAVEMENT AREAS SHALL BE COMPACTED TO 100% OF MAXIMUM STANDARD PROCTOR DENSITY WITHIN THE TOP 12 INCHES AND A MINIMUM 90% OF MAXIMUM STANDARD PROCTOR DENSITY BELOW 12-INCH DEPTH. FILL WITHIN LANDSCAPED AREAS SHALL BE COMPACTED TO MINIMUM 90% OF MAXIMUM STANDARD PROCTOR DENSITY. MAXIMUM STANDARD PROCTOR DENSITY SHALL BE DETERMINED IN ACCORDANCE WITH ASTM D 698. REFER TO GEOTECHNICAL ENGINEER'S REPORT FOR ADDITIONAL EARTHWORK SPECIFICATIONS AND REQUIREMENTS.
- FOR SLOPE CONSTRUCTION 3:1 AND STEEPER AND EXCEEDING 5 FEET IN VERTICAL HEIGHT, THE CONTRACTOR SHALL COORDINATE WITH A GEOTECHNICAL ENGINEER ON THE SUITABILITY OF SOILS PLANNED FOR THESE SLOPES AND FOLLOW RECOMMENDATIONS SET FORTH BY THE GEOTECHNICAL ENGINEER FOR SLOPE CONSTRUCTION. ALL SUCH SLOPES SHALL BE TRACKED TOP TO BOTTOM AND STABILIZED WITH A ROLLED EROSION CONTROL BLANKET CONSISTING OF POLYPROPYLENE NETTING AND A STRAW/COCONUT FIBER MATRIX, STAKED TO MANUFACTURER'S RECOMMENDATIONS. TOP SOIL PLACEMENT ON SLOPES SHALL BE INSTALLED IN A BENCHED PATTERN.
- ALL PROJECT SUBGRADE SHALL BE INSPECTED BY THE GEOTECHNICAL ENGINEER. IF THE GEOTECHNICAL ENGINEER DETERMINES THAT UNSATISFACTORY SOIL IS PRESENT, THE UNSATISFACTORY MATERIAL SHALL BE REMOVED AND REPLACED WITH COMPACTED BACKFILL. SUCH ADDITIONAL AUTHORIZED EXCAVATION SHALL BE PAID FOR ACCORDING TO THE CONTRACT PROVISIONS FOR UNIT PRICES.
- CONTRACTOR SHALL BE RESPONSIBLE FOR MAINTAINING ALL FILL AND BACKFILL MATERIAL WITHIN 3 PERCENT OF THE OPTIMUM MOISTURE CONTENT AS DETERMINED BY ASTM D 698. SOIL MATERIAL THAT EXCEEDS THE OPTIMUM MOISTURE CONTENT BY 3 PERCENT OR MORE, AND IS TOO WET TO COMPACT TO THE SPECIFIED DRY UNIT WEIGHT, SHALL BE SCARIFIED AND AIR DRIED, LIME STABILIZED, OR REMOVED AND REPLACED.
- CONTRACTOR SHALL PROVIDE ALL Dewatering MEASURES NECESSARY, INCLUDING WELL PUMPS, SUMP PUMPS, TEMPORARY SHORING, ETC., TO ENSURE COMPLETION OF STABLE EXCAVATION AND BACKFILL OPERATIONS. GROUNDWATER SHALL BE MAINTAINED A MINIMUM OF 2 FT. BELOW THE BOTTOM OF ALL EXCAVATIONS.
- CONTRACTOR SHALL CONSULT WITH THE GEOTECHNICAL ENGINEER AND PROVIDE ANY AND ALL SHORING DETERMINED TO BE NECESSARY TO PROTECT EXISTING BUILDING FOUNDATIONS OR OTHER ADJACENT IMPROVEMENTS.
- OWNER SHALL ENGAGE A QUALIFIED INDEPENDENT GEOTECHNICAL ENGINEERING TESTING AGENCY TO PERFORM FIELD QUALITY CONTROL TESTING. TESTING AGENCY SHALL TEST COMPACTION OF SOILS IN PLACE ACCORDING TO ASTM D2922 AND ASTM D2937, AS APPLICABLE. TEST SHALL BE PERFORMED AT EACH COMPACTED BACKFILL LAYER AT A RATE OF NOT LESS THAN ONE TEST FOR EACH 2500 SF OF FILL AREA OR ONE TEST PER EACH 100 LF OF WALL OR TRENCH LENGTH.
- ALL GRADED OR DISTURBED AREAS BEYOND THE LIMITS OF PAVING, SIDEWALKS, BUILDINGS, ETC., THAT ARE NOT OTHERWISE LANDSCAPED PER THE LANDSCAPING PLAN, SHALL BE STABILIZED WITH A NEW LAWN SEED IN ACCORDANCE WITH THE SEEDING SPECIFICATION. CONTRACTOR SHALL MAINTAIN SEEDED AREAS UNTIL A HEALTHY STAND OF GRASS IS ESTABLISHED.



Cole Jenett & Stone
BOLTON & MENK, INC.

418 S DAWSON STREET
RALEIGH, NORTH CAROLINA 27601
Phone: (919) 715-1800
Email: raleigh@bolton-menk.com
www.bolton-menk.com

TERWILLIGER PAPPAS

510 GLENWOOD AVE
SUITE 317
RALEIGH, NC 27603

SOLIS BUFFALO RD
MULTIFAMILY

5017 FORESTVILLE RD
RALEIGH, NC 27618

GRADING AND
DRAINAGE - NOTES

PROJECT NO:
50645

REVISIONS:

0. AIR Submittal 11/09/2022
1. 1st AIR Plan Review 01/12/2023
2. 2nd AIR Plan Review 02/23/2023
3. 3rd AIR Plan Review 04/08/2023
4. 4th AIR Plan Review 05/25/2023

SCALE:	N/A
DATE:	05/25/2023
DESIGNED BY:	VALUE
DRAWN BY:	VALUE
CHECKED BY:	VALUE

C-403

FILE NO:

CITY OF RALEIGH STANDARD UTILITY NOTES

1. ALL MATERIALS & CONSTRUCTION METHODS SHALL BE IN ACCORDANCE WITH CITY OF RALEIGH DESIGN STANDARDS, DETAILS & SPECIFICATIONS (REFERENCE: CORPUS HANDBOOK, CURRENT EDITION).
2. UTILITY SEPARATION REQUIREMENTS:
- a) A DISTANCE OF 100' SHALL BE MAINTAINED BETWEEN SANITARY SEWER & ANY PRIVATE OR PUBLIC WATER SUPPLY SOURCE SUCH AS AN IMPOUNDED RESERVOIR USED AS A SOURCE OF DRINKING WATER. IF ADEQUATE LATERAL SEPARATION CANNOT BE ACHIEVED, FERROUS SANITARY SEWER PIPE SHALL BE SPECIFIED & INSTALLED TO WATERLINE SPECIFICATIONS. HOWEVER, THE MINIMUM SEPARATION SHALL NOT BE LESS THAN 20' FROM A PRIVATE WELL OR 50' FROM A PUBLIC WELL.
- b) WHEN INSTALLING WATER AND/OR SEWER MAINS, THE HORIZONTAL SEPARATION BETWEEN UTILITIES SHALL BE 10' IF THIS SEPARATION CANNOT BE MAINTAINED DUE TO EXISTING CONDITIONS, THE VARIATION ALLOWED IS THE WATER MAIN IN A SEPARATE TRENCH WITH THE ELEVATION OF THE WATER MAIN AT LEAST 18" ABOVE THE TOP OF THE SEWER AND MUST BE APPROVED BY THE PUBLIC UTILITIES DIRECTOR. ALL DISTANCES ARE MEASURED FROM OUTSIDE DIAMETER TO OUTSIDE DIAMETER.
- c) WHERE IT IS IMPOSSIBLE TO OBTAIN PROPER SEPARATION, OR ANYTIME A SANITARY SEWER PASSES OVER A WATERMAIN, DIP MATERIALS OR STEEL ENCASEMENT EXTENDED 10' ON EACH SIDE OF CROSSING MUST BE SPECIFIED & INSTALLED TO WATERLINE SPECIFICATIONS.
- d) 5.0' MINIMUM HORIZONTAL SEPARATION IS REQUIRED BETWEEN ALL SANITARY SEWER AND STORM SEWER FACILITIES, UNLESS DIP MATERIAL IS SPECIFIED FOR SANITARY SEWER.
- e) MAINTAIN 18" MIN. VERTICAL SEPARATION AT ALL WATERMAIN AND ROP STORM DRAIN CROSSINGS; MAINTAIN 24" MIN. VERTICAL SEPARATION AT ALL SANITARY SEWER AND ROP STORM DRAIN CROSSINGS. WHERE ADEQUATE SEPARATIONS CANNOT BE ACHIEVED, SPECIFY DIP MATERIALS AND A CONCRETE CRADLE HAVING 6" MIN. CLEARANCE (PER CORPUS DETAILS W-41 & S-49).

- f) ALL OTHER UNDERGROUND UTILITIES SHALL CROSS WATER & SEWER FACILITIES WITH 18" MIN. VERTICAL SEPARATION REQUIRED.
3. ANY NECESSARY FIELD REVISIONS ARE SUBJECT TO REVIEW & APPROVAL OF AN AMENDED PLAN AND/OR PROFILE BY THE CITY OF RALEIGH PUBLIC UTILITIES DEPARTMENT PRIOR TO CONSTRUCTION.
4. CONTRACTOR SHALL MAINTAIN CONTINUOUS WATER & SEWER SERVICE TO EXISTING RESIDENCES AND BUSINESSES THROUGHOUT CONSTRUCTION OF PROJECT. ANY NECESSARY SERVICE INTERRUPTIONS SHALL BE PRECEDED BY A 24 HOUR ADVANCE NOTICE TO THE CITY OF RALEIGH PUBLIC UTILITIES DEPARTMENT.
5. 3.0' MINIMUM COVER IS REQUIRED ON ALL WATER MAINS AND SEWER FORCEMAINS. 4.0' MINIMUM COVER IS REQUIRED ON ALL REUSE MAINS.
6. IT IS THE DEVELOPER'S RESPONSIBILITY TO ABANDON OR REMOVE EXISTING WATER AND SEWER SERVICES NOT BEING USED IN REDEVELOPMENT OF A SITE UNLESS OTHERWISE DIRECTED BY THE CITY OF RALEIGH PUBLIC UTILITIES DEPARTMENT. THIS INCLUDES ABANDONING TAP AT MAIN AND REMOVAL OF SERVICE FROM ROW OR EASEMENT PER CORPUS HANDBOOK PROCEDURE.
7. INSTALL 2.5" COPPER WATER SERVICES WITH METERS LOCATED AT ROW OR WITHIN A 2'X2' WATERLINE EASEMENT IMMEDIATELY ADJACENT. NOTE: IT IS THE APPLICANT'S RESPONSIBILITY TO PROPERLY SIZE THE WATER SERVICE FOR EACH CONNECTION TO PROVIDE ADEQUATE FLOW & PRESSURE.
8. INSTALL 6" PVC SEWER SERVICES @ 1.0% MINIMUM GRADE WITH CLEANOUTS LOCATED AT ROW OR EASEMENT LINE & SPACED EVERY 75 LINEAR FEET MAXIMUM.
9. PRESSURE REDUCING VALVES ARE REQUIRED ON ALL WATER SERVICES EXCEEDING 80 PSI; BACKWATER VALVES ARE REQUIRED ON ALL SANITARY SEWER SERVICES HAVING BUILDING DRAINS LOWER THAN 1.0' ABOVE THE NEXT UPSTREAM MANHOLE.

10. ALL ENVIRONMENTAL PERMITS APPLICABLE TO THE PROJECT MUST BE OBTAINED FROM NCDWQ, USACE &/OR FEMA FOR ANY RIPARIAN BUFFER, WETLAND &/OR FLOODPLAIN IMPACTS (RESPECTIVELY) PRIOR TO CONSTRUCTION.

11. GREASE INTERCEPTOR // OIL WATER SEPARATOR SIZING CALCULATIONS & INSTALLATION SPECIFICATIONS SHALL BE APPROVED BY THE CORPUS FOG PROGRAM COORDINATOR PRIOR TO ISSUANCE OF A BUILDING PERMIT. CONTACT TIM BEASLEY AT (919) 250-7225 OR TIMOTHY.BEASLEY@RALEIGHNC.GOV FOR MORE INFORMATION.
12. CROSS-CONNECTION CONTROL PROTECTION DEVICES ARE REQUIRED BASED ON DEGREE OF HEALTH HAZARD INVOLVED AS LISTED IN APPENDIX-B OF THE RULES GOVERNING PUBLIC WATER SYSTEMS IN NORTH CAROLINA. THESE GUIDELINES ARE THE MINIMUM REQUIREMENTS. THE DEVICES SHALL MEET AMERICAN SOCIETY OF SANITARY ENGINEERING (ASSE) STANDARDS OR BE ON THE UNIVERSITY OF SOUTHERN CALIFORNIA APPROVAL LIST. THE DEVICES SHALL BE INSTALLED AND TESTED (BOTH INITIAL & PERIODIC TESTING THEREAFTER) IN ACCORDANCE WITH THE MANUFACTURER'S RECOMMENDATIONS OR THE LOCAL CROSS-CONNECTION CONTROL PROGRAM. HOWEVER IS MORE STRINGENT, CONTACT JOANIE HELVEY AT (919) 312-5923 OR JOANIE.HELVEY@RALEIGHNC.GOV FOR MORE INFORMATION.

GENERAL NOTES

1. CONTRACTOR TO FIELD VERIFY LOCATION & ELEVATION OF ALL EXISTING UTILITIES PRIOR TO CONSTRUCTION.
2. UTILITY CONSTRUCTION SHALL BE IN ACCORDANCE WITH CITY OF RALEIGH STANDARDS AND SPECIFICATIONS UNLESS OTHERWISE NOTED.
3. CONTRACTOR IS RESPONSIBLE FOR CONTACTING AND COORDINATING WITH ALL UTILITY SERVICE PROVIDERS THAT HAVE UTILITIES ON OR IMMEDIATELY ADJACENT TO THE SITE AND WORK AREA.
4. STORM DRAINAGE INSTALLATION SHALL BE IN ACCORDANCE WITH COR STANDARDS AND SPECIFICATIONS.

UTILITY LEGEND

SYMBOL	DETAIL
	EXISTING WATER MAIN -/-
	EXISTING SAN. SEWER LINE AND MANHOLE -/-
	PROPOSED WATER LINE -/-
	PROPOSED METER AND BACKFLOW PREVENTION DEVICES -/-
	PROPOSED SANITARY SEWER LINE/LATERAL -/-
	PROPOSED SANITARY SEWER MANHOLE -/-
	PROPOSED CLEANOUT -/-
	PROPOSED FIRE HYDRANT -/-
	EXISTING FIRE HYDRANT -/-



Cole Jones & Stone
BOLTON & MENK, INC.

418 S DAWSON STREET
RALEIGH, NORTH CAROLINA 27601
Phone: (919) 719-1800
Email: raleigh@bolton-menk.com
www.bolton-menk.com

TERWILLIGER PAPPAS

510 GLENWOOD AVE
SUITE 317
RALEIGH, NC 27603



SOLIS BUFFALO RD
MULTIFAMILY

5017 FORESTVILLE RD
RALEIGH, NC 27615

OVERALL UTILITY
PLAN

PROJECT NO:
50645


- REVISIONS:
- | | |
|----|--------------------------------|
| 0. | ASR Submittal 11/09/2022 |
| 1. | 1st ASR Plan Review 01/12/2023 |
| 2. | 2nd ASR Plan Review 02/23/2023 |
| 3. | 3rd ASR Plan Review 04/28/2023 |
| 4. | 4th ASR Plan Review 05/25/2023 |

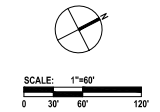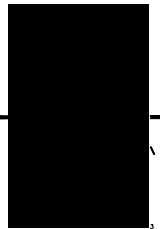


SCALE:	1" = 60'
DATE:	05/25/2023
DESIGNED BY:	AH
DRAWN BY:	AH
CHECKED BY:	BL TH

C-500

FILE NO:

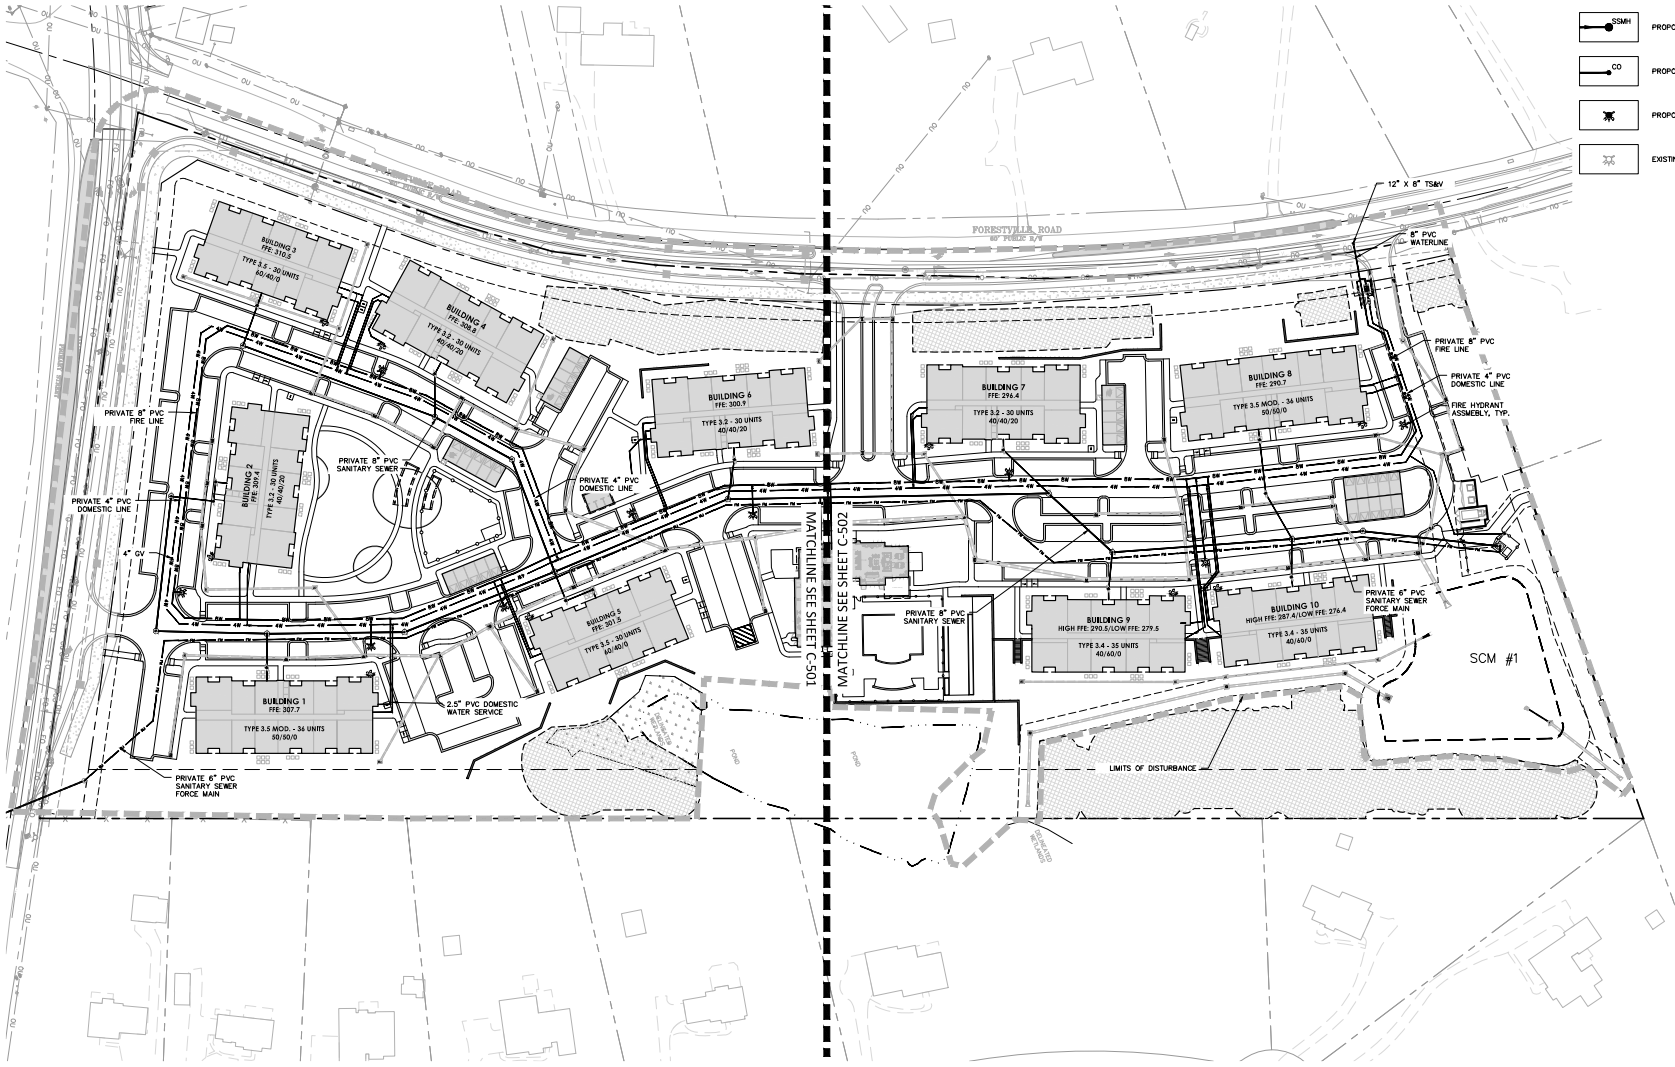

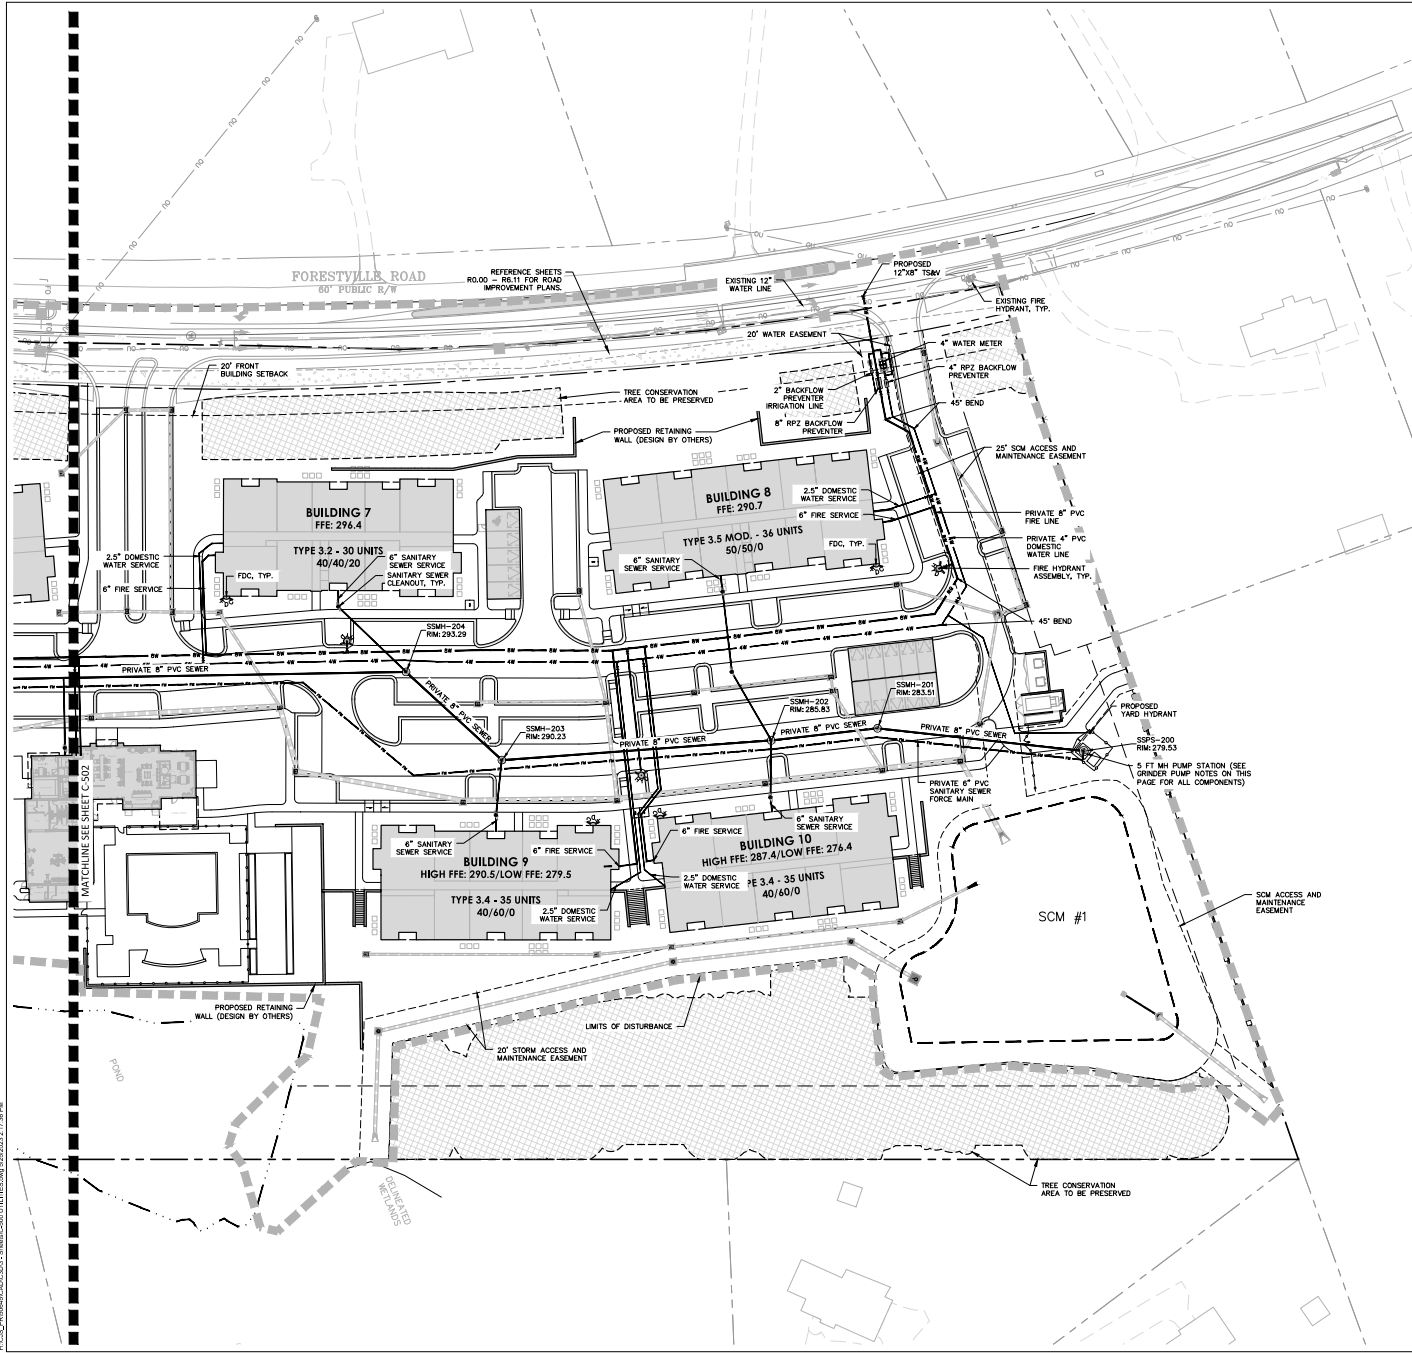

UTILITY LEGEND

SYMBOL	DETAIL
	EXISTING WATER MAIN
	EXISTING SAN. SWR. LINE AND MANHOLE
	PROPOSED WATER LINE
	PROPOSED METER AND BACKFLOW PREVENTION DEVICES
	PROPOSED SANITARY SEWER LINE/LATERAL
	PROPOSED SANITARY SEWER MANHOLE
	PROPOSED CLEANOUT
	PROPOSED FIRE HYDRANT
	EXISTING FIRE HYDRANT

GRINDER PUMP COMPONENTS

- (2) 5 HP COMMERCIAL GRINDER PUMPS WITH 282 GPM CAPACITY AT 40 FT TDH
- FIBERGLASS WET WELL, 60" DIA. 19.5 FT DEEP, LOCKING ALUMINUM HATCH COVER
- GUIDE RAILS & LIFTING CABLE
- CHECK VALVES & SHUT-OFF VALVES
- NEMA 4X CONTROL PANEL WITH FLOAT SWITCH CONTROLS, AUDIBLE AND VISIBLE ALARMS, AND GENERATOR TRANSFER SWITCH
- 4" DISCHARGE WITH 6" PVC FORCE MAIN



Cole Jones & Stone
BOLTON & MENK, INC.

418 S DAWSON STREET
RALEIGH, NORTH CAROLINA 27601
Phone: (919) 719-1800
Email: raleigh@bolton-menk.com
www.bolton-menk.com

TERWILLIGER PAPPAS

510 GLENWOOD AVE
SUITE 317
RALEIGH, NC 27603

**SOLIS BUFFALO RD
MULTIFAMILY**

5017 FORESTVILLE RD
RALEIGH, NC 27618

**UTILITY PLAN -
NORTH
ENLARGEMENT**

PROJECT NO:

50645

REVISIONS:

1. 1st ASR Plan Review 01/12/2023
2. 2nd ASR Plan Review 02/23/2023
3. 3rd ASR Plan Review 04/20/2023
4. 4th ASR Plan Review 05/25/2023




SCALE: 1"=40'
0 20' 40' 80'

SCALE:	1"=40'
DATE:	05/25/2023
DESIGNED BY:	AH
DRAWN BY:	AH
CHECKED BY:	BL TH

C-501

FILE NO:

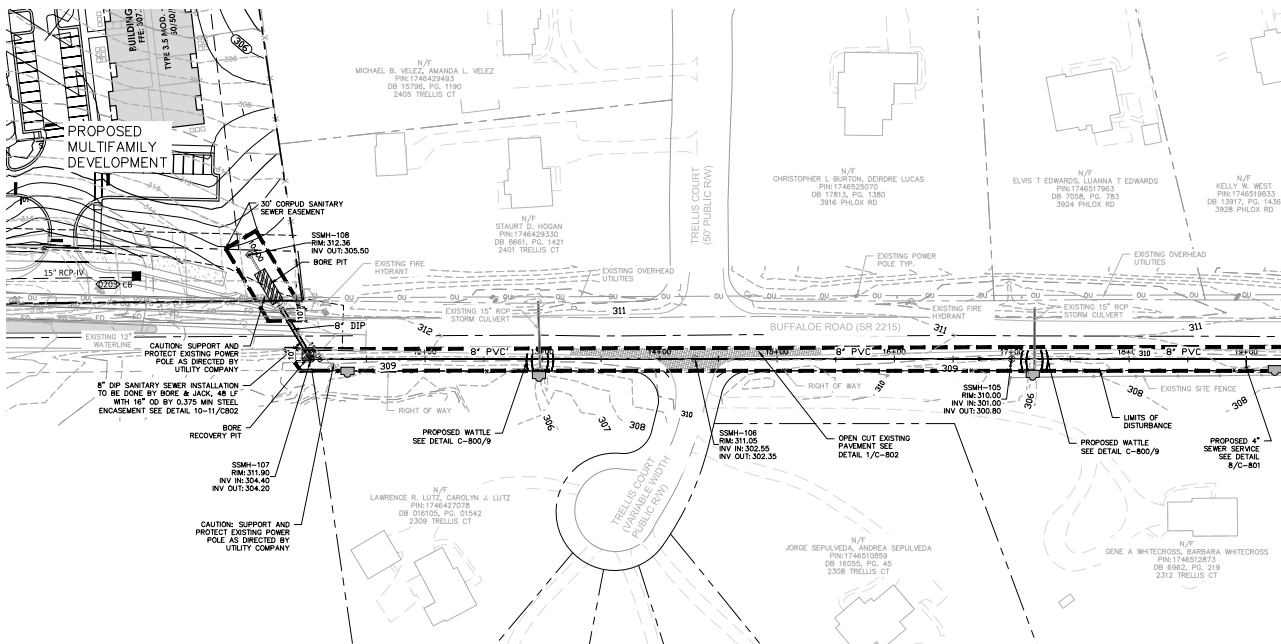

UTILITY LEGEND

SYMBOL	DETAIL
	EXISTING WATER MAIN -/-
	EXISTING SAN. SWR. LINE AND MANHOLE -/-
	PROPOSED SANITARY SEWER LINE/LATERAL C-801/8
	PROPOSED SANITARY SEWER MANHOLE C-801/10
	PROPOSED CLEANOUT C-801/8
	PROPOSED SILT FENCE C-800/1
	PROPOSED TREE PROTECTION FENCE C-800/5
	PROPOSED SILT FENCE OUTLET C-800/2
	EXISTING FIRE HYDRANT -/-
	BLOCK AND GRAVEL INLET PROTECTION C-800/4
	PROPOSED WATLLES C-800/9



Cole Jones & Stone
BOLTON & MENK, INC.

418 S DAWSON STREET
RALEIGH, NORTH CAROLINA 27601
Phone: (919) 719-1800
Email: raleigh@bolton-menk.com
www.bolton-menk.com

TERWILLIGER PAPPAS

510 GLENWOOD AVE
RALEIGH, NC 27618

SOLIS BUFFALO RD
MULTIFAMILY

5017 FORESTVILLE RD
RALEIGH, NC 27618

BUFFALO ROAD
SANITARY OUTFALL
1 OF 2


PROJECT NO:
50645

REVISIONS:

1.	1st ASR Plan Review 01/12/2023
2.	2nd ASR Plan Review 02/23/2023
3.	3rd ASR Plan Review 04/28/2023
4.	4th ASR Plan Review 05/25/2023



- CONTRACTOR IS FULLY RESPONSIBLE FOR CONTACTING APPROPRIATE PARTIES AND ENSURING THAT ALL EXISTING UTILITIES ARE LOCATED PRIOR TO CONSTRUCTION.
- CONTRACTOR IS RESPONSIBLE FOR PLACING BARRICADES, USING FLAG MEN, ETC., AS NECESSARY TO ENSURE THE SAFETY OF THE PUBLIC.
- ALL PAVEMENT CUTS, CONCRETE OR ASPHALT, ARE TO BE REPLACED ACCORDING TO THE STANDARDS OF THE NORTH CAROLINA DEPARTMENT OF TRANSPORTATION, OR LOCAL JURISDICTION, WHICHEVER IS MORE STRINGENT.
- SHORING SHALL BE IN ACCORDANCE WITH OSHA TRENCHING STANDARDS, 29 CFR, PART 1926, SUBPART P, OR AS AMENDED.

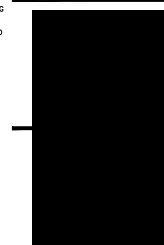


SCALE: 1"=50'
0 25' 50' 100'

SCALE:	1"=50'
DATE:	05/25/2023
DESIGNED BY:	NDG
DRAWN BY:	NDG
CHECKED BY:	BL TH



C-520

FILE NO:

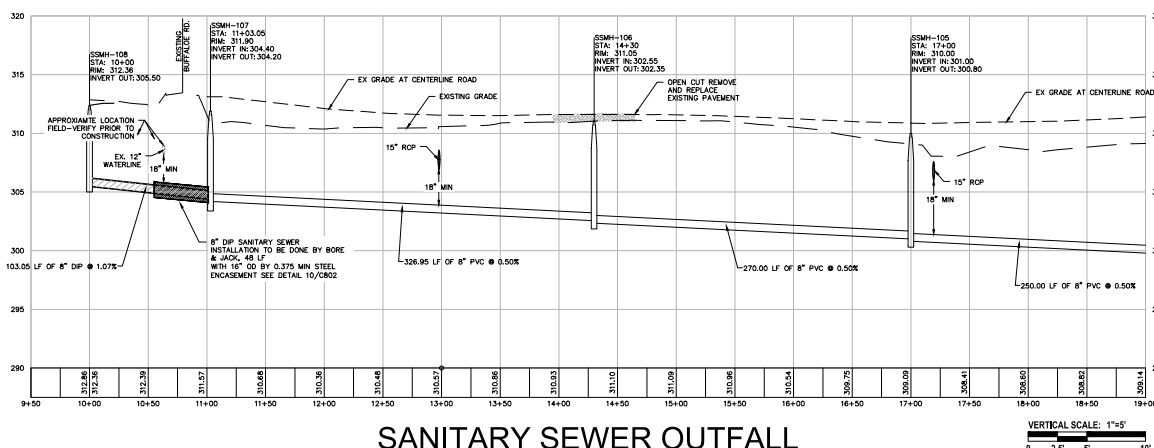

SANITARY SEWER OUTFALL

VERTICAL SCALE: 1"=5'
0 2.5' 5' 10'

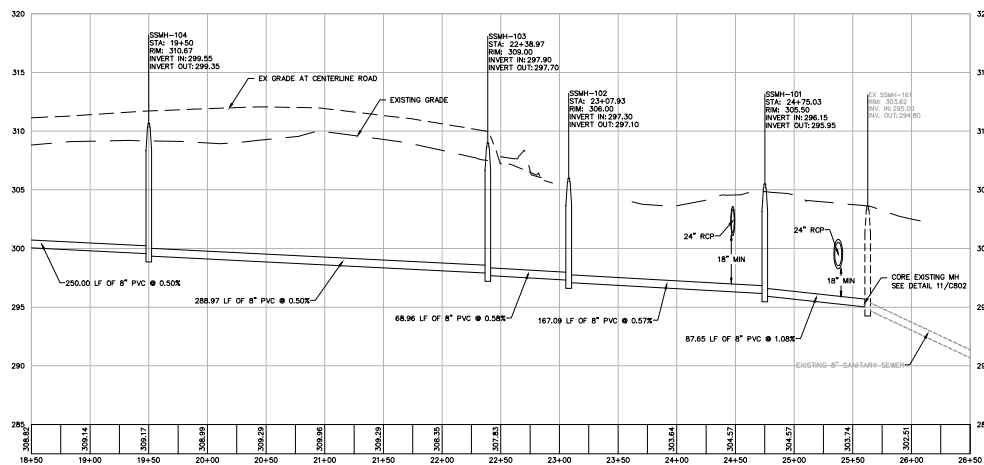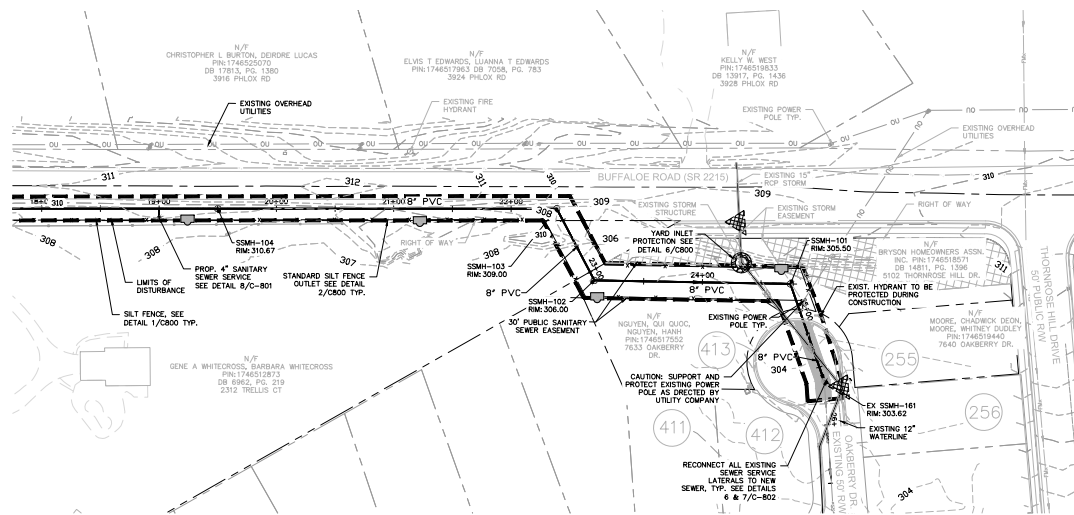

SANITARY SEWER OUTFALL

VERTICAL SCALE: 1"=5'
0 25 50 100'

UTILITY LEGEND

SYMBOL	DETAIL
	EXISTING WATER MAIN -/-
	EXISTING SAN. SWR. LINE AND MANHOLE -/-
	PROPOSED SANITARY SEWER LINE/LATERAL C-801/8
	PROPOSED SANITARY SEWER MANHOLE C-801/10
	PROPOSED CLEANOUT C-802/8
	PROPOSED SILT FENCE C-800/1
	PROPOSED TREE PROTECTION FENCE C-800/5
	PROPOSED SILT FENCE OUTLET C-800/2
	EXISTING FIRE HYDRANT -/-
	BLOCK AND GRAVEL INLET PROTECTION C-800/4
	PROPOSED WATLLES C-800/9



418 S DAWSON STREET
RALEIGH, NORTH CAROLINA 27601
Phone: (919) 719-1800
Email: raleigh@bolton-menk.com
www.bolton-menk.com

TERWILLIGER PAPPAS

510 GLENWOOD AVE
SUITE 317
RALEIGH, NC 27603

SOLIS BUFFALO RD MULTIFAMILY

5017 FORESTVILLE RD
RALEIGH, NC 27615

BUFFALO ROAD SANITARY OUTFALL 2 OF 2

PROJECT NO:
50645

REVISIONS:
D. AIR Submittal 11/09/2022
1. 1st AIR Plan Review 01/12/2023
2. 2nd AIR Plan Review 02/23/2023
3. 3rd AIR Plan Review 04/20/2023
4. 4th AIR Plan Review 05/25/2023



- CONTRACTOR IS FULLY RESPONSIBLE FOR CONTRACTING APPROPRIATE PARTIES AND ENSURING THAT ALL EXISTING UTILITIES ARE LOCATED PRIOR TO CONSTRUCTION.
- CONTRACTOR IS RESPONSIBLE FOR PLACING BARRICADES, USING FLAG MEN, ETC., AS NECESSARY TO ENSURE THE SAFETY OF THE PUBLIC.
- ALL PAVEMENT CUTS, CONCRETE OR ASPHALT, ARE TO BE REPLACED ACCORDING TO THE STANDARDS OF THE NORTH CAROLINA DEPARTMENT OF TRANSPORTATION, OR LOCAL JURISDICTION, WHICHEVER IS MORE STRINGENT.
- SHORING SHALL BE IN ACCORDANCE WITH OSHA TRENCHING STANDARDS, 29 CFR, PART 1926, SUBPART P, OR AS AMENDED.



SCALE: 1"=50'
0 25 50 100'

SCALE:	1"=50'
DATE:	05/25/2023
DESIGNED BY:	NDG
DRAWN BY:	NDG
CHECKED BY:	BL TH

C-521

FILE NO.

PLANTING NOTES

1. SIZE AND GRADING STANDARDS OF PLANT MATERIAL SHALL CONFORM TO THE LATEST EDITION OF "AMERICAN STANDARD FOR NURSERY STOCK", BY THE AMERICAN HORTICULTURE INDUSTRY ASSOCIATION, INC. (ANSI 2001).
2. HEIGHT AND WIDTH SPECIFICATIONS INDICATED ON PLANT SCHEDULE SHALL TAKE PRECEDENCE OVER CONTAINER SIZE.
3. ALL ANNUAL/PERENNIAL BEDS SHALL BE AMENDED BY THE CONTRACTOR PER THE SPECIFICATIONS AND PARSED 8" ABOVE EXISTING OR PROPOSED GRADE. CONTRACTOR SHALL PROVIDE TOPSOIL AS REQUIRED TO RAISE GRADES.
4. CONTRACTOR SHALL MOUND ALL PARKING LOT ISLANDS TO 8" ABOVE BACK OF CURB AT THE CENTER OF ISLAND. CONTRACTOR SHALL SOFTEN AND PLACE AMENITY TOPSOIL IF NECESSARY FOR MOUNDING AS INDICATED ON CONSTRUCTION DOCUMENTS.
5. CONTRACTOR SHALL MULCH ALL SHRUB BEDS WITH 3" AGED TRIPLE SHREDED HARDWOOD BARK. MAINTAIN 2" CLEAR OF BASE OF TRUNK OR STEM. CONTRACTOR SHALL MULCH ALL ANNUAL BEDS WITH 2" PINE BARK FINES.
6. ALL DISTURBED AREAS NOT INDICATED TO RECEIVE SOO OR MULCH SHALL BE SEED BY THE CONTRACTOR.
7. CONTRACTOR SHALL REMOVE ALL HARD MULCH OF CLAY, STONES OVER 1" IN DIAMETER, AND ALL CONSTRUCTION DEBRIS INCLUDING GRACIL, ROOTS, LIMBS AND OTHER CELEBRITY MATTER WHICH WOULD BE HARMFUL, OR PREVENT PROPER ESTABLISHMENT AND/OR MAINTENANCE OF LAWN AND PLANTING AREAS.
8. IN AREAS WHERE CONSTRUCTION GRAVEL IS EMBEDDED IN THE SOIL, CONTRACTOR SHALL REMOVE CONTAMINATED SOIL TO A DEPTH OF 6" AND FILL WITH CLEAN TOPSOIL. CONTRACTOR SHALL IMPORT TOPSOIL AT NO CHARGE TO OWNER IF REQUIRED TO FILL THESE EXCAVATIONS.
9. CONTRACTOR SHALL RESEED/RESSO LAWN AREAS DAMAGED DUE TO PLANT MATERIAL INSTALLATION.
10. SEE SPECIFICATIONS FOR SOIL AMENDMENT, PREPARATION AND FERTILIZER REQUIREMENTS. FERTILIZER RATES TO BE PER SOIL TEST RESULTS.
11. CONTRACTOR SHALL COORDINATE ALL PLANTING IN THE RIGHT-OF-WAY WITH THE NORTH CAROLINA DEPARTMENT OF TRANSPORTATION OR LOCAL TRANSPORTATION DEPARTMENT.
12. BASIN SLOPES AND SWALES TO BE SEEDING AND STABILIZED. SEE EROSION CONTROL AND GRADING PLANS AND NOTES.
13. ANY AREA NOT DIRECTED TO RECEIVE SEED OR SOO SHALL BE MULCHED.
14. ADJUSTMENTS TO THE LOCATION OF PLANT MATERIAL MAY BE REQUIRED. NOTIFY COLENESEY & STONE, P.A. IF DISCREPANCIES OCCUR.
15. ALL STRAPPING AND TOP 1/3 OF WIRE BASKET SHALL BE CUT AWAY AND REMOVED BY THE CONTRACTOR FROM ROOT BALL PRIOR TO BACKFILLING PLANTING PIT. CONTRACTOR SHALL REMOVE TOP 1/3 OF THE BUILDUP FROM ROOT BALL.
16. FOR NEW TREE PLANTING AREAS WHERE THERE WAS EXISTING PAVEMENT, CONTRACTOR SHALL REMOVE ALL PAVEMENT, GRAVEL, SUB-BASE AND CONSTRUCTION DEBRIS. REMOVE COMPACTED SOIL AND ADD 24" NEW PLANTING SOIL OR AMEND THE TOP 24" OF EXISTING SOIL TO MEET SPECIFIED PLANTING SOIL STANDARDS FOR TREES.
17. LARGE MATURING TREES SHALL BE A MINIMUM 25 TO 30 FEET FROM OVERHEAD DISTRIBUTION OR TRANSMISSION LINES. IF TREES CONFLICT WITH POWER LINES OR SIGNS, CONTRACTOR SHALL CONTACT LANDSCAPE ARCHITECT TO RESOLVE BEFORE PLANTING.
18. INSTALLER SHALL BE RESPONSIBLE TO REPAIR OR REPLACE PLANTINGS THAT FAIL IN MATERIALS, WORKMANSHIP, OR GROWTH WITHIN SPECIFIED WARRANTY PERIOD (ONE YEAR FROM DATE OF FINAL ACCEPTANCE BY OWNER).
19. FOR SEEDING AREAS, AN ACCEPTABLE LAWN AT THE END OF THE MAINTENANCE PERIOD SHALL CONSIST OF A HEALTHY, UNIFORM, CLOSE STAND OF GRASS, FREE OF WEEDS AND SURFACE IRREGULARITIES, WITH TOTAL GRASS COVERAGE EXCEEDING 90 PERCENT OVER ANY 10 SQ. FT. AND BARE SPOTS NOT EXCEEDING 5 BY 5 INCHES, WITH AT LEAST 85% OF THE TOTAL GRASS COVERAGE CONSISTING OF THE SPECIFIED GRASS SPECIES.

PLANTING CODE COMPLIANCE TABLE

TYPE	REQUIREMENT	CALCULATION	PROVIDED	CODE SECTION
NEIGHBORHOOD TRANSITION BUFFER	ZONE A - TYPE 3 (50' AVERAGE WIDTH) CANOPY TREES: 6/100 LF UNDERSTORY TREES: 5/100 LF SHRUBS: 60/100 LF ZONE A - TYPE 2 (20' AVERAGE WIDTH) CANOPY TREES: 5/100 LF UNDERSTORY TREES: 4/100 LF SHRUBS: 30/100 LF	TOTAL FRONTAGE: 1,776 LF FRONTAGE WITH POND: 317 LF FRONTAGE WITH PLANTING: 639 LF 639/(100÷6.39) = 6.39÷38 TREES 6.39÷32 UNDERSTORY TREES 6.44÷26=383 SHRUBS TOTAL FRONTAGE: 379 LF FRONTAGE WITH PLANTING: 327 LF 327/(100÷3.27) = 3.27÷14 TREES 3.27÷13 UNDERSTORY TREES 3.27÷13=98 SHRUBS	(39) CANOPY TREES (48) UNDERSTORY TREES (482) SHRUBS (14) CANOPY TREES (14) UNDERSTORY TREES (126) SHRUBS	ZONING CONDITIONS SEE COVER SHEET CITY OF RALEIGH UDO SEC. 3.5.3.C ZONING CONDITIONS SEE COVER SHEET CITY OF RALEIGH UDO SEC. 3.5.3.C
PARKING LOT PLANTING	1 CANOPY TREE PER 2,000 SF OF PARKING AREA	PARKING AREA: 176,519 SF 176,519/2000= 88 TREES	(97) CANOPY TREES	CITY OF RALEIGH UDO SEC. 7.1.7.F
AMENITY AREA	10% SITE AREA	SITE AREA: 885,300 SF (20.32 AC) 10% SITE AREA: 88,530 SF (2.03 AC)	138,855 SF (3.19 AC)	CITY OF RALEIGH UDO SEC. 5.2.4
SURFACE PARKING SCREENING	30 SHRUBS PER 100 LF	FRONTAGE: 384 384/(100÷3.84) = 3.84÷20=116 SHRUBS	(189) SHRUBS	CITY OF RALEIGH UDO SEC. 7.1.7.B.4
STREET/PAVING PLANTING	1 CANOPY TREE PER 40 LF OF STREET FRONTAGE	FRONTAGE: 1757 LF FRONTAGE WITH TCA: 626 REMAINING FRONTAGE: 1,131 1,131/40=28 CANOPY TREES	(29) CANOPY TREES	CITY OF RALEIGH UDO SEC. 8.4.1.D.4
SOIL SCREENING	VEGETATIVE MATERIAL MUST OCCUPY 75% OF VERTICAL PLANE, AVG. MATURE HT. OF 6 FT.		(76) SHRUBS PROVIDED	CITY OF RALEIGH UDO SEC. 7.2.B.C

SEE SHEETS C-612-C-616 FOR TREE CONSERVATION AREA CALCULATIONS

LEGEND

SYMBOL	EXISTING TREE	PROPOSED TREE	PROPOSED SHRUBS	PROPOSED SEED/SOO	PROPOSED GROUND COVER	TREE CONSERVATION AREA	AMENITY AREA	PROPOSED LIGHT FIXTURE

DETAIL

-/-	
-/-	
418 S DAWSON STREET
RALEIGH, NORTH CAROLINA 27601
Phone: (919) 719-1800
Email: raleigh@bolton-mink.com
www.bolton-mink.com

TERWILLIGER PAPPAS

510 GLENWOOD AVE
SUITE 317
RALEIGH, NC 27603


SOLIS BUFFALO RD MULTIFAMILY

5017 FORESTVIEW RD
RALEIGH, NC 27615

OVERALL CODE PLANTING PLAN


PROJECT NO:
50645

REVISIONS:
B. AIR Submittal 11/09/2022
1. 1st AIR Plan Review 01/12/2023
2. 2nd AIR Plan Review 02/23/2023
3. 3rd AIR Plan Review 04/20/2023
4. 4th AIR Plan Review 05/25/2023

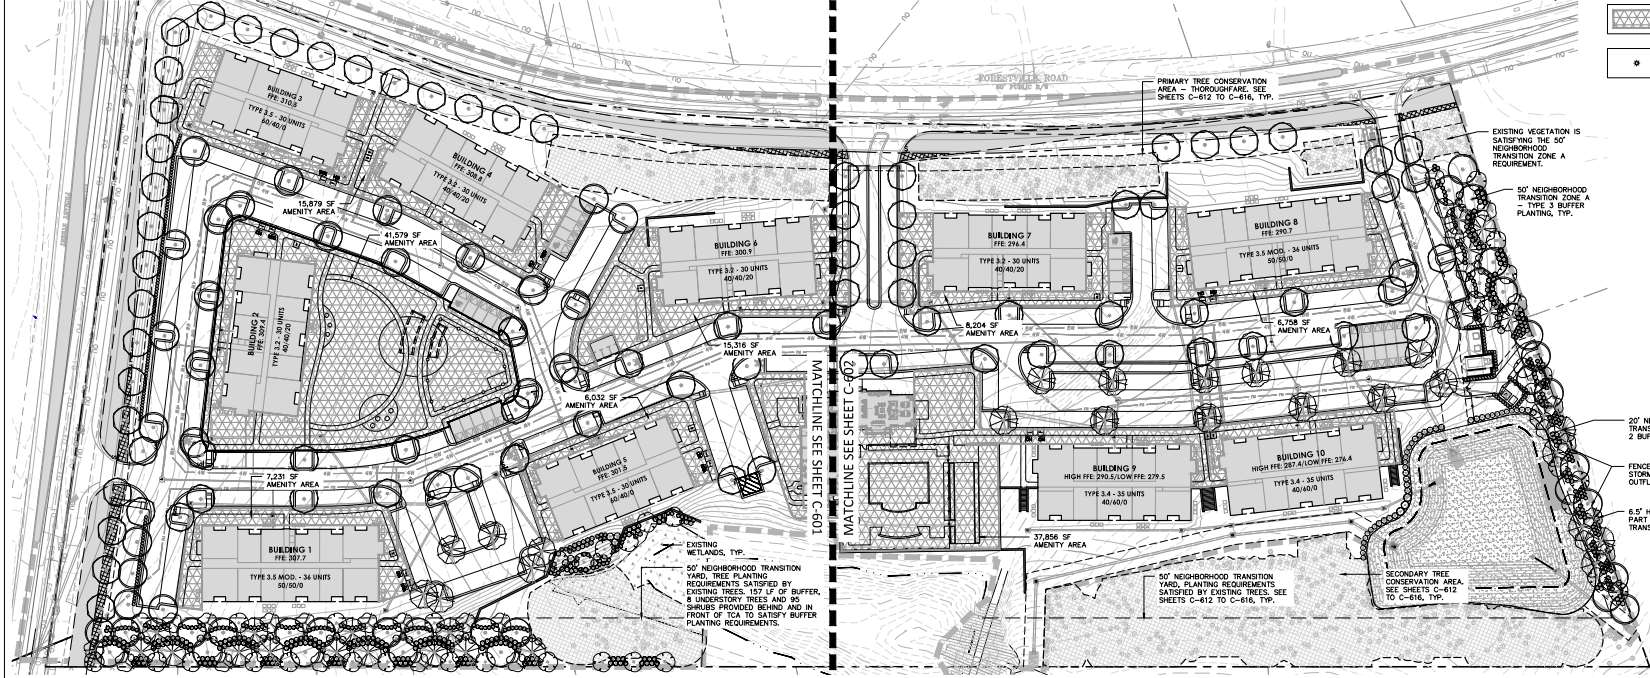

PLANT SCHEDULE	CODE	QTY	BOTANICAL NAME	COMMON NAME	CONT	SIZE	SPAC	REMARKS
NEIGHBORHOOD TRANSITION TREES								
QUNN	31	QUERUS NUTTALLI	NUTTALL OAK	846	3" CAL. 12"-14" HT.	A.I.		
QUSH	24	QUERUS SHUMARDII	SHUMARD OAK	846	3" CAL. 12"-14" HT.	A.I.		
NEIGHBORHOOD TRANSITION UNDERSTORY TREES								
CECA	25	CERIS CANADENSIS	EASTERN REDBUD	846	1.5" - 2" CAL. 8" - 10" HT.	A.I.		
CHV	36	CHORANTHUS VIRGINICUS	WHITE FRINGETREE	846	1.5" - 2" CAL. 8" - 10" HT.	A.I.		
PARKING LOT TREES								
QUNN	25	QUERUS NUTTALLI	NUTTALL OAK	846	3" CAL. 12"-14" HT.	A.I.		
QUPI	53	QUERUS PHellos	WILLOW OAK	846	3" CAL. 12"-14" HT.	A.I.		
QUSH	19	QUERUS SHUMARDII	SHUMARD OAK	846	3" CAL. 12"-14" HT.	A.I.		
STREET TREE								
QUPS	29	QUERUS PHellos	WILLOW OAK	846	3" CAL. 12"-14" HT.	40' O.C.		

PLANT SCHEDULE CODE PLANTING OVERALL	CODE	QTY	BOTANICAL NAME	COMMON NAME	CONT	SIZE	SPAC	REMARKS
NEIGHBORHOOD TRANSITION SHRUBS								
FLG	39	FORSYTHIA X INTERMEDIA 'LYNWOOD GOLD'	LYNWOOD GOLD FORSYTHIA	CONT.	24" - 30" HT.	7' O.C.		
HYPL	110	HYDRANGEA PANICULATA 'LIMELIGHT'	LIMELIGHT PANICLE HYDRANGEA	CONT.	24" - 30" HT.	5' O.C.		
IBEN	148	ILEX CORNUTA 'BURFORDI NANA'	DWARF BURFORD HOLLY	CONT.	18"-24" HT.	4' O.C.		
IFAF	100	ILICUM FLORIDANUM 'AZTEC FIRE'	AZTEC FIRE FLORIDA ANISE	CONT.	18"-24" HT./SPR.	4' O.C.		
LIJR	211	LIQUSTRUM JAPONICUM 'RECURVIFOLIUM'	CURLY LEAF JAPANESE PRIVET	CONT.	24"-30" HT./SP.	5' O.C.		
PARKING LOT SHRUBS								
AGLR	191	ABELIA X GRANDIFLORA 'LITTLE RICHARD'	LITTLE RICHARD GLOSSY ABELIA	CONT.	18"-24" HT.	3' O.C.		
SCM SCREENING								
ILCS	21	ILEX CRENATA 'STEEDS'	STEEDS JAPANESE HOLLY	CONT.	24" - 30" HT.	6' O.C.		
INRS	3	ILEX X 'NELLIE R. STEVENS'	NELLIE R. STEVENS HOLLY	CONT.	6"-8" HT.	A.I.		
LORS	20	LOROPETALUM CHINENSE RUBRUM 'SHANG-RED'	RED DIAMOND FRINGE FLOWER	CONT.	24" - 30" HT.	6' O.C.		
SCM PLANTING								
SEED	33,243 SF	CYNODON DACTYLON 'BLACKJACK'	BLACKJACK BERMUDAGRASS	SEED	SEED			

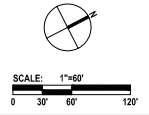

SCALE: 1"=60'
DATE: 05/25/2023
DESIGNED BY: HLPK
DRAWN BY: PK
CHECKED BY: RB

C-600

FILE NO.



Cole Jones & Stone
BOLTON & MENK, INC.

418 S DAWSON STREET
RALEIGH, NORTH CAROLINA 27601
Phone: (919) 719-1800
Email: raleigh@bolton-menk.com
www.bolton-menk.com

TERWILLIGER PAPPAS

510 GLENWOOD AVE
SUITE 317
RALEIGH, NC 27603


**SOLIS BUFFALO RD
MULTIFAMILY**

5017 FORESTVILLE RD
RALEIGH, NC 27616

**CODE PLANTING
PLAN - NORTH
ENLARGEMENT**


PROJECT NO:
50645

REVISIONS:
D. ASR Submittal 11/09/2022
1. 1st ASR Plan Review 01/12/2023
2. 2nd ASR Plan Review 02/23/2023
3. 3rd ASR Plan Review 04/20/2023
4. 4th ASR Plan Review 05/25/2023

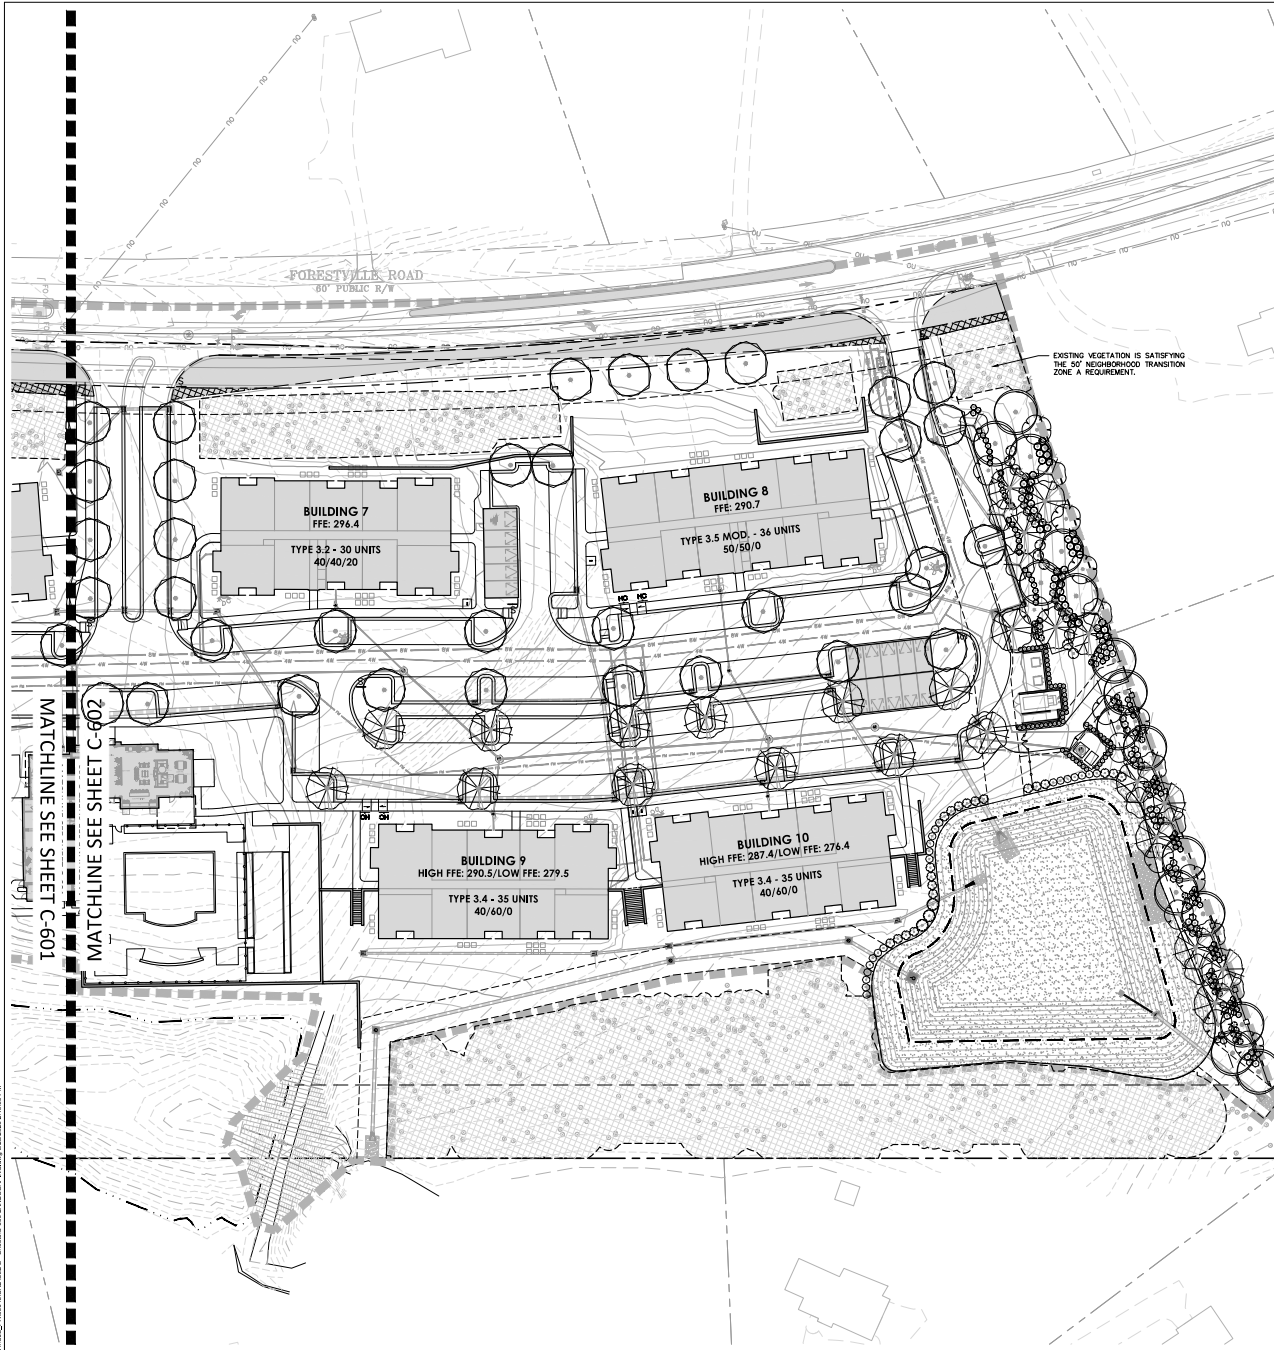

PLANT SCHEDULE CODE PLANTING C-601 (SEE SHEET C-600 FOR QUANTITIES)


NEIGHBORHOOD TRANSITION TREES	CODE	BOTANICAL NAME	COMMON NAME
	QUN	QUERCUS NUTTALLI	NUTTALL OAK
	QSN	QUERCUS SHUMARDII	SHUMARD OAK
NEIGHBORHOOD TRANSITION UNDERSTORY TREES	CODE	BOTANICAL NAME	COMMON NAME
	CECA	CERCIS CANADENSIS	EASTERN REDBUD
	CHM	CHONANTHUS VIRGINICUS	WHITE FRINGETREE
PARKING LOT TREES	CODE	BOTANICAL NAME	COMMON NAME
	QUPH	QUERCUS PHELLOS	WILLOW OAK
	QUSH	QUERCUS SHUMARDII	SHUMARD OAK
STREET TREE	CODE	BOTANICAL NAME	COMMON NAME
	QUPS	QUERCUS PHELLOS	WILLOW OAK
NEIGHBORHOOD TRANSITION SHRUBS	CODE	BOTANICAL NAME	COMMON NAME
	FLG	FORSYTHIA X INTERMEDIA 'LYNWOOD GOLD'	LYNWOOD GOLD FORSYTHIA
	HYPL	HYDRANGEA PANCULATA 'LIMELIGHT'	LIMELIGHT PANGLE HYDRANGEA
	ICBN	ILEX CORNUTA 'BURFORD NANA'	DWARF BURFORD HOLLY
	IFAF	ILICUM FLORIDANUM 'AZTEC FIRE'	AZTEC FIRE FLORIDA ANISE
	LJLR	LIQUSTRUM JAPONICUM 'RECURVIFOLIUM'	CURLY LEAF JAPANESE PRIVET
PARKING LOT SHRUBS	CODE	BOTANICAL NAME	COMMON NAME
	AGLR	ABELIA X GRANDIFLORA 'LITTLE RICHARD'	LITTLE RICHARD GLOSSY ABELIA
SCM SCREENING	CODE	BOTANICAL NAME	COMMON NAME
	ILCS	ILEX ORENATA 'STEEDS'	STEEDS JAPANESE HOLLY
	INRS	ILEX X 'NELLIE R. STEVENS'	NELLIE R. STEVENS HOLLY
	LORS	LOREPETALUM CHINENSE RUBRUM 'SHANG-RED'	RED DIAMOND "FRINGE FLOWER

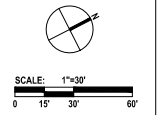

SCALE:	1"=30'
DATE:	05/25/2023
DESIGNED BY:	HL/PK
DRAWN BY:	PK
CHECKED BY:	RB

C-601

FILE NO:

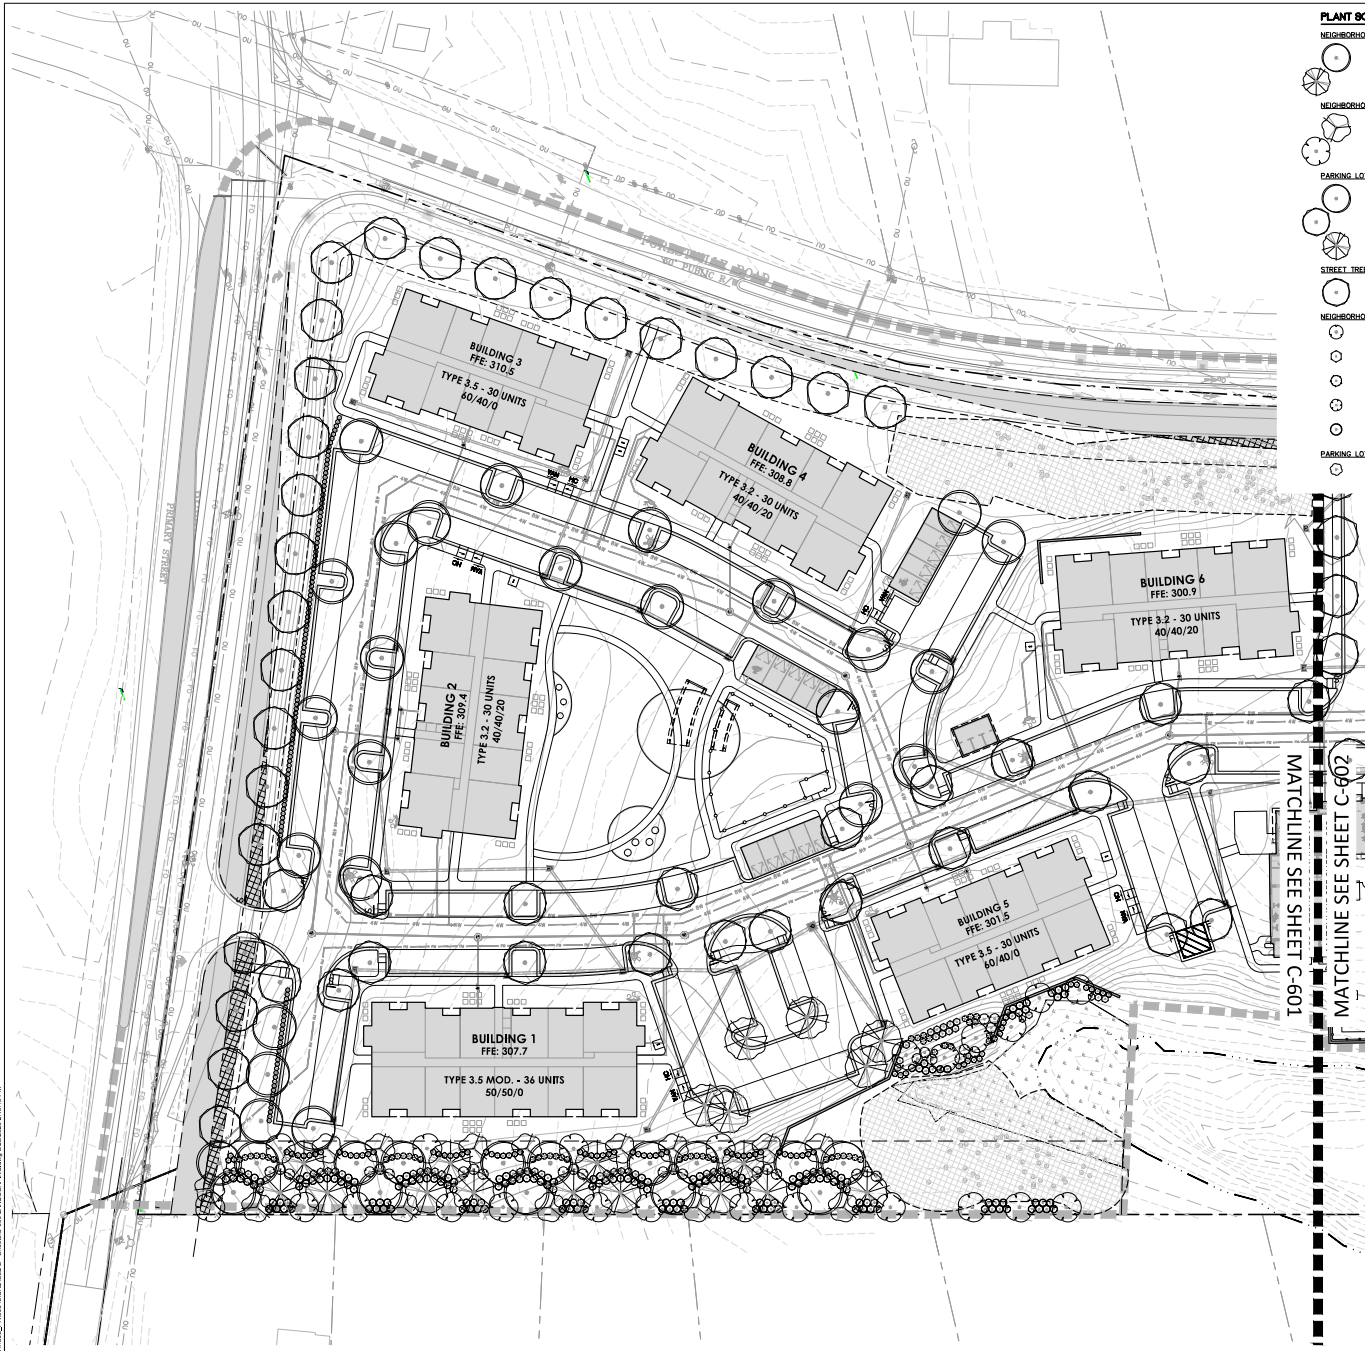

PLANT SCHEDULE CODE PLANTING C-602 (SEE SHEET C-600 FOR QUANTITIES)

NEIGHBORHOOD TRANSITION TREES



CODE	BOTANICAL NAME	COMMON NAME
QURN	QUERCUS NUTTALLI	NUTTALL OAK
QUSN	QUERCUS SHUMARDII	SHUMARD OAK

NEIGHBORHOOD TRANSITION UNDERSTORY TREES



CODE	BOTANICAL NAME	COMMON NAME
CECA	CERIS CANADENSIS	EASTERN REDBUD
CHVI	CHIONANTHUS VIRGINICUS	WHITE FRINGETREE

PARKING LOT TREES



CODE	BOTANICAL NAME	COMMON NAME
QUNU	QUERCUS NUTTALLI	NUTTALL OAK
QUPH	QUERCUS PHELLOS	WILLOW OAK

STREET TREE



CODE	BOTANICAL NAME	COMMON NAME
QUSH	QUERCUS SHUMARDII	SHUMARD OAK
QUPS	QUERCUS PHELLOS	WILLOW OAK

NEIGHBORHOOD TRANSITION SHRUBS



CODE	BOTANICAL NAME	COMMON NAME
FLG	FORSYTHIA X INTERMEDIA 'LYNWOOD GOLD'	LYNWOOD GOLD FORSYTHIA
HYPL	HYDRANGEA PANICULATA 'LIMELIGHT'	LIMELIGHT PANICLE HYDRANGEA

PARKING LOT SHRUBS



CODE	BOTANICAL NAME	COMMON NAME
ICBN	ILEX CORNUTA 'BURFORDI NANA'	DWARF BURFORD HOLLY
IFAF	ILICUM FLORIDANUM 'AZTEC FIRE'	AZTEC FIRE FLORIDA ANISE

CODE	BOTANICAL NAME	COMMON NAME
LJLR	LIGUSTRUM JAPONICUM 'RECURVIFOLIUM'	CURLY LEAF JAPANESE PRIVET
CODE	BOTANICAL NAME	COMMON NAME
ASLR	ABELIA X GRANDIFLORA 'LITTLE RICHARD'	LITTLE RICHARD GLOSSY ABELIA



Cole Jones & Stone
BOLTON & MENK, INC.

418 S DAWSON STREET
RALEIGH, NORTH CAROLINA 27601
Phone: (919) 719-1800
Email: raleigh@bolton-menk.com
www.bolton-menk.com

TERWILLIGER PAPPAS

510 GLENWOOD AVE
SUITE 317
RALEIGH, NC 27603

**SOLIS BUFFALO RD
MULTIFAMILY**

5017 FORESTVILLE RD
RALEIGH, NC 27615

**CODE PLANTING
PLAN - SOUTH
ENLARGEMENT**

PROJECT NO:
50645

REVISIONS:

1.	1st ASR Plan Review 01/12/2023
2.	2nd ASR Plan Review 02/23/2023
3.	3rd ASR Plan Review 04/28/2023
4.	4th ASR Plan Review 05/25/2023



SCALE:	1"=30'
DATE:	05/05/2023
DESIGNED BY:	HL/PK
DRAWN BY:	PK
CHECKED BY:	RB

C-602

FILE NO:



Cole Jones & Stone
BOLTON & MENK, INC.

418 S DAWSON STREET
RALEIGH, NORTH CAROLINA 27601
Phone: (919) 719-1800
Email: raleigh@bolton-menk.com
www.bolton-menk.com


510 GLENWOOD AVE
SUITE 317
RALEIGH, NC 27603

**SOLIS BUFFALOE RD
MULTIFAMILY**


OVERALL TREE PROTECTION AREA PLAN

REVISIONS:

0. ASR Submittal 11/09/2022
1. 1st ASR Plan Review 01/12/2023
2. 2nd ASR Plan Review 02/23/2023
3. 3rd ASR Plan Review 04/28/2023
4. 4th ASR Plan Review 05/25/2023

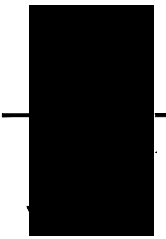

FILE NO.:

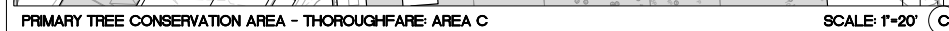

1 GLENWOOD AVE
2 APT 317
3 RALEIGH, NC 27603

OLIS BUFFALOE RD
MULTIFAMILY

7 FORESTVILLE RD

FREE CONSERVATION
AREAS C & E


SUBJECT NO:

Area 13					
		\$h 1.794		Acres 0.0023	
#	Tree Type	DBH	Health	SQ. FT.	Per Acre
1	OAR	4	GOOD	0.09	2.18
2	BANPLE	2	GOOD	0.03	1.23
3	ASH	5	GOOD	0.14	5.57
4	ASH	45	GOOD	11.04	277.7
5	HOLLY	4	GOOD	0.09	2.18
6	SUGARBERRY	6	GOOD	0.30	6.89
7	CANNONBALL	8	GOOD	0.53	6.63
TOTAL BASAL AREA:				13.09	288.5

TREE TABLE
 TREES ARE LISTED WITH AN ABBREVIATION AND
 A SIZE IN INCHES
 T TULIP
 A ASH
 AH AMERICAN HOPHORNBEAM
 H HOLLY
 P PINE
 AB AMERICAN BEECH
 SW SWEETWOOD
 CS COMMON SASSAFRAS
 E ELM
 RB REDBUD
 CUC CUCUMBER
 BR BRUSH
 M MAPLE
 DW DOGWOOD
 HIC HICKORY
 O OAK
 LN LINEN
 WH WHITE HAZEL
 BL BUCKEYE
 CH CHESTNUT
 SB SUGARBERRY
 C CANNABERRY
 C CEDAR
 G GUM
 MAG MAGNOLIA
 SPR SPRUCE
 CM CREEPY MYRTLE

TREE CONSERVATION AREA NOTE:
VISIT [HTTPS://ARCCG.IS/144IHh1](https://arccg.is/144ihh1) FOR TCA PHOTOGRAPHS.
CLICK ON EACH POINT TO SEE PHOTOS. PHOTO 1 IS
A STANDARD IMAGE. PHOTO 2 IS A PANORAMIC VIEW.

Area C8						
Sf: 2,565			Acres: 0.0589			
#	Type/Type	DBH	Health	SQL FT.	Per-Acre	
1	PINE	4	GOOD	0.09	1.48	
2	PINE	8	GOOD	0.34	2.92	
3	PINE	3	GOOD	0.03	0.85	
4	PINE	3	GOOD	0.03	0.85	
5	PINE	3	GOOD	0.03	0.85	
6	PINE	4	GOOD	0.08	1.48	
7	PINE	6	GOOD	0.34	2.92	
8	MALB.			2.68	42.61	
TOTAL BASAL AREA			4.35	75.71		

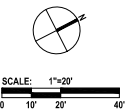

SCALE:	1"=20'
DATE:	05/25/2023
DESIGNED BY:	RB, PK
DRAWN BY:	PK
CHECKED BY:	RB

C-614

FILE NO.:



Cole Jones & Stone
BOLTON & MENK, INC.

418 S DAWSON STREET
RALEIGH, NORTH CAROLINA 27601
Phone: (919) 719-1800
Email: raleigh@bolton-menk.com
www.bolton-menk.com

TERWILLIGER PAPPAS

510 GLENWOOD AVE
SUITE 317
RALEIGH, NC 27603

**SOLIS BUFFALO RD
MULTIFAMILY**

5017 FORESTVIEW RD
RALEIGH, NC 27616

**TREE CONSERVATION
AREA D**

PROJECT NO:
50645

REVISIONS:
B. AIR Submittal 11/09/2022
1. 1st AIR Plan Review 01/12/2023
2. 2nd AIR Plan Review 02/23/2023
3. 3rd AIR Plan Review 03/02/2023
4. 4th AIR Plan Review 05/25/2023

Area B6					
#	Tree Type	DBH	Heath	SO. FT.	Per Acre
1	AMERICAN HOPHORBEAM	4	0.000	0.00	1.58
2	AMERICAN HOPHORBEAM	18	0.000	1.50	16.10
3	AM	8	0.000	0.50	1.58
4	AM	9	0.000	0.40	6.89
5	AM	8	0.000	0.50	3.50
6	HOLLY	3	0.000	0.50	1.58
7	HOLLY	3	0.000	0.50	1.58
8	HOLLY	3	0.000	0.50	1.58
9	HOLLY	6	0.000	0.50	1.50
10	AM	8	0.000	0.50	1.58
11	AM	10	0.000	0.50	6.85
12	AM	10	0.000	0.50	11.43
13	AM	4	0.000	0.50	1.58
14	AM	18	0.000	1.50	16.10
15	AM	18	0.000	1.50	16.10
TOTAL BASAL AREA: 2.31					

Area B7					
#	Tree Type	DBH	Heath	SO. FT.	Per Acre
1	AM	7	0.000	0.50	4.89
2	AM	9	0.000	0.40	7.70
3	AMERICAN HOPHORBEAM	3	0.000	0.50	0.86
4	MAPLE	3	0.000	0.50	0.86
5	MAPLE	4	0.000	0.50	1.82
6	MAPLE	3	0.000	0.50	1.86
7	MAPLE	3	0.000	0.50	1.86
8	AM	7	0.000	0.50	4.89
9	HOLLY	4	0.000	0.50	1.82
10	HOLLY	4	0.000	0.50	1.82
11	HOLLY	4	0.000	0.50	1.82
12	AM	30	0.000	3.10	38.35
13	AM	8	0.000	0.50	6.08
14	AM	10	0.000	0.50	1.86
15	AM	8	0.000	0.50	1.82
16	AM	8	0.000	0.50	1.82
17	AM	13	0.000	0.50	11.43
18	AM	17	0.000	0.80	27.48
19	AM	11	0.000	0.80	11.80
20	AM	18	0.000	1.40	24.33
21	AM	18	0.000	1.40	24.33
TOTAL BASAL AREA: 8.22					


Area B8					
#	Tree Type	DBH	Heath	SO. FT.	Per Acre
1	MAPLE	6	0.000	0.50	6.42
2	MAPLE	8	0.000	0.50	1.82
3	MAPLE	8	0.000	0.50	0.86
4	AM	18	0.000	1.50	16.10
5	AM	3	0.000	0.50	1.86
6	AM	3	0.000	0.50	1.86
7	AM	4	0.000	0.50	1.82
8	AM	3	0.000	0.50	1.82
9	AM	10	0.000	0.50	6.08
10	AM	10	0.000	0.50	6.08
11	AM	10	0.000	0.50	6.08
12	AM	10	0.000	0.50	6.08
13	AM	10	0.000	0.50	6.08
14	AM	10	0.000	0.50	6.08
15	AM	10	0.000	0.50	6.08
16	AM	10	0.000	0.50	6.08
17	AM	10	0.000	0.50	6.08
18	AM	10	0.000	0.50	6.08
19	AM	10	0.000	0.50	6.08
20	AM	10	0.000	0.50	6.08
TOTAL BASAL AREA: 24.82					

Area B9					
#	Tree Type	DBH	Heath	SO. FT.	Per Acre
1	AM	4	0.000	0.50	1.58
2	AM	10	0.000	0.50	1.58
3	DOODWOOD	7	0.000	0.50	1.58
4	AMERICAN HOPHORBEAM	18	0.000	1.50	16.10
5	AM	10	0.000	0.50	1.58
6	AM	10	0.000	0.50	1.58
7	AM	10	0.000	0.50	1.58
8	AM	10	0.000	0.50	1.58
9	AM	10	0.000	0.50	1.58
10	AM	10	0.000	0.50	1.58
11	AM	10	0.000	0.50	1.58
12	AM	10	0.000	0.50	1.58
13	AM	10	0.000	0.50	1.58
14	AM	10	0.000	0.50	1.58
15	AM	10	0.000	0.50	1.58
16	AM	10	0.000	0.50	1.58
17	AM	10	0.000	0.50	1.58
18	AM	10	0.000	0.50	1.58
19	AM	10	0.000	0.50	1.58
20	AM	10	0.000	0.50	1.58
TOTAL BASAL AREA: 24.82					

Area B10					
#	Tree Type	DBH	Heath	SO. FT.	Per Acre
1	MAPLE	7	0.000	0.50	6.42
2	HOLLY	3	0.000	0.50	1.80
3	HOLLY	6	0.000	0.50	1.80
4	HOLLY	6	0.000	0.50	1.80
5	DOODWOOD	3	0.000	0.50	1.80
6	DOODWOOD	3	0.000	0.50	1.80
7	PRIME	27	0.000	8.80	81.68
8	AM	14	0.000	1.50	21.88
9	AM	7	0.000	0.50	1.80
10	AM	7	0.000	0.50	1.80
11	AM	7	0.000	0.50	1.80
12	AM	7	0.000	0.50	1.80
13	AM	7	0.000	0.50	1.80
14	AM	7	0.000	0.50	1.80
15	AM	7	0.000	0.50	1.80
16	AM	7	0.000	0.50	1.80
17	AM	7	0.000	0.50	1.80
18	AM	7	0.000	0.50	1.80
19	AM	7	0.000	0.50	1.80
20	AM	7	0.000	0.50	1.80
TOTAL BASAL AREA: 7.10					

Area B11					
#	Tree Type	DBH	Heath	SO. FT.	Per Acre
1	PRIME	18	0.000	1.50	16.10
2	PRIME	18	0.000	1.50	16.10
3	AMERICAN HOPHORBEAM	18	0.000	1.50	16.10
4	AM	18	0.000	1.50	16.10
5	AM	18	0.000	1.50	16.10
6	AM	18	0.000	1.50	16.10
7	AM	18	0.000	1.50	16.10
8	AM	18	0.000	1.50	16.10
9	AM	18	0.000	1.50	16.10
10	AM	18	0.000	1.50	16.10
11	AM	18	0.000	1.50	16.10
12	AM	18	0.000	1.50	16.10
13	AM	18	0.000	1.50	16.10
14	AM	18	0.000	1.50	16.10
15	AM	18	0.000	1.50	16.10
16	AMERICAN HOPHORBEAM	18	0.000	1.50	16.10
17	AM	18	0.000	1.50	16.10
18	DOODWOOD	3	0.000	0.50	1.80
TOTAL BASAL AREA: 8.20					

Area B5					
#	Tree Type	DBH	Heath	SO. FT.	Per Acre
1	HOLLY	3	0.000	0.50	1.80
2	HOLLY	3	0.000	0.50	1.80
3	HOLLY	3	0.000	0.50	1.80
100	HOLLY	3	0.000	0.50	1.80
TOTAL SPACIAL AREA			0.56	222.50	

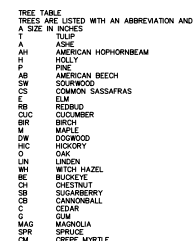

ColeJenest&Stone
BOLTON & MENK, INC.

418 S DAWSON STREET
RALEIGH, NORTH CAROLINA 27601
Phone: (919) 719-1800
Email: raleigh@bolton-menk.com
www.bolton-menk.com

TERWILLIGER PAPPAS

510 GLENWOOD AVE

SOLIS BUFFALOE RD
MULTIFAMILY

5017 FORESTVILLE RD

TREE CONSERVATION
AREA D

PROJECT NO. _____

REVISIONS:

1. 1st ASR Plan Review 01/12/2023
2. 2nd ASR Plan Review 02/23/2023
3. 3rd ASR Plan Review 04/28/2023
4. 4th ASR Plan Review 05/25/2023

9	58	4	0.000	100% BLU	PELLAGRA
9	58	4	0.000	100% BLU	PELLAGRA
12	80	3	0.000	100% BLU	PELLAGRA
12	80	3	0.000	100% BLU	PELLAGRA
12	80	3	0.000	100% BLU	PELLAGRA
12	80	3	0.000	100% BLU	PELLAGRA
14	81	31	0.000	100% BLU	PELLAGRA
14	81	31	0.000	100% BLU	PELLAGRA
15	81	30	0.000	100% BLU	PELLAGRA
TOTAL BASE AREA			0.00	0.00	

TREE CONSERVATION AREA NOTE:
VISIT [HTTPS://ARCCGIS/1449BH1](https://arccgis/1449BH1) FOR TCA PHOTOGRAPHS.
CLICK ON EACH POINT TO SEE PHOTOS. PHOTO 1 IS
A STANDARD IMAGE. PHOTO 2 IS A PANORAMIC VIEW.

TREE CONSERVATION AREA NOTE:
VISIT [HTTPS://ARCC.JS/1448H1](https://arcc.js/1448H1) FOR TCA PHOTOGRAPHS.
CLICK ON EACH POINT TO SEE PHOTOS. PHOTO 1 IS
A STANDARD IMAGE. PHOTO 2 IS A PANORAMIC VIEW.

SCALE: 1"=20'



0 10' 20' 40'

SCALE:	1"=20'
DATE:	05/25/
DESIGNED BY:	RB, PK
DRAWN BY:	PK
CHECKED BY:	RB

C-616

FILE NO.



Cole Jones & Stone
BOLTON & MENK, INC.

418 S DAWSON STREET
RALEIGH, NORTH CAROLINA 27601
Phone: (919) 719-1800
Email: raleigh@bolton-menk.com
www.bolton-menk.com

TERWILLIGER PAPPAS

510 GLENWOOD AVE
SUITE 317
RALEIGH, NC 27603

SOLIS BUFFALO RD
MULTIFAMILY

5017 FORESTLIDE RD
RALEIGH, NC 27618

SITE DETAILS I

PROJECT NO:

50645

REVISIONS:

1. AIR Submittal 11/09/2022

2. 1st AIR Plan Review 01/12/2023

3. 2nd AIR Plan Review 02/23/2023

4. 3rd AIR Plan Review 04/20/2023

5. 4th AIR Plan Review 05/25/2023

DATE:

05/25/2023

DESIGNED BY:

RB

DRAWN BY:

PLRB

CHECKED BY:

RB

SCALE:

VARIABLES

DATE:

05/25/2023

DESIGNED BY:

RB

DRAWN BY:

PLRB

CHECKED BY:

RB

SCALE:

VARIABLES

DATE:

05/25/2023

DESIGNED BY:

RB

DRAWN BY:

PLRB

CHECKED BY:

RB

SCALE:

VARIABLES

DATE:

05/25/2023

DESIGNED BY:

RB

DRAWN BY:


PLRB

CHECKED BY:

RB

C-700

FILE NO:

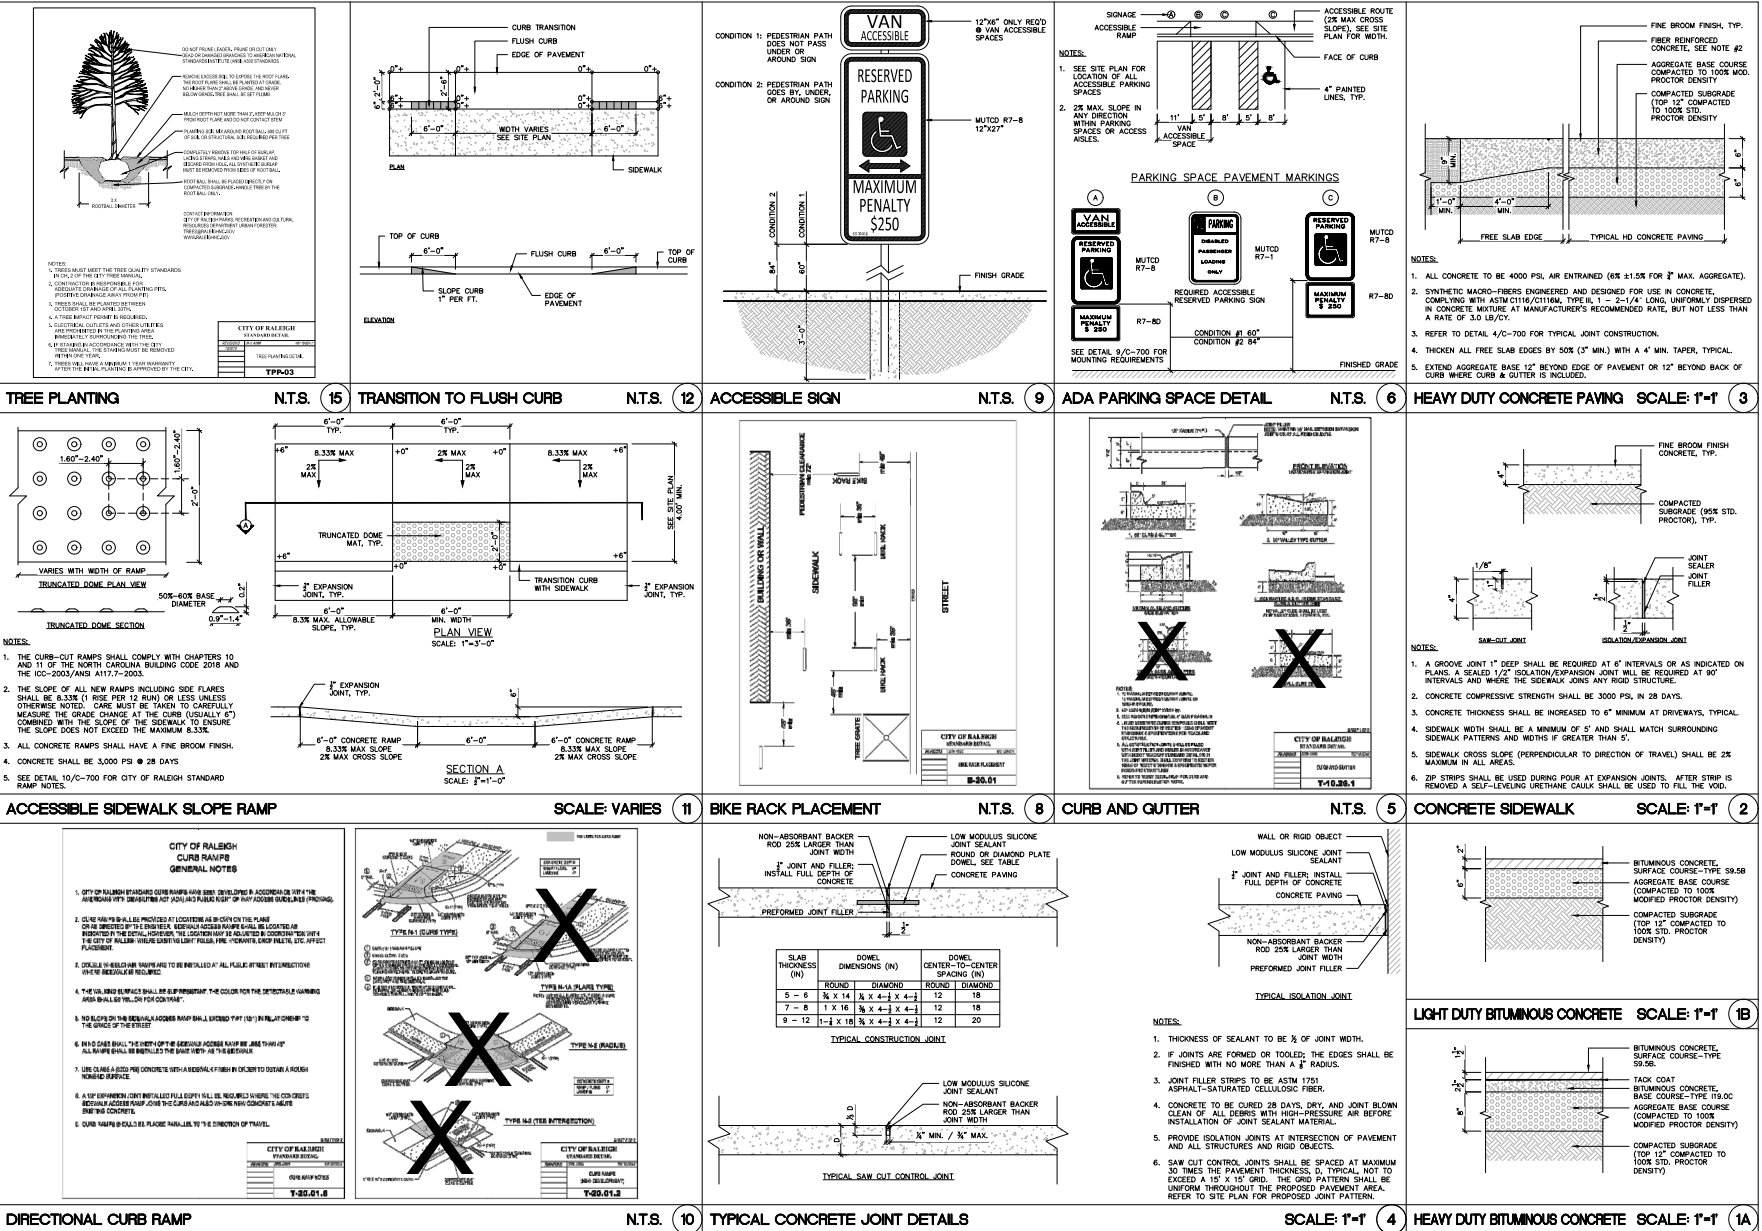

PROJECT MATRIX | OVERALL PROJECT

Unit Building Area Analysis								
	QTY	1st level Gross SF	2nd level Gross SF	3rd level Gross SF	4th level Gross SF	Bldg Total Gross SF	Project Gross SF	AC % of GSF
MIX 3.0	2	13,889	13,782	13,270	-	40,941	81,882	86%
MIX 3.2	4	12,162	12,055	11,543	-	35,760	143,040	87%
MIX 3.4	2	12,017	11,910	11,398	-	35,325	70,650	86%
MIX 3.5	2	11,129	11,022	10,510	-	32,661	65,322	86%
Totals	10						360,894	86%

Unit Matrix										
Unit Type	QTY	Air Cond SF	Balcony SF	Entry SF	Storage SF	Garage SF	Total SF	% Total Units	% Bed & Qty	ANSI A 2%
AS1	0	707	0	-	0	0	707	0%	1B = 46% 144	3
A1	84	756	60	-	0	0	816	27%		
A2	60	816	0	-	0	0	816	19%		
B1	48	1,164	60	-	0	0	1,224	15%	2B = 46% 144	3
B1c	96	1,176	60	-	0	0	1,236	31%		
C1	24	1,248	60	-	0	0	1,308	8%	3B = 8% 24	1
Average		997								
Totals	312	311,184	15,120		0	0	326,304	100%	100%	7

Building Unit Matrix												
	QTY	Unit/ Bldg	AS1	A1	A2	B1	B1c	C1	Bldg AC RSF	Project AC RSF		
MIX 3.0	2	36	0	12	6	6	12	0	35,064	70,128		
MIX 3.2	4	30	0	6	6	6	6	6	30,960	123,840		
MIX 3.4	2	30	0	6	6	6	12	0	30,528	61,056		
MIX 3.5	2	30	0	12	6	0	12	0	28,080	56,160		
Totals	10	312	0	84	60	48	96	24	-	311,184		



1520 Prudential Drive
Jacksonville, Florida 32207
904.353.3900 (or) 904.353.3948 [F]

PLANS, DESIGN CONCEPTS, WRITTEN MATERIALS & DRAWINGS ARE NOT TO BE REPRODUCED, ALTERED, COPIED IN ANY FORM OR MANNER NOR ASIGNED TO ANY PARTY WITHOUT FIRST OBTAINING THE EXPRESS WRITTEN PERMISSION AND CONSENT OF GROUP 4 ARCHITECTURAL SERVICES, LLC.

DO NOT SCALE THE DRAWINGS IF NOT SHOWN, VERIFY CORRECT DIMENSIONS WITH THE ARCHITECT. SCALE NOTES & FOR FULL ANALYST SEE PERMITS.

CONTRACTOR SHALL CHECK & VERIFY ALL JOB SITE CONDITIONS.

© 2022 G4 Architectural Services, LLC.

Not valid for permitting
without digital signature,
Seal, and Date.

Issues and Revisions		Description	
Rev	Date	By	
1			
2			
3			
4			
5			
6			
7			
8			
9			
10			



Project Number: XXXXXXXXX
Drawn By: G4
Checked By: JAX
Project Name:
SQUIS BUFFALO
TERWUJGER PAPPAS
RALEIGH, NC
Drawing Name:
PROJECT MATRIX
OVERALL PROJECT

A01e



② BUILDING MIX 3.5 - MODIFIED
EXTERIOR ELEVATION - RIGHT

MATERIAL LEGEND	
①	FIBER CEMENT LAP SIDING, 7" EXPOSURE, PAINTED
②	FIBER CEMENT LAP SIDING, 10" EXPOSURE, PAINTED
③	FIBER CEMENT PANEL, SMOOTH, PAINTED
④	FIBER CEMENT TRIM, SMOOTH, PAINTED
⑤	42" HIGH ALUMINUM GUARDRAIL
⑥	ARCHITECTURAL ASPHALT SHINGLES
⑦	FIBER CEMENT BOARD AND BATTEN, SMOOTH, PAINTED
⑧	FIBER CEMENT LAP SIDING, 3" EXPOSURE, PAINTED
⑨	B1, PAINTED
⑩	B2, PAINTED
⑪	B3, PAINTED
GENERAL MATERIALS (UNO)	
FIBER CEMENT TRIM : SMOOTH : PAINTED : 5/4" THICK UNLD. ALL DOOR / WINDOW TRIM AT FIBER CEMENT WALLS RE: DETAILS	
ALL FIBER CEMENT LAP SIDING: WOOD GRAIN TEXTURE	
WALLS OR SECTION OF WALLS RECEIVING BOARD AND BATTEN TO HAVE BATTENS EQUALLY SPACED, STARTING ON CENTER AND SPACED OUTWARD	



① BUILDING MIX 3.5 - MODIFIED
EXTERIOR ELEVATION - FRONT



PLANS, DESIGN CONCEPTS, WRITTEN MATERIALS &
DRAWINGS ARE NOT TO BE REPRODUCED, COPIED,
COPIED IN ANY FORM OR MANNER, FOR ANY
PURPOSE WITHOUT THE EXPRESS WRITTEN
PERMISSION AND CONSENT OF GROUP 4
ARCHITECTURAL SERVICES, LLC.

DO NOT SCALE THE DRAWINGS. IF NOT SHOWN, VERIFY
CORRECT DIMENSIONS WITH THE ARCHITECT. SCALE
NOTES: 1. FOR THE PLANS: 1/8" = 1'-0"

CONTRACTOR SHALL CHECK & VERIFY ALL JOBSITE
CONDITIONS.


© 2022 G4 Architectural Services, LLC.

Issues and Revisions	
No.	By
Date	
1	
2	
3	
4	
5	
6	
7	
8	
9	
10	
11	
12	
13	
14	
15	
16	
17	
18	
19	
20	



Project Number:
Drawn By: G4
Checked By:
Project Name:
SOUTH BUFFALO
TERVILLE PAPPAS
RALEIGH, NC
Drawing Name:
BUILDING MIX 3.2
EXTERIOR ELEVATIONS
ELEVATION B

A330a

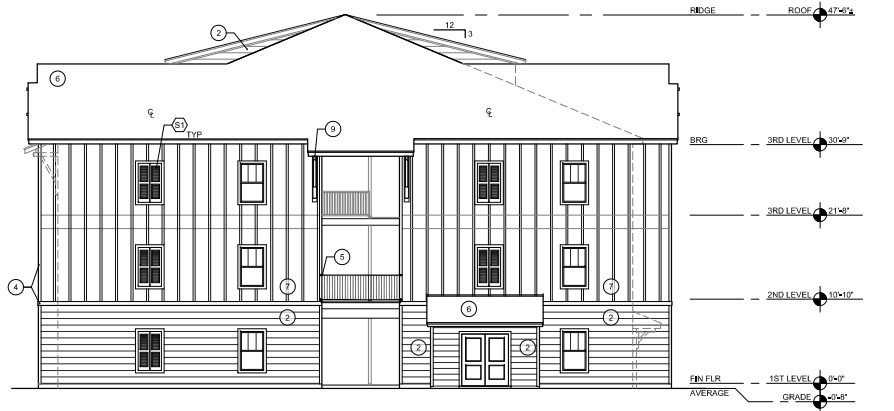

2 BUILDING MIX 3.5 - MODIFIED
EXTERIOR ELEVATION - LEFT

MATERIAL LEGEND	
1	FIBER CEMENT LAP SIDING, 7" EXPOSURE, PAINTED
2	FIBER CEMENT LAP SIDING, 10" EXPOSURE, PAINTED
3	FIBER CEMENT PANEL, SMOOTH, PAINTED
4	FIBER CEMENT TRIM, SMOOTH, PAINTED
5	42" HIGH ALUMINUM GUARDRAIL
6	ARCHITECTURAL ASPHALT SHINGLES
7	FIBER CEMENT BOARD AND BATTEN, SMOOTH, PAINTED
8	FIBER CEMENT LAP SIDING, 3" EXPOSURE, PAINTED
9	B1, PAINTED
10	B2, PAINTED
11	B3, PAINTED
GENERAL MATERIALS (UNO)	
FIBER CEMENT TRIM : SMOOTH - PAINTED : 1/4" THICK UNLD. ALL DOOR / WINDOW TRIM AT FIBER CEMENT WALLS RE: DETAILS	
ALL FIBER CEMENT LAP SIDING: WOOD GRAIN TEXTURE	
WALLS OR SECTION OF WALLS RECEIVING BOARD AND BATTEN TO HAVE BATTENS EQUALLY SPACED, STARTING ON CENTER AND SPACED OUTWARD	



1520 Prudential Drive
Jacksonville, FL 32207
904.333.2900 (or) 904.333.2968 (f)


PLANS, DESIGN CONCEPTS, WRITTEN MATERIALS &
DRAWINGS ARE NOT TO BE REPRODUCED, COPIED,
COPIED IN ANY FORM OR MANNER, FOR ANY
PURPOSE WITHOUT THE EXPRESS WRITTEN
PERMISSION AND CONSENT OF GROUP 4
ARCHITECTURAL SERVICES, LLC.

DO NOT SCALE THE DRAWINGS. IF NOT SHOWN, VERIFY
CORRECT DIMENSIONS WITH THE ARCHITECT. SCALE
NOTES: 1. FOR THIS PLAN, 1" = 16'-0".

CONTRACTOR SHALL CHECK & VERIFY ALL JOBSITE
CONDITIONS.

© 2022 G4 Architectural Services, LLC.

Issues and Revisions	
No.	By
Date	
1	
2	
3	
4	
5	
6	
7	
8	
9	
10	
11	

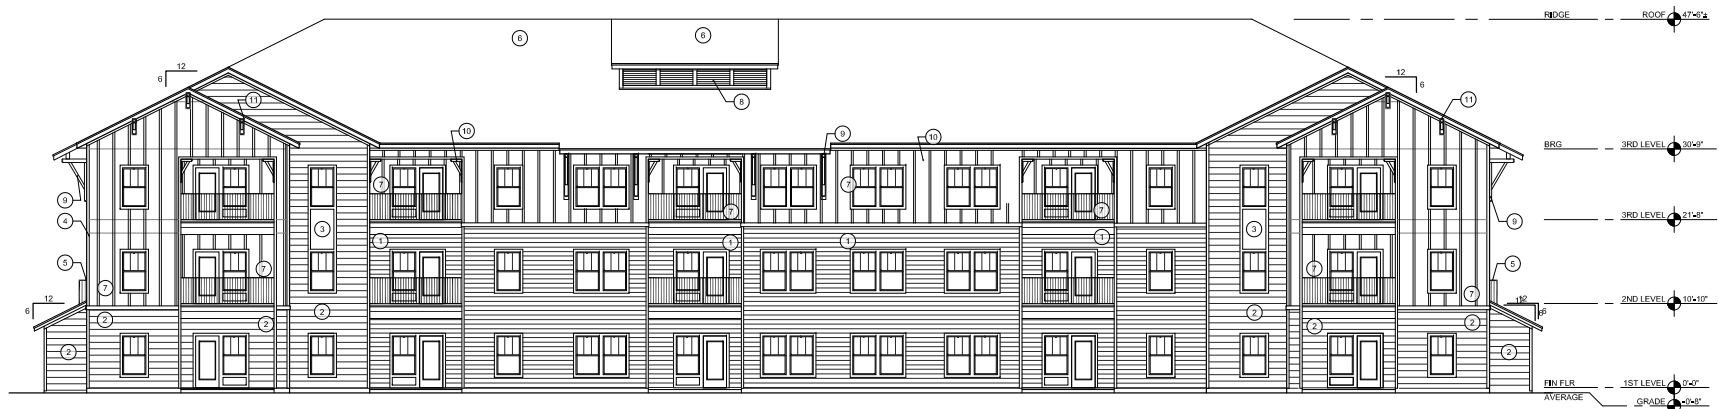


1 BUILDING MIX 3.5 - MODIFIED
EXTERIOR ELEVATION - REAR



Project Number:	
Drawn By:	G4
Checked By:	
Project Name:	
SOB: BUFFALO	
TERVILLE PAPPAS	
RALEIGH, NC	
Drawing Name:	
BUILDING MIX 3.2	
EXTERIOR ELEVATIONS	
ELEVATION B	

A330b

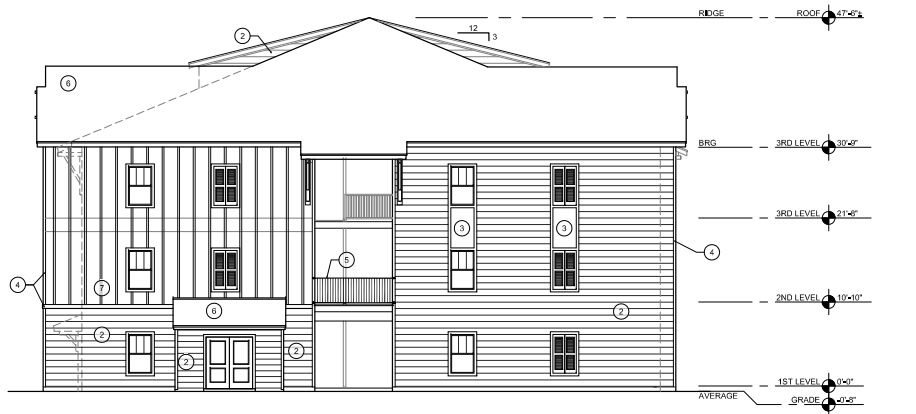

2 BUILDING MIX 3.2 - MODIFIED
EXTERIOR ELEVATION - RIGHT

MATERIAL LEGEND	
1	FIBER CEMENT LAP SIDING, 7" EXPOSURE, PAINTED
2	FIBER CEMENT LAP SIDING, 10" EXPOSURE, PAINTED
3	FIBER CEMENT PANEL, SMOOTH, PAINTED
4	FIBER CEMENT TRIM, SMOOTH, PAINTED
5	42" HIGH ALUMINUM GUARDRAIL
6	ARCHITECTURAL ASPHALT SHINGLES
7	FIBER CEMENT BOARD AND BATTEN, SMOOTH, PAINTED
8	FIBER CEMENT LAP SIDING, 3" EXPOSURE, PAINTED
9	B1, PAINTED
10	B2, PAINTED
11	B3, PAINTED
GENERAL MATERIALS (UNO)	
FIBER CEMENT TRIM : SMOOTH : PAINTED : 5/8" THICK UNLD. ALL DOOR / WINDOW TRIM AT FIBER CEMENT WALLS REF: DETAILS	
ALL FIBER CEMENT LAP SIDING: WOOD GRAIN TEXTURE	
WALLS OR SECTION OF WALLS RECEIVING BOARD AND BATTEN TO HAVE BATTENS EQUALLY SPACED, STARTING ON CENTER AND SPACED OUTWARD	



1520 Prudential Drive
Jacksonville, FL 32207
904.333.2900 (or) 904.333.2968 (f)

PLANS, DESIGN CONCEPTS, WRITTEN MATERIALS &
DRAWINGS ARE NOT TO BE REPRODUCED, COPIED,
COPIED IN ANY FORM OR MANNER, NOR ADAPTED,
TO ANY PART, WITHOUT WRITTEN PERMISSION OR EXPRESS
WRITTEN PERMISSION AND CONSENT OF GROUP 4
ARCHITECTURAL SERVICES, LLC.

DO NOT SCALE THE DRAWINGS. IF NOT SHOWN, VERIFY
CORRECT DIMENSIONS WITH THE ARCHITECT. SCALE
NOTES: 1. FOR THE PLANS, 1" = 10'-0". 2. FOR THE
CONTRACTOR SHALL CHECK & VERIFY ALL JOINTS
CONFORMING.

© 2022 G4 Architectural Services, LLC.

Issues and Revisions		Drawn By	Checked By
No.	Date	By	By
1			
2			
3			
4			
5			
6			
7			
8			
9			
10			
11			



1 BUILDING MIX 3.2 - MODIFIED
EXTERIOR ELEVATION - FRONT




Project Number:	
Drawn By:	G4
Checked By:	
Project Name:	
SOB: BUFFALO	
TERVILLE PAPPAS	
RALEIGH, NC	
Drawing Name:	
BUILDING MIX 3.2	
EXTERIOR ELEVATIONS	
ELEVATION B	

A332a



2 BUILDING MIX 3.2 - MODIFIED
EXTERIOR ELEVATION - LEFT

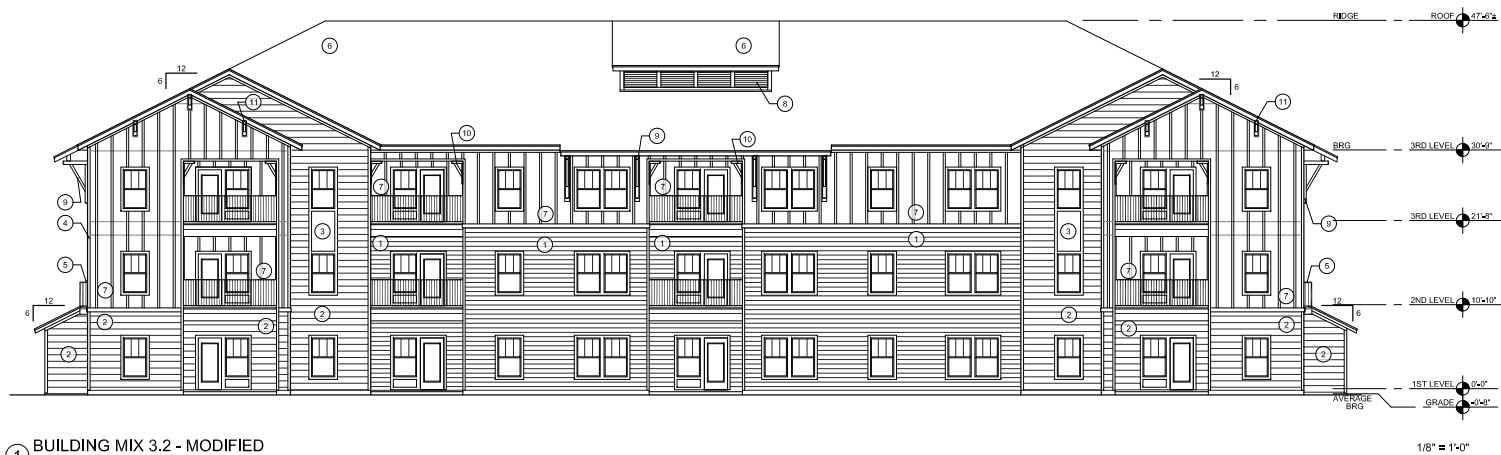

1 BUILDING MIX 3.2 - MODIFIED
EXTERIOR ELEVATION - REAR

MATERIAL LEGEND	
1	FIBER CEMENT LAP SIDING, 7" EXPOSURE, PAINTED
2	FIBER CEMENT LAP SIDING, 10" EXPOSURE, PAINTED
3	FIBER CEMENT PANEL, SMOOTH, PAINTED
4	FIBER CEMENT TRIM, SMOOTH, PAINTED
5	42" HIGH ALUMINUM GUARDRAIL
6	ARCHITECTURAL ASPHALT SHINGLES
7	FIBER CEMENT BOARD AND BATTEN, SMOOTH, PAINTED
8	FIBER CEMENT LAP SIDING, 3" EXPOSURE, PAINTED
9	B1, PAINTED
10	B2, PAINTED
11	B3, PAINTED
GENERAL MATERIALS (UNO)	
FIBER CEMENT TRIM : SMOOTH : PAINTED : 5/4" THICK UNLD. ALL DOOR / WINDOW TRIM AT FIBER CEMENT WALLS RE: DETAILS	
ALL FIBER CEMENT LAP SIDING: WOOD GRAIN TEXTURE	
WALLS OR SECTION OF WALLS RECEIVING BOARD AND BATTEN TO HAVE BATTENS EQUALLY SPACED, STARTING ON CENTER AND SPACED OUTWARD	



1520 Prudential Drive
Jacksonville, FL 32207
904.333.2000 (or) 904.333.2968 (f)

PLANS, DESIGN CONCEPTS, WRITTEN MATERIALS &
DRAWINGS ARE NOT TO BE REPRODUCED, COPIED,
COPIED IN ANY FORM OR MANNER, NOR ADAPTED,
TO ANY PART, WITHOUT WRITTEN PERMISSION AND
CONSENT OF GROUP 4 ARCHITECTURAL SERVICES, LLC.

DO NOT SCALE THE DRAWINGS. IF NOT SHOWN, VERIFY
CORRECT DIMENSIONS WITH THE ARCHITECT. SCALE
NOTES: FOR THE PROJECT, SEE THE ARCHITECT'S
CONTRACTOR SHALL CHECK & VERIFY ALL JOBSITE
CONDITIONS.


© 2022 G4 Architectural Services, LLC.

Issues and Revisions	
No.	By
1	1
2	2
3	3
4	4
5	5
6	6
7	7
8	8
9	9
10	10
11	11
12	12
13	13
14	14
15	15
16	16
17	17
18	18
19	19
20	20
21	21
22	22
23	23
24	24
25	25
26	26
27	27
28	28
29	29
30	30
31	31
32	32
33	33
34	34
35	35
36	36
37	37
38	38
39	39
40	40
41	41
42	42
43	43
44	44
45	45
46	46
47	47
48	48
49	49
50	50



Project Number:	
Drawn By:	G4
Checked By:	
Project Name:	
SOB: BUFFALO	
TERVILLE PAPPAS	
RALEIGH, NC	
Drawing Name:	
BUILDING MIX 3.2	
EXTERIOR ELEVATIONS	
ELEVATION B	

A332b

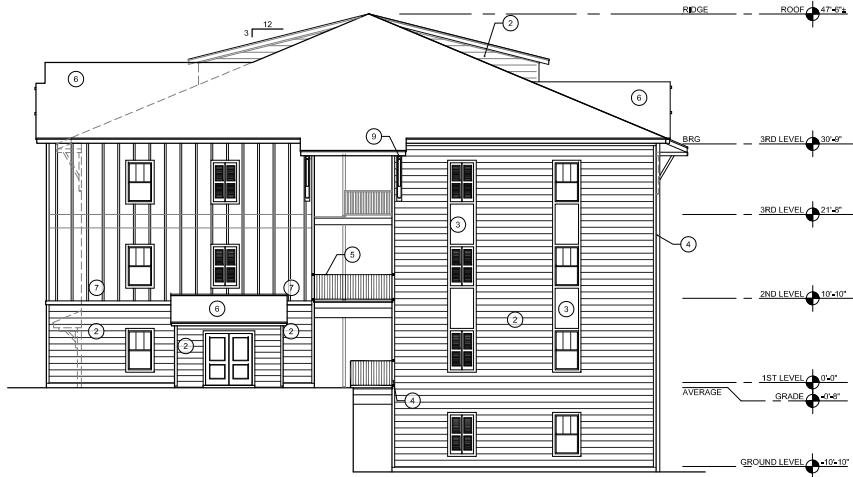

2 BUILDING MIX 3.4 - MODIFIED
EXTERIOR ELEVATION - RIGHT

1/8" = 1'-0"

MATERIAL LEGEND	
1	FIBER CEMENT LAP SIDING, 7" EXPOSURE, PAINTED
2	FIBER CEMENT LAP SIDING, 10" EXPOSURE, PAINTED
3	FIBER CEMENT PANEL, SMOOTH, PAINTED
4	FIBER CEMENT TRIM, SMOOTH, PAINTED
5	42" HIGH ALUMINUM GUARDRAIL
6	ARCHITECTURAL ASPHALT SHINGLES
7	FIBER CEMENT BOARD AND BATTEN, SMOOTH, PAINTED
8	FIBER CEMENT LAP SIDING, 3" EXPOSURE, PAINTED
9	B1, PAINTED
10	B2, PAINTED
11	B3, PAINTED
GENERAL MATERIALS (UNO)	
FIBER CEMENT TRIM: SMOOTH; PAINTED; 5/4" THICK UNLO, ALL DOOR / WINDOW TRIM AT FIBER CEMENT WALLS RE: DETAILS	
ALL FIBER CEMENT LAP SIDING: WOOD GRAIN TEXTURE	
WALLS OR SECTION OF WALLS RECEIVING BOARD AND BATTEN TO HAVE BATTENS EQUALLY SPACED, STARTING ON CENTER AND SPACED OUTWARD	



1 BUILDING MIX 3.4 - MODIFIED
EXTERIOR ELEVATION - FRONT

1/8" = 1'-0"



PLANS, DESIGN CONCEPTS, WRITTEN MATERIALS & DRAWINGS ARE NOT TO BE REPRODUCED, COPIED, COLORED, OR ANY FORM OR MANNER, NOR ADAPTED, COPIED, OR ANY PART THEREOF, WITHOUT THE EXPRESS WRITTEN PERMISSION AND CONSENT OF GROUP 4 DESIGN ARCHITECTURAL SERVICES, LLC.

DO NOT SCALE THE DRAWINGS. IF NOT SHOWN, VERIFY CORRECT DIMENSIONS WITH THE ARCHITECT. SCALE NOTES ARE FOR THE ARCHITECT'S USE ONLY.

CONTRACTOR SHALL CHECK & VERIFY ALL JOB SITE CONDITIONS.

© 2022 G4 Architectural Services, LLC.


Not to be used for permitting
without proper Seal and Date.

Issues and Revisions	
Rev	Date
1	
2	
3	
4	
5	
6	
7	
8	
9	
10	
11	



Project Number:	XXXXXX
Drawn By:	G4
Checked By:	JAX
Project Name:	
SOB: BUFFALO	
TERVILGER PAPPAS	
RALEIGH, NC	
Drawing Name:	
BUILDING MIX 3.4	
EXTERIOR ELEVATIONS	
ELEVATION B	

A334a

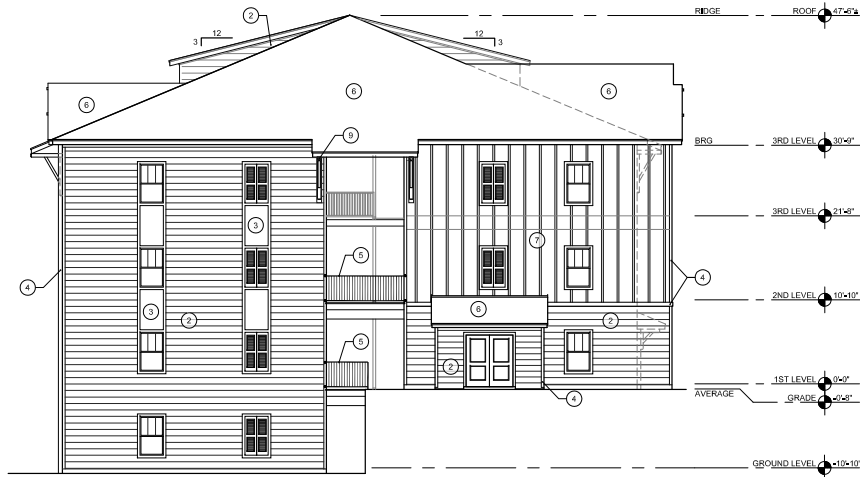

2 BUILDING MIX 3.4 - MODIFIED
EXTERIOR ELEVATION - LEFT

1/8" = 1'-0"

MATERIAL LEGEND	
1	FIBER CEMENT LAP SIDING, 7" EXPOSURE, PAINTED
2	FIBER CEMENT LAP SIDING, 10" EXPOSURE, PAINTED
3	FIBER CEMENT PANEL, SMOOTH, PAINTED
4	FIBER CEMENT TRIM, SMOOTH, PAINTED
5	42" HIGH ALUMINUM GUARDRAIL
6	ARCHITECTURAL ASPHALT SHINGLES
7	FIBER CEMENT BOARD AND BATTEN, SMOOTH, PAINTED
8	FIBER CEMENT LAP SIDING, 3" EXPOSURE, PAINTED
9	B1, PAINTED
10	B2, PAINTED
11	B3, PAINTED
GENERAL MATERIALS (UNO)	
FIBER CEMENT TRIM : SMOOTH : PAINTED : 1/4" THICK UNO, ALL DOOR / WINDOW TRIM AT FIBER CEMENT WALLS, RE: DETAILS	
ALL FIBER CEMENT LAP SIDING; WOOD GRAIN TEXTURE	
WALLS OR SECTION OF WALLS RECEIVING BOARD AND BATTEN TO HAVE BATTENS EQUALLY SPACED, STARTING ON CENTER AND SPACED OUTWARD	



1 BUILDING MIX 3.4 - MODIFIED
EXTERIOR ELEVATION - REAR

1/8" = 1'-0"



1520 Pruden Road
Jacksonville, FL 32207
904.353.3900 (or) 904.353.3948 (f)

PLANS, DESIGN CONCEPTS, WRITTEN MATERIALS & DRAWINGS ARE NOT TO BE REPRODUCED, ALTERED, COPIED, IN ANY FORM OR MANNER, NOR ADAPTED, TO ANY PARTY WITHOUT THE WRITTEN PERMISSION AND CONSENT OF GROUP 4 ARCHITECTURAL SERVICES, LLC.

DO NOT SCALE THE DRAWINGS. IF NOT SHOWN, VERIFY CORRECT DIMENSIONS WITH THE ARCHITECT. SCALE NOTES DO NOT TAKE PRECEDENCE OVER DETAILS.

CONTRACTOR SHALL CHECK & VERIFY ALL JOBSITE CONDITIONS.


© 2022 G4 Architectural Services, LLC.

Issues and Revisions		Drawn By	Check By
No.	Date		
1			
2			
3			
4			
5			
6			
7			
8			
9			
10			
11			



Project Number:	
Drawn By:	G4
Checked By:	
Project Name:	
	SOB: BUFFALO
	TERVILGER PAPPAS
	RALEIGH, NC
Drawing Name:	
	BUILDING MIX 3.4
	EXTERIOR ELEVATIONS
	ELEVATION B

A334b

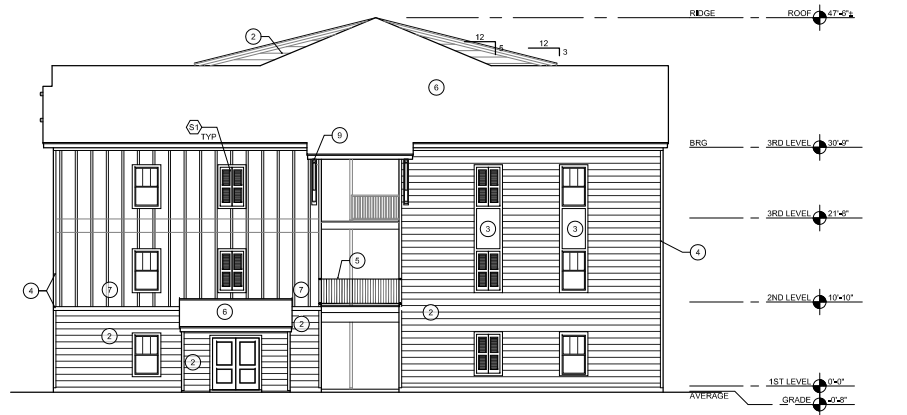

② BUILDING MIX 3.5
EXTERIOR ELEVATION - RIGHT

MATERIAL LEGEND	
①	FIBER CEMENT LAP SIDING, 7" EXPOSURE, PAINTED
②	FIBER CEMENT LAP SIDING, 10" EXPOSURE, PAINTED
③	FIBER CEMENT PANEL, SMOOTH, PAINTED
④	FIBER CEMENT TRIM, SMOOTH, PAINTED
⑤	42" HIGH ALUMINUM GUARDRAIL
⑥	ARCHITECTURAL ASPHALT SHINGLES
⑦	FIBER CEMENT BOARD AND BATTEN, SMOOTH, PAINTED
⑧	FIBER CEMENT LAP SIDING, 3" EXPOSURE, PAINTED
⑨	B1, PAINTED
⑩	B2, PAINTED
⑪	B3, PAINTED
GENERAL MATERIALS (UNO)	
FIBER CEMENT TRIM : SMOOTH - PAINTED : 1/4" THICK UNL.D. ALL DOOR / WINDOW TRIM AT FIBER CEMENT WALLS RE: DETAILS	
ALL FIBER CEMENT LAP SIDING: WOOD GRAIN TEXTURE	
WALLS OR SECTION OF WALLS RECEIVING BOARD AND BATTEN TO HAVE BATTENS EQUALLY SPACED, STARTING ON CENTER AND SPACED OUTWARD	

Issues and Revisions	
Rev	Date
1	
2	
3	
4	
5	
6	
7	
8	
9	
10	
11	
12	
13	
14	
15	
16	
17	
18	
19	
20	



① BUILDING MIX 3.5
EXTERIOR ELEVATION - FRONT

SUMMIT CONTRACTING GROUP, INC.	
Project Number:	
Drawn By:	G4
Checked By:	
Project Name:	
SOB: BUFFALO	
TERVILGER PAPPAS	
RALEIGH, NC	
Drawing Name:	
BUILDING MIX 3.5	
EXTERIOR ELEVATIONS	
ELEVATION B	





A335a



Issues and Revisions			
Rev	Date	By	Description
01			
02			
03			
04			
05			
06			
07			
08			




Issues and Revisions		By	Date
Rev	Issue		
1			
2			
3			
4			
5			
6			
7			
8			
9			
10			

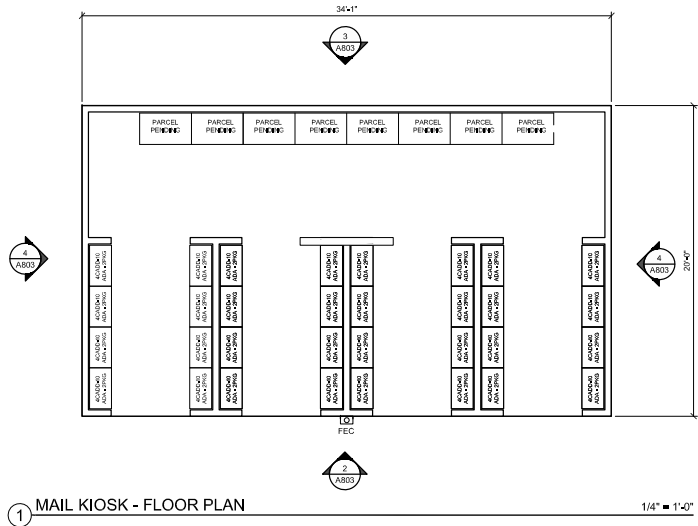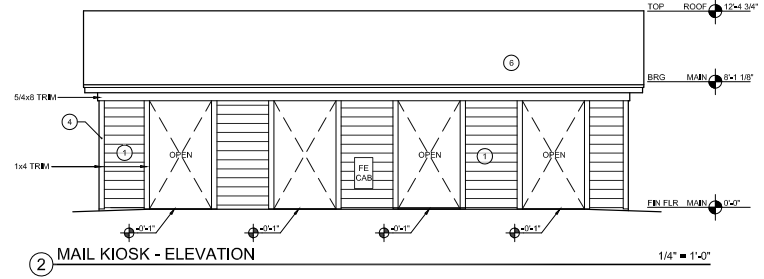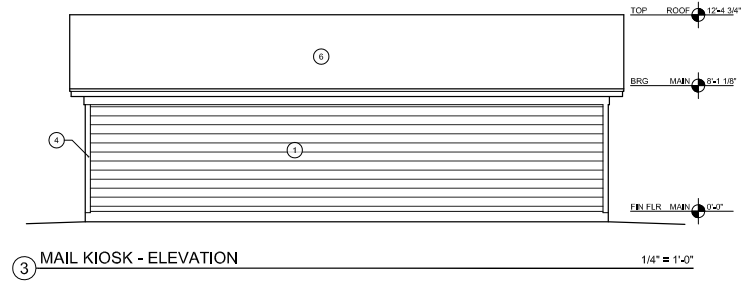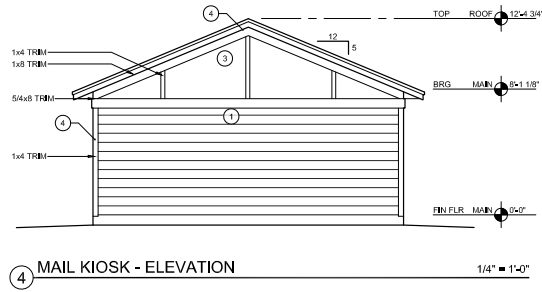


MATERIAL LEGEND	
1	FIBER CEMENT LAP SIDING, 7" EXPOSURE, PAINTED
3	FIBER CEMENT PANEL, SMOOTH, PAINTED
4	FIBER CEMENT TRIM, SMOOTH, PAINTED
6	ARCHITECTURAL ASPHALT SHINGLES


MAILBOX BASIS OF DESIGN IS FLORENCE CORPORATION
MODELS. ALL MAIL KEYS TO BE PROVIDED AT 54" AFF
AND MAIL SLOT AT 48" AFF MAXIMUM.

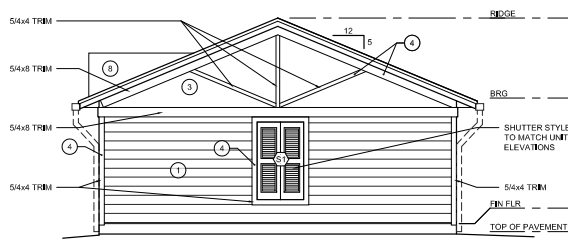

4 GARAGE - SIDE ELEVATION
5 BAY | STANDARD

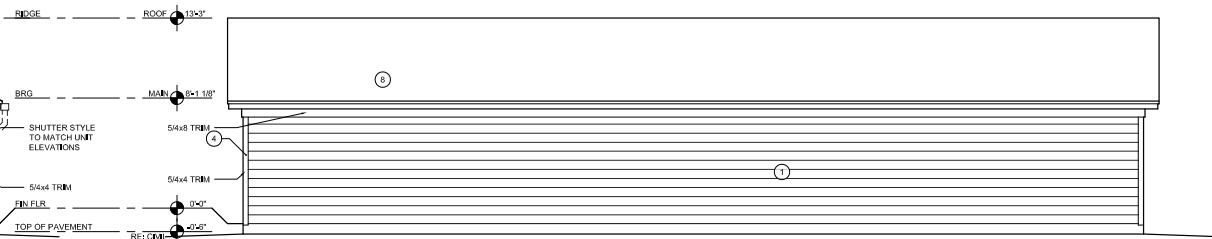


3 GARAGE - REAR ELEVATION
5 BAY | STANDARD

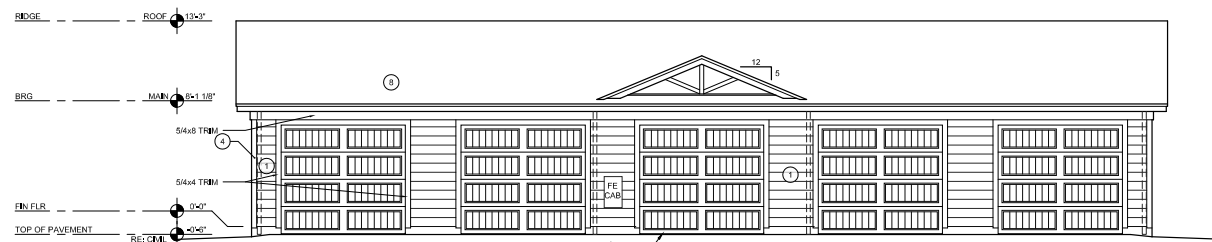

2 GARAGE - FRONT ELEVATION
5 BAY | STANDARD

1/4" = 1'-0"


MATERIAL LEGEND	
1	FIBER CEMENT LAP SIDING, 7" EXPOSURE, PAINTED
2	FIBER CEMENT LAP SIDING, 10" EXPOSURE, PAINTED
3	FIBER CEMENT PANEL, SMOOTH, PAINTED
4	FIBER CEMENT TRIM, SMOOTH, PAINTED
5	NOT USED
6	NOT USED
7	NOT USED
8	ARCHITECTURAL ASPHALT SHINGLES

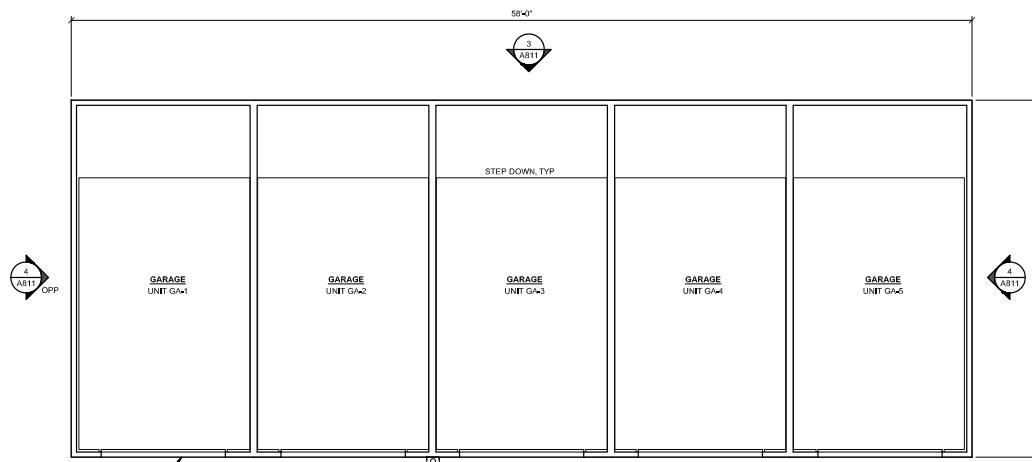


1 GARAGE - FLOOR PLAN
5 BAY | STANDARD

1/4" = 1'-0"


Issues and Revisions		By	Date
1	1	1	1
2	2	2	2
3	3	3	3
4	4	4	4
5	5	5	5
6	6	6	6
7	7	7	7
8	8	8	8
9	9	9	9
10	10	10	10

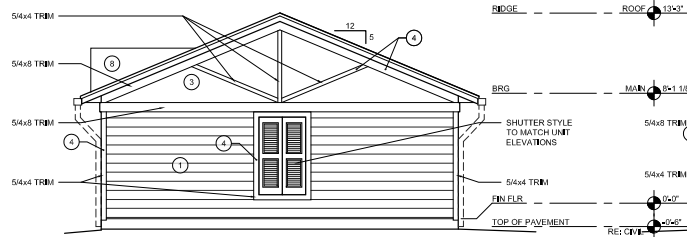

4 GARAGE - SIDE ELEVATION
5 BAY | ANSI

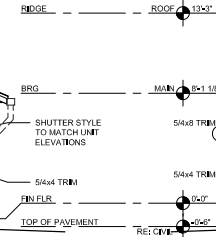


3 GARAGE - REAR ELEVATION
5 BAY | ANSI

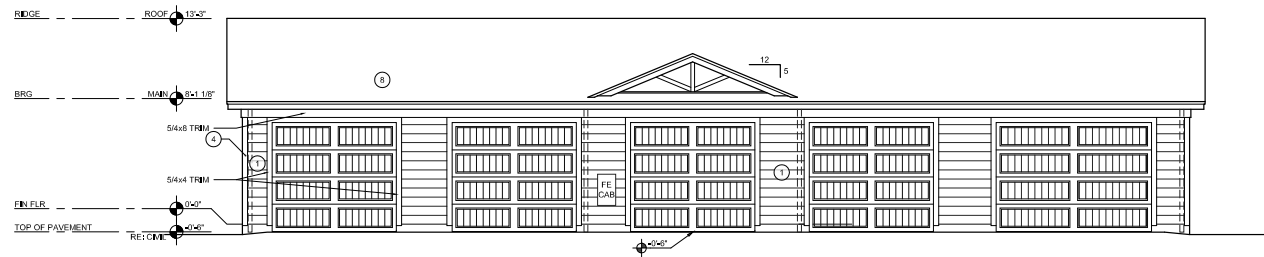


2 GARAGE - FRONT ELEVATION
5 BAY | ANSI

MATERIAL LEGEND	
1	FIBER CEMENT LAP SIDING, 7" EXPOSURE, PAINTED
2	FIBER CEMENT LAP SIDING, 10" EXPOSURE, PAINTED
3	FIBER CEMENT PANEL, SMOOTH, PAINTED
4	FIBER CEMENT TRIM, SMOOTH, PAINTED
5	NOT USED
6	NOT USED
7	NOT USED
8	ARCHITECTURAL ASPHALT SHINGLES

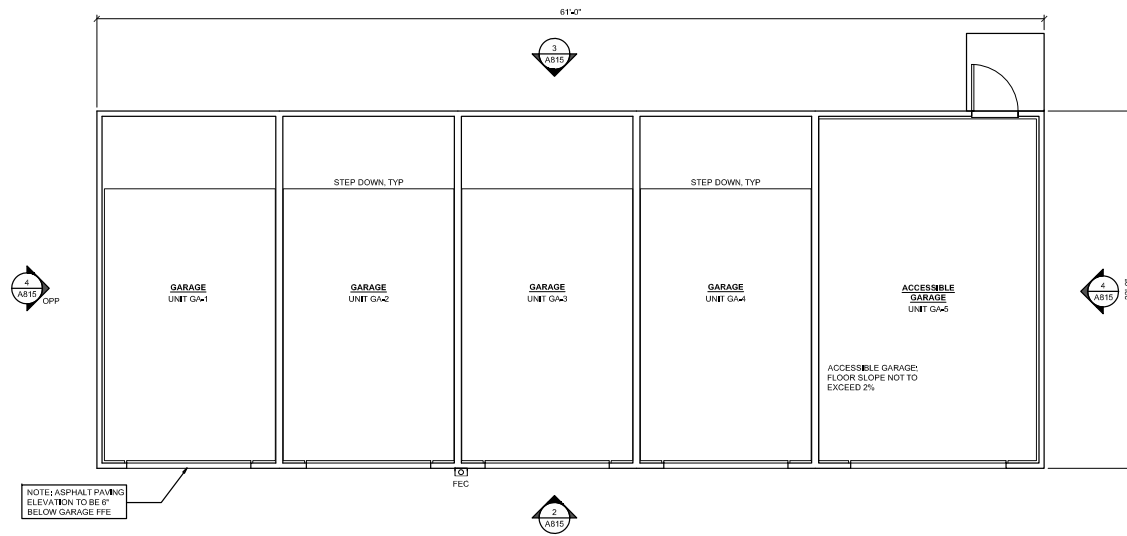


1 GARAGE - FLOOR PLAN
5 BAY | ANSI

Issues and Revisions		By	Date
1			
2			
3			
4			
5			
6			
7			
8			
9			
10			

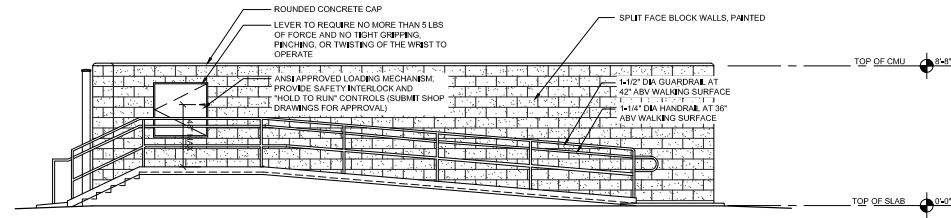


③ TRASH COMPACTOR - EXTERIOR ELEVATION

1/4" = 1'-0"

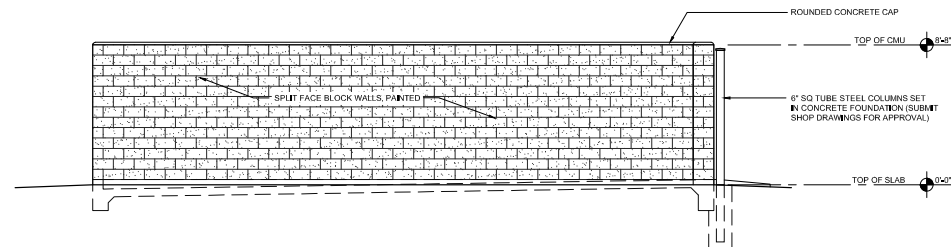


② TRASH COMPACTOR - EXTERIOR ELEVATION

1/4" = 1'-0"

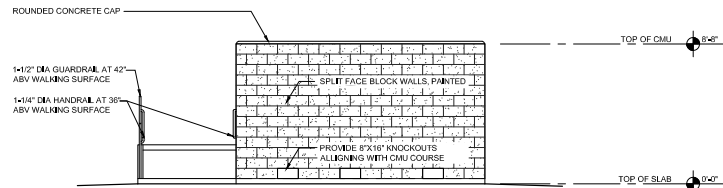


⑤ TRASH COMPACTOR - EXTERIOR ELEVATION

1/4" = 1'-0"

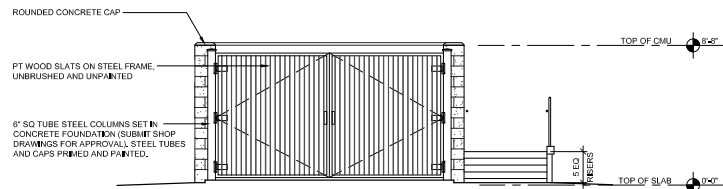

④ TRASH COMPACTOR - EXTERIOR ELEVATION

1/4" = 1'-0"

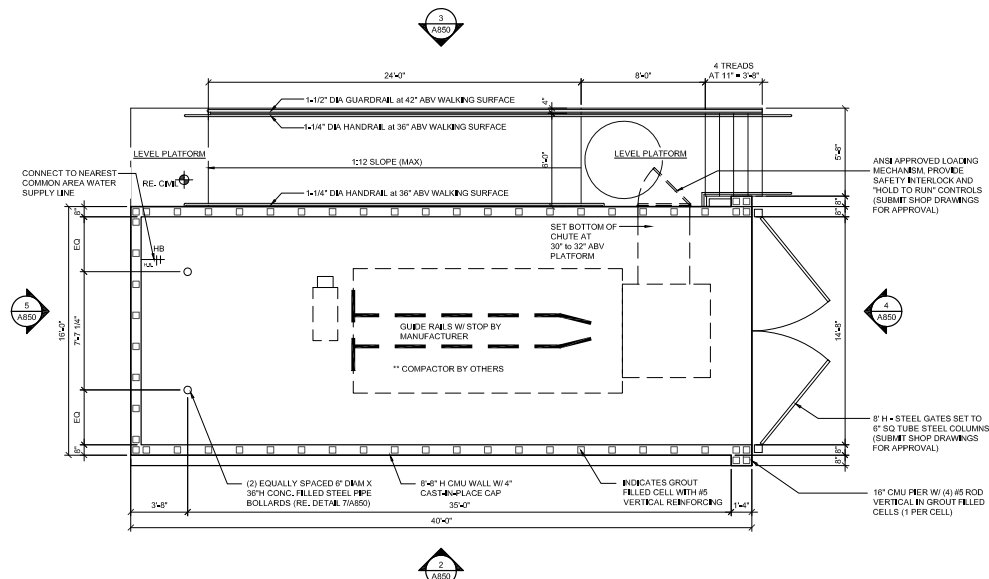


① TRASH COMPACTOR - FLOOR PLAN

1/4" = 1'-0"

NOTE: ** INDICATES DIMENSION BASED ON INFORMATION SUPPLIED BY MARATHON EQUIPMENT FOR MODEL # RJ250SC COMPACTOR
** COORDINATE ENCLOSURE WITH TRASH VENDOR.

Issues and Revisions		By	Date
1	1		
2	1		
3	1		
4	1		
5	1		
6	1		
7	1		
8	1		
9	1		
10	1		
11	1		
12	1		
13	1		
14	1		
15	1		
16	1		
17	1		
18	1		
19	1		
20	1		

5/24/2023 K:\RAL_Roadway\07222020 - Buffalo Rd. Offsite Roadway\Proj\07222020_rdy_1sld.dgn

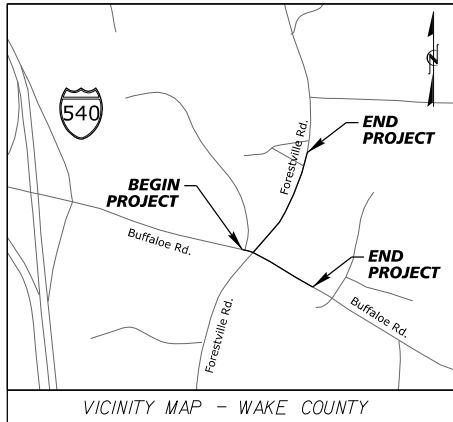

NOTE: NOT TO SCALE

PARCEL ADDRESS: 5017 FORESTVILLE RD, RALEIGH, NC 27616
WAKE COUNTY PIN #: 1746438113

DEVELOPER:

TERWILLIGER PAPPAS MULTIFAMILY PARTNERS, LLC
510 GLENWOOD AVE, SUITE 317
RALEIGH, NC 27603
ATTN: MATT MURPHY
mmurphy@terwilligerpappas.com

ENGINEER:

KIMLEY-HORN AND ASSOCIATES, INC.
421 FAYETTEVILLE RD SUITE 600
RALEIGH, NC 27605
ATTN: EVAN PARROTT, P.E.
919.677.2000
evan.parrott@kimley-horn.com

SURVEYOR:

JOHN A. EDWARDS & COMPANY
333 WADE AVENUE
RALEIGH, NC, 27605
ATTN: CHRIS POOLE
919-828-4428
chrise@jaeco.com


BLOCK LENGTH: 4,362 LF
PARCEL IS EXEMPT FROM MAX. BLOCK LENGTH
REQUIREMENTS PER UDO 8.3.2.A.vii

This document, together with the concepts and designs presented herein, as an without written authorization and adaption by Kimley-Horn and Associates, Inc. shall be without liability to Kimley-Horn and Associates, Inc. for which it was prepared. Reuse of and improper reliance on this document instrument of service, is intended only for the specific purpose and client.

INDEX OF SHEETS	
SHEET NO.	DESCRIPTION
R0.00	TITLE SHEET
R0.01	PROJECT NOTES
R0.02	CONVENTIONAL SYMBOLS
R1.00 + R1.02	TYPICAL SECTIONS
R1.03 + R1.05	DETAIL SHEETS
R1.06	DRAINAGE SUMMARY SHEET
R2.00 + R2.01	PLAN SHEETS
R2.02 + R2.03	PROFILE SHEETS
R2.04 + R2.07	INTERSECTION SIGHT DISTANCE SHEETS
R3.00 + R3.05	TRAFFIC MANAGEMENT PLANS
R4.00 + R4.02	PAVEMENT MARKING & SIGNING PLANS
R5.00 + R5.05	EROSION CONTROL PLANS AND DETAILS
R6.00 + R6.05	CROSS SECTIONS
R6.06 + R6.12	VIADUCT CROSS SECTIONS

Contact the North Carolina One Call Center prior to doing any digging. 1-800-632-4949.


Please contact the City of Raleigh Engineering inspector at development.services@raleighnc.gov to schedule a pre-construction meeting prior to obtaining building permits for this plan.

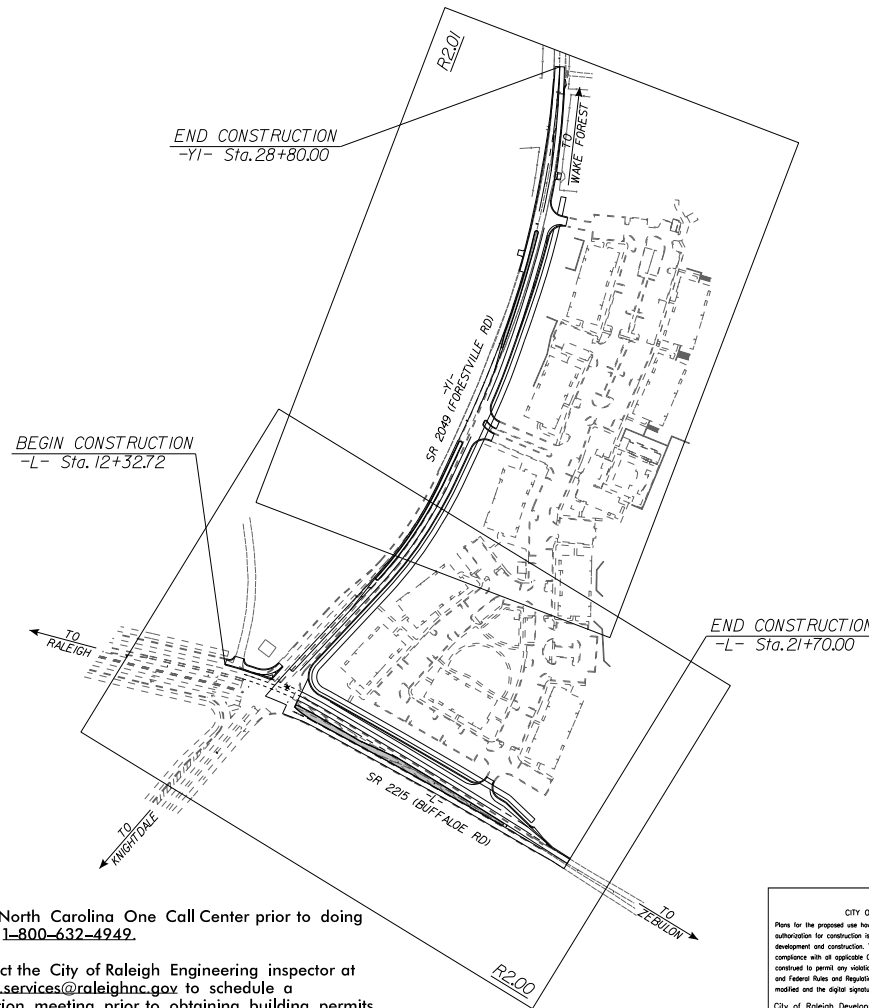

CITY OF RALEIGH - PLANS AUTHORIZED FOR CONSTRUCTION

Plans for the proposed use have been reviewed for general compliance with applicable codes. This limited review, and authorization for construction is not to be considered to represent total compliance with all legal requirements for development and construction. The property owner, design consultants, and contractors are each responsible for compliance with all applicable City, State and Federal laws. This specific authorization below is not a permit, nor shall it be construed to permit any violation of City, State or Federal Law. All construction must be in accordance with all Local, State, and Federal Rules and Regulations. This approval of this electronic document is only valid if the document has not been modified and the digital signature below is valid.

City of Raleigh Development Approval: _____

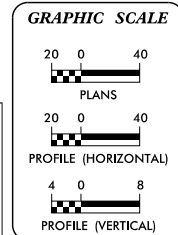

SOLIS BUFFALO

OFFSITE IMPROVEMENTS

WIDENING, TURN LANES, SIGNAL, STRIPING, AND DRIVEWAYS
RALEIGH, WAKE COUNTY, NC

LOCATION: FROM THE INTERSECTION OF BUFFALO RD AND FORESTVILLE RD
EXTENDING 1,700' NORTH ON FORESTVILLE RD AND
825' EAST ON BUFFALO RD

Kimley»Horn

© 2022
421 FAYETTEVILLE STREET, SUITE 600, RALEIGH, NC 27601
PHONE: 919.677.2000
WWW.KIMLEY-HORN.COM
NC LICENSE # E-1002

TITLE SHEET

SOLIS BUFFALO
OFFSITE ROADWAY

NORTH CAROLINA

RALEIGH

SHEET NUMBER
R0.00

REVISIONS

DATE

BY

5/24/2023 K:\3dL_Roadway\07222020 - Bu\Voice Rd_07\Site\Roadway\Proj\07222020_cdy_10a.dgn

GENERAL NOTES

1. WORK IN THIS PROJECT SHALL CONFORM TO THESE PLANS, THE LATEST EDITIONS OF THE NORTH CAROLINA DEPARTMENT OF TRANSPORTATION (NCDOT) ROAD AND BRIDGE SPECIFICATIONS, THE NCDOT ROAD AND BRIDGE STANDARDS, THE NORTH CAROLINA EROSION AND SEDIMENT CONTROL HANDBOOK, THE NORTH CAROLINA EROSION AND SEDIMENT CONTROL REGULATIONS, CITY OF RALEIGH, AND GENERAL DESIGN STANDARDS. IN THE EVENT OF CONFLICT BETWEEN ANY OF THESE STANDARDS, SPECIFICATIONS, OR PLANS, THE MOST STRINGENT SHALL GOVERN UNLESS OTHERWISE NOTED IN THESE PLANS.
2. THE CONTRACTOR SHALL BE SOLELY RESPONSIBLE FOR ALL JOBSITE SAFETY, INCLUDING BUT NOT LIMITED TO TRENCH SAFETY, DURING ALL PHASES OF CONSTRUCTION.
3. THE LOCATION AND SIZE OF EXISTING UTILITIES AS SHOWN IS APPROXIMATE ONLY. THE CONTRACTOR IS RESPONSIBLE FOR HORIZONTALLY AND VERTICALLY LOCATING AND PROTECTING ALL PUBLIC OR PRIVATE UTILITIES (SHOWN OR NOT SHOWN WHICH LIE IN OR ADJACENT TO THE CONSTRUCTION SITE). AT LEAST 48 HOURS PRIOR TO ANY DEMOLITION, GRADING, OR CONSTRUCTION ACTIVITY, THE CONTRACTOR SHALL NOTIFY THE NORTH CAROLINA ONE-CALL UTILITIES LOCATION SERVICE (1-800-632-4949 FOR PROPER IDENTIFICATION OF EXISTING UTILITIES WITHIN THE SITE).
4. THE CONTRACTOR SHALL SALVAGE AND PROTECT ALL EXISTING POWER POLES, SIGNS, MANHOLES, TELEPHONE RISERS, WATER VALVES, ETC. DURING ALL CONSTRUCTION PHASES. THE CONTRACTOR SHALL REPAIR, AT HIS OWN EXPENSE, ANY EXISTING UTILITIES DAMAGED DURING CONSTRUCTION.
5. TRAFFIC CONTROL ON PUBLIC STREETS IS THE RESPONSIBILITY OF THE CONTRACTOR AND SHALL BE IN CONFORMANCE WITH THE TRAFFIC CONTROL PLAN, THE "MANUAL OF UNIFORM TRAFFIC CONTROL DEVICES," AND AS FURTHER DIRECTED BY THE CITY AND STATE INSPECTORS.
6. ALL MANUFACTURERS' PRODUCTS SPECIFIED IN THESE PLANS OR USED AS APPROVED ALTERNATES SHALL BE INSTALLED PER THE MANUFACTURERS' SPECIFICATIONS.
7. ANY DISCREPANCIES FOUND BETWEEN THE DRAWINGS AND SPECIFICATIONS AND SITE CONDITIONS OR ANY INCONSISTENCIES OR AMBIGUITIES IN DRAWINGS OR SPECIFICATIONS SHALL BE IMMEDIATELY REPORTED TO THE ENGINEER, IN WRITING, WHO SHALL PROMPTLY ADDRESS SUCH INCONSISTENCIES OR AMBIGUITIES. WORK DONE BY THE CONTRACTOR AFTER HIS DISCOVERY OF SUCH DISCREPANCIES, INCONSISTENCIES, OR AMBIGUITIES SHALL BE DONE AT THE CONTRACTOR'S RISK.
8. CONSTRUCTION STAKEOUT FOR THIS PROJECT SHALL BE PROVIDED BY THE CONTRACTOR.
9. A PRE-CONSTRUCTION CONFERENCE SHALL BE HELD PRIOR TO THE START OF CONSTRUCTION. THE CONTRACTOR SHALL ARRANGE THE MEETING WITH NCDOT AND THE CITY OF RALEIGH.
10. CONTRACTOR IS RESPONSIBLE FOR VERIFYING OR OBTAINING ALL REQUIRED PERMITS AND APPROVALS PRIOR TO COMMENCING CONSTRUCTION. NCDOT ENCROACHMENTS SHALL BE OBTAINED BY THE ENGINEER.
11. THE FRAMES AND COVERS OF ALL EXISTING AND PROPOSED DRAINAGE, SANITARY SEWER, WATER MAIN, GAS, AND WIRE UTILITY STRUCTURES SHALL BE ADJUSTED TO MATCH PROPOSED FINISHED ELEVATIONS AND SLOPES.
12. ROADWAYS MUST BE CAPABLE OF SUPPORTING FIRE APPARATUS DURING CONSTRUCTION.
13. ALL CONSTRUCTION SHALL BE IN ACCORDANCE WITH CURRENT CITY OF RALEIGH AND NCDOT STANDARDS, SPECIFICATIONS, DETAILS AND ENCROACHMENT AGREEMENTS AS APPLICABLE.
14. NO CHANGES TO ANY ASPECT OF THIS ROADWAY PLAN, INCLUDING BUT NOT LIMITED TO, LANDSCAPING, GRADING, BUILDING ELEVATIONS, LIGHTING, OR UTILITIES WILL BE MADE WITHOUT THE APPROVAL OF NCDOT.
15. ALL TREE PROTECTION FENCING SHALL BE MAINTAINED UNTIL ALL SITE WORK IS COMPLETED. THE FENCING SHALL BE REMOVED PRIOR TO THE FINAL SITE INSPECTION FOR THE CERTIFICATE OF OCCUPANCY (CO).
16. CONTRACTOR TO ENSURE THAT ALL STREETS WITHIN THE LIMITS OF THE PROJECT AND IN FRONT OF THE PROJECT ARE KEPT CLEAN AT ALL TIMES OR A WASH STATION WILL BE REQUIRED.

UTILITY NOTES

1. WATER VALVE BOXES THAT ARE ENCOUNTERED WITHIN THE PROJECT LIMITS ARE TO BE RAISED OR LOWERED TO MATCH THE ADJACENT FINISHED WORK.
2. WATER METER BOXES THAT ARE ENCOUNTERED WITHIN THE PROJECT LIMITS OUTSIDE THE PROPOSED PAVEMENT SECTION ARE TO BE RAISED OR LOWERED TO MATCH THE ADJACENT FINISHED WORK.
3. WATER METER BOXES THAT ARE ENCOUNTERED WITHIN THE PROPOSED PAVEMENT SECTION ARE TO BE RELOCATED OUT OF THE PROPOSED PAVEMENT.

GRADING

1. THE GRADE LINES SHOWN DENOTE THE FINISHED ELEVATION OF THE PROPOSED SURFACING AT GRADE POINTS SHOWN ON THE TYPICAL SECTIONS. GRADE LINES MAY BE ADJUSTED AT THEIR BEGINNING AND ENDING AND AT STRUCTURES AND EXISTING PAVEMENT AS DIRECTED BY THE ENGINEER IN ORDER TO SECURE A PROPER TIE-IN.
2. REFER TO EROSION CONTROL SHEETS FOR CLEARING LIMITS AND TEMPORARY EROSION CONTROL DEVICES TO BE INSTALLED PRIOR TO COMMENCING CONSTRUCTION.
3. EROSION AND SEDIMENT CONTROL MEASURES SHALL BE MAINTAINED CONTINUOUSLY, RELOCATED WHEN AND AS NECESSARY, AND SHALL BE CHECKED AFTER EVERY RAINFALL. SEEDED AREAS SHALL BE CHECKED REGULARLY AND SHALL BE WATERED, FERTILIZED, RESEDED, AND MULCHED AS NECESSARY TO OBTAIN A DENSE STAND OF GRASS.
4. ALL AREAS SHALL BE GRADED FOR POSITIVE DRAINAGE, AND AS SHOWN ON THESE PLANS. THE CONTRACTOR SHALL MAINTAIN ADEQUATE SITE DRAINAGE DURING ALL PHASES OF CONSTRUCTION. IN ADDITION TO THE MEASURES SHOWN IN THESE PLANS, THE CONTRACTOR SHALL USE INTERM SILT FENCES, DIVERSION DITCHES, BERMS, OR OTHER METHODS AS REQUIRED TO DIRECT DRAINAGE AS SHOWN ON THESE PLANS, TO BEST UTILIZE THE EROSION CONTROL DEVICES IN PLACE, AND TO PREVENT SILT AND CONSTRUCTION DEBRIS FROM FLOWING ONTO ADJACENT PROPERTIES. CONTRACTOR SHALL COMPLY WITH ALL APPLICABLE STATE AND LOCAL EROSION, CONSERVATION, AND SILTATION ORDINANCES. CONTRACTOR SHALL REMOVE ALL TEMPORARY EROSION CONTROL DEVICES UPON COMPLETION OF PERMANENT DRAINAGE FACILITIES AND THE ESTABLISHMENT OF A STAND OF GRASS OR OTHER GROWTH TO PREVENT EROSION.
5. GRADING CONTRACTOR SHALL COORDINATE WITH THE UTILITY COMPANIES FOR ANY REQUIRED UTILITY ADJUSTMENTS AND/OR RELOCATIONS.
6. ALL MATERIALS USED FOR BACKFILL SHALL BE FREE OF WOOD, ROOTS, ROCKS, BOULDERS, OR ANY OTHER NON-COMPATIBLE SOIL TYPE MATERIAL. UNSATISFACTORY MATERIALS ALSO INCLUDE MAN-MADE FILLS AND REFUSE DEBRIS DERIVED FROM ANY SOURCE.
7. ALL GRADING / SOIL COMPACTION OPERATIONS WITHIN THE LIMITS OF STATE RIGHT OF WAYS SHALL ADHERE TO NCDOT REQUIREMENTS. IN ACCORDANCE WITH AASHTO 199 AS MODIFIED BY THE DEPARTMENT, COPIES OF THESE MODIFIED TESTING PROCEDURES ARE AVAILABLE UPON REQUEST FROM THE DEPARTMENT'S MATERIALS AND TESTS UNIT.
8. ALL DEMOLITION DEBRIS AND OTHER EXCESS MATERIAL SHALL BE HAULED OFF-SITE AS DIRECTED BY THE OWNER AND PROPERLY DISPOSED OF.
9. PROPOSED CONTOURS AND GUTTER GRADIENTS ARE APPROXIMATE. PROPOSED ROADWAY PROFILES/SUPERELEVATIONS ARE TO BE USED IN CASE OF DISCREPANCY.
10. REFER TO ROADWAY PLAN FOR HORIZONTAL DIMENSIONS.
11. WHERE FILL IS TO BE PLACED ON EXISTING SLOPES STEEPER THAN 4:1, CONTRACTOR SHALL EXCAVATE BENCHES WITH A MAXIMUM DEPTH OF 3'.
12. THE CONTRACTOR SHALL OBTAIN ALL PERMITS REQUIRED FOR BLASTING ROCK IF BLAST ROCK IS ENCOUNTERED. CONTRACTOR SHALL BE SOLELY RESPONSIBLE FOR COMPLYING WITH ALL BLASTING AND SAFETY REQUIREMENTS.
13. TREE PROTECTION FENCING SHALL BE INSTALLED AND INSPECTED BEFORE THE GRADING PERMIT IS ISSUED.

PAVING/CURBING

1. WHERE PROPOSED CURB AND GUTTER TIES TO EXISTING CURB OR CURB AND GUTTER, A TRANSITION OF 10' SHALL BE MADE TO CONFORM TO THE EXISTING HEIGHTS AND SHAPES.
2. BEFORE ANY EARTHWORK IS DONE, THE CONTRACTOR SHALL STAKE OUT AND MARK THE LIMITS OF PAVEMENT AND OTHER ITEMS ESTABLISHED IN THE PLANS. THE CONTRACTOR SHALL PROVIDE ALL NECESSARY ENGINEERING AND SURVEYING FOR LINE AND GRADE CONTROL POINTS RELATED TO EARTHWORK.
3. ALL PAVEMENT SUB GRADES SHALL BE SCARIFIED TO A DEPTH OF 8 INCHES AND COMPACTED TO A MINIMUM DENSITY OF 100 PERCENT OF ASTM D-1557 DENSITY AT OPTIMUM MOISTURE CONTENT UNLESS OTHERWISE SHOWN ON THE CONSTRUCTION PLANS OR AS DIRECTED BY THE GEOTECHNICAL ENGINEER. FILL SHALL BE PLACED AND COMPACTED IN MAXIMUM 8" LIFTS. IN AREAS WHERE ROCK IS ENCOUNTERED AT FINAL SUB GRADE ELEVATION, THE EXPOSED ROCK SHALL BE TOPPED WITH A LEVELING COURSE OF SANDY CLAY OR CLAYEY SAND (P.I. BETWEEN 4 AND 15) AS NEEDED TO PROVIDE A SMOOTH SURFACE FOR PAVING.
4. THE CONTRACTOR SHALL CLEAR AND GRUB THE SITE AND PLACE, COMPACT, AND MOISTURE CONDITION ALL FILL PER THE PROJECT GEOTECHNICAL ENGINEER'S SPECIFICATIONS. THE FILL MATERIAL TO BE USED SHALL BE APPROVED BY THE GEOTECHNICAL ENGINEER PRIOR TO PLACEMENT.
5. ALL CURB JOINTS SHALL EXTEND THROUGH THE CURB. MINIMUM LENGTH OF OFFSET JOINTS AT RADIUS POINTS IS 15 FEET. ALL JOINTS SHALL BE SEALED WITH JOINT SEALANT.
6. TESTING OF MATERIALS REQUIRED FOR THE CONSTRUCTION OF THE PAVING IMPROVEMENTS SHALL BE PERFORMED BY AN APPROVED AGENCY FOR TESTING MATERIALS. THE NOMINATION OF THE TESTING LABORATORY AND THE PAYMENT OF SUCH TESTING SERVICES SHALL BE MADE BY THE OWNER. IT SHALL BE THE CONTRACTOR'S RESPONSIBILITY TO SHOW BY STANDARD TESTING PROCEDURES THAT THE WORK CONSTRUCTED DOES MEET THE REQUIREMENTS OF THE NCDOT SPECIFICATIONS.
7. ALL REINFORCING STEEL SHALL BE NEW DOMESTIC BILLET STEEL CONFORMING TO ASTM A-615, GRADE 60, AND SHALL BE SUPPORTED BY BAR CHAIRS.
8. ALL SIGNS, PAVEMENT MARKINGS, AND OTHER TRAFFIC CONTROL DEVICES ON PUBLIC STREETS SHALL CONFORM TO MUTCD, AND NCDOT STANDARDS.
9. ALL HANDICAP RAMPING, STRIPING, AND PAVEMENT MARKINGS SHALL CONFORM TO ADA REQUIREMENTS AND THE "NORTH CAROLINA STATE BUILDING CODE, VOL. I-C: ACCESSIBILITY CODE." ALL RAMPS SHALL COMPLY WITH THE LATEST NCDOT STANDARDS. WHEELCHAIR RAMPS ARE SHOWN ON THE PLANS AT APPROXIMATE LOCATIONS.
10. CONTRACTOR SHALL SAWCUT & REMOVE ANY THE EXISTING PAVEMENT WHEN THE EXISTING PAVEMENT IS BEING WIDENED OR WHERE NEW CURB AND GUTTER IS PROPOSED.
11. ALL CURVES ON THIS PROJECT SHALL BE SUPERELEVATED IN ACCORDANCE WITH STD. 225.04 & 225.05 USING THE RATE OF SUPERELEVATION AND RUNOFF SHOWN ON THE PLANS. SUPERELEVATION IS TO BE REVOLVED ABOUT THE GRADE POINTS SHOWN ON THE TYPICAL SECTIONS.

PROJECT NOTES

SHEET NUMBER
R0.01

RALEIGH

NORTH CAROLINA

SOLIS BUFFALO

OFFSITE ROADWAY

DATE: 5/24/2023

SCALE: NTS

DESIGNED BY: EP

DRAWN BY:

CHECKED BY:

DATE: 5/24/2023

SCALE: NTS

DESIGNED BY: EP

DRAWN BY:

CHECKED BY:

Kimley»Horn

© 2023
421 FAYETTEVILLE STREET, SUITE 400, RALEIGH, NC 27601
PHONE: 919-877-2000 FAX: 919-877-2050
NC LICENSE # F-0102

CITY OF RALEIGH - PLANS AUTHORIZED FOR CONSTRUCTION

Plans for the proposed use have been reviewed for general compliance with applicable codes. This limited review, and authorization for construction is not to be considered to represent total compliance with all legal requirements for development and construction. The property owner, design consultants, and contractors are each responsible for compliance with all applicable City, State and Federal laws. This specific authorization below is not a permit, nor shall it be construed to permit any violation of City, State or Federal Law. All construction must be in accordance with all Local, State, and Federal Rules and Regulations. This approval of this electronic document is only valid if the document has not been modified and the digital signature below is valid:

City of Raleigh Development Approval _____

Note: Not to Scale

BOUNDARIES AND PROPERTY:

State Line	-----
County Line	-----
Township Line	-----
City Line	-----
Reservation Line	-----
Property Line	-----
Existing Iron Pin (EIP)	⊙
Computed Property Corner	X
Existing Concrete Monument (ECM)	⊠
Parcel/Sequence Number	②3
Existing Fence Line	-X-X-X-
Proposed Woven Wire Fence	⊖
Proposed Chain Link Fence	⊖
Proposed Barbed Wire Fence	⊖
Existing Wetland Boundary	---WA---
Proposed Wetland Boundary	---WA---
Existing Endangered Animal Boundary	---EAB---
Existing Endangered Plant Boundary	---EPB---
Existing Historic Property Boundary	---HPB---
Known Contamination Area: Soil	-X-X-X-
Potential Contamination Area: Soil	-X-X-X-
Known Contamination Area: Water	-X-X-X-
Potential Contamination Area: Water	-X-X-X-
Contaminated Site: Known or Potential	☒☒

BUILDINGS AND OTHER CULTURE:

Gas Pump Vent or UG Tank Cap	⊙
Sign	⊙
Well	⊙
Small Mine	⊙
Foundation	⊠
Area Outline	⊠
Cemetery	⊠
Building	⊠
School	⊠
Church	⊠
Dam	⊠

HYDROLOGY:

Stream or Body of Water	-----
Hydro, Pool or Reservoir	-----
Jurisdictional Stream	---JS---
Buffer Zone 1	---BZ 1---
Buffer Zone 2	---BZ 2---
Flow Arrow	→
Disappearing Stream	→
Spring	⊙
Wetland	---WA---
Proposed Lateral, Tail, Head Ditch	-----
False Sump	⊠

RAILROADS:

Standard Gauge	-----
RR Signal Milepost	⊙
Switch	⊠
RR Abandoned	-----
RR Dismantled	-----

RIGHT OF WAY & PROJECT CONTROL:

Primary Horiz Control Point	⊙
Primary Horiz and Vert Control Point	⊙
Secondary Horiz and Vert Control Point	⊙
Vertical Benchmark	⊙
Existing Right of Way Monument	⊙
Proposed Right of Way Monument (Rebar and Cap)	⊙
Proposed Right of Way Monument (Concrete)	⊙
Existing Permanent Easement Monument	⊙
Proposed Permanent Easement Monument (Rebar and Cap)	⊙
Existing C/A Monument	⊙
Proposed C/A Monument (Rebar and Cap)	⊙
Proposed C/A Monument (Concrete)	⊙
Existing Right of Way Line	-----
Proposed Right of Way Line	-----
Existing Control of Access Line	-----
Proposed Control of Access Line	-----
Proposed ROW and CA Line	-----
Existing Easement Line	-----
Proposed Temporary Construction Easement	-----
Proposed Temporary Drainage Easement	-----
Proposed Permanent Drainage Easement	-----
Proposed Permanent Drainage/Utility Easement	-----
Proposed Permanent Utility Easement	-----
Proposed Temporary Utility Easement	-----
Proposed Aerial Utility Easement	-----

ROADS AND RELATED FEATURES:

Existing Edge of Pavement	-----
Existing Curb	-----
Proposed Slope Stakes Cut	-----
Proposed Slope Stakes Fill	-----
Proposed Curb Ramp	-----
Existing Metal Guardrail	-----
Proposed Guardrail	-----
Existing Cable Guiderail	-----
Proposed Cable Guiderail	-----
Equality Symbol	⊙
Pavement Removal	-----

VEGETATION:

Single Tree	⊙
Single Shrub	⊙
Hedge	-----

STATE OF NORTH CAROLINA, DIVISION OF HIGHWAYS
CONVENTIONAL PLAN SHEET SYMBOLS

Woods Line	-----
Orchard	-----
Vineyard	-----

EXISTING STRUCTURES:

MAJOR:	-----
Bridge, Tunnel or Box Culvert	-----
Bridge Wing Wall, Head Wall and End Wall	-----
MINOR:	-----
Head and End Wall	-----
Pipe Culvert	-----
Footbridge	-----
Drainage Box: Catch Basin, DI or JB	-----
Paved Ditch Gutter	-----
Storm Sewer Manhole	-----
Storm Sewer	-----

UTILITIES:

* SUE – Subsurface Utility Engineering
LOS – Level of Service – A,B,C or D (Accuracy)

POWER:	-----
Existing Power Pole	-----
Proposed Power Pole	-----
Existing Joint Use Pole	-----
Proposed Joint Use Pole	-----
Power Manhole	-----
Power Line Tower	-----
Power Transformer	-----
UG Power Cable Hand Hole	-----
H-Frame Pole	-----
UG Power Line Test Hole (SUE – LOS A)*	-----
UG Power Line (SUE – LOS B)*	-----
UG Power Line (SUE – LOS C)*	-----
UG Power Line (SUE – LOS D)*	-----

TELEPHONE:

Existing Telephone Pole	-----
Proposed Telephone Pole	-----
Telephone Manhole	-----
Telephone Pedestal	-----
Telephone Cell Tower	-----
UG Telephone Cable Hand Hole	-----
UG Telephone Test Hole (SUE – LOS A)*	-----
UG Telephone Cable (SUE – LOS B)*	-----
UG Telephone Cable (SUE – LOS C)*	-----
UG Telephone Cable (SUE – LOS D)*	-----
UG Telephone Conduit (SUE – LOS B)*	-----
UG Telephone Conduit (SUE – LOS C)*	-----
UG Telephone Conduit (SUE – LOS D)*	-----
UG Fiber Optics Cable (SUE – LOS B)*	-----
UG Fiber Optics Cable (SUE – LOS C)*	-----
UG Fiber Optics Cable (SUE – LOS D)*	-----

WATER:

Water Manhole	-----
Water Meter	-----
Water Valve	-----
Water Hydrant	-----
UG Water Line Test Hole (SUE – LOS A)*	-----
UG Water Line (SUE – LOS B)*	-----
UG Water Line (SUE – LOS C)*	-----
UG Water Line (SUE – LOS D)*	-----
Above Ground Water Line	-----

TV:

TV Pedestal	-----
TV Tower	-----
UG TV Cable Hand Hole	-----
UG TV Test Hole (SUE – LOS A)*	-----
UG TV Cable (SUE – LOS B)*	-----
UG TV Cable (SUE – LOS C)*	-----
UG TV Cable (SUE – LOS D)*	-----
UG Fiber Optic Cable (SUE – LOS B)*	-----
UG Fiber Optic Cable (SUE – LOS C)*	-----
UG Fiber Optic Cable (SUE – LOS D)*	-----

GAS:

Gas Valve	-----
Gas Meter	-----
UG Gas Line Test Hole (SUE – LOS A)*	-----
UG Gas Line (SUE – LOS B)*	-----
UG Gas Line (SUE – LOS C)*	-----
UG Gas Line (SUE – LOS D)*	-----
Above Ground Gas Line	-----

SANITARY SEWER:

Sanitary Sewer Manhole	-----
Sanitary Sewer Cleanout	-----
UG Sanitary Sewer Line	-----
Above Ground Sanitary Sewer	-----
SS Force Main Line Test Hole (SUE – LOS A)*	-----
SS Force Main Line (SUE – LOS B)*	-----
SS Force Main Line (SUE – LOS C)*	-----
SS Force Main Line (SUE – LOS D)*	-----

MISCELLANEOUS:

Utility Pole	-----
Utility Pole with Base	-----
Utility Located Object	-----
Utility Traffic Signal Box	-----
Utility Unknown UG Line (SUE – LOS B)*	-----
UG Tank; Water, Gas, Oil	-----
Underground Storage Tank, Approx. Loc.	-----
AG Tank; Water, Gas, Oil	-----
Geoenvironmental Boring	-----
Abandoned According to Utility Records	-----
End of Information	-----

CITY OF RALEIGH – PLANS AUTHORIZED FOR CONSTRUCTION
Plans for the proposed and have been reviewed for general compliance with applicable codes. This limited review, and authorization for construction is not to be considered to represent total compliance with all legal requirements for development and construction. The property owner, design consultants, and contractors are each responsible for compliance with all applicable City, State and Federal laws. This specific authorization below is not a permit, nor shall it be construed to permit any violation of City, State or Federal Law. All construction must be in accordance with all Local, State, and Federal Rules and Regulations. This approval of this electronic document is only valid if the document has not been modified and the digital signature below is valid:
City of Raleigh Development Approval _____

KHA PROJECT DATE 5/24/2023		NYS SCALE DESIGNED BY: EP DRAWN BY: EP CHECKED BY: BV	
CONVENTIONAL SYMBOLS			
SOLIS BUFFALO OFFSITE ROADWAY		NORTH CAROLINA	
SHEET NUMBER R0.02		RALEIGH	

Kimley»Horn
© 2023
421 FAYETTEVILLE STREET, SUITE 400, RALEIGH, NC 27601
PHONE: 919-877-2000 FAX: 919-877-2050
NC LICENSE # F-0102

TYPICAL SECTION NO. 1
-L- Sta. 12+32.72 to Sta. 20+45.00

TYPICAL SECTION NO. 1A
-L- Sta. 12+32.72 to Sta. 13+47.52

-L- Sta. 19+91.49 to Sta. 20+45.00

TYPICAL SECTION NO. 2
-L- Sta. 20+45.00 to Sta. 21+70.00

C1	PROP. APPROX. 1.5" ASPHALT CONCRETE SURFACE COURSE, TYPE S95C, AT AN AVERAGE RATE OF 165 LBS. PER SQ. YD.
C2	PROP. APPROX. 3" ASPHALT CONCRETE SURFACE COURSE, TYPE S95C, AT AN AVERAGE RATE OF 165 LBS. PER SQ. YD. IN EACH OF TWO LAYERS.
C3	PROP. VAR. DEPTH ASPHALT CONCRETE SURFACE COURSE, TYPE S95C, AT AN AVERAGE RATE OF 114 LBS. PER SQ. YD. PER 1" DEPTH, TO BE PLACED IN LAYERS NOT LESS THAN 1.5" IN DEPTH OR GREATER THAN 2" IN DEPTH.
D1	PROP. APPROX. 4" ASPHALT CONCRETE INTERMEDIATE COURSE, TYPE I190C, AT AN AVERAGE RATE OF 456 LBS. PER SQ. YD.
D2	PROP. VAR. DEPTH ASPHALT CONCRETE INTERMEDIATE COURSE, TYPE I190C, AT AN AVERAGE RATE OF 114 LBS. PER SQ. YD. PER 1" DEPTH, TO BE PLACED IN LAYERS NOT LESS THAN 2.5" OR GREATER THAN 4" IN DEPTH.
E1	PROP. APPROX. 5" ASPHALT CONCRETE BASE COURSE, TYPE B250C, AT AN AVERAGE RATE OF 285 LBS. PER SQ. YD. IN EACH OF TWO LAYERS.
E2	PROPOSED VAR. DEPTH ASPHALT CONCRETE BASE COURSE, TYPE B250C, AT AN AVERAGE RATE OF 114 LBS. PER SQ. YD. PER 1" DEPTH, TO BE PLACED IN LAYERS NOT LESS THAN 3" OR GREATER THAN 5 1/2" IN DEPTH.
J1	PROP. 10" AGGREGATE BASE COURSE.
R1	1'-6" CONCRETE CURB AND GUTTER.
R2	2'-6" CONCRETE CURB AND GUTTER.
R3	5" MONOLITHIC CONCRETE ISLAND (SURFACE MOUNT).
S1	PROPOSED 6" CONCRETE MULTI-USE PATH.
T	EARTH MATERIAL.
U	EXISTING PAVEMENT.
V1	MILLING ASPHALT PAVEMENT, 1.5" DEPTH.
V2	MILLING ASPHALT PAVEMENT, VARIABLE DEPTH.
W	VARIABLE DEPTH ASPHALT PAVEMENT (SEE WEDGING DETAIL SHEET R101).

TYPICAL SECTION NOTES:

- 1. SEE PLAN SHEETS FOR LANE TAPER LOCATIONS**
- 2. PAVEMENT EDGE SLOPES ARE 1:1 UNLESS OTHERWISE NOTED**
- 3. SEE PLAN SHEETS FOR MEDIAN LOCATION AND TYPE**
- 4. SEE PLAN SHEETS FOR TURN LANE LOCATIONS**
- 5. SEE MINIMUM SAWCUT DIMENSIONS
DETAIL ON SHEET R1.02**

CITY OF RALEIGH - PLANS AUTHORIZED FOR CONSTRUCTION

Plans for the proposed use have been reviewed for general compliance with applicable codes. This limited review, and authorization for construction is not to be considered to represent total compliance with all legal requirements for development and construction. The property owner, design consultants, and contractors are each responsible for compliance with all applicable City, State and Federal laws. This specific authorization below is not a permit, nor shall it be construed to permit or authorize any use of the property in violation of the City of Raleigh Zoning Ordinance, the Comprehensive Rules and Regulations. This approval of this electronic document is only valid if the document has not been modified and the digital signature below is valid.

City of Raleigh Development Approval

Kimley»Horn
© 2022

421 FAYETTEVILLE STREET, SUITE 600, RALEIGH, NC 27601
PHONE: 919-677-2000 FAX: 919-677-2050
WWW.KIMLEY-HORN.COM






TYPICAL SECTIONS

SOLIS BUFFALO
OFFSITE ROADWAY

NORTH CAROLINA

SALE


SHEET NUMBER
R1.00

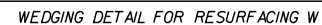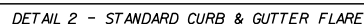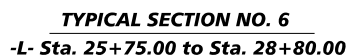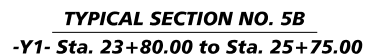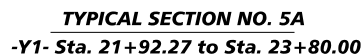

City of Raleigh Development Approval _____

PAVEMENT SCHEDULE	
C1	PROP. APPROX. 1.5" ASPHALT CONCRETE SURFACE COURSE, TYPE S9.5C, AT AN AVERAGE RATE OF 165 LBS. PER SQ. YD.
C2	PROP. APPROX. 3" ASPHALT CONCRETE SURFACE COURSE, TYPE S9.5C, AT AN AVERAGE RATE OF 165 LBS. PER SQ. YD. IN EACH OF TWO LAYERS.
C3	PROP. VAR. DEPTH ASPHALT CONCRETE SURFACE COURSE, TYPE S9.5C, AT AN AVERAGE RATE OF 114 LBS. PER SQ. YD. PER 1" DEPTH, TO BE PLACED IN LAYERS NOT LESS THAN 1.5" IN DEPTH OR GREATER THAN 2" IN DEPTH.
D1	PROP. APPROX. 4" ASPHALT CONCRETE INTERMEDIATE COURSE, TYPE I19.0C, AT AN AVERAGE RATE OF 456 LBS. PER SQ. YD.
D2	PROP. VAR. DEPTH ASPHALT CONCRETE INTERMEDIATE COURSE, TYPE I19.0C, AT AN AVERAGE RATE OF 114 LBS. PER SQ. YD. PER 1" DEPTH, TO BE PLACED IN LAYERS NOT LESS THAN 2.5" OR GREATER THAN 4" IN DEPTH.
E1	PROP. APPROX. 5" ASPHALT CONCRETE BASE COURSE, TYPE B25.0C, AT AN AVERAGE RATE OF 285 LBS. PER SQ. YD. IN EACH OF TWO LAYERS.
E2	PROPOSED VAR. DEPTH ASPHALT CONCRETE BASE COURSE, TYPE B25.0C, AT AN AVERAGE RATE OF 114 LBS. PER SQ. YD. PER 1" DEPTH, TO BE PLACED IN LAYERS NOT LESS THAN 3" OR GREATER THAN 5 1/2" IN DEPTH.
J1	PROP. 10" AGGREGATE BASE COURSE.
R1	1'-6" CONCRETE CURB AND GUTTER.
R2	2'-6" CONCRETE CURB AND GUTTER.
R3	5' MONOLITHIC CONCRETE ISLAND (SURFACE MOUNT).
S1	PROPOSED 6" CONCRETE MULTI-USE PATH.
T	EARTH MATERIAL.
U	EXISTING PAVEMENT.
V1	MILLING ASPHALT PAVEMENT, 1.5" DEPTH.
V2	MILLING ASPHALT PAVEMENT, VARIABLE DEPTH.
W	VARIABLE DEPTH ASPHALT PAVEMENT (SEE WEDGING DETAIL SHEET R101).

TYPICAL SECTION NOTES:			
1. SEE PLAN SHEETS FOR LANE TAPER LOCATIONS			
2. PAVEMENT EDGE SLOPES ARE 1:1 UNLESS OTHERWISE NOTED			
3. SEE PLAN SHEETS FOR MEDIAN LOCATION AND TYPE			
4. SEE PLAN SHEETS FOR TURN LANE LOCATIONS			
5. SEE MINIMUM SAWCUT DIMENSIONS DETAIL ON SHEET R1.01			

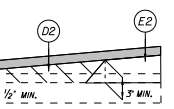

PAVEMENT SCHEDULE

ITEM	DESCRIPTION
C1	PROP. APPROX. 1.5" ASPHALT CONCRETE SURFACE COURSE, TYPE S9.5C, AT AN AVERAGE RATE OF 165 LBS. PER SQ. YD.
C2	PROP. APPROX. 3" ASPHALT CONCRETE SURFACE COURSE, TYPE S9.5C, AT AN AVERAGE RATE OF 165 LBS. PER SQ. YD. IN EACH OF TWO LAYERS.
C3	PROP. VAR. DEPTH ASPHALT CONCRETE SURFACE COURSE, TYPE S9.5C, AT AN AVERAGE RATE OF 114 LBS. PER SQ. YD. PER 1" DEPTH, TO BE PLACED IN LAYERS NOT LESS THAN 1.5" IN DEPTH OR GREATER THAN 2" IN DEPTH.
D1	PROP. APPROX. 4" ASPHALT CONCRETE INTERMEDIATE COURSE, TYPE I19.0C, AT AN AVERAGE RATE OF 456 LBS. PER SQ. YD.
D2	PROP. VAR. DEPTH ASPHALT CONCRETE INTERMEDIATE COURSE, TYPE I19.0C, AT AN AVERAGE RATE OF 114 LBS. PER SQ. YD. PER 1" DEPTH, TO BE PLACED IN LAYERS NOT LESS THAN 2.5" OR GREATER THAN 4" IN DEPTH.
E1	PROP. APPROX. 5" ASPHALT CONCRETE BASE COURSE, TYPE B25.0C, AT AN AVERAGE RATE OF 285 LBS. PER SQ. YD. IN EACH OF TWO LAYERS.
E2	PROPOSED VAR. DEPTH ASPHALT CONCRETE BASE COURSE, TYPE B25.0C, AT AN AVERAGE RATE OF 114 LBS. PER SQ. YD. PER 1" DEPTH, TO BE PLACED IN LAYERS NOT LESS THAN 3" OR GREATER THAN 5 1/2" IN DEPTH.
J1	PROP. 10" AGGREGATE BASE COURSE.
R1	1'-6" CONCRETE CURB AND GUTTER.
R2	2'-6" CONCRETE CURB AND GUTTER.
R3	5' MONOLITHIC CONCRETE ISLAND (SURFACE MOUNT).
S1	PROPOSED 6" CONCRETE MULTI-USE PATH.
T	EARTH MATERIAL.
U	EXISTING PAVEMENT.
V1	MILLING ASPHALT PAVEMENT, 1.5" DEPTH.
V2	MILLING ASPHALT PAVEMENT, VARIABLE DEPTH.
W	VARIABLE DEPTH ASPHALT PAVEMENT (SEE WEDGING DETAIL SHEET R101).

PAVEMENT SCHEDULE


ITEM	DESCRIPTION
C1	PROP. APPROX. 1.5" ASPHALT CONCRETE SURFACE COURSE, TYPE S9.5C, AT AN AVERAGE RATE OF 165 LBS. PER SQ. YD.
C2	PROP. APPROX. 3" ASPHALT CONCRETE SURFACE COURSE, TYPE S9.5C, AT AN AVERAGE RATE OF 165 LBS. PER SQ. YD. IN EACH OF TWO LAYERS.
C3	PROP. VAR. DEPTH ASPHALT CONCRETE SURFACE COURSE, TYPE S9.5C, AT AN AVERAGE RATE OF 114 LBS. PER SQ. YD. PER 1" DEPTH, TO BE PLACED IN LAYERS NOT LESS THAN 1.5" IN DEPTH OR GREATER THAN 2" IN DEPTH.
D1	PROP. APPROX. 4" ASPHALT CONCRETE INTERMEDIATE COURSE, TYPE I19.0C, AT AN AVERAGE RATE OF 456 LBS. PER SQ. YD.
D2	PROP. VAR. DEPTH ASPHALT CONCRETE INTERMEDIATE COURSE, TYPE I19.0C, AT AN AVERAGE RATE OF 114 LBS. PER SQ. YD. PER 1" DEPTH, TO BE PLACED IN LAYERS NOT LESS THAN 2.5" OR GREATER THAN 4" IN DEPTH.
E1	PROP. APPROX. 5" ASPHALT CONCRETE BASE COURSE, TYPE B25.0C, AT AN AVERAGE RATE OF 285 LBS. PER SQ. YD. IN EACH OF TWO LAYERS.
E2	PROPOSED VAR. DEPTH ASPHALT CONCRETE BASE COURSE, TYPE B25.0C, AT AN AVERAGE RATE OF 114 LBS. PER SQ. YD. PER 1" DEPTH, TO BE PLACED IN LAYERS NOT LESS THAN 3" OR GREATER THAN 5 1/2" IN DEPTH.
J1	PROP. 10" AGGREGATE BASE COURSE.
R1	1'-6" CONCRETE CURB AND GUTTER.
R2	2'-6" CONCRETE CURB AND GUTTER.
R3	5' MONOLITHIC CONCRETE ISLAND (SURFACE MOUNT).
S1	PROPOSED 6" CONCRETE MULTI-USE PATH.
T	EARTH MATERIAL.
U	EXISTING PAVEMENT.
V1	MILLING ASPHALT PAVEMENT, 1.5" DEPTH.
V2	MILLING ASPHALT PAVEMENT, VARIABLE DEPTH.
W	VARIABLE DEPTH ASPHALT PAVEMENT (SEE WEDGING DETAIL SHEET R101).

TYPICAL SECTION NOTES:

- SEE PLAN SHEETS FOR LANE TAPER LOCATIONS
- PAVEMENT EDGE SLOPES ARE 1:1 UNLESS OTHERWISE NOTED
- SEE PLAN SHEETS FOR MEDIAN LOCATION AND TYPE
- SEE PLAN SHEETS FOR TURN LANE LOCATIONS
- SEE MINIMUM SAWCUT DIMENSIONS DETAIL ON SHEET R1.01

PAVEMENT SCHEDULE


ITEM	DESCRIPTION
C1	PROP. APPROX. 1.5" ASPHALT CONCRETE SURFACE COURSE, TYPE S9.5C, AT AN AVERAGE RATE OF 165 LBS. PER SQ. YD.
C2	PROP. APPROX. 3" ASPHALT CONCRETE SURFACE COURSE, TYPE S9.5C, AT AN AVERAGE RATE OF 165 LBS. PER SQ. YD. IN EACH OF TWO LAYERS.
C3	PROP. VAR. DEPTH ASPHALT CONCRETE SURFACE COURSE, TYPE S9.5C, AT AN AVERAGE RATE OF 114 LBS. PER SQ. YD. PER 1" DEPTH, TO BE PLACED IN LAYERS NOT LESS THAN 1.5" IN DEPTH OR GREATER THAN 2" IN DEPTH.
D1	PROP. APPROX. 4" ASPHALT CONCRETE INTERMEDIATE COURSE, TYPE I19.0C, AT AN AVERAGE RATE OF 456 LBS. PER SQ. YD.
D2	PROP. VAR. DEPTH ASPHALT CONCRETE INTERMEDIATE COURSE, TYPE I19.0C, AT AN AVERAGE RATE OF 114 LBS. PER SQ. YD. PER 1" DEPTH, TO BE PLACED IN LAYERS NOT

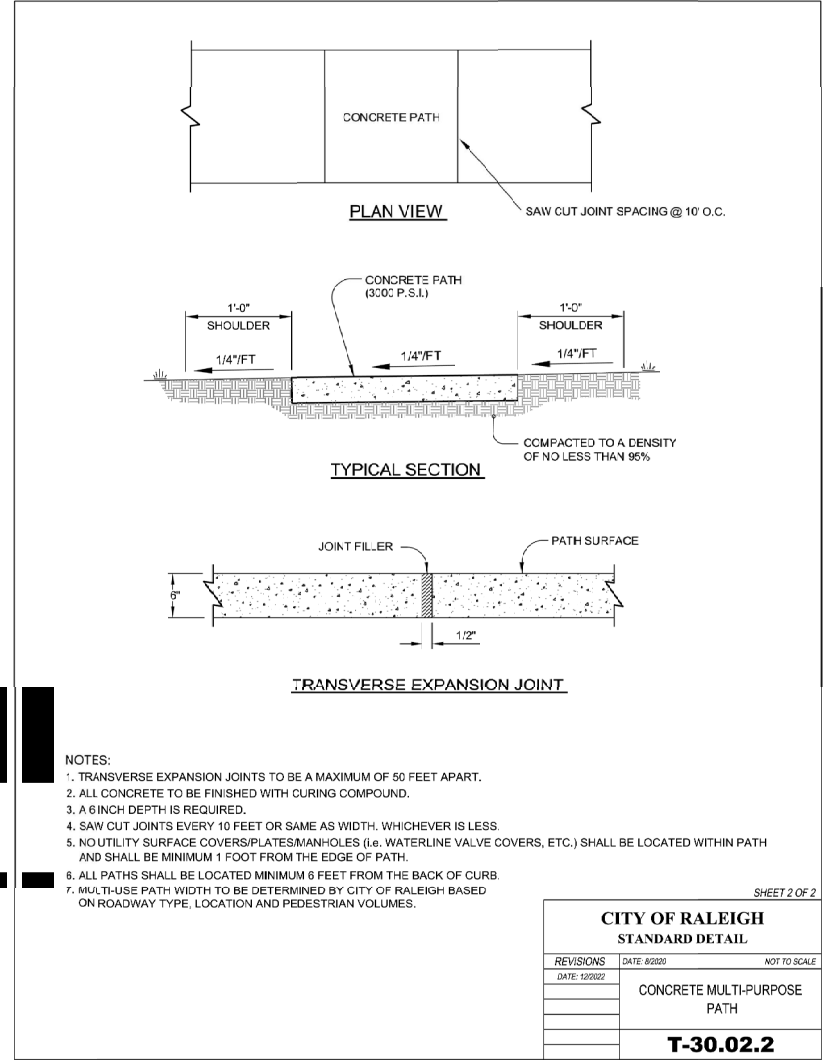


CITY OF RALEIGH – PLANS AUTHORIZED FOR CONSTRUCTION


Plans for the proposed use have been reviewed for general compliance with applicable codes. This limited review, and authorization for construction is not to be considered to represent total compliance with all legal requirements for development and construction. The property owner, design consultants, and contractors are each responsible for compliance with all applicable City, State and Federal laws. This specific authorization below is not a permit, nor shall it be construed to permit any violation of City, State or Federal Law. All construction must be in accordance with all Local, State, and Federal Rules and Regulations. This approval of this electronic document is only valid if the document has not been modified and the digital signature below is valid.

City of Raleigh Development Approval _____

SHEET NUMBER R1.03	SOLIS BUFFALO OFFSITE ROADWAY	NORTH CAROLINA	RALEIGH		BY		DATE		REVISIONS		No.	
ROADWAY DETAILS			KVA PROJECT 07222020 DATE 5/24/2023 SCALE 5/24/2023 DESIGNED BY: EP DRAWN BY: EP CHECKED BY: BV		 421 PANTERVILLE STREET, SUITE 600, RALEIGH, NC 27601 PHONE: 919.487.2600 FAX: 919.487.2650 WWW.KHALE-HORN.COM NC LICENSE #: F-002							

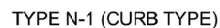

- ① 7.5% 8.33% (1:12) MAX RAMP SLOPE
- ② 1.5% 2.08% (1:48) MAX CROSS SLOPE
- ③ CURB RAMPS REQUIRE A (4'-0") MINIMUM LANDING WITH A MAXIMUM CROSS SLOPE AND LONGITUDINAL SLOPE OF 1.5% 2.08% MAX. WHERE PEDESTRIANS PERFORM TURNING MANEUVERS, SLOPE TO DRAIN TO CURB.
- ④ RAMPS AND DOWNS SHALL BE INSTALLED THE SAME WIDTH HAS THE SIDEWALK.
- ⑤ IF LENGTH EXCEEDS 5', TRUNCATED DOWNS SHALL BE INSTALLED ALONG THE BACK OF THE CURB COVERING THE FULL WIDTH OF THE RAMP.

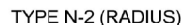

SHEET 2 OF 9

CITY OF RALEIGH
STANDARD DETAIL

REVISIONS	DATE: 8/2020	NOT TO SCALE
DATE: 12/2022	CURB RAMPS (NEW DEVELOPMENT)	
	T-20.01.2	

1. CITY OF RALEIGH STANDARD CURB RAMPS HAVE BEEN DEVELOPED IN ACCORDANCE WITH THE AMERICANS WITH DISABILITIES ACT (ADA) AND PUBLIC RIGHT OF WAY ACCESS GUIDELINES (PROWAG).
2. CURB RAMPS SHALL BE PROVIDED AT LOCATIONS AS SHOWN ON THE PLANS OR AS DIRECTED BY THE ENGINEER. SIDEWALK ACCESS RAMPS SHALL BE LOCATED AS INDICATED IN THE DETAIL, HOWEVER, THE LOCATION MAY BE ADJUSTED IN COORDINATION WITH THE CITY OF RALEIGH WHERE EXISTING LIGHT POLES, FIRE HYDRANTS, DROP INLETS, ETC. AFFECT PLACEMENT.
3. DOUBLE WHEELCHAIR RAMPS ARE TO BE INSTALLED AT ALL PUBLIC STREET INTERSECTIONS WHERE SIDEWALK IS REQUIRED
4. THE WALKING SURFACE SHALL BE SLIP RESISTANT. THE COLOR FOR THE DETECTABLE WARNING AREA SHALL BE YELLOW FOR CONTRAST.
5. NO SLOPE ON THE SIDEWALK ACCESS RAMP SHALL EXCEED 1"/FT (12:1) IN RELATIONSHIP TO THE GRADE OF THE STREET.
6. IN NO CASE SHALL THE WIDTH OF THE SIDEWALK ACCESS RAMP BE LESS THAN 48" ALL RAMPS SHALL BE INSTALLED THE SAME WIDTH AS THE SIDEWALK.
7. USE CLASS A (3000 PSI) CONCRETE WITH A SIDEWALK FINISH IN ORDER TO OBTAIN A ROUGH NONSKID SURFACE.
8. A 1/2" EXPANSION JOINT INSTALLED FULL DEPTH WILL BE REQUIRED WHERE THE CONCRETE SIDEWALK ACCESS RAMP JOINS THE CURB AND ALSO WHERE NEW CONCRETE ABUTS EXISTING CONCRETE.
9. CURB RAMPS SHOULD BE PLACED PARALLEL TO THE DIRECTION OF TRAVEL.

SHEET 8 OF 9

CITY OF RALEIGH
STANDARD DETAIL

REVISIONS	DATE: 8/2020	NOT TO SCALE
	CURB RAMP NOTES	
	T-20.01.8	

CITY OF RALEIGH - PLANS AUTHORIZED FOR CONSTRUCTION

Plans for the proposed use have been reviewed for general compliance with applicable codes. This limited review, and authorization for construction is not to be considered to represent total compliance with all legal requirements for development and construction. The property owner, design consultants, and contractors are each responsible for compliance with all applicable City, State and Federal laws. This specific authorization below is each person, nor shall it be construed to permit any violation of City, State or Federal Law. All Construction must be in accordance with all Local, State and Federal Rules and Regulations. This approval of this electronic document is only valid if the document has not been modified and the digital signature below is valid:

City of Raleigh Development Approval:

Kimley»Horn

21 FAYETTEVILLE STREET, SUITE 600, RALEIGH, NC 27601
PHONE: 919-677-2000 FAX: 919-677-2050

KHA PROJECT	NTS
017222020	EP
DATE	EP
5/24/2023	
SCALE	
DESIGNED BY:	
DRAWN BY:	

DRAINAGE DETAILS

SOLIS BUFFALO
OFFSITE ROADWAY



PORTLAND, ME

FIGURE 1

SHEET NUMBER
R1.04



SHEET NUMBER R1.05	SOLIS BUFFALOEE OFFSITE ROADWAY	RAI FIGH NORTH CAROLINA	ROADWAY DETAILS KWA PROJECT DATE 5/24/2023 SCALE NTS DESIGNED BY: EP DRAWN BY: BP CHECKED BY: BV	 421 FAYETTEVILLE STREET, SUITE 600, RALEIGH, NC 27601 PHONE: 919-877-2000 FAX: 919-877-2050 WWW.KIMLEY-HORN.COM	No. Revisions Date By
------------------------------	--	--------------------------------	---	--	--------------------------------

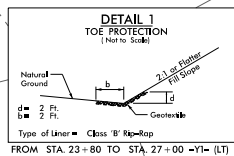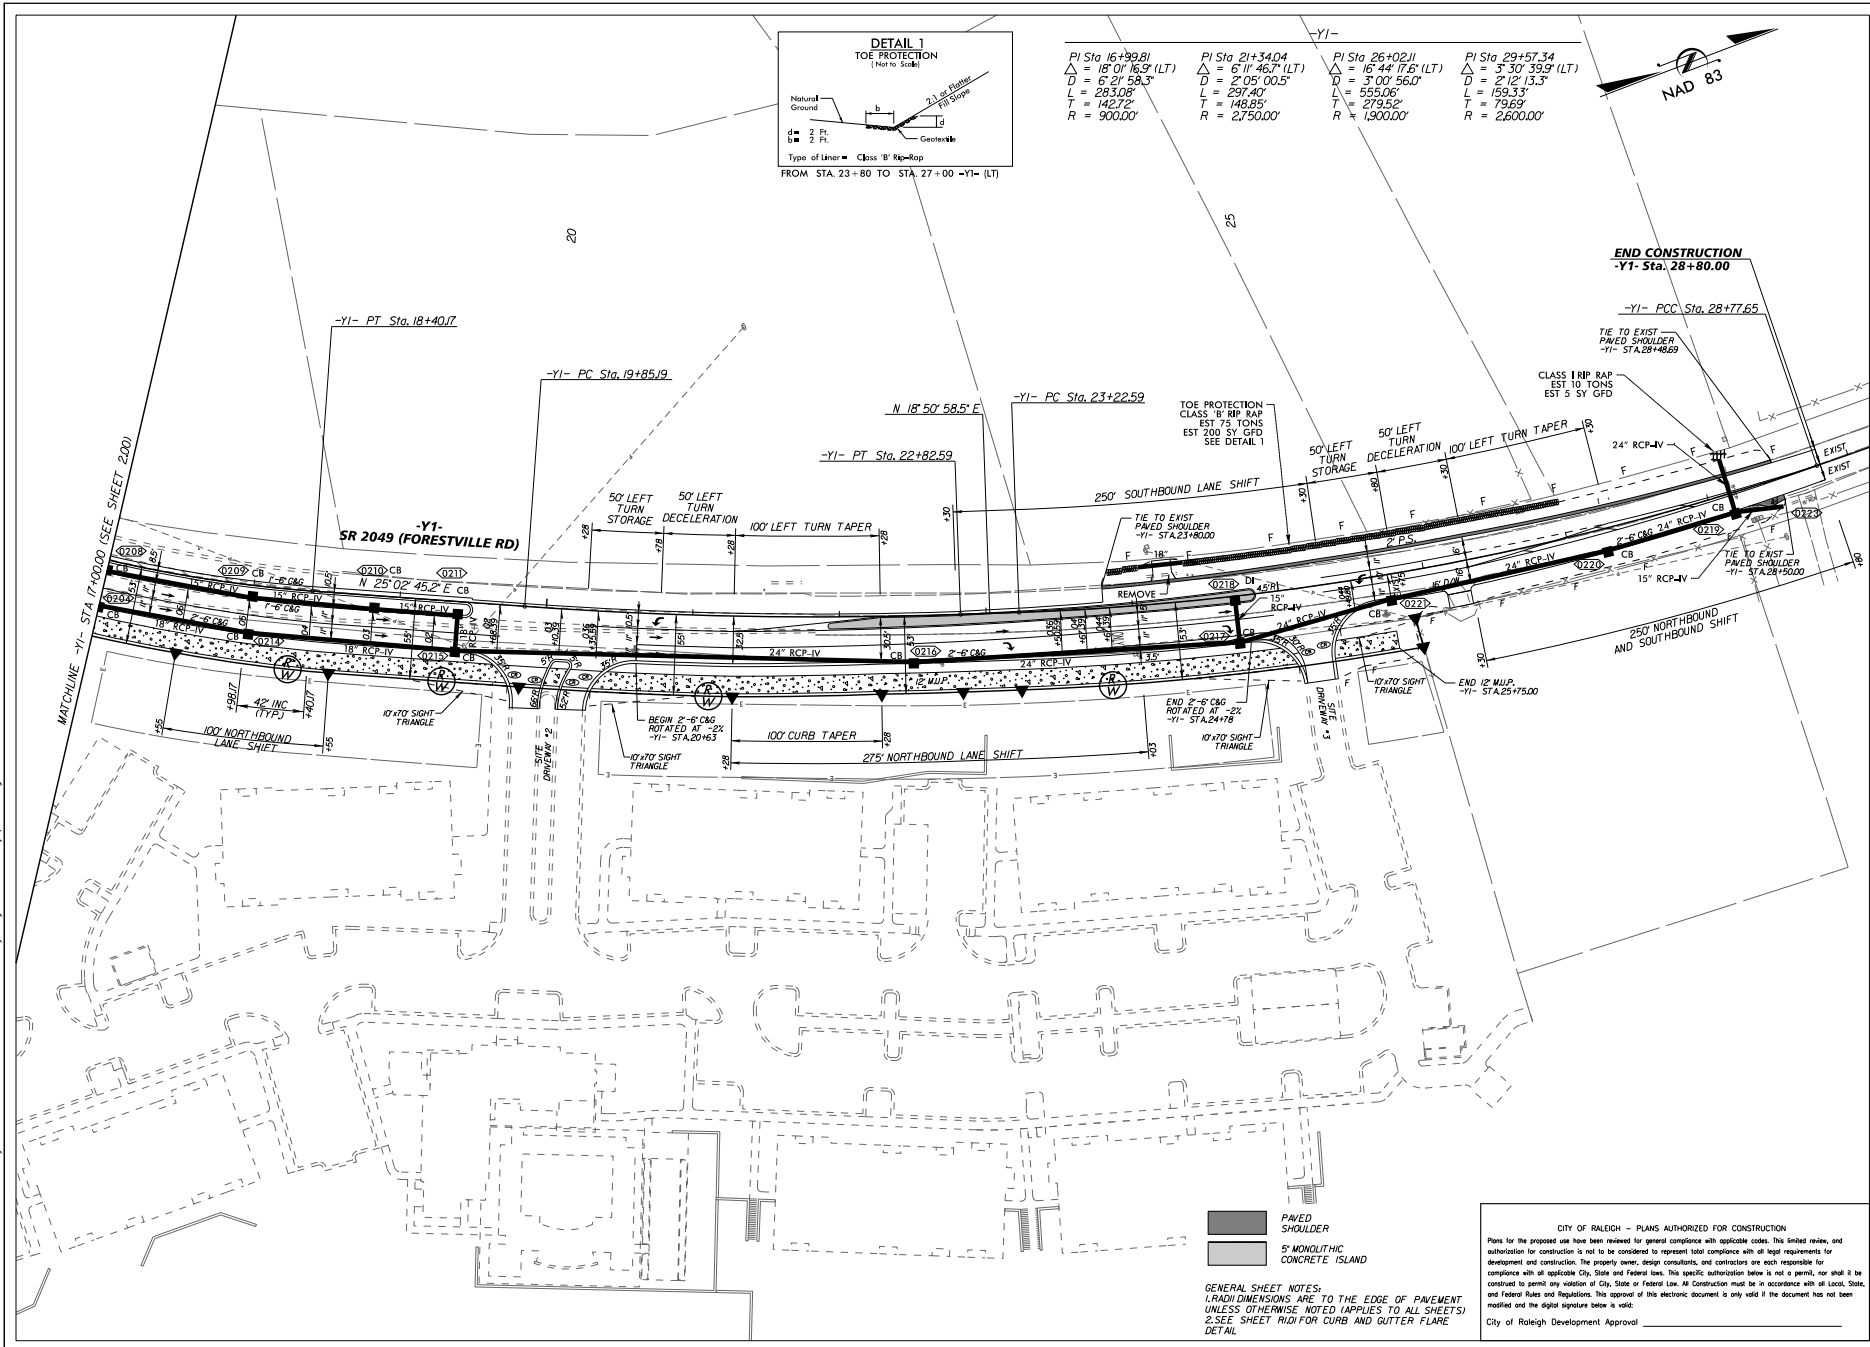

PI Sta. 16+39.81 Δ = 18° 01' 16.5" (LT) D = 6' 21" 58.3" L = 283.08' T = 142.72' R = 500.00'	PI Sta. 21+34.04 Δ = 6° 11' 46.7" (LT) D = 2' 05' 00.5" L = 297.40' T = 146.89' R = 2750.00'	PI Sta. 26+02.11 Δ = 16° 44' 17.5" (LT) D = 3' 00' 56.0" L = 555.06' T = 279.52' R = 1500.00'	PI Sta. 29+57.34 Δ = 3° 30' 39.9" (LT) D = 2' 12' 13.3" L = 159.33' T = 79.69' R = 2600.00'
---	---	--	--



KIMLEY-HORN		© 2023		421 FAYETTEVILLE STREET, SUITE 400, RALEIGH, NC 27601		PHONE: 919-977-2000 FAX: 919-977-2050		WWW.KIMLEY-HORN.COM		NC LICENSE # F-0102	
KHA PROJECT		DATE		SCALE		DESIGNED BY		DRAWN BY		CHECKED BY	
07/24/2023		5/24/2023		1"=40'		EP		EP		BY	
PLAN SHEET											
SOLIS BUFFALO OFFSITE ROADWAY											
NORTH CAROLINA											
RALEIGH											
SHEET NUMBER R2.01											

Diagram illustrating a vertical curve design for a road project, showing elevation (feet) versus stationing.


Key Data Points:

- BEGIN WIDENING:** Station 12+32.72, ELEV = 316.52'
- BEGIN GRADE:** Station 13+47.19, ELEV = 318.02'
- Grade 1:** +11.4000%
- Grade 2:** -10.3300%
- Grade 3:** -11.8350%
- Grade 4:** -11.3858%
- EXISTING GROUND:** Indicated by a dashed line.
- END GRADE:** Station 21+70.00, ELEV = 312.70'
- BEGIN MILL TO TIE-IN:** Station 20+50.00, ELEV = 312.98'

Vertical Curve Data:

- Curve 1:** PI = 15+05.00, ELEV = 318.23', VC = 170', K = 98
- Curve 2:** PI = 17+90.00, ELEV = 318.35', VC = 170', K = 113
- Curve 3:** PI = 20+95.00, ELEV = 313.28', VC = 170', K = 378

Horizontal Alignment: -L- NC 2215 (BUFFALO RD)

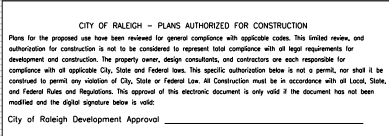

SHEET NUMBER R2.02	SOLIS BUFFALOEE OFFSITE ROADWAY NORTH CAROLINA	PROFILE			© 2022 333 PAVETTILLE STREET, SUITE 600, WALEIGH, NC 27601 PHONE: 919-555-1100 FAX: 919-555-3867 WWW.KH-H.COM NC LICENSE # F-0102	No.	DATE	BY
KHA PROJECT 017222020			DATE 5/24/2023			SCALE 1"=40'		
DESIGNED BY: EP			DRAWN BY: EP			CHECKED BY: BW		

Profile view showing elevation (270 to 350) versus stationing (23 to 28). The profile includes vertical curve data (PI, EL, VC, KA, KB) and grade percentages (-13.6800%, -11.2545%, -10.3033%). A label "-Y1- NC 2049 (FORESTVILLE RD)" is present. A note indicates "END OVERLAY AND WIDENING" at station 27.51628+80.00 with elevation 279.59.

CITY OF RALEIGH - PLANS AUTHORIZED FOR CONSTRUCTION

Plans for the proposed use have been reviewed for general compliance with applicable codes. This limited review, and authorization for construction is not to be considered to represent total compliance with all legal requirements for development and construction. The property owner, design consultants, and contractors are each responsible for compliance with all applicable City, State and Federal laws. This specific authorization below is not a permit; nor shall it be construed to permit any violation of City, State or Federal Law. All Construction must be in accordance with all Local, State, and Federal Rules and Regulations. This approval of this electronic document is only valid if the document has not been modified and the digital signature below is valid.

City of Raleigh Development Approval: _____

NO.	REVISIONS	DATE	BY

Kimley»Horn
© 2022
333 FAYETTEVILLE STREET, SUITE 600, RALEIGH, NC 27601
PHONE: 919-883-1144 FAX: 919-883-1145
NC LICENSE # F-1012




PROFILE

SOLIS BUFFALO OFFSITE ROADWAY
RALEIGH NORTH CAROLINA

SHEET NUMBER
R2.03


SHEET NUMBER R2.03	SOLIS BUFFALO OFFSITE ROADWAY	NORTH CAROLINA	RALEIGH	PROFILE	KHA PROJECT 017222020 DATE 5/24/2023 SCALE 1"=40' DESIGNED BY: EP DRAWN BY: EP CHECKED BY: BV	 © 2022 333 F AINETTVILLE STREET, SUITE 600, WALEIGH, NC 27601 PHONE: 919.446.4600 FAX: 919.446.4647 WWW.KIMLEY-HORN.COM NC LICENSE # F-0102	No.	REVISIONS	DATE	BY

5/24/2023 K:\RAL_Roadway\07222020 - Buf Lake Rd. Off Site\Roadway\Proj\07222020_rdy_sub_2205.dgn

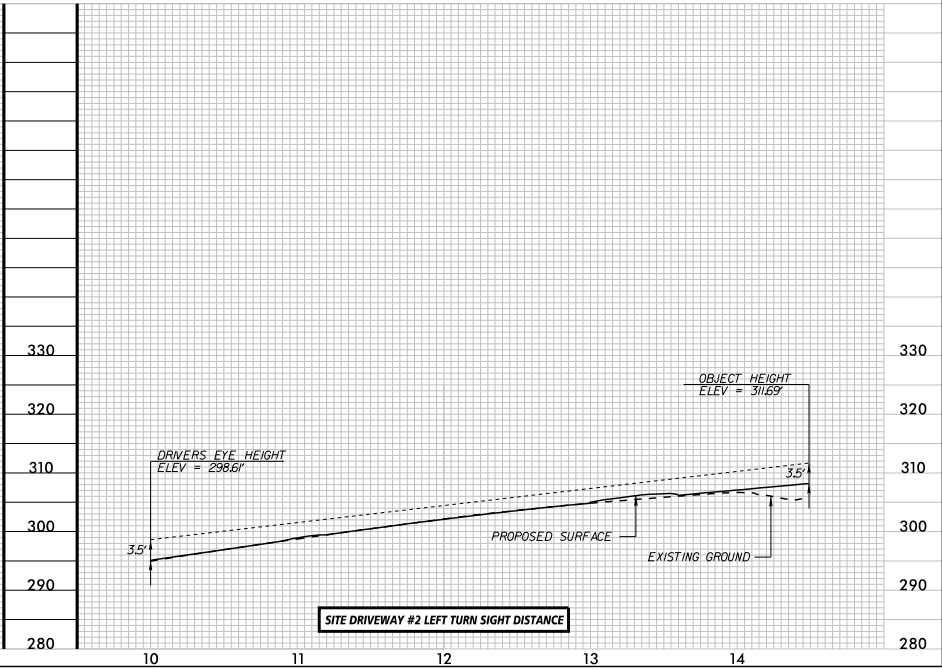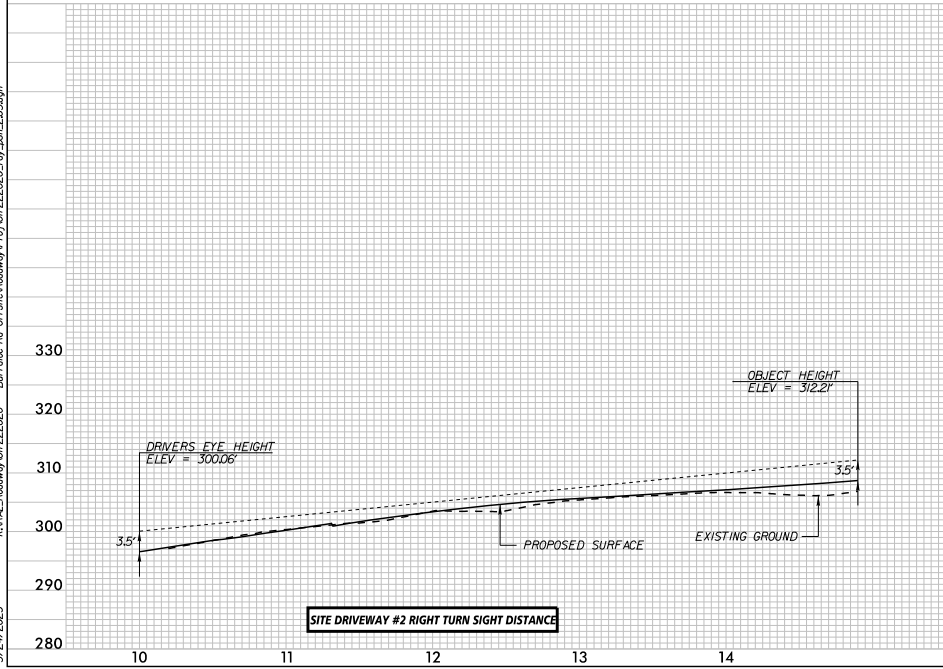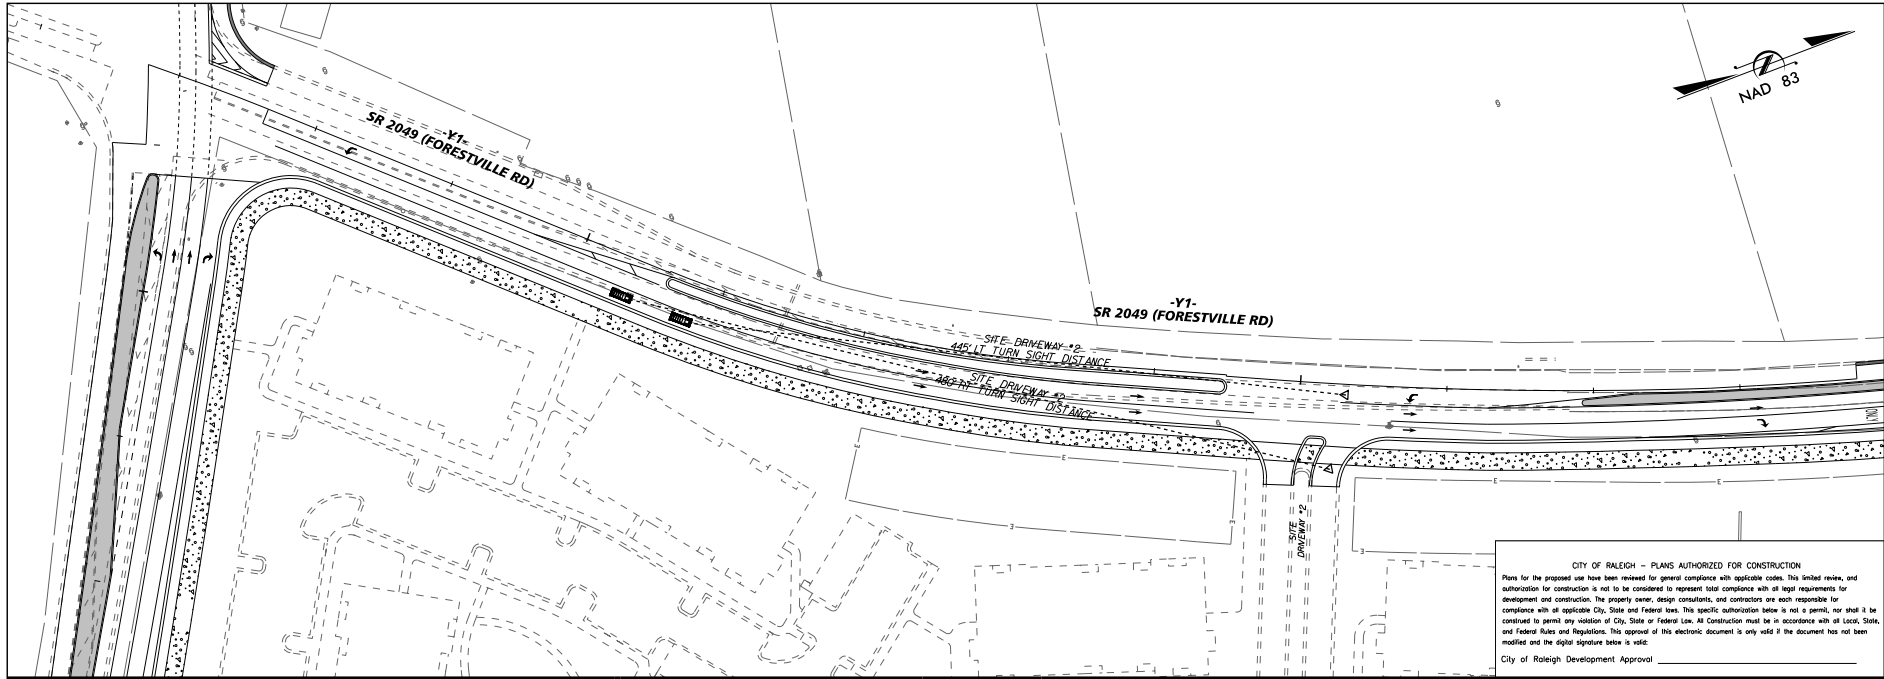

KIMLEY HORN		KIMLEY HORN	
421 FAYETTEVILLE STREET, SUITE 400, RALEIGH, NC 27601		421 FAYETTEVILLE STREET, SUITE 400, RALEIGH, NC 27601	
PHONE: 919-977-2000 FAX: 919-977-2050		PHONE: 919-977-2000 FAX: 919-977-2050	
WWW.KIMLEYHORN.COM		WWW.KIMLEYHORN.COM	
NC LICENSE # F-002		NC LICENSE # F-002	
REVISED		REVISED	
DATE		DATE	
BY		BY	
SHEET NUMBER		SHEET NUMBER	
R2.05		R2.05	
PROJECT		PROJECT	
SITE DRIVEWAY #2		SITE DRIVEWAY #2	
INTERSECTION SIGHT		INTERSECTION SIGHT	
DISTANCE		DISTANCE	
SOLIS BUFFALO		SOLIS BUFFALO	
OFFSITE ROADWAY		OFFSITE ROADWAY	
NORTH CAROLINA		NORTH CAROLINA	
MORRISVILLE		MORRISVILLE	
DESIGNED BY: CDP		DESIGNED BY: CDP	
DRAWN BY: CDP		DRAWN BY: CDP	
CHECKED BY: CDP		CHECKED BY: CDP	
BY		BY	


5/24/2023 K:\24\Roadway\07222023 - Buf\Buf Rd Off Site\Roadway\Proj\07222023_01_sub_2206.dgn

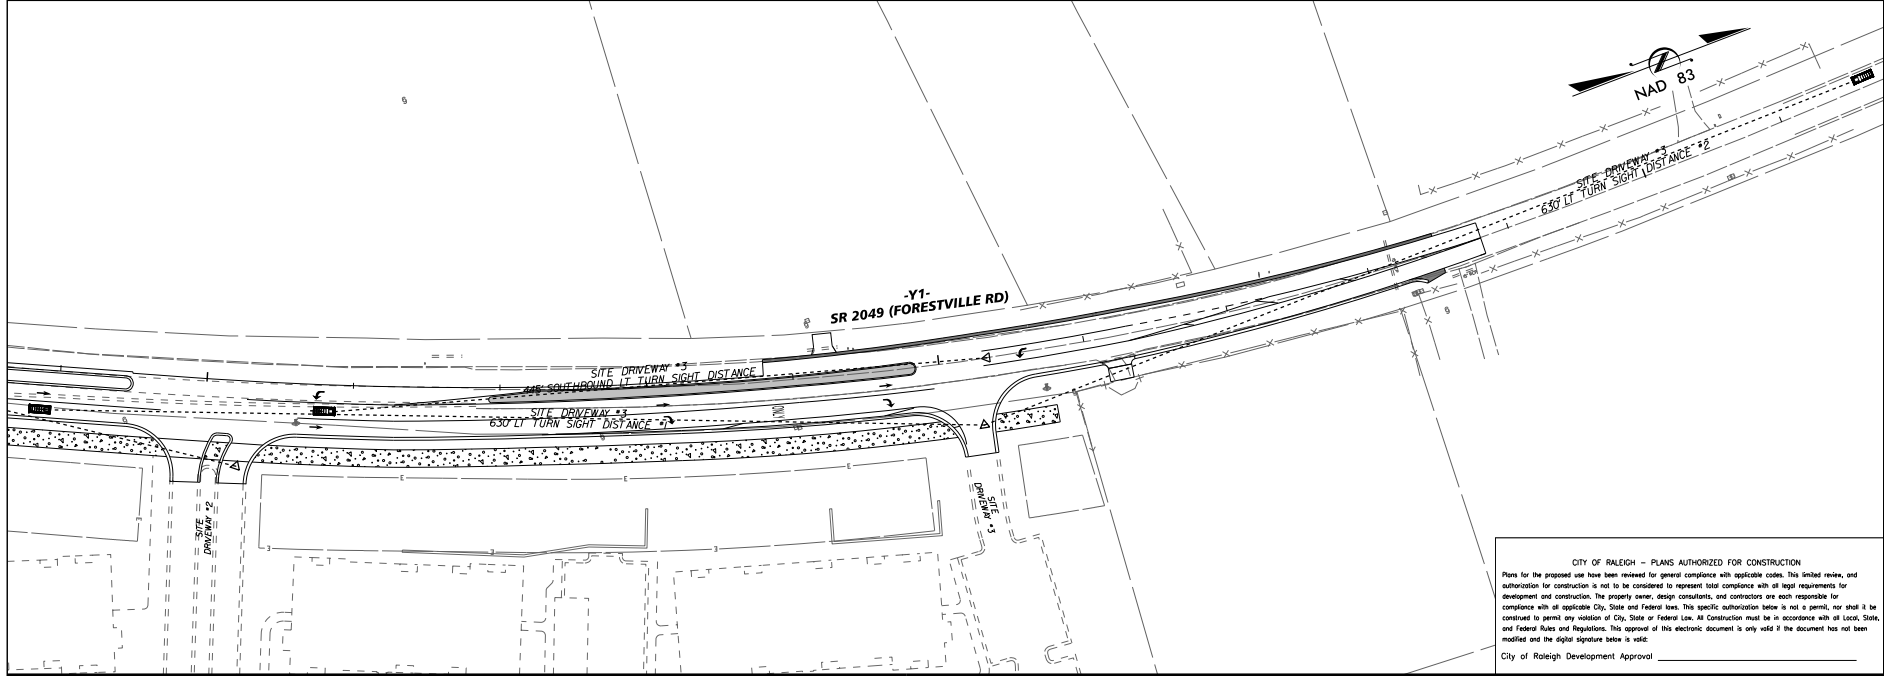

CITY OF RALEIGH - PLANS AUTHORIZED FOR CONSTRUCTION



Plans for the proposed use have been reviewed for general compliance with applicable codes. This limited review, and authorization for construction is not to be considered to represent total compliance with all legal requirements for development and construction. The property owner, design consultants, and contractors are each responsible for compliance with all applicable City, State and Federal laws. This specific authorization below is not a permit, nor shall it be construed to permit any violation of City, State or Federal Law. All Construction must be in accordance with all Local, State, and Federal Rules and Regulations. This approval of this electronic document is only valid if the document has not been modified and the digital signature below is valid.

City of Raleigh Development Approval _____

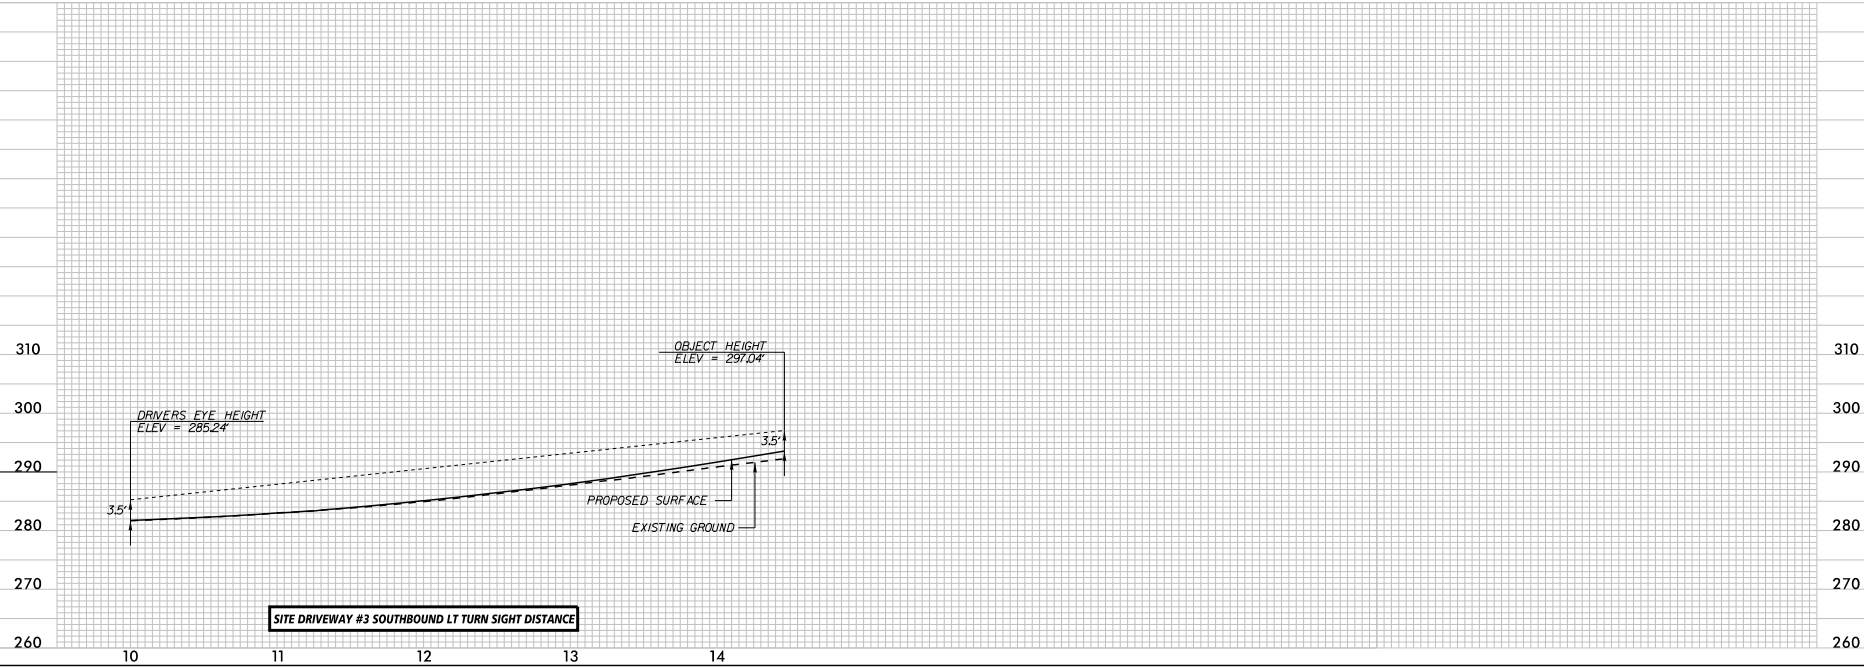

KIMLEY-HORN		DATE	BY
421 FAYETTEVILLE STREET, SUITE 400, RALEIGH, NC 27601		REVISIONS	
PHONE: 919-977-2000 FAX: 919-977-2000		No.	
NC LICENSE # F-0102		DATE	BY
KNA PROJECT		DATE	
SITE DRIVEWAY #3		5/24/2023	
INTERSECTION SIGHT		SCALE 1"=40'	
DISTANCE		DESIGNED BY: CDP	
SOLIS BUFFALO		DRAWN BY: CDP	
OFFSITE ROADWAY		CHECKED BY: BY	
SHEET NUMBER		R2.06	
MORRISVILLE		NORTH CAROLINA	

This document, together with the concepts and designs presented herein, is an instrument of service, is intended only for the specific purpose and client for which it was prepared. Plans of and proper reliance on this document without written authorization and signature by Kimley-Horn and Associates, Inc. shall be without liability to Kimley-Horn and Associates, Inc.

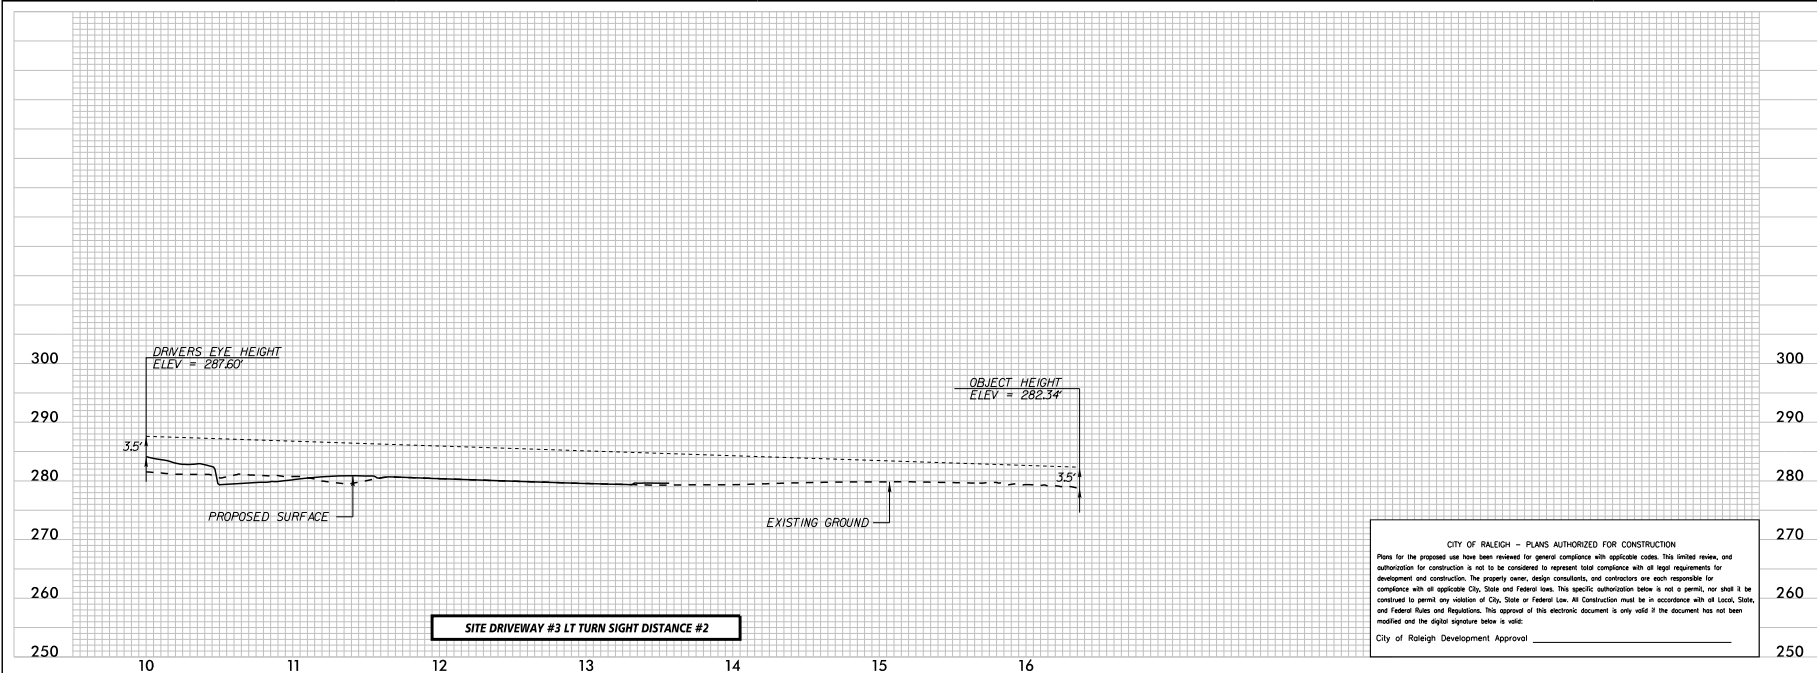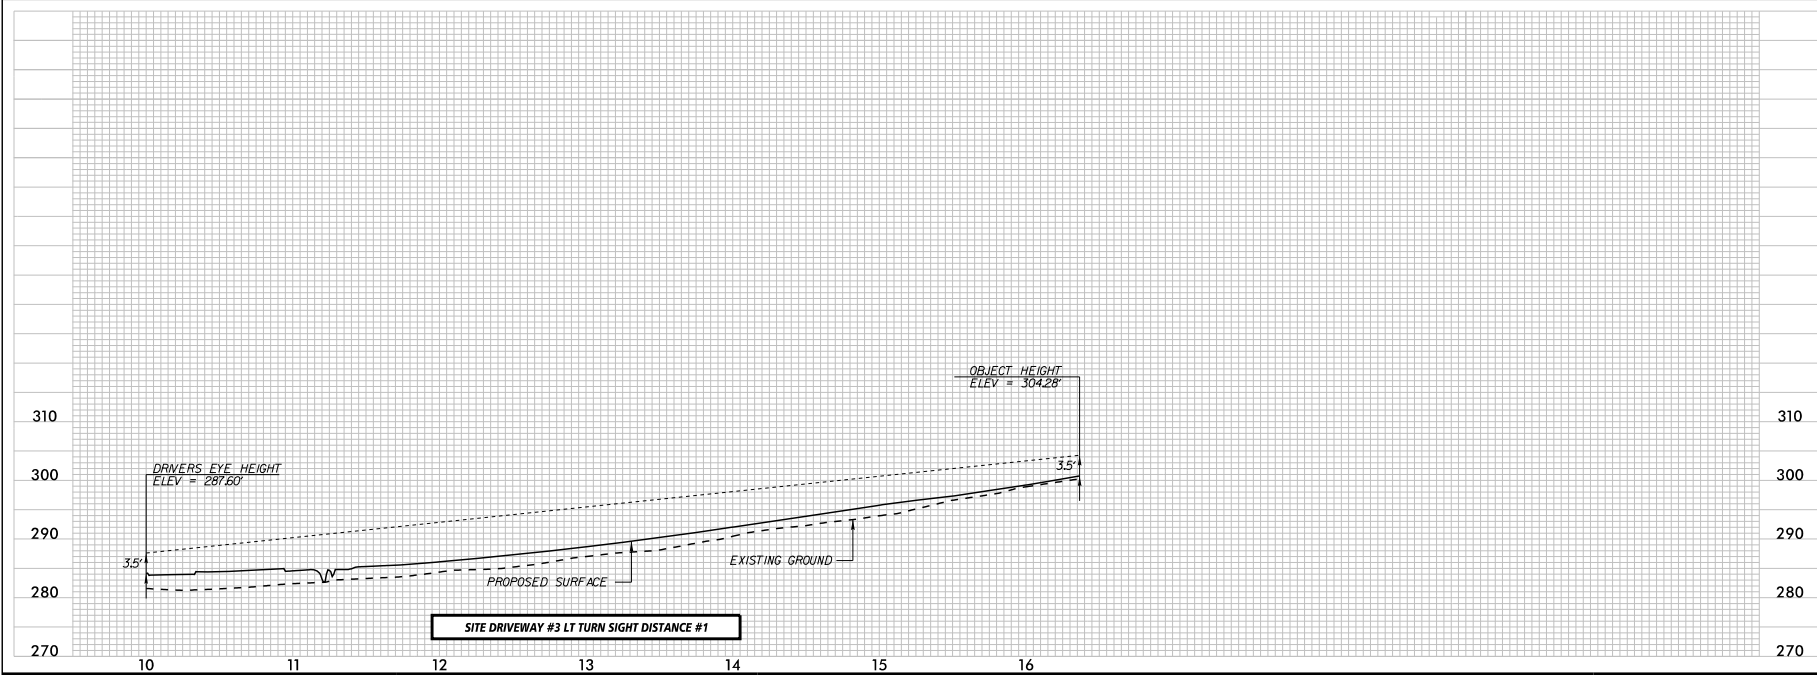

CITY OF RALEIGH -- PLANS AUTHORIZED FOR CONSTRUCTION

Plans for the proposed use have been reviewed for general compliance with applicable codes. This limited review, and authorization for construction is not to be considered to represent total compliance with all legal requirements for development and construction. The property owner, design consultants, and contractors are each responsible for compliance with all applicable City, State and Federal laws. This specific authorization neither is not a permit, nor shall it be construed to permit any violation of City, State or Federal Law. All Construction must be in accordance with all Local, State, and Federal Rules and Regulations. This approval of this electronic document is only valid if the document has not been modified and the digital signature below is valid.

City of Raleigh Development Approval _____

KIMLEY-HORN & ASSOCIATES, INC.		KIMLEY-HORN & ASSOCIATES, INC.	
333 FAYETTEVILLE STREET, SUITE 600, RALEIGH, NC 27601		333 FAYETTEVILLE STREET, SUITE 600, RALEIGH, NC 27601	
PHONE: 919-853-8844 FAX: 919-853-5847		PHONE: 919-853-8844 FAX: 919-853-5847	
NC LICENSE # F-0102		NC LICENSE # F-0102	
© 2022		© 2022	
DESIGNED BY: EP		DESIGNED BY: EP	
DRAWN BY: EP		DRAWN BY: EP	
CHECKED BY: BV		CHECKED BY: BV	
DATE: 5/24/2023		DATE: 5/24/2023	
SCALE: 1"=40'		SCALE: 1"=40'	
PROJECT: KHA PROJECT		PROJECT: KHA PROJECT	
SITE DRIVEWAY #3		SITE DRIVEWAY #3	
INTERSECTION SIGHT		INTERSECTION SIGHT	
DISTANCE		DISTANCE	
SOLIS BUFFALO		SOLIS BUFFALO	
OFFSITE ROADWAY		OFFSITE ROADWAY	
RALEIGH		RALEIGH	
NORTH CAROLINA		NORTH CAROLINA	
SHEET NUMBER		SHEET NUMBER	
R2.07		R2.07	

PLAN FOR PROPOSED TRAFFIC CONTROL, MARKING & DELINEATION WAKE COUNTY

ROADWAY STANDARD DRAWINGS

THE FOLLOWING ROADWAY STANDARDS AS SHOWN IN "ROADWAY STANDARD DRAWINGS" - N.C. DEPARTMENT OF TRANSPORTATION - RALEIGH, N.C., DATED JANUARY 2018 ARE APPLICABLE TO THIS PROJECT AND BY REFERENCE HEREBY ARE CONSIDERED A PART OF THESE PLANS:

STD. NO.	TITLE
1101.01	WORK ZONE ADVANCE WARNING SIGNS
1101.02	TEMPORARY LANE CLOSURES
1101.04	TEMPORARY SHOULDER CLOSURES
1101.05	WORK ZONE VEHICLE ACCESSES
1101.11	TRAFFIC CONTROL DESIGN TABLES
1110.01	STATIONARY WORK ZONE SIGNS
1110.02	PORTABLE WORK ZONE SIGNS
1130.01	DRUM
1135.01	CONES
1145.01	BARRICADES - TYPE III
1150.01	FLAGGING DEVICES
1180.01	SKINNY DRUM
1205.01	PAVEMENT MARKINGS - LINE TYPES AND OFFSETS
1205.02	PAVEMENT MARKINGS - DIVIDED AND UNDIVIDED ROADWAYS
1205.04	PAVEMENT MARKINGS - INTERSECTIONS
1205.05	PAVEMENT MARKINGS - TURN LANES
1205.07	PAVEMENT MARKINGS - PEDESTRIAN CROSSWALKS
1205.08	PAVEMENT MARKINGS - SYMBOLS AND WORD MESSAGES
1205.13	PAVEMENT MARKINGS - LANE REDUCTIONS
1250.01	RAISED PAVEMENT MARKERS - INSTALLATION SPACING
1251.01	RAISED PAVEMENT MARKERS - (PERMANENT AND TEMPORARY)

INDEX OF SHEETS

SHEET NO.	TITLE
R3.00	TRAFFIC CONTROL TITLE SHEET, LIST OF APPLICABLE ROADWAY STANDARD DRAWINGS, AND LEGEND
R3.01	GENERAL NOTES
R3.02	PHASING NOTES
R3.03 - R3.04	PHASE I PLANS AND DETAILS
R3.05 - R3.06	PHASE II PLANS AND DETAILS

LEGEND

GENERAL	
	DIRECTION OF TRAFFIC FLOW
	NORTH ARROW
	PROPOSED PVMT.
	EXISTING PVMT.
	WORK AREA
	WEDGING
	REMOVAL OF EXISTING PAVEMENT
	TEMPORARY PAVEMENT

TRAFFIC CONTROL DEVICES

	TYPE I BARRICADE
	TYPE II BARRICADE
	TYPE III BARRICADE
	CONES
	DRUM
	SKINNY DRUM
	FLASHING ARROW PANEL (TYPE C)
	STATIONARY SIGN
	PORTABLE SIGN
	STATIONARY OR PORTABLE SIGN
	CRASH CUSHION
	CHANGEABLE MESSAGE SIGN
	TRUCK MOUNTED ATTENUATOR (TMA)
	POLICE
	FLAGGER

CRYSTAL/CRYSTAL PAVEMENT MARKER PAVEMENT MARKINGS

	YELLOW/YELLOW PAVEMENT MARKER
	CRYSTAL/RED PAVEMENT MARKER
	PAVEMENT MARKING SYMBOLS

CITY OF RALEIGH - PLANS AUTHORIZED FOR CONSTRUCTION

Plans for the proposed use have been reviewed for general compliance with applicable codes. This limited review, and authorization for construction is not to be considered to represent total compliance with all legal requirements for development and construction. The property owner, design consultants, and contractors are each responsible for compliance with all applicable City, State and Federal laws. This specific authorization below is not a permit, nor shall it be construed to permit any violation of City, State or Federal Law. All Construction must be in accordance with all Local, State, and Federal Rules and Regulations. This approval of this electronic document is only valid if the document has not been modified and the digital signature below is valid:

City of Raleigh Development Approval _____

TEMPORARY PAVEMENT MARKING SCHEDULE

PAVEMENT MARKING LINES	
P1 - PAINT (4" WHITE, 2X)	EDGE LINE
P2 - PAINT (4" WHITE, 2X)	SOLID LANE LINE
P3 - PAINT (4" WHITE, 2X)	10 FT. WHITE SKIP
P4 - PAINT (4" WHITE, 2X)	3' X 9'/SP MINISKIP
P11 - PAINT (4" YELLOW, 2X)	SINGLE CENTERLINE
P13 - PAINT (4" YELLOW, 2X)	DOUBLE CENTERLINE
P23 - PAINT (8" WHITE, 2X)	3' X 9'/SP MINISKIP
P42 - PAINT (8" YELLOW, 2X)	DIAGONAL
P50 - PAINT (12" WHITE, 2X)	GORELINE
P51 - PAINT (12" WHITE, 2X)	DIAGONAL
P61 - PAINT (24" WHITE, 2X)	STOP BARS

PAVEMENT MARKING SYMBOLS	
P70 - PAINT 2X (LEFT TURN ARROW)	
P71 - PAINT 2X (RIGHT TURN ARROW)	
P72 - PAINT 2X (STRAIGHT ARROW)	
P100 - PAINT 2X (ONLY)	

Kimley»Horn

© 2022
421 FAYETTEVILLE STREET, SUITE 600, RALEIGH, NC 27601
PHONE: 919-477-2000 FAX: 919-477-2050
WWW.KIMLEY-HORN.COM
NC LICENSE # F-0102

KHA PROJECT
DATE
5/24/2023
SCALE
NTS
DESIGNED BY: EP
DRAWN BY: EP
CHECKED BY: BV

TRAFFIC
MANAGEMENT
PLAN

SOLIS BUFFALO
OFFSITE ROADWAY

NORTH CAROLINA

RALEIGH

SHEET NUMBER
R3.00

CHANGES MAY BE REQUIRED WHEN PHYSICAL DIMENSIONS IN THE DETAIL DRAWINGS, STANDARD DETAILS, AND ROADWAY DETAILS ARE NOT ATTAINABLE TO MEET FIELD CONDITIONS OR RESULT IN DUPLICATE OR UNDESIRABLE OVERLAPPING OF DEVICES. MODIFICATION MAY INCLUDE: MOVING, SUPPLEMENTING, COVERING, OR REMOVAL OF DEVICES AS DIRECTED BY THE ENGINEER.

THE FOLLOWING GENERAL NOTES APPLY AT ALL TIMES FOR THE DURATION OF THE CONSTRUCTION PROJECT EXCEPT WHEN OTHERWISE NOTED IN THE PLAN OR DIRECTED BY THE ENGINEER.

A) DO NOT CLOSE OR NARROW TRAVEL LANES AS FOLLOWS:

<u>ROAD NAME</u>	<u>DAY AND TIME RESTRICTIONS</u>
BUFFALO RD (SR 2215) FORESTVILLE RD (SR 2049)	6:00 AM TO 9:00 AM & 4:00 PM TO 7:00 PM MONDAY THRU FRIDAY

B) DO NOT CLOSE OR NARROW TRAVEL LANES DURING HOLIDAYS AND SPECIAL EVENTS AS FOLLOWS:

ROAD NAME
BUFFALOE RD (SR 2215)
FORESTVILLE RD (SR 2049)

HOLIDAY

1. FOR ANY UNEXPECTED OCCURRENCE THAT CREATES UNUSUALLY HIGH TRAFFIC VOLUMES, AS DIRECTED BY THE ENGINEER.
2. FOR NEW YEAR'S, BETWEEN THE HOURS OF 6:00 A.M. DECEMBER 31st TO 7:00 P.M. - JANUARY 2ND. IF NEW YEAR'S DAY IS ON A FRIDAY, SATURDAY, SUNDAY, OR MONDAY THEN UNTIL 7:00 P.M. THE FOLLOWING TUESDAY.
3. FOR EASTER, BETWEEN THE HOURS OF 6:00 A.M. THURSDAY AND 7:00 P.M. MONDAY.
4. FOR MEMORIAL DAY, BETWEEN THE HOURS OF 6:00 A.M. FRIDAY TO 7:00 P.M. TUESDAY.
5. FOR INDEPENDENCE DAY, BETWEEN THE HOURS OF 6:00 A.M. THE DAY BEFORE INDEPENDENCE DAY AND 7:00 P.M. THE DAY AFTER INDEPENDENCE DAY.

IF INDEPENDENCE DAY IS ON A FRIDAY, SATURDAY, SUNDAY OR MONDAY THEN BETWEEN THE HOURS OF 6:00 A.M. THE THURSDAY BEFORE INDEPENDENCE DAY AND 7:00 P.M. THE TUESDAY AFTER INDEPENDENCE DAY.

6. FOR LABOR DAY BETWEEN THE HOURS OF 6:00 A.M. FRIDAY AND 7:00 P.M. TUESDAY.
7. FOR THANKSGIVING DAY, BETWEEN THE HOURS OF 6:00 A.M. TUESDAY TO 7:00 P.M. MONDAY.
8. FOR CHRISTMAS, BETWEEN THE HOURS OF 6:00 A.M. THE FRIDAY BEFORE THE WEEK OF CHRISTMAS DAY AND 7:00 P.M. THE FOLLOWING TUESDAY AFTER THE WEEK OF CHRISTMAS.

C) DO NOT CLOSE ROADS AS FOLLOWS:

<u>ROAD NAME</u>	<u>DAY AND TIME RESTRICTIONS</u>
BUFFALOE RD (SR2215)	ANYTIME
FORESTVILLE RD (SR2049)	

D) DO NOT STOP TRAFFIC AS FOLLOWS:

<u>ROAD NAME</u>	<u>DAY AND TIME RESTRICTIONS</u>	<u>OPERATIONS</u>
BUFFALOE RD (SR2215) FORESTVILLE RD (SR2049)	MONDAY THRU FRIDAY FROM 6 AM TO 9 AM AND FROM 4 PM TO 7 PM	TRAFFIC SHIFTS

E) REMOVE LANE CLOSURE DEVICES FROM THE LANE WHEN WORK IS NOT BEING PERFORMED BEHIND THE LANE CLOSURE OR WHEN A LANE CLOSURE IS NO LONGER NEEDED OR AS DIRECTED BY THE ENGINEER.

- F) WHEN PERSONNEL AND/OR EQUIPMENT ARE WORKING WITHIN 15 FT OF AN OPEN TRAVEL LANE, CLOSE THE NEAREST OPEN SHOULDER USING ROADWAY STANDARD DRAWING NO. 1101.04 UNLESS THE WORK AREA IS PROTECTED BY BARRIER OR GUARDRAIL OR A LANE CLOSURE IS INSTALLED.
- G) WHEN PERSONNEL AND/OR EQUIPMENT ARE WORKING ON THE SHOULDER ADJACENT TO AN UNDIVIDED FACILITY AND WITHIN 5 FT OF AN OPEN TRAVEL LANE, CLOSE THE NEAREST OPEN TRAVEL LANE USING ROADWAY STANDARD DRAWING NO. 1101.02 UNLESS THE WORK AREA IS PROTECTED BY BARRIER OR GUARDRAIL.

WHEN PERSONNEL AND/OR EQUIPMENT ARE WORKING ON THE SHOULDER ADJACENT TO A DIVIDED FACILITY AND WITHIN 10 FT OF AN OPEN TRAVEL LANE, CLOSE THE NEAREST OPEN TRAVEL LANE USING ROADWAY STANDARD DRAWING NO. 1101.02 UNLESS THE WORK AREA IS PROTECTED BY BARRIER OR GUARDRAIL.

- H) WHEN PERSONNEL AND/OR EQUIPMENT ARE WORKING WITHIN A LANE OF TRAVEL OF AN UNDIVIDED OR DIVIDED FACILITY, CLOSE THE LANE ACCORDING TO THE TRAFFIC CONTROL PLANS, ROADWAY STANDARD DRAWINGS, OR AS DIRECTED BY THE ENGINEER. CONDUCT THE WORK SO THAT ALL PERSONNEL AND/OR EQUIPMENT REMAIN WITHIN THE CLOSED TRAVEL LANE.

- I) DO NOT WORK SIMULTANEOUSLY WITHIN 15 FT ON BOTH SIDES OF AN OPEN TRAVELWAY, RAMP, OR LOOP WITHIN THE SAME LOCATION UNLESS PROTECTED WITH GUARDRAIL OR BARRIER.**

J) BACKFILL AT A 6:1 SLOPE UP TO THE EDGE AND ELEVATION OF EXISTING PAVEMENT IN AREAS ADJACENT TO AN OPENED TRAVEL LANE THAT HAS AN EDGE OF PAVEMENT DROP-OFF AS FOLLOWS:

BACKFILL DROP-OFFS THAT EXCEED 2 INCHES ON ROADWAYS WITH POSTED SPEED LIMITS OF 45 MPH OR GREATER.

BACKFILL DROP-OFFS THAT EXCEED 3 INCHES ON ROADWAYS WITH POSTED SPEED LIMITS LESS THAN 45 MPH.

BACKFILL WITH SUITABLE COMPACTED MATERIAL, AS APPROVED BY THE ENGINEER. AT NO EXPENSE TO THE DEPARTMENT.

K) NOTIFY THE ENGINEER THIRTY (30) CALENDAR DAYS PRIOR TO ANY TRAFFIC PATTERN ALTERATION.

L) **INSTALL ADVANCE WORK ZONE WARNING SIGNS WHEN WORK IS WITHIN 40 FT FROM THE EDGE OF TRAVEL LANE AND NO MORE THAN THREE (3) DAYS PRIOR TO THE BEGINNING OF CONSTRUCTION.**

- M) COVER OR REMOVE ALL SIGNS AND DEVICES REQUIRED TO CLOSE THE ROAD WHEN ROAD CLOSURE IS NOT IN OPERATION.**

**COVER OR REMOVE ALL SIGNS REQUIRED FOR THE OFF-SITE
DETOUR WHEN THE DETOUR IS NOT IN OPERATION.**

- N) ENSURE ALL NECESSARY SIGNING IS IN PLACE PRIOR TO ALTERING ANY TRAFFIC PATTERN.**

- O) **INSTALL BLACK ON ORANGE "DIP" SIGNS (W8-2) AND/OR "BUMP" SIGNS (W8-1) 300 IN ADVANCE OF THE UNEVEN AREA, OR AS DIRECTED BY THE ENGINEER.**

P) WHEN LANE CLOSURES ARE NOT IN EFFECT SPACE CHANNELIZING DEVICES IN WORK AREAS NO GREATER IN FEET THAN TWICE THE POSTED SPEED LIMIT (MPH) EXCEPT, 10 FT ON-CENTER IN RADII, AND 3 FT OFF THE EDGE OF AN OPEN TRAVELWAY. REFER TO STANDARD SPECIFICATIONS FOR ROADS AND STRUCTURES SECTIONS 1130 (DRUMS), 1135 (CONES) AND 1180 (SKINNY DRUMS) FOR ADDITIONAL REQUIREMENTS.

- Q) PLACE TYPE III BARRICADES, WITH "ROAD CLOSED" SIGN R11-2 ATTACHED, OF SUFFICIENT LENGTH TO CLOSE ENTIRE ROADWAY.**

- R) PLACE ADDITIONAL SETS OF THREE CHANNELIZING DEVICES (DRUMS) PERPENDICULAR TO THE EDGE OF TRAVELWAY ON 500 FT CENTERS WHEN UNOPENED LANES ARE CLOSED TO TRAFFIC.**

S) INSTALL TEMPORARY PAVEMENT MARKINGS AND TEMPORARY PAVEMENT MARKERS ON INTERIM LAYERS OF PAVEMENT AS FOLLOWS:

<u>ROAD NAME</u>	<u>MARKING</u>	<u>MARKER</u>
BUFFALOE RD. (SR 2215)	PAINT	RAISED MARKER
FORESTVILLE RD. (SR 2049)	PAINT	RAISED MARKER

- T) PLACE ONE APPLICATION OF PAINT FOR TEMPORARY TRAFFIC PATTERNS. PLACE A SECOND APPLICATION OF PAINT SIX (6) MONTHS AFTER THE INITIAL APPLICATION AND EVERY SIX MONTHS AS DIRECTED BY THE ENGINEER.**

- U) TIE PROPOSED PAVEMENT MARKING LINES TO EXISTING PAVEMENT MARKING LINES.**

- V) REMOVE/REPLACE ANY CONFLICTING/DAMAGED PAVEMENT MARKINGS AND MARKERS BY THE END OF EACH DAY'S OPERATION.**

- W) TRACE THE PROPOSED MONOLITHIC ISLAND LOCATIONS WITH PROPER COLOR PAVEMENT MARKINGS PRIOR TO INSTALLATION. PLACE TUBULAR MARKERS TO DELINEATE ANY PROPOSED MONOLITHIC ISLANDS BEFORE INSTALLATION**

X) LAW ENFORCEMENT MAY BE USED TO MAINTAIN TRAFFIC THROUGH THE WORK AREA AND/OR INTERSECTIONS AS DIRECTED BY THE ENGINEER.

- Y) ALL CURB RAMP LOCATIONS SHALL BE DERIVED FROM STATIONING SHOWN ON PAVEMENT MARKING PLANS OR AS DIRECTED BY THE ENGINEER IN COORDINATION WITH THE SIGNING AND DELINEATION UNIT.**

CITY OF RALEIGH - PLANS AUTHORIZED FOR CONSTRUCTION

Plans for the proposed use have been reviewed for general compliance with applicable codes. This limited review, and authorization for construction is not to be considered to represent total compliance with all legal requirements for development and construction. The property owner, design consultants, and contractors are each responsible for compliance with all applicable City, State and federal laws. This specific authorization below is not a permit, nor shall it be construed to permit any violation of City, State or Federal Law. All construction must be in accordance with all Local, State, and Federal Rules and Regulations. This approval of this electronic document is only valid if the document has not been modified and the digital signature below is valid:

City of Raleigh Development Approval

K:\RAL_Roadway\017222020 - Buffalo Rd Offsite\Work Zone Traffic Control\DesignSheets\017222020_Imp_TSH.dgn

CITY OF RALEIGH - PLANS AUTHORIZED FOR CONSTRUCTION

Plans for the proposed work have been reviewed for general compliance with applicable codes. This limited review, and authorization for construction is not to be considered to represent total compliance with all legal requirements for development and construction. The property owner, design consultants, and contractors are each responsible for compliance with all applicable City, State and Federal laws. This specific authorization is not a permit, nor shall it be construed to permit any violation of City, State or Federal Law. All construction must be in accordance with all Local, State, and Federal Rules and Regulations. This approval of this electronic document is only valid if the document has not been modified and the digital signature below is valid.

City of Raleigh Development Approval _____

TRAFFIC MANAGEMENT PLAN

SOLIS BUFFALOE
OFFSITE ROADWAY

GH

DATE	NTS
5/24/2023	
SCALE	EP
DESIGNED BY:	EP
DRAWN BY:	EP
CHECKED BY:	BV


Kimley»»Horn
© 2022
421 FAYETTEVILLE STREET, SUITE 600, RALEIGH, NC 27601
PHONE: 919-677-2000 FAX: 919-677-2050
WWW.KIMLEY-HORN.COM
NC LICENSE #: F-0102

NC LICENSE #: F-0102

No.

REVISIONS

DATE	B
------	---

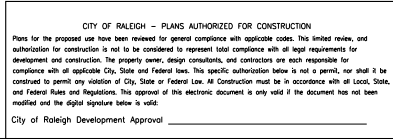


SHEET NUMBER
R3.03

017222020	DATE	NTS
5/24/2023		
SCALE	DESIGNED BY:	EP
	DRAWN BY:	EP

Kimley»»Horn
© 2022
421 FAYETTEVILLE STREET, SUITE 600, RALEIGH, NC 27601
PHONE: 919-677-2000 FAX: 919-677-2050
WWW.KIMLEY-HORN.COM

5/24/2023 K:\3AL_Roadway\07222020 - Bufaloe Rd. Offsite\Work Zone Traffic Control\Design\Sheets\07222020_rmp_000_1.dwg

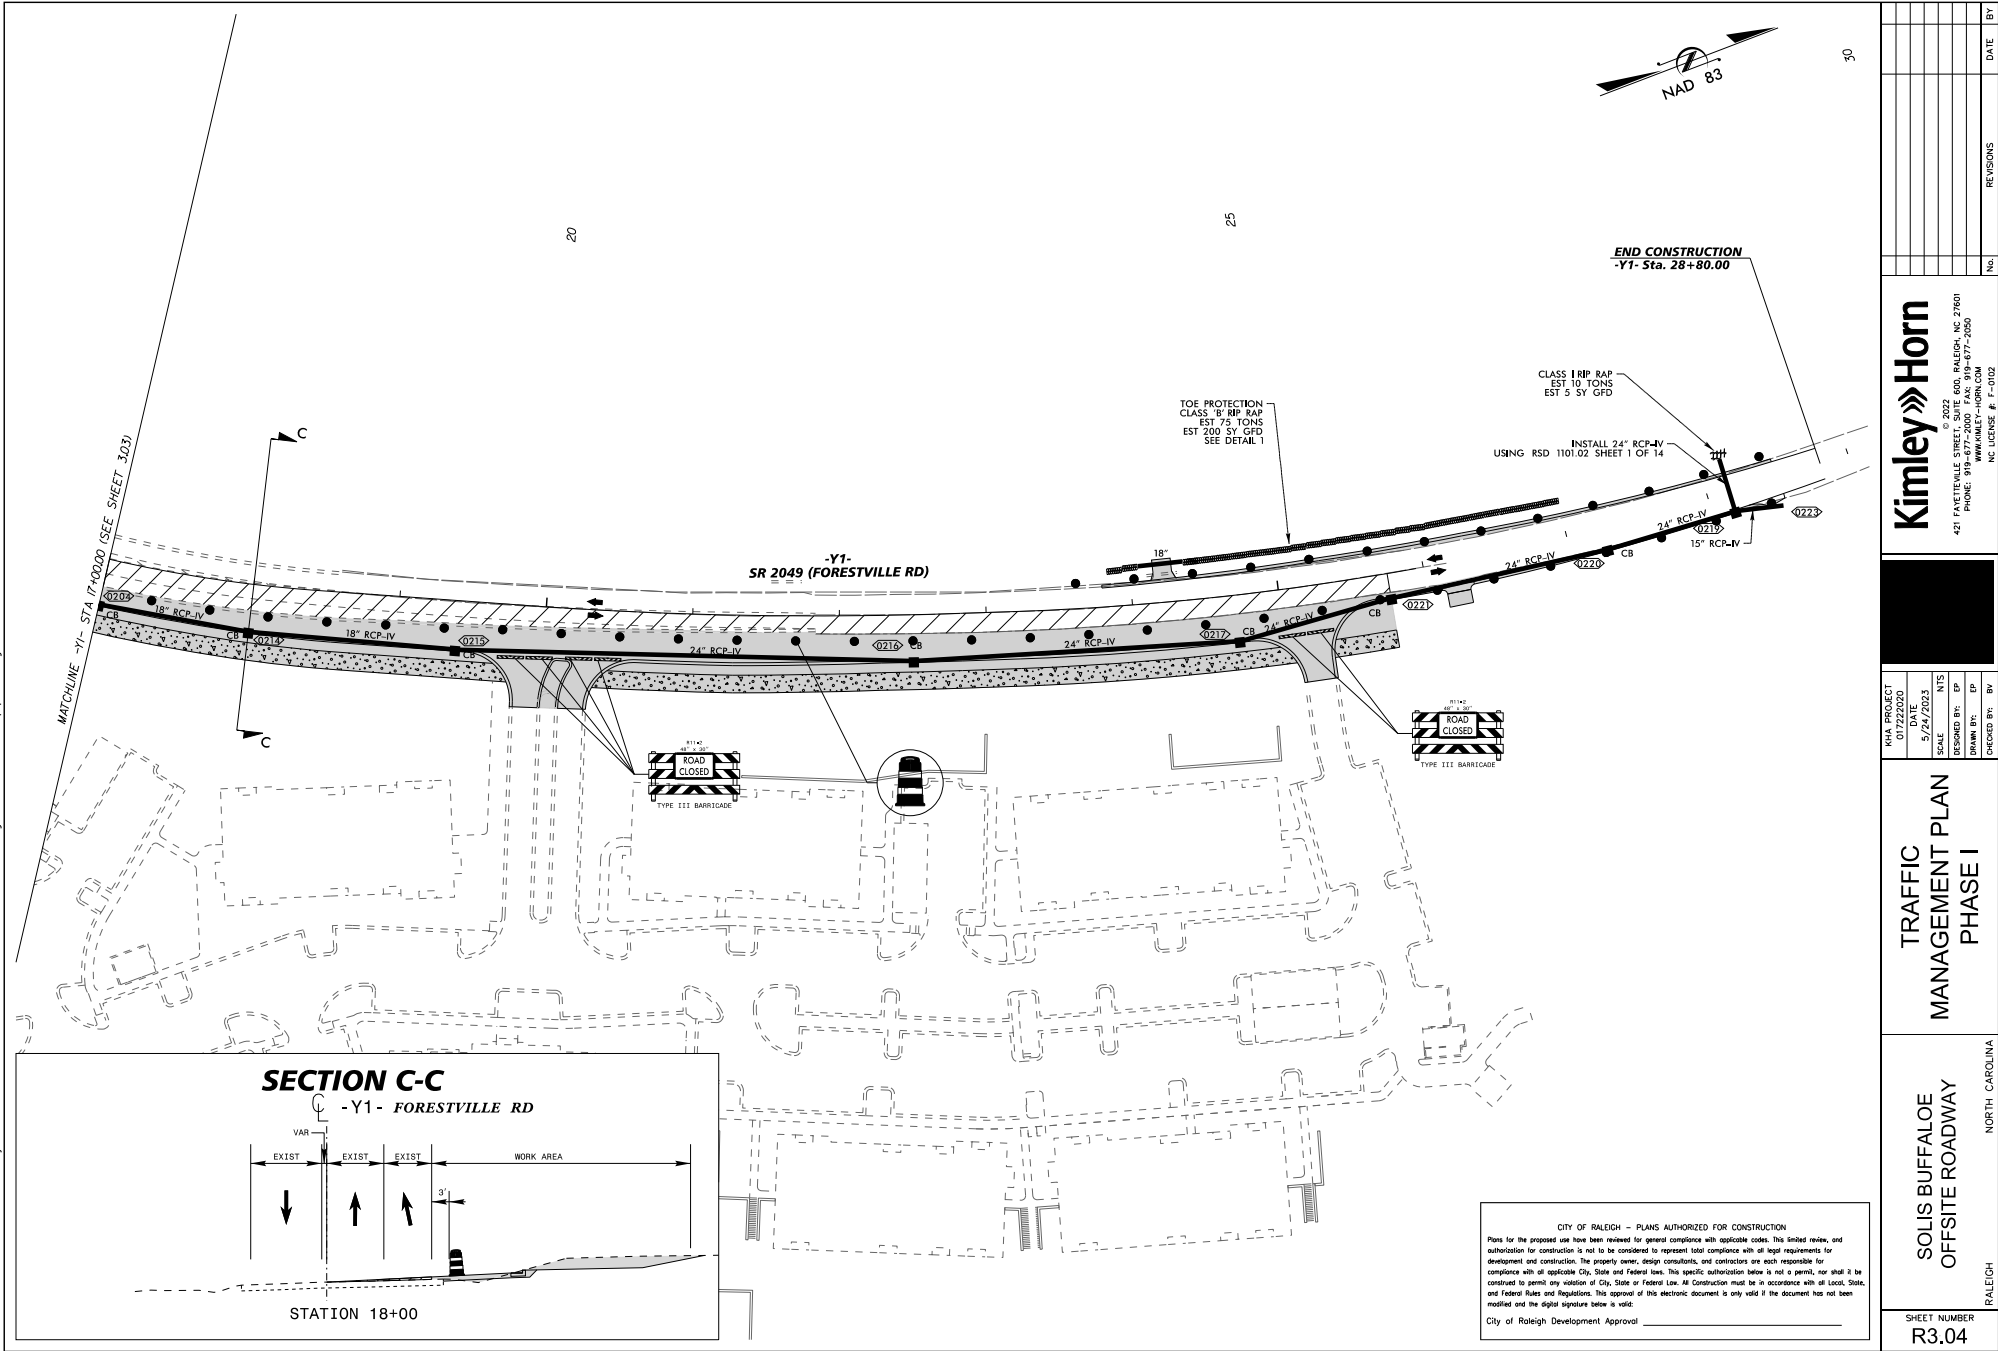


CITY OF RALEIGH - PLANS AUTHORIZED FOR CONSTRUCTION

Plans for the proposed use have been reviewed for general compliance with applicable codes. This limited review, and authorization for construction is not to be considered to represent total compliance with all legal requirements for development and construction. The property owner, design consultants, and contractors are each responsible for compliance with all applicable City, State and Federal laws. This specific authorization below is not a permit, nor shall it be construed to permit any violation of City, State or Federal Law. All Construction must be in accordance with all Local, State, and Federal Rules and Regulations. This approval of this electronic document is only valid if the document has not been modified and the digital signature below is valid:

City of Raleigh Development Approval _____

TRAFFIC MANAGEMENT PLAN PHASE I		SOLIS BUFFALO OFFSITE ROADWAY		NORTH CAROLINA		RALEIGH	
KHA PROJECT 07222020		DATE 5/24/2023		SCALE NTS		DESIGNED BY: EP	
DRAWN BY: BV		CHECKED BY: BV		NO.		DATE	
BY		REVISIONS		DATE		BY	
Kimley»Horn		© 2023		421 FAYETTEVILLE STREET, SUITE 600, RALEIGH, NC 27601		PHONE: 919-877-2000 FAX: 919-877-2050	
NC LICENSE # F-002							
SHEET NUMBER R3.04							

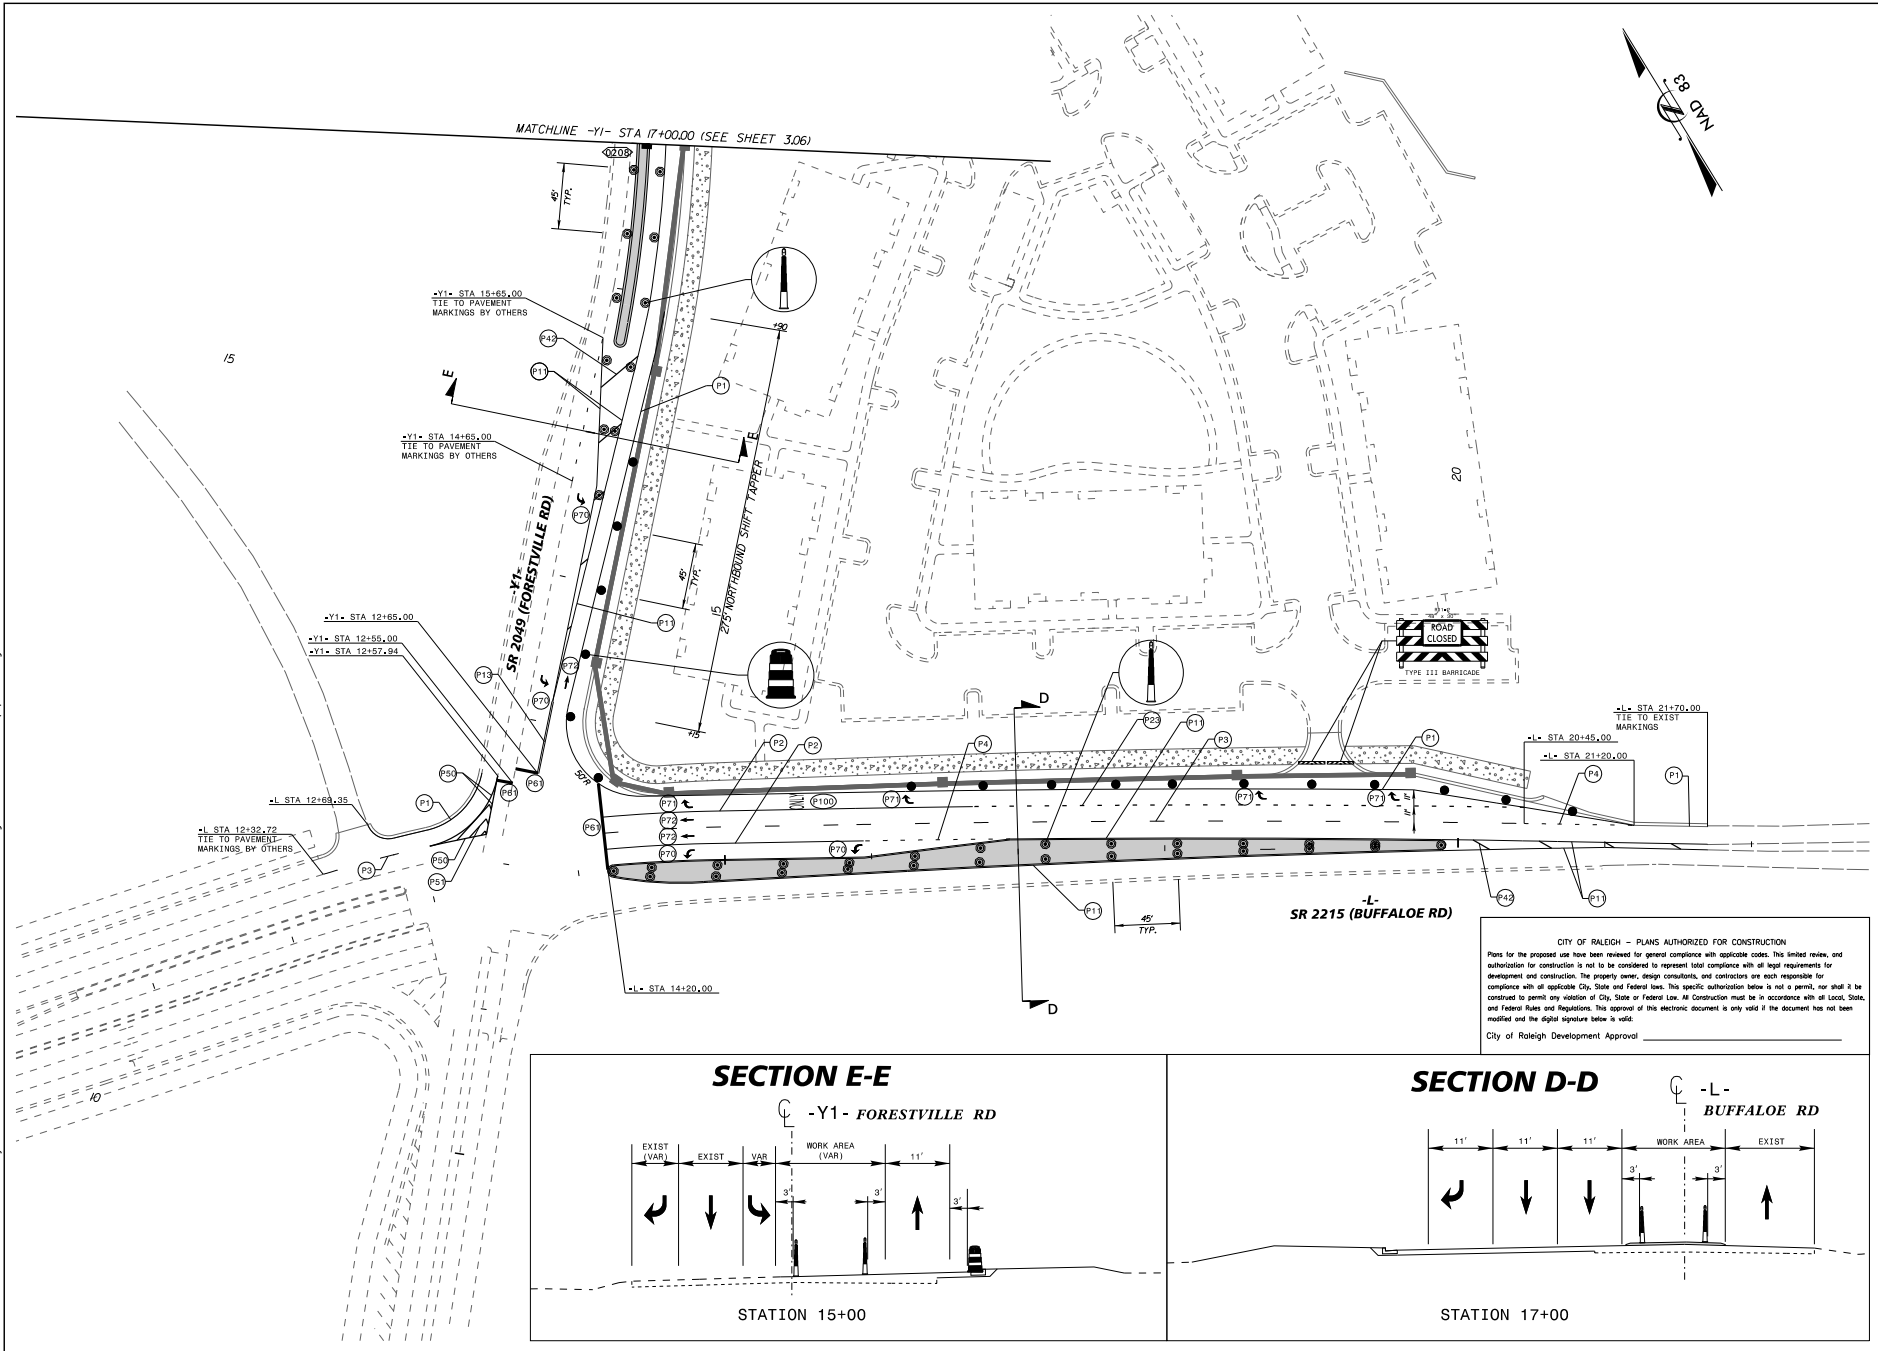


SHEET NUMBER R3.05	RALEIGH	NORTH CAROLINA
------------------------------	---------	----------------

Kimley»»Horn
© 2022
421 FAYETTEVILLE STREET, SUITE 600, RALEIGH, NC 27601
PHONE: 919-677-2000 FAX: 919-677-2050
WWW.KIMLEY-HORN.COM
NC LICENSE #: F-0102

[illegible]

5/24/2023 K:\3AL_Roadway\07222020 - Buford Rd Offsite\Work Zone Traffic Control\Design\Sheets\07222020_imp_ash_306.dgn

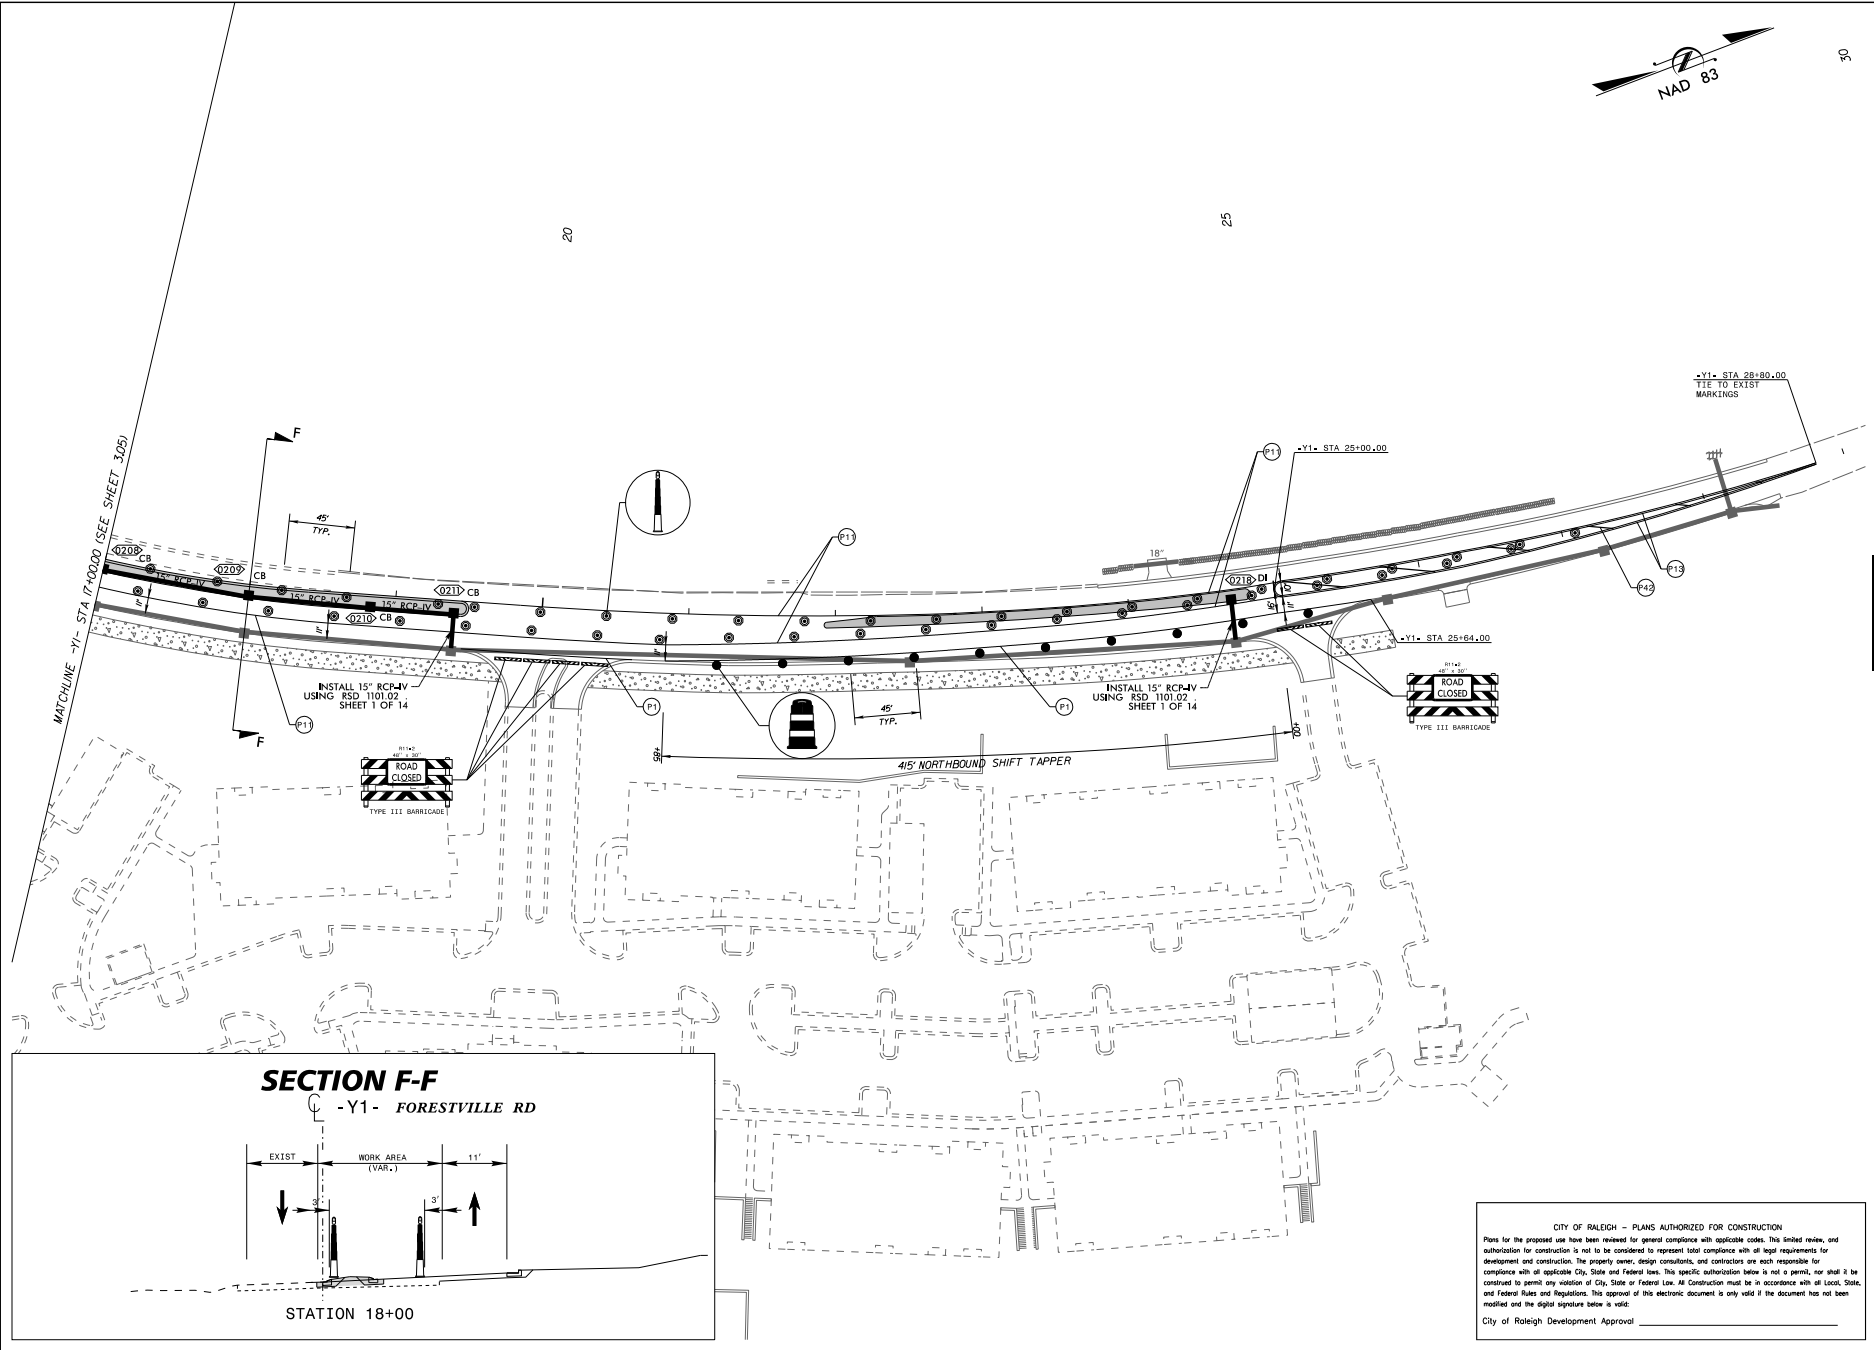

30


Kimley»Horn		© 2022 421 FAYETTEVILLE STREET, SUITE 600, RALEIGH, NC 27601 PHONE: 919-877-2000 FAX: 919-877-2050 WWW.KIMLEY-HORN.COM NC LICENSE # F-002	
TRAFFIC MANAGEMENT PLAN PHASE II		SOLIS BUFFALO OFFSITE ROADWAY	
NORTH CAROLINA		RALEIGH	
SHEET NUMBER R3.06		DATE BY	
REVISIONS		No.	
KHA PROJECT 07222020		KHA DATE 5/24/2023	
SCALE NTS		DESIGNED BY EP	
DRAWN BY EP		CHECKED BY BY	

CITY OF RALEIGH - PLANS AUTHORIZED FOR CONSTRUCTION

Plans for the proposed use have been reviewed for general compliance with applicable codes. This limited review, and authorization for construction is not to be considered to represent total compliance with all legal requirements for development and construction. The property owner, design consultants, and contractors are each responsible for compliance with all applicable City, State and Federal laws. This specific authorization below is not a permit, nor shall it be construed to permit any violation of City, State or Federal Law. All Construction must be in accordance with all Local, State, and Federal Rules and Regulations. This approval of this electronic document is only valid if the document has not been modified and the digital signature below is valid:

City of Raleigh Development Approval _____



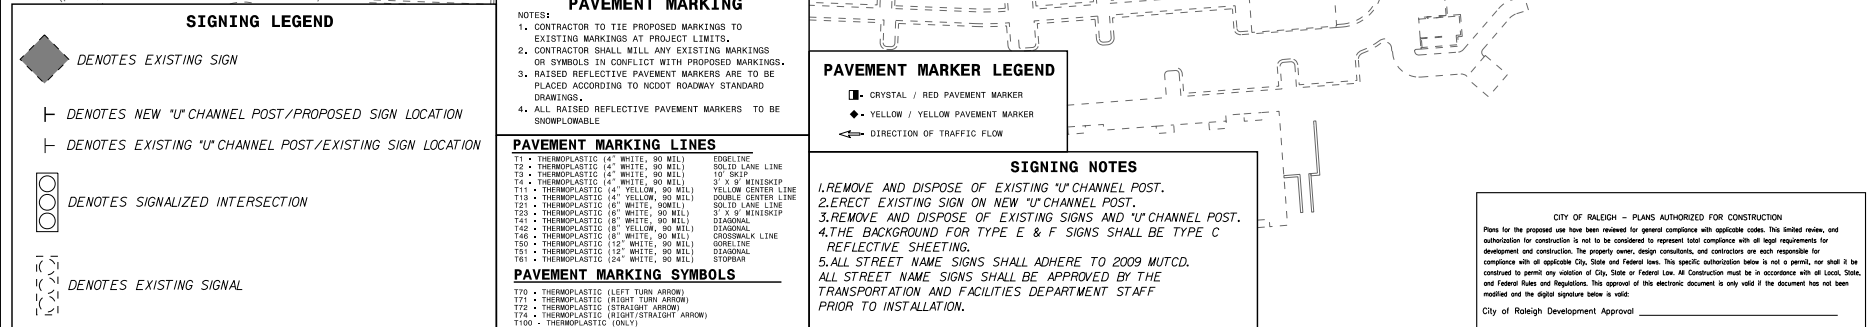


CITY OF RALEIGH – PLANS AUTHORIZED FOR CONSTRUCTION

Plans for the proposed use have been reviewed for general compliance with applicable codes. This limited review, and authorization for construction is not to be considered to represent total compliance with all legal requirements for development and construction. The property owner, design consultants, and contractors are each responsible for compliance with all applicable City, State and Federal laws. This specific authorization is not a permit, nor shall it be construed to permit any violation of City, State or Federal Law. No Construction must be in accordance with all Local, State, and Federal Rules and Regulations. This approval of this electronic document is only valid if the document has not been modified and the digital signature below is valid:


City of Raleigh Development Approval _____

- NOTES**
- 1 WHEELCHAIR RAMP LOCATIONS ARE APPROXIMATE ONLY. WHEELCHAIR RAMPS SHOULD BE LOCATED AND CONSTRUCTED IN ACCORDANCE WITH THE CITY OF RALEIGH AND NCDOT STANDARDS AFTER THE LOCATIONS OF THE PROPOSED STOP BARS AND/OR PEDESTRIAN CROSSWALKS HAVE BEEN STAKED OUT.**
 - 2 ALL SIGNS SHALL USE PRISMATIC SHEETING THAT MEETS MINIMUM RETRO REFLECTIVITY STANDARDS FOUND IN THE LATEST EDITION OF THE MUTCD.**
 - 3 INSTALL TYPE N-1 DIRECTIONAL RAMP SEE DETAIL SHEET R1.04**
 - 4 INSTALL PEDESTRIAN REFUGE SEE DETAIL SHEET R1.05**



SHEET NUMBER R4.01		SOLIS BUFFALO OFFSITE ROADWAY		PAVEMENT MARKING AND SIGNING PLAN		KHA PROJECT DATE SCALE DESIGNED BY: NTS DRAWN BY: EP CHECKED BY: BV		 © 2022 421 FAYETTEVILLE STREET, SUITE 600, RALEIGH, NC 27601 PHONE 919-487-2000 FAX 919-487-2050 WWW.KIMLEY-HORN.COM NC LICENSE # F-1022		No. _____ REVISIONS _____ DATE _____ BY _____	
------------------------------	--	----------------------------------	--	--------------------------------------	--	--	--	--	--	--	--

5/24/2023 K:\P\L\2022\07222020 - BUF 1008 RD UT Signalizing Proj\07222020\2023\07222020.dwg

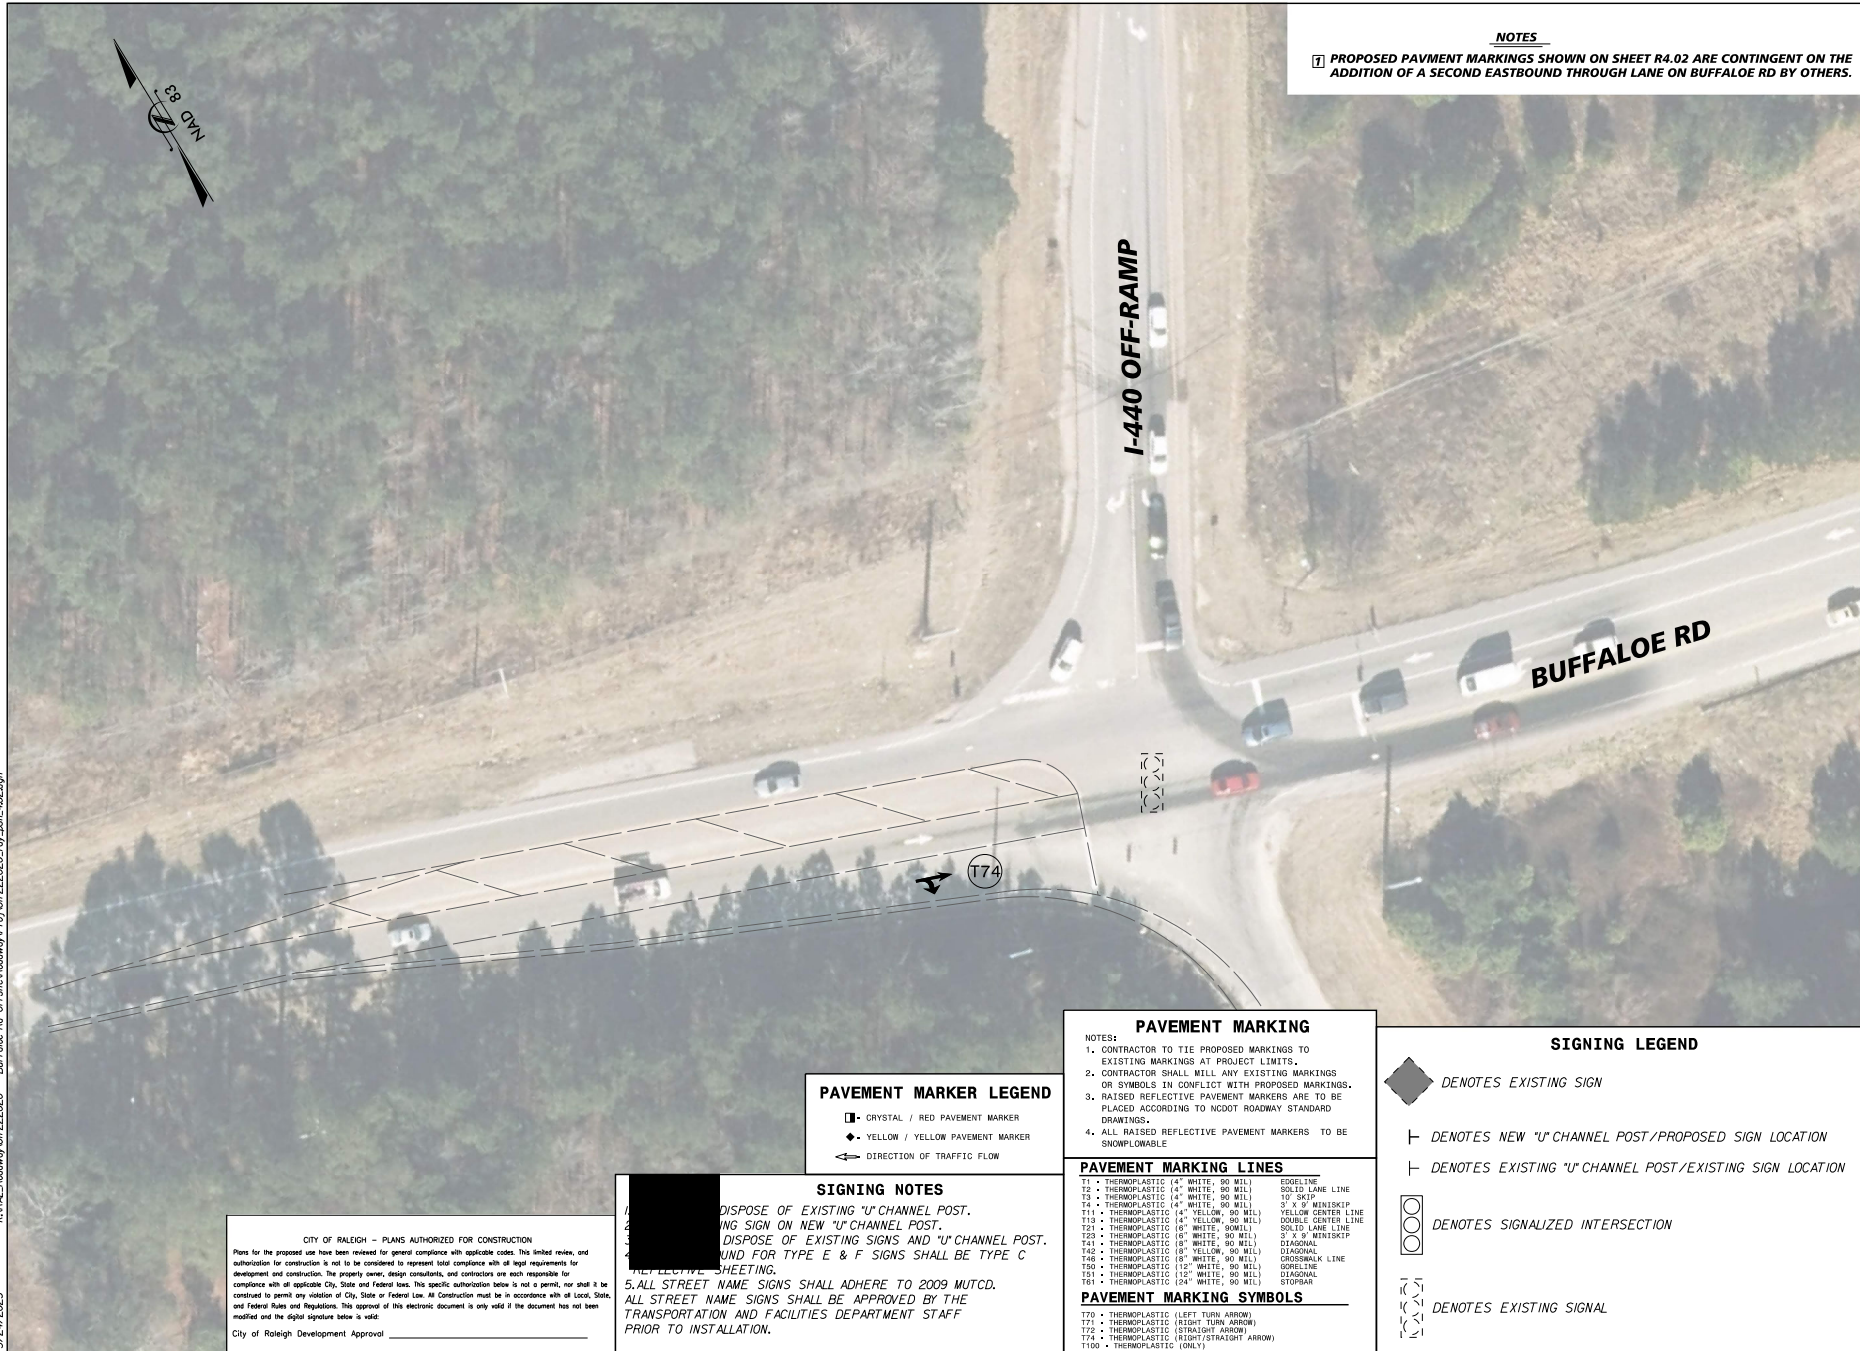

CITY OF RALEIGH - PLANS AUTHORIZED FOR CONSTRUCTION
Plans for the proposed use have been reviewed for general compliance with applicable codes. This limited review, and authorization for construction is not to be considered to represent total compliance with all legal requirements for development and construction. The property owner, design consultants, and contractors are each responsible for compliance with all applicable City, State and Federal laws. This specific authorization below is not a permit, nor shall it be construed to permit any violation of City, State or Federal Law. All Construction must be in accordance with all Local, State, and Federal Rules and Regulations. This approval of this electronic document is only valid if the document has not been modified and the digital signature below is valid.
City of Raleigh Development Approval _____

SIGNING NOTES
1. DISPOSE OF EXISTING "U" CHANNEL POST.
2. INSTALL NEW "U" CHANNEL POST.
3. DISPOSE OF EXISTING SIGNS AND "U" CHANNEL POST.
4. INSTALL NEW SIGNS AND "U" CHANNEL POST.
5. ALL STREET NAME SIGNS SHALL ADHERE TO 2009 MUTCD.
6. ALL STREET NAME SIGNS SHALL BE APPROVED BY THE TRANSPORTATION AND FACILITIES DEPARTMENT STAFF PRIOR TO INSTALLATION.

PAVEMENT MARKER LEGEND
■ CRYSTAL / RED PAVEMENT MARKER
◆ YELLOW / YELLOW PAVEMENT MARKER
→ DIRECTION OF TRAFFIC FLOW

PAVEMENT MARKING
NOTES:
1. CONTRACTOR TO TIE PROPOSED MARKINGS TO EXISTING MARKINGS AT PROJECT LIMITS.
2. CONTRACTOR SHALL WEAR ANY EXISTING MARKINGS OR SYMBOLS IN CONFLICT WITH PROPOSED MARKINGS.
3. RAISED REFLECTIVE PAVEMENT MARKERS ARE TO BE PLACED ACCORDING TO NCOTD ROADWAY STANDARD DRAWINGS.
4. ALL RAISED REFLECTIVE PAVEMENT MARKERS TO BE SNOWFLOWABLE.

PAVEMENT MARKING LINES
T1 • THERMOPLASTIC (4" WHITE, 90 WLL) EDGE LINE
T2 • THERMOPLASTIC (4" WHITE, 90 WLL) SOLID LANE LINE
T3 • THERMOPLASTIC (4" WHITE, 90 WLL) 10' SKT
T4 • THERMOPLASTIC (4" WHITE, 90 WLL) 3' X 6' WALKER
T11 • THERMOPLASTIC (4" YELLOW, 90 WLL) YELLOW CENTER LINE
T12 • THERMOPLASTIC (4" YELLOW, 90 WLL) DOUBLE CENTER LINE
T21 • THERMOPLASTIC (6" WHITE, 90 WLL) SOLID LANE LINE
T22 • THERMOPLASTIC (6" WHITE, 90 WLL) 3' X 6' WALKER
T41 • THERMOPLASTIC (8" WHITE, 90 WLL) DIAGONAL
T42 • THERMOPLASTIC (8" YELLOW, 90 WLL) DIAGONAL
T46 • THERMOPLASTIC (8" WHITE, 90 WLL) CROSSWALK LINE
T50 • THERMOPLASTIC (12" WHITE, 90 WLL) GORE LINE
T51 • THERMOPLASTIC (12" WHITE, 90 WLL) DIAGONAL
T52 • THERMOPLASTIC (24" WHITE, 90 WLL) STOPBAR

PAVEMENT MARKING SYMBOLS
T70 • THERMOPLASTIC (LEFT TURN ARROW)
T71 • THERMOPLASTIC (RIGHT TURN ARROW)
T72 • THERMOPLASTIC (STRAIGHT ARROW)
T74 • THERMOPLASTIC (RIGHT/STRAIGHT ARROW)
T100 • THERMOPLASTIC (ONLY)


SIGNING LEGEND
◆ DENOTES EXISTING SIGN
└ DENOTES NEW "U" CHANNEL POST/PROPOSED SIGN LOCATION
└ DENOTES EXISTING "U" CHANNEL POST/EXISTING SIGN LOCATION
◻◻◻◻ DENOTES SIGNALIZED INTERSECTION
└└└└ DENOTES EXISTING SIGNAL

NOTES
1. PROPOSED PAVEMENT MARKINGS SHOWN ON SHEET R4.02 ARE CONTINGENT ON THE ADDITION OF A SECOND EASTBOUND THROUGH LANE ON BUFFALOE RD BY OTHERS.

KHA PROJECT 07/22/2020		DATE 5/24/2023		SCALE NTS		DESIGNED BY EP		DRAWN BY EP		CHECKED BY BY	
PAVEMENT MARKING AND SIGNAGE PLAN		NORTH CAROLINA		SHEET NUMBER R4.02		RALEIGH		KIMLEY-HORN		NO. _____	
SOLIS BUFFALOE OFFSITE ROADWAY		DATE 5/24/2023		REVISIONS		BY		DATE		BY	

© 2023
421 FAYETTEVILLE STREET, SUITE 600, RALEIGH, NC 27601
PHONE: 919-876-2000 FAX: 919-877-2050
WWW.KIMLEY-HORN.COM
NC LICENSE # F-0102

5/24/2023 K:\3dL_Roadway\07222020 - Buffalo Rd Offsite Erosion Control\PS\07222020.dwg EC_Layout

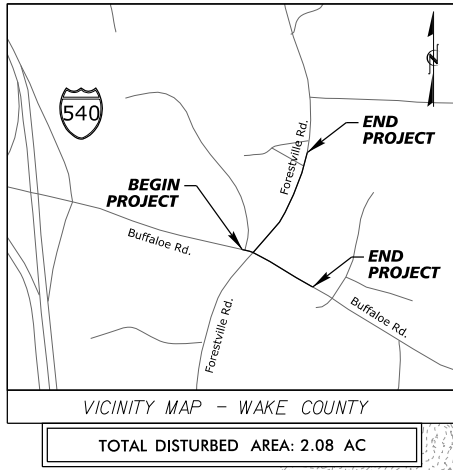

SOLIS BUFFALOE

OFFSITE ROADWAY EROSION CONTROL PLAN

LOCATION: FROM THE INTERSECTION OF BUFFALOE RD AND FORESTVILLE RD
EXTENDING 1,700' NORTH ON FORESTVILLE RD AND
825' EAST ON BUFFALOE RD



Kimley»Horn

© 2022
421 FAYETTEVILLE STREET, SUITE 600, RALEIGH, NC 27601
PHONE: 919.486.7777 FAX: 919.486.7777
WWW.KIMLEY-HORN.COM
NC LICENSE # F-0102

EROSION CONTROL
TITLE SHEET

SOLIS BUFFALOE
OFFSITE ROADWAY

SHEET NUMBER
R5.00

RALEIGH

NORTH CAROLINA


EROSION CONTROL
TITLE SHEET

Kimley»Horn


© 2022
421 FAYETTEVILLE STREET, SUITE 600, RALEIGH, NC 27601
PHONE: 919.486.7777 FAX: 919.486.7777
WWW.KIMLEY-HORN.COM
NC LICENSE # F-0102

DATE BY


5/24/2023 K:\RAL_Roadway\07222020 - Buf Trace Rd Offsite Erosion Control\PS\NOT222020_rdy_dwg_501.dwg

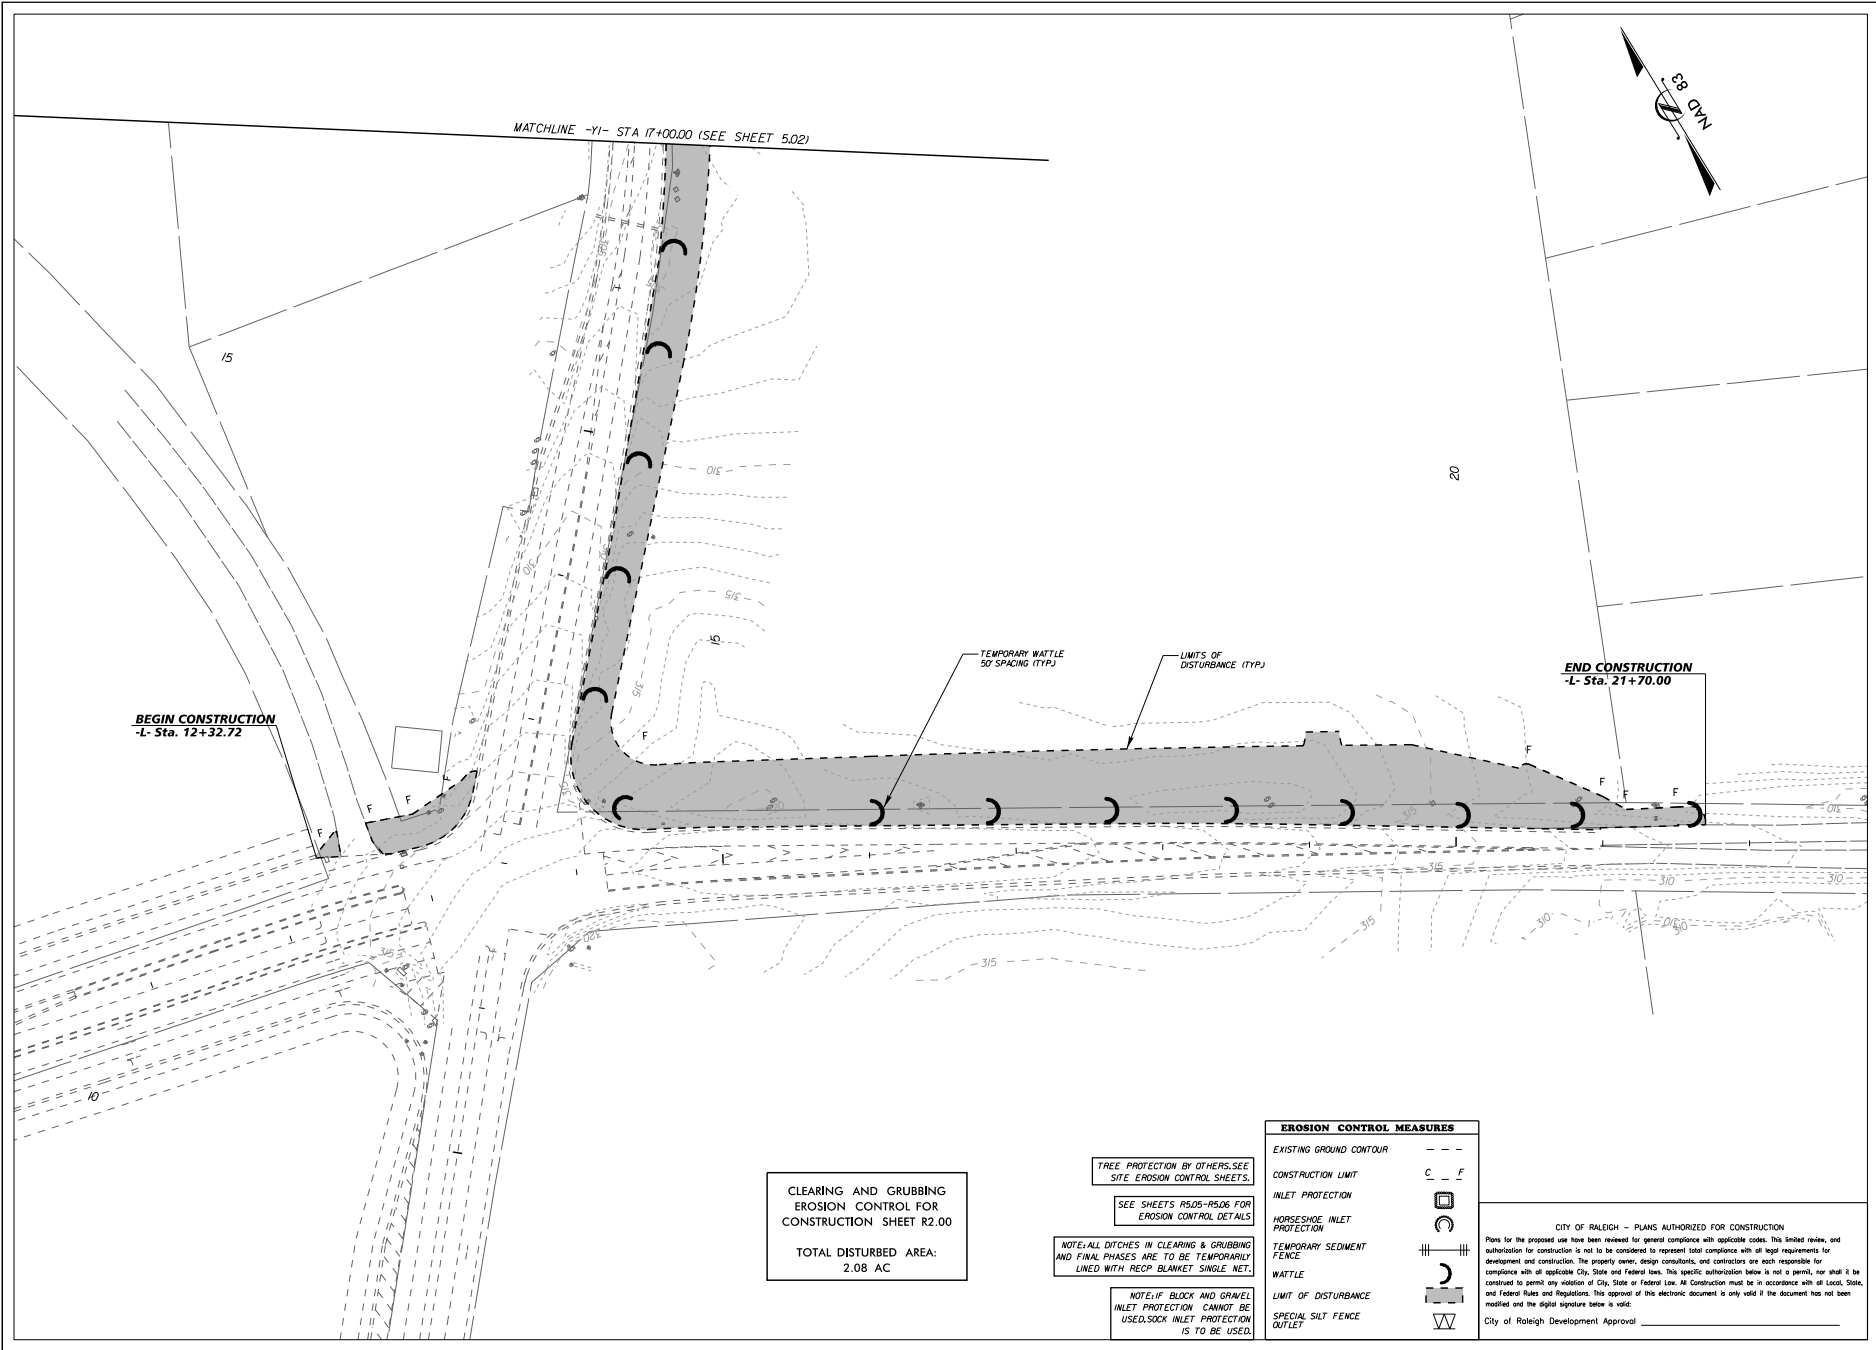

KIMLEY HORN		KIMLEY HORN		KIMLEY HORN	
421 FAYETTEVILLE STREET, SUITE 600, RALEIGH, NC 27601		421 FAYETTEVILLE STREET, SUITE 600, RALEIGH, NC 27601		421 FAYETTEVILLE STREET, SUITE 600, RALEIGH, NC 27601	
PHONE: 919-877-2000 FAX: 919-877-2000		PHONE: 919-877-2000 FAX: 919-877-2000		PHONE: 919-877-2000 FAX: 919-877-2000	
NC LICENSE # F-0102		NC LICENSE # F-0102		NC LICENSE # F-0102	
PROJECT NO.		PROJECT NO.		PROJECT NO.	
DATE		DATE		DATE	
BY		BY		BY	
CHECKED BY		CHECKED BY		CHECKED BY	
DESIGNED BY		DESIGNED BY		DESIGNED BY	
SCALE		SCALE		SCALE	
5/24/2023		5/24/2023		5/24/2023	
KIMLEY HORN		KIMLEY HORN		KIMLEY HORN	
EROSION CONTROL		EROSION CONTROL		EROSION CONTROL	
SOLIS BUFFALO OFFSITE ROADWAY		SOLIS BUFFALO OFFSITE ROADWAY		SOLIS BUFFALO OFFSITE ROADWAY	
NORTH CAROLINA		NORTH CAROLINA		NORTH CAROLINA	
RALEIGH		RALEIGH		RALEIGH	
SHEET NUMBER		SHEET NUMBER		SHEET NUMBER	
R5.01		R5.01		R5.01	

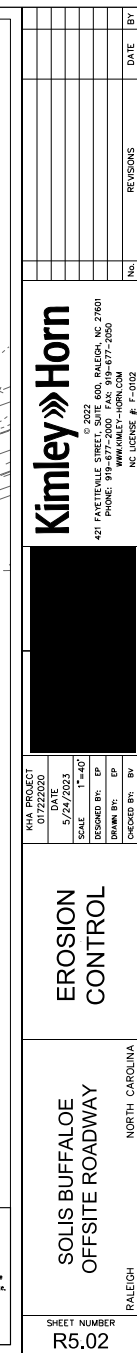

5/24/2023 K:\RAL_Roadway\07222020 - Bu\1000 Rd OffsiteErosion Control\PS\07222020_rly_dwg_504.dgn

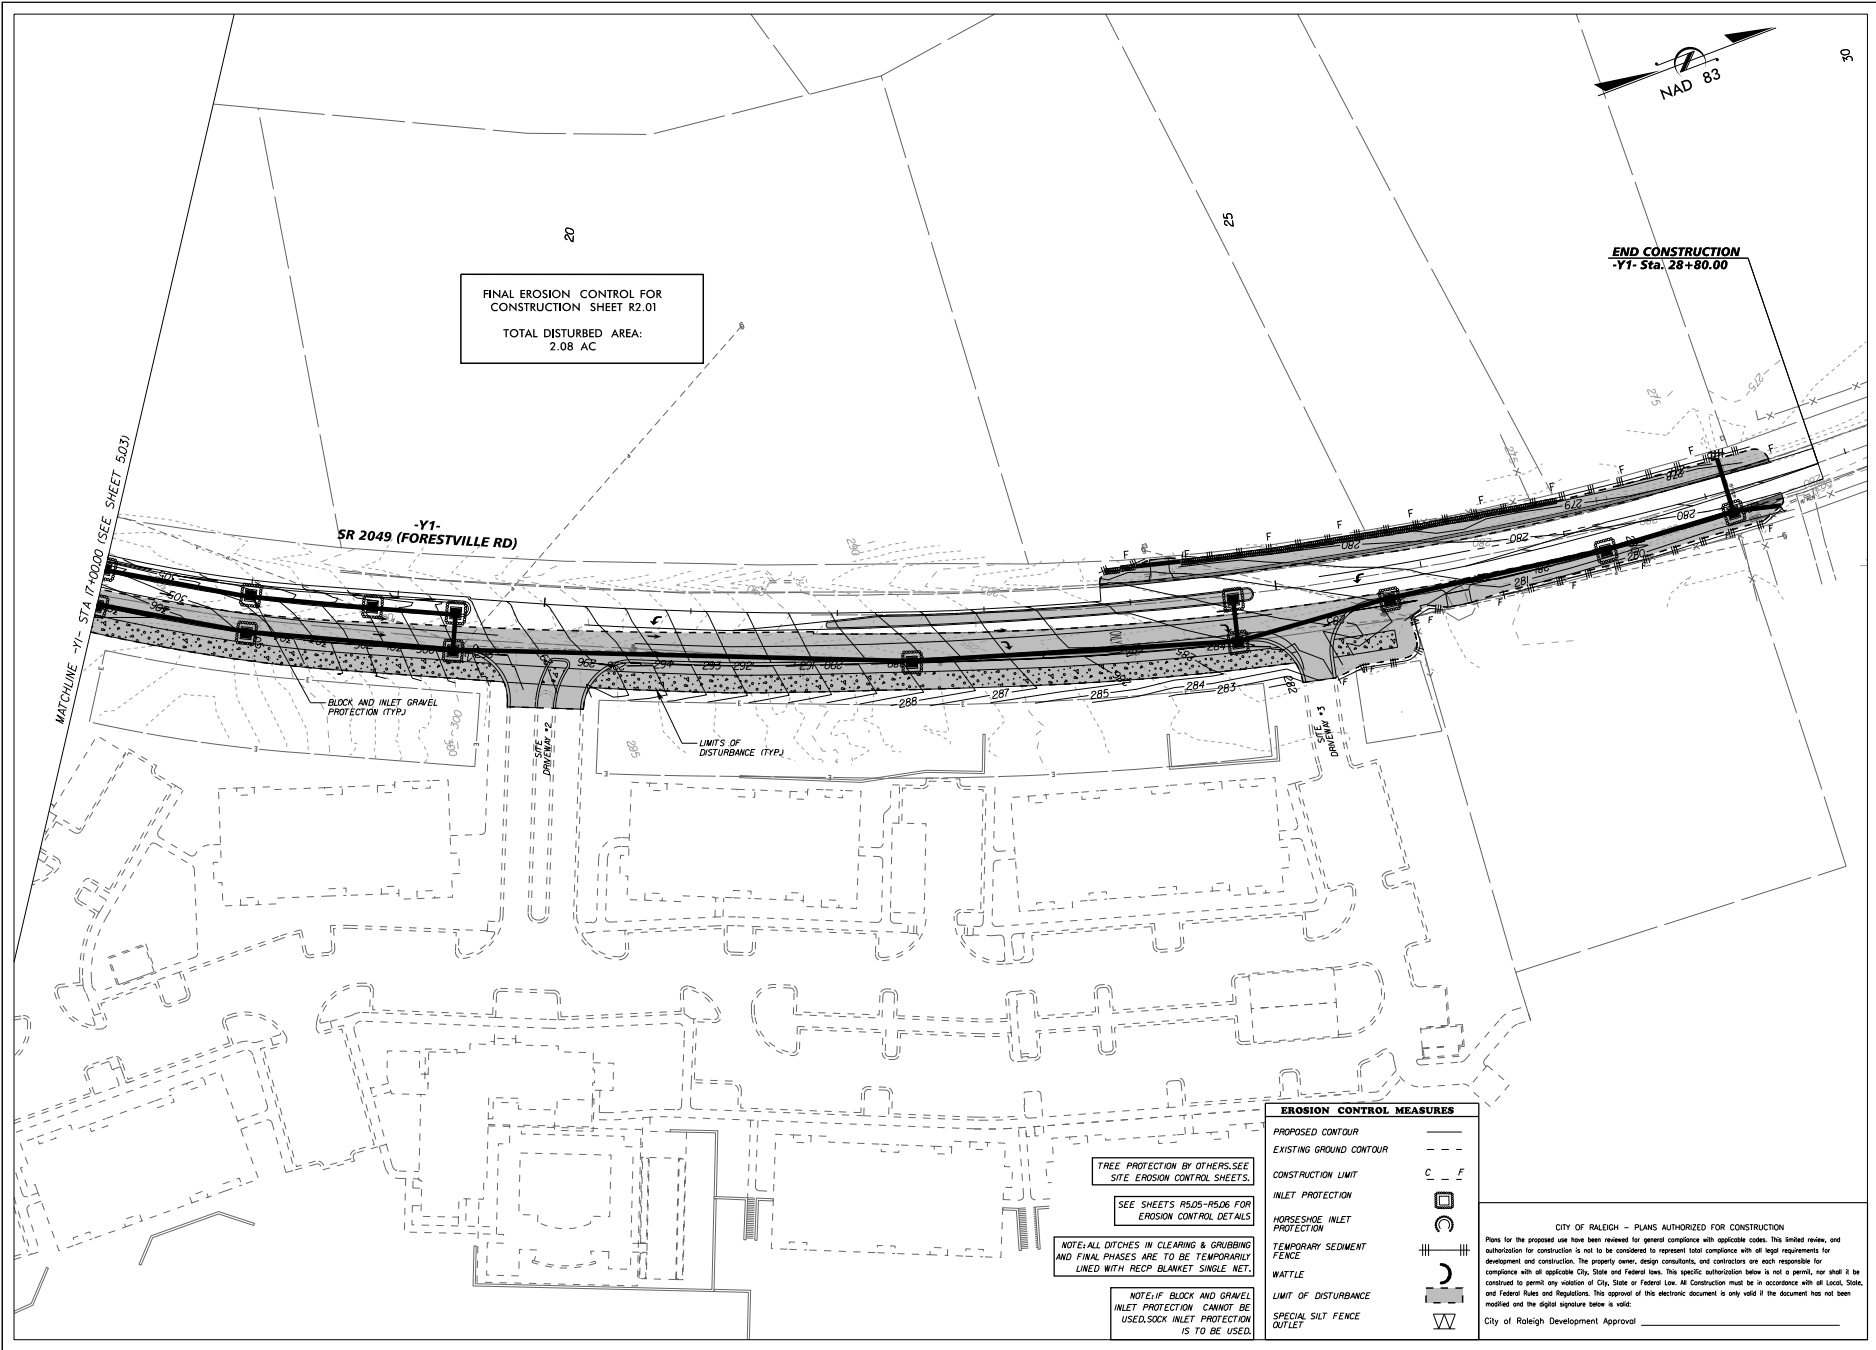

KHA PROJECT		KHA PROJECT	
DATE	5/24/2023	DATE	5/24/2023
SCALE	1"=40'	SCALE	1"=40'
DESIGNED BY	EP	DESIGNED BY	EP
DRAWN BY	EP	DRAWN BY	EP
CHECKED BY	BY	CHECKED BY	BY

Kimley»Horn

© 2023
421 FAYETTEVILLE STREET, SUITE 600, RALEIGH, NC 27601
PHONE: 919-877-2000 FAX: 919-877-2050
WWW.KIMLEY-HORN.COM
NC LICENSE # F-002

EROSION CONTROL

SOLIS BUFFALO OFFSITE ROADWAY

NORTH CAROLINA

R5.04

5/24/2023 K:\RAL_Planbook\07222620 - Buffave Rd. Offsite\Erosion Control\PS\0407222620_07_04b_000_001.dwg

CONSTRUCTION SEQUENCE		VEGETATION PLAN (NCDENR 6J1)		TOPSOILING (6.04)																																																																										
CONSTRUCTION SPECIFICATIONS 1. Request preconstruction meeting. 2. Obtain grading permits. 3. Install all erosion control measures as shown. 4. Obtain certificate of compliance through on-site inspection by Erosion Control Officer. 5. Proceed with grading. 6. Clean sediment basins when one-half full. 7. Seed and mulch denuded area within 15 days or duration shown on ground stabilization requirements, whichever is shorter, after any phase of grading. 8. Maintain soil erosion control measures until permanent ground cover is established. 9. Request final approval by Erosion Control Officer. 10. Remove soil erosion control measures and stabilize these areas.		SEEDING AND MULCHING The kinds of seed and fertilizer, and the rates of application of seed, fertilizer, and limestone shall be as stated below. During periods of overlapping dates, the kind of seed to be used shall be determined by the Engineer. <table><tr><th>Date</th><th>Type</th><th>Planting Rate</th></tr><tr><td>Mar.-1-Aug. 31</td><td>Tall Fescue Centipede Unimulched Common Bermudagrass Fertilizer Limestone</td><td>50 lbs./acre 15 lbs./acre 25 lbs./acre 4000 lbs./acre 500 lbs./acre</td></tr><tr><td>Sept.-1-Feb. 28</td><td>Tall Fescue Centipede Unimulched Common Bermudagrass Fertilizer Limestone</td><td>50 lbs./acre 15 lbs./acre 35 lbs./acre 500 lbs./acre 4000 lbs./acre</td></tr></table> Slopes (2:1 and steeper) and Waste & Borrow Locations <table><tr><th>Date</th><th>Type</th><th>Planting Rate</th></tr><tr><td>Jan.-1-Dec. 31</td><td>Tall Fescue Unimulched Common Bermudagrass Fertilizer Limestone</td><td>75 lbs./acre 35 lbs./acre 500 lbs./acre 4000 lbs./acre</td></tr></table> Approved Tall Fescue Cultivars <table><tr><td>Adventure</td><td>Adventure II</td><td>Amigo</td><td>Anthem</td></tr><tr><td>Apache</td><td>Apache II</td><td>Arlo</td><td>Austin</td></tr><tr><td>Bankston</td><td>Bananza</td><td>Bananza II</td><td>Chapel Hill</td></tr><tr><td>Chesapeake</td><td>Cherifain</td><td>Cherifain II</td><td>Crossfire II</td></tr><tr><td>Madison</td><td>Falcon</td><td>Falcon II</td><td>Falcon</td></tr><tr><td>Firetown Petite</td><td>Firetown</td><td>Firetown I</td><td>Genesis</td></tr><tr><td>Self-inspection</td><td>Firetown</td><td>Firetown II</td><td>Genesis</td></tr><tr><td>Jaguar</td><td>Jaguar III</td><td>Kentucky 31</td><td>Kitty</td></tr><tr><td>Monarch</td><td>Monarch</td><td>Musgrave</td><td>Olympic</td></tr><tr><td>Pacer</td><td>Pacer</td><td>Pacer</td><td>Pacer</td></tr><tr><td>Rabel Jr.</td><td>Rabel Jr.</td><td>Rabel II</td><td>Reneade</td></tr><tr><td>Chenopodium</td><td>Chenopodium</td><td>Titan</td><td>Titan</td></tr><tr><td>Tombawk</td><td>Tombawk</td><td>Tribute</td><td>Vegas</td></tr><tr><td>Wolfpack</td><td>Wolfpack</td><td>Wrange</td><td></td></tr></table> SEEDING AND MULCHING On cut and fill slopes 2:1 or steeper, add 30P (23kg) Sericea Lespedeza January 1-December 31. Fertilizer shall be 10-20-20 analysis. Upon written approval of the Engineer, a different analysis of fertilizer may be used provided the 1-2-2 ratio is maintained and the rate of application adjusted to provide the same amount of plant food as a 10-20-20 analysis.		Date	Type	Planting Rate	Mar.-1-Aug. 31	Tall Fescue Centipede Unimulched Common Bermudagrass Fertilizer Limestone	50 lbs./acre 15 lbs./acre 25 lbs./acre 4000 lbs./acre 500 lbs./acre	Sept.-1-Feb. 28	Tall Fescue Centipede Unimulched Common Bermudagrass Fertilizer Limestone	50 lbs./acre 15 lbs./acre 35 lbs./acre 500 lbs./acre 4000 lbs./acre	Date	Type	Planting Rate	Jan.-1-Dec. 31	Tall Fescue Unimulched Common Bermudagrass Fertilizer Limestone	75 lbs./acre 35 lbs./acre 500 lbs./acre 4000 lbs./acre	Adventure	Adventure II	Amigo	Anthem	Apache	Apache II	Arlo	Austin	Bankston	Bananza	Bananza II	Chapel Hill	Chesapeake	Cherifain	Cherifain II	Crossfire II	Madison	Falcon	Falcon II	Falcon	Firetown Petite	Firetown	Firetown I	Genesis	Self-inspection	Firetown	Firetown II	Genesis	Jaguar	Jaguar III	Kentucky 31	Kitty	Monarch	Monarch	Musgrave	Olympic	Pacer	Pacer	Pacer	Pacer	Rabel Jr.	Rabel Jr.	Rabel II	Reneade	Chenopodium	Chenopodium	Titan	Titan	Tombawk	Tombawk	Tribute	Vegas	Wolfpack	Wolfpack	Wrange		APPLYING AND COVERING LIMESTONE, FERTILIZER, AND SEED B) LIMESTONE AND FERTILIZER: Limestone may be applied as a part of the seedbed preparation, provided it is immediately worked into the soil. If not so applied, limestone and fertilizer shall be distributed uniformly over the prepared seedbed at the specified rate of application and then harrowed, raked, or otherwise thoroughly worked or mixed into the seedbed. If liquid fertilizer is used, storage containers for the liquid fertilizer shall be located on the project and shall be equipped for application of the liquid prior to its use. The storage containers shall be equipped with approved metering and/or metering devices which will enable the Engineer to record at any time the amount of liquid that has been removed from the container. Application equipment for liquid fertilizer, other than a hydraulic seeder, shall be calibrated to ensure that the required rate of fertilizer is applied uniformly. C) SEED: Seed shall be distributed uniformly over the seedbed at the required rate of application and immediately harrowed, dragged, raked, or otherwise worked so as to over the seed with a layer of soil. The depth of covering shall be as directed by the Engineer. If 2 kinds of seed are to be used which require different depths of covering, they shall be sown separately. When a combination seed and fertilizer drill is used, seed and fertilizer may be drilled into the soil at the same time as has been applied and worked into the soil. If 2 kinds of seed are being used which require different depth of covering, the seed requiring the lighter covering may be sown broadcast or with a special attachment to the drill, or drilled lightly following the initial drilling operation. When a hydraulic seeder is used for application of seed and fertilizer, the seed shall not remain in water containing fertilizer for more than 30 minutes prior to application unless otherwise permitted by the Engineer. Immediately after seed has been properly covered the seedbed shall be compacted. In the manner and degree approved by the Engineer.		CONSTRUCTION SPECIFICATIONS MATERIALS Determine whether the quality and quantity of available topsoil justifies selective handling. Quality topsoil has the following characteristics: Texture - loam, sandy loam, and silt loam are best; sandy clay loam, silty clay loam, clay loam, and loamy sand are fair. Do not use heavy clay and organic soils such as peat or muck as topsoil. Organic matter content - (sometimes referred to as "humic matter") should be greater than 1.5% by weight. Acidity - pH should be greater than 3.6 before liming, and liming is required if it is less than 6.0. Soluble salts - should be less than 500 ppm. Sodium - sodium adsorption ratio should be less than 12. The depth of material meeting the above qualifications should be at least 2 inches. Soil factors such as rust, iron, manganese, and other staining and layer thickness affect the ease of excavation and spreading of topsoil. Generally, the upper part of the soil, which is richest in organic matter, is most desirable; however, material excavated from deeper layers may be worth storing if it meets the other criteria listed above. Organic soils such as mucks and peats do not make good topsoil. They can be identified by their extremely light weight when dry. STRIPPING Strip topsoil only from those areas that will be disturbed by excavation, filling, roadbuilding, or compaction by equipment. A 4 to 6-inch stripping depth is common, but depth varies depending on the site. Determine depth of stripping by taking soil cores at several locations within each area to be stripped. Fossil depth generally varies along a gradient from hilltop to toe of the slope. Put sediment basins, erosion controls, and other controls into place before stripping. STOCKPILING Select stockpile location to avoid slopes and natural drainage ways, avoiding traffic routes, on large sites, respreading is easier and more economical when topsoil is stockpiled in small piles located near areas where they will be used. If excessive erosion is likely, stockpiles should be stabilized with grass and seed. Sediment barriers - Use sediment fences or other barriers where necessary to retain sediment.	
Date	Type	Planting Rate																																																																												
Mar.-1-Aug. 31	Tall Fescue Centipede Unimulched Common Bermudagrass Fertilizer Limestone	50 lbs./acre 15 lbs./acre 25 lbs./acre 4000 lbs./acre 500 lbs./acre																																																																												
Sept.-1-Feb. 28	Tall Fescue Centipede Unimulched Common Bermudagrass Fertilizer Limestone	50 lbs./acre 15 lbs./acre 35 lbs./acre 500 lbs./acre 4000 lbs./acre																																																																												
Date	Type	Planting Rate																																																																												
Jan.-1-Dec. 31	Tall Fescue Unimulched Common Bermudagrass Fertilizer Limestone	75 lbs./acre 35 lbs./acre 500 lbs./acre 4000 lbs./acre																																																																												
Adventure	Adventure II	Amigo	Anthem																																																																											
Apache	Apache II	Arlo	Austin																																																																											
Bankston	Bananza	Bananza II	Chapel Hill																																																																											
Chesapeake	Cherifain	Cherifain II	Crossfire II																																																																											
Madison	Falcon	Falcon II	Falcon																																																																											
Firetown Petite	Firetown	Firetown I	Genesis																																																																											
Self-inspection	Firetown	Firetown II	Genesis																																																																											
Jaguar	Jaguar III	Kentucky 31	Kitty																																																																											
Monarch	Monarch	Musgrave	Olympic																																																																											
Pacer	Pacer	Pacer	Pacer																																																																											
Rabel Jr.	Rabel Jr.	Rabel II	Reneade																																																																											
Chenopodium	Chenopodium	Titan	Titan																																																																											
Tombawk	Tombawk	Tribute	Vegas																																																																											
Wolfpack	Wolfpack	Wrange																																																																												
MAINTENANCE Follow the construction sequence throughout project development. When changes in construction activities are needed, amend the sequence schedule in advance to maintain management control. Notification of Land Resources Sediment and Erosion Control Self-inspection Program The Sedimentation Pollution Control Act was amended in 2006 to require that persons responsible for land-disturbing activities inspect a project after each phase of the project to make sure that the approved erosion and sedimentation control plan is being followed. Details detailing the documentation of these inspections are included in the Self-inspection Program. The Self-inspection program is separate from the weekly self-monitoring program of the NPDES Stormwater Permit for Construction Activities. The focus of the self-inspection report is the installation and maintenance of erosion and sedimentation control measures according to the approved plan. The inspections must be conducted after each phase of the project and continue until permanent ground cover is established. In accordance with NCGS 114A-54 and 114A-62, the Self-inspection Report Form is available on an Excel spreadsheet from http://portal.ncdenr.gov/web/r/erosion/ . If you have questions or cannot access the form, please contact NC DENR Division of Land Resources at (919) 791-4200.		SEEDBED PREPARATION The Contractor shall cut and satisfactorily dispose of weeds or other unacceptable growth on the areas to be seeded. Unweeded and rough areas outside of the graded section, such as crop rows, farm contours, ditches, and ditch spoil banks, fence line and hedgerow soil accumulations, and other minor irregularities which cannot be obliterated by normal seedbed preparation operations, shall be shaped and smoothed as directed by the Engineer to provide for more effective seeding and for ease of subsequent mowing operations. The soil shall then be scarified or otherwise loosened to a depth of not less than 5 inches except as otherwise provided below. The depth of loosening shall be broken and the top 2 to 3 inches of soil shall be worked into an acceptable seedbed by the use of soil pulverizers, dropspreader harrows or by other methods approved by the Engineer. All rock and debris 3 inches or larger shall be removed on median, shoulders, and ditch cut or fill slopes which are 3:1 or flatter, prior to the application of seed and fertilizer. On cut slopes that are 2:1 and steeper, both the depth of preparation and the degree of smoothness of the seedbed may be reduced as permitted by the Engineer, but in all cases the slope surface shall be scarified, grooved, trenched, or punctured so as to provide pockets, ridges, or trenches in which the seedling materials can lodge. Contractor shall be responsible for providing the required seed bed. It may be necessary to seed these sections with a hydro-seed. On cut slopes that are either 2:1 or steeper, the Engineer may permit the preparation of a partial or complete seedbed during the grading of the slope. If, at the time of seeding and mulching operations such preparation is still in a condition acceptable to the Engineer, additional seedbed preparation may be reduced or eliminated. Seedbed preparation within 2 feet of the edge of any pavement shall be limited to a depth of 2 to 3 inches. The preparation of seedbeds shall not be done when the soil is frozen, extremely wet, or when the Engineer determines that it is an otherwise unfavorable working condition.		RIP RAP (6J5) CONSTRUCTION SPECIFICATIONS Subgrade Preparation - Prepare the subgrade for riprap and filter to the required lines and grades shown on the plans, compact any fill required in the subgrade to a density approximating that of the surrounding undisturbed material of overfill depressions within riprap. Remove brush, stumps, and other objectionable material. Cut the subgrade sufficiently deep that the finished grade of the riprap will be at the elevation of the surrounding area. Channels should be excavated sufficiently to allow placement of the riprap in manner such that the finished inside dimensions and grade of the riprap meet design specifications. Sand and gravel filter blanket - Place the filter blanket immediately after the ground foundation is prepared. For gravel spread, filter stone in a uniform layer to the specified depth. Where more than one layer of filter material is used, spread the layers with minimal mixing. Synthetic Filter Fabric - Place the filter fabric directly on the prepared foundation. Overlap the edges by at least 12 inches, and space anchor pins every 3 ft along the edges. Bury the upstream end of the cloth a minimum of 12 inches below ground and where necessary, bury the lower end of the cloth or overlap with the placement. Place riprap to its full thickness in one operation. Do not place riprap by dumping through chutes or other methods that cause segregation of stone sizes. Take care not to dislodge the underlying base or filter when placing the stones. The finished slope shall be free of pockets of small stone or clusters of large stones. Hand placing may be necessary to achieve the proper distribution of stone sizes to produce a relatively smooth uniform surface. The finished grade of the riprap should blend with the surrounding area. No overfill or protrusion of riprap should be apparent. MAINTENANCE Inspected channels at regular intervals as well as after major rains, and make repairs promptly. Give special attention to the outlet and inlet sections and other points where concentrated flow enters. Carefully check stability at road crossings and look for indications of piping, scour holes, or bank failures. Make repairs immediately. Maintain all appurtenances adjacent to the channel in a healthy, vigorous condition to protect the area from erosion and scour during out-of-bank flow. Control of weed and brush growth may be needed in some locations.																																																																										
MAINTENANCE PLAN 1. The Contractor shall inspect all erosion and sediment control practices for stability and operation within 24 hours following every runoff producing 0.5 inch rainfall (in a 24 hour period) but in no case less than once every week. Any needed repairs will be made immediately by the Contractor to maintain all practices as designed. Also per National Pollutant Discharge Elimination System (NPDES) general stormwater permit, a rain gauge must be installed on site. The rain gauge must be installed on site and inspected by the Contractor must be made and logged after every half inch of rainfall and once a week. 2. The Contractor shall remove sediment from sediment basin when storage capacity has been approximately 50% filled. Gravel will be cleaned or replaced when the sediment pool no longer drains properly. 3. The Contractor shall remove sediment from behind silt fence when it becomes 0.5 feet deep or when the silt fence, silt fence will be repaired as necessary to maintain a barrier. 4. The Contractor shall fertilize, reseed as necessary, and mulch all seeded areas according to specifications in the vegetative plan to maintain a vigorous, dense vegetative cover. 5. The Contractor must inspect all outlets where stormwater runoff leaves the site and evaluate the effect on nearby streams or wetlands. Corrective action must be taken if sediment is deposited off site or into stream or wetland, or causes a visible increase in turbidity of any waterbody. 6. The Contractor shall provide ground cover on exposed slopes or other areas within the time frame specified in the stabilization table or sooner of completion of any phase of grading.		SEEDBED PREPARATION The Contractor shall cut and satisfactorily dispose of weeds or other unacceptable growth on the areas to be seeded. Unweeded and rough areas outside of the graded section, such as crop rows, farm contours, ditches, and ditch spoil banks, fence line and hedgerow soil accumulations, and other minor irregularities which cannot be obliterated by normal seedbed preparation operations, shall be shaped and smoothed as directed by the Engineer to provide for more effective seeding and for ease of subsequent mowing operations. The soil shall then be scarified or otherwise loosened to a depth of not less than 5 inches except as otherwise provided below. The depth of loosening shall be broken and the top 2 to 3 inches of soil shall be worked into an acceptable seedbed by the use of soil pulverizers, dropspreader harrows or by other methods approved by the Engineer. All rock and debris 3 inches or larger shall be removed on median, shoulders, and ditch cut or fill slopes which are 3:1 or flatter, prior to the application of seed and fertilizer. On cut slopes that are 2:1 and steeper, both the depth of preparation and the degree of smoothness of the seedbed may be reduced as permitted by the Engineer, but in all cases the slope surface shall be scarified, grooved, trenched, or punctured so as to provide pockets, ridges, or trenches in which the seedling materials can lodge. Contractor shall be responsible for providing the required seed bed. It may be necessary to seed these sections with a hydro-seed. On cut slopes that are either 2:1 or steeper, the Engineer may permit the preparation of a partial or complete seedbed during the grading of the slope. If, at the time of seeding and mulching operations such preparation is still in a condition acceptable to the Engineer, additional seedbed preparation may be reduced or eliminated. Seedbed preparation within 2 feet of the edge of any pavement shall be limited to a depth of 2 to 3 inches. The preparation of seedbeds shall not be done when the soil is frozen, extremely wet, or when the Engineer determines that it is an otherwise unfavorable working condition.		LAND GRADING (6.02) CONSTRUCTION SPECIFICATIONS 1. Construct and maintain all erosion and sedimentation control practices and measures in accordance with the approved sedimentation control plan and construction schedule. 2. Remove good topsoil from areas to be graded and filled, and preserve it for use in finishing the grading of all critical areas. 3. Specify areas to be topsoiled to a minimum depth of 2 inches before placing topsoil. 4. Clear and grub areas to be filled to remove trees, vegetation, roots, or other objectionable material that would affect the planned stability of the fill. 5. Ensure that fill material is free of brush, rubbish, rocks, logs, stumps, buried debris, and other materials that would affect the planned stability of the fill. 6. Place all fill in layers not to exceed 9 inches in thickness, and compact the layers as required to reduce erosion, slippage, settlement, or other related problems. 7. Do not incorporate frozen material or soft or highly compressible materials into fill slopes. 8. Do not place fill on a frozen foundation, due to possible subsidence and slippage. 9. Keep diversions and other water conveyance measures free of sediment during all phases of development. 10. Handle slopes or springs encountered during construction in accordance with approved methods. 11. Permanently stabilize all graded areas immediately after final grading is completed on each area. In the grading plan, apply temporary stabilization measures on all graded areas when work is to be interrupted or delayed for 15 working days or longer. 12. Show topsoil stockpiles, borrow areas, and spoil areas on the plans, and make sure they are adequately protected from erosion include final stabilization of these areas in the plan. MAINTENANCE Periodically check all graded areas and the supporting erosion and sedimentation control practices, especially after heavy rainfall. Promptly remove all sediment from diversions and other water disposal facilities, if washouts or breaks occur, repair them immediately. Promptly remove all sediment from diversions and other water disposal facilities. It is an essential part of an effective erosion and sedimentation control plan.																																																																										
GROUND STABILIZATION REQUIREMENTS Contractor shall stabilize (temporary or permanent) all disturbed areas within 7 or 14 days of termination of grading operations per the following guidelines: Perimeter ditches, swales, ditches and slopes - 7 days High Quality Water Zones - 7 days Slopes 2:1 or steeper - 7 days Slopes between 2:1 and 3:1 greater than 10' in length - 7 days Slopes between 2:1 and 3:1 less than 10' in length - 14 days Slopes between 3:1 and 4:1 less than 50' in length - 14 days Slopes between 3:1 and 4:1 greater than 50' in length - 7 days Slopes flatter than 4:1 - 14 days		SEEDBED PREPARATION The Contractor shall cut and satisfactorily dispose of weeds or other unacceptable growth on the areas to be seeded. Unweeded and rough areas outside of the graded section, such as crop rows, farm contours, ditches, and ditch spoil banks, fence line and hedgerow soil accumulations, and other minor irregularities which cannot be obliterated by normal seedbed preparation operations, shall be shaped and smoothed as directed by the Engineer to provide for more effective seeding and for ease of subsequent mowing operations. The soil shall then be scarified or otherwise loosened to a depth of not less than 5 inches except as otherwise provided below. The depth of loosening shall be broken and the top 2 to 3 inches of soil shall be worked into an acceptable seedbed by the use of soil pulverizers, dropspreader harrows or by other methods approved by the Engineer. All rock and debris 3 inches or larger shall be removed on median, shoulders, and ditch cut or fill slopes which are 3:1 or flatter, prior to the application of seed and fertilizer. On cut slopes that are 2:1 and steeper, both the depth of preparation and the degree of smoothness of the seedbed may be reduced as permitted by the Engineer, but in all cases the slope surface shall be scarified, grooved, trenched, or punctured so as to provide pockets, ridges, or trenches in which the seedling materials can lodge. Contractor shall be responsible for providing the required seed bed. It may be necessary to seed these sections with a hydro-seed. On cut slopes that are either 2:1 or steeper, the Engineer may permit the preparation of a partial or complete seedbed during the grading of the slope. If, at the time of seeding and mulching operations such preparation is still in a condition acceptable to the Engineer, additional seedbed preparation may be reduced or eliminated. Seedbed preparation within 2 feet of the edge of any pavement shall be limited to a depth of 2 to 3 inches. The preparation of seedbeds shall not be done when the soil is frozen, extremely wet, or when the Engineer determines that it is an otherwise unfavorable working condition.		CONSTRUCTION SPECIFICATIONS Subgrade Preparation - Prepare the subgrade for riprap and filter to the required lines and grades shown on the plans, compact any fill required in the subgrade to a density approximating that of the surrounding undisturbed material of overfill depressions within riprap. Remove brush, stumps, and other objectionable material. Cut the subgrade sufficiently deep that the finished grade of the riprap will be at the elevation of the surrounding area. Channels should be excavated sufficiently to allow placement of the riprap in manner such that the finished inside dimensions and grade of the riprap meet design specifications. Sand and gravel filter blanket - Place the filter blanket immediately after the ground foundation is prepared. For gravel spread, filter stone in a uniform layer to the specified depth. Where more than one layer of filter material is used, spread the layers with minimal mixing. Synthetic Filter Fabric - Place the filter fabric directly on the prepared foundation. Overlap the edges by at least 12 inches, and space anchor pins every 3 ft along the edges. Bury the upstream end of the cloth a minimum of 12 inches below ground and where necessary, bury the lower end of the cloth or overlap with the placement. Place riprap to its full thickness in one operation. Do not place riprap by dumping through chutes or other methods that cause segregation of stone sizes. Take care not to dislodge the underlying base or filter when placing the stones. The finished slope shall be free of pockets of small stone or clusters of large stones. Hand placing may be necessary to achieve the proper distribution of stone sizes to produce a relatively smooth uniform surface. The finished grade of the riprap should blend with the surrounding area. No overfill or protrusion of riprap should be apparent. MAINTENANCE Inspected channels at regular intervals as well as after major rains, and make repairs promptly. Give special attention to the outlet and inlet sections and other points where concentrated flow enters. Carefully check stability at road crossings and look for indications of piping, scour holes, or bank failures. Make repairs immediately. Maintain all appurtenances adjacent to the channel in a healthy, vigorous condition to protect the area from erosion and scour during out-of-bank flow. Control of weed and brush growth may be needed in some locations.																																																																										
GROUND STABILIZATION REQUIREMENTS Contractor shall stabilize (temporary or permanent) all disturbed areas within 7 or 14 days of termination of grading operations per the following guidelines: Perimeter ditches, swales, ditches and slopes - 7 days High Quality Water Zones - 7 days Slopes 2:1 or steeper - 7 days Slopes between 2:1 and 3:1 greater than 10' in length - 7 days Slopes between 2:1 and 3:1 less than 10' in length - 14 days Slopes between 3:1 and 4:1 less than 50' in length - 14 days Slopes between 3:1 and 4:1 greater than 50' in length - 7 days Slopes flatter than 4:1 - 14 days		SEEDBED PREPARATION The Contractor shall cut and satisfactorily dispose of weeds or other unacceptable growth on the areas to be seeded. Unweeded and rough areas outside of the graded section, such as crop rows, farm contours, ditches, and ditch spoil banks, fence line and hedgerow soil accumulations, and other minor irregularities which cannot be obliterated by normal seedbed preparation operations, shall be shaped and smoothed as directed by the Engineer to provide for more effective seeding and for ease of subsequent mowing operations. The soil shall then be scarified or otherwise loosened to a depth of not less than 5 inches except as otherwise provided below. The depth of loosening shall be broken and the top 2 to 3 inches of soil shall be worked into an acceptable seedbed by the use of soil pulverizers, dropspreader harrows or by other methods approved by the Engineer. All rock and debris 3 inches or larger shall be removed on median, shoulders, and ditch cut or fill slopes which are 3:1 or flatter, prior to the application of seed and fertilizer. On cut slopes that are 2:1 and steeper, both the depth of preparation and the degree of smoothness of the seedbed may be reduced as permitted by the Engineer, but in all cases the slope surface shall be scarified, grooved, trenched, or punctured so as to provide pockets, ridges, or trenches in which the seedling materials can lodge. Contractor shall be responsible for providing the required seed bed. It may be necessary to seed these sections with a hydro-seed. On cut slopes that are either 2:1 or steeper, the Engineer may permit the preparation of a partial or complete seedbed during the grading of the slope. If, at the time of seeding and mulching operations such preparation is still in a condition acceptable to the Engineer, additional seedbed preparation may be reduced or eliminated. Seedbed preparation within 2 feet of the edge of any pavement shall be limited to a depth of 2 to 3 inches. The preparation of seedbeds shall not be done when the soil is frozen, extremely wet, or when the Engineer determines that it is an otherwise unfavorable working condition.		CONSTRUCTION SPECIFICATIONS Subgrade Preparation - Prepare the subgrade for riprap and filter to the required lines and grades shown on the plans, compact any fill required in the subgrade to a density approximating that of the surrounding undisturbed material of overfill depressions within riprap. Remove brush, stumps, and other objectionable material. Cut the subgrade sufficiently deep that the finished grade of the riprap will be at the elevation of the surrounding area. Channels should be excavated sufficiently to allow placement of the riprap in manner such that the finished inside dimensions and grade of the riprap meet design specifications. Sand and gravel filter blanket - Place the filter blanket immediately after the ground foundation is prepared. For gravel spread, filter stone in a uniform layer to the specified depth. Where more than one layer of filter material is used, spread the layers with minimal mixing. Synthetic Filter Fabric - Place the filter fabric directly on the prepared foundation. Overlap the edges by at least 12 inches, and space anchor pins every 3 ft along the edges. Bury the upstream end of the cloth a minimum of 12 inches below ground and where necessary, bury the lower end of the cloth or overlap with the placement. Place riprap to its full thickness in one operation. Do not place riprap by dumping through chutes or other methods that cause segregation of stone sizes. Take care not to dislodge the underlying base or filter when placing the stones. The finished slope shall be free of pockets of small stone or clusters of large stones. Hand placing may be necessary to achieve the proper distribution of stone sizes to produce a relatively smooth uniform surface. The finished grade of the riprap should blend with the surrounding area. No overfill or protrusion of riprap should be apparent. MAINTENANCE Inspected channels at regular intervals as well as after major rains, and make repairs promptly. Give special attention to the outlet and inlet sections and other points where concentrated flow enters. Carefully check stability at road crossings and look for indications of piping, scour holes, or bank failures. Make repairs immediately. Maintain all appurtenances adjacent to the channel in a healthy, vigorous condition to protect the area from erosion and scour during out-of-bank flow. Control of weed and brush growth may be needed in some locations.																																																																										
GROUND STABILIZATION REQUIREMENTS Contractor shall stabilize (temporary or permanent) all disturbed areas within 7 or 14 days of termination of grading operations per the following guidelines: Perimeter ditches, swales, ditches and slopes - 7 days High Quality Water Zones - 7 days Slopes 2:1 or steeper - 7 days Slopes between 2:1 and 3:1 greater than 10' in length - 7 days Slopes between 2:1 and 3:1 less than 10' in length - 14 days Slopes between 3:1 and 4:1 less than 50' in length - 14 days Slopes between 3:1 and 4:1 greater than 50' in length - 7 days Slopes flatter than 4:1 - 14 days		SEEDBED PREPARATION The Contractor shall cut and satisfactorily dispose of weeds or other unacceptable growth on the areas to be seeded. Unweeded and rough areas outside of the graded section, such as crop rows, farm contours, ditches, and ditch spoil banks, fence line and hedgerow soil accumulations, and other minor irregularities which cannot be obliterated by normal seedbed preparation operations, shall be shaped and smoothed as directed by the Engineer to provide for more effective seeding and for ease of subsequent mowing operations. The soil shall then be scarified or otherwise loosened to a depth of not less than 5 inches except as otherwise provided below. The depth of loosening shall be broken and the top 2 to 3 inches of soil shall be worked into an acceptable seedbed by the use of soil pulverizers, dropspreader harrows or by other methods approved by the Engineer. All rock and debris 3 inches or larger shall be removed on median, shoulders, and ditch cut or fill slopes which are 3:1 or flatter, prior to the application of seed and fertilizer. On cut slopes that are 2:1 and steeper, both the depth of preparation and the degree of smoothness of the seedbed may be reduced as permitted by the Engineer, but in all cases the slope surface shall be scarified, grooved, trenched, or punctured so as to provide pockets, ridges, or trenches in which the seedling materials can lodge. Contractor shall be responsible for providing the required seed bed. It may be necessary to seed these sections with a hydro-seed. On cut slopes that are either 2:1 or steeper, the Engineer may permit the preparation of a partial or complete seedbed during the grading of the slope. If, at the time of seeding and mulching operations such preparation is still in a condition acceptable to the Engineer, additional seedbed preparation may be reduced or eliminated. Seedbed preparation within 2 feet of the edge of any pavement shall be limited to a depth of 2 to 3 inches. The preparation of seedbeds shall not be done when the soil is frozen, extremely wet, or when the Engineer determines that it is an otherwise unfavorable working condition.		CONSTRUCTION SPECIFICATIONS Subgrade Preparation - Prepare the subgrade for riprap and filter to the required lines and grades shown on the plans, compact any fill required in the subgrade to a density approximating that of the surrounding undisturbed material of overfill depressions within riprap. Remove brush, stumps, and other objectionable material. Cut the subgrade sufficiently deep that the finished grade of the riprap will be at the elevation of the surrounding area. Channels should be excavated sufficiently to allow placement of the riprap in manner such that the finished inside dimensions and grade of the riprap meet design specifications. Sand and gravel filter blanket - Place the filter blanket immediately after the ground foundation is prepared. For gravel spread, filter stone in a uniform layer to the specified depth. Where more than one layer of filter material is used, spread the layers with minimal mixing. Synthetic Filter Fabric - Place the filter fabric directly on the prepared foundation. Overlap the edges by at least 12 inches, and space anchor pins every 3 ft along the edges. Bury the upstream end of the cloth a minimum of 12 inches below ground and where necessary, bury the lower end of the cloth or overlap with the placement. Place riprap to its full thickness in one operation. Do not place riprap by dumping through chutes or other methods that cause segregation of stone sizes. Take care not to dislodge the underlying base or filter when placing the stones. The finished slope shall be free of pockets of small stone or clusters of large stones. Hand placing may be necessary to achieve the proper distribution of stone sizes to produce a relatively smooth uniform surface. The finished grade of the riprap should blend with the surrounding area. No overfill or protrusion of riprap should be apparent. MAINTENANCE Inspected channels at regular intervals as well as after major rains, and make repairs promptly. Give special attention to the outlet and inlet sections and other points where concentrated flow enters. Carefully check stability at road crossings and look for indications of piping, scour holes, or bank failures. Make repairs immediately. Maintain all appurtenances adjacent to the channel in a healthy, vigorous condition to protect the area from erosion and scour during out-of-bank flow. Control of weed and brush growth may be needed in some locations.																																																																										
GROUND STABILIZATION REQUIREMENTS Contractor shall stabilize (temporary or permanent) all disturbed areas within 7 or 14 days of termination of grading operations per the following guidelines: Perimeter ditches, swales, ditches and slopes - 7 days High Quality Water Zones - 7 days Slopes 2:1 or steeper - 7 days Slopes between 2:1 and 3:1 greater than 10' in length - 7 days Slopes between 2:1 and 3:1 less than 10' in length - 14 days Slopes between 3:1 and 4:1 less than 50' in length - 14 days Slopes between 3:1 and 4:1 greater than 50' in length - 7 days Slopes flatter than 4:1 - 14 days		SEEDBED PREPARATION The Contractor shall cut and satisfactorily dispose of weeds or other unacceptable growth on the areas to be seeded. Unweeded and rough areas outside of the graded section, such as crop rows, farm contours, ditches, and ditch spoil banks, fence line and hedgerow soil accumulations, and other minor irregularities which cannot be obliterated by normal seedbed preparation operations, shall be shaped and smoothed as directed by the Engineer to provide for more effective seeding and for ease of subsequent mowing operations. The soil shall then be scarified or otherwise loosened to a depth of not less than 5 inches except as otherwise provided below. The depth of loosening shall be broken and the top 2 to 3 inches of soil shall be worked into an acceptable seedbed by the use of soil pulverizers, dropspreader harrows or by other methods approved by the Engineer. All rock and debris 3 inches or larger shall be removed on median, shoulders, and ditch cut or fill slopes which are 3:1 or flatter, prior to the application of seed and fertilizer. On cut slopes that are 2:1 and steeper, both the depth of preparation and the degree of smoothness of the seedbed may be reduced as permitted by the Engineer, but in all cases the slope surface shall be scarified, grooved, trenched, or punctured so as to provide pockets, ridges, or trenches in which the seedling materials can lodge. Contractor shall be responsible for providing the required seed bed. It may be necessary to seed these sections with a hydro-seed. On cut slopes that are either 2:1 or steeper, the Engineer may permit the preparation of a partial or complete seedbed during the grading of the slope. If, at the time of seeding and mulching operations such preparation is still in a condition acceptable to the Engineer, additional seedbed preparation may be reduced or eliminated. Seedbed preparation within 2 feet of the edge of any pavement shall be limited to a depth of 2 to 3 inches. The preparation of seedbeds shall not be done when the soil is frozen, extremely wet, or when the Engineer determines that it is an otherwise unfavorable working condition.		CONSTRUCTION SPECIFICATIONS Subgrade Preparation - Prepare the subgrade for riprap and filter to the required lines and grades shown on the plans, compact any fill required in the subgrade to a density approximating that of the surrounding undisturbed material of overfill depressions within riprap. Remove brush, stumps, and other objectionable material. Cut the subgrade sufficiently deep that the finished grade of the riprap will be at the elevation of the surrounding area. Channels should be excavated sufficiently to allow placement of the riprap in manner such that the finished inside dimensions and grade of the riprap meet design specifications. Sand and gravel filter blanket - Place the filter blanket immediately after the ground foundation is prepared. For gravel spread, filter stone in a uniform layer to the specified depth. Where more than one layer of filter material is used, spread the layers with minimal mixing. Synthetic Filter Fabric - Place the filter fabric directly on the prepared foundation. Overlap the edges by at least 12 inches, and space anchor pins every 3 ft along the edges. Bury the upstream end of the cloth a minimum of 12 inches below ground and where necessary, bury the lower end of the cloth or overlap with the placement. Place riprap to its full thickness in one operation. Do not place riprap by dumping through chutes or other methods that cause segregation of stone sizes. Take care not to dislodge the underlying base or filter when placing the stones. The finished slope shall be free of pockets of small stone or clusters of large stones. Hand placing may be necessary to achieve the proper distribution of stone sizes to produce a relatively smooth uniform surface. The finished grade of the riprap should blend with the surrounding area. No overfill or protrusion of riprap should be apparent. MAINTENANCE Inspected channels at regular intervals as well as after major rains, and make repairs promptly. Give special attention to the outlet and inlet sections and other points where concentrated flow enters. Carefully check stability at road crossings and look for indications of piping, scour holes, or bank failures. Make repairs immediately. Maintain all appurtenances adjacent to the channel in a healthy, vigorous condition to protect the area from erosion and scour during out-of-bank flow. Control of weed and brush growth may be needed in some locations.																																																																										
GROUND STABILIZATION REQUIREMENTS Contractor shall stabilize (temporary or permanent) all disturbed areas within 7 or 14 days of termination of grading operations per the following guidelines: Perimeter ditches, swales, ditches and slopes - 7 days High Quality Water Zones - 7 days Slopes 2:1 or steeper - 7 days Slopes between 2:1 and 3:1 greater than 10' in length - 7 days Slopes between 2:1 and 3:1 less than 10' in length - 14 days Slopes between 3:1 and 4:1 less than 50' in length - 14 days Slopes between 3:1 and 4:1 greater than 50' in length - 7 days Slopes flatter than 4:1 - 14 days		SEEDBED PREPARATION The Contractor shall cut and satisfactorily dispose of weeds or other unacceptable growth on the areas to be seeded. Unweeded and rough areas outside of the graded section, such as crop rows, farm contours, ditches, and ditch spoil banks, fence line and hedgerow soil accumulations, and other minor irregularities which cannot be obliterated by normal seedbed preparation operations, shall be shaped and smoothed as directed by the Engineer to provide for more effective seeding and for ease of subsequent mowing operations. The soil shall then be scarified or otherwise loosened to a depth of not less than 5 inches except as otherwise provided below. The depth of loosening shall be broken and the top 2 to 3 inches of soil shall be worked into an acceptable seedbed by the use of soil pulverizers, dropspreader harrows or by other methods approved by the Engineer. All rock and debris 3 inches or larger shall be removed on median, shoulders, and ditch cut or fill slopes which are 3:1 or flatter, prior to the application of seed and fertilizer. On cut slopes that are 2:1 and steeper, both the depth of preparation and the degree of smoothness of the seedbed may be reduced as permitted by the Engineer, but in all cases the slope surface shall be scarified, grooved, trenched, or punctured so as to provide pockets, ridges, or trenches in which the seedling materials can lodge. Contractor shall be responsible for providing the required seed bed. It may be necessary to seed these sections with a hydro-seed. On cut slopes that are either 2:1 or steeper, the Engineer may permit the preparation of a partial or complete seedbed during the grading of the slope. If, at the time of seeding and mulching operations such preparation is still in a condition acceptable to the Engineer, additional seedbed preparation may be reduced or eliminated. Seedbed preparation within 2 feet of the edge of any pavement shall be limited to a depth of 2 to 3 inches. The preparation of seedbeds shall not be done when the soil is frozen, extremely wet, or when the Engineer determines that it is an otherwise unfavorable working condition.		CONSTRUCTION SPECIFICATIONS Subgrade Preparation - Prepare the subgrade for riprap and filter to the required lines and grades shown on the plans, compact any fill required in the subgrade to a density approximating that of the surrounding undisturbed material of overfill depressions within riprap. Remove brush, stumps, and other objectionable material. Cut the subgrade sufficiently deep that the finished grade of the riprap will be at the elevation of the surrounding area. Channels should be excavated sufficiently to allow placement of the riprap in manner such that the finished inside dimensions and grade of the riprap meet design specifications. Sand and gravel filter blanket - Place the filter blanket immediately after the ground foundation is prepared. For gravel spread, filter stone in a uniform layer to the specified depth. Where more than one layer of filter material is used, spread the layers with minimal mixing. Synthetic Filter Fabric - Place the filter fabric directly on the prepared foundation. Overlap the edges by at least 12 inches, and space anchor pins every 3 ft along the edges. Bury the upstream end of the cloth a minimum of 12 inches below ground and where necessary, bury the lower end of the cloth or overlap with the placement. Place riprap to its full thickness in one operation. Do not place riprap by dumping through chutes or other methods that cause segregation of stone sizes. Take care not to dislodge the underlying base or filter when placing the stones. The finished slope shall be free of pockets of small stone or clusters of large stones. Hand placing may be necessary to achieve the proper distribution of stone sizes to produce a relatively smooth uniform surface. The finished grade of the riprap should blend with the surrounding area. No overfill or protrusion of riprap should be apparent. MAINTENANCE Inspected channels at regular intervals as well as after major rains, and make repairs promptly. Give special attention to the outlet and inlet sections and other points where concentrated flow enters. Carefully check stability at road crossings and look for indications of piping, scour holes, or bank failures. Make repairs immediately. Maintain all appurtenances adjacent to the channel in a healthy, vigorous condition to protect the area from erosion and scour during out-of-bank flow. Control of weed and brush growth may be needed in some locations.																																																																										
GROUND STABILIZATION REQUIREMENTS Contractor shall stabilize (temporary or permanent) all disturbed areas within 7 or 14 days of termination of grading operations per the following guidelines: Perimeter ditches, swales, ditches and slopes - 7 days High Quality Water Zones - 7 days Slopes 2:1 or steeper - 7 days Slopes between 2:1 and 3:1 greater than 10' in length - 7 days Slopes between 2:1 and 3:1 less than 10' in length - 14 days Slopes between 3:1 and 4:1 less than 50' in length - 14 days Slopes between 3:1 and 4:1 greater than 50' in length - 7 days Slopes flatter than 4:1 - 14 days		SEEDBED PREPARATION The Contractor shall cut and satisfactorily dispose of weeds or other unacceptable growth on the areas to be seeded. Unweeded and rough areas outside of the graded section, such as crop rows, farm contours, ditches, and ditch spoil banks, fence line and hedgerow soil accumulations, and other minor irregularities which cannot be obliterated by normal seedbed preparation operations, shall be shaped and smoothed as directed by the Engineer to provide for more effective seeding and for ease of subsequent mowing operations. The soil shall then be scarified or otherwise loosened to a depth of not less than 5 inches except as otherwise provided below. The depth of loosening shall be broken and the top 2 to 3 inches of soil shall be worked into an acceptable seedbed by the use of soil pulverizers, dropspreader harrows or by other methods approved by the Engineer. All rock and debris 3 inches or larger shall be removed on median, shoulders, and ditch cut or fill slopes which are 3:1 or flatter, prior to the application of seed and fertilizer. On cut slopes that are 2:1 and steeper, both the depth of preparation and the degree of smoothness of the seedbed may be reduced as permitted by the Engineer, but in all cases the slope surface shall be scarified, grooved, trenched, or punctured so as to provide pockets, ridges, or trenches in which the seedling materials can lodge. Contractor shall be responsible for providing the required seed bed. It may be necessary to seed these sections with a hydro-seed. On cut slopes that are either 2:1 or steeper, the Engineer may permit the preparation of a partial or complete seedbed during the grading of the slope. If, at the time of seeding and mulching operations such preparation is still in a condition acceptable to the Engineer, additional seedbed preparation may be reduced or eliminated. Seedbed preparation within 2 feet of the edge of any pavement shall be limited to a depth of 2 to 3 inches. The preparation of seedbeds shall not be done when the soil is frozen, extremely wet, or when the Engineer determines that it is an otherwise unfavorable working condition.		CONSTRUCTION SPECIFICATIONS Subgrade Preparation - Prepare the subgrade for riprap and filter to the required lines and grades shown on the plans, compact any fill required in the subgrade to a density approximating that of the surrounding undisturbed material of overfill depressions within riprap. Remove brush, stumps, and other objectionable material. Cut the subgrade sufficiently deep that the finished grade of the riprap will be at the elevation of the surrounding area. Channels should be excavated sufficiently to allow placement of the riprap in manner such that the finished inside dimensions and grade of the riprap meet design specifications. Sand and gravel filter blanket - Place the filter blanket immediately after the ground foundation is prepared. For gravel spread, filter stone in a uniform layer to the specified depth. Where more than one layer of filter material is used, spread the layers with minimal mixing. Synthetic Filter Fabric - Place the filter fabric directly on the prepared foundation. Overlap the edges by at least 12 inches, and space anchor pins every 3 ft along the edges. Bury the upstream end of the cloth a minimum of 12 inches below ground and where necessary, bury the lower end of the cloth or overlap with the placement. Place riprap to its full thickness in one operation. Do not place riprap by dumping through chutes or other methods that cause segregation of stone sizes. Take care not to dislodge the underlying base or filter when placing the stones. The finished slope shall be free of pockets of small stone or clusters of large stones. Hand placing may be necessary to achieve the proper distribution of stone sizes to produce a relatively smooth uniform surface. The finished grade of the riprap should blend with the surrounding area. No overfill or protrusion of riprap should be apparent. MAINTENANCE Inspected channels at regular intervals as well as after major rains, and make repairs promptly. Give special attention to the outlet and inlet sections and other points where concentrated flow enters. Carefully check stability at road crossings and look for indications of piping, scour holes, or bank failures. Make repairs immediately. Maintain all appurtenances adjacent to the channel in a healthy, vigorous condition to protect the area from erosion and scour during out-of-bank flow. Control of weed and brush growth may be needed in some locations.																																																																										
GROUND STABILIZATION REQUIREMENTS Contractor shall stabilize (temporary or permanent) all disturbed areas within 7 or 14 days of termination of grading operations per the following guidelines: Perimeter ditches, swales, ditches and slopes - 7 days High Quality Water Zones - 7 days Slopes 2:1 or steeper - 7 days Slopes between 2:1 and 3:1 greater than 10' in length - 7 days Slopes between 2:1 and 3:1 less than 10' in length - 14 days Slopes between 3:1 and 4:1 less than 50' in length - 14 days Slopes between 3:1 and 4:1 greater than 50' in length - 7 days Slopes flatter than 4:1 - 14 days		SEEDBED PREPARATION The Contractor shall cut and satisfactorily dispose of weeds or other unacceptable growth on the areas to be seeded. Unweeded and rough areas outside of the graded section, such as crop rows, farm contours, ditches, and ditch spoil banks																																																																												



KHA PROJECT		DATE		BY	
07/24/2023		5/24/2023		1-407	
SCALE		DESIGNED BY		DRAWN BY	
EP		EP		EP	
CHECKED BY		CHECKED BY		CHECKED BY	
BY		BY		BY	
DATE		DATE		DATE	
REV		REV		REV	
NO.		NO.		NO.	
REVISIONS		REVISIONS		REVISIONS	
DATE		DATE		DATE	
BY		BY		BY	
DATE		DATE		DATE	
REV		REV		REV	
NO.		NO.		NO.	
REVISIONS		REVISIONS		REVISIONS	
DATE		DATE		DATE	
BY		BY		BY	
DATE		DATE		DATE	
REV		REV		REV	
NO.		NO.		NO.	
REVISIONS		REVISIONS		REVISIONS	
DATE		DATE		DATE	
BY		BY		BY	
DATE		DATE		DATE	
REV		REV		REV	
NO.		NO.		NO.	
REVISIONS		REVISIONS		REVISIONS	
DATE		DATE		DATE	
BY		BY		BY	
DATE		DATE		DATE	
REV		REV		REV	
NO.		NO.		NO.	
REVISIONS		REVISIONS		REVISIONS	
DATE		DATE		DATE	
BY		BY		BY	
DATE		DATE		DATE	
REV		REV		REV	
NO.		NO.		NO.	
REVISIONS		REVISIONS		REVISIONS	
DATE		DATE		DATE	
BY		BY		BY	
DATE		DATE		DATE	
REV		REV		REV	
NO.		NO.		NO.	
REVISIONS		REVISIONS		REVISIONS	
DATE		DATE		DATE	
BY		BY		BY	
DATE		DATE		DATE	
REV		REV		REV	
NO.		NO.		NO.	
REVISIONS		REVISIONS		REVISIONS	
DATE		DATE		DATE	
BY		BY		BY	
DATE		DATE		DATE	
REV		REV		REV	
NO.		NO.		NO.	
REVISIONS		REVISIONS		REVISIONS	
DATE		DATE		DATE	
BY		BY		BY	
DATE		DATE		DATE	
REV		REV		REV	
NO.		NO.		NO.	
REVISIONS		REVISIONS		REVISIONS	
DATE		DATE		DATE	
BY		BY		BY	
DATE		DATE		DATE	
REV		REV		REV	
NO.		NO.		NO.	
REVISIONS		REVISIONS		REVISIONS	
DATE		DATE		DATE	
BY		BY		BY	
DATE		DATE		DATE	
REV		REV		REV	
NO.		NO.		NO.	
REVISIONS		REVISIONS		REVISIONS	
DATE		DATE		DATE	
BY		BY		BY	
DATE		DATE		DATE	
REV		REV		REV	
NO.		NO.		NO.	
REVISIONS		REVISIONS		REVISIONS	
DATE		DATE		DATE	
BY		BY		BY	
DATE		DATE		DATE	
REV		REV		REV	
NO.		NO.			

NOTES:

1. Use block and gravel inlet protection when inlet is at existing pavement locations.
2. Use block & gravel device or acceptable alternative over grate drain holes.

CONSTRUCTION SPECIFICATIONS

1. Lay one beam on each side of the structure on its side in the bottom row to allow pond drainage. The foundation should be placed on a level surface. The beams should be placed on the bottom row to allow water to drain along the edge of the structure. The beams should be placed on the bottom row to allow water to drain along the edge of the structure. The beams should be placed on the bottom row to allow water to drain along the edge of the structure.
2. Carefully fit hardware clips or comparable wire mesh with 1/2 inch openings over the drainage area and fasten in place.
3. Use clean groundhog 1/2-inch diameter plastic pipe 2 inches below the top of the beam on the inside or latter and smooth it to an even grade. Use DOT #57 washed stone.
4. The structure shall be inspected after each rain and repairs shall be made as needed.
5. Sediment shall be removed and the top (rastroing) to its original dimensions when the sediment has accumulated to the design depth. The sediment shall be removed by the contractor using a suitable area and in such a manner that it will not erode.
6. Structures shall be removed and the area stabilized when the remaining drainage area has been properly stabilized.
7. No. 57 stone shall be paid for at the contract unit price per cubic yard.

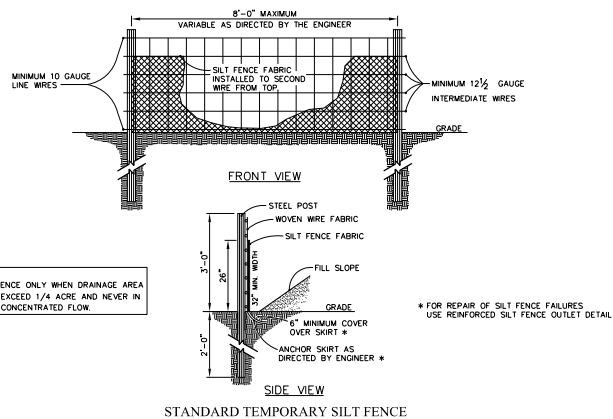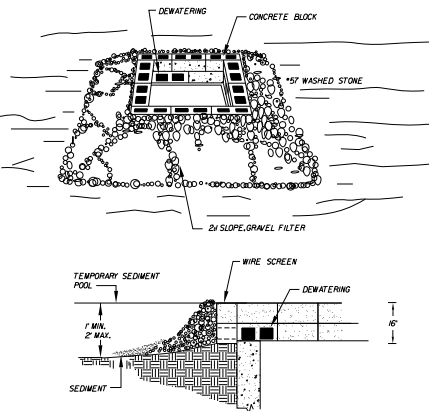

* FOR REPAIR OF SILT FENCE FAILURES
USE REINFORCED SILT FENCE OUTLET DETAIL.

STATE OF
NORTH CAROLINA
DEPT. OF TRANSPORTATION
DIVISION OF HIGHWAYS
RALEIGH, N.C.


7-06

ENGLISH STANDARD DRAWING FOR
ROCK PIPE INLET SEDIMENT TRAP TYPE 'B'

ENGLISH STANDARD DRAWING FOR

SHEET 1 OF 1
1635.02

NOTE:
USE CLASS 'A' EROSION
CONTROL STON FOR
STRUCTURAL STONE.
USE NO. 5 OR NO. 57 STONE
FOR SEDIMENT CONTROL.
CONSTRUCT TOP OF BERM
A MINIMUM OF ONE FOOT
BELOW THE SHOULDER OR
DIVERSION POINT.
PROVIDE A TOTAL SEDIMENT
TRAP VOLUME OF 1800± CUBIC
FEET PER ACRE OF DISTURBED
AREA. SOME OF THE REQUIRED
VOLUME MAY BE PROVIDED BY
OTHER UP OR DOWNSTREAM
CONTROLS.

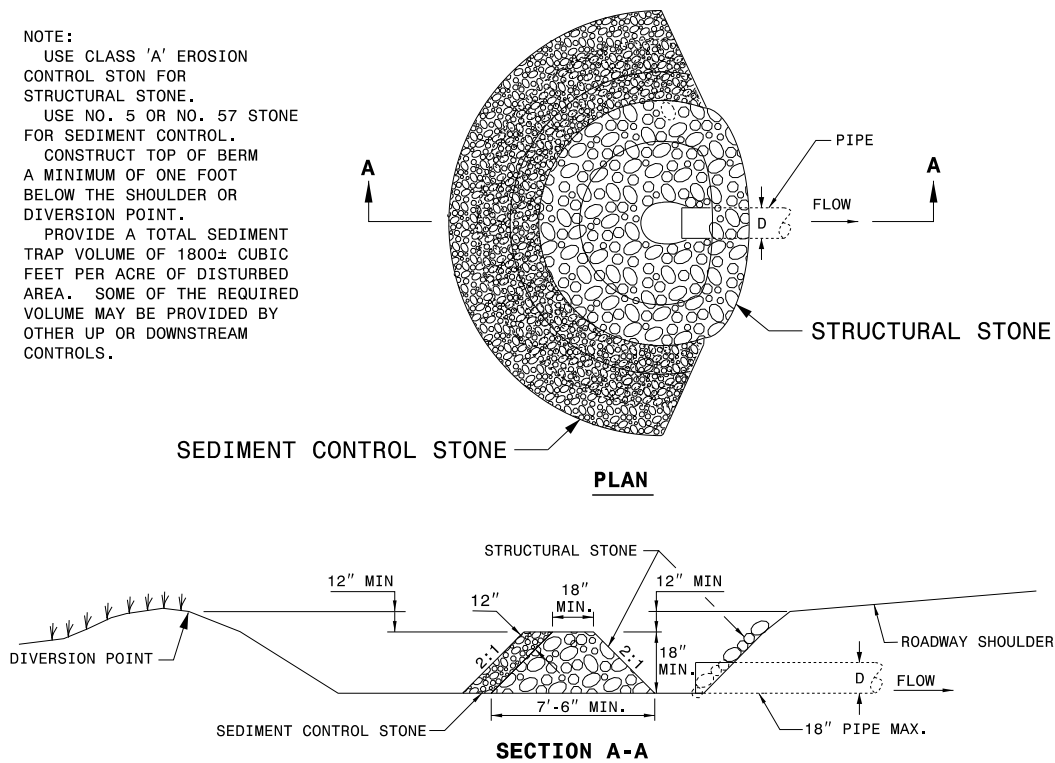

7-06 STATE OF
NORTH CAROLINA
DEPT. OF TRANSPORTATION
DIVISION OF HIGHWAYS
RALEIGH, N.C.

ENGLISH STANDARD DRAWING FOR
ROCK PIPE INLET SEDIMENT TRAP TYPE 'B'

SHEET 1 OF 1
1635.02

CITY OF RALEIGH - PLANS AUTHORIZED FOR CONSTRUCTION

Plans for the proposed use have been reviewed for general compliance with applicable codes. This limited review, and authorization for construction is not to be considered to represent total compliance with all legal requirements for development and construction. The property owner, design consultants, and contractors are each responsible for compliance with all applicable City, State and Federal laws. This specific authorization below is not a permit, nor shall it be construed to permit any violation of City, State or Federal Law. All Construction must be in accordance with all Local, State and Federal Rules and Regulations. This approval of this electronic document is only valid if the document has been modified and the digital signature below is valid:

City of Raleigh Development Approval

City of Raleigh Development Approval _____

KHA PROJECT	DATE	DESIGNED BY:	EP
017222020	5/24/2023	DRAWN BY:	EP
	SCALE		1"=40'

EROSION
CONTROL

SOLIS BUFFALO
OFFSITE ROADWAY

NORTH CAROLINA

RAI FIGH

Kimley»»Horn

© 2022
221 FAYETTEVILLE STREET, SUITE 600, RALEIGH, NC 27601
PHONE: 919-677-2000 FAX: 919-677-2050
WWW.KIMLEY-HORN.COM
NC LICENSE # E-0102

REVISIONS

5

W/W

—

[illegible][illegible]


29

1

6


R

K:\RAL_Roadway\07222020 - Buffalo Rd Offsite\Roadway\SC07222020_04.plt.dgn 5/24/2023

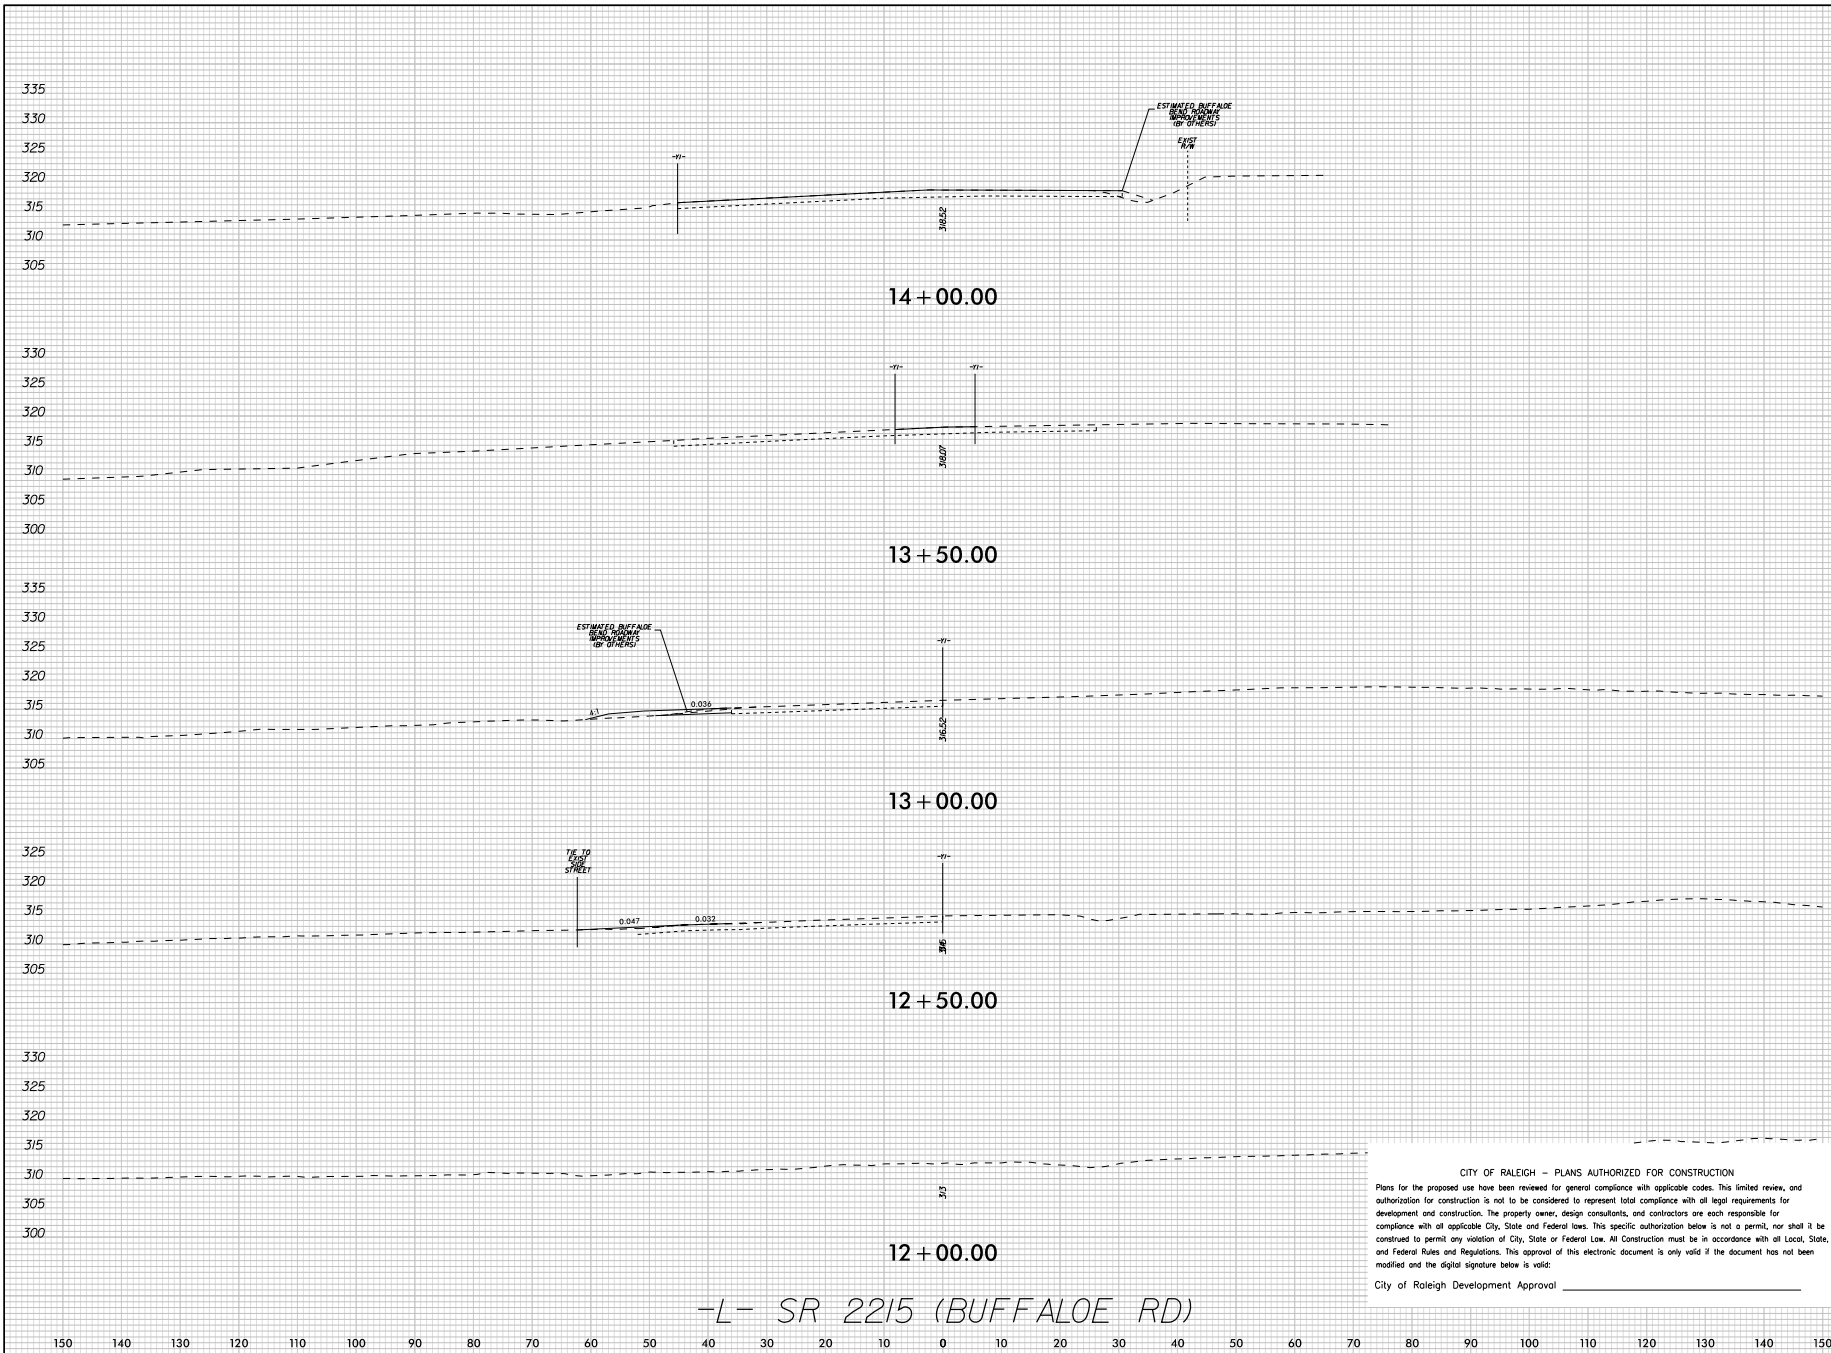

KIMLEY-HORN		© 2022 421 FAYETTEVILLE STREET, SUITE 400, RALEIGH, NC 27601 PHONE: 919-955-5647 WWW.KIMLEY-HORN.COM NC LICENSE # F-0102	
ROADWAY CROSS-SECTIONS		SHEET NUMBER R6.00	
SOLIS BUFFALO OFFSITE ROADWAY		NORTH CAROLINA	
RALEIGH		DATE	
BY		BY	
CHECKED BY: EP		REVISIONS	
DESIGNED BY: EP		No.	
DRAWN BY: EP		DATE	
KHA PROJECT 07222020			
DATE 5/24/2023			
SCALE 1"=10'			

5/24/2023 K:\RAL_Roadway\07222020 - Buffalo Rd Offsite\Roadway\SC07222020_04.plt.dgn

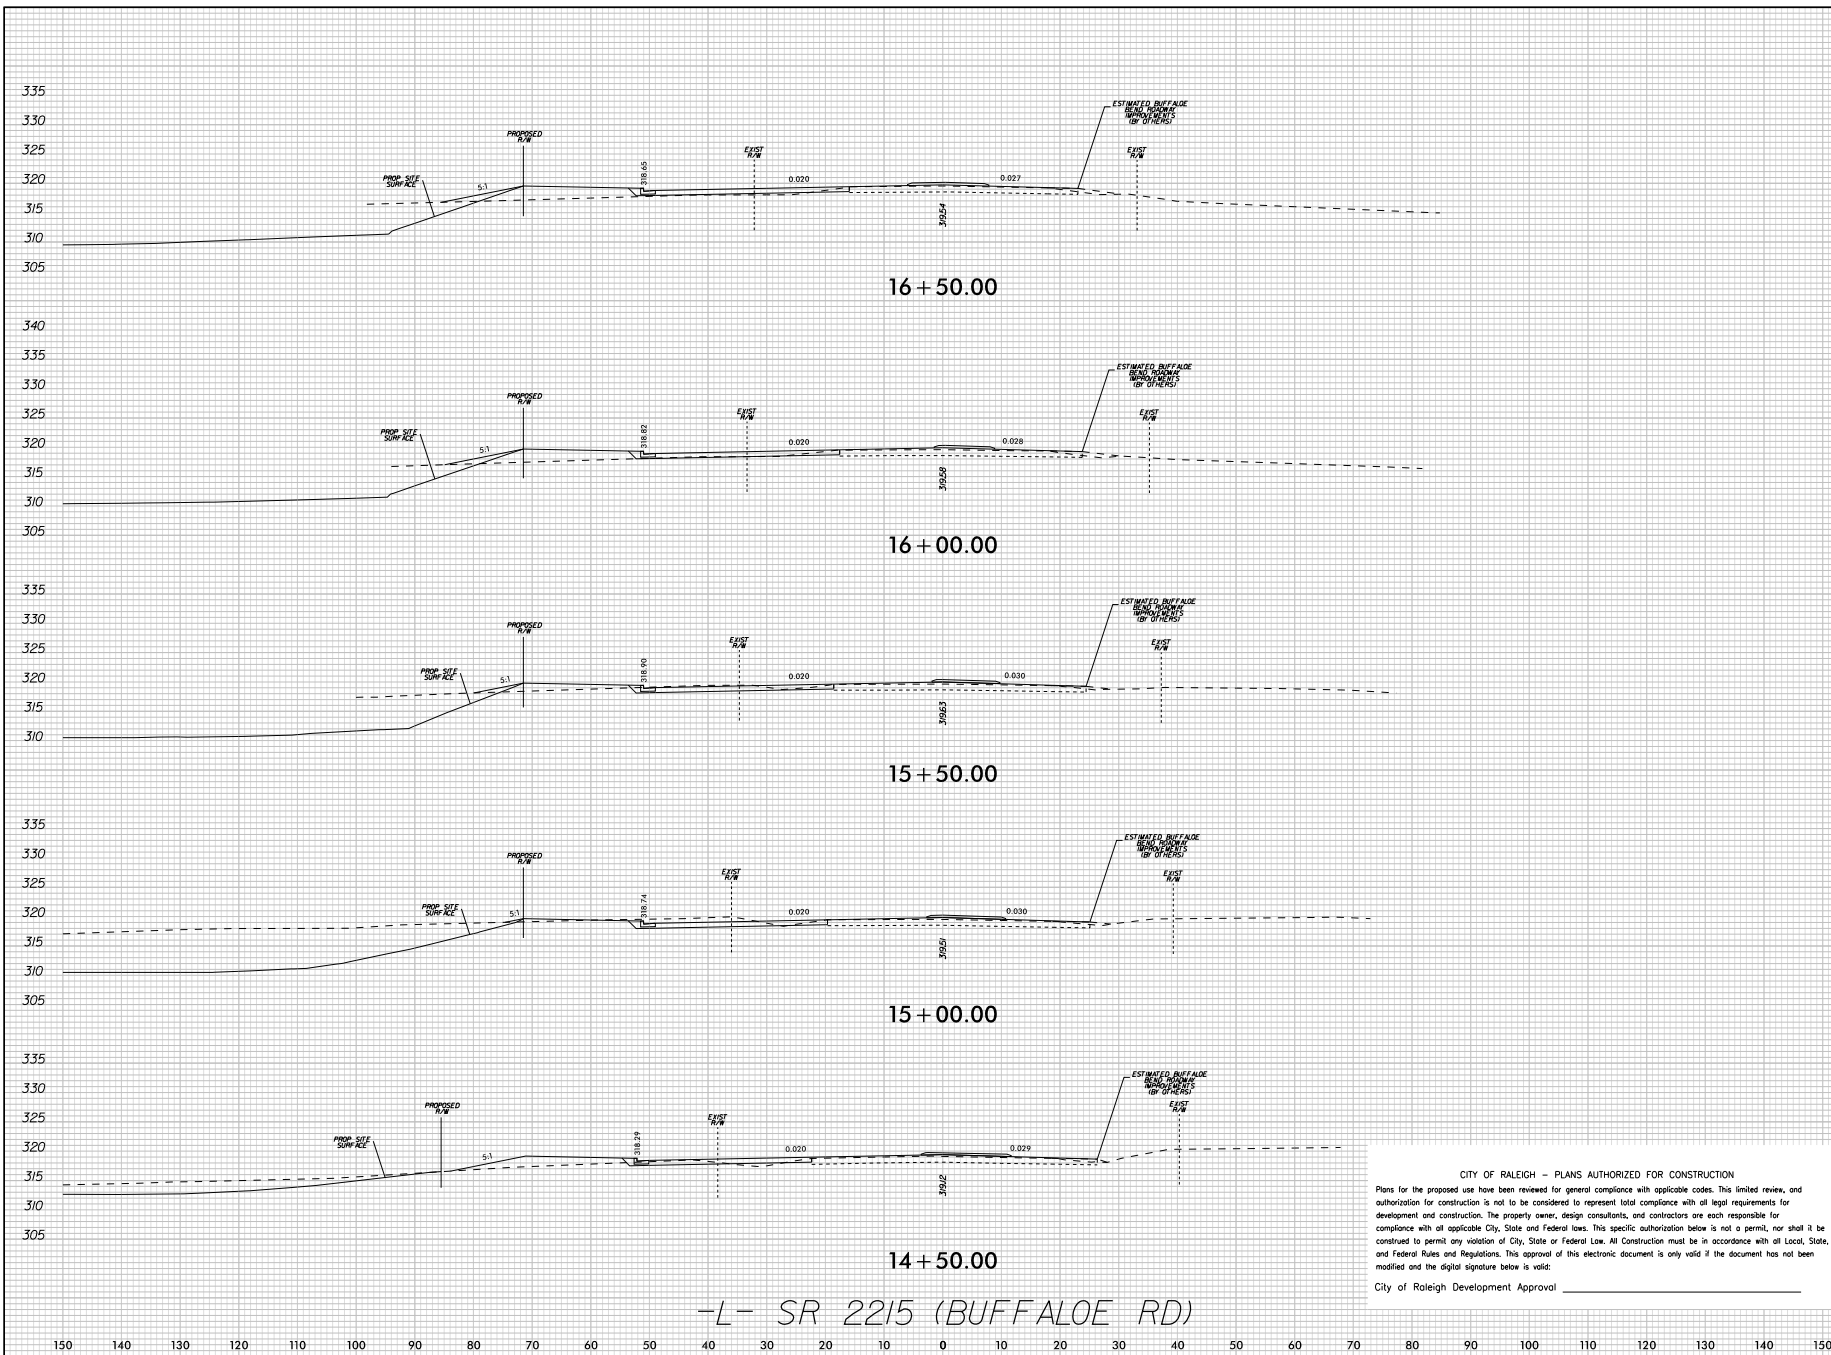

CITY OF RALEIGH - PLANS AUTHORIZED FOR CONSTRUCTION


Plans for the proposed use have been reviewed for general compliance with applicable codes. This limited review, and authorization for construction is not to be considered to represent total compliance with all legal requirements for development and construction. The property owner, design consultants, and contractors are each responsible for compliance with all applicable City, State and Federal laws. This specific authorization below is not a permit, nor shall it be construed to permit any violation of City, State or Federal Law. All Construction must be in accordance with all Local, State, and Federal Rules and Regulations. This approval of this electronic document is only valid if the document has not been modified and the digital signature below is valid:

City of Raleigh Development Approval _____

KHA PROJECT		DATE		SCALE		DESIGNED BY:		DRAWN BY:		CHECKED BY:		BY	
07/22/2020		5/24/2023		1"=10'		EP		EP					
ROADWAY CROSS-SECTIONS												RALEIGH	
SOLIS BUFFALO E OFFSITE ROADWAY												NORTH CAROLINA	
SHEET NUMBER R6.01												DATE	
REVISED												BY	

Kimley»Horn

© 2022
421 FAYETTEVILLE STREET, SUITE 400, RALEIGH, NC 27601
PHONE: 919-876-8800 FAX: 919-876-8817
WWW.KIMLEY-HORN.COM
NC LICENSE # E-002

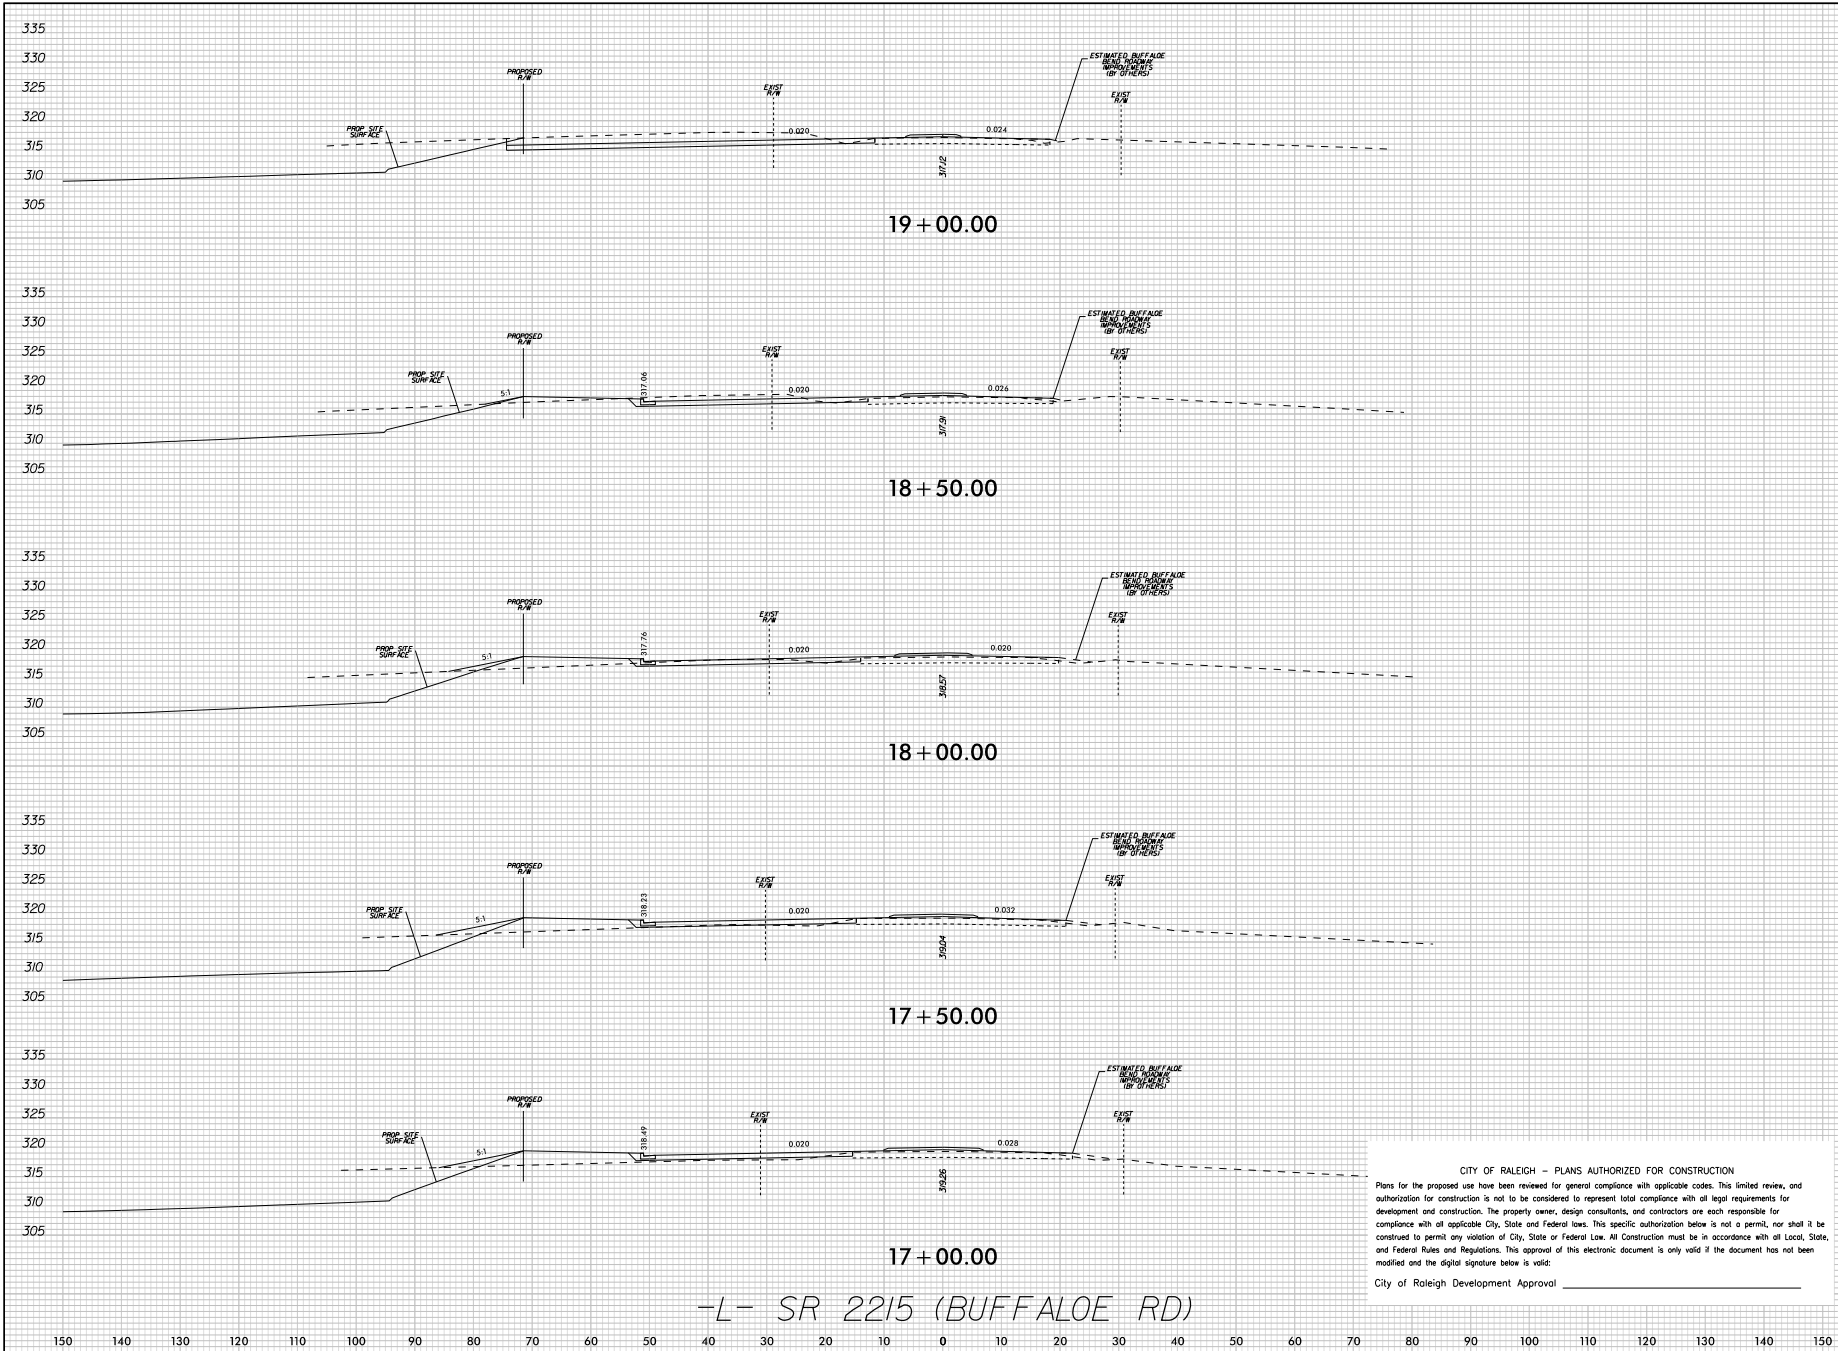


CITY OF RALEIGH – PLANS AUTHORIZED FOR CONSTRUCTION

Plans for the proposed use have been reviewed for general compliance with applicable codes. This limited review, and authorization for construction is not to be considered to represent total compliance with all legal requirements for development and construction. The property owner, design consultants, and contractors are each responsible for compliance with all applicable City, State and Federal laws. This specific authorization below is not a permit, nor shall it be construed to permit any violation of City, State or Federal Law. All construction must be in accordance with all Local, State and Federal Rules and Regulations. This approval of this electronic document is only valid if the document has not been modified and the digital signature below is valid:

City of Raleigh Development Approval _____

[illegible]

5/24/2023 K:\RAL_Roadway\07222020 - Buffalo Rd Offsite\Roadway\SC07222020_00_00.dgn

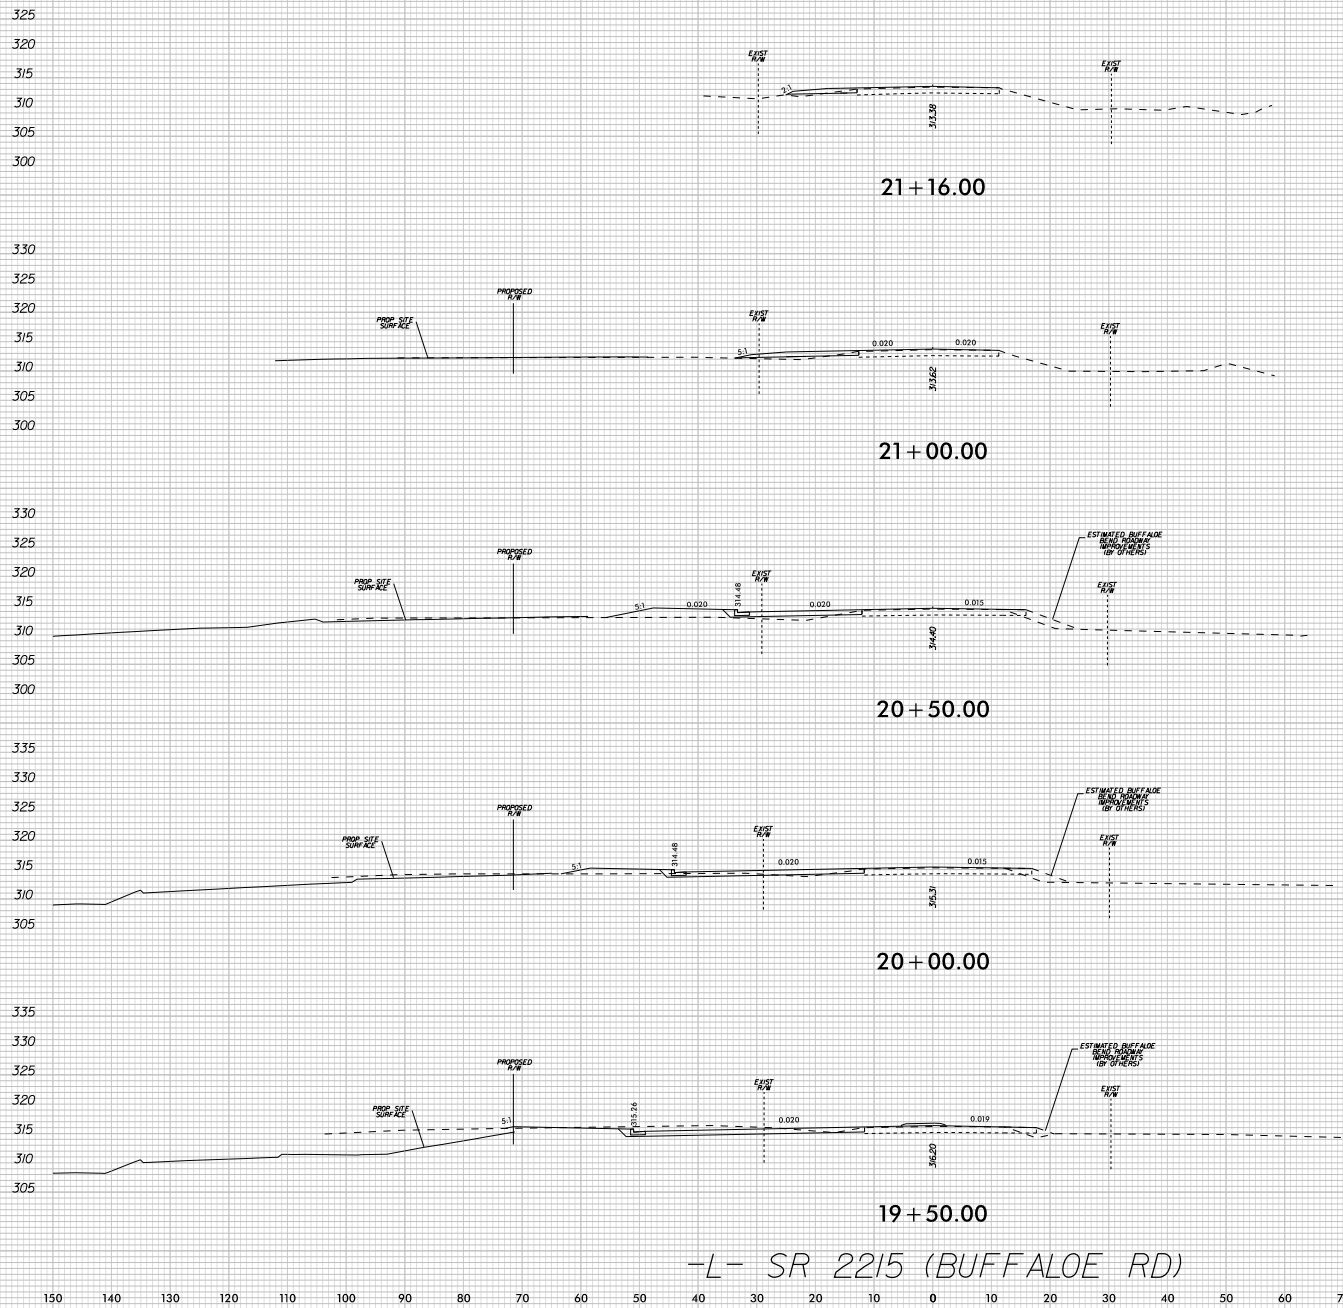

CITY OF RALEIGH - PLANS AUTHORIZED FOR CONSTRUCTION

Plans for the proposed use have been reviewed for general compliance with applicable codes. This limited review, and authorization for construction is not to be considered to represent total compliance with all legal requirements for development and construction. The property owner, design consultants, and contractors are each responsible for compliance with all applicable City, State and Federal laws. This specific authorization below is not a permit, nor shall it be construed to permit any violation of City, State or Federal Law. All Construction must be in accordance with all Local, State, and Federal Rules and Regulations. This approval of this electronic document is only valid if the document has not been modified and the digital signature below is valid:


City of Raleigh Development Approval _____

KHA PROJECT		DATE		SCALE		DESIGNED BY		DRAWN BY		CHECKED BY		BY	
07/22/2020		5/24/2023		1"=10'		EP		EP					
ROADWAY CROSS-SECTIONS												RALEIGH	
SOLIS BUFFALO E OFFSITE ROADWAY												NORTH CAROLINA	
SHEET NUMBER R6.03												DATE	
REVISIONS												BY	
No.													

Kimley»Horn

© 2022
421 FAYETTEVILLE STREET, SUITE 400, RALEIGH, NC 27601
PHONE: 919-555-5617
WWW.KIMLEY-HORN.COM
NC LICENSE # F-002

5/24/2023 K:\RAL_Roadway\07222020 - Buffalo Rd Offsite\Roadway\SC07222020_rdy_pl.dgn

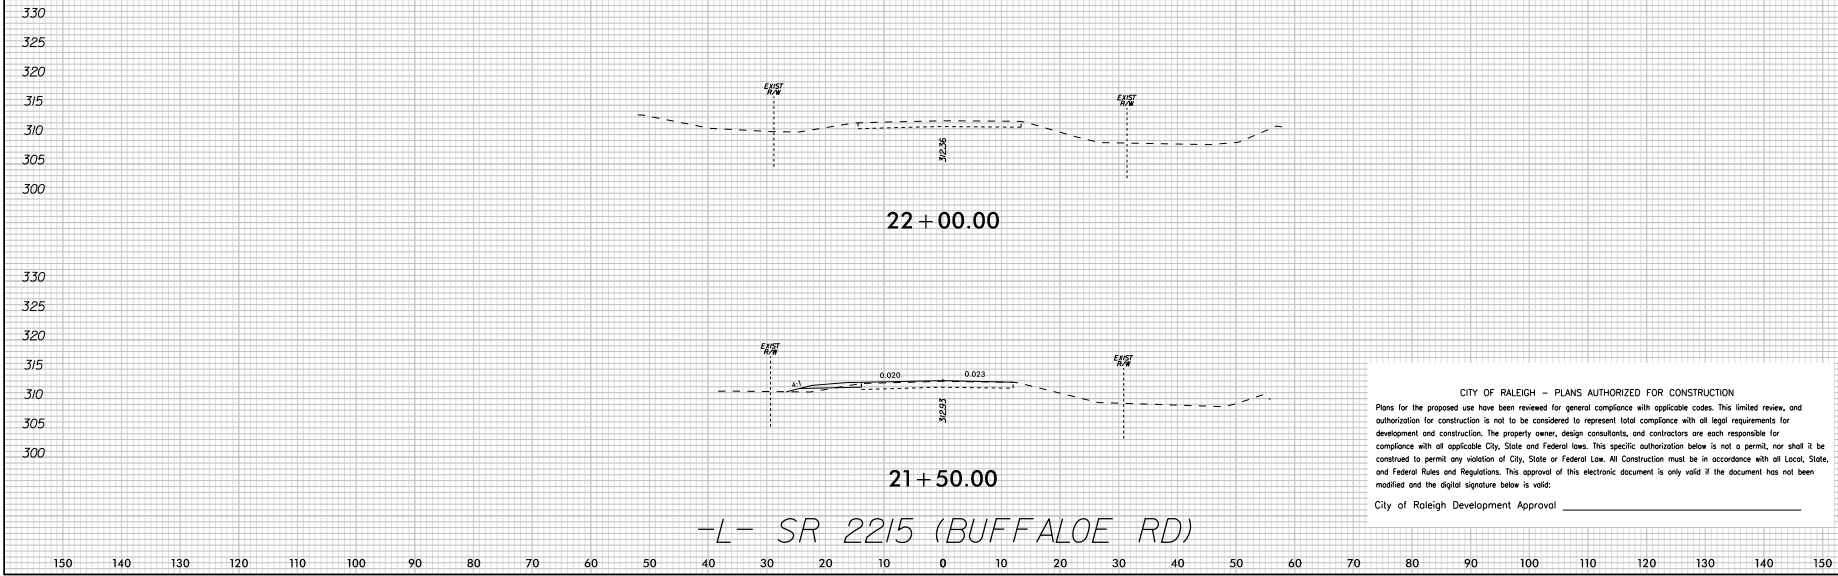


CITY OF RALEIGH - PLANS AUTHORIZED FOR CONSTRUCTION

Plans for the proposed use have been reviewed for general compliance with applicable codes. This limited review, and authorization for construction is not to be considered to represent total compliance with all legal requirements for development and construction. The property owner, design consultants, and contractors are each responsible for compliance with all applicable City, State and Federal laws. This specific authorization below is not a permit, nor shall it be construed to permit any violation of City, State or Federal Law. All Construction must be in accordance with all Local, State, and Federal Rules and Regulations. This approval of this electronic document is only valid if the document has not been modified and the digital signature below is valid:

City of Raleigh Development Approval _____

KHA PROJECT DATE 5/24/2023		SCALE 1"=10'		DESIGNED BY: EP		DRAWN BY:		CHECKED BY: BV							
ROADWAY CROSS-SECTIONS		SHEET NUMBER R6.04		NORTH CAROLINA RALEIGH		Kimley»Horn		© 2022 421 FAYETTEVILLE STREET, SUITE 600, RALEIGH, NC 27601 PHONE: 919-553-5817 WWW.KIMLEY-HORN.COM NC LICENSE # F-002		REVISIONS		DATE		BY	


5/24/2023 K:\RAL_Roadway\07222020 - Bull Creek Rd Offsite\Roadway\SCD\07222020_rdy_wd_Y1.dgn

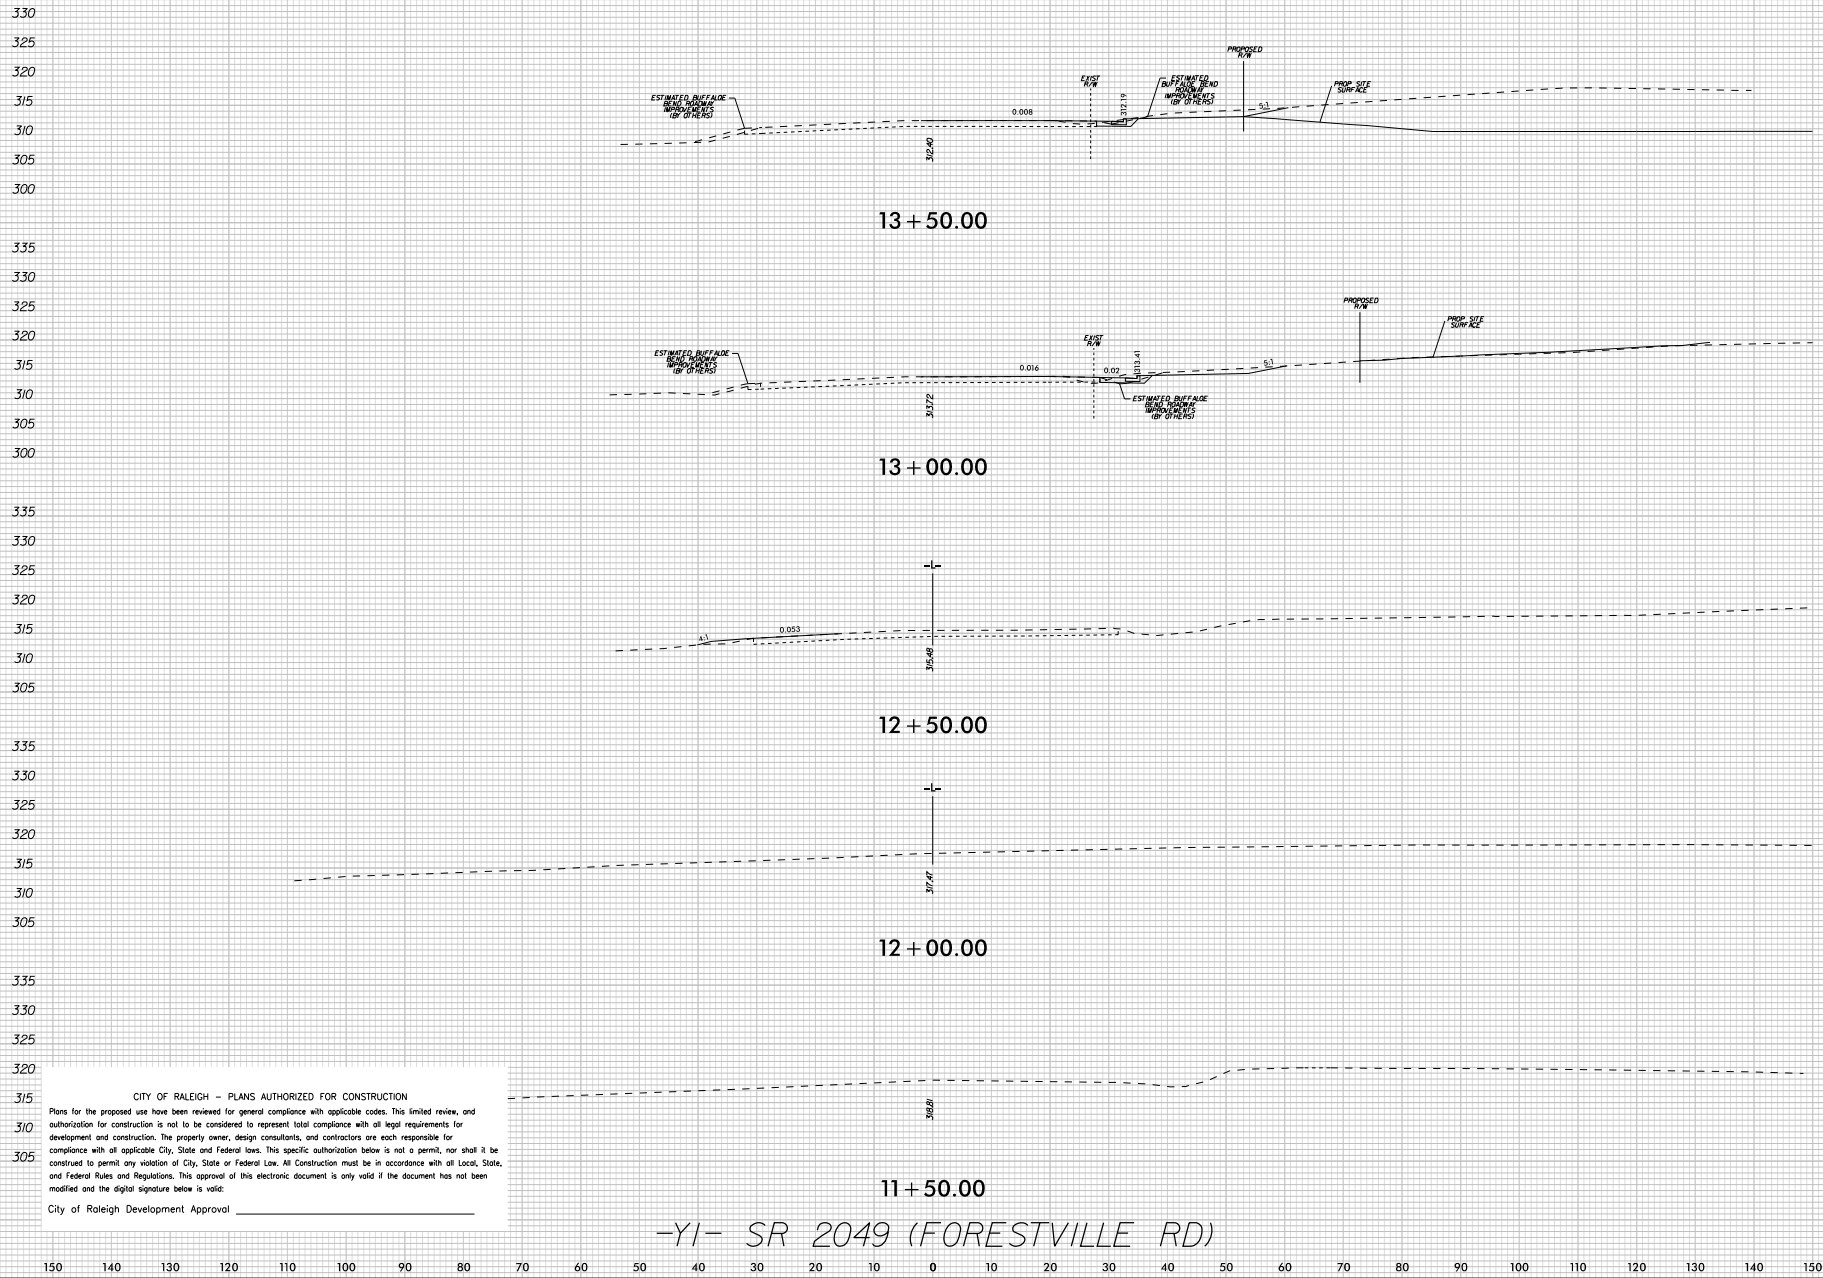

CITY OF RALEIGH - PLANS AUTHORIZED FOR CONSTRUCTION
Plans for the proposed use have been reviewed for general compliance with applicable codes. This limited review, and authorization for construction is not to be considered to represent total compliance with all legal requirements for development and construction. The property owner, design consultants, and contractors are each responsible for compliance with all applicable City, State and Federal laws. This specific authorization below is not a permit, nor shall it be construed to permit any violation of City, State or Federal Law. All Construction must be in accordance with all Local, State, and Federal Rules and Regulations. This approval of this electronic document is only valid if the document has not been modified and the digital signature below is valid:
City of Raleigh Development Approval _____

KIMLEY-HORN		© 2022 421 FAYETTEVILLE STREET, SUITE 400, RALEIGH, NC 27601 PHONE: 919-553-5847 FAX: 919-553-5847 NC LICENSE # F-0022	
PROJECT		DATE	
5/24/2023		5/24/2023	
SCALE		1"=10'	
DESIGNED BY: EP		DRAWN BY: EP	
CHECKED BY: BV		DATE	
ROADWAY CROSS-SECTIONS		REVISED	
SOLIS BUFFALO OFFSITE ROADWAY		No.	
RALEIGH NORTH CAROLINA		BY	
SHEET NUMBER		DATE	
R6.05		BY	

5/24/2023 K:\RAL_Roadway\07222020 - Buffaloe Rd Offsite\Roadway\SCD\07222020_rdy_wd_Y1.dgn

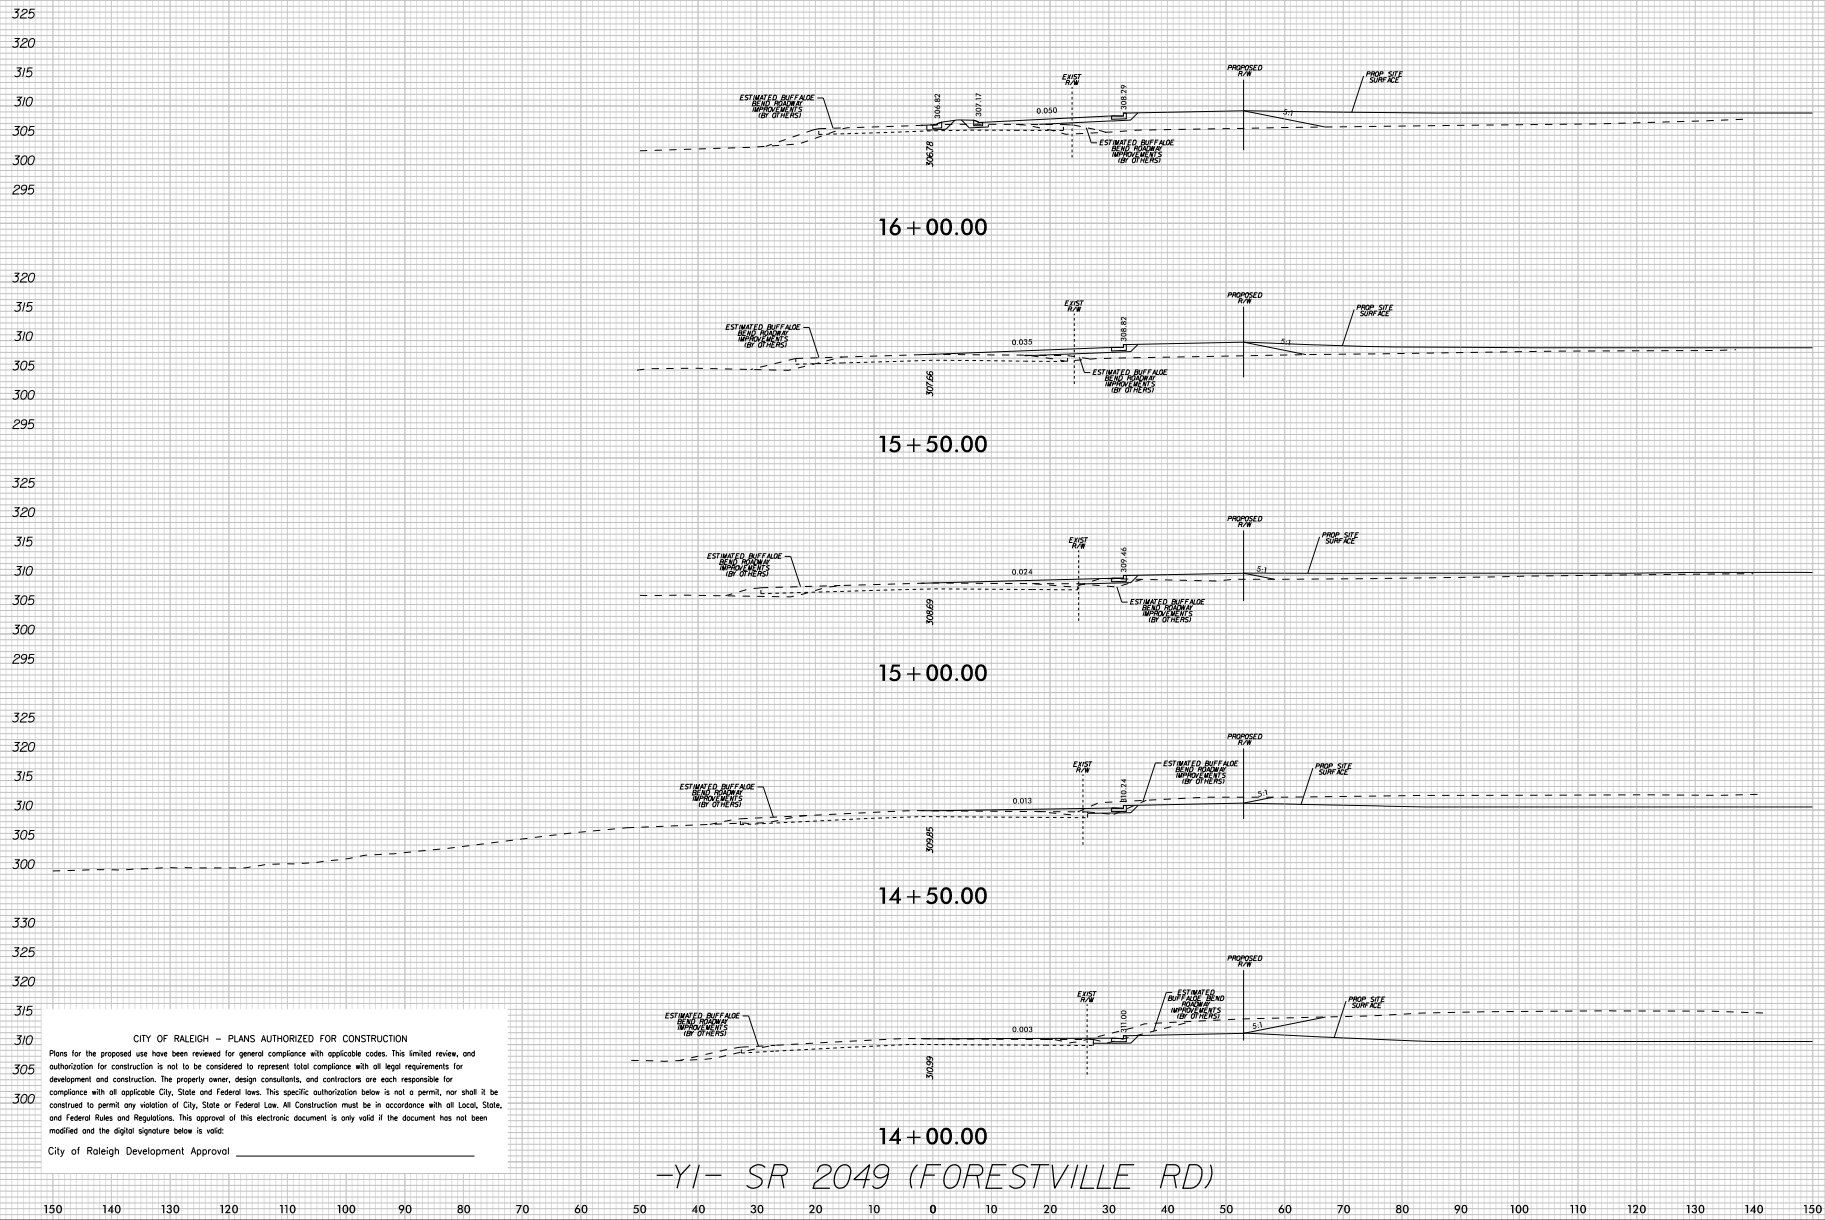

CITY OF RALEIGH - PLANS AUTHORIZED FOR CONSTRUCTION


Plans for the proposed use have been reviewed for general compliance with applicable codes. This limited review, and authorization for construction is not to be considered to represent total compliance with all legal requirements for development and construction. The property owner, design consultants, and contractors are each responsible for compliance with all applicable City, State and Federal laws. This specific authorization below is not a permit, nor shall it be construed to permit any violation of City, State or Federal Law. All Construction must be in accordance with all Local, State, and Federal Rules and Regulations. This approval of this electronic document is only valid if the document has not been modified and the digital signature below is valid:

City of Raleigh Development Approval _____

-YI- SR 2049 (FORESTVILLE RD)


KHA PROJECT 07/22/2020		DATE 5/24/2023		SCALE 1"=10'		DESIGNED BY: EP		DRAWN BY: EP		CHECKED BY: BY	
ROADWAY CROSS-SECTIONS						SHEET NUMBER R6.06					
SOLIS BUFFALOE OFFSITE ROADWAY						RALEIGH NORTH CAROLINA					
Kimley»Horn						© 2022 421 FAYETTEVILLE STREET, SUITE 400, RALEIGH, NC 27601 PHONE: 919-853-5555 FAX: 919-853-5567 WWW.KIMLEY-HORN.COM NC LICENSE # F-0102					
REVISIONS						DATE BY					

5/24/2023

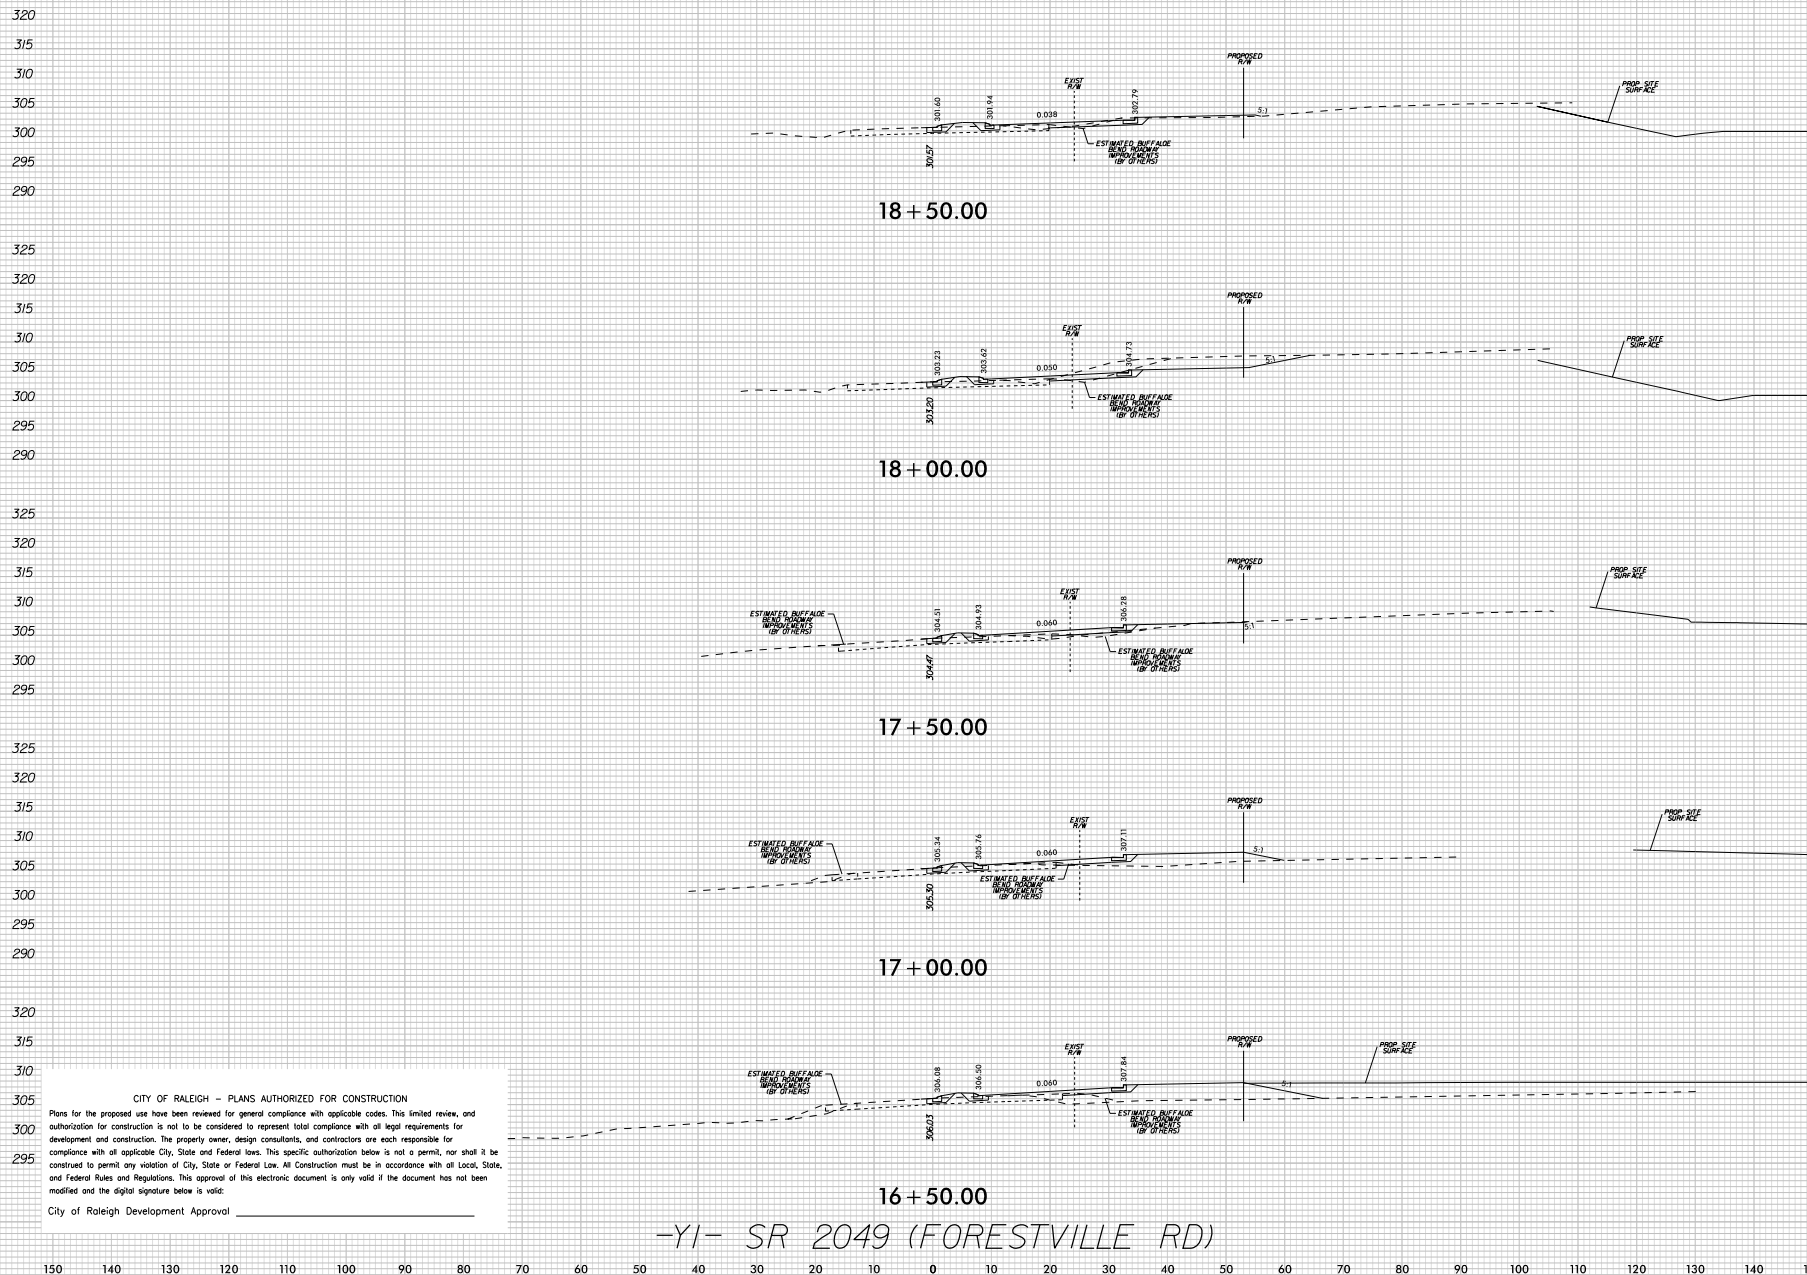

SHEET NUMBER		RALEIGH		NORTH CAROLINA	
R6.07					
SOLIS BUFFALO E		ROADWAY		KHA PROJECT	
OFFSITE ROADWAY		CROSS-SECTIONS		CROSS-SECTION	
				DATE	
				5/24/2023	
				SCALE	
				1"=10'	
				DESIGNED BY:	
				EP	
				DRAWN BY:	
				BP	
				CHECKED BY:	
				BV	

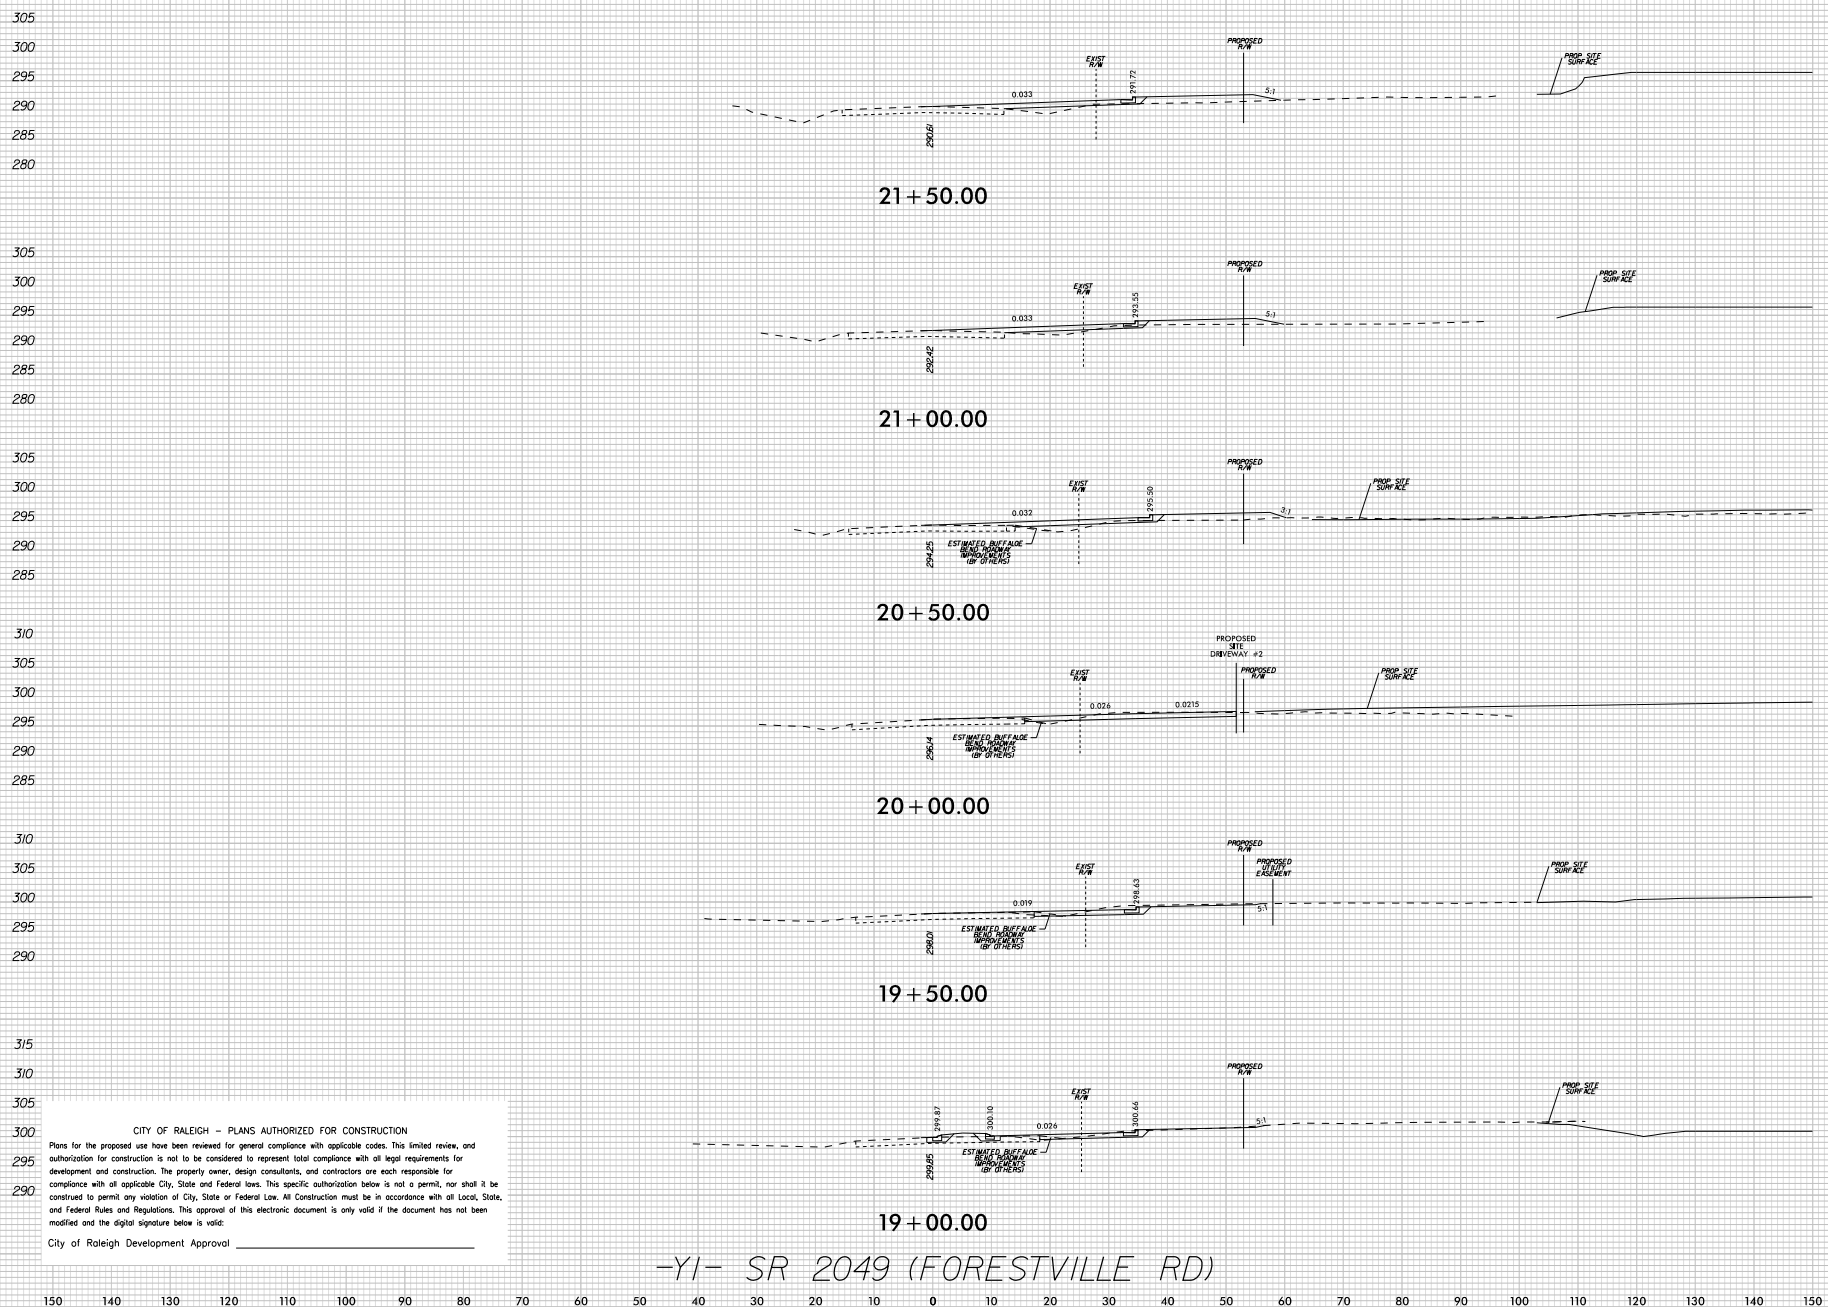

5/24/2023




CITY OF RALEIGH - PLANS AUTHORIZED FOR CONSTRUCTION

Plans for the proposed site have been reviewed for general compliance with applicable codes. This limited review, and authorization for construction is not to be considered to represent total compliance with all legal requirements for development and construction. The property owner, design consultants, and contractors are each responsible for compliance with all applicable City, State and Federal laws. This specific authorization below is not a permit, nor shall it be construed to permit any violation of City, State or Federal Law. All construction must be in accordance with all Local, State, and Federal Rules and Regulations. This approval of this electronic document is only valid if the document has not been modified and the digital signature below is valid:

City of Raleigh Development Approval _____

SHEET NUMBER		R6.08	
SOLIS BUFFALO OFFSITE ROADWAY		NORTH CAROLINA	
ROADWAY		CROSS-SECTIONS	
KNA PROJECT UTTERED	DATE	SCALE	1"=10'
5/24/2023		DESIGNED BY:	EP
		DRAWN BY:	EP
		CHECKED BY:	BP
			
<p>Kimley»Horn</p> <p>© 2022</p> <p>421 FAYETTEVILLE STREET, SUITE 600, RALEIGH, NC 27601 PHONE 919-553-5647 WWW.KIMLEY-HORN.COM</p> <p>NC LICENSE # F-1012</p>		<p>No.</p> <p>REVISIONS</p> <p>DATE</p> <p>BY</p>	

5/24/2023 K:\RAL_Roadway\07222020 - Buffalo Rd Offsite\Roadway\SC07222020_rdy_wd_1.dgn

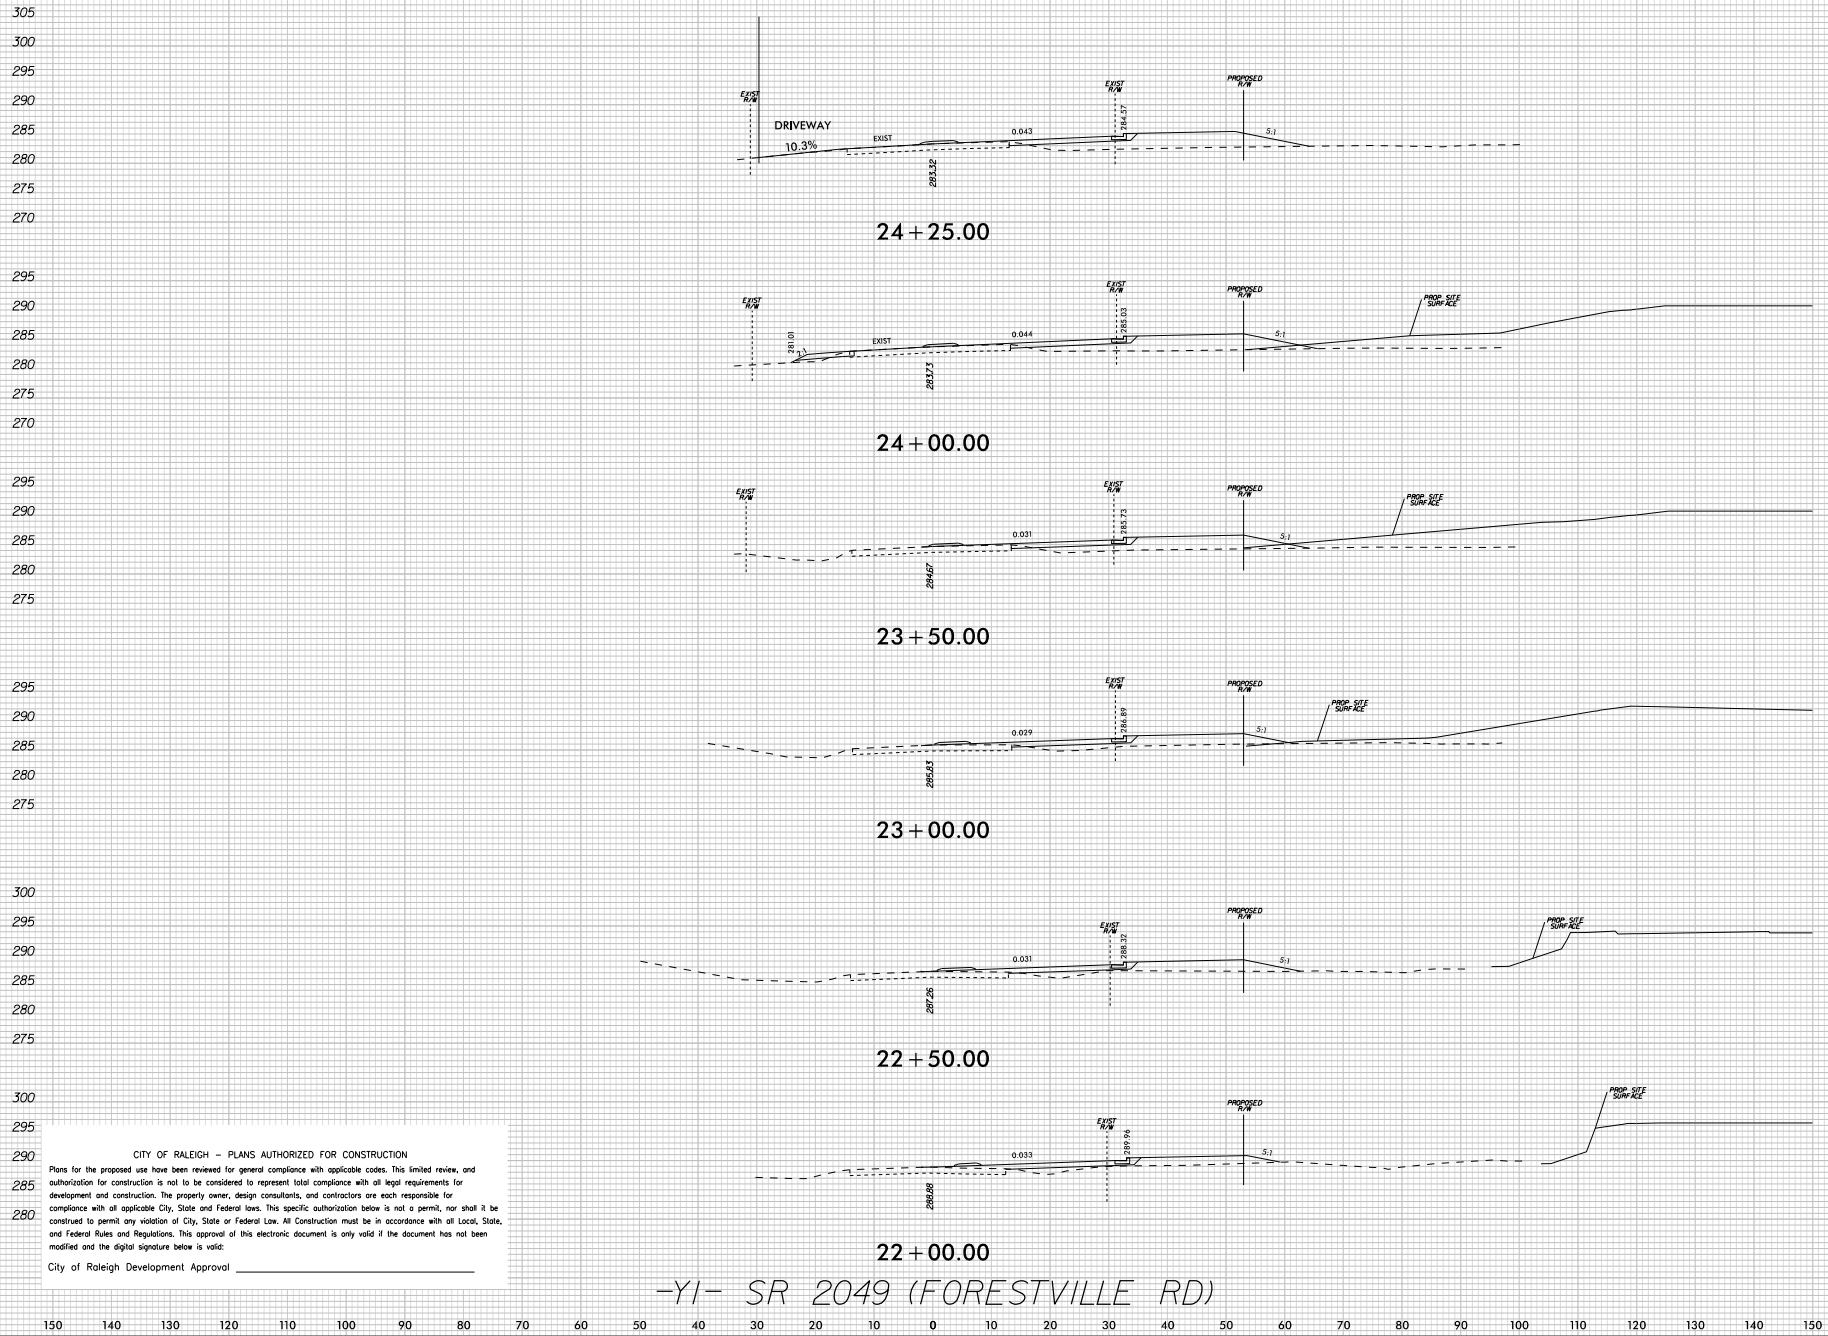


CITY OF RALEIGH - PLANS AUTHORIZED FOR CONSTRUCTION
Plans for the proposed use have been reviewed for general compliance with applicable codes. This limited review, and authorization for construction is not to be considered to represent total compliance with all legal requirements for development and construction. The property owner, design consultants, and contractors are each responsible for compliance with all applicable City, State and Federal laws. This specific authorization below is not a permit, nor shall it be construed to permit any violation of City, State or Federal Law. All Construction must be in accordance with all Local, State, and Federal Rules and Regulations. This approval of this electronic document is only valid if the document has not been modified and the digital signature below is valid:
City of Raleigh Development Approval _____

-YI- SR 2049 (FORESTVILLE RD)

KIMLEY-HORN		DATE		BY	
© 2022		REVISIONS		No.	
421 FAYETTEVILLE STREET, SUITE 400, RALEIGH, NC 27601		No.		No.	
PHONE: 919-876-1000 FAX: 919-876-1001		No.		No.	
WWW.KIMLEY-HORN.COM		No.		No.	
NC LICENSE # F-0102		No.		No.	
KHA PROJECT		DATE		BY	
07/24/2020		5/24/2023		EP	
SCALE		1"=10'		EP	
DESIGNED BY:		DRAWN BY:		CHECKED BY:	
ROADWAY		CROSS-SECTIONS		NORTH CAROLINA	
SOLIS BUFFALO		OFFSITE ROADWAY		RALEIGH	
SHEET NUMBER		R6.09		RALEIGH	

K:\RAL_Roadway\07222020 - Buffaloe Rd Offsite\Roadway\SCD\07222020_rdy_wd_1.dgn
5/24/2023

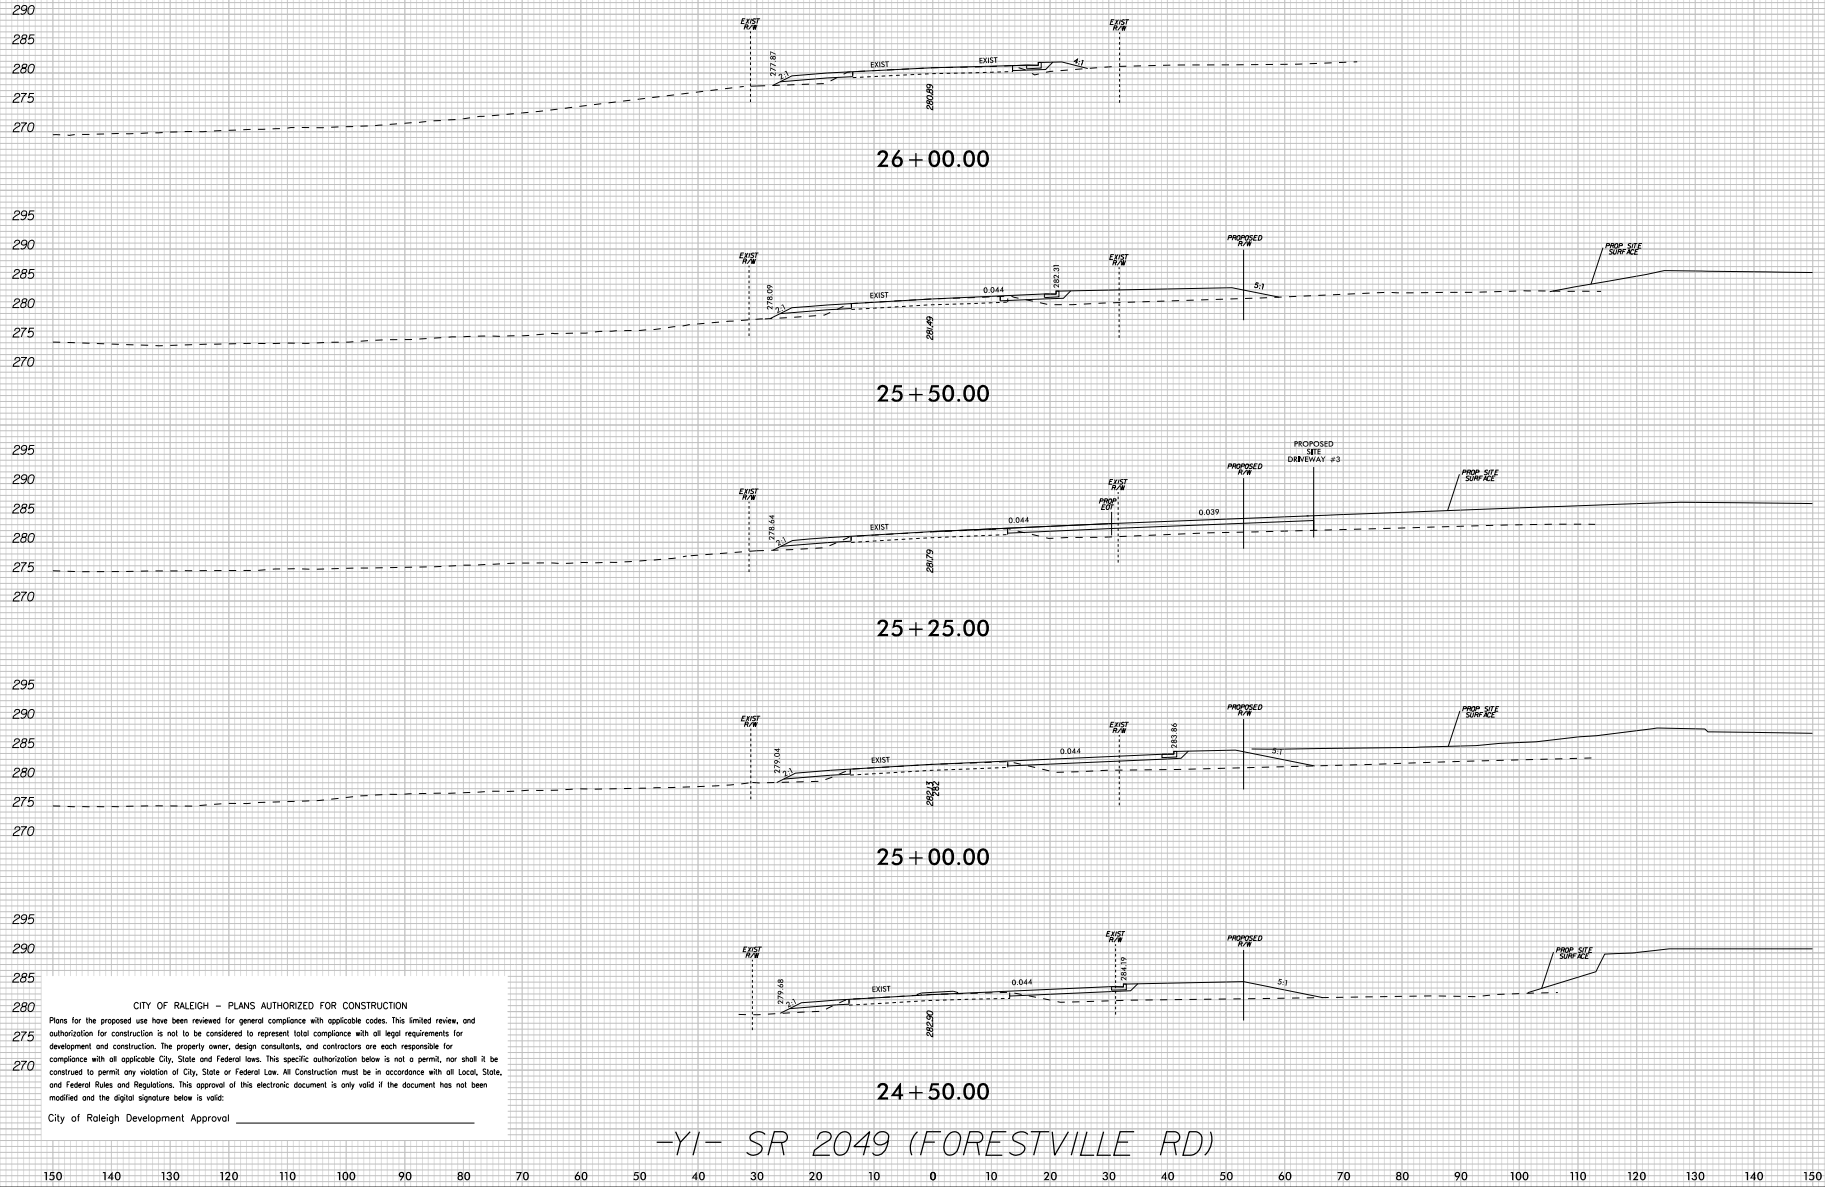


SHEET NUMBER
R6.10

SOLIS BUFFALO
OFFSITE ROADWAY

RALEIGH NORTH CAROLINA

ROADWAY
CROSS-SECTIONS


KHA PROJECT
07/22/2020
DATE
5/24/2023
SCALE
1"=10'
DESIGNED BY: EP
DRAWN BY: EP
CHECKED BY: BY

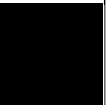






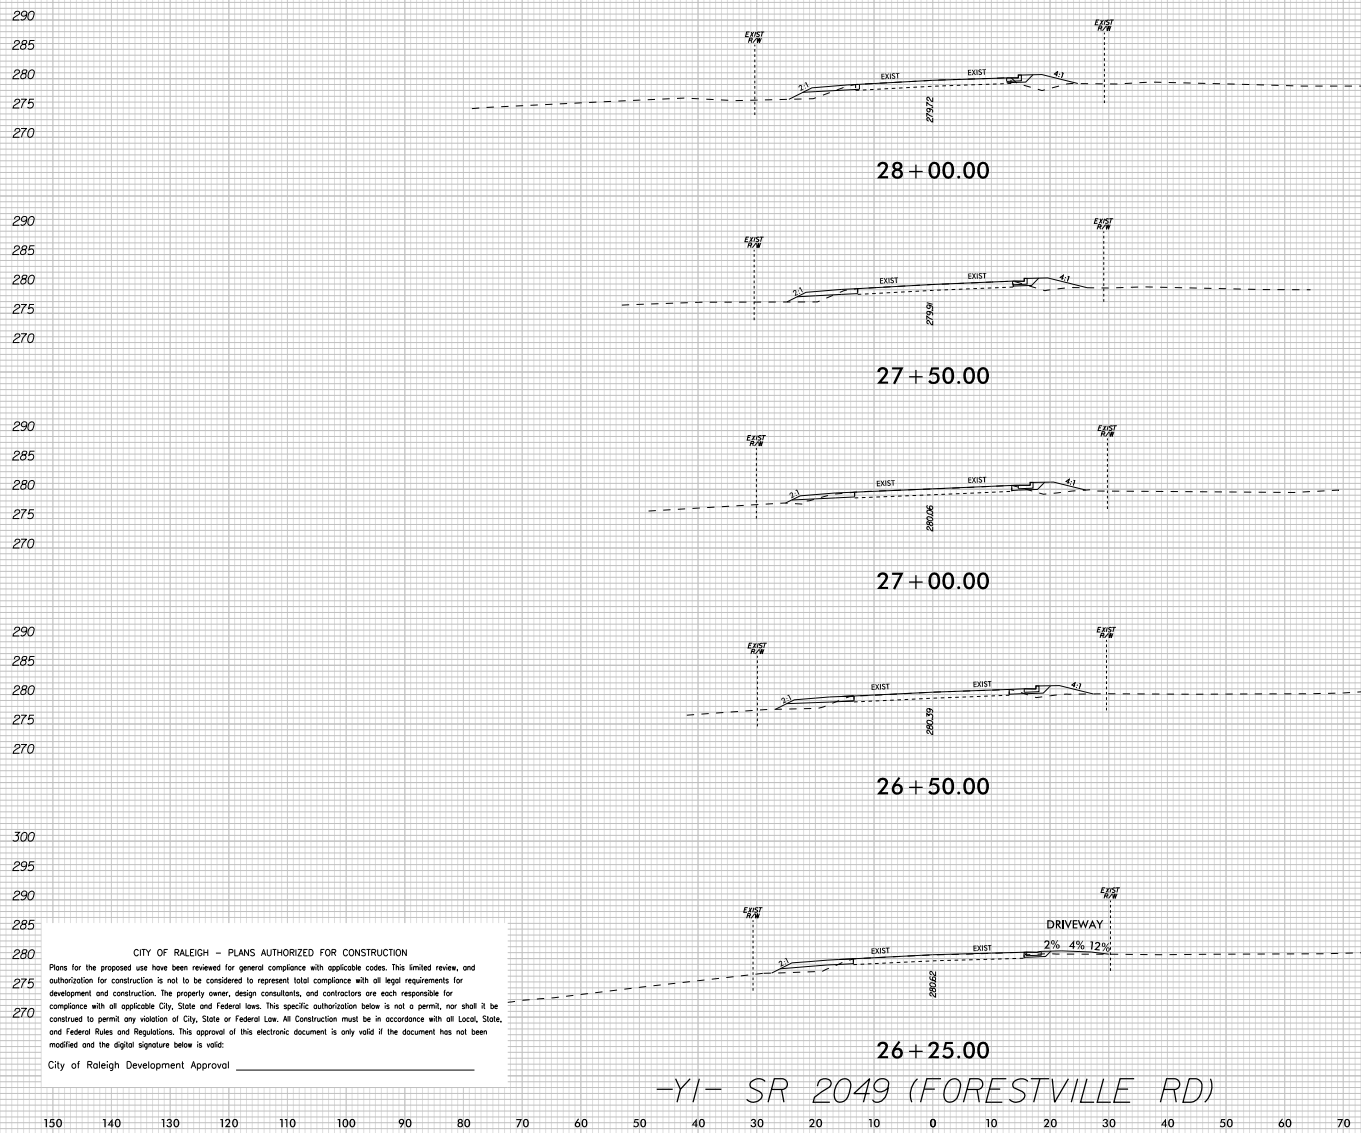


Kimley-Horn
© 2022
421 FAYETTEVILLE STREET, SUITE 400, RALEIGH, NC 27601
PHONE: 919-555-5555
WWW.KIMLEY-HORN.COM
NC LICENSE # F-0022

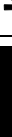
REVISIONS
No. DATE BY

5/24/2023



SHEET NUMBER R6.11	SOLIS BUFFALO OFFSITE ROADWAY NORTH CAROLINA RALEIGH	ROADWAY CROSS-SECTIONS	KHA PROJECT 07222020	DATE 5/24/2023	SCALE 1"=10'	DESIGNED BY EP	DRAWN BY EP	CHECKED BY BV																																																																																																		
------------------------------	---	---------------------------	-------------------------	-------------------	-----------------	-------------------	----------------	------------------	---	---	--	---	---	--	--	
5/24/2023 K:\RAL_Roadway\07222020 - Bull Creek Rd Offsite Roadway\SCD\07222020_rdy_wd.Y1.dgn

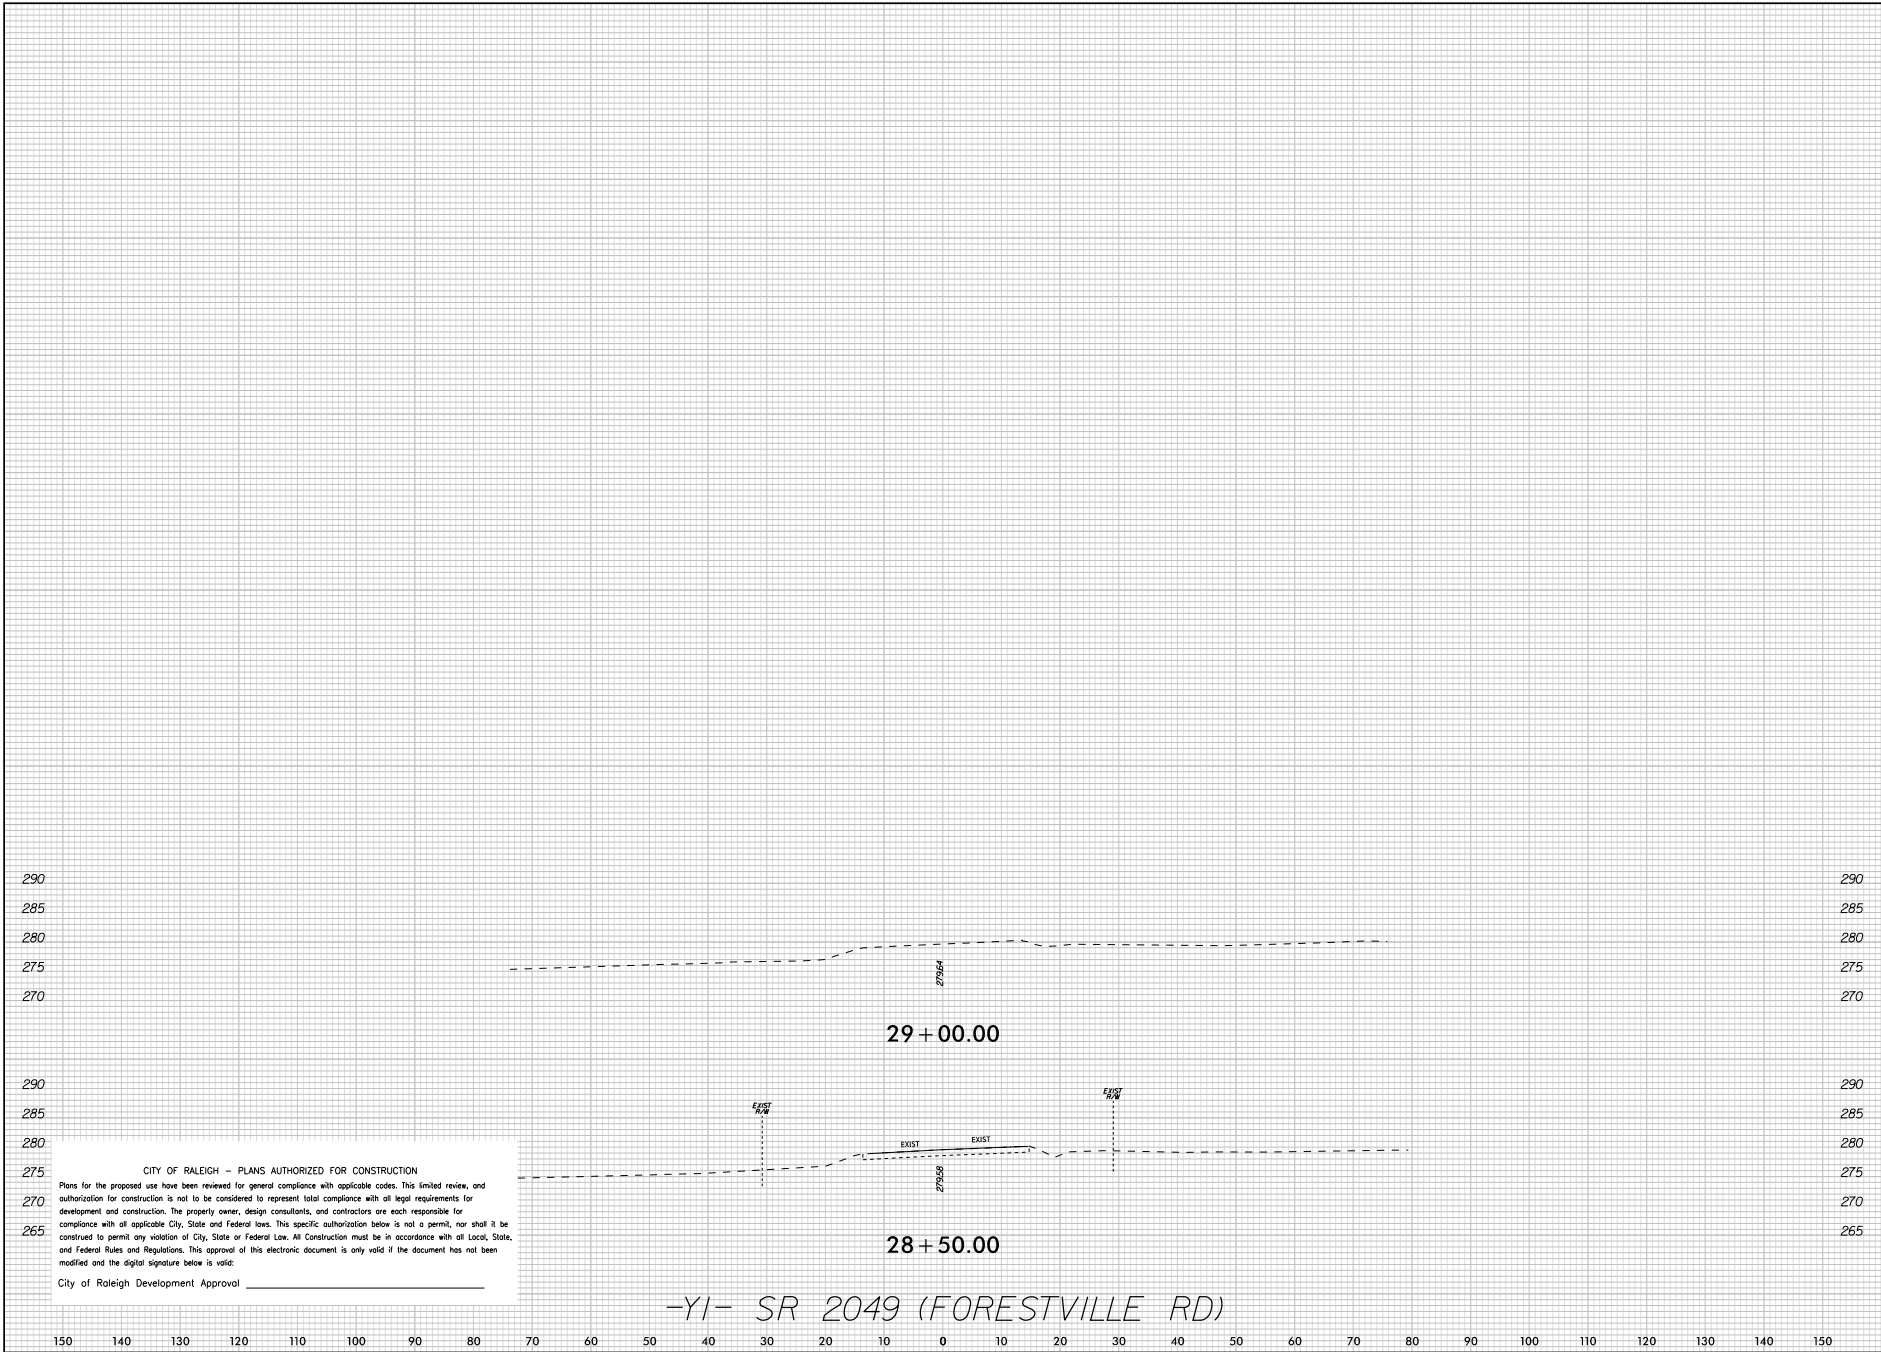

CITY OF RALEIGH - PLANS AUTHORIZED FOR CONSTRUCTION
Plans for the proposed use have been reviewed for general compliance with applicable codes. This limited review, and authorization for construction is not to be considered to represent total compliance with all legal requirements for development and construction. The property owner, design consultants, and contractors are each responsible for compliance with all applicable City, State and Federal laws. This specific authorization below is not a permit, nor shall it be construed to permit any violation of City, State or Federal Law. All Construction must be in accordance with all Local, State, and Federal Rules and Regulations. This approval of this electronic document is only valid if the document has not been modified and the digital signature below is valid:
City of Raleigh Development Approval _____

-YI- SR 2049 (FORESTVILLE RD)

KHA PROJECT 07/22/2020		DATE 5/24/2023		SCALE 1"=10'		DESIGNED BY: EP		DRAWN BY: EP		CHECKED BY: BY	
ROADWAY CROSS-SECTIONS						SHEET NUMBER R6.12					
SOLIS BUFFALO OFFSITE ROADWAY						RALEIGH NORTH CAROLINA					
Kimley»Horn						© 2022 421 FAYETTEVILLE STREET, SUITE 600, RALEIGH, NC 27601 PHONE: 919-853-5847 FAX: 919-853-5847 WWW.KIMLEY-HORN.COM NC LICENSE # F-002					
REVISIONS						DATE					
BY						DATE					



PROPRIETARY & CONFIDENTIAL

ent together with the concepts and designs presented herein, as an instrument of service, is the sole property of Duke Energy. It is intended only for the specific purpose and prospective use stated in the title block of this drawing. Any use, copying, reproduction or disclosure of the drawing, design or any information contained herein by the prospective customer or other entities, including consultants, architects, engineers, or equipment manufacturers is expressly prohibited and shall not be permitted absent prior written consent, and payment of compensation to Duke Energy. Duke Energy disclaims any liability or responsibility for any use of or reliance on this document.

<p align="center">BUFFALO E ROAD MULTIFAMILY</p> <p align="center">Raleigh, NC</p> <p align="center">SITE LIGHTING ARRANGEMENT</p>		
Designed by	DUKE ENERGY PROGRESS LIGHTING SOLUTIONS	
Reviewed by	N. Johnson	Scale 1" = 80'
Date	02/22/2023	Size Drawing size "D"
Description	LED Shoebox	
Drawing No.	23-0084A	Sht. 1 OF 1



Shoobox LED

Light fixture LED fixture
LED fixture LED fixture
LED fixture LED fixture
LED fixture LED fixture

Shoobox LED

Light fixture LED fixture
LED fixture LED fixture
LED fixture LED fixture
LED fixture LED fixture

Light fixture LED fixture
LED fixture LED fixture
LED fixture LED fixture
LED fixture LED fixture

Light fixture LED fixture
LED fixture LED fixture
LED fixture LED fixture
LED fixture LED fixture

Light fixture LED fixture
LED fixture LED fixture
LED fixture LED fixture
LED fixture LED fixture

Statistics						
Description	Symbol	Avg	Max	Min	Max/Min	Avg/Min
Parking	✱	1.5 fc	4.2 fc	0.4 fc	10.5:1	3.8:1

Symbol	Label	Quantity	Description	Number Lamps	Lumens Per Lamp	Light Loss Factor
✱	A	19	LED 150w Shoobox - Type IV - 4000K	48	385	0.85
✱	B	4	(2) LED 150w Shoobox - Type IV - 4000K	48	385	0.85
✱	C	1	LED 50w Shoobox - Type IV - 3000K	16	382	0.85

NO.	DATE	REVISION	BY

LIGHTING DESIGN TOLERANCE
The calculated footcandle light levels in this lighting design are predicted values and are based on specific information that has been supplied to Duke Energy. Any inaccuracies in the supplied information, differences in luminaire installation, lighted area geometry including elevation differences, reflective properties of surrounding surfaces, obstructions (foliage or otherwise) in the lighted area, or lighting from sources other than listed in this design may produce different results from the predicted values. Normal tolerances of voltage, lamp output, and ballast and luminaire manufacture will also affect results.



PROPRIETARY & CONFIDENTIAL
This document together with the concepts and designs presented herein, presented as an instrument of service, is the sole property of Duke Energy, and is intended only for the specific purpose and prospective client as stated in the title block of this drawing. Any use, copying, reproduction or disclosure of the drawing, design or any information contained herein by the prospective customer or other entities, including without limitation, architects, engineers, or equipment manufacturers is hereby expressly prohibited and shall not be permitted absent prior written consent from, and payment of compensation to Duke Energy. Duke Energy disclaims any liability or responsibility for any unauthorized use of or reliance on this document.

Buffalo Road Multifamily	
Raleigh, NC	
SITE LIGHTING ARRANGEMENT	
Designed by	DUKE ENERGY PROGRESS LIGHTING SOLUTIONS
Reviewed by	N. Johnson
Date	02/22/2023
Description	LED Shoobox
Drawing No.	23-0084A
Sheet	1 OF 1