

# Administrative Approval Action

Case File / Name: ASR-SR-19-2019 HOME 2 SUITES RALEIGH City of Raleigh
Development Services Department
One Exchange Plaza
Raleigh, NC 27602
(919) 996-2492
currentplanning@raleighnc.gov
www.raleighnc.gov

LOCATION:

This site is located between Chapel Hill Road and Corporate Ridge Road at 6110 and

6114 Corporate Ridge Road. The PIN numbers identifying these lots are 0774622792

and 0774624675.

**REQUEST:** 

The applicant is proposing 65,445 square feet of gross floor area for a hotel with 4 stories on two lots to be recombined. The site is zoned Commercial Mixed Use (CX-4-PL) with a Parking Limited Frontage and is located in the Special Highway

Overlay District-1 (SHOD-1).

**DESIGN** 

ADJUSTMENT(S)/

ALTERNATES, ETC:

N/A

FINDINGS:

City Administration finds that this request, with the below conditions of approval being met, conforms to the Unified Development Ordinance. This approval is based on a preliminary plan dated August 2, 2019 by Pabst Design

Group.

## **CONDITIONS OF APPROVAL and NEXT STEPS:**

This document must be applied to the second sheet of all future submittals except for final plats. This is a preliminary plan and as such no permits have been issued with this approval. To obtain permits and/or completion of the project, the following steps are required:

☑ <u>SITE PERMITTING REVIEW</u> - For land disturbance of 12,000 square feet or greater, public or private infrastructure, shared stormwater devices, etc. Site Permitting Review may be submitted upon receipt of this signed approval document.

The following items are required prior to approval of Site Permitting Review plans:

### Engineering

 Required NCDOT encroachment and/or driveway permits must be approved and copies provided to Development Services – Development Engineering prior to concurrent review approval.

### Stormwater

2. A surety equal to of the cost of clearing, grubbing and reseeding a site, shall be paid to the City (UDO 9.4.4).

☑ <u>BUILDING PERMITS</u> - For buildings and structures shown on the approved plans. Commercial building permit plans must include the signed, approved Site Permitting Review plans attached, if applicable. Permit sets may be reviewed prior to the recordation of required plats, but cannot be approved.

The following items must be approved prior to the issuance of building permits:

### General

1. A recombination map shall be recorded, recombining the existing two lots into a single tract.



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2. Verification shall be provided that a private drainage easement exists between existing lots 3 and 4 of BM2009 PG 1170 to accommodate the drainage pipe crossing the shared property line between the two lots on the north side of those lots (shown on sheet C-4.0 of the preliminary plan as EX 24" RCP). If no private drainage easement exists in that location then one shall be recorded and a copy of the approved and recorded plat shall be provided to the City.

### Engineering

- 3. A 5' general utility easement and associated deed of easement shall be approved by the City and the location of the easement shall be shown on the map approved for recordation. The deed of easement shall be recorded at Wake County Register of Deeds within one day of recordation of the recorded plat. A recorded copy of this document must be provided to the Development Services Department within one day from authorization of lot recordation. If a recorded copy of the document is not provided within this time, further recordings and building permit issuance will be withheld.
- 4. A fee-in-lieu for 3.5-ft sidewalk width along Chapel Hill Rd where no sidewalk is being proposed shall be paid to the City of Raleigh (UDO 8.1.10). A fee-in-lieu was already paid for 2.5-ft of sidewalk width.
- 5. The required right of way for proposed and/or existing streets shall be dedicated to the City of Raleigh and is shown on a plat approved for recordation.
- 6. A public infrastructure surety shall be provided to the City of Raleigh Development Services Development Engineering (UDO 8.1.3).
- 7. A cross access agreement between the lots identified as PINs 0774624675 and 0774626661 (shown as lots 5 and 6 on BM2009 PG1170) for the proposed driveway between these lots shall be approved by the Development Services Department for recording in the Wake County Registry, and a copy of the recorded cross access easement shall be returned to the Development Services Department within one day of plat recordation. If a recorded copy of the document is not provided, further recordings and building permit issuance will be withheld.

### **Urban Forestry**

8. A tree impact permit must be obtained for the approved streetscape tree installation in the right of way. This development proposes 6 street trees along Corporate Ridge Road and 17 street trees along Chapel Hill Road for a total of 23 street trees.

The following are required prior to issuance of building occupancy permit:

### General

1. Final inspection of all right of way street trees by Urban Forestry Staff.

**EXPIRATION DATES:** 

The expiration provisions of UDO Section 10.2.8 E, including the ability to request extensions in the expiration date, apply to this site plan. If significant construction has not taken place on a project after administrative site review



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approval, that approval may expire and be declared void, requiring re-approval before permits may be issued. To avoid allowing this plan approval to expire the following must take place by the following dates:

**3-Year Expiration Date:** September 19, 2022 Obtain a valid building permit for the total area of the project, or a phase of the project.

4-Year Completion Date:

Within four years after issuance of the first building permit for the site plan, the construction of the entire site plan must be completed unless an applicant has been granted vested rights. Failure to complete construction within this specified time frame shall automatically void the approved site plan for which no building permits have been issued.


I hereby certify this a	administrative decision.		
Signed:	Insta, Ponth	Date:	09/19/2019
	Development Services Dir/Designee		
Staff Coordinator	Daniel Sterall		

# ADMINISTRATIVE SITE REVIEW PLAN FOR: HOME 2 SUITES RALEIGH

RALEIGH, NORTH CAROLINA

	trative Sit (for UDO I			licati	on		SI	ELOPME ERVICES PARTME
Development S	ervices Customer Litchford Sa	Service Cente tellite Office						9-996-1831
When sub	mitting plans, ple	ase check the a	ppropriate	building t	type and incl	ude the Plan C	hecklist docun	nent.
1		BUILDING	TYPE				FOR OFFI	CE USE ONLY
☐ Detached			Ģeneral				Transac	tion Number
Attached			Mixed Use				Assigned Pro	ject Coordinator
Apartment			Open Lot					
Townhouse				١.			Assigned	Team Leader
Has your project previou	sly been through the	Due Diligence o	or Sketch Pla	ın Review I	process? If yes	, provide the tra	nsaction #	9.11
	and the second second	Established	GENERAL IN	8-88 - C-387/38	AND WARREN			
Development Name Ho						- 1 Carlo		ang a area sang s
			f annlianhla	01101			nits? Yes	$\square_{No}$
Zoning District CX-2	1-PL (	Overlay District (i	т аррисавіе)	SHO	J-1	Inside City Lim	nits?	⊔No
Proposed Use Hotel								
Property Address(es) 6	110 and 6114	Corporate	Ridge F	Road	Major Stree	t Locator: Cha	pel Hill Ro	ad (54)
Wake County Property I	dentification Numbe	er(s) for each par	cel to which	these guid	elines will app	oly:		***************************************
P.I.N. 077462279	2 P.I.N.	077462467	 '5	P.I.N.		P	.I.N.	
What is your project type?  Mixed Residential  Duplex Other: If other, please d	Apartment Non-Residential C	ondo $\square$	Elderly Facilit School Religious Insti		Hospitals Shopping Cent Residential Co	ter 🔲 Bai	nks [	Office Industrial Bu Cottage Cou
WORK SCOPE	Per City Code Sect occupancy (per Ch New hotel; 4 regional storr	apter 6 of the UI Story w/ +/-	00), indicate 110 roon	impacts ons. Ass	n parking requ	uirements.		e to exis
DESIGN ADJUSTMENT OR ADMIN ALTERNATE	Per City Code Chap Administrative AE Design adj					sign adjustment,	or Section 10 -	Alternate
CLIENT/DEVELOPER/ OWNER	Company Oaks Hospitality, LLC Name (s) Ajay Mulcl		nandani	1.00010000				
	Address 840 Handsworth Lane Unit 01-306, Raleigh, NC 2760							
	Phone 919.80					@yahoo.co		
	Company Pab	st Design (	Group, P	'A	Name (s)	Jim Clark	, PE	
CONSULTANT (Contact Person for Plans)	Address 404E	Glenwood	Avenue	, Raleig	jh, NC 27	603		

DEVELOPMENT TYPE & SITE DATA	A TABLE (Appli	cable to all develo	oments)			
Zoning Information		I shi da Bara sa Bara sa	Building Info	rmation		
Zoning District(s) CX-4-PL	is ten 64MM iss. Moo	Proposed building	2600FG.46T.8640	1 1 500 p 50 1 1 1 2 1 A	100 May 183	
If more than one district, provide the acreage of each: n/a	-	Existing Building(s)				
Overlay District SHOD-1	ь	Proposed Building				
Total Site Acres Inside City Limits ■ Yes □ No 2.29 acre	9S	Total sq. ft. gross (	existing & pro	posed) 65.4	45	
Off street parking: Required 110 Provided 110	1	Proposed height o	- Arm			
COA (Certificate of Appropriateness) case # n/a		# of stories 4		U DANS		
BOA (Board of Adjustment) case # A- n/a		Ceiling height of 1 <sup>s</sup>	Floor 8'1(	)" (9'6" in a	areas)	
CUD (Conditional Use District) case # Z- n/a		D D	100			
To a state of the	ater Information				4 00 to 1	
Existing Impervious Surface 0.049/2135 acres/square feet		Flood Hazard Area	□ <sub>Yes</sub> ■	No		
Proposed Impervious Surface 1,69/73766 acres/square feet		If Yes, please prov		***		
Neuse River Buffer ☐ Yes ☐ No Wetlands ☐ Yes ☐		Alluvial Soils <b>n/a</b> FEMA Map Panel #		Flood Study <b>r</b> 7400J	n/a	
FOR RESIDEN	ITIAL DEVELOP					
Total # Of Apartment, Condominium or Residential Units	5. Bedroo	m Units: 1br 2l	or 3br	4br or more	<u> </u>	
2. Total # Of Congregate Care Or Life Care Dwelling Units	6. Infill De	6. Infill Development 2.2:7				
3. Total Number of Hotel Units	7. Open S	7. Open Space (only) or Amenity				
4. Overall Total # Of Dwelling Units (1-6 Above)		project a cottage cou		□ <sub>No</sub>		
SIGNATURE BLOCK (A	pplicable to all	developments)				
In filing this plan as the property owner(s), I/we do hereby agree and and assigns jointly and severally to construct all improvements and napproved by the City.  I hereby designate Pabst Design Group, Pareceive and respond to administrative comments, to resubmit plans application.	make all dedication	ons as shown on this to serve as my a	oroposed de gent regardir	velopment plan	n as on, to	
I/we have read, acknowledge and affirm that this project is conformi	ing to all applicat	ion requirements ap	olicable with	the proposed d	levelopm	
use.		e v	Date 3	7/19		
Printed Name Ajay Mulchandani	o c				manufacture (	
ruised range	· .	_ v		, G		
Signed		d.	Date			
Printed Name	9			a a		
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a	u n	<sup>M</sup> d	ь	ė	0	
e	9					
			th .			

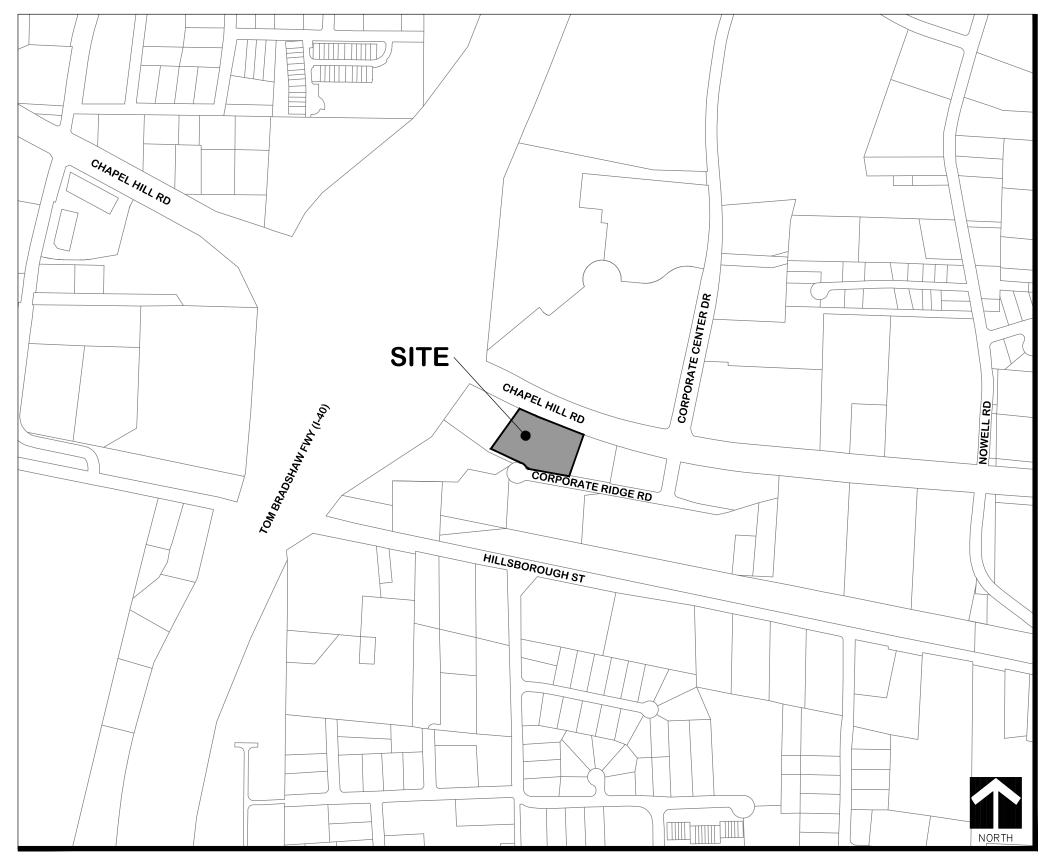

VICINITY MAP 1" = 500'

OWNER:
OAKS HOSPITALITY, LLC
840 HANDSWORTH LANE UNIT 01-306
RALEIGH, NC 27607
TEL: 919.802.1370
E-MAIL: ajaycenterpointe@yahoo.com
CIVIL ENGINEER:
PABST DESIGN GROUP, PA
404-B GLENWOOD AVENUE
RALEIGH, NC 27603
TEL: 919.848.4399
FAX: 919.848.4395
E-MAIL: jclark@pabstdesign.com
ARCHITECT:
R4 ARCHITECTURE
2000 SAM RITTENBERG BOULEVARD
CHARLESTON, SC 29407
TEL: 843.531.6848
E-MAIL: kwoudstra@r4architecture.com
SURVEYOR:
CDK GEOMATICS, PC
1340 SE MAYNARD ROAD
CARY, NC 27511
TEL: 919.535.3225
F-MAII · kniver@cdk-geo.com

1. ALL CONSTRUCTION SHALL BE DONE IN ACCORDANCE WITH ALL CITY O

2. A TREE CONSERVATION AREA PER UDO SECTION 9.1.2 IS NOT REQUIRE FOR THIS SITE BECAUSE IT WAS PROVIDED ELSEWHERE WITHIN THE PARITRACK OF THE SUBDIVISION WHEN THE TWO SUBJECT LOTS WERE

	INDEX TO PLANS
C-0.0	COVER SHEET
	BM 2009 PG 1170-71 (CURRENT PLAT)
C-1.0	<b>EXISTING CONDITIONS &amp; DEMOLITION PLAN</b>
C-2.0	SITE LAYOUT PLAN
C-2.1	TRASH TRUCK TEMPLATE INGRESS/EGRESS
C-2.2	FIRE TRUCK TEMPLATE INGRESS/EGRESS
C-2.3	ADA ACCESSIBILITY PLAN
C-3.0	UTILITY PLAN
C-4.0	GRADING & STORM DRAINAGE PLAN
C-4.1	BUILDING HEIGHT COMPLIANCE
D-1.0	SITE DETAIL SHEET
D-1.1	SITE DETAIL SHEET
D-2.0	UTILITY DETAIL SHEET
D-2.1	UTILITY DETAIL SHEET
D-3.0	STORM DRAINAGE DETAIL SHEET
L-1.0	LANDSCAPE PLAN
L-1.1	LANDSCAPE DETAIL SHEET
19-0137A	LED 205 SHOEBOX
A100a	STORAGE & TRASH ENCLOSURE - PLAN,
Lumin 1	SECTIONS & DETAILS
A101b-A105	PRELIMINARY FIRST FLOOR PLAN
A200-A201	PRELIMINARY EXTERIOR ELEVATIONS
A901	WINDOW ELEVATIONS

# **MUNICIPAL CONTACT LIST**

PLANNING AND ZONING
CITY OF RALEIGH
PLANNING DEPARTMENT
JUSTIN RAMETTA, PLANNER II
ONE EXCHANGE PLAZA, 3RD FLOOR
RALEIGH, NC 27601
919.996.2665

STREETS AND HIGHWAYS

DIVISION 5, DISTRICT 1
M. SCOTT WHEELER, PE
4009 DISTRICT DRIVE
RALEIGH, NC 27607
919.733.3213
919.715.5778 FAX

BUILDING INSPECTIONS

BUILDING INSPECTIONS
CITY OF RALEIGH
BUILDING & SAFETY DIVISION
CURT WILLIS
ONE EXCHANGE PLAZA, STE. 504
RALEIGH, NC 27601
919.516.2723

EROSION CONTROL CITY OF RALEIGH STORMWATER ADMINISTRATOR BEN BROWN, PE ONE EXCHANGE PLAZA RALEIGH, NC 27601 919.996-3515 WATER AND SEWER
CITY OF RALEIGH
PUBLIC UTILITIES DEPARTMENT
BRIAN CASEY
ONE EXCHANGE PLAZA
RALEIGH, NC 27601
919.996.2207

ELECTRIC SERVICE
DUKE ENERGY PROGRESS
KEITH SANDERS
4690 SIMMS CREEK RD
RALEIGH, NC 27616
919.431.4706
ROGER TURNER
9920 FAYETTEVILLE RD
RALEIGH, NC 27603
919.557.2626

NATURAL GAS SERVICES PSNC ENERGY MATTHEW KOEHL 3516 SPRING FOREST RD RALEIGH, NC 27616 919.501.7668

FOR REVIEW ONLY NOT FOR CONSTRUCTION

T DESIGN GROUT

DATE: 3.12.2019
PROJECT ENGINEER:
PROJECT CADD DESIGNER:
RJM


2 SUITES RALEIGH SH, WAKE COUNTY, NORTH CAROLINA
FRATIVE SITE REVIEW PLA

1 REVISED PER COR COMMENTS 5/10/13
2 REVISED PER COR COMMENTS 6/24/13
3 REVISED PER COR COMMENTS 8/2/19

SHEET **C-0.0** 

**DRAWING** 

PROJECT NUMBER

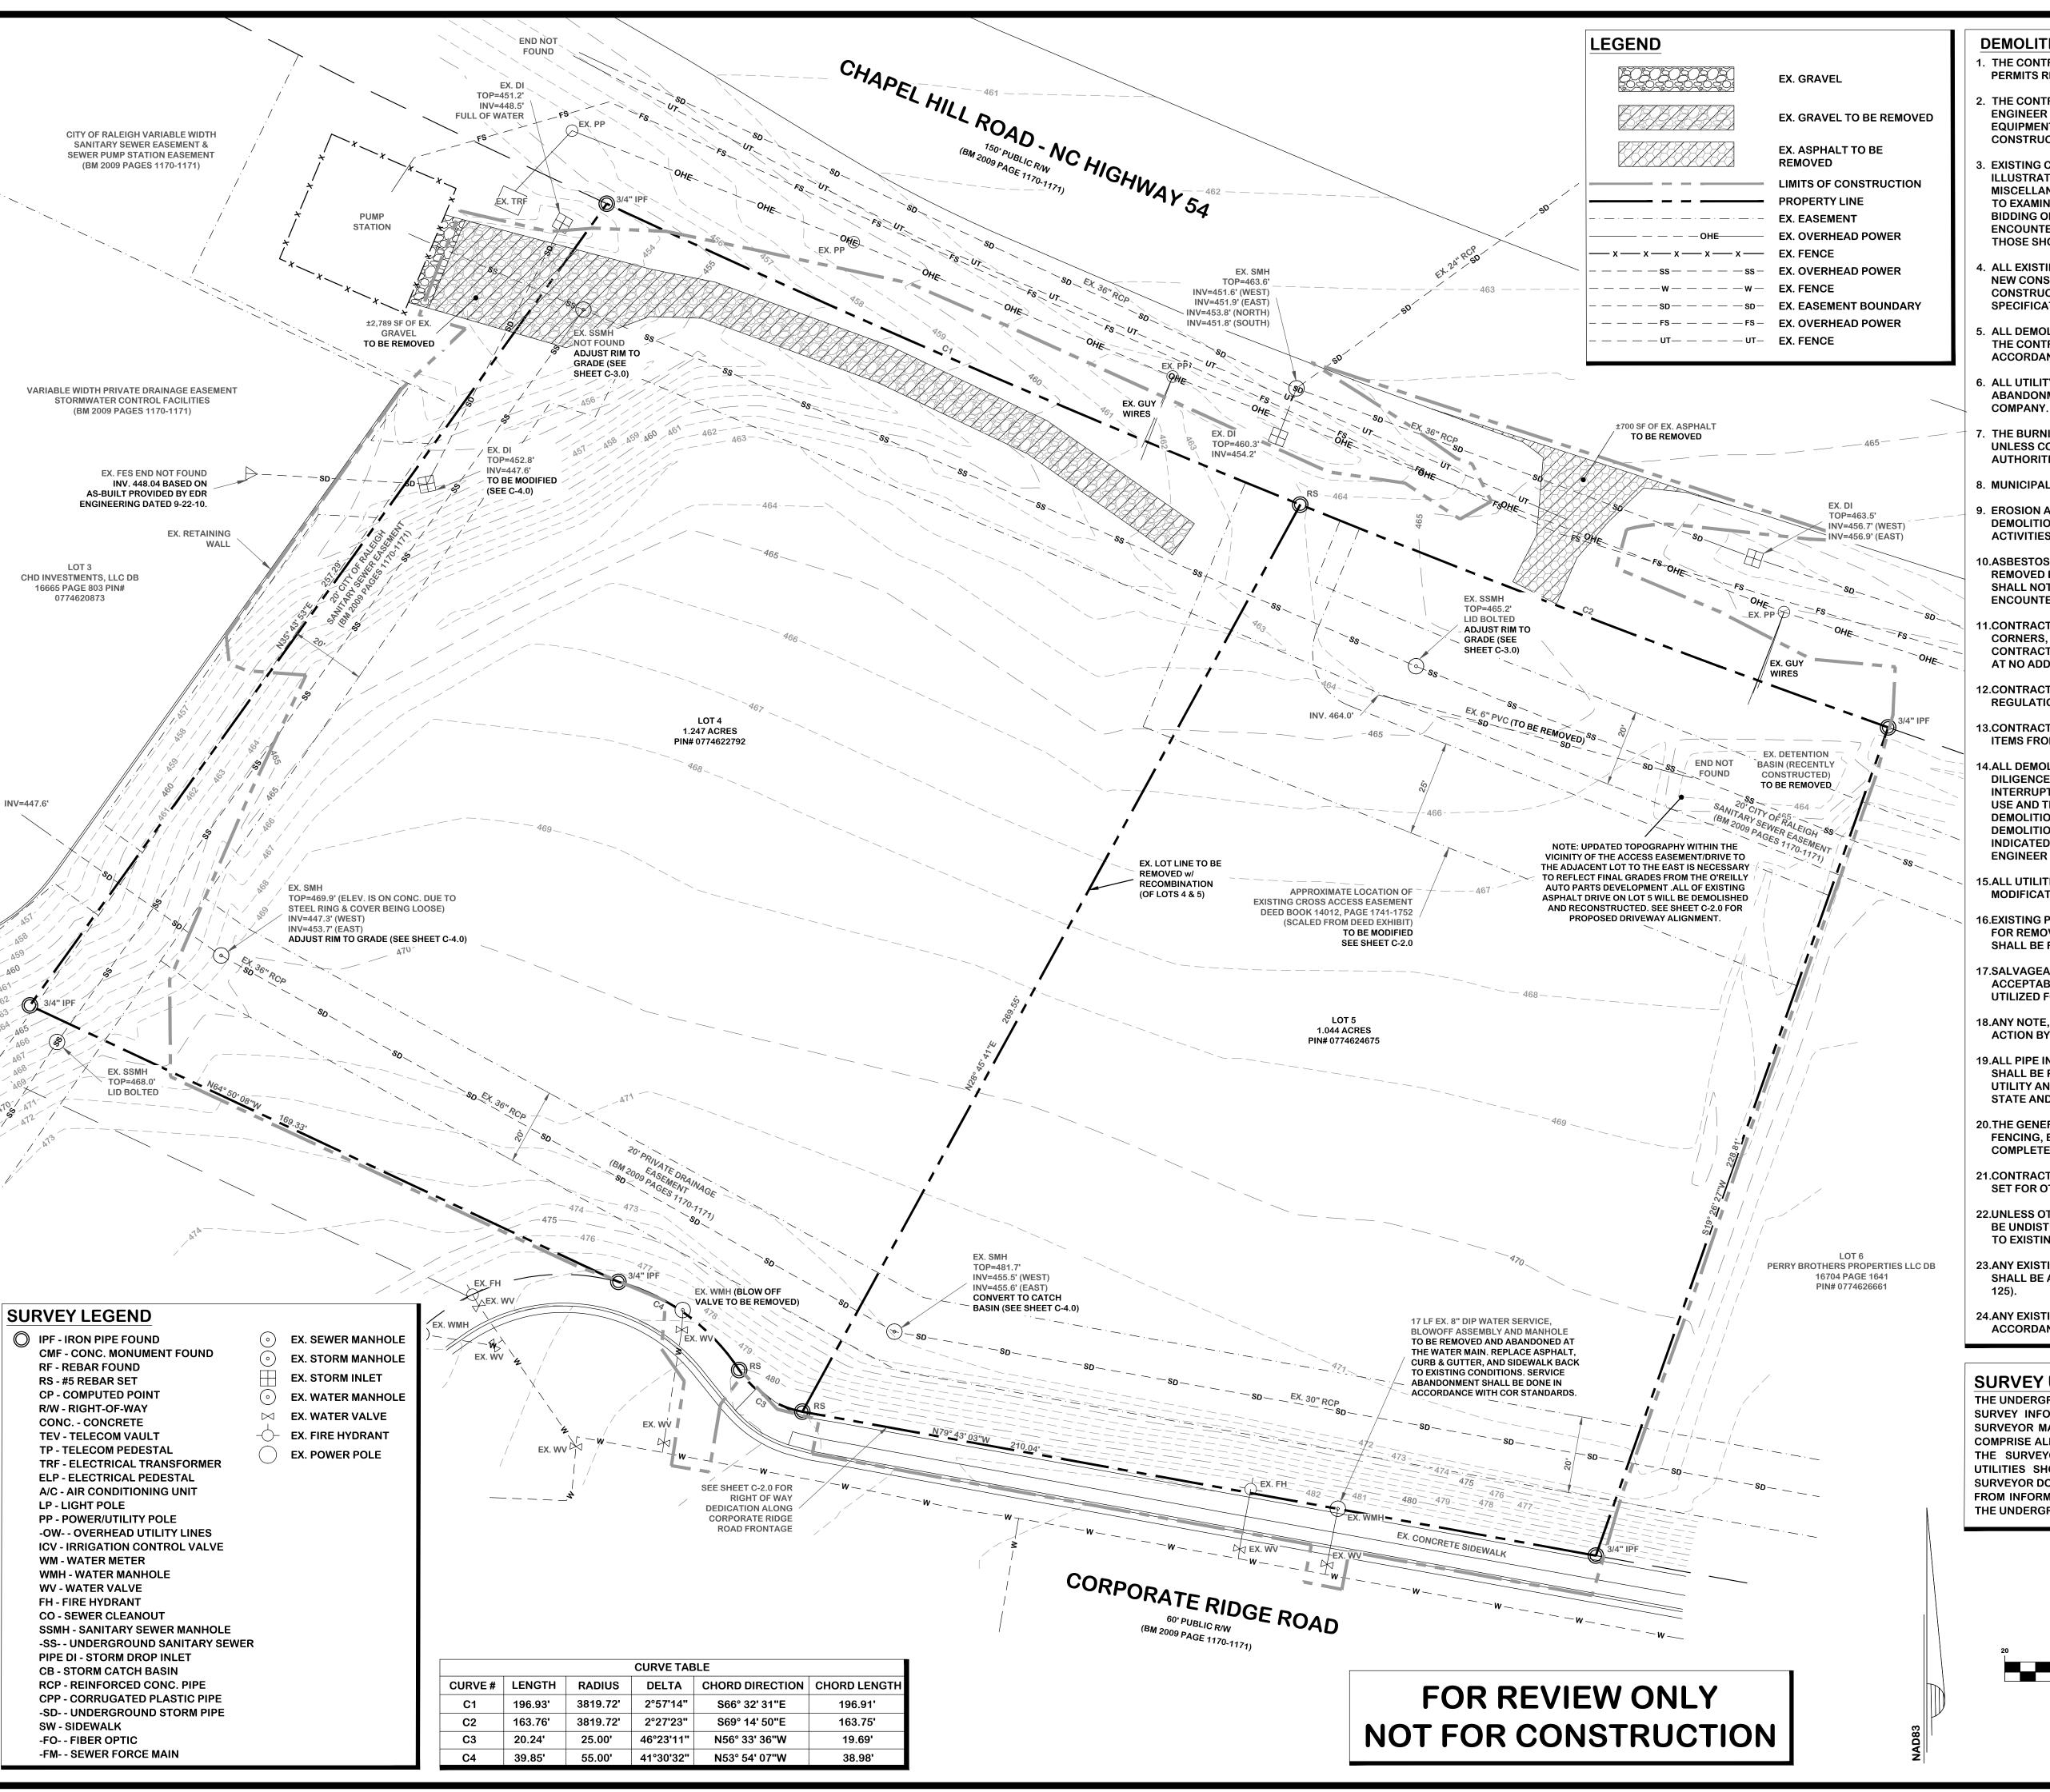

**DEMOLITION NOTES** 

1. THE CONTRACTOR IS RESPONSIBLE FOR OBTAINING ALL LOCAL AND STATE PERMITS REQUIRED FOR DEMOLITION WORK.

2. THE CONTRACTOR SHALL INDEMNIFY AND HOLD HARMLESS THE OWNER AND/OR ENGINEER FOR ANY AND ALL INJURIES AND/OR DAMAGES TO PERSONNEL, EQUIPMENT, AND/OR EXISTING FACILITIES IN THE DEMOLITION AND CONSTRUCTION DESCRIBED IN THE PLANS AND SPECIFICATIONS.

3. EXISTING CONDITIONS AS DEPICTED ON THESE PLANS ARE GENERAL AND ILLUSTRATIVE IN NATURE AND DO NOT INCLUDE MECHANICAL, ELECTRICAL AND MISCELLANEOUS STRUCTURES. IT IS THE RESPONSIBILITY OF THE CONTRACTOR TO EXAMINE THE SITE AND BE FAMILIAR WITH EXISTING CONDITIONS PRIOR TO BIDDING ON THE DEMOLITION WORK FOR THIS PROJECT. IF CONDITIONS ENCOUNTERED DURING EXAMINATION ARE SIGNIFICANTLY DIFFERENT THAN THOSE SHOWN, THE CONTRACTOR SHALL NOTIFY THE ENGINEER IMMEDIATELY.

4. ALL EXISTING ABOVE AND BELOW GROUND STRUCTURES WITHIN THE LIMITS OF NEW CONSTRUCTION SHALL BE RAZED UNLESS NOTED OTHERWISE WITHIN THIS CONSTRUCTION SET, ARCHITECTURAL PLANS AND/OR PROJECT SPECIFICATIONS. THIS INCLUDES FOUNDATION SLABS, WALLS, AND FOOTINGS.

5. ALL DEMOLITION WASTE AND CONSTRUCTION DEBRIS SHALL BE REMOVED BY THE CONTRACTOR AND DISPOSED OF IN A STATE APPROVED WASTE SITE AND IN ACCORDANCE WITH ALL LOCAL AND STATE CODES AND PERMIT REQUIREMENTS

6. ALL UTILITY REMOVAL, RELOCATION, CUTTING, CAPPING AND/OR ABADAMENT SHALL BE COORDINATED WITH THE APPROPRIATE UTILITY

7. THE BURNING OF CLEARED MATERIAL AND DEBRIS SHALL NOT BE ALLOWED UNLESS CONTRACTOR GETS WRITTEN AUTHORIZATION FROM THE LOCAL

8. MUNICIPAL AND UTILITY CONTACTS ARE LISTED ON COVER SHEET C-0.0.

9. EROSION AND SEDIMENTATION CONTROL MEASURES AROUND AREAS OF DEMOLITION SHALL BE INSTALLED PRIOR TO INITIATION OF DEMOLITION ACTIVITIES.

10.ASBESTOS OR HAZARDOUS MATERIALS, IF FOUND ON SITE, SHALL BE REMOVED BY A LICENSED HAZARDOUS MATERIALS CONTRACTOR. CONTRACTOR SHALL NOTIFY OWNER IMMEDIATELY IF HAZARDOUS MATERIALS ARE ENCOUNTERED.

1.CONTRACTOR SHALL PROTECT ALL CORNER PINS, MONUMENTS, PROPERTY CORNERS, AND BENCHMARKS DURING DEMOLITION ACTIVITIES. IF DISTURBED, CONTRACTOR SHALL HAVE DISTURBED ITEMS RESET BY A LICENSED SURVEYOR AT NO ADDITIONAL COST TO THE OWNER.

12.CONTRACTOR SHALL ADHERE TO ALL LOCAL, STATE, FEDERAL, AND OSHA REGULATIONS WHEN OPERATING DEMOLITION EQUIPMENT AROUND UTILITIES.

13.CONTRACTOR SHALL PROTECT AT ALL TIMES ADJACENT STRUCTURES AND ITEMS FROM DAMAGE DUE TO DEMOLITION ACTIVITIES.

14.ALL DEMOLITION WORK SHALL BE PERFORMED WITH "DUE CARE AND DILIGENCE" SO AS TO PREVENT THE ARBITRARY DESTRUCTION OR INTERRUPTION OF CONCEALED UTILITIES WHICH ARE INTENDED TO REMAIN IN USE AND THE ROUTING OF WHICH COULD NOT BE PREDETERMINED UNTIL DEMOLITION WAS STARTED. ALL SUCH DISCOVERIES OF UTILITIES DURING THE DEMOLITION PROCESS WHICH ARE IN A LOCATION DIFFERENT FROM THAT INDICATED OR ARE UNIDENTIFIED, SHALL BE REPORTED TO THE OWNER, ENGINEER AND ARCHITECT BEFORE REMOVAL FOR FINAL DISPOSITION.

15.ALL UTILITIES OR STRUCTURES NOT DESIGNATED FOR REMOVAL OR MODIFICATION ARE TO REMAIN AND BE PROTECTED FROM DAMAGE.

16.EXISTING PAVEMENT, CURB AND GUTTER, SIDEWALK, ETC. NOT INDICATED FOR REMOVAL, WHICH IS DAMAGED DURING DEMOLITION/CONSTRUCTION, SHALL BE REPAIRED OR REPLACED TO MATCH ORIGINAL CONDITION.

17.SALVAGEABLE FILL MATERIALS FROM SITE DEMOLITION DETERMINED TO BE ACCEPTABLE BY AN INDEPENDENT SOILS TESTING LABORATORY SHALL BE UTILIZED FOR FILL MATERIAL WHERE APPROPRIATE.

18.ANY NOTE, OR REFERENCE TO ANY ELEMENT, WHICH DOES NOT SPECIFY ACTION BY THE CONTRACTOR SHALL BE CONSTRUED AS INFORMATION ONLY.

19.ALL PIPE INSTALLATION, WHEN REQUIRED BY PIPE DEPTHS AND EXCAVATION, SHALL BE PERFORMED WITH THE USE OF TRENCH BOXES. ALL EXCAVATIONS, UTILITY AND GRADING WORK, SHALL BE IN ACCORDANCE WITH ALL LOCAL, STATE AND FEDERAL RULES AND REGULATIONS.

20.THE GENERAL CONTRACTOR SHALL PROVIDE ALL SAFETY AND SECURITY FENCING, BARRIERS, PROTECTION MATERIAL AND METHODS AS REQUIRED TO COMPLETE ANY OFF SITE WORK IN A SAFE AND TIMELY MANNER.

21.CONTRACTOR SHALL REFER TO OTHER PLANS WITHIN THIS CONSTRUCTION SET FOR OTHER PERTINENT INFORMATION.


22.UNLESS OTHERWISE NOTED, ALL EXISTING VEGETATION TO REMAIN AND TO BE UNDISTURBED FOR THE DURATION OF CONSTRUCTION. IF DAMAGES OCCUR TO EXISTING VEGETATION, PLANTS SHALL BE REPLACED IN KIND.

23.ANY EXISTING PRIVATE SERVICE NOT TO BE USED (LABELED TO BE REMOVED)
SHALL BE ABANDONED PER CORPUD STANDARDS (PU HANDBOOK, PAGE 67 AND

24.ANY EXISTING WELLS AND/OR SEPTIC SYSTEMS SHALL BE ABANDONED IN ACCORDANCE WITH WAKE COUNTY HEALTH DEPARTMENT STANDARDS.

# **SURVEY UTILITY NOTES:**

THE UNDERGROUND UTILITIES SHOWN HEREON, HAVE BEEN LOCATED FROM FIELD SURVEY INFORMATION (PAINT MARKINGS ON THE GROUND BY OTHERS). THE SURVEYOR MAKES NO GUARANTEE THAT THE UNDERGROUND UTILITIES SHOWN COMPRISE ALL SUCH UTILITIES IN THE AREA, EITHER IN SERVICE OR ABANDONED. THE SURVEYOR FURTHER DOES NOT WARRANT THAT THE UNDERGROUND UTILITIES SHOWN ARE IN THE EXACT LOCATION INDICATED ALTHOUGH THE SURVEYOR DOES CERTIFY THAT THEY ARE LOCATED AS ACCURATELY AS POSSIBLE FROM INFORMATION AVAILABLE. THE SURVEYOR HAS NOT EXCAVATED DOWN TO THE UNDERGROUND UTILITIES AND PHYSICALLY LOCATED THEM.

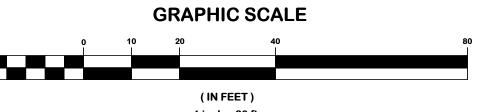

DESIGN (A(

: 3.12.2019
CT ENGINEER:
CT CADD DESIGNER:

PLAN
PLAN
PROJECT ENGIN

ADMINISTRATIVE SITE REVIEW PL.
STING CONDITIONS & DEMOLITION

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**70.5** 


O. REVISION DATE


1 REVISED PER COR COMMENTS 5/10/1

DRAWING
SHEET

C-1.0

PROJECT NUMBER

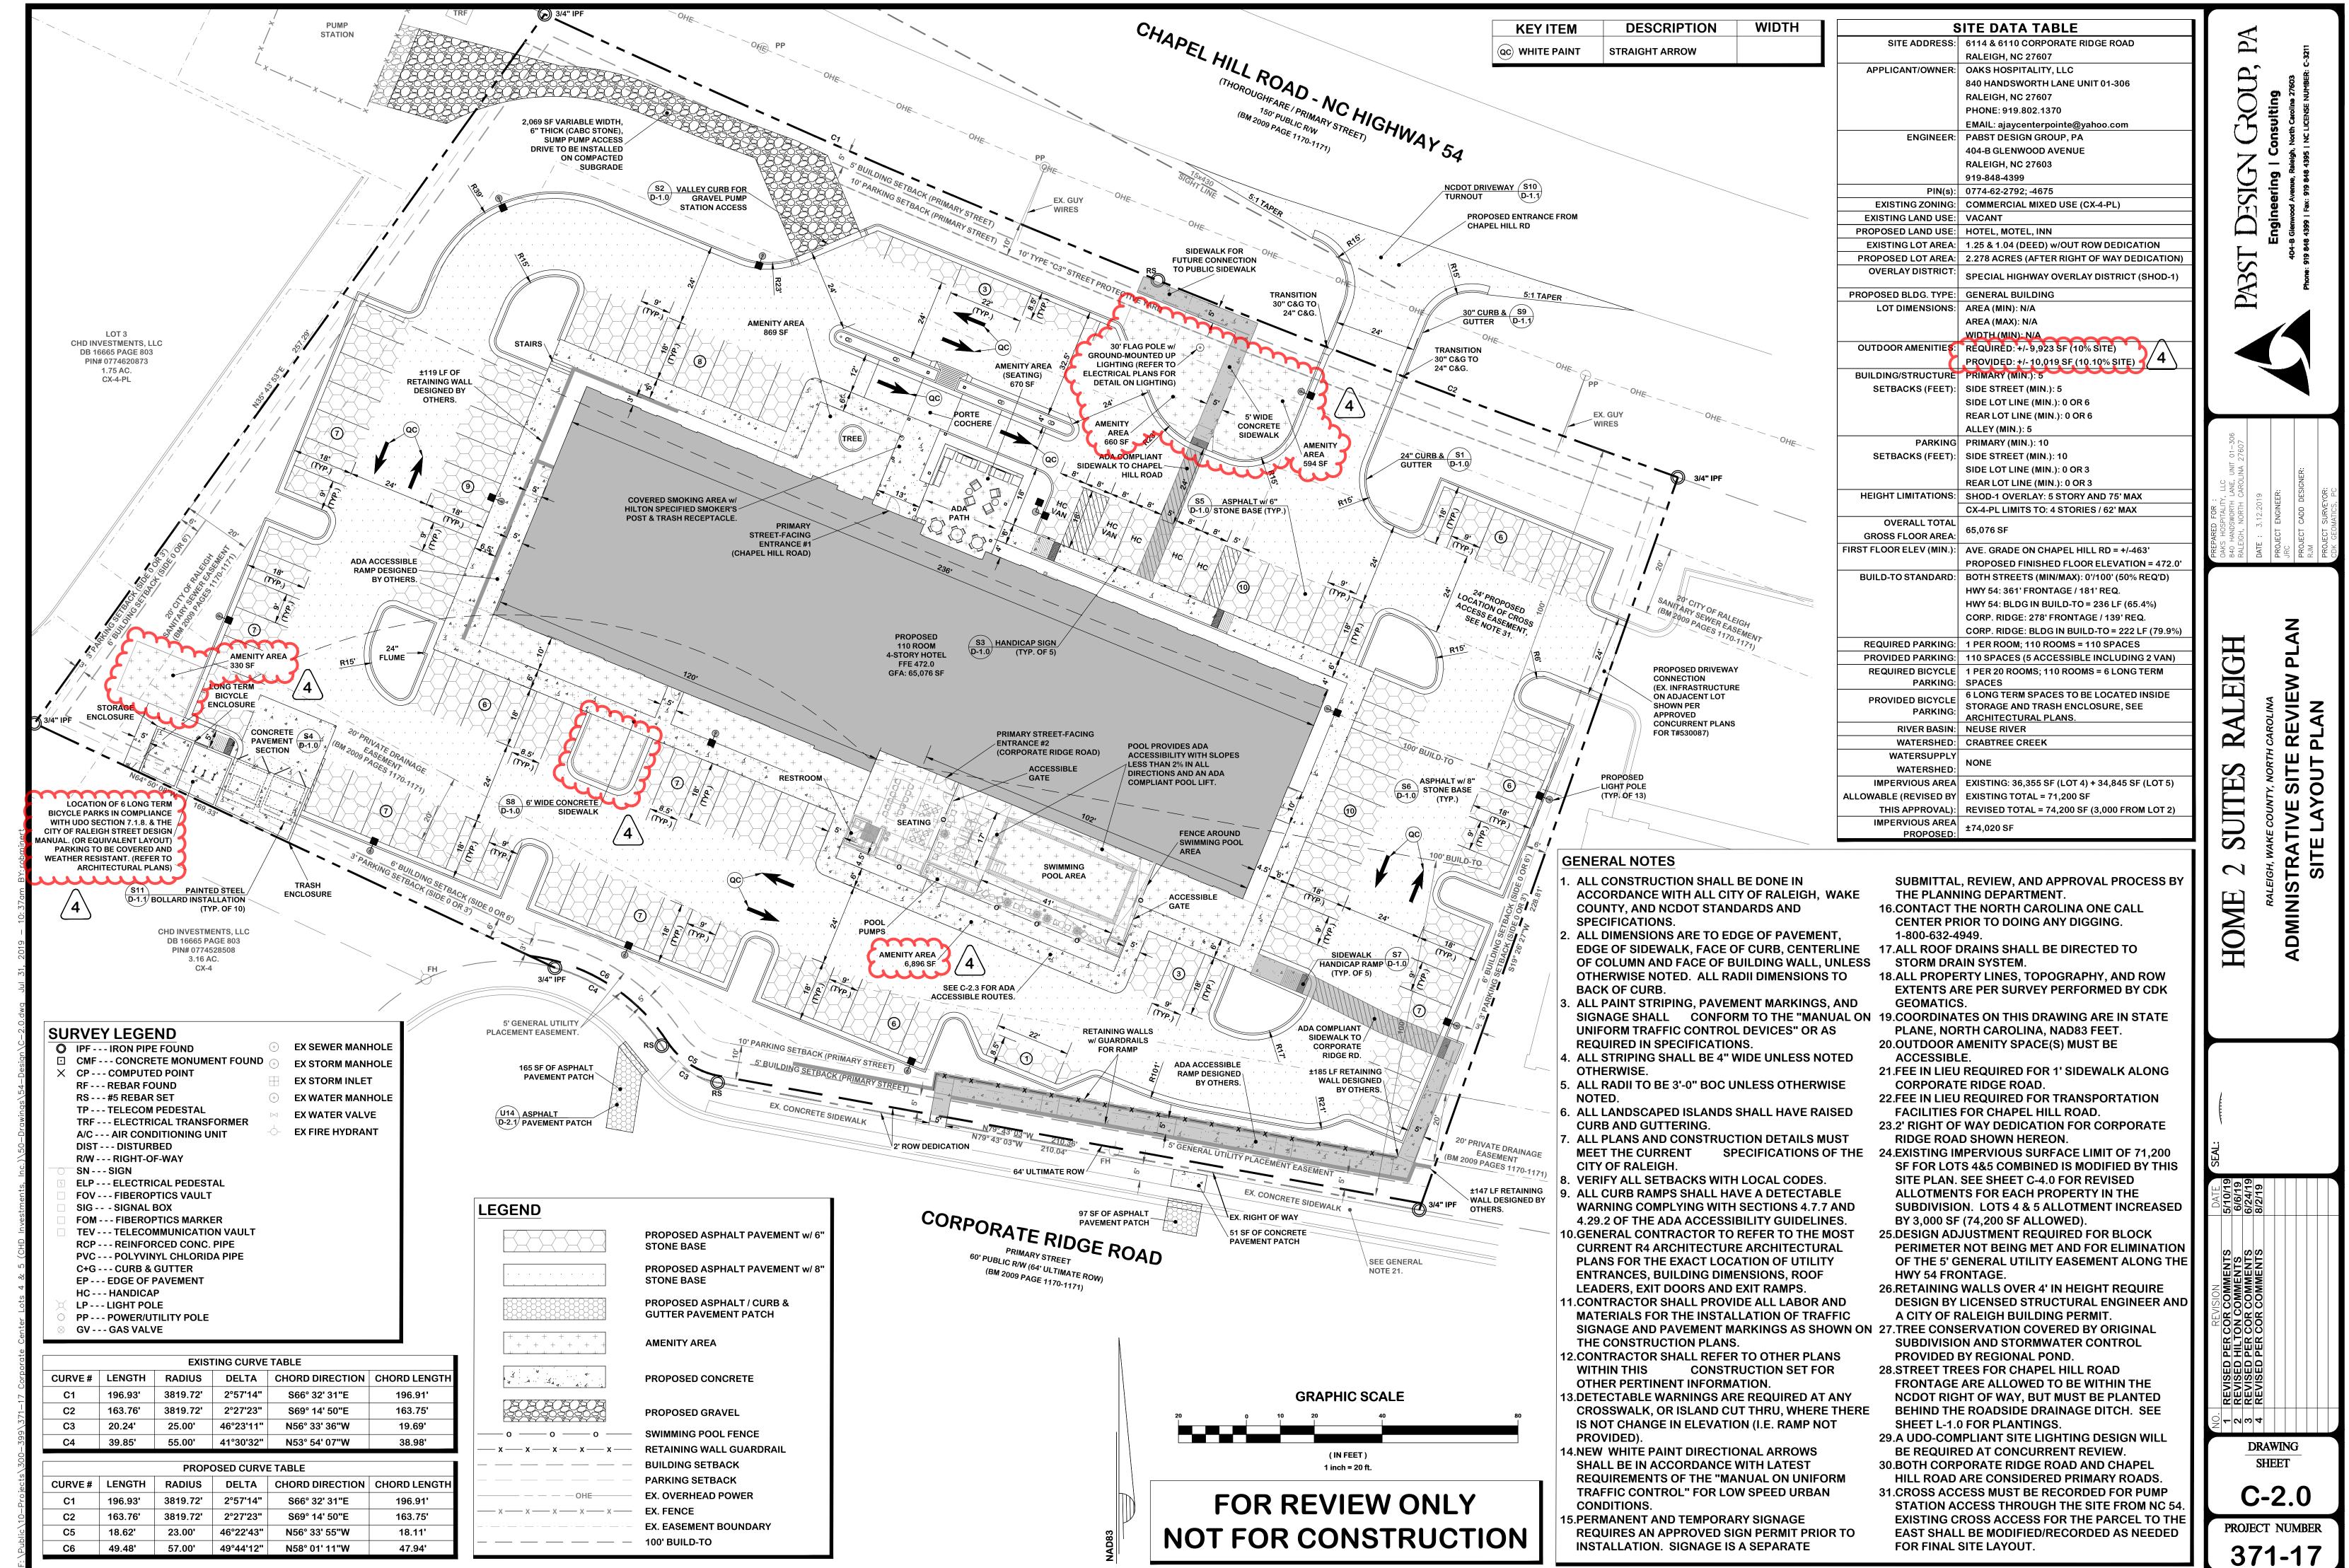

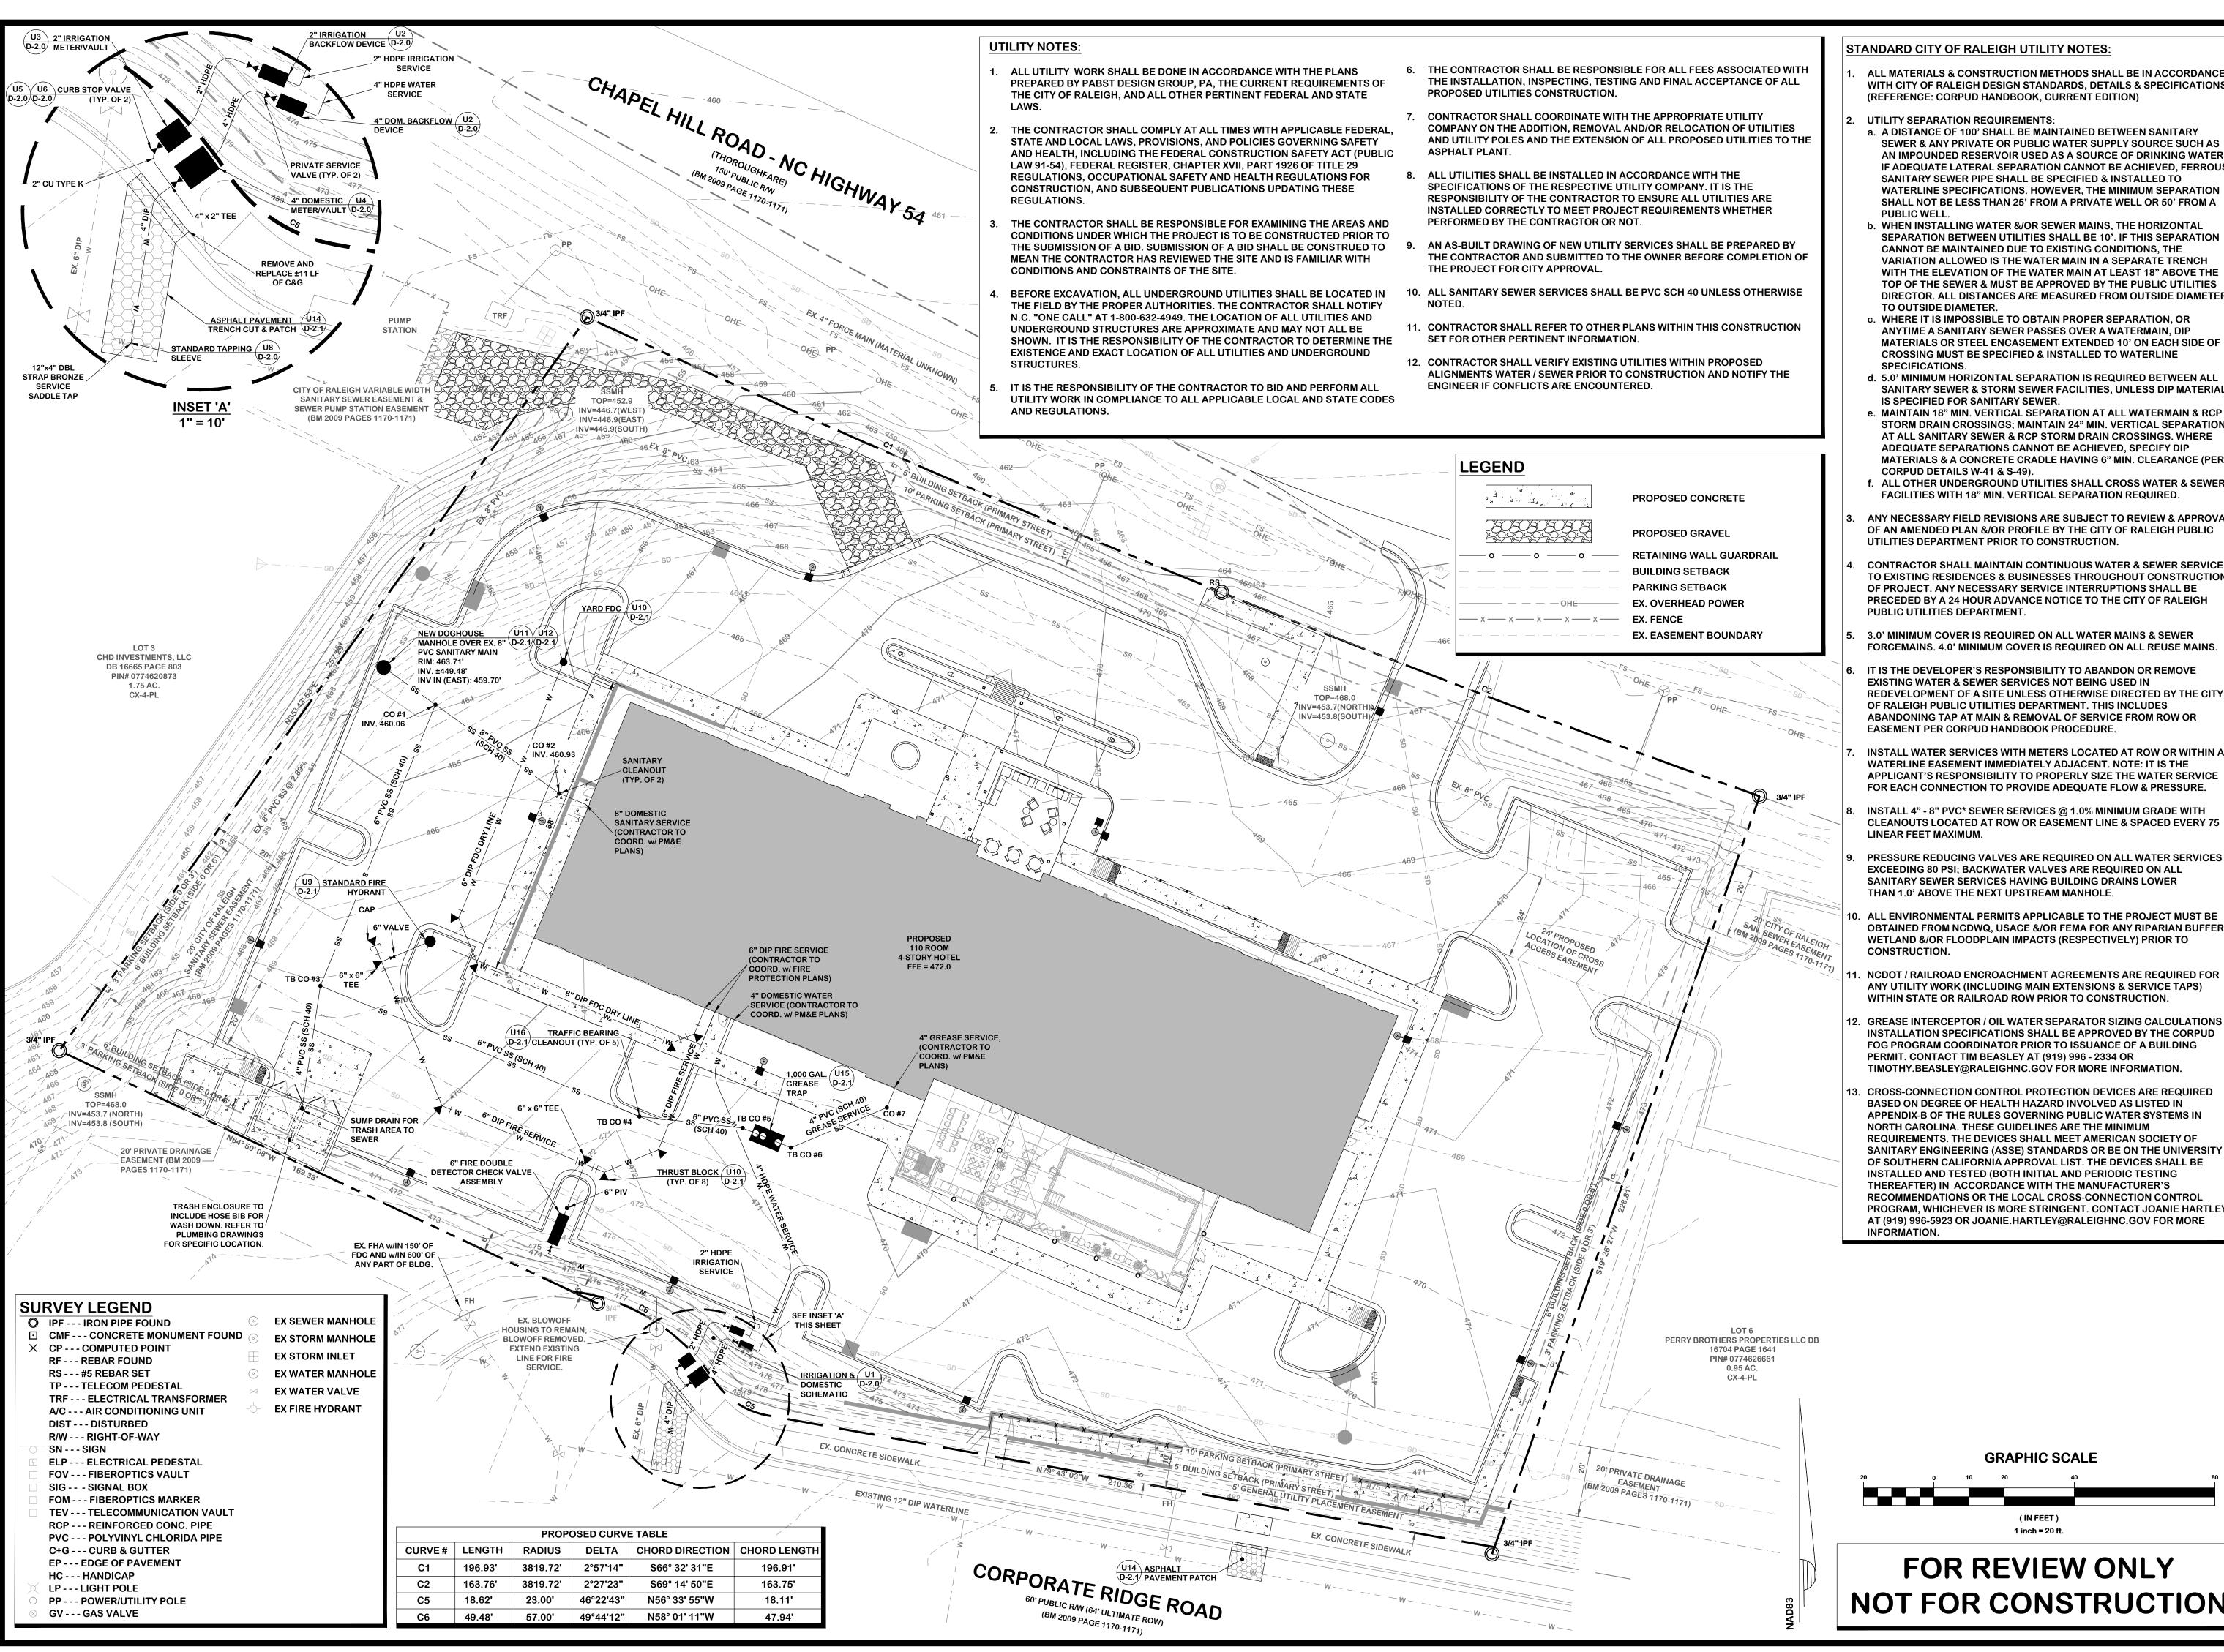

STANDARD CITY OF RALEIGH UTILITY NOTES:

ALL MATERIALS & CONSTRUCTION METHODS SHALL BE IN ACCORDANCE WITH CITY OF RALEIGH DESIGN STANDARDS, DETAILS & SPECIFICATIONS (REFERENCE: CORPUD HANDBOOK, CURRENT EDITION)

**UTILITY SEPARATION REQUIREMENTS:** 

a. A DISTANCE OF 100' SHALL BE MAINTAINED BETWEEN SANITARY SEWER & ANY PRIVATE OR PUBLIC WATER SUPPLY SOURCE SUCH AS AN IMPOUNDED RESERVOIR USED AS A SOURCE OF DRINKING WATER IF ADEQUATE LATERAL SEPARATION CANNOT BE ACHIEVED, FERROUS SANITARY SEWER PIPE SHALL BE SPECIFIED & INSTALLED TO WATERLINE SPECIFICATIONS. HOWEVER, THE MINIMUM SEPARATION SHALL NOT BE LESS THAN 25' FROM A PRIVATE WELL OR 50' FROM A

b. WHEN INSTALLING WATER &/OR SEWER MAINS, THE HORIZONTAL SEPARATION BETWEEN UTILITIES SHALL BE 10'. IF THIS SEPARATION CANNOT BE MAINTAINED DUE TO EXISTING CONDITIONS, THE VARIATION ALLOWED IS THE WATER MAIN IN A SEPARATE TRENCH WITH THE ELEVATION OF THE WATER MAIN AT LEAST 18" ABOVE THE TOP OF THE SEWER & MUST BE APPROVED BY THE PUBLIC UTILITIES DIRECTOR. ALL DISTANCES ARE MEASURED FROM OUTSIDE DIAMETER

c. WHERE IT IS IMPOSSIBLE TO OBTAIN PROPER SEPARATION, OR ANYTIME A SANITARY SEWER PASSES OVER A WATERMAIN, DIP MATERIALS OR STEEL ENCASEMENT EXTENDED 10' ON EACH SIDE OF **CROSSING MUST BE SPECIFIED & INSTALLED TO WATERLINE** 

d. 5.0' MINIMUM HORIZONTAL SEPARATION IS REQUIRED BETWEEN ALL SANITARY SEWER & STORM SEWER FACILITIES, UNLESS DIP MATERIA

IS SPECIFIED FOR SANITARY SEWER. e. MAINTAIN 18" MIN. VERTICAL SEPARATION AT ALL WATERMAIN & RCP STORM DRAIN CROSSINGS; MAINTAIN 24" MIN. VERTICAL SEPARATION AT ALL SANITARY SEWER & RCP STORM DRAIN CROSSINGS. WHERE ADEQUATE SEPARATIONS CANNOT BE ACHIEVED, SPECIFY DIP

f. ALL OTHER UNDERGROUND UTILITIES SHALL CROSS WATER & SEWER FACILITIES WITH 18" MIN. VERTICAL SEPARATION REQUIRED.

ANY NECESSARY FIELD REVISIONS ARE SUBJECT TO REVIEW & APPROVAL OF AN AMENDED PLAN &/OR PROFILE BY THE CITY OF RALEIGH PUBLIC

**CONTRACTOR SHALL MAINTAIN CONTINUOUS WATER & SEWER SERVICE** TO EXISTING RESIDENCES & BUSINESSES THROUGHOUT CONSTRUCTION OF PROJECT. ANY NECESSARY SERVICE INTERRUPTIONS SHALL BE PRECEDED BY A 24 HOUR ADVANCE NOTICE TO THE CITY OF RALEIGH PUBLIC UTILITIES DEPARTMENT.

3.0' MINIMUM COVER IS REQUIRED ON ALL WATER MAINS & SEWER FORCEMAINS. 4.0' MINIMUM COVER IS REQUIRED ON ALL REUSE MAINS.

IT IS THE DEVELOPER'S RESPONSIBILITY TO ABANDON OR REMOVE **EXISTING WATER & SEWER SERVICES NOT BEING USED IN** REDEVELOPMENT OF A SITE UNLESS OTHERWISE DIRECTED BY THE CITY OF RALEIGH PUBLIC UTILITIES DEPARTMENT. THIS INCLUDES ABANDONING TAP AT MAIN & REMOVAL OF SERVICE FROM ROW OR EASEMENT PER CORPUD HANDBOOK PROCEDURE.

INSTALL WATER SERVICES WITH METERS LOCATED AT ROW OR WITHIN A WATERLINE EASEMENT IMMEDIATELY ADJACENT. NOTE: IT IS THE APPLICANT'S RESPONSIBILITY TO PROPERLY SIZE THE WATER SERVICE FOR EACH CONNECTION TO PROVIDE ADEQUATE FLOW & PRESSURE.

INSTALL 4" - 8" PVC\* SEWER SERVICES @ 1.0% MINIMUM GRADE WITH **CLEANOUTS LOCATED AT ROW OR EASEMENT LINE & SPACED EVERY 75** 

9. PRESSURE REDUCING VALVES ARE REQUIRED ON ALL WATER SERVICES EXCEEDING 80 PSI; BACKWATER VALVES ARE REQUIRED ON ALL SANITARY SEWER SERVICES HAVING BUILDING DRAINS LOWER THAN 1.0' ABOVE THE NEXT UPSTREAM MANHOLE.

10. ALL ENVIRONMENTAL PERMITS APPLICABLE TO THE PROJECT MUST BE OBTAINED FROM NCDWQ, USACE &/OR FEMA FOR ANY RIPARIAN BUFFER, WETLAND &/OR FLOODPLAIN IMPACTS (RESPECTIVELY) PRIOR TO

NCDOT / RAILROAD ENCROACHMENT AGREEMENTS ARE REQUIRED FOR ANY UTILITY WORK (INCLUDING MAIN EXTENSIONS & SERVICE TAPS) WITHIN STATE OR RAILROAD ROW PRIOR TO CONSTRUCTION.

12. GREASE INTERCEPTOR / OIL WATER SEPARATOR SIZING CALCULATIONS 8 INSTALLATION SPECIFICATIONS SHALL BE APPROVED BY THE CORPUD FOG PROGRAM COORDINATOR PRIOR TO ISSUANCE OF A BUILDING PERMIT. CONTACT TIM BEASLEY AT (919) 996 - 2334 OR

CROSS-CONNECTION CONTROL PROTECTION DEVICES ARE REQUIRED BASED ON DEGREE OF HEALTH HAZARD INVOLVED AS LISTED IN APPENDIX-B OF THE RULES GOVERNING PUBLIC WATER SYSTEMS IN NORTH CAROLINA. THESE GUIDELINES ARE THE MINIMUM REQUIREMENTS. THE DEVICES SHALL MEET AMERICAN SOCIETY OF SANITARY ENGINEERING (ASSE) STANDARDS OR BE ON THE UNIVERSITY OF SOUTHERN CALIFORNIA APPROVAL LIST. THE DEVICES SHALL BE INSTALLED AND TESTED (BOTH INITIAL AND PERIODIC TESTING THEREAFTER) IN ACCORDANCE WITH THE MANUFACTURER'S RECOMMENDATIONS OR THE LOCAL CROSS-CONNECTION CONTROL PROGRAM, WHICHEVER IS MORE STRINGENT. CONTACT JOANIE HARTLEY AT (919) 996-5923 OR JOANIE.HARTLEY@RALEIGHNC.GOV FOR MORE

**GRAPHIC SCALE** 1 inch = 20 ft.

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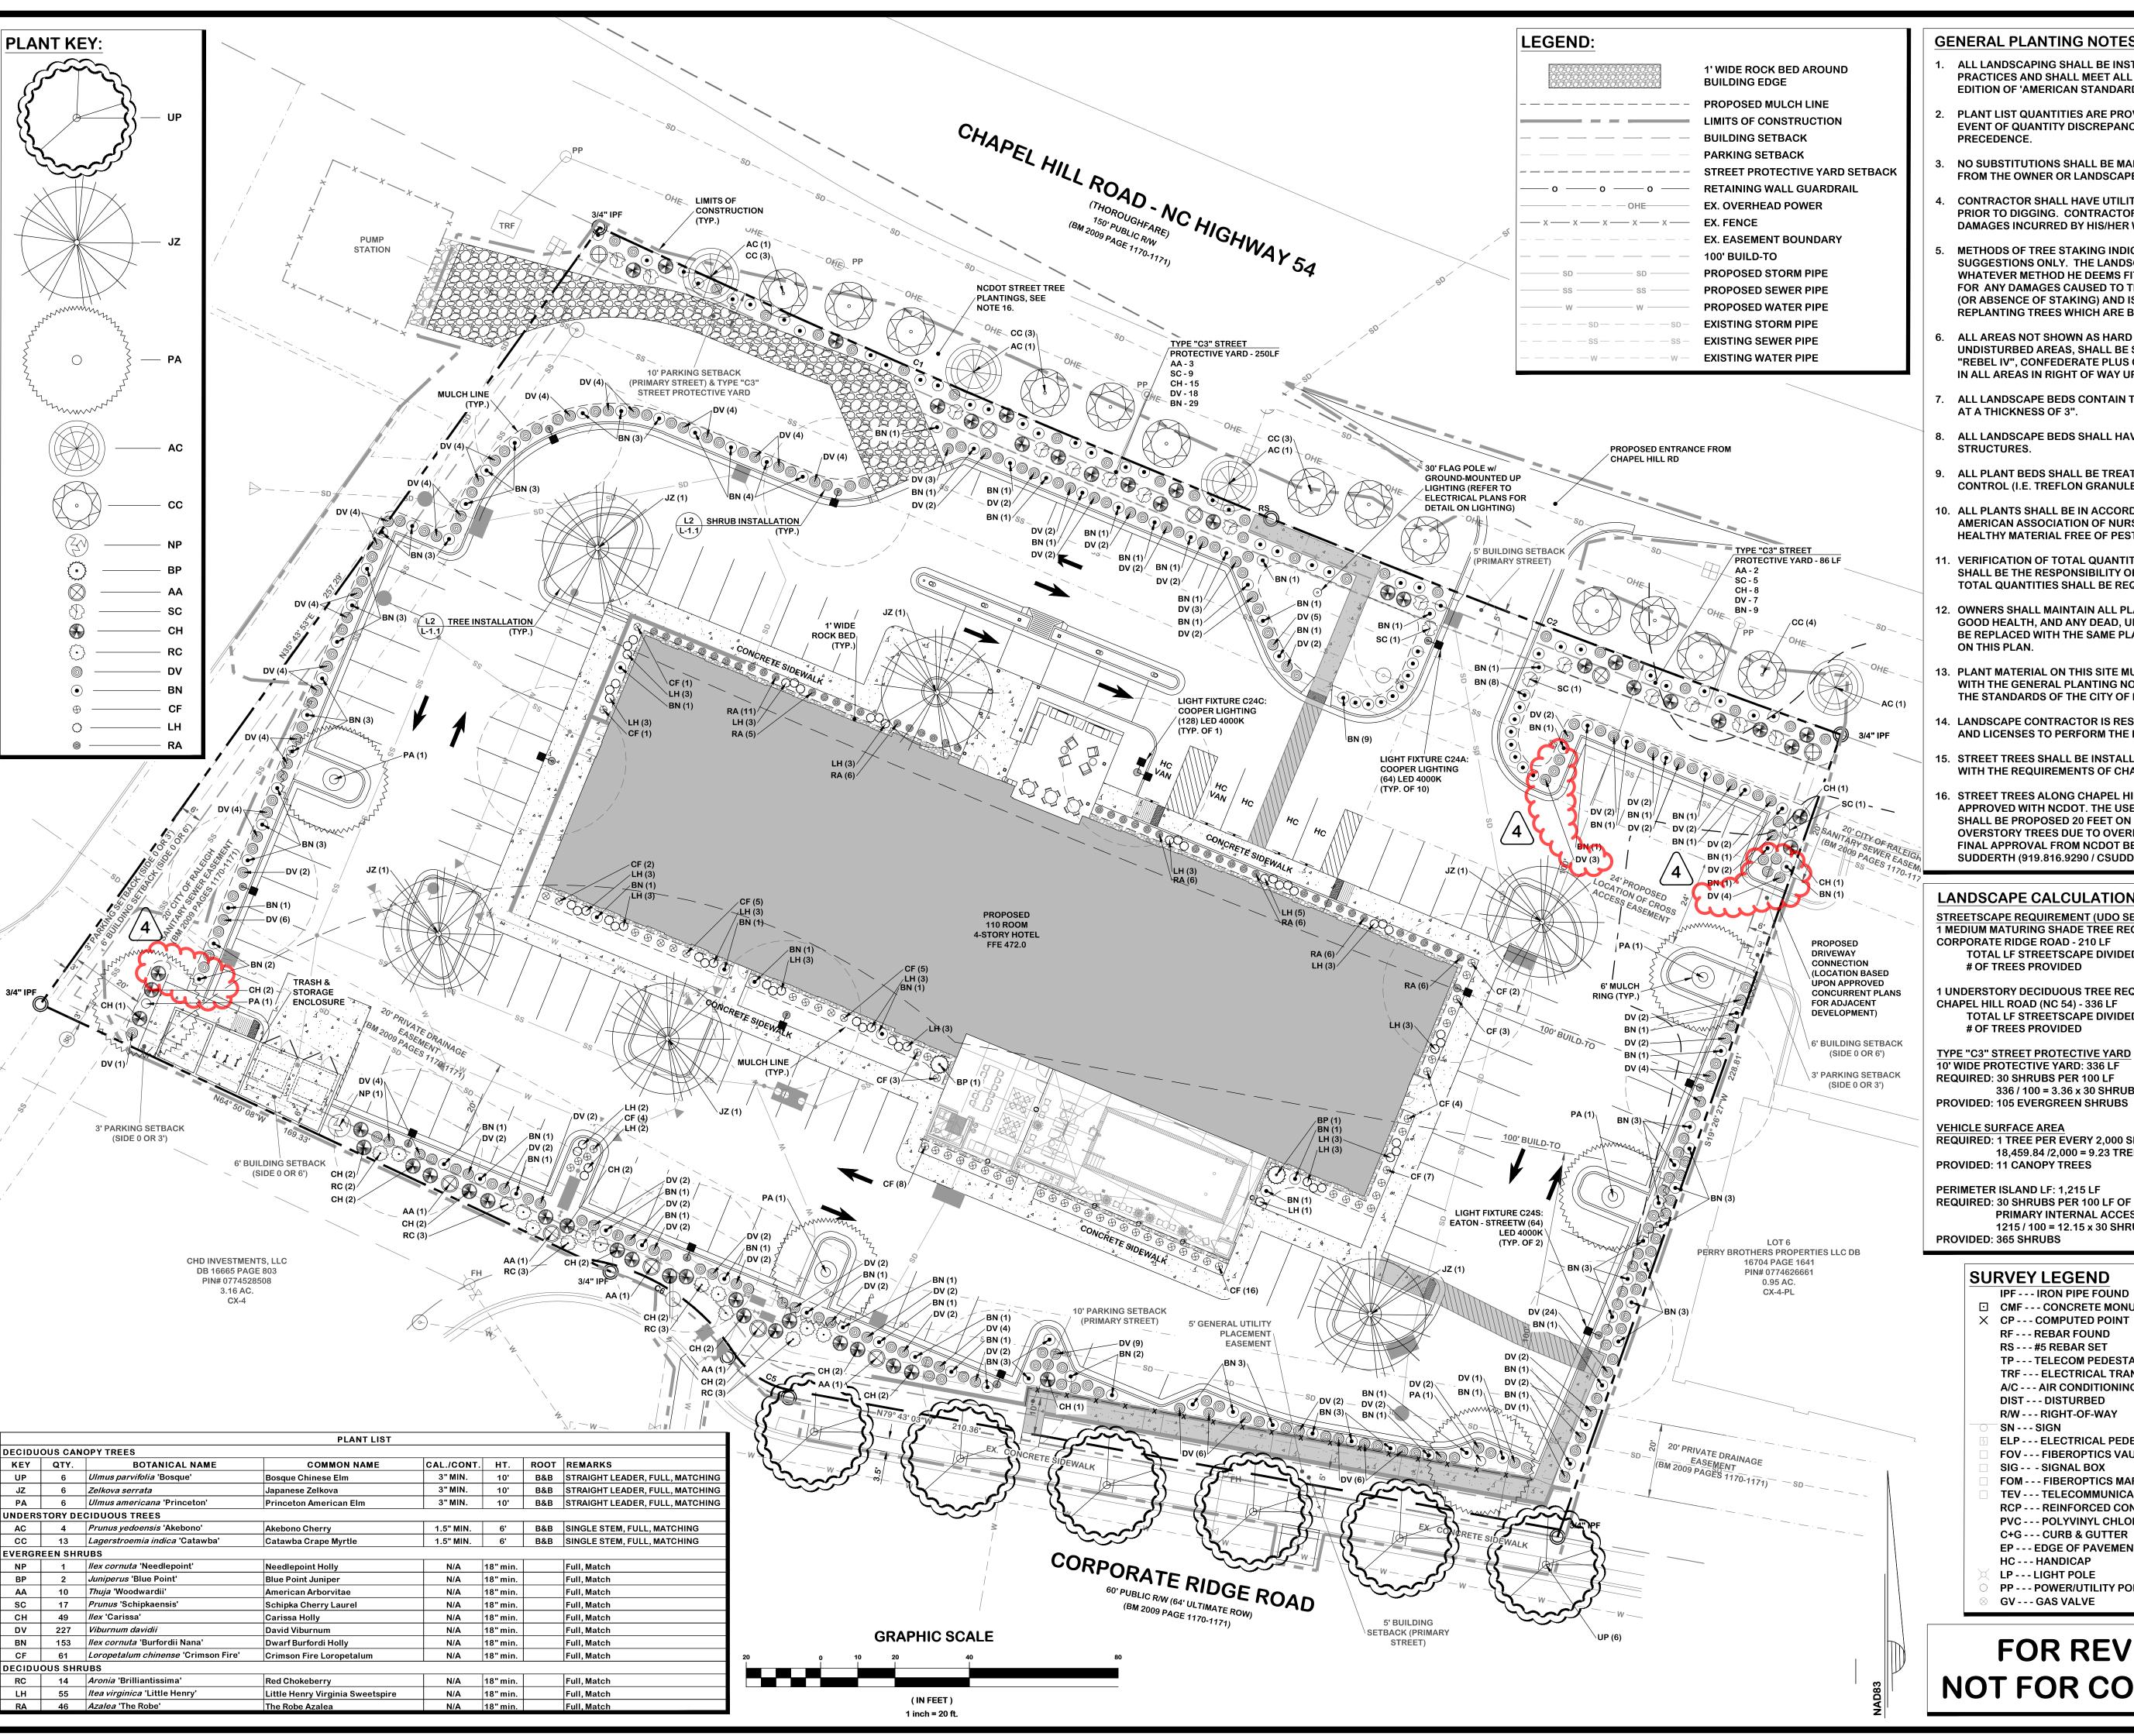
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DRAWING SHEET C-3.0

PROJECT NUMBER



**GENERAL PLANTING NOTES:** 

- ALL LANDSCAPING SHALL BE INSTALLED ACCORDING TO SOUND NURSERY PRACTICES AND SHALL MEET ALL STANDARDS AS STATED IN THE LATEST EDITION OF 'AMERICAN STANDARD FOR NURSERY STOCK'.
- PLANT LIST QUANTITIES ARE PROVIDED FOR CONVENIENCE ONLY. IN THE EVENT OF QUANTITY DISCREPANCIES, THE DRAWINGS SHALL TAKE PRECEDENCE.
- NO SUBSTITUTIONS SHALL BE MADE WITHOUT WRITTEN AUTHORIZATION FROM THE OWNER OR LANDSCAPE DESIGNER.
- CONTRACTOR SHALL HAVE UTILITY COMPANY LOCATE ALL UTILITIES PRIOR TO DIGGING. CONTRACTOR SHALL BE RESPONSIBLE FOR ALL DAMAGES INCURRED BY HIS/HER WORK.
- METHODS OF TREE STAKING INDICATED ON THE DRAWINGS ARE SUGGESTIONS ONLY. THE LANDSCAPE CONTRACTOR SHALL USE WHATEVER METHOD HE DEEMS FIT, HOWEVER HE WILL BE HELD LIABLE FOR ANY DAMAGES CAUSED TO TREES BY IMPROPER STAKING METHODS (OR ABSENCE OF STAKING) AND IS RESPONSIBLE FOR UPRIGHTING AND REPLANTING TREES WHICH ARE BLOWN OVER.
- ALL AREAS NOT SHOWN AS HARD SURFACES, PLANT BED, MULCHED OR UNDISTURBED AREAS, SHALL BE SEEDED OR SODDED AS LAWN WITH "REBEL IV", CONFEDERATE PLUS OR LESCO TALL TURF TYPE FESCUE FOR IN ALL AREAS IN RIGHT OF WAY UP TO THE ROAD.
- ALL LANDSCAPE BEDS CONTAIN TRIPLE SHREDDED HARDWOOD MULCH AT A THICKNESS OF 3".
- B. ALL LANDSCAPE BEDS SHALL HAVE POSITIVE DRAINAGE AWAY FROM ALL
- 9. ALL PLANT BEDS SHALL BE TREATED WITH PRE-EMERGENT WEED
- CONTROL (I.E. TREFLON GRANULES).
- 10. ALL PLANTS SHALL BE IN ACCORDANCE WITH THE LATEST EDITION OF TH AMERICAN ASSOCIATION OF NURSERYMEN AND SHALL BE VIGOROUS, HEALTHY MATERIAL FREE OF PESTS AND DISEASE.
- 11. VERIFICATION OF TOTAL QUANTITIES AS SHOWN ON THE PLANT LIST SHALL BE THE RESPONSIBILITY OF THE PLANTING CONTRACTOR, AND THE TOTAL QUANTITIES SHALL BE REQUIRED ON THE PLANTING PLAN.
- 12. OWNERS SHALL MAINTAIN ALL PLANT BEDS AND PLANT MATERIAL IN GOOD HEALTH, AND ANY DEAD, UNHEALTHY OR MISSING PLANTS SHALL BE REPLACED WITH THE SAME PLANT MATERIAL ORIGINALLY SPECIFIED ON THIS PLAN.
- 13. PLANT MATERIAL ON THIS SITE MUST BE INSTALLED IN CONFORMANCE WITH THE GENERAL PLANTING NOTES AND DETAILS ON THIS PLAN OR TO THE STANDARDS OF THE CITY OF RALEIGH.
- 14. LANDSCAPE CONTRACTOR IS RESPONSIBLE FOR ALL REQUIRED PERMITS AND LICENSES TO PERFORM THE REQUIRED WORK.
- 15. STREET TREES SHALL BE INSTALLED AND MAINTAINED IN ACCORDANCE WITH THE REQUIREMENTS OF CHAPTER 2 OF THE CITY TREE MANUAL.
- 16. STREET TREES ALONG CHAPEL HILL ROAD ARE CONDITIONALLY APPROVED WITH NCDOT. THE USE OF UNDERSTORY, SINGLE STEM TREES SHALL BE PROPOSED 20 FEET ON CENTER IN SUBSTITUTE FOR OVERSTORY TREES DUE TO OVERHEAD UTILITY LINES AND SHALL HAVE FINAL APPROVAL FROM NCDOT BEFORE PLANTING, CONTACT CORY SUDDERTH (919.816.9290 / CSUDDERTH@NCDOT.GOV) WITH NCDOT.

# LANDSCAPE CALCULATIONS

**STREETSCAPE REQUIREMENT (UDO SEC. 8.5.2.):** 1 MEDIUM MATURING SHADE TREE REQUIRED PER 40 LINEAR FEET CORPORATE RIDGE ROAD - 210 LF

TOTAL LF STREETSCAPE DIVIDED BY 40' 210 / 40 = 5.25 # OF TREES PROVIDED

1 UNDERSTORY DECIDUOUS TREE REQUIRED PER 20 LINEAR FEET CHAPEL HILL ROAD (NC 54) - 336 LF TOTAL LF STREETSCAPE DIVIDED BY 20'

# OF TREES PROVIDED = 17 TREES

10' WIDE PROTECTIVE YARD: 336 LF **REQUIRED: 30 SHRUBS PER 100 LF** 336 / 100 = 3.36 x 30 SHRUBS = 100.8 SHRUBS **PROVIDED: 105 EVERGREEN SHRUBS** 

**VEHICLE SURFACE AREA** REQUIRED: 1 TREE PER EVERY 2,000 SF OF PARKING AREA 18,459.84 /2,000 = 9.23 TREES

PERIMETER ISLAND LF: 1,215 LF REQUIRED: 30 SHRUBS PER 100 LF OF PERIMETER ISLAND THAT IS ALONG PRIMARY INTERNAL ACCESS DRIVES.

1215 / 100 = 12.15 x 30 SHRUBS = 364.5 SHRUBS

# **SURVEY LEGEND**

RS - - - #5 REBAR SET

IPF - - - IRON PIPE FOUND ★ CP - - - COMPUTED POINT RF - - - REBAR FOUND

TP - - - TELECOM PEDESTAL TRF - - - ELECTRICAL TRANSFORMER A/C - - - AIR CONDITIONING UNIT

**DIST - - - DISTURBED** R/W - - - RIGHT-OF-WAY SN - - - SIGN **ELP---ELECTRICAL PEDESTAL** 

FOV - - - FIBEROPTICS VAULT SIG -- - SIGNAL BOX **FOM - - - FIBEROPTICS MARKER** TEV - - - TELECOMMUNICATION VAULT RCP - - - REINFORCED CONC. PIPE

PVC --- POLYVINYL CHLORIDA PIPE C+G - - - CURB & GUTTER **EP---EDGE OF PAVEMENT** HC - - - HANDICAP

LP - - - LIGHT POLE PP - - - POWER/UTILITY POLE GV - - - GAS VALVE

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**EX SEWER MANHOLE** 

EX STORM MANHOLE

EX WATER MANHOLE

**EX WATER VALVE** 

**EX FIRE HYDRANT** 


**EX STORM INLET** 

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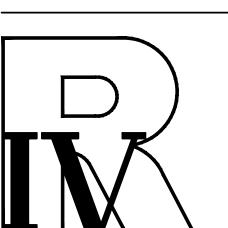


**Project** 

Home 2 Suites Raleigh, NC

Oaks Hospitality LLC 840 Handsworth Lane#30 Raleigh, NC 27607

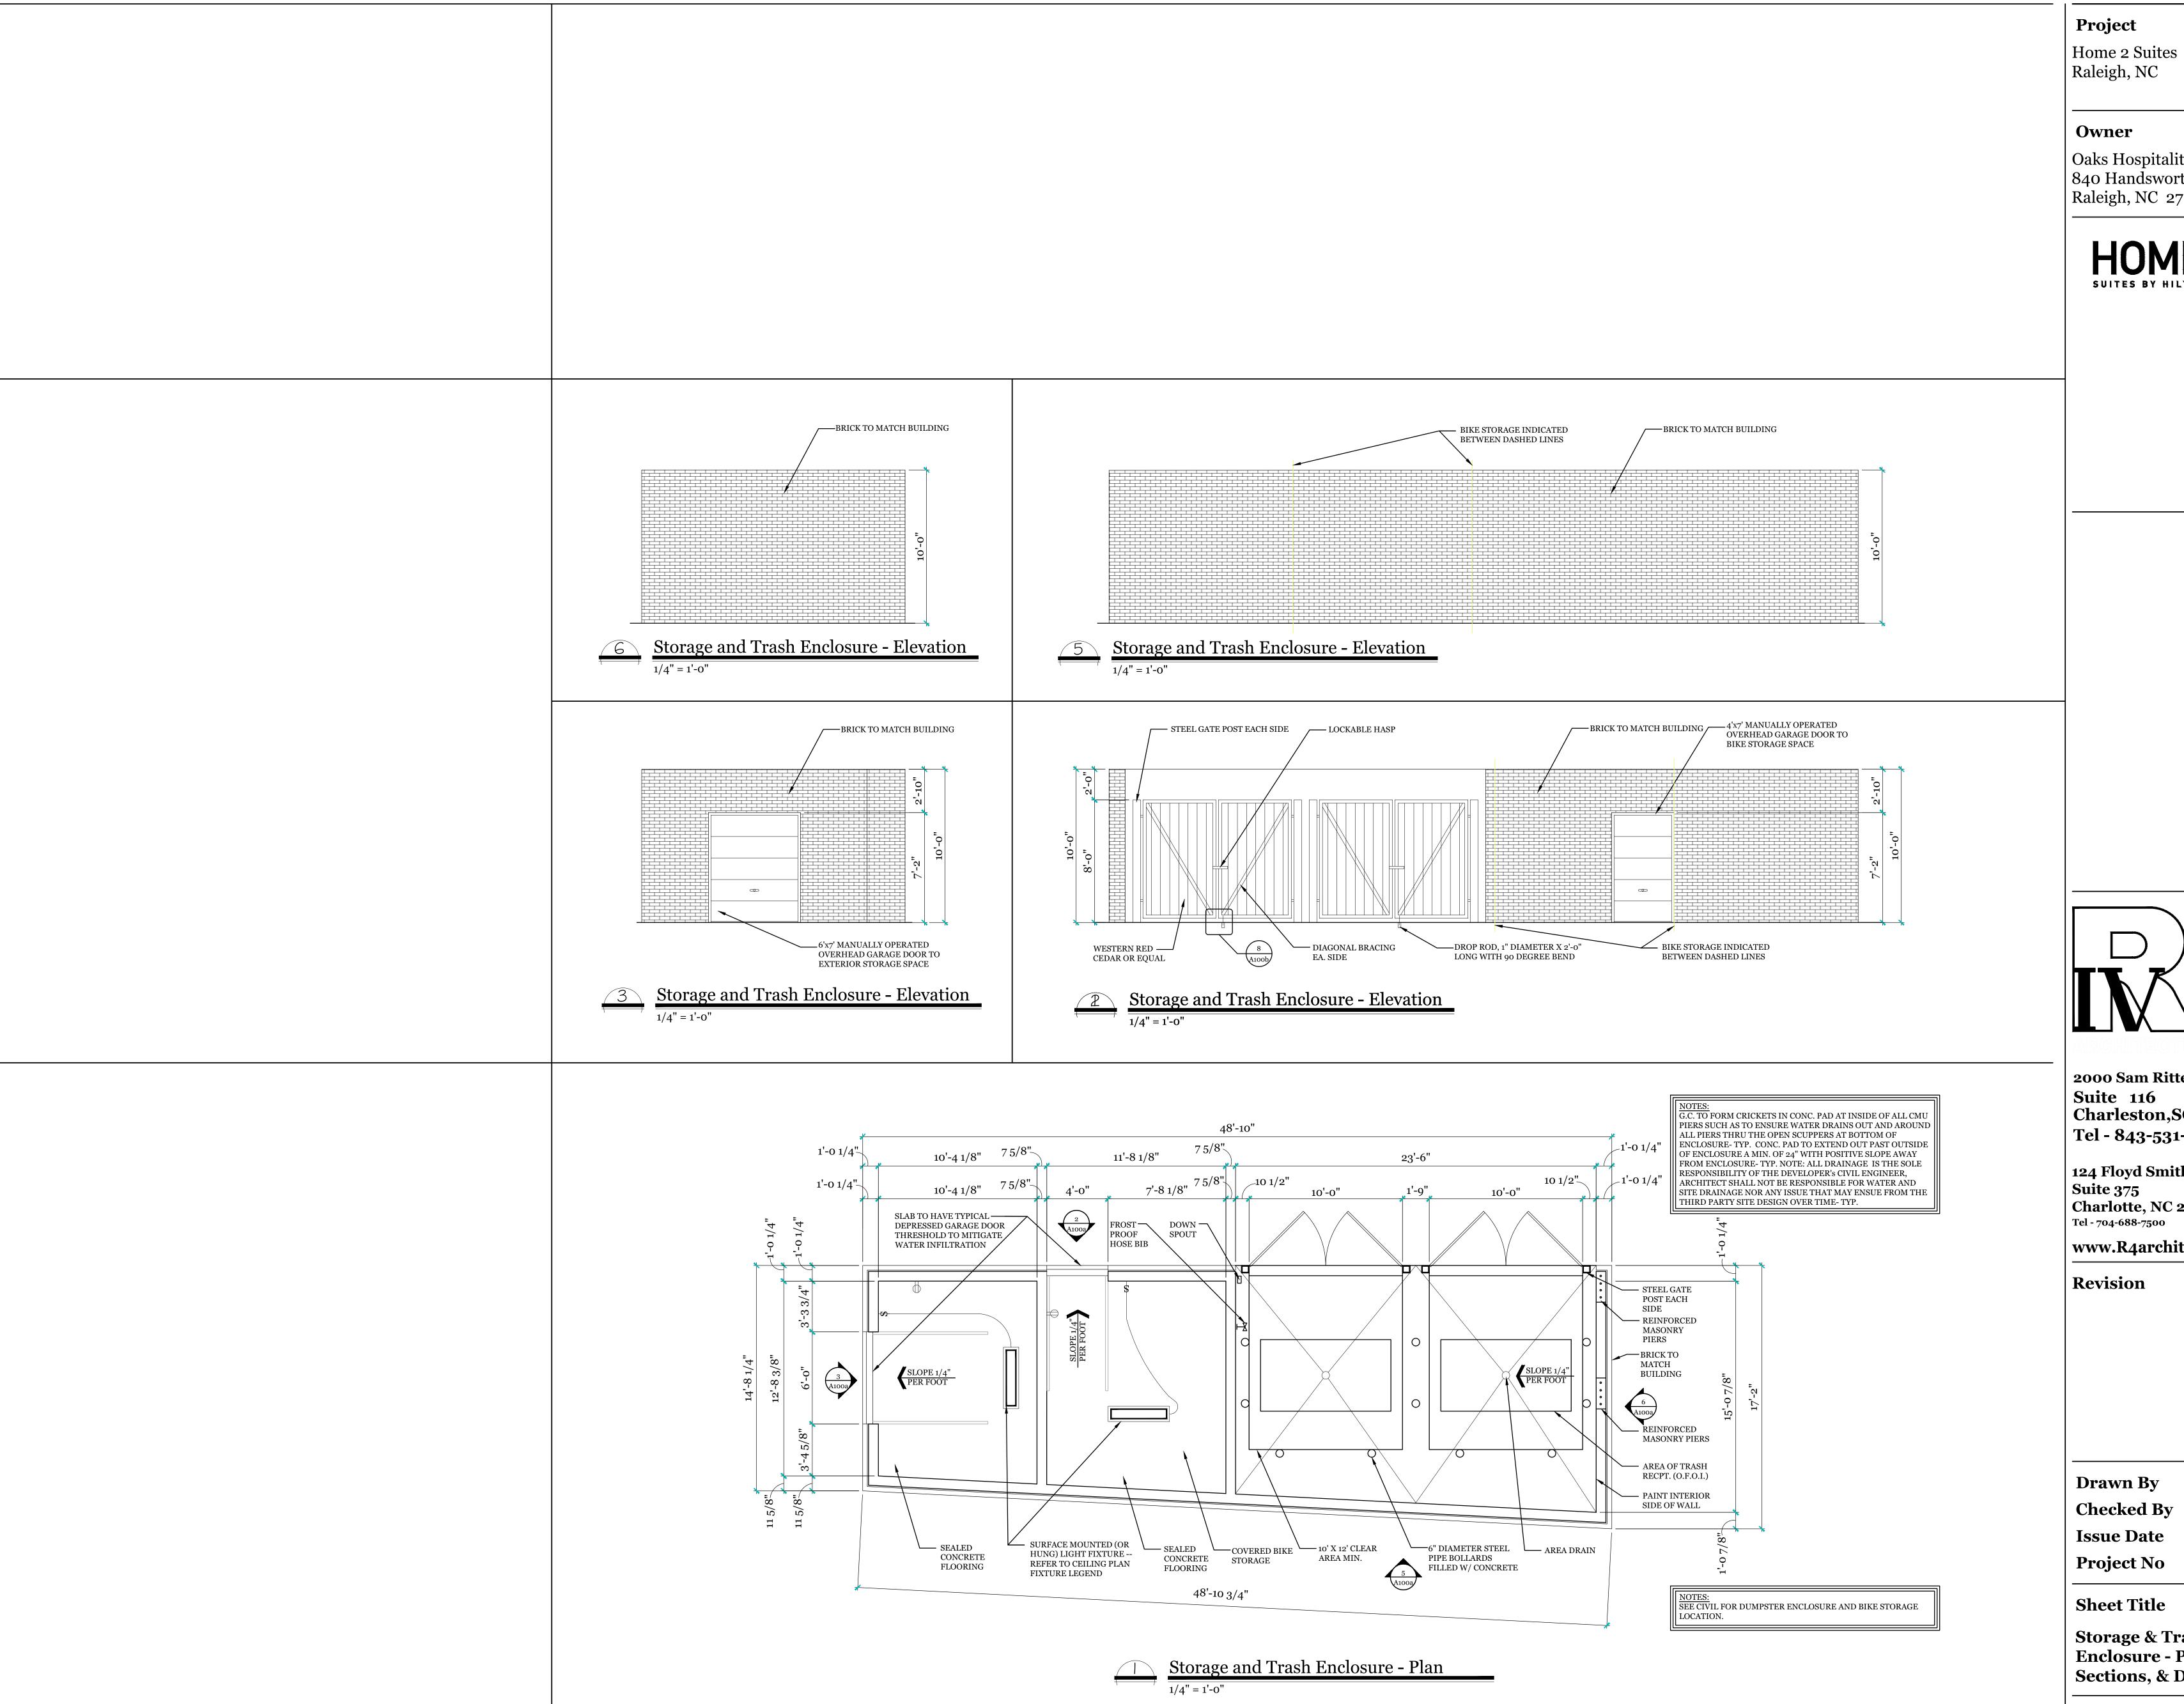



2000 Sam Rittenberg Blvo Suite 116 Charleston,SC 29407 Tel - 843-531-6848

124 Floyd Smith Drive Suite 375 Charlotte, NC 28262

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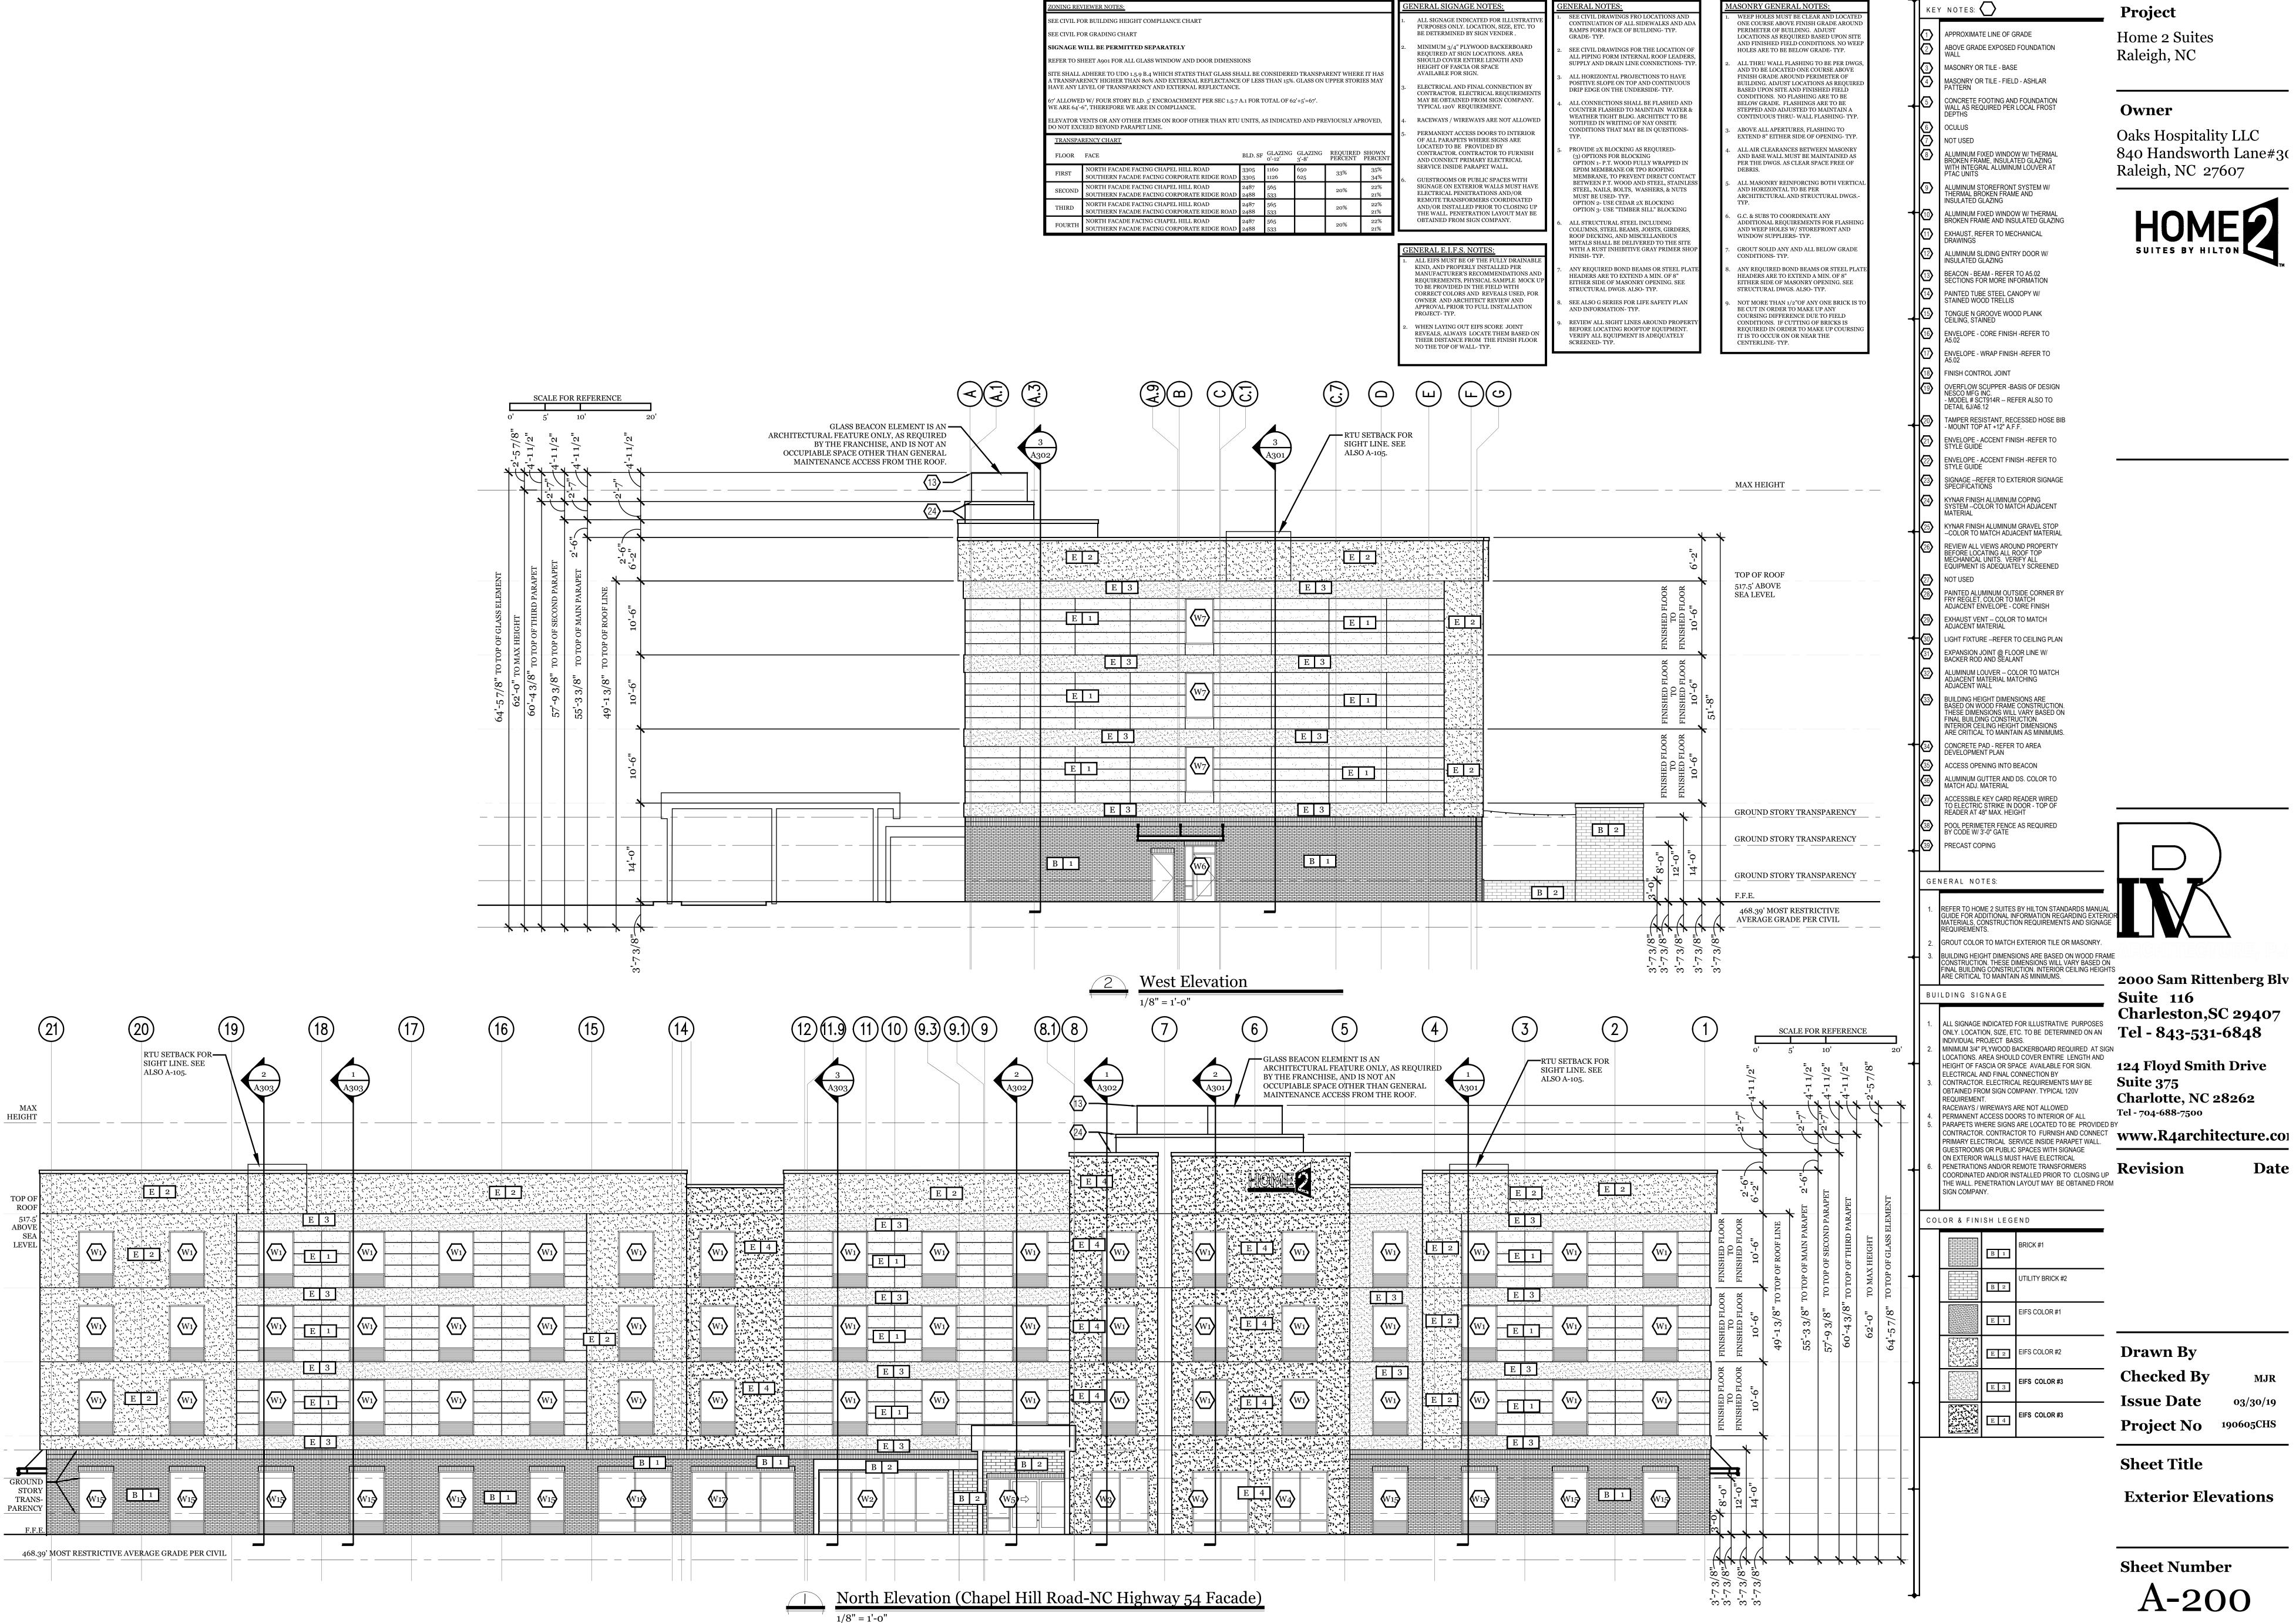
Project No 190605CHS

**Sheet Title** 

Storage & Trash Enclosure - Plan, Sections, & Details

**Sheet Number** 

A100a





ASONRY GENERAL NOTES:


840 Handsworth Lane#30



Charleston,SC 29407

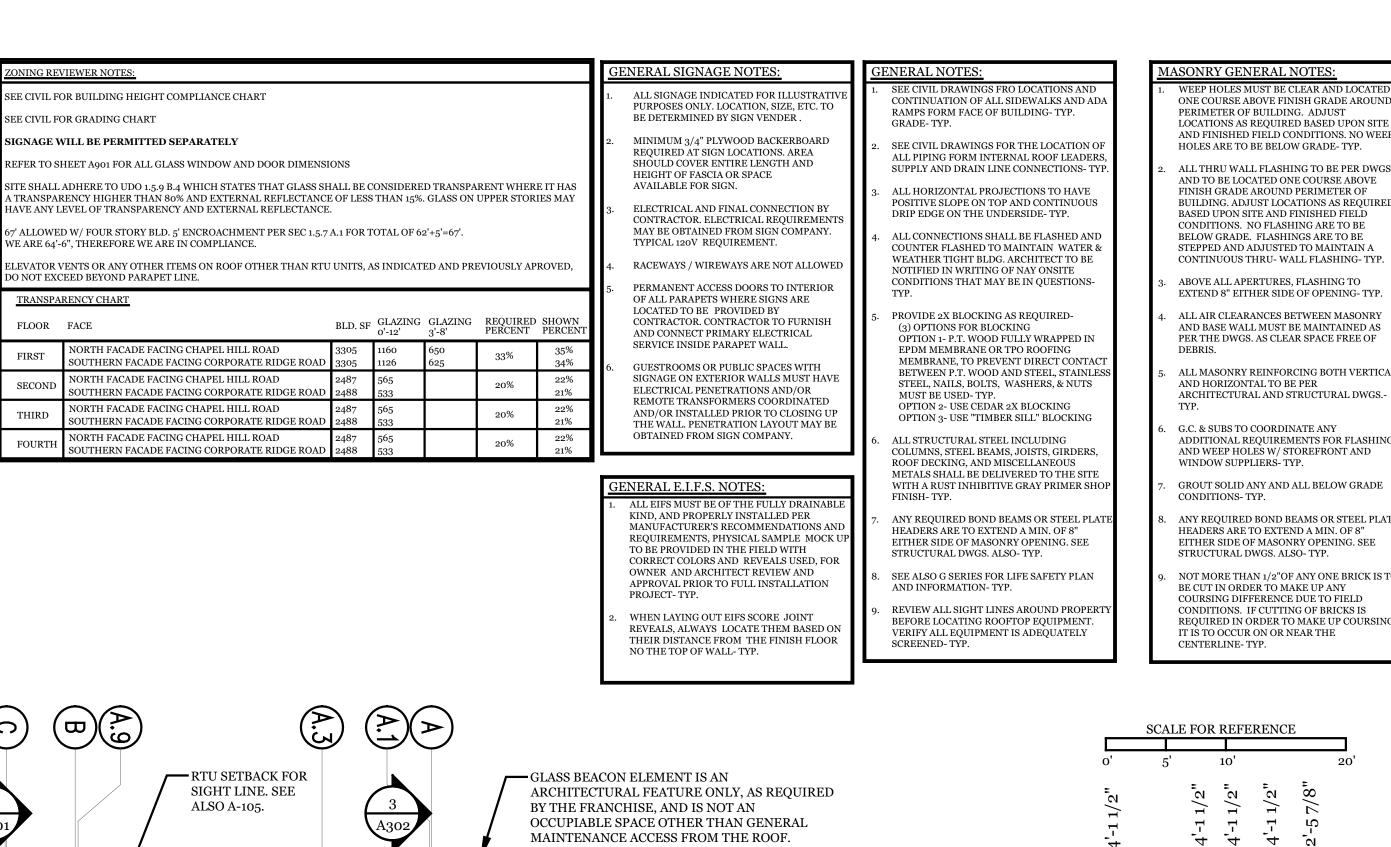

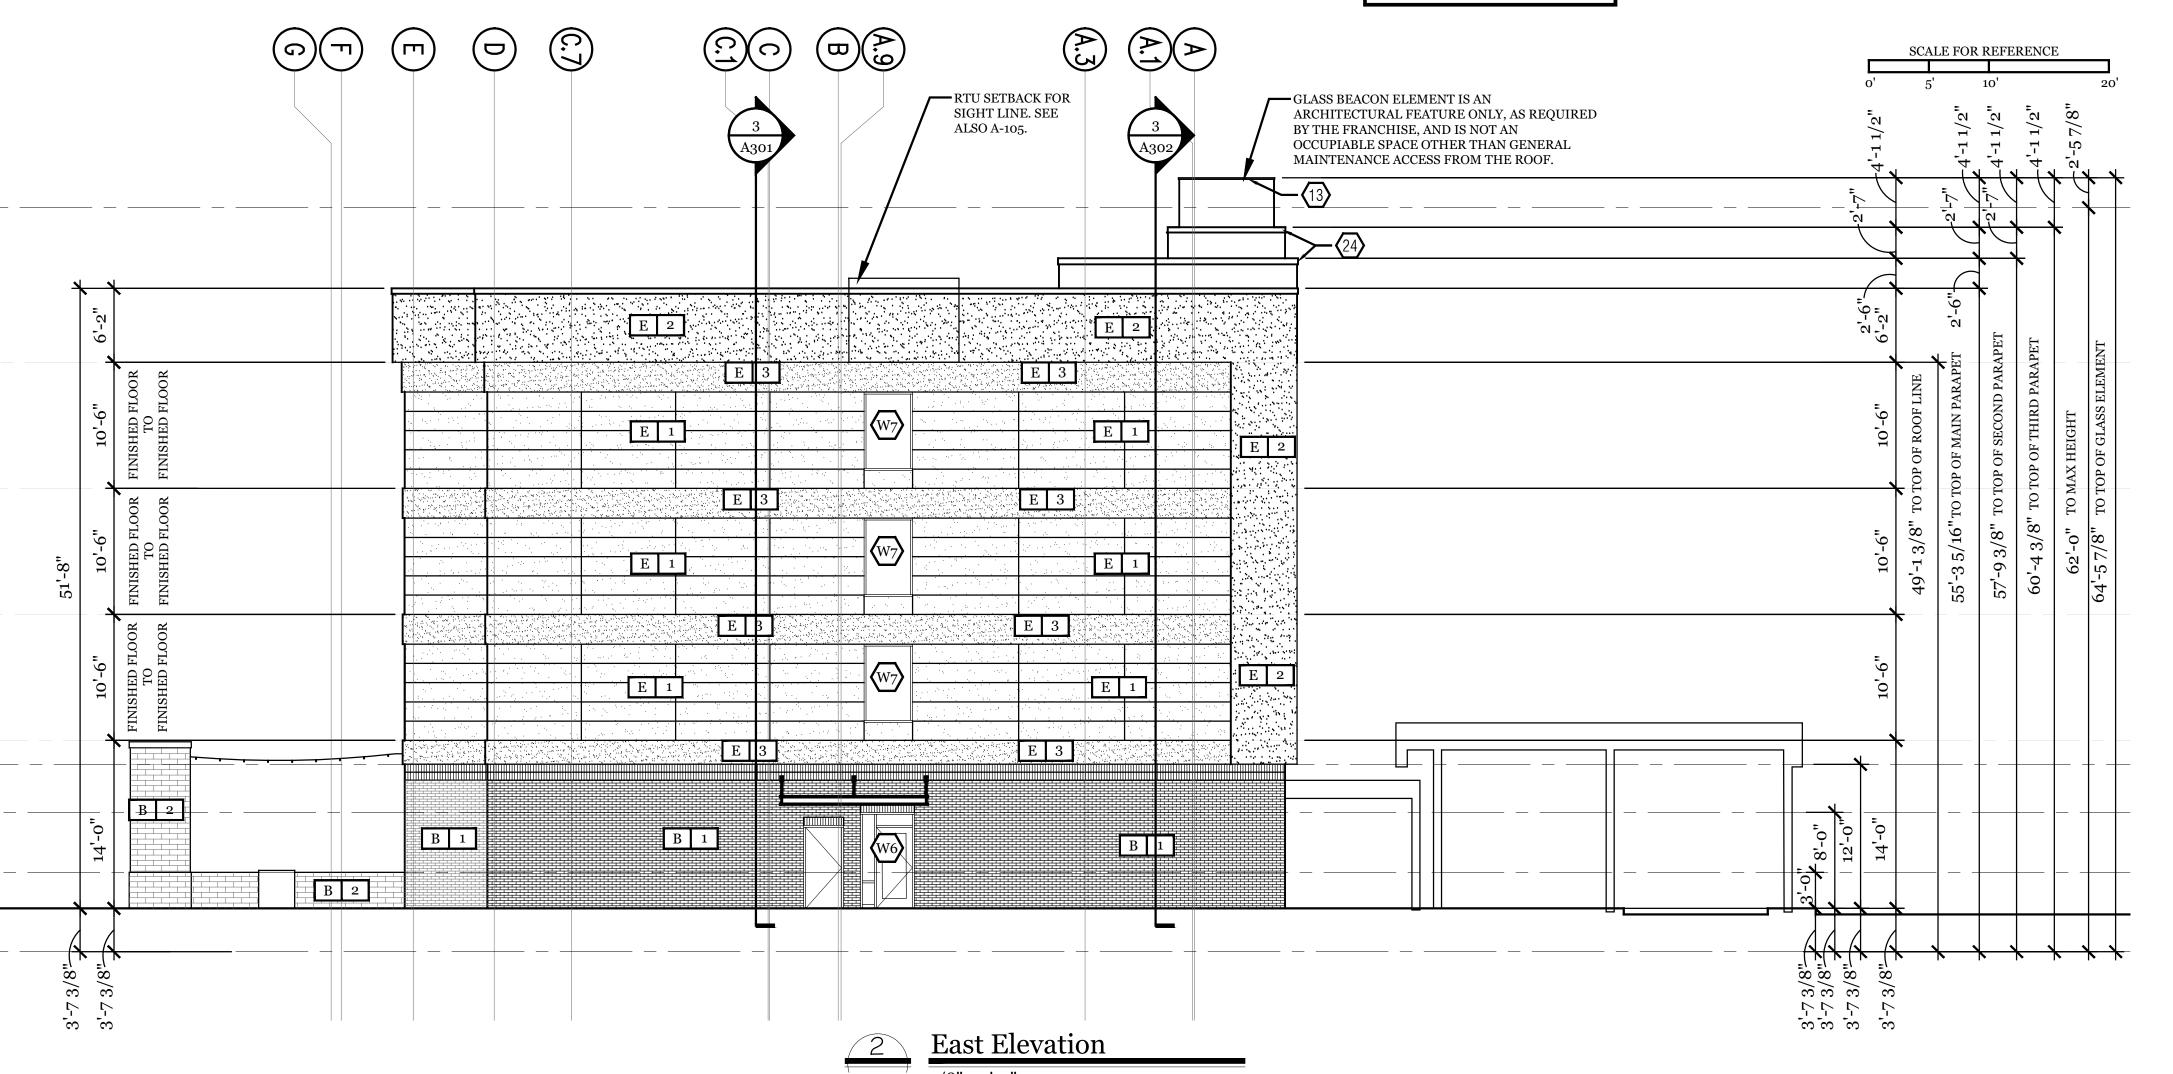

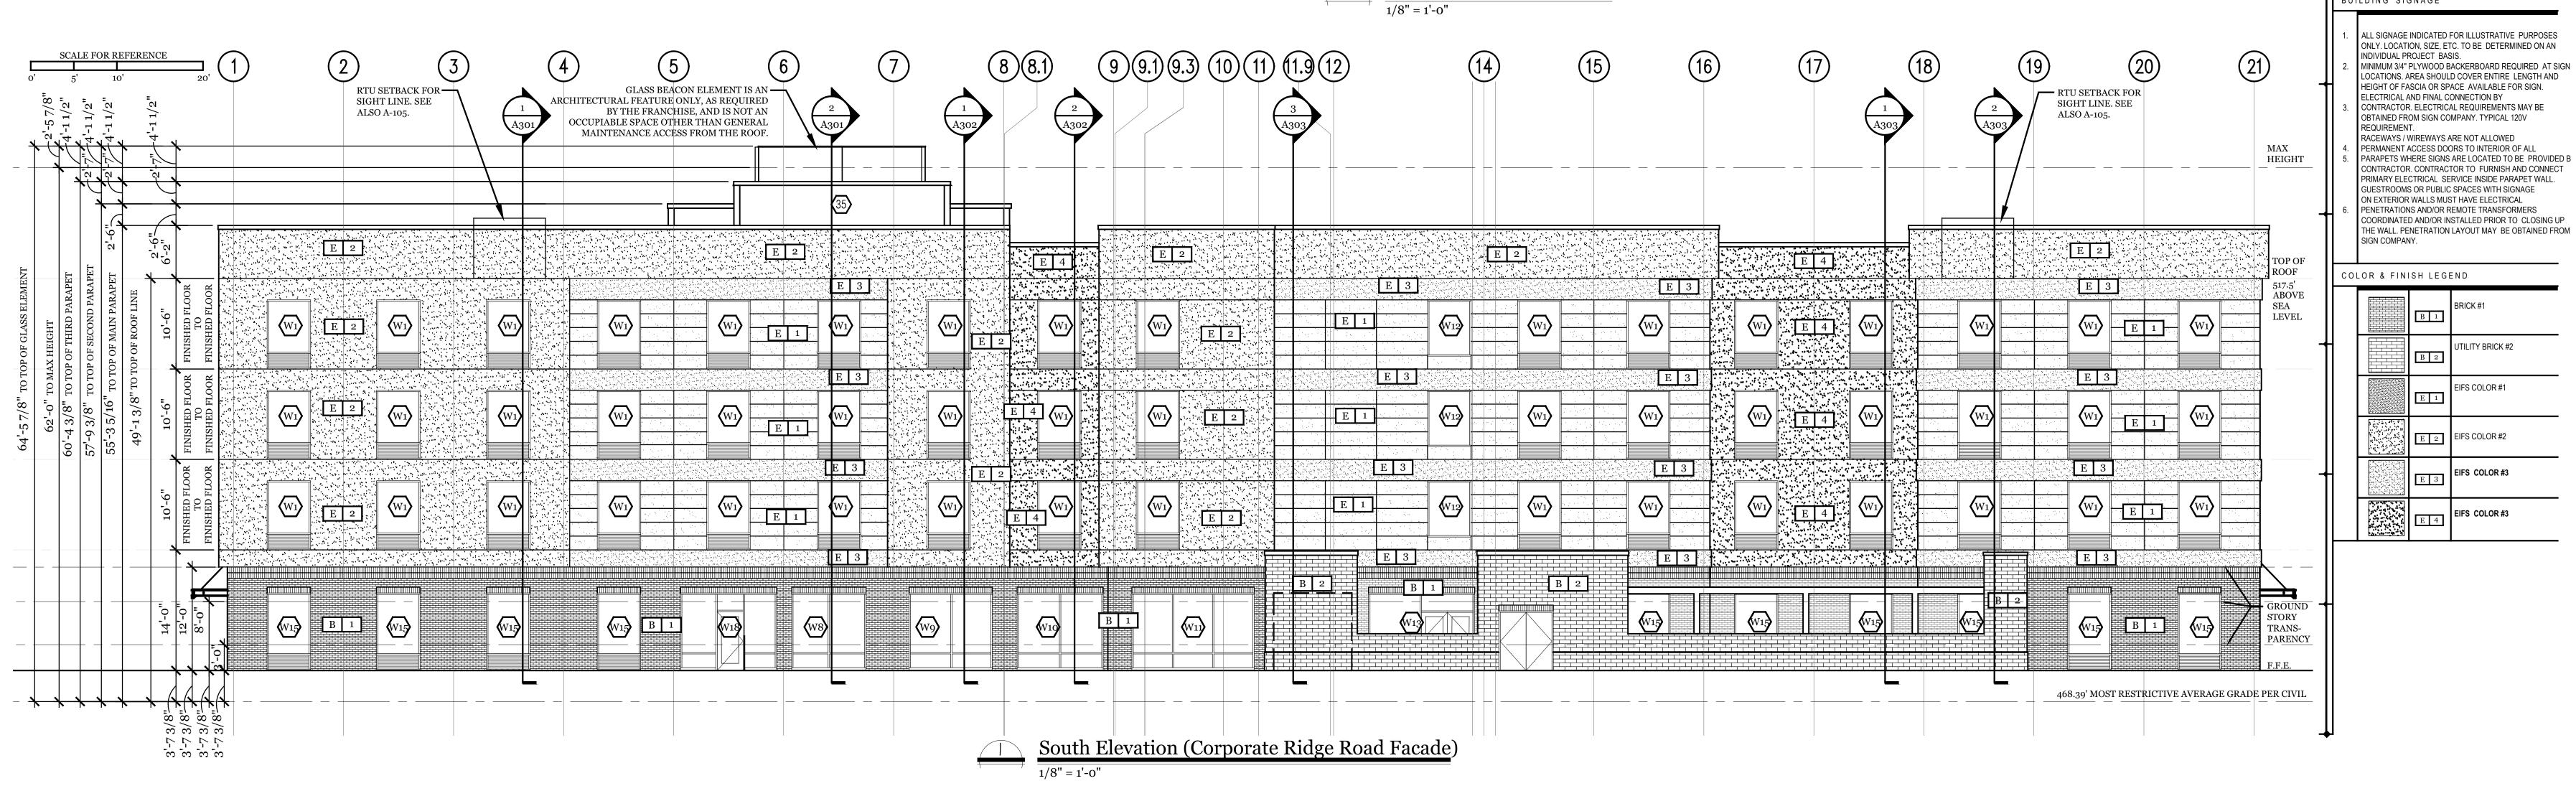

KEY NOTES:

OCULUS

NOT USED

APPROXIMATE LINE OF GRADE

MASONRY OR TILE - FIELD - ASHLAR

CONCRETE FOOTING AND FOUNDATION

WALL AS REQUIRED PER LOCAL FROST

ALUMINUM FIXED WINDOW W/ THERMAL BROKEN FRAME, INSULATED GLAZING

ALUMINUM STOREFRONT SYSTEM W/

ALUMINUM FIXED WINDOW W/ THERMAL

BROKEN FRAME AND INSULATED GLAZING

HERMAL BROKEN FRAME AND

EXHAUST, REFER TO MECHANICAL

ALUMINUM SLIDING ENTRY DOOR W/

SECTIONS FOR MORE INFORMATION

BEACON - BEAM - REFER TO A5.02

PAINTED TUBE STEEL CANOPY W/ STAINED WOOD TRELLIS

TONGUE N GROOVE WOOD PLANK

ENVELOPE - CORE FINISH -REFER TO

ENVELOPE - WRAP FINISH -REFER TO

TAMPER RESISTANT, RECESSED HOSE BIB - MOUNT TOP AT +12" A.F.F.

ENVELOPE - ACCENT FINISH -REFER TO

ENVELOPE - ACCENT FINISH -REFER TO

SIGNAGE --REFER TO EXTERIOR SIGNAGE

KYNAR FINISH ALUMINUM GRAVEL STOP

STEM --COLOR TO MATCH ADJACENT

-COLOR TO MATCH ADJACENT MATERIAL REVIEW ALL VIEWS AROUND PROPERTY BEFORE LOCATING ALL ROOF TOP MECHANICAL UNITS. VERIFY ALL

EQUIPMENT IS ADEQUATELY SCREENED

PAINTED ALUMINUM OUTSIDE CORNER BY FRY REGLET, COLOR TO MATCH ADJACENT ENVELOPE - CORE FINISH

(29) EXHAUST VENT -- COLOR TO MATCH

130 LIGHT FIXTURE --REFER TO CEILING PLAN

ALUMINUM LOUVER -- COLOR TO MATCH ADJACENT MATERIAL MATCHING ADJACENT WALL

CONCRETE PAD - REFER TO AREA DEVELOPMENT PLAN

ACCESS OPENING INTO BEACON

READER AT 48" MAX. HEIGHT

POOL PERIMETER FENCE AS REQUIRED BY CODE W/ 3'-0" GATE

PRECAST COPING

GENERAL NOTES:

ALUMINUM GUTTER AND DS. COLOR TO MATCH ADJ. MATERIAL

ACCESSIBLE KEY CARD READER WIRED TO ELECTRIC STRIKE IN DOOR - TOP OF

ARE CRITICAL TO MAINTAIN AS MINIMUMS.

REFER TO HOME 2 SUITES BY HILTON STANDARDS MANUAL

EXPANSION JOINT @ FLOOR LINE W/ BACKER ROD AND SEALANT

BASED ON WOOD FRAME CONSTRUCTION THESE DIMENSIONS WILL VARY BASED O FINAL BUILDING CONSTRUCTION. INTERIOR CEILING HEIGHT DIMENSIONS

ARE CRITICAL TO MAINTAIN AS MINIMUM

KYNAR FINISH ALUMINUM COPING

OVERFLOW SCUPPER -BASIS OF DESIGN NESCO MFG INC. - MODEL # SCT914R -- REFER ALSO TO

CEILING, STAINED

[18] FINISH CONTROL JOINT

NSULATED GLAZING

ITH INTEGRAL ALUMINUM LOUVER AT


MASONRY OR TILE - BASE

**Project** Home 2 Suites ABOVE GRADE EXPOSED FOUNDATION Raleigh, NC

Owner

Oaks Hospitality LLC 840 Handsworth Lane#30 Raleigh, NC 27607



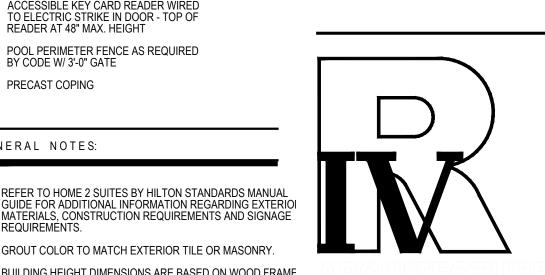

CONSTRUCTION. THESE DIMENSIONS WILL VARY BASED ON FINAL BUILDING CONSTRUCTION. INTERIOR CEILING HEIGHTS 2000 Sam Rittenberg Blv Suite 116 Charleston, SC 29407 Tel - 843-531-6848

> 124 Floyd Smith Drive Suite 375 Charlotte, NC 28262 Tel - 704-688-7500

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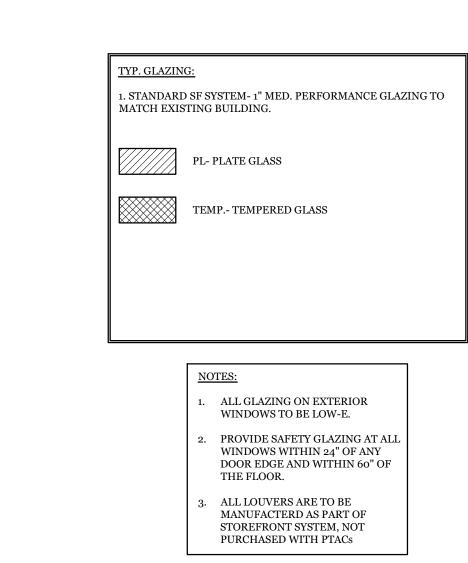
UTILITY BRICK #2


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**Issue Date** Project No 190605CHS

**Sheet Title Exterior Elevations** 

**Sheet Number** A-201





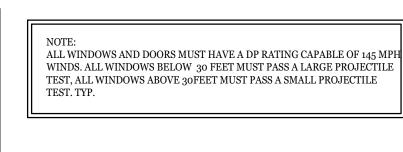



**Project** 


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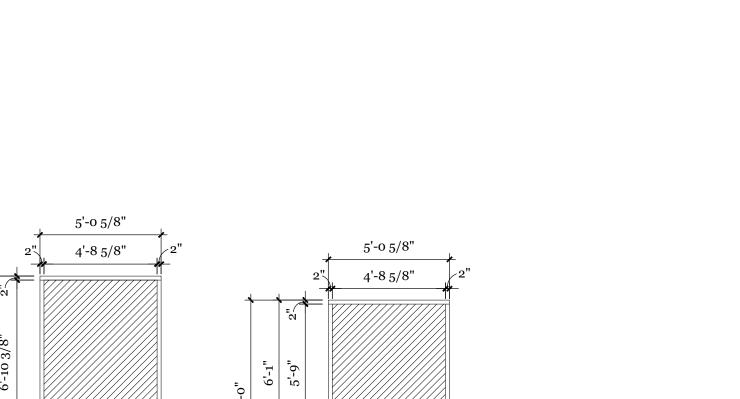
Home 2 Suites Raleigh, NC

Oaks Hospitality LLC 840 Handsworth Lane#306


Raleigh, NC 27607





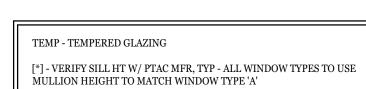

W14 GLAZING:40.38 SF

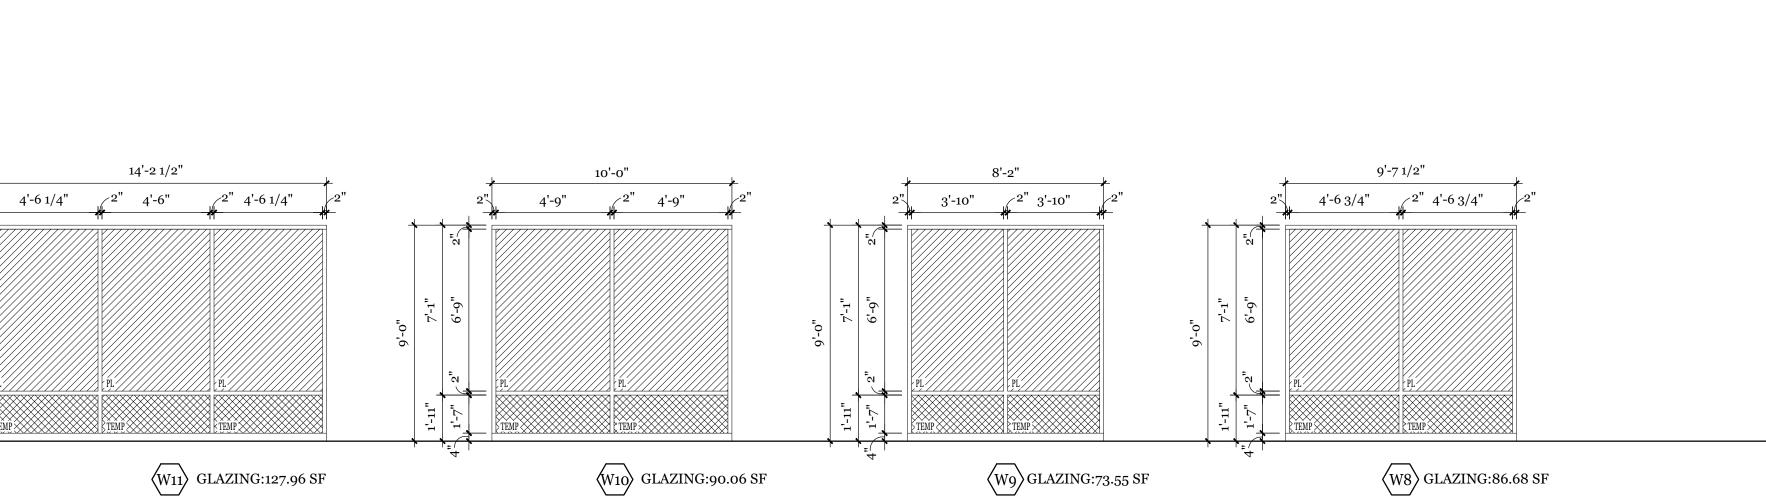

1-95/8"

W15 GLAZING:45.53 SF W/O GRILL: 36.32 SF

10'-6 7/8"

5'-0 3/8" 2" 5'-0 3/8"

W16 GLAZING:95.11 SF

3'-11 1/4" 3'-4" 3'-8 3/4"
3'-11 1/4" 2" 3'-2" 2"3'-6 3/4"

W13 GLAZING:110.95 SF

W6 GLAZING:35.99 SF

W7 GLAZING:26.41 SF

W18 GLAZING: 100.5 SF

W12 GLAZING:32.94 SF

2" 3'-9 1/4" 2"3'-9 1/4" 2"

W4 GLAZING:72.43 SF

3'-3 3/4" 8'-4 1/4" 2" 2'-11 3/4" 2" 4'-1 1/8" 4'-1 1/8"


 $\langle W_5 \rangle$  GLAZING:93.31 SF

14'-8 3/4"

4'-8 5/8" 2" 4'-8 5/8" 2" 4'-7 3/8" 2"

W17 GLAZING: 132.57 SF

2" 3'-10 1/4" 2"3'-10 1/4" 2"

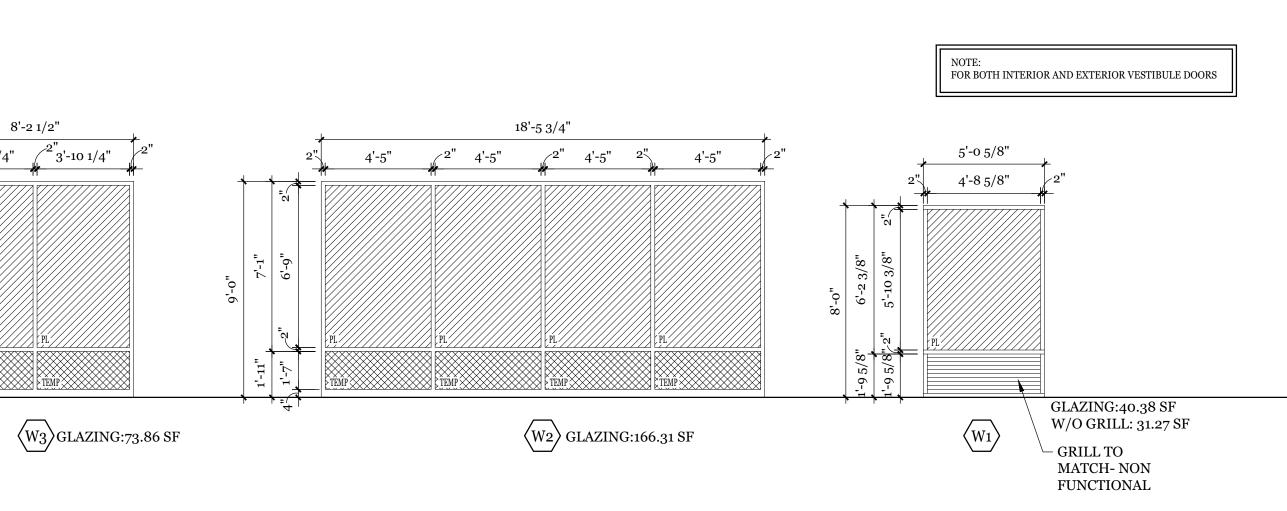

 $\frac{\text{Window Types}}{1/4" = 1'-0"}$ 

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Project No 190605CHS

**Sheet Title** 

Window Elevations

**Sheet Number** A-901