

Administrative Approval Action

Case File / Name: ASR-SR-32-2019 904 & 906 Method Road Duplex

City of Raleigh **Development Services Department** One Exchange Plaza Raleigh, NC 27602 (919) 996-2492 currentplanning@raleighnc.gov www.raleighnc.gov

LOCATION: This site is located north of Western Boulevard on the west side of Method Road at

904 and 906 Method Road.

REQUEST: Development of two attached houses (duplexes), both 2 stories, on an existing two

lots totalling 0.488 acres tract, zoned R-10 and SRPOD, into a proposed combined

6,852 square foot/total of 4 units, 2 units in each duplex building structure.

The two existing lots are a part of an approved subdivision plan SUB-S-57-2016 "Method Oaks Subdivision" recorded in BM 2017 PG 2052. Lot 1 being 10,637 sf/.244 acres & Lot 2 being 10,647 sf/.244 acres. The lots are currently vacant and the demolition permit is noted on the coversheet of the ASR plans (note #2).

DESIGN

ADJUSTMENT(S)/

N/A

ALTERNATES, ETC:

FINDINGS: City Administration finds that this request, with the below conditions of

approval being met, conforms to the Unified Development Ordinance. This approval is based on a preliminary plan dated October 16, 2019 by CMS

Engineering PLLC.

CONDITIONS OF APPROVAL and NEXT STEPS:

This document must be applied to the second sheet of all future submittals except for final plats. This is a preliminary plan and as such no permits have been issued with this approval. To obtain permits and/or completion of the project, the following steps are required:

☑ BUILDING PERMITS - For buildings and structures shown on the approved plans. Commercial building permit plans must include the signed, approved Site Permitting Review plans attached, if applicable. Permit sets may be reviewed prior to the recordation of required plats, but cannot be approved.

The following items must be approved prior to the issuance of building permits:

General

- 1. On building elevation Sheet A-3, on the "east elevation" illustration, the 'lowest' spot grade is shown along the elevation plane.
- 2. The gross floor area for each individual building is indicated on the building permit plans for both structures.

Engineering

- 3. A right-of-way obstruction permit shall be obtained from Right-of-way Services for any construction activity within the right-of-way.
- 4. A public infrastructure surety shall be provided to the City of Raleigh Development Services -Development Engineering (UDO 8.1.3) for the street trees if documentation that the surety for the street trees was paid prior to recordation of lots cannot be provided.

Public Utilities



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A plat must be recorded at the Wake County Register of Deeds office for all utility easement dedications.

Stormwater

- 6. The City form document entitled Declaration of Maintenance Covenant and Grant of Protection Easement for Stormwater Control Facilities shall be approved by the City and recorded with the county register of deeds office (UDO 9.2.2.G).
- 7. A stormwater control plan with a stormwater operations and maintenance manual and budget shall be approved (UDO 9.2).
- 8. These lots are exempt per UDO Section 9.2.2.A.2.b.i as a commercial subdivision of one-half acre or less approved after May 1, 2001, but are subject to impervious limitations of subsection A.4 and subject to further review upon placement of impervious surface areas.
- A surety equal to of the cost of clearing, grubbing and reseeding a site, shall be paid to the City (UDO 9.4.4).
- 10. If total land disturbance will be over 12,000 sq. ft. for multiple buildings, a separate site plan submittal & approval will be required. Site plans require an erosion control plan. (UDO 9.4.6.)
- 11. A payment equal to twenty-four percent (24%) of the estimated cost of constructing all stormwater control facilities shown on the development plans shall be paid by the developer to the City stormwater facility replacement fund (UDO 9.2.2.G.3).
- 12. All stormwater control measures and means of transporting stormwater runoff to and from any stormwater runoff control measures shall be shown on all plats for recording as private drainage easements (UDO 9.2).

Urban Forestry

13. A tree impact permit must be obtained for the approved streetscape tree installation in the right of way. This development proposes 3 street trees along Method Road.

The following are required prior to issuance of building occupancy permit:

Stormwater

- 1. As-built impervious survey is accepted by the Engineering Services Department (UDO 9.2).
- 2. As-built drawings and associated forms for all Stormwater devices are accepted by the Engineering Services Department (UDO 9.2.2.D.3).

EXPIRATION DATES: The expiration provisions of UDO Section 10.2.8 E, including the ability to request extensions in the expiration date, apply to this site plan. If significant construction has not taken place on a project after administrative site review



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approval, that approval may expire and be declared void, requiring re-approval before permits may be issued. To avoid allowing this plan approval to expire the following must take place by the following dates:

3-Year Expiration Date: November 26, 2022

Obtain a valid building permit for the total area of the project, or a phase of the project.

4-Year Completion Date:

I hereby certify this administrative decision.

Within four years after issuance of the first building permit for the site plan, the construction of the entire site plan must be completed unless an applicant has been granted vested rights. Failure to complete construction within this specified time frame shall automatically void the approved site plan for which no building permits have been issued.

VICINITY MAP SCALE: 1"=500'

INDEX TITLE & EXISTING CONDITIONS SP-1 INFILL COMPATIBILITY SP-1A SITE & UTILITY PLAN SP-2 GRADING & STORMWATER PLAN .. SP-3 LANDSCAPE PLAN SP-4 LOT 1 BUILDING ELEVATIONS A-1-1 LOT 1 BUILDING ELEVATIONS A-2-1 LOT 2 BUILDING ELEVATIONS A-1-2 LOT 2 BUILDING ELEVATIONS A-2-2

Lot Number(s) by Phase **Number of Units** Open Space?

Attached

☐ Apartment

Development Name 904 & 906 Method Road

- 1. PRELIMINARY SUBDIVISION APPROVAL CASE S-57-16, Trans. #485284, recorded in BM 2017 Pg 205.
- 2. DEMOLITION PERMIT NO. BL-131000. BOUNDARY SURVEY AND ALL EXISTING ON—SITE AND OFF—SITE FEATURES PROVIDED BY TRUE LINE SURVEYING, PC.
- 4. ALL CONSTRUCTION SHALL COMPLY WITH APPLICABLE CITY OF RALEIGH DEVELOPMENT STANDARDS AND SPECIFICATIONS
- 5. ALL NEW DRIVEWAY LOCATIONS WILL BE DETERMINED AND PERMITTED AT SITE PLAN SUBMITTAL PER CITY OF RALEIGH STANDARDS.
- 6. DEVELOPERS HAVE REVIEWED AND ARE IN COMPLIANCE WITH THE REQUIREMENTS SET FORTH IN THE SOLID WASTE DESIGN MANUAL
- SOLID WASTE SERVICE WILL BE PROVIDED AT PUBLIC STREET BY 96-GAL. STANDARD CITY OF RALEIGH RESIDENTIAL SOLID WASTE CART PER CITY OF RALEIGH WASTE DESIGN MANUAL
- 8. A SURETY OF 125% OF ESTIMATED CONSTRUCTION COST IS REQUIRED FOR THE CONSTRUCTION COSTS OF ALL PUBLIC IMPROVEMENTS WHICH ARE NOT COMPLETE AT THE TIME OF BUILDING PERMIT
- 9. PER SEC. 9.1, THIS PROJECT IS EXEMPT FROM CITY OF RALEIGH TREE CONSERVATION REQUIREMENTS

Administrative Site Review Application (for UDO Districts only)

pment Services Customer Service Center | 1 Exchange Plaza, Suite 400 | Raleigh, NC 27601 | 919-996-2495 | efax 919-996-1831

When submitting plans, please check the appropriate building type and include the Plan Checklist document

Apartment Elderly Facilities Hospitals Hotels/Motels

Non-Residential Condo School Shopping Center Banks

Telecommunication Tower Religious Institutions Residential Condo Retail

Phone (919) 833-0830 Email patti@cmsengineering.net

Construction of two duplexes (four units) on two lots

☐ General

☐ Mixed Use

10. RESIDENTIAL INFILL RULES APPLY (SEC.2.2.7) AND PROPOSED SETBACKS AND BUILDING HEIGHTS ARE BASED ON SAID RULES.

DEVELOPMENT SERVICES DEPARTMENT

FOR OFFICE USE ONLY

Transaction Number

Assigned Project Coordinator


Assigned Team Leader


Building Information otal Ste Acros - Incide City Limits 🗷 yes 🔲 No UD (Conditional Use District) case # 2- N/A

IRFAN SIDDIQUI DB 16280 PG 678 PIN 0794-01-4359 EUGENE POWELL DB 8346 PG 2004 PIN 0794-01-4259 Faul D. Hafre Carlow Properties CC. SIGNATURE(S) & TITLE/POSITION/OF PROPERTY OWNER(S): MPMON/ MANAGER VICINITY MAP (NOT TO SCALE) NO. 5 REBAR IRON STAKES SET AT ALL LOT CORNERS UNLESS OTHERWISE NOTED 5) ZONING: R-10 SRPOD 5) PARENT TRACT DEED DB 16306 PG 2162 7) REID: 0076593 15981 SF 0.367 AC 7) REID: 0076593 8) NO HORIZONTAL CONTROL FOUND WITHIN 2000' OF SURVEY 9) PARENT TRACT PIN 0794-01-6358 PIN 0794-01-6457 NEW CROSS ACCESS EASEMENT 0) EXISTING ADDRESS: 904 METHOD ROAD, RALEIGH, NC 27606 1) EXISTING LAND USE: RESIDENTIAL Molly L. Derny Signature Printed Name: Mally L. Herring Sonary Public Sonary 1.7 EASIMED LAND USE: RESIDENTIAL 12) THE SUBDINISION IS SUBJECT TO STORMWATER REGULATIONS AND EXEMPTIONS UNDER ARTICLE 9.2.2.A.2.b.i OF THE UDO 3) DEMO PERMIT FOR STRUCTURE ON PARENT LOT: #131000 MY COMMISSION EXPIRES: 119 19 10637 SF 0.244 AC 10647 SF 0.244 AC DB 16306 PG 2162 DB 16280 PG 678 DB 12640 PG 198 DB 8346 PG 2004 DB 15519 PG 1801 DB 8171 PG 1437 THIS PLAT OR MAP IS NOT A SUBDIVISION, BUT A RECOMBINATION OF PREVIOUSLY PLATTED PROPERTY, AND MEETS ALL STATUTORY REQUIREMENTS FOR RECORDING. PLANNING AND DEVELOPMENT OFFICER/ WAKE COUNTY REVIEW OFFICER METHOD ROAD 60' R/W (PUBLIC) METHOD OAKS PROPERTY SHOWN HEREON IS NOT AS SHOWN LOCATED IN A FEMA DESIGNATED FLOOD ZONE. FEMA FLOOD HAZARD PANEL NO. 3720079400 EFFECTIVE DATE: 05/2/2006 **SUBDIVSION** RALEIGH TOWNSHIP, WAKE COUNTY NORTH CAROLINA LEGEND IRON PIPE FOUND IRON PIPE STONMENT FOUND IRON PIPE SEMENATED FOUND IRON PIPE SEMENATED FOUND PROBLEMANT FOUND PROBLEMANT FOUND COUNTY IRON HAKE COUNTY. NC 118 CHARLES P. GILLIAH REGISTER OF DEEDS PRESENTED 8 RECORDED ON 10/12/2017 15:06:11 BOOK:BH2017 PAGE:02052 TRUE LINE SURVEYING, P.C. DRAWN BY: DANNY CHECKED BY: C, LANE PLS DRAWING NAME: FINALPLAT.DWG SURVEY DATE: 7/6/16 RECORDED IN BOM 2017 PG 2052

904 & 906 Method Road Duplex Site Plan

ASR-SR-32-2019

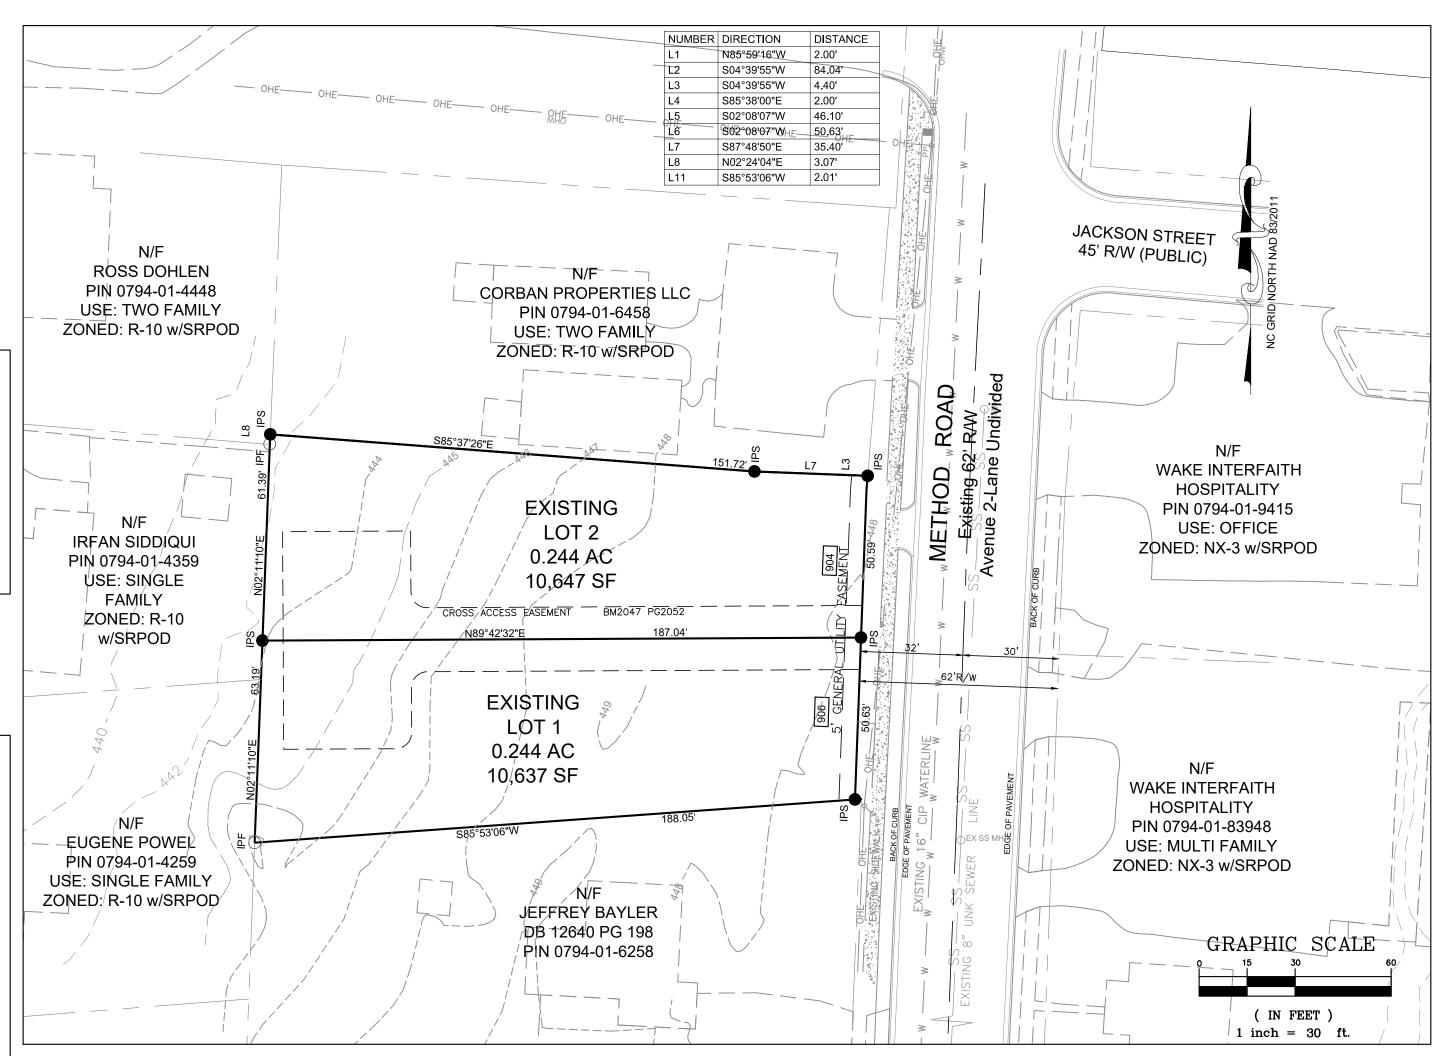

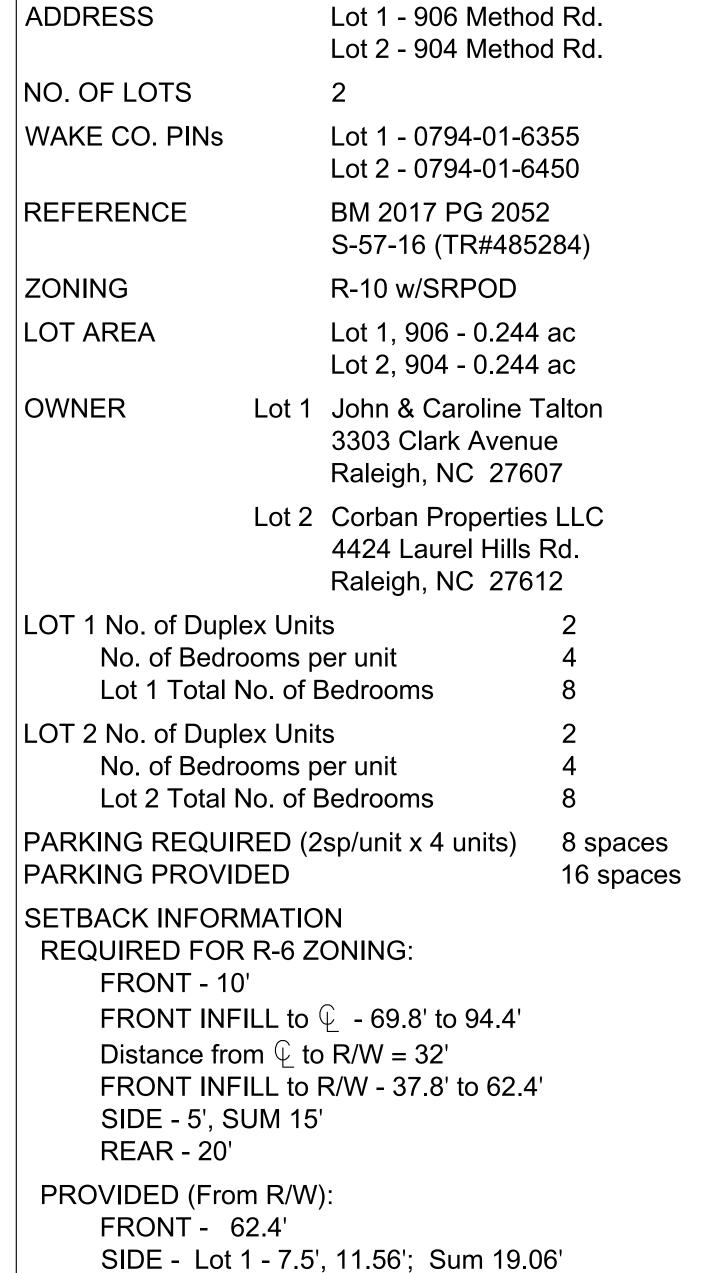


PLAN SUMMARY

STORMWATER EXEMPTION:

Lot 2 - 8.7', 12.33'; Sum 21.0'

REAR - Lot 1 - 66.47'; Lot 2 - 67.2'

PER SEC. 9.2.2.A.3, THIS PROJECT IS EXEMPT FROM CITY OF RALEIGH STORMWATER REQUIREMENTS.

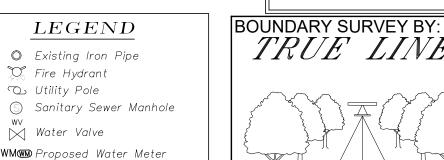

co● Proposed Sewer Clean Ou



CLAYTON, N.C. 27520 TELEPHONE: (919) 359-0427 FAX: (919) 359-0428 www.truelinesurveying.com

N.C. UNDERGROUND UTILITIES 3 DAYS BEFORE DIGGING CALL A ONE CALL SYSTEM FOR COMMUNITY AND JOB SAFETY

ASR-SR-32-2019 TRANS.#596127

EXISTING CONDITIONS

904Method SR1 DRAWN: CHECKED: PDH LAN DATE: 05/06/19


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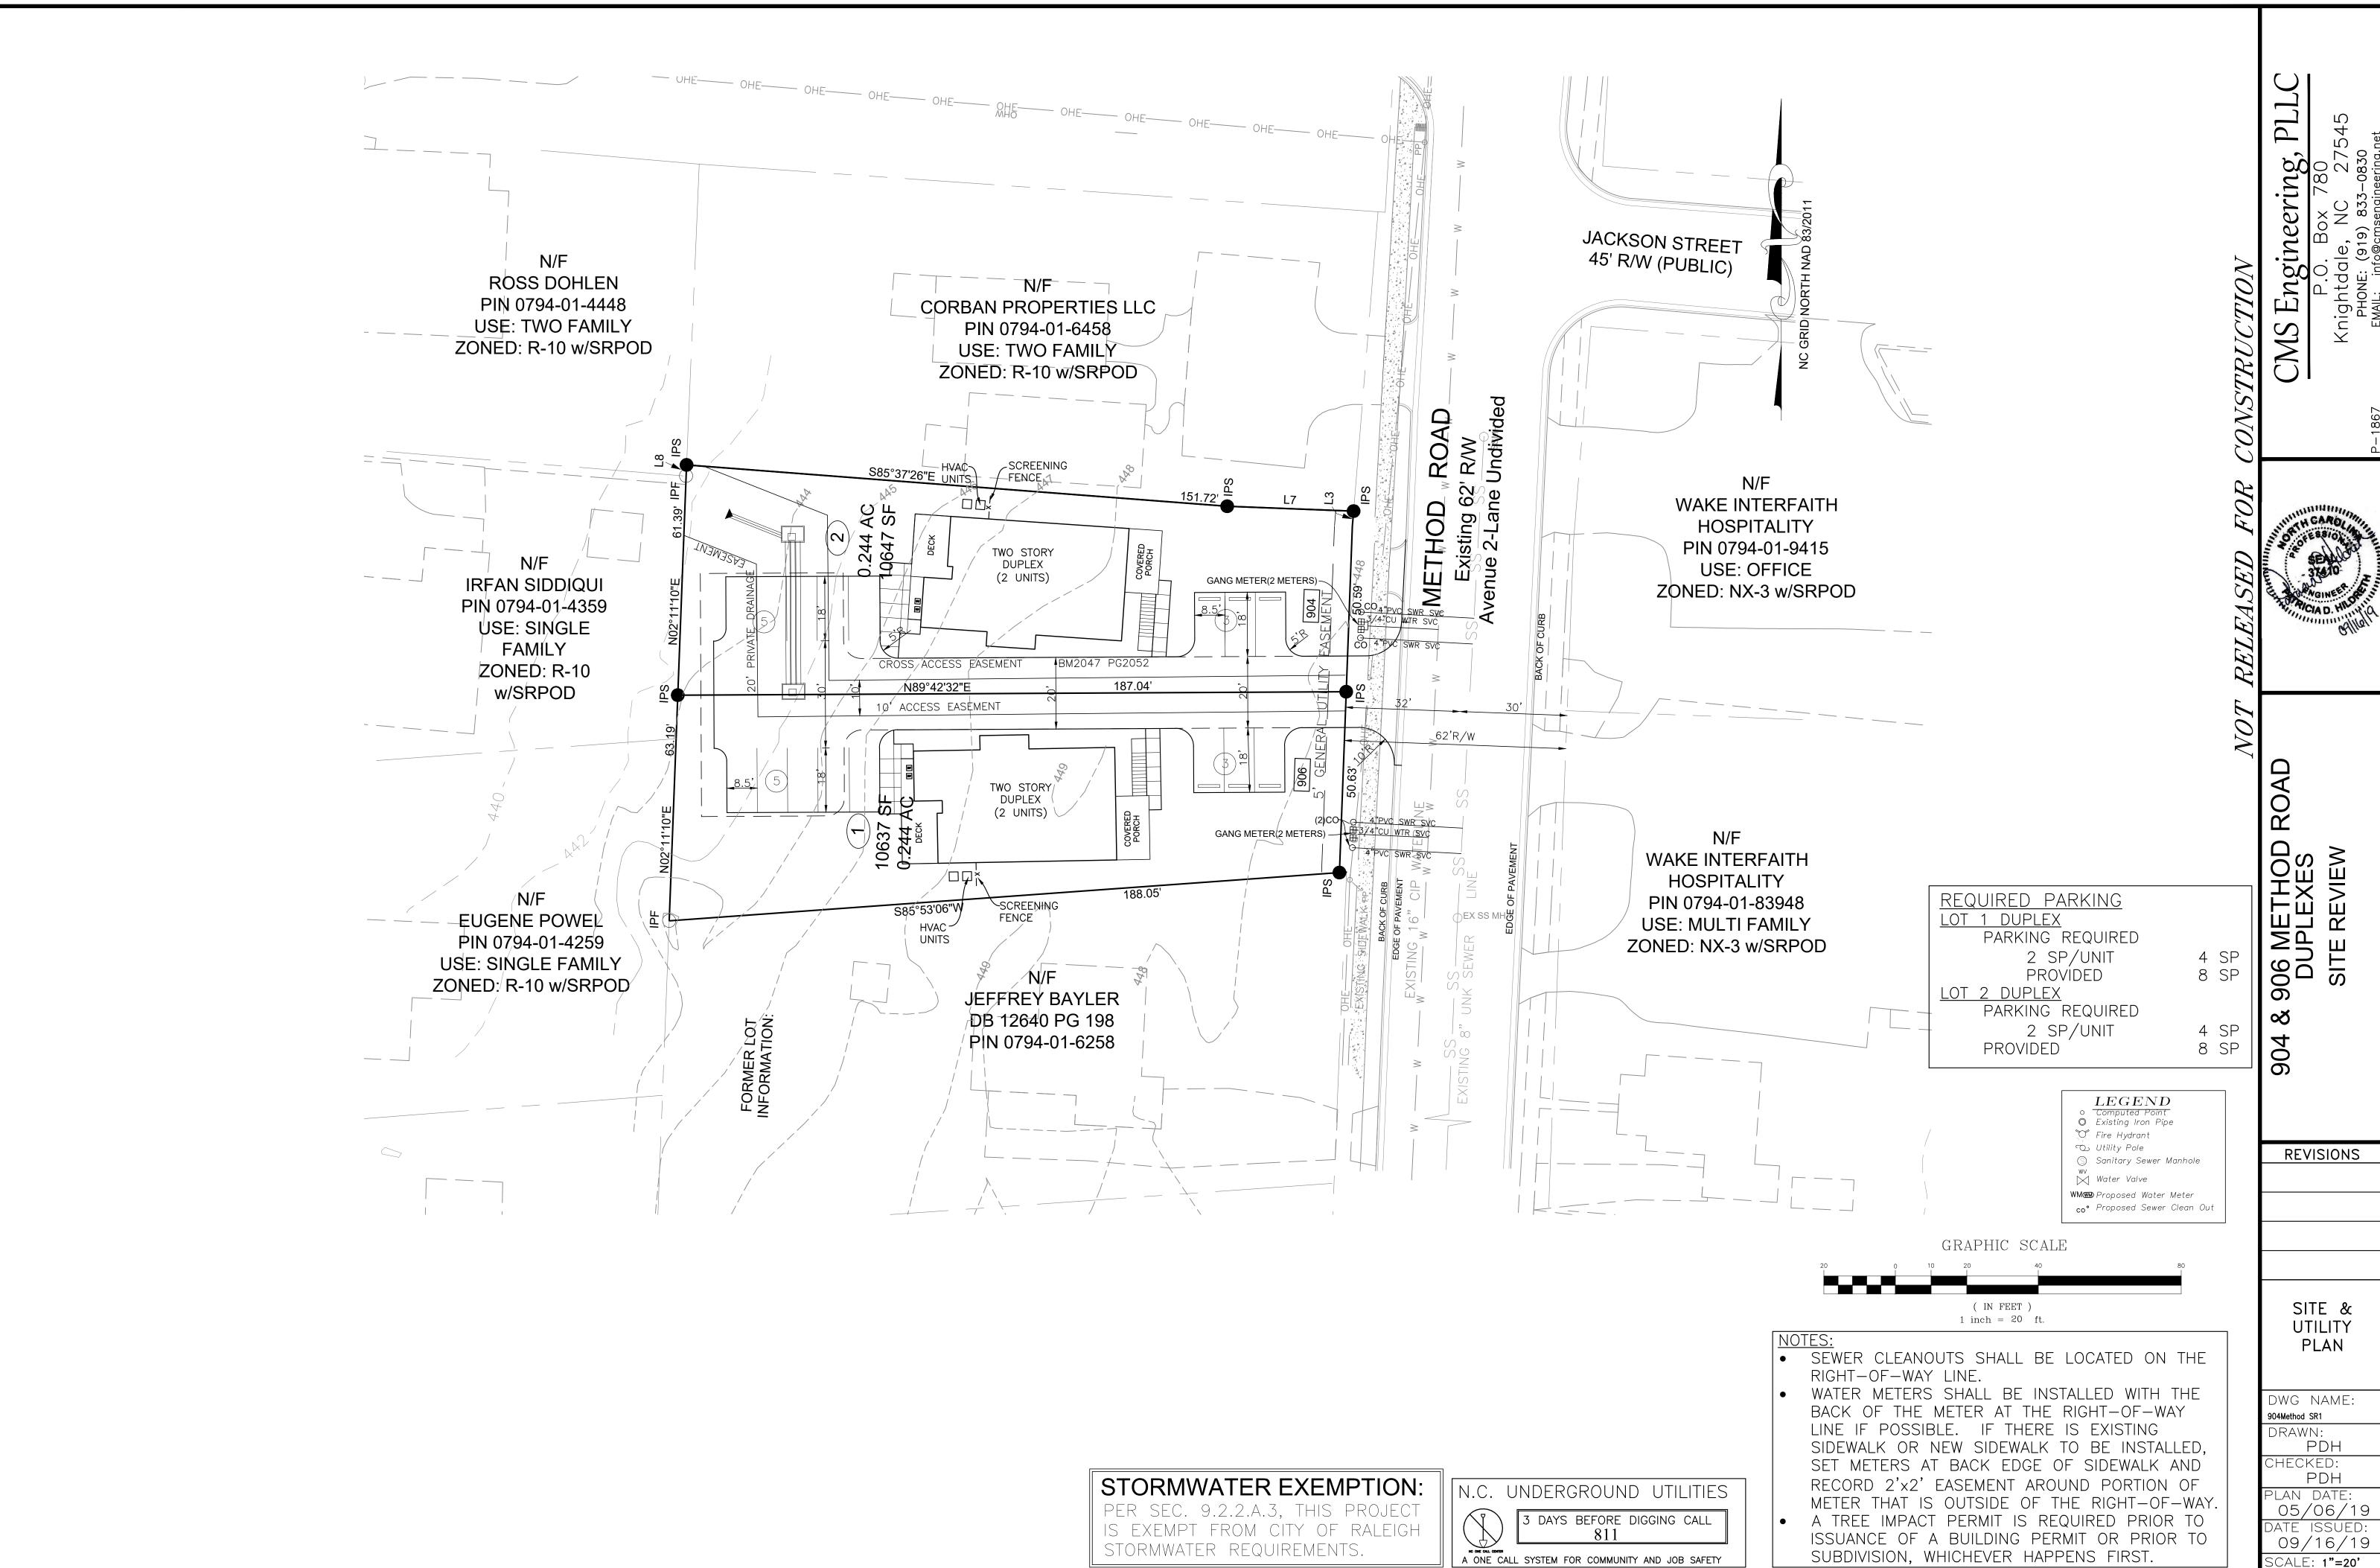
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306 METHOD DUPLEXES SITE REVIEW ASR-SR-32-2019 0

REVISIONS


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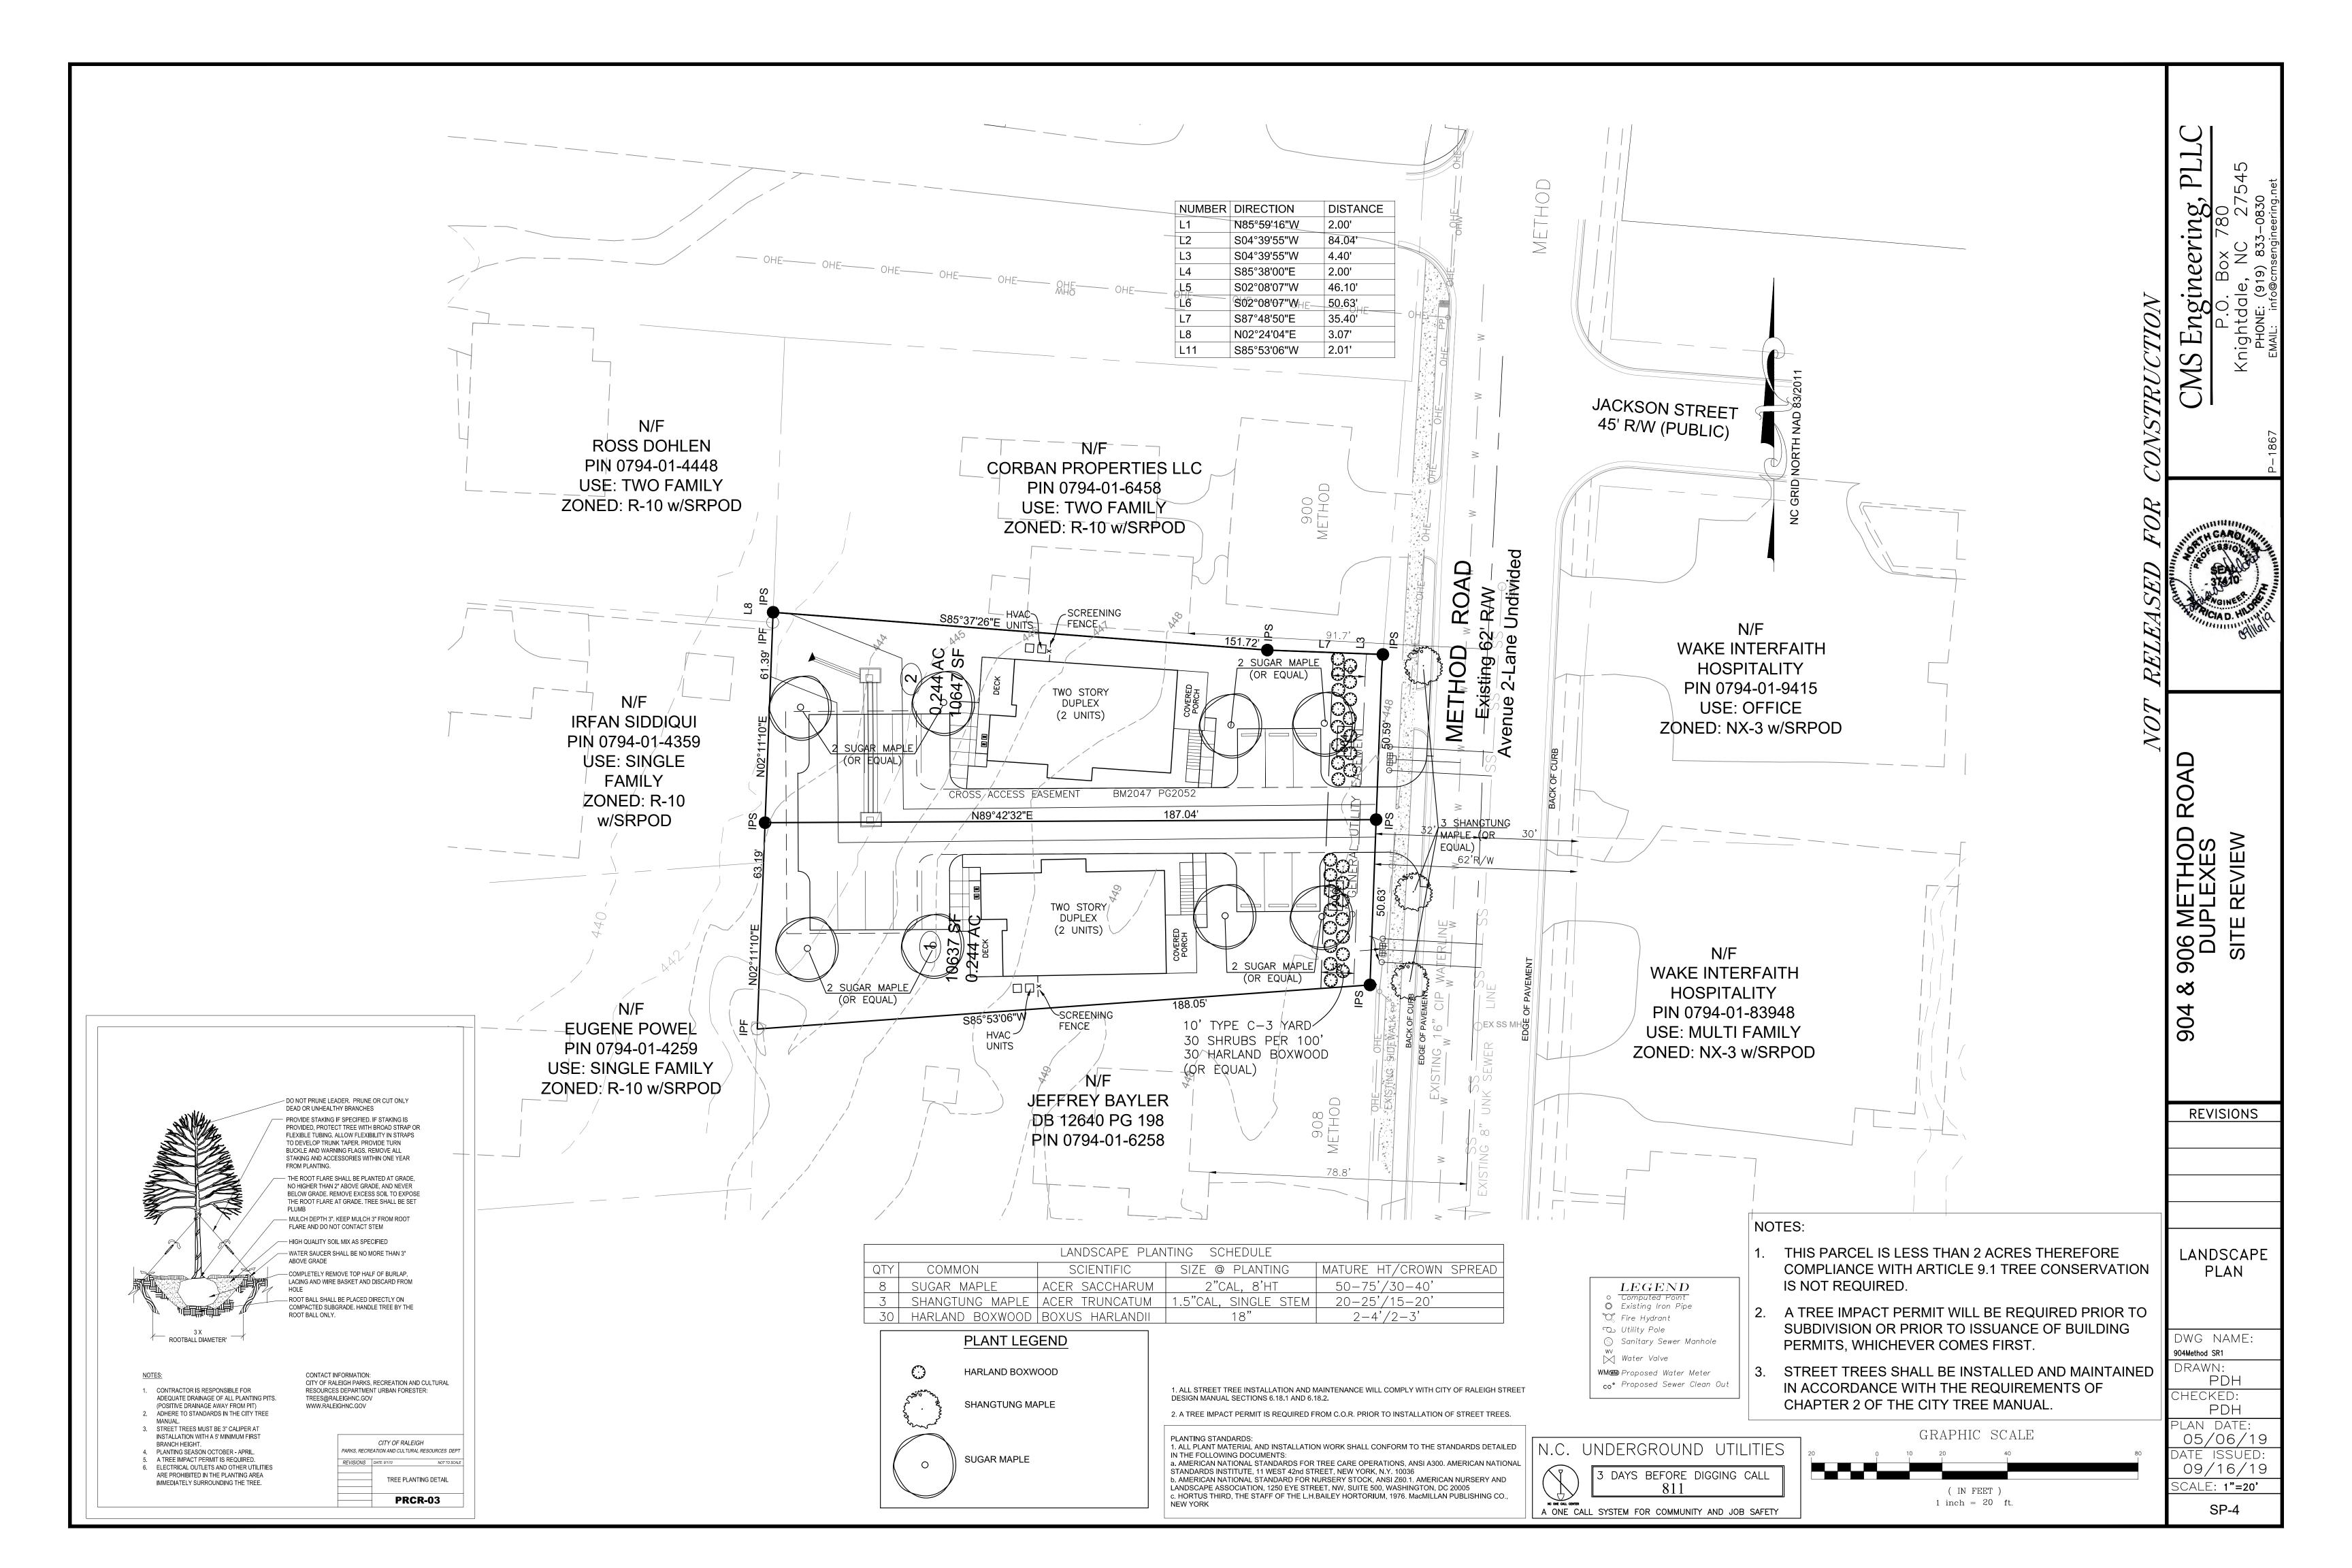






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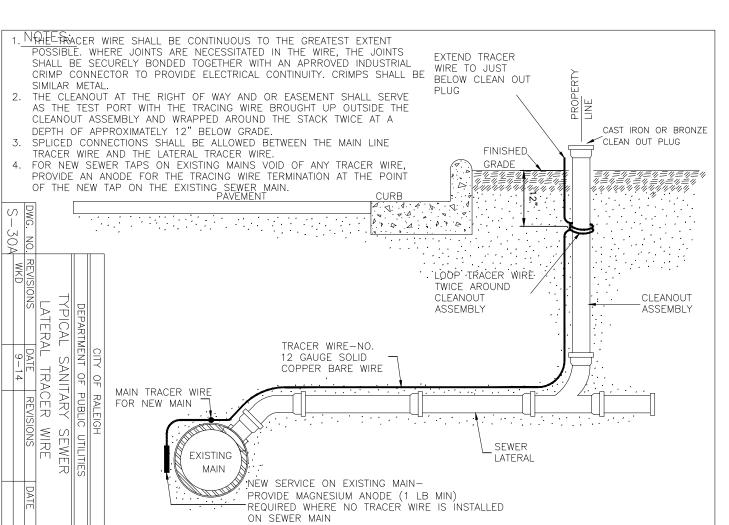
SP-2

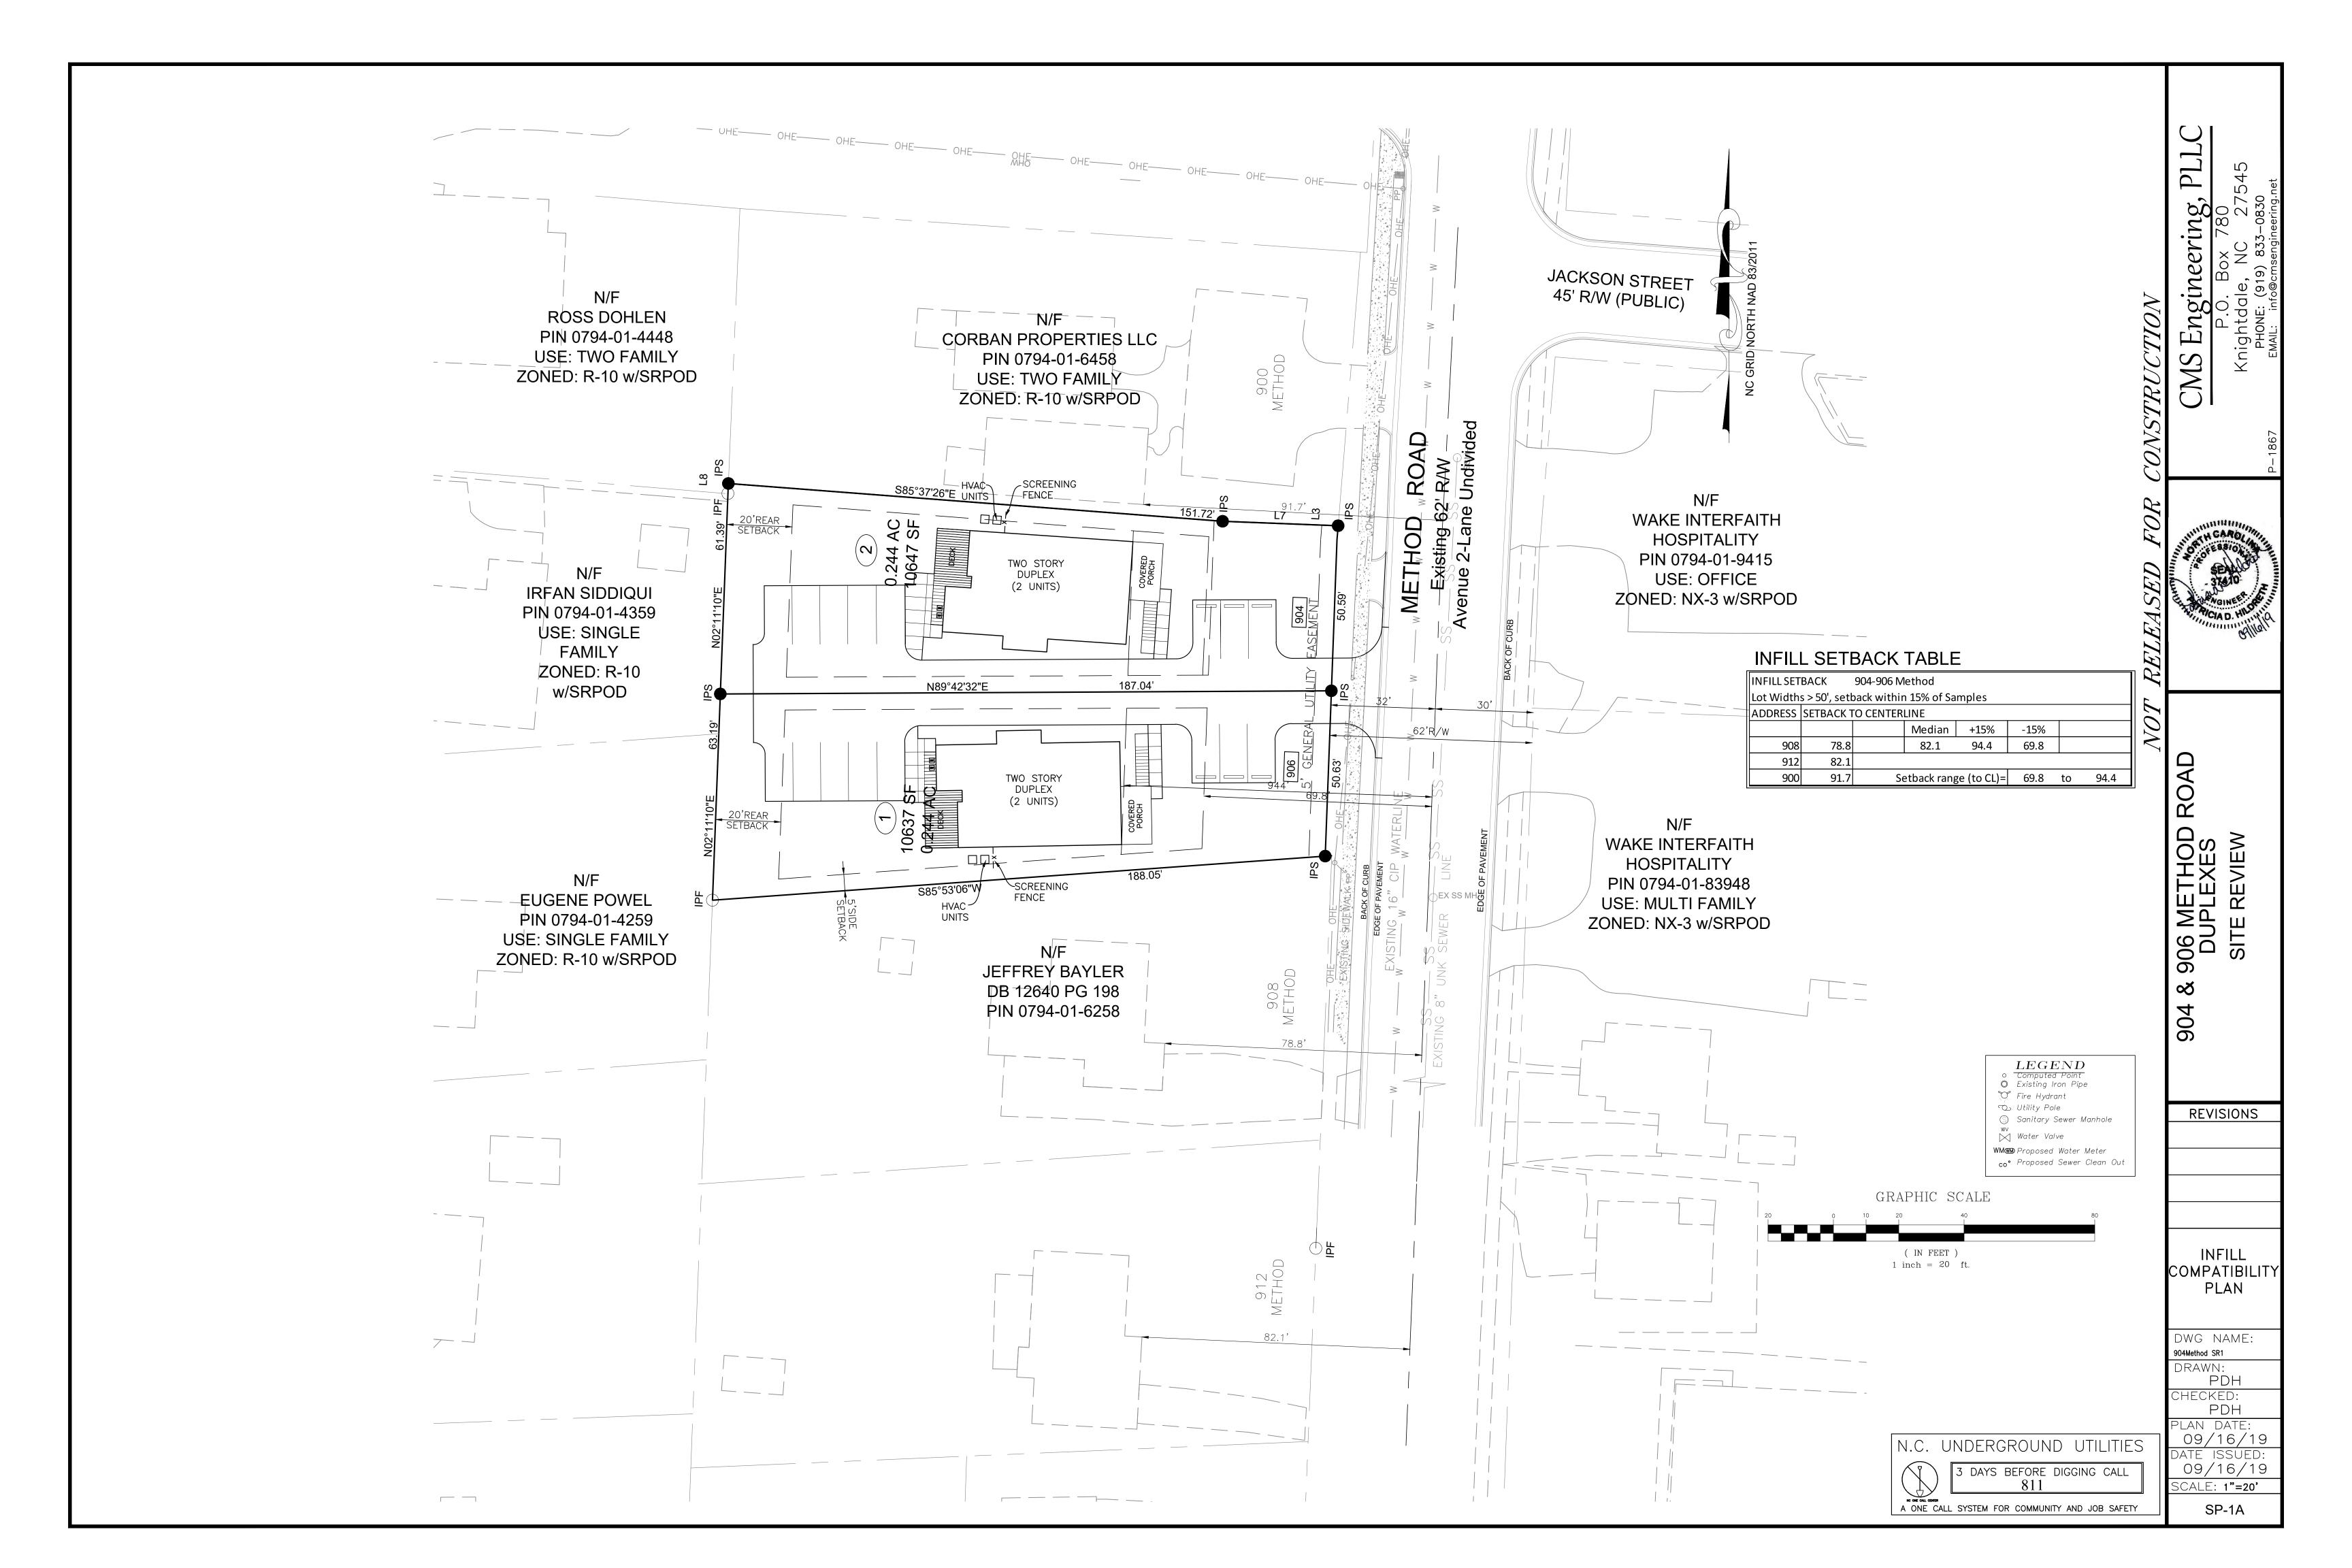





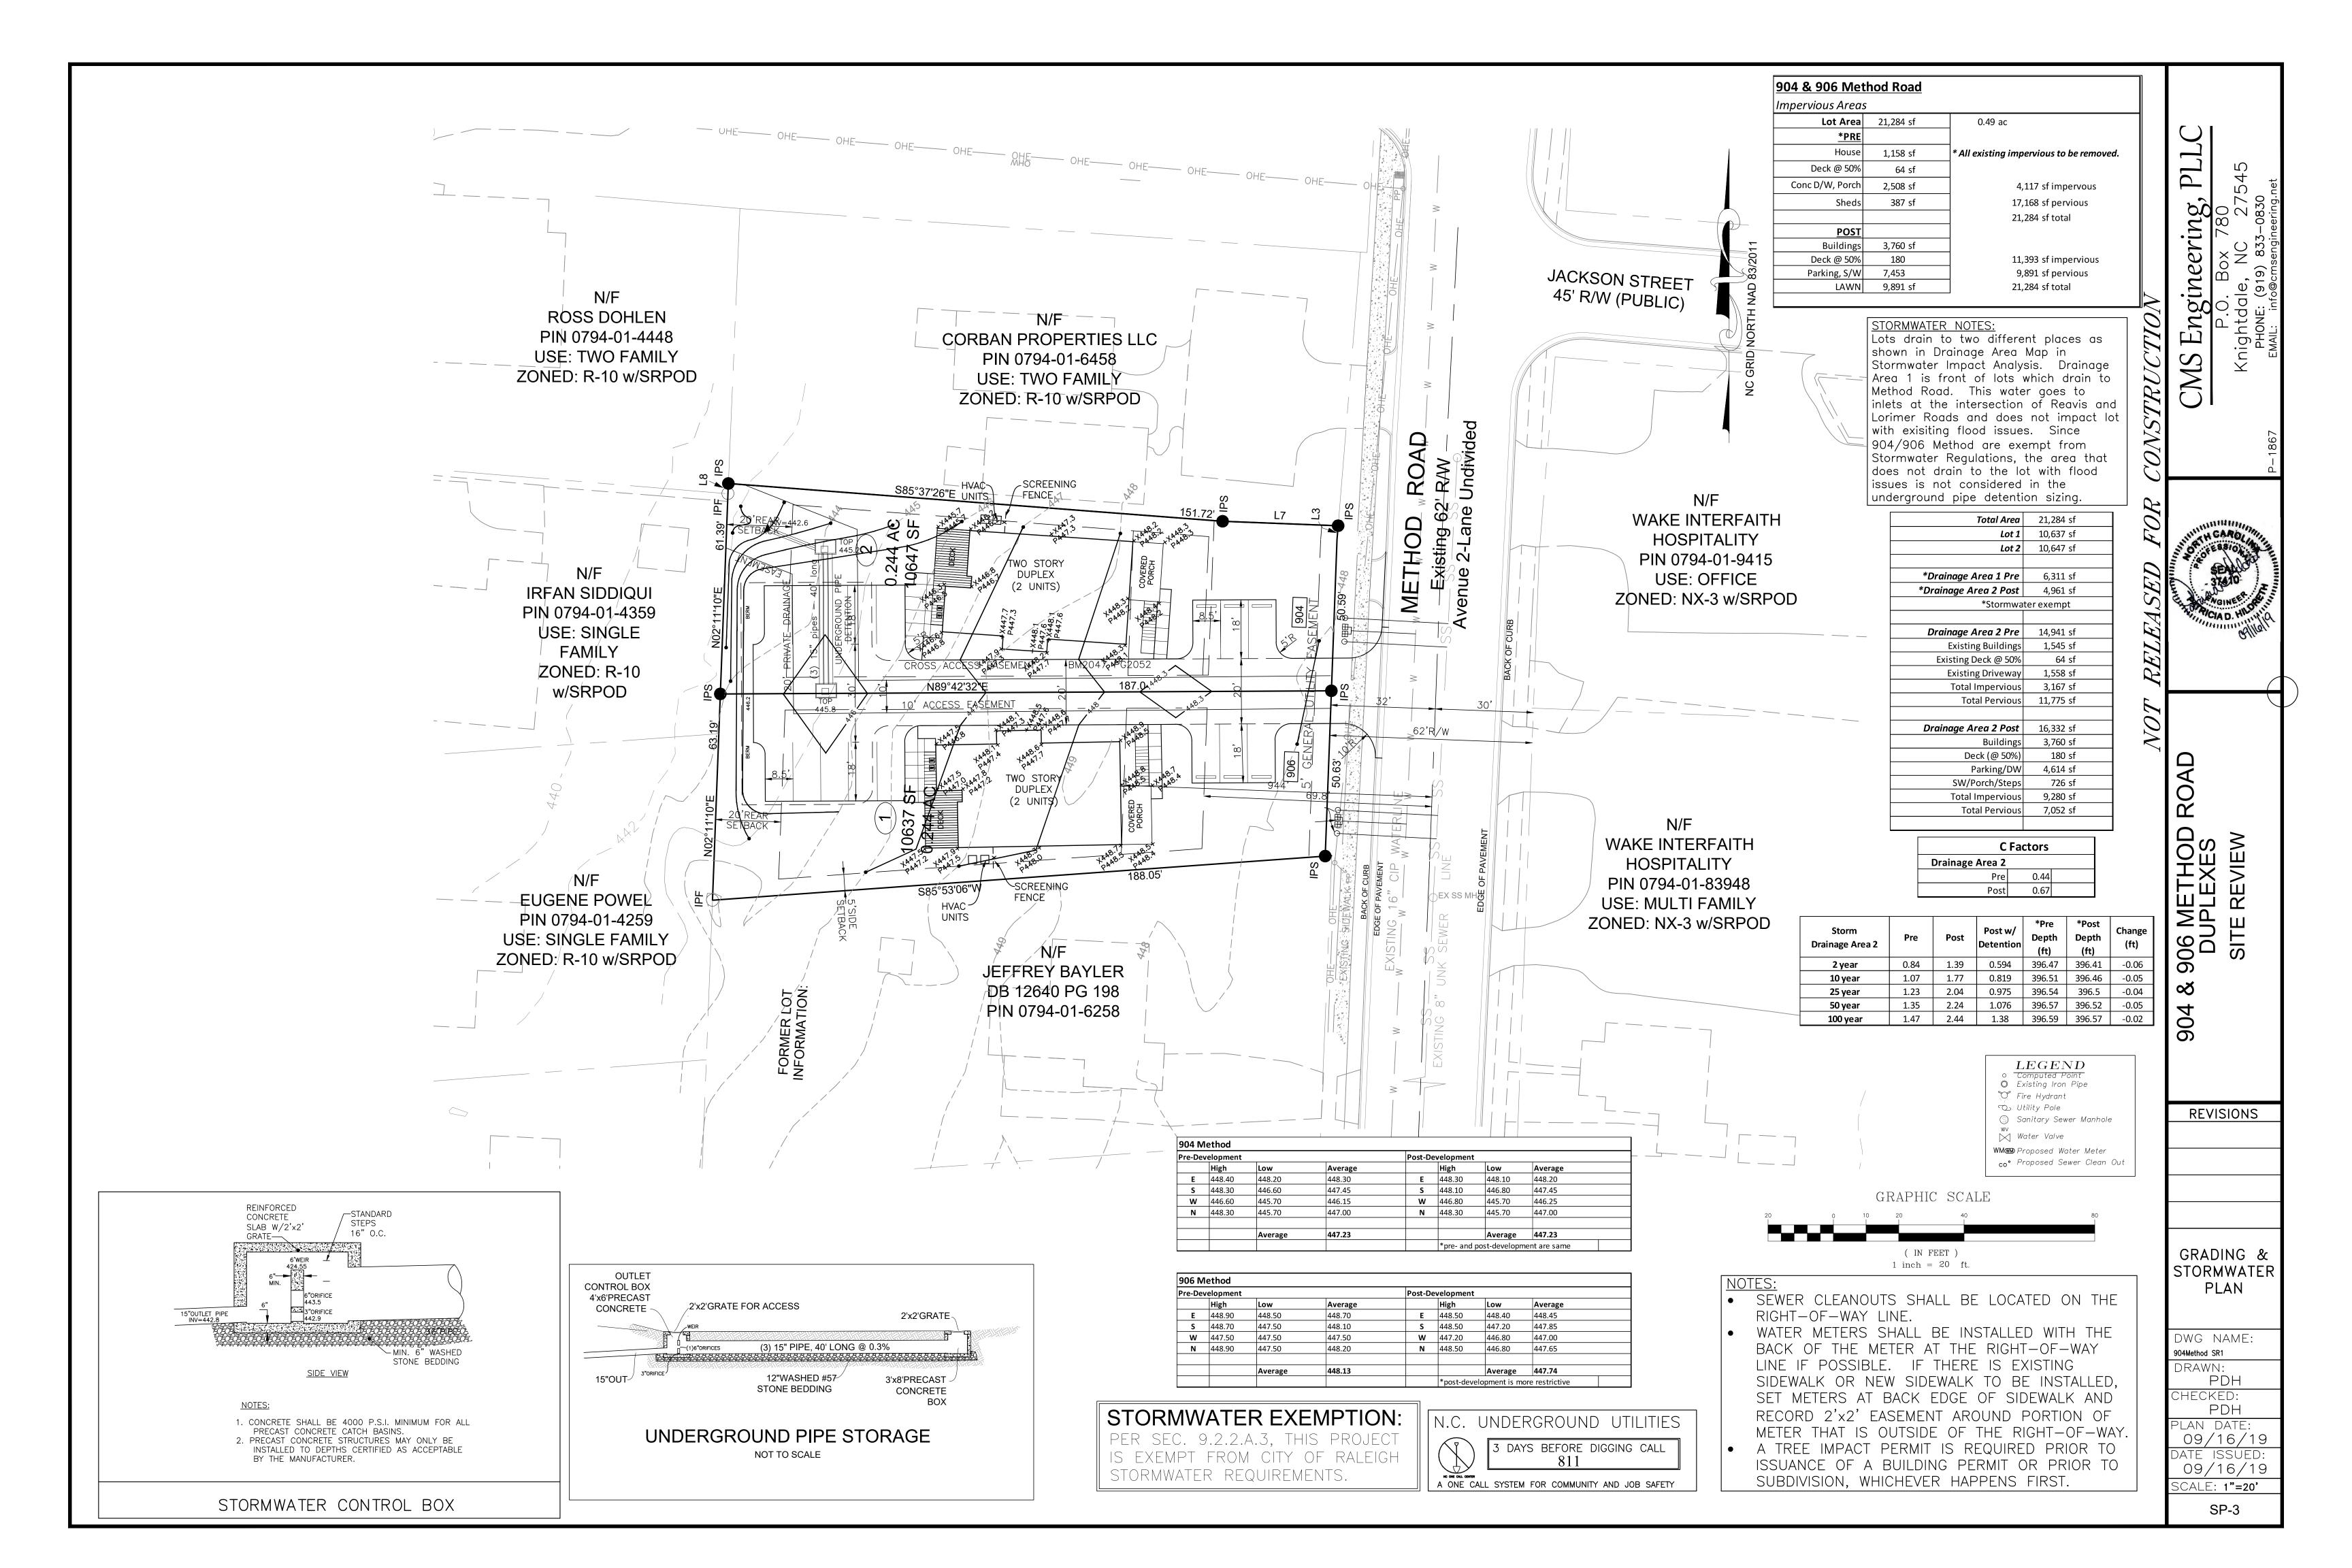


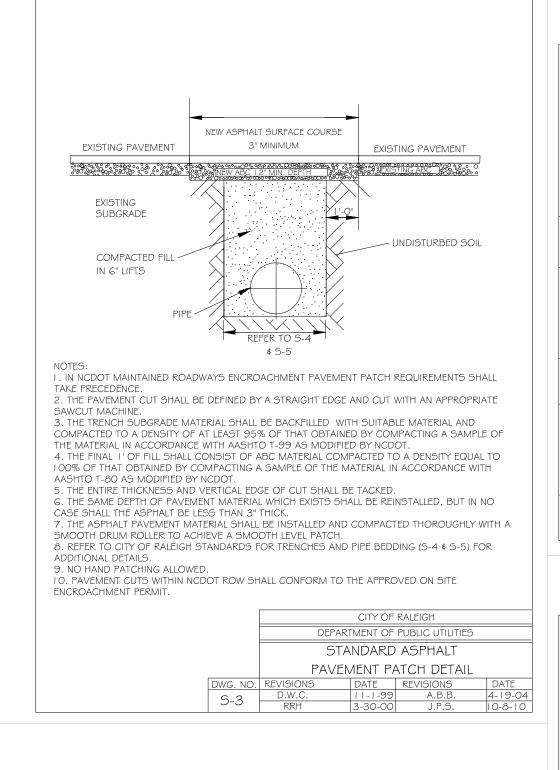


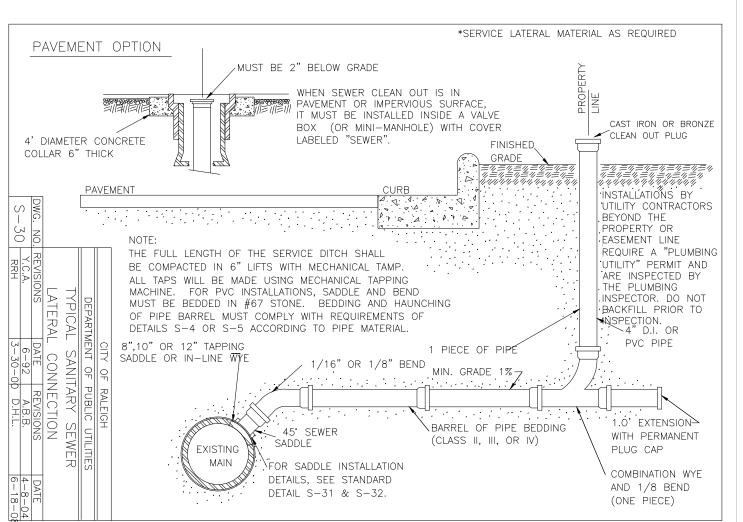


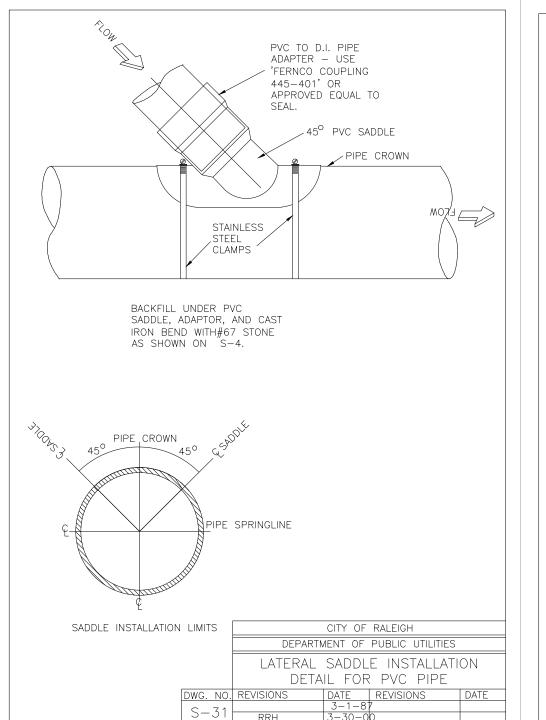


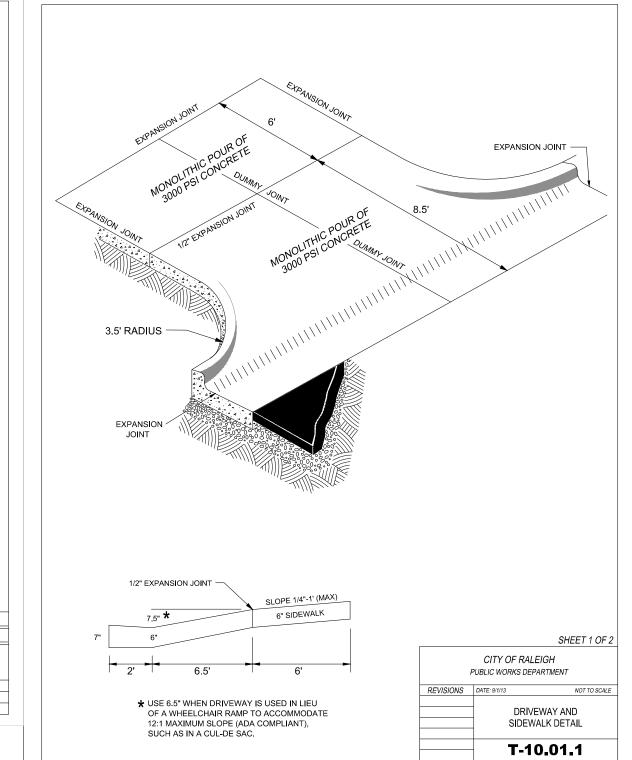

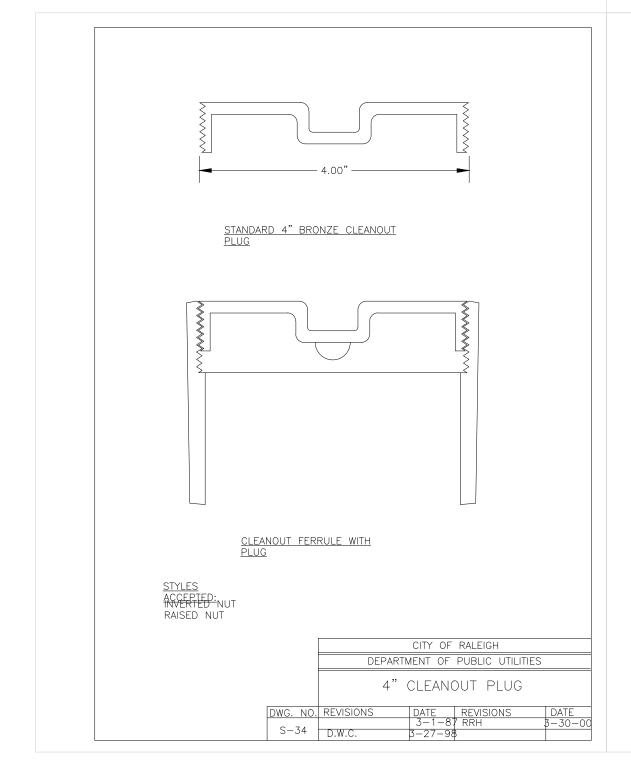

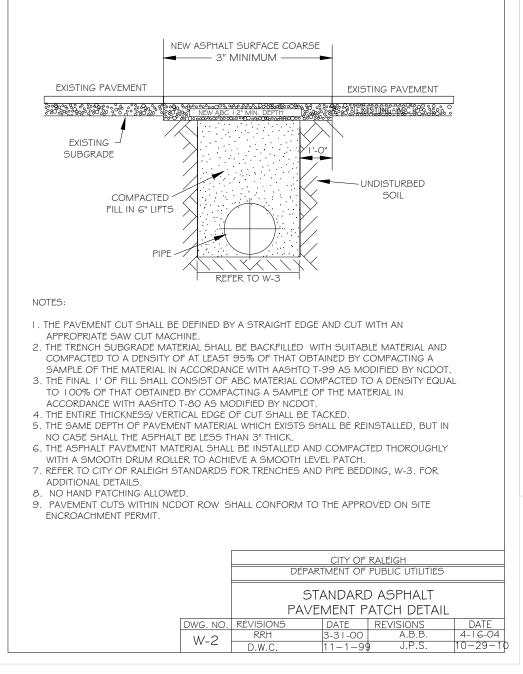

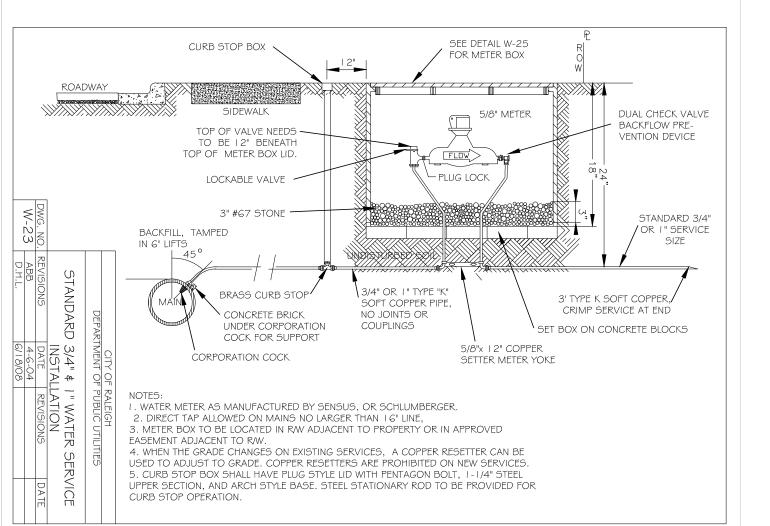

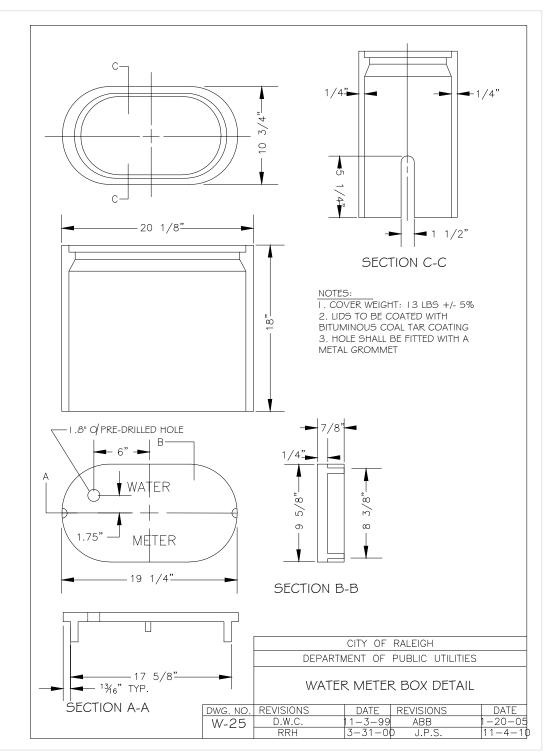

NOT RELEASED FOR CONSTRUCTION

PLL

904 & 906 METHOD ROAD DUPLEXES SITE REVIEW

REVISIONS

DETAILS

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904Method SR1


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5/16/19
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SP-5




Scale:1/4"=1'



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usiness Park. Suite 102 est, NC 27587 09 / Fax: 919.263.1512

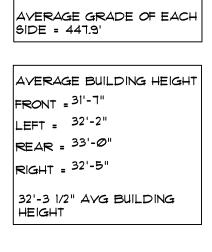847 Wake Forest, NC 27587

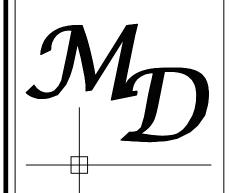Corban Homes

Method Road Duplex

Lot #1

	FRONT & LEFT ELEVATIONS				
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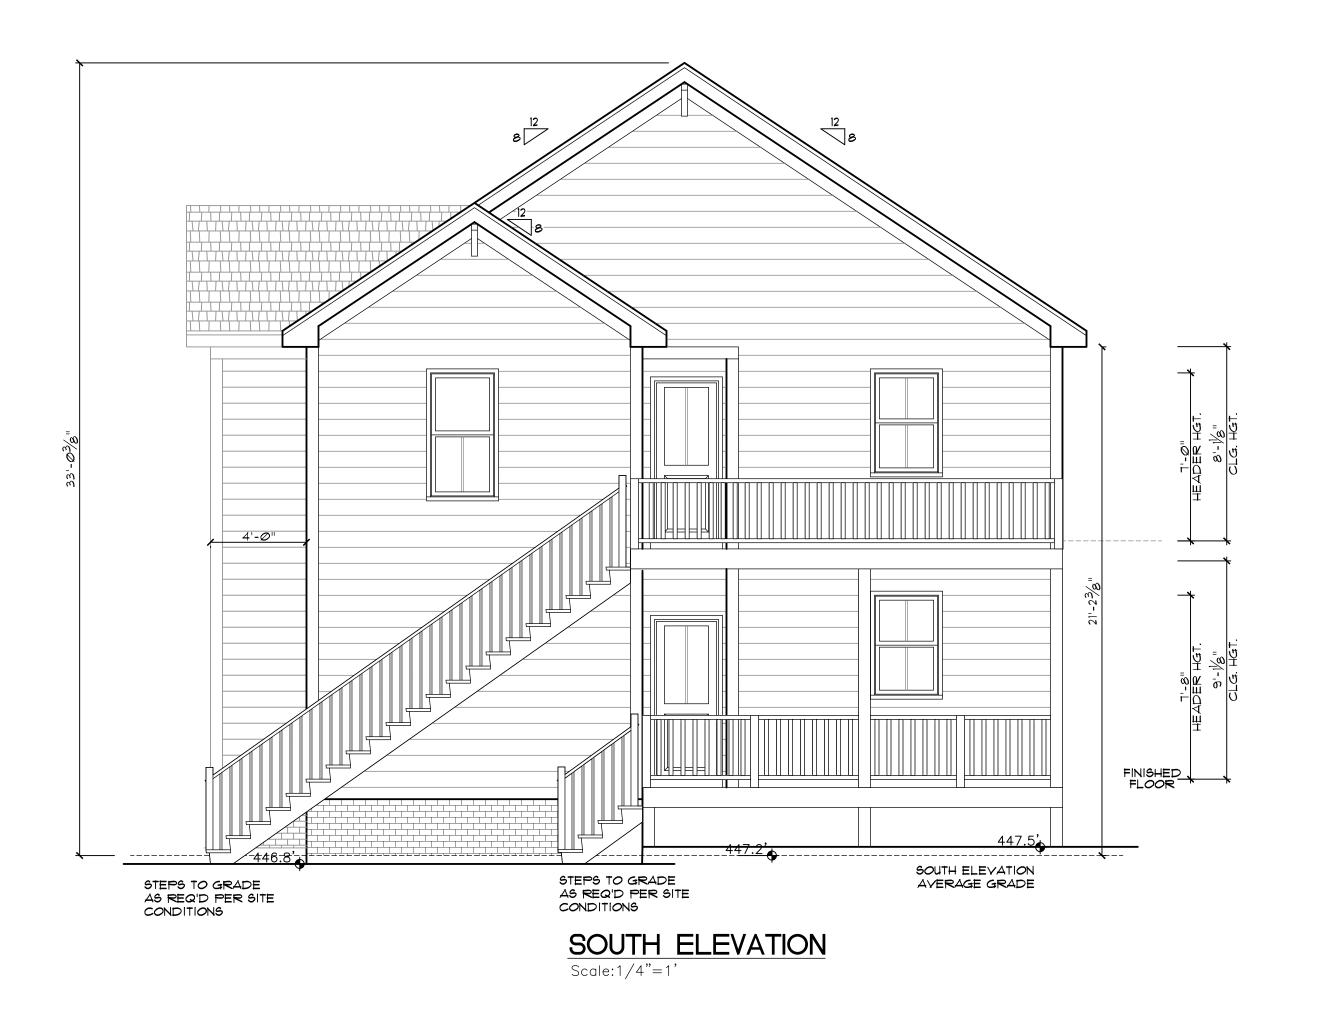
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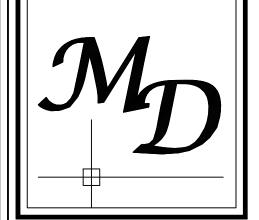
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Drawn By: **MMc.**Date: **08.23.2019**

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47 Wake Forest Business Park. Suite 10 Wake Forest, NC 27587 Office: 919.263.1509 / Fax: 919.263.151

Corban Homes Method Road Duplex Lot #1

REAR & RIGHT ELEVATIONS

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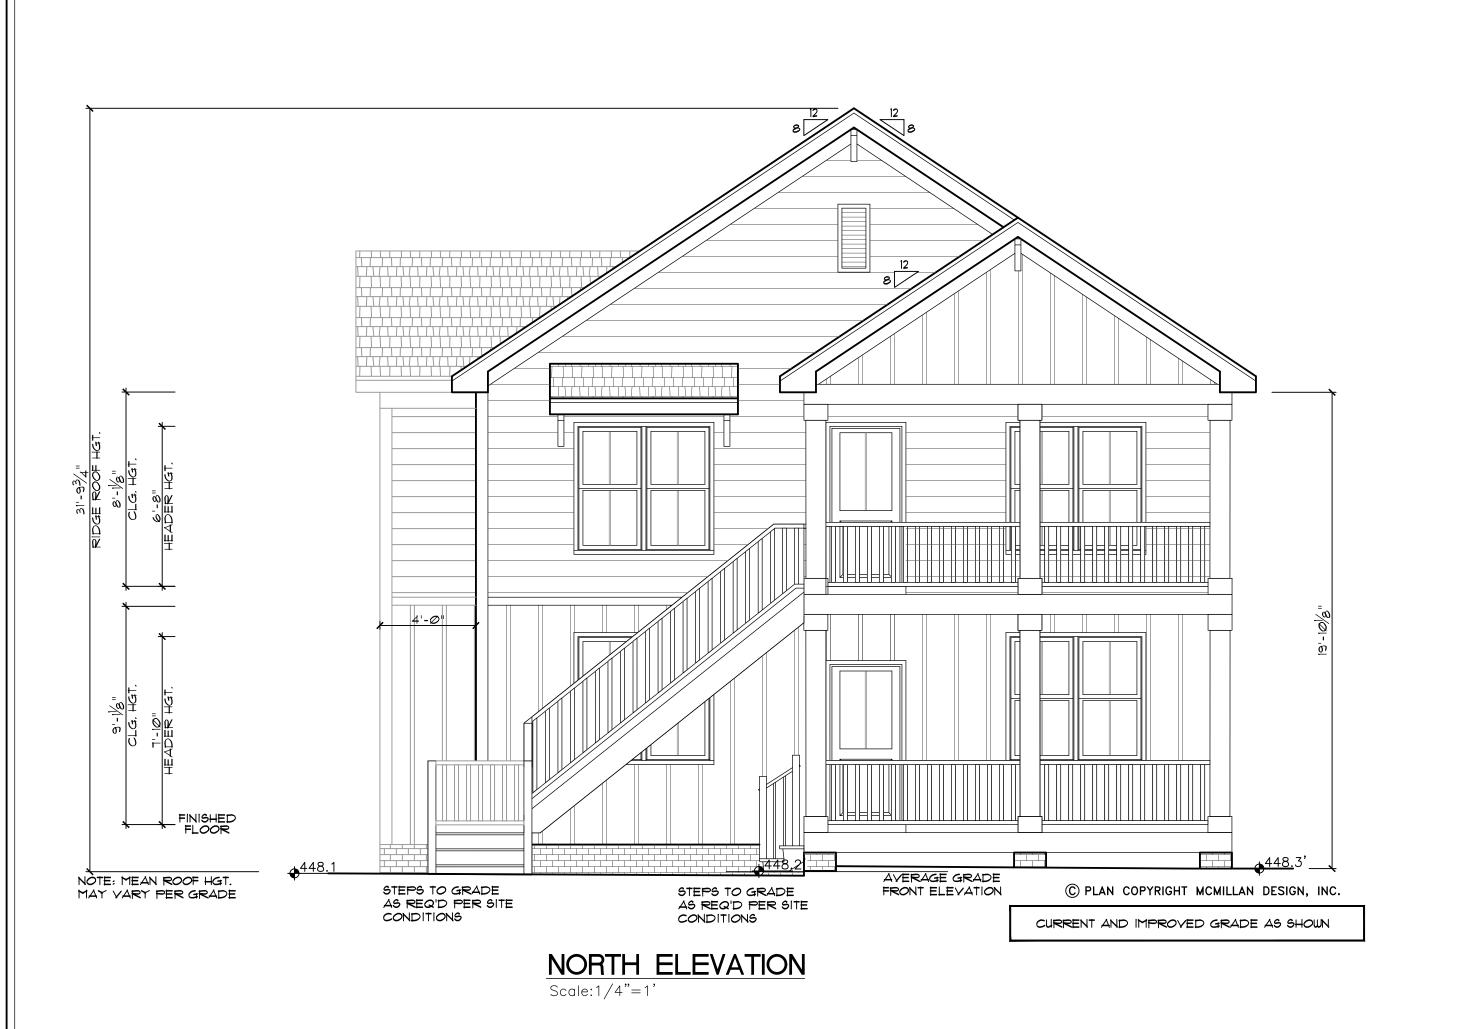
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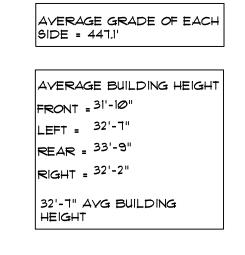
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Drawn By: MMc.

Date: 08.23.2019


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Pre-De،	/elopment			Post-De	velopment			
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Homes I Road Duplex Corban Method Lot #2

Sheet Title:			
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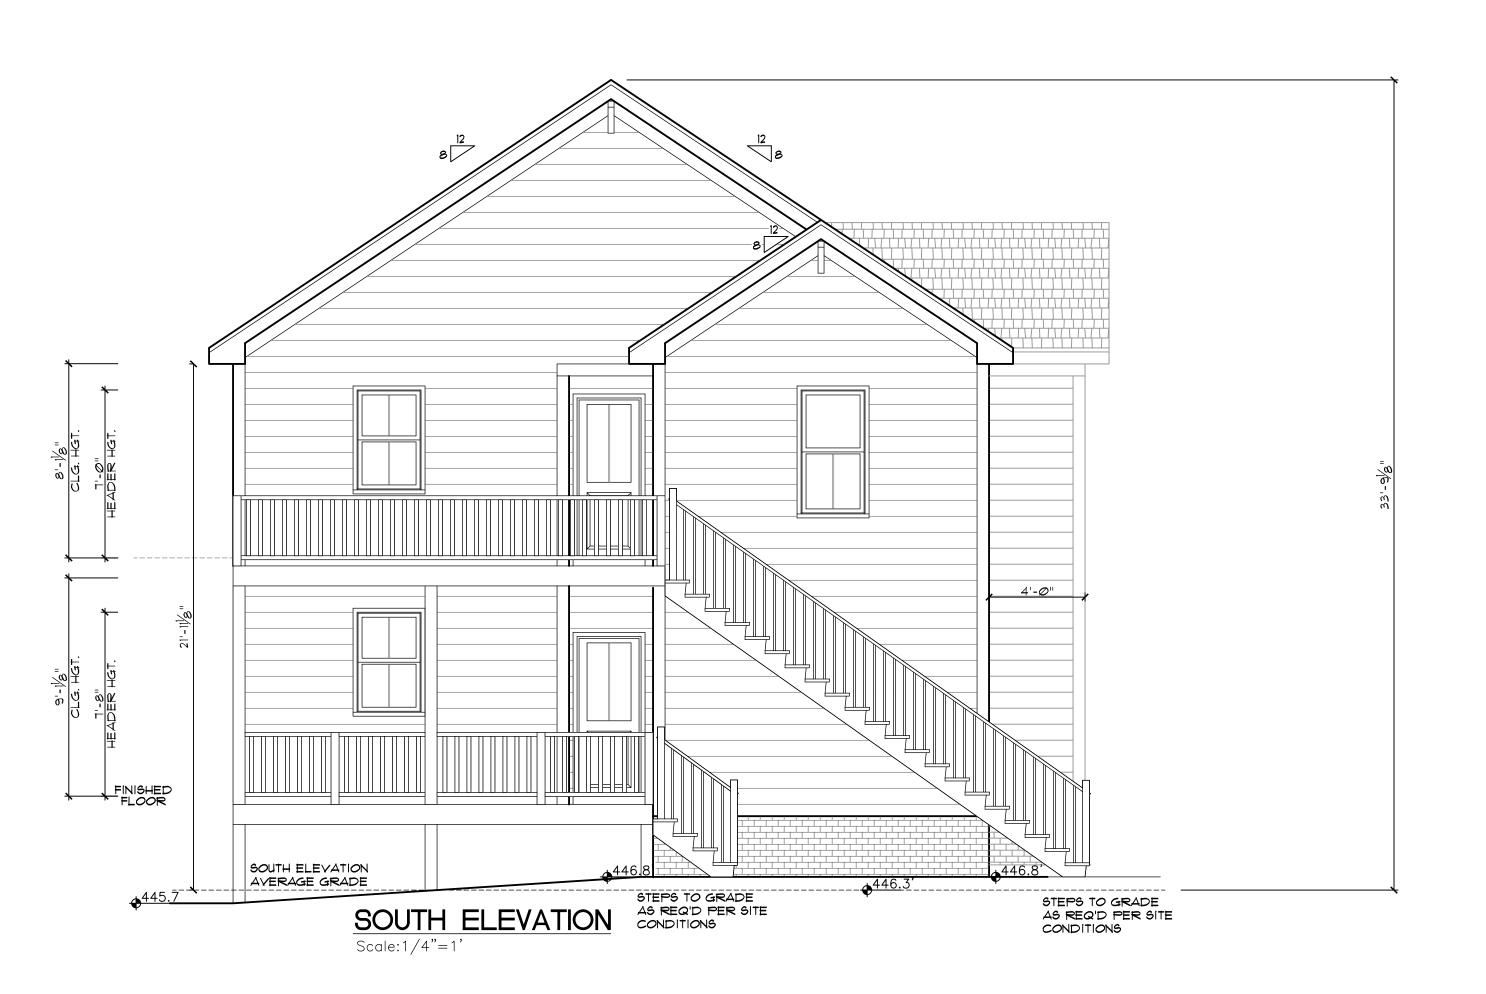
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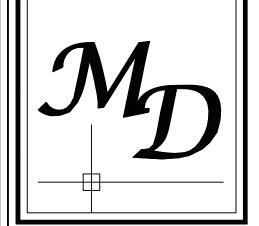
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Corban Homes

Method Road Duplex

I.ot #2

Sheet Title:
REAR & RIGHT
ELEVATIONS
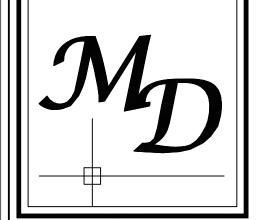
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Sheet No. A2

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