

Administrative Approval Action

Case File / Name: ASR-SR-7-2019
Palisades 3 & 4

City of Raleigh
Development Services Department
One Exchange Plaza
Raleigh, NC 27602
(919) 996-2492
currentplanning@raleighnc.gov
www.raleighnc.gov

LOCATION: This site is located inside the city limits on the southwest corner of the intersection

of Trinity Road and Nowell Road at 5401 Trinity Road.

REQUEST: Development of a 5.62 acre site zoned OX-7-PL CU, and OX-7-PK CU (rezoning

case Z-16-18) into a 172,235 square foot office building and associated parking

including a parking deck of 154,095 square feet size.

An Administrative Alternate has been approved by the Planning Director for this

project, as noted below. (AAD-17-19)

Approval of an amenity area to supplement the Build To requirement along Nowell Road. (1.5.6). Also approval of a non street facing entrance for pedestrian access.

(1.5.8)

A Design Adjustment has been approved by the Board of Adjustment for this

project, as noted below. (A-153-19)

Partial relief from the block perimeter requirement. (8.3.2 A)

DESIGN

ADJUSTMENT(S)/

ALTERNATES, ETC: SPR-0072-2020: DSLC - Site Permitting Review/Major [Signature Set]

FINDINGS: City Administration finds that this request, with the below conditions of

approval being met, conforms to the Unified Development Ordinance. This approval is based on a preliminary plan dated November 15, 2019 by SEPI

Engineering and Construction.

CONDITIONS OF APPROVAL and NEXT STEPS:

This document must be applied to the second sheet of all future submittals except for final plats. This is a preliminary plan and as such no permits have been issued with this approval. To obtain permits and/or completion of the project, the following steps are required:

☑ <u>SITE PERMITTING REVIEW</u> - For land disturbance of 12,000 square feet or greater, public or private infrastructure, shared stormwater devices, etc. Site Permitting Review may be submitted upon receipt of this signed approval document.

The following items are required prior to approval of Site Permitting Review plans:

Engineering

- 1. Required NCDOT encroachment and/or driveway permits must be approved and copies provided to Development Services Development Engineering prior to concurrent review approval.
- 2. A right-of-way obstruction permit must be obtained from Right-of-way Services prior to the commencement of any construction activities within the right-of-way.

Stormwater

- 3. A nitrogen offset payment must be made to a qualifying mitigation bank (UDO 9.2.2.B).
- 4. A surety equal to of the cost of clearing, grubbing and reseeding a site, shall be paid to the City (UDO 9.4.4).

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5. A stormwater control plan with a stormwater operations and maintenance manual and budget shall be approved (UDO 9.2).

Urban Forestry

- 6. Tree protection fence must be inspected by Urban Forestry staff prior to the issuance of a grading permit.
- 7. Submit a final tree conservation plan that includes metes and bounds descriptions of all tree conservation areas and tree protection fencing as required (UDO 9.1.5).

☑ <u>LEGAL DOCUMENTS</u> - Email to legaldocumentreview@raleighnc.gov. Legal documents must be approved, executed, and recorded prior to or in conjunction with the recorded plat on which the associated easements are shown. Copies of recorded documents must be returned to the City within one business day of recording to avoid withholding of further permit issuance.

		_		
V	Cross Access Agreements Required		Ø	Utility Placement Easement Required

☑ **RECORDED MAP(S)** - Submit plat to record new property lines, easements, tree conservation areas, etc.). Plats may be submitted for review when the Site Permitting Review plans, if required, have been deemed ready for mylar signature.

The following items must be approved prior to recording the plat:

Engineering

- 1. An offer of cross access agreement from the subject parcel PIN 0774963627 to the adjacent parcel PIN 0774864380 shall be approved by the Development Services Department for recording in the Wake County Registry, and a copy of the recorded offer of cross access easement shall be returned to the Development Services Department within one day of plat recordation. If a recorded copy of the document is not provided within this time, further recordings and building permit issuance will be withheld.
- 2. A 5' utility placement easement and associated deed of easement shall be approved by the City and the location of the easement shall be shown on the map approved for recordation. The deed of easement shall be recorded at Wake County Register of Deeds within one day of recordation of the recorded plat. A recorded copy of these documents must be provided to the Development Services Department within one day from authorization of lot recordation. If recorded copies of the documents are not provided, further recordings and building permit issuance will be withheld.
- 3. The required right of way for proposed and/or existing streets shall be dedicated to the City of Raleigh and shown on the map approved for recordation.

Stormwater

4. All stormwater control measures and means of transporting stormwater runoff to and from any nitrogen and stormwater runoff control measures shall be shown on all plats for recording as private drainage easements (UDO 9.2).

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Urban Forestry

5. A tree conservation plat shall be recorded with metes and bounds showing the designated tree conservation areas (UDO 9.1).

☑ <u>BUILDING PERMITS</u> - For buildings and structures shown on the approved plans. Commercial building permit plans must include the signed, approved Site Permitting Review plans attached, if applicable. Permit sets may be reviewed prior to the recordation of required plats, but cannot be approved.

The following items must be approved prior to the issuance of building permits:

General

1. Comply with all conditions of Z-16-18.

Engineering

 A public infrastructure surety shall be provided to the City of Raleigh Development Services – Development Engineering (UDO 8.1.3).

Public Utilities

3. A plat must be recorded at the Wake County Register of Deeds office for all utility easement dedications.

Stormwater

- 4. A payment equal to twenty-four percent (24%) of the estimated cost of constructing all stormwater control facilities shown on the development plans shall be paid by the developer to the City stormwater facility replacement fund (UDO 9.2.2.G.3).
- 5. A surety equal to 125% of the cost of the construction of a stormwater device shall be paid to the Engineering Services Department (UDO 9.2.2.D.1.d).

Urban Forestry

6. A tree conservation plat shall be recorded with metes and bounds showing the designated tree conservation areas (UDO 9.1).

The following are required prior to issuance of building occupancy permit:

Stormwater

 As-built drawings and associated forms for all Stormwater devices are accepted by the Engineering Services Department (UDO 9.2.2.D.3).

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Urban Forestry

Final inspection of all tree conservation areas by Urban Forestry Staff.

EXPIRATION DATES: The expiration provisions of UDO Section 10.2.8 E, including the ability to request extensions in the expiration date, apply to this site plan. If significant construction has not taken place on a project after administrative site review approval, that approval may expire and be declared void, requiring re-approval before permits may be issued. To avoid allowing this plan approval to expire the following must take place by the following dates:

3-Year Expiration Date: February 18, 2023

Obtain a valid building permit for the total area of the project, or a phase of the project.

4-Year Completion Date:

Within four years after issuance of the first building permit for the site plan, the construction of the entire site plan must be completed unless an applicant has been granted vested rights. Failure to complete construction within this specified time frame shall automatically void the approved site plan for which no building permits have been issued.

I hereby certify this administrative decision.

02/19/2020 Date:

Staff Coordinator: Michael Walters

PALISADES 3

5401 TRINITY ROAD | RALEIGH, NC

ADMINISTRATIVE SITE REVIEW

ASR-SR-7-19 | TRANSACTION # 584215

6th Submittal: January 30, 2020

PROJECT TEAM

OWNER/DEVELOPER

KEYSTONE - PALISADES III, LLC FORMERLY KNOWN AS: **KEYSTONE - TRINITY ROAD LLC** 5410 Trinity Road, Suite 215 Raleigh, NC 27607

Michael Blount, President Keystone Corporation 919.747.7912 mblount@kscdevelop.com

ARCHITECT

HAGERSMITH DESIGN, P.A. 300 S. Dawson Street Raleigh, NC 27601

Bryan Gibson, AIA 919.821.5547 BGibson@hagersmith.com

RIGHT OF WAY OBSTRUCTION NOTES

WITHIN RALEIGH'S JURISDICTION.

TO THE MUTCD.

LANDSCAPE ARCHITECT SURVEYOR / ENGINEER

1 Glenwood Avenue, Suite 600

SEPI ENGINEERING &

Raleigh, NC 27603

919.789.9977

Civil Engineer:

Marty Hebrank, P.E.

<u> Traffic Engineer:</u>

Henry Fitts, P.L.S.

hfitts@sepiinc.com

Surveyor:

1. LANE AND SIDEWALK CLOSURES OR DETOURS: PRIOR TO ANY LANE OR

WORK. RIGHTOFWAYSERVICES@RALEIGHNC.GOV FOR APPROVAL.

SIDEWALK OBSTRUCTION, THE CONTRACTOR OR ENGINEER SHALL SUBMIT A

TRAFFIC CONTROL AND/OR PEDESTRIAN PLAN ALONG WITH A RIGHT-OF-WAY

SERVICES APPLICATION TO REQUEST THE OBSTRUCTION PRIOR TO THE START OF

THE CITY OF RALEIGH REQUIRES AN APPROVED RIGHT-OF-WAY OBSTRUCTION

PERMIT FOR WORK ON ANY PUBLIC STREET OR SIDEWALK AND NCDOT ROAD

ALL TRAFFIC CONTROL SIGNAGE AND PRACTICES SHALL ADHERE TO THE

MANUAL ON UNIFORM TRAFFIC CONTROL, AND THE LATEST EDITION OF THE

NCDOT "STANDARD SPECIFICATION FOR ROADWAY STRUCTURES", NCDOT

"ROADWAY STANDARD DRAWING MANUAL", AND THE NCDOT SUPPLEMENT

ALL PUBLIC SIDEWALKS MUST BE ACCESSIBLE TO PEDESTRIANS WHO ARE

VISUALLY IMPAIRED AND/OR PEOPLE WITH MOBILITY CONCERNS. EXISTING

and alternative pedestrian routes during construction shall be

REQUIRED TO BE COMPLIANT WITH THE PUBLIC RIGHTS OF WAY ACCESSIBILITY

GUIDELINES (PROWAG), THE ADA STANDARDS FOR ACCESSIBLE DESIGN AND

PRIOR TO THE START OF WORK, THE CLIENT SHALL SCHEDULE A

PRE-CONSTRUCTION MEETING WITH THE ENGINEERING INSPECTIONS

COORDINATOR TO REVIEW THE SPECIFIC COMPONENTS OF THE APPROVED

PROVIDE A MAXIMUM OF 2% OF CROSS SLOPE AND A MAXIMUM OF 5% IN THE

GROUND SURFACES ALONG ACCESSIBLE ROUTES TO BE STABLE, FIRM, AND

SLIP RESISTANT WITH DIRECT CHANGES IN LEVEL OF 1/4" MAXIMUM AND

BEVELED CHANGES IN LEVEL OF 1/2" MAXIMUM WITH A BEVELED SLOPE NO

ACCESSIBLE ROUTES EXCEEDING 5% IN GRADE IN THE DIRECTION OF TRAVEL

ARE NOTED ON THE PLANS AS "RAMPS". PROVIDE HANDRAILS AS SHOWN ON

THIS DEVELOPMENT PROPOSES USE OF A PRIVATE VENDOR FOR SOLID WASTE

THE PLANS AND IN ACCORDANCE WITH FFHA STANDARDS.

SOLID WASTE SERVICES STATEMENT:

DIRECTION OF TRAVEL ON ALL ACCESSIBLE ROUTES, EXCEPT ON RAMPS.

6. ALL PERMITS MUST BE AVAILABLE AND VISIBLE ON SITE DURING THE OPERATION.

THE MANUAL ON UNIFORM TRAFFIC CONTROL DEVICES (MUTCD).

PLAN, AND ENSURE ALL PERMITS ARE ISSUED.

ACCESSIBILITY NOTES:

GREATER THAN 1:2.

SERVICE.

Lisa Lundeen, P.E.

CONSTRUCTION, INC.

Landscape Architect:

Jeff Westmoreland, PLA

mhebrank@sepiinc.com

llundeen@sepiinc.com

jwestmoreland@sepiinc.com

UNLESS EXPLICITLY SPECIFIED ON THIS SITE PLAN, THIS PROJECT SHALL COMPLY WITH THE CITY OF RALEIGH UNIFIED DEVELOPMENT ORDINANCE (UDO) AND ALL OTHER APPLICABLE REGULATIONS AND GUIDELINES. IN THE EVENT OF A DISCREPANCY BETWEEN THIS APPROVED PLAN AND THE APPLICABLE REGULATIONS OR GUIDELINES, THE MORE STRINGENT SHALL APPLY.

GENERAL NOTES:


- CONTRACTOR SHALL HAVE A CURRENT COPY OF CITY OF RALEIGH STANDARD DETAILS AND SPECIFICATIONS ON SITE.
- CONTRACTOR TO OBTAIN COPIES OF ALL PERMITS PRIOR TO CONSTRUCTION, COMPLY WITH ALL REQUIREMENTS LISTED THEREIN, AND COORDINATE AND OBTAIN ALL INSPECTIONS.
- ERECT AND MAINTAIN TREE PROTECTION FENCING AROUND ALL TREE CONSERVATION AREAS.
- ALL ACTIVITIES SHALL COMPLY AT A MINIMUM WITH ALL STATE AND FEDERAL REGULATIONS, AS WELL AS THE APPROPRIATE COUNTY HEALTH DEPARTMENT REGULATIONS, AND CITY AND COUNTY FIRE DEPARTMENT REGULATION FOR HAZARDOUS MATERIALS AND WASTES.
- 6. ALL WORK SHALL BE STAKED BY A LICENSED NC LAND SURVEYOR.
- CONTRACTOR SHALL COORDINATE SITE PLAN AND INFRASTRUCTURE CONSTRUCTION PLANS PRIOR TO CONSTRUCTION. NOTIFY CIVIL ENGINEER OF ANY DISCREPANCIES IN ORDER TO PROVIDE A SOLUTION PRIOR TO BEGINNING CONSTRUCTION.

8. PROTECTION OF EXISTING VEGETATION:

AT THE START OF GRADING INVOLVING THE LOWERING OF EXISTING GRADE around a tree or stripping of topsoil, a clean, sharp, vertical cut Shall be made at the edge of the tree conservation area at the same TIME AS OTHER EROSION CONTROL MEASURES ARE INSTALLED. THE TREE PROTECTION FENCING SHALL BE INSTALLED ON THE SIDE OF THE CUT FARTHEST away from the tree trunk and shall remain in place until all CONSTRUCTION IN THE VICINITY OF THE TREES IS COMPLETE. NO STORAGE OF materials, fill, or equipment and no trespassing shall be allowed WITHIN THE BOUNDARY OF THE PROTECTED AREA.

- BOUNDARY & TOPOGRAPHIC INFORMATION TAKEN FROM A FIELD SURVEY PREPARED BY SEPI ENGINEERING & CONSTRUCTION DATED AUGUST 3, 2018. ADDITIONAL INFORMATION OBTAINED FROM A MAP OF CORRECTION PREPARED BY JOHN A. EDWARDS & COMPANY DATED MARCH 8, 2018 AND RECORDED IN B.M. 2018 PG. 544, WAKE COUNTY REGISTRY, AND WAKE COUNTY GIS.
- 10. TOPOGRAPHICAL INFORMATION GATHERED UNDER THE SUPERVISION OF SEPI ENGINEERING & CONSTRUCTION, INC.
- 11. ALL DRIVEWAY AND ENCROACHMENT AGREEMENTS WILL BE ISSUED BY THE NCDOT DISTRICT OFFICE. THESE MUST BE APPROVED AND COPIES PROVIDED PRIOR TO CONCURRENT APPROVAL.
- 12. ONCE ALL TREE CONSERVATION AREAS HAVE BEEN DETERMINED AND A TREE CONSERVATION PERMIT HAS BEEN OBTAINED, AND PRIOR TO OR CONCURRENT TO ANY SUBDIVIDING OF THE PROPERTY AND PRIOR TO ISSUANCE OF A BUILDING PERMIT, THE LANDOWNERS SHALL RECORD WITH THE LOCAL COUNTY REGISTER OF DEEDS THE FOLLOWING:
 - a. A PLAT WITH METES AND BOUNDS DESCRIPTIONS OF ALL TREE CONSERVATION AREAS:
 - b. AN EASEMENT THAT ALLOWS CURRENT AND FUTURE LOT OWNERS ACCESS TO OTHERWISE INACCESSIBLE TREE CONSERVATION AREAS TO PERFORM TREE MAINTENANCE ACTIVITIES INCLUDING REQUIRED REPLACEMENT PLANTINGS;
 - c. A HOMEOWNERS' ASSOCIATION DECLARATION PREPARED IN CONFORMITY WITH N.C. GEN. STAT., CHAPTER 47F FOR THE MAINTENANCE AND PROTECTION OF THE TREES WITHIN RECORDED TREE CONSERVATION AREAS;
- 13. THE CONTRACTOR SHALL OBTAIN A RIGHT-OF-WAY PERMIT FROM THE TRANSPORTATION OPERATION DIVISION/PUBLIC WORKS DEPARTMENT FOR ANY WORK WHICH REQUIRES THE CLOSURE OF A TRAVEL LANE(S) AND/OR
- 14. FIELD ADJUSTMENTS TO THIS PLAN MAY BE REQUIRED BY CITY OF RALEIGH INSPECTORS AS NEEDED DURING CONSTRUCTION.
- 15. WITHIN THE SIGHT TRIANGLES SHOWN ON THIS PLAN, NO OBSTRUCTION BETWEEN 2 FEET AND 8 FEET IN HEIGHT ABOVE THE CURB LINE ELEVATION SHALL BE LOCATED IN WHOLE OR PART. OBSTRUCTIONS INCLUDE BUT ARE NOT LIMITED TO ANY BERM, FOLIAGE, FENCE, WALL, SIGN OR PARKED VEHICLE.
- 16. UNLESS NOTED OTHERWISE, ACCESS ROUTE FOR EMERGENCY VEHICLES SHALL PROVIDE AN INSIDE TURNING RADIUS OF 28' MINIMUM.
- 17. THE MINIMUM CORNER CLEARANCE FROM THE CURB LINE OF INTERSECTING STREETS SHALL BE AT LEAST 20 FEET FROM THE POINT OF TANGENCY OF THE CURB. NO DRIVEWAYS SHALL ENCROACH ON THIS MINIMUM CORNER
- 18. WHEELCHAIR ACCESS RAMPS WILL BE PROVIDED IN ACCORDANCE WITH CITY OF RALEIGH PUBLIC WORKS DEPARTMENT STANDARDS, PROWAG STANDARDS, ANSI STANDARDS, AND ADAAG SPECIFICATIONS.

VICINITY MAP

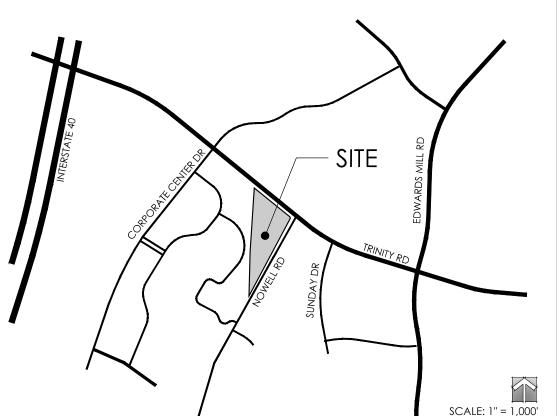

ZONING CONDITIONS (Z-16-18)

- RESIDENTIAL AND HOTEL USES SHALL NOT BE PERMITTED.
- 2. A MAXIMUM OF 250,000 SQUARE FEET OF GROSS FLOOR AREA MAY BE DEVELOPED ON THE PROPERTY.
- THE EXTERIOR OF THE BUILDING(S) ON THE PROPERTY, EXCLUSIVE OF ROOF, DOORS, AND TRIM SHALL BE COMPRISED OF AT LEAST SIXTY PERCENT (60%) GLASS, BRICK, STONE, MASONRY AND/OR HARDIPLANK OR SIMILAR CEMENTITIOUS MATERIAL. NO EIFS OR VINYL SIDING SHALL BE PERMITTED TO BE USED ON THE EXTERIOR OF ANY BUILDING ON THE PROPERTY.
- *SEE ARCHITECTURAL SHEETS FOR BUILDING MATERIALS AND PERCENTAGES.*
- NO MEDIUM OR HIGH PROFILE GROUND SIGNS SHALL BE PERMITTED IN AREA 1 (REZONED TO OX-7-PK-CU) AS DESCRIBED ON EXHIBIT B (AS ATTACHED TO ORIGINAL ORDINANCE).

ADMINISTRATIVE ALTERNATE (AAD-17-19)

Administrative Alternates for following UDO Sections were approved 10/08/19:

- UDO Section 1.5.6 Build-to: Outdoor amenity area provided to meet build-to requirement on Nowell Road.
- in lieu of an access point along building facade facing Nowell Road.

BOARD OF ADJUSTMENT (A-153-19)

Design Adjustment approved 11/13/19 for UDO Section 8.3.2.A Block Perimeter. This case was granted a 4,266' design adjustment from the 2,500' maximum block perimeter requirement that results in a block perimeter of 6,766' in order to construct a general building (office/business) and a parking deck.

C-0.0 COVER SHEET EXISTING CONDITIONS & DEMOLITION PLAN

TREE CONSERVATION PLAN C-2.0 SITE PLAN

AREA CALCULATIONS

EROSION CONTROL PLAN (NOT INCLUDED IN THIS SET)

DRAINAGE TABLES

STORMWATER PLAN - UNDERGROUND DETENTION

UTILITY PLAN SITE DETAILS

STORM DRAINAGE DETAILS

EXTERIOR ELEVATION - OFFICE BUILDING

EXTERIOR ELEVATION - OFFICE BUILDING

EXTERIOR ELEVATION - OFFICE BUILDING

SITE DATA SITE ADDRESS PARCEL ID 0774-96-3627 **EXISTING USE** VACANT EXISTING ZONING OX-7-PL-CU / OX-7-PK-CU (Z-16-18)

RIVER BASIN FLOODPLAIN WATERSHED OVERLAY DISTRICT N/A SOIL TYPE

GROSS ACREAGE 5.62 AC PROPOSED RIGHT-OF-WAY DEDICATION 0.29 AC NET ACREAGE 5.33 AC

B1: Office/Business PD: Open Parking Deck 154,095 SF (GFA)

UDO Section 1.5.8 Pedestrian Access: A non-street facing entrance

SHEET INDEX

C-2.1

GRADING & DRAINAGE PLAN

SITE DETAILS

EROSION CONTROL DETAILS (NOT INCLUDED IN THIS SET)

WATER DETAILS (NOT INCLUDED IN THIS SET)

SEWER DETAILS (NOT INCLUDED IN THIS SET)

LANDSCAPE PLAN

L-2.0 LANDSCAPE DETAILS

LP-1.0 SITE LIGHTING PLAN EXTERIOR ELEVATION - OFFICE BUILDING

EXTERIOR ELEVATION - OFFICE BUILDING

EXTERIOR ELEVATION - PARKING DECK A-202 EXTERIOR ELEVATION - PARKING DECK

5401 TRINITY ROAD

PROPOSED USES 172,235 SF (GFA)

BUILDING HEIGHT

B1: Office/Business 77'-4" FT PD: Open Parking Deck 54'-4" FT

OUTDOOR AMENITY AREA Required Provided Outdoor Amenity Area (min. 10%) 0.53 AC 0.00 AC 0.09 AC Additional Amenity Area to Meet Build-to

0.53 AC Total Amenity Area 0.62 AC BUILD-TO (UDO 3.4.5.C) Primary Street Build-to (0' min./100' max.) 20 FT Right-of-Way Length (Nowell Rd) 926 LF

Existing Tree Conservation Area 200 LF Site Access Driveways 30 LF Build-to Frontage Length 696 176 LF Build-to Width - Building 1 263 LF Build-to Width - Amenity Area

Build-to Required

Build-to Provided (Bldg + Amenity)

LONG-TERM BIKE PARKING

PARKING REQUIREMENTS (UDO 7.1.2)

50%

63%

Calculation Required Provided

1/5,000 SF 34 20**

		•	
VEHICULAR PARKING - GENERAL OFFICE	1/400 SF	431	542
Standard Spaces - Parking Deck			475
Standard Spaces - Surface Parking			67
Accessible Spaces	2% of Req'd	10.8	11.0
SHORT-TERM BIKE PARKING	1/10,000 SF	17	10**

Long-Term Bike Parking located within Parking Deck. See Arch. Drawings. **UDO 7.1.8.A Provides exemption that limits bike parking to maximum of 30 spaces on a single lot.

DEVELOPMENT SERVICES

Phone #: 919-747-7912

Phone #: 919-747-5858

Company: SEPI

Applicant Name: Jeff Westmorelan

Administrative Site Review Application

This form is required when submitting site plans as referenced in Unified Development Ordinance (UDO) Section 10.2.8. Please check the appropriate building types and include the plan checklist document when submitting

Office Use Only: Transaction # Planning Coordinator: Sketch transaction #: 549033 Apartment Open lot Board of Adjustment #: Zoning Case #: Z-16-18 Administrative Alternate #: GENERAL INFORMATION Development name: Palisades 3 Inside City limits? X Yes No Property address(es): 5401 Trinity Road Please describe the scope of work. Include any additions, expansions, and change of use. Development of one office building and associated parking deck. Current Property Owner/Developer Contact Name: Michael Blount Company: Keystone - Trinity Road LLC Title: President Address: 5410 Trinity Road, Suite 215, Raleigh, NC 27607

Address: 1 Glenwood Avenue, Suite 600, Raleigh, NC 27603

Page **1** of **2** REVISION 05.01.19 raleighnc.gov DEVELOPMENT TYPE + SITE DATE TABLE

Email: mblount@kscdevelop.com

Email: jwestmoreland@sepiinc.com

Existing gross floor area (not to be demolished) Zoning district (if more than one, please provide the OX-7-PK-CU / 0.76 AC Existing gross floor area to be demolished OX-7-PL-CU / 4.86 AC Gross site acreage: 5.62 AC New gross floor area: 172,235 Total sf gross (to remain and new): 172,235 # of parking spaces required: # of parking spaces proposed: Proposed # of buildings: 1

Proposed # of stories for each: Overlay District (if applicable): xisting use (UDO 6.1.4): VACANT roposed use (UDO 6.1.4): OFFICE STORMWATER INFORMATION Proposed Impervious Surface: s this a flood hazard area? Yes No If yes, please provide:

Alluvial soils: ___ Flood stu FEMA Map Panel #: Neuse River Buffer Yes No Wetlands Yes RESIDENTIAL DEVELOPMENTS Total # of dwelling units: Total # of hotel units: # of bedroom units: 1b 4br or more:

Is your project a cottage court? Yes No

SIGNATURE BLOCK in filing this plan as the property owner(s), I/we do hereby agree and firmly bind ourselves, my/our heirs, executors, administrators, successors, and assigns jointly and severally to construct all improvements and make all dedications as shown on this proposed development plan as approved by the City of Raleigh this application, to receive and response to administrative comments, to resubmit plans on my behalf, and to represent me in any public meeting regarding this application.

l/we have read, acknowledge, and affirm that this project is conforming to all application requirements applicable with the proposed development use. I acknowledge that this application is subject to the filing calendar and submittal policy, which states applications will expire after 180 days of inactivity. Signature: //which Dlew

Page **2** of **2 REVISION 05.01.19**

ALL CONSTRUCTION SHALL BE IN ACCORDANCE WITH ALL CITY OF RALEIGH AND NCDOT STANDARDS AND SPECIFICATIONS

PRELIMINARY - DO NOT USE FOR CONSTRUCTION

Know what's below. Call before you dig.

BEFORE YOU DIG

KACT LOCATION OF ALL EXISTING UTILITIES BEFORE COMMENCING WORK, A AGREES TO BE FULLY RESPONSIBLE FOR ANY AND ALL DAMAGES WHICH MIGH BE OCCASIONED BY THE CONTRACTOR'S FAILURE TO EXACTLY LOCATE AND

1 GLENWOOD AVE, SUITE 600 | RALEIGH, NC 27603 PHONE I 919.789.9977 1020 DAVID TAYLOR DR., SUITE 115 | CHARLOTTE, NC 28262 PHONE | 704.714.4880

5030 NEW CENTRE DR., SUITE B | WILMINGTON, NC 28403

3644 PUNGO CREEK RD. | PINETOWN, NC 278653 PHONE | 252.964.6900 sepiinc.com

HE CONTRACTOR NEITHER THE OWNER NOR THE ENGINEER HALL BE EXPECTED TO ASSUME ANY RESPONSIBILITY FOR SAFETY OF THE WORK, OF PERSONS ENGAGED IN THE WORK, OF ANY NEARBY STRUCTURES, OR OF ANY OTHER PERSONS.

Raleigh

CONSTRUCTION SITE SAFETY IS THE SOLE RESPONSIBILITY OF

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PALISADES 3

5401 Trinity Road

Raleigh, NC

PREPARED FOR: Keystone - Trinity Road LLC 5410 Trinity Road, Suite 215


Raleigh, NC 27607


PROJECT: SE18.060 ISSUE: | ASR 1st Submittal 01.23.2019 To Client for Preliminary Pricing 06.19.2019 Mass Grading 1st Submittal 08.20.2019 Mass Grading 2nd Submittal 09.18.2019 ASR 6th Submittal 01.30.2020


ASR 1st Comment Responses 06.26.2019 ASR 2nd Comment Responses 09.11.2019 Mass Grading 1st Comment 09.18.2019 Responses ASR 3rd Comment Responses 1.15.2019 Mass Grading Revisions 2.16.2019 ASR 4th Comment Responses 12.27.2019

ASR 5th Comment Responses 01.30.2020 PROJ. MGR: | J. WESTMORELAND DRAWN BY: M. ARMFIELD

CHECKED BY: M. HEBRANK COVER

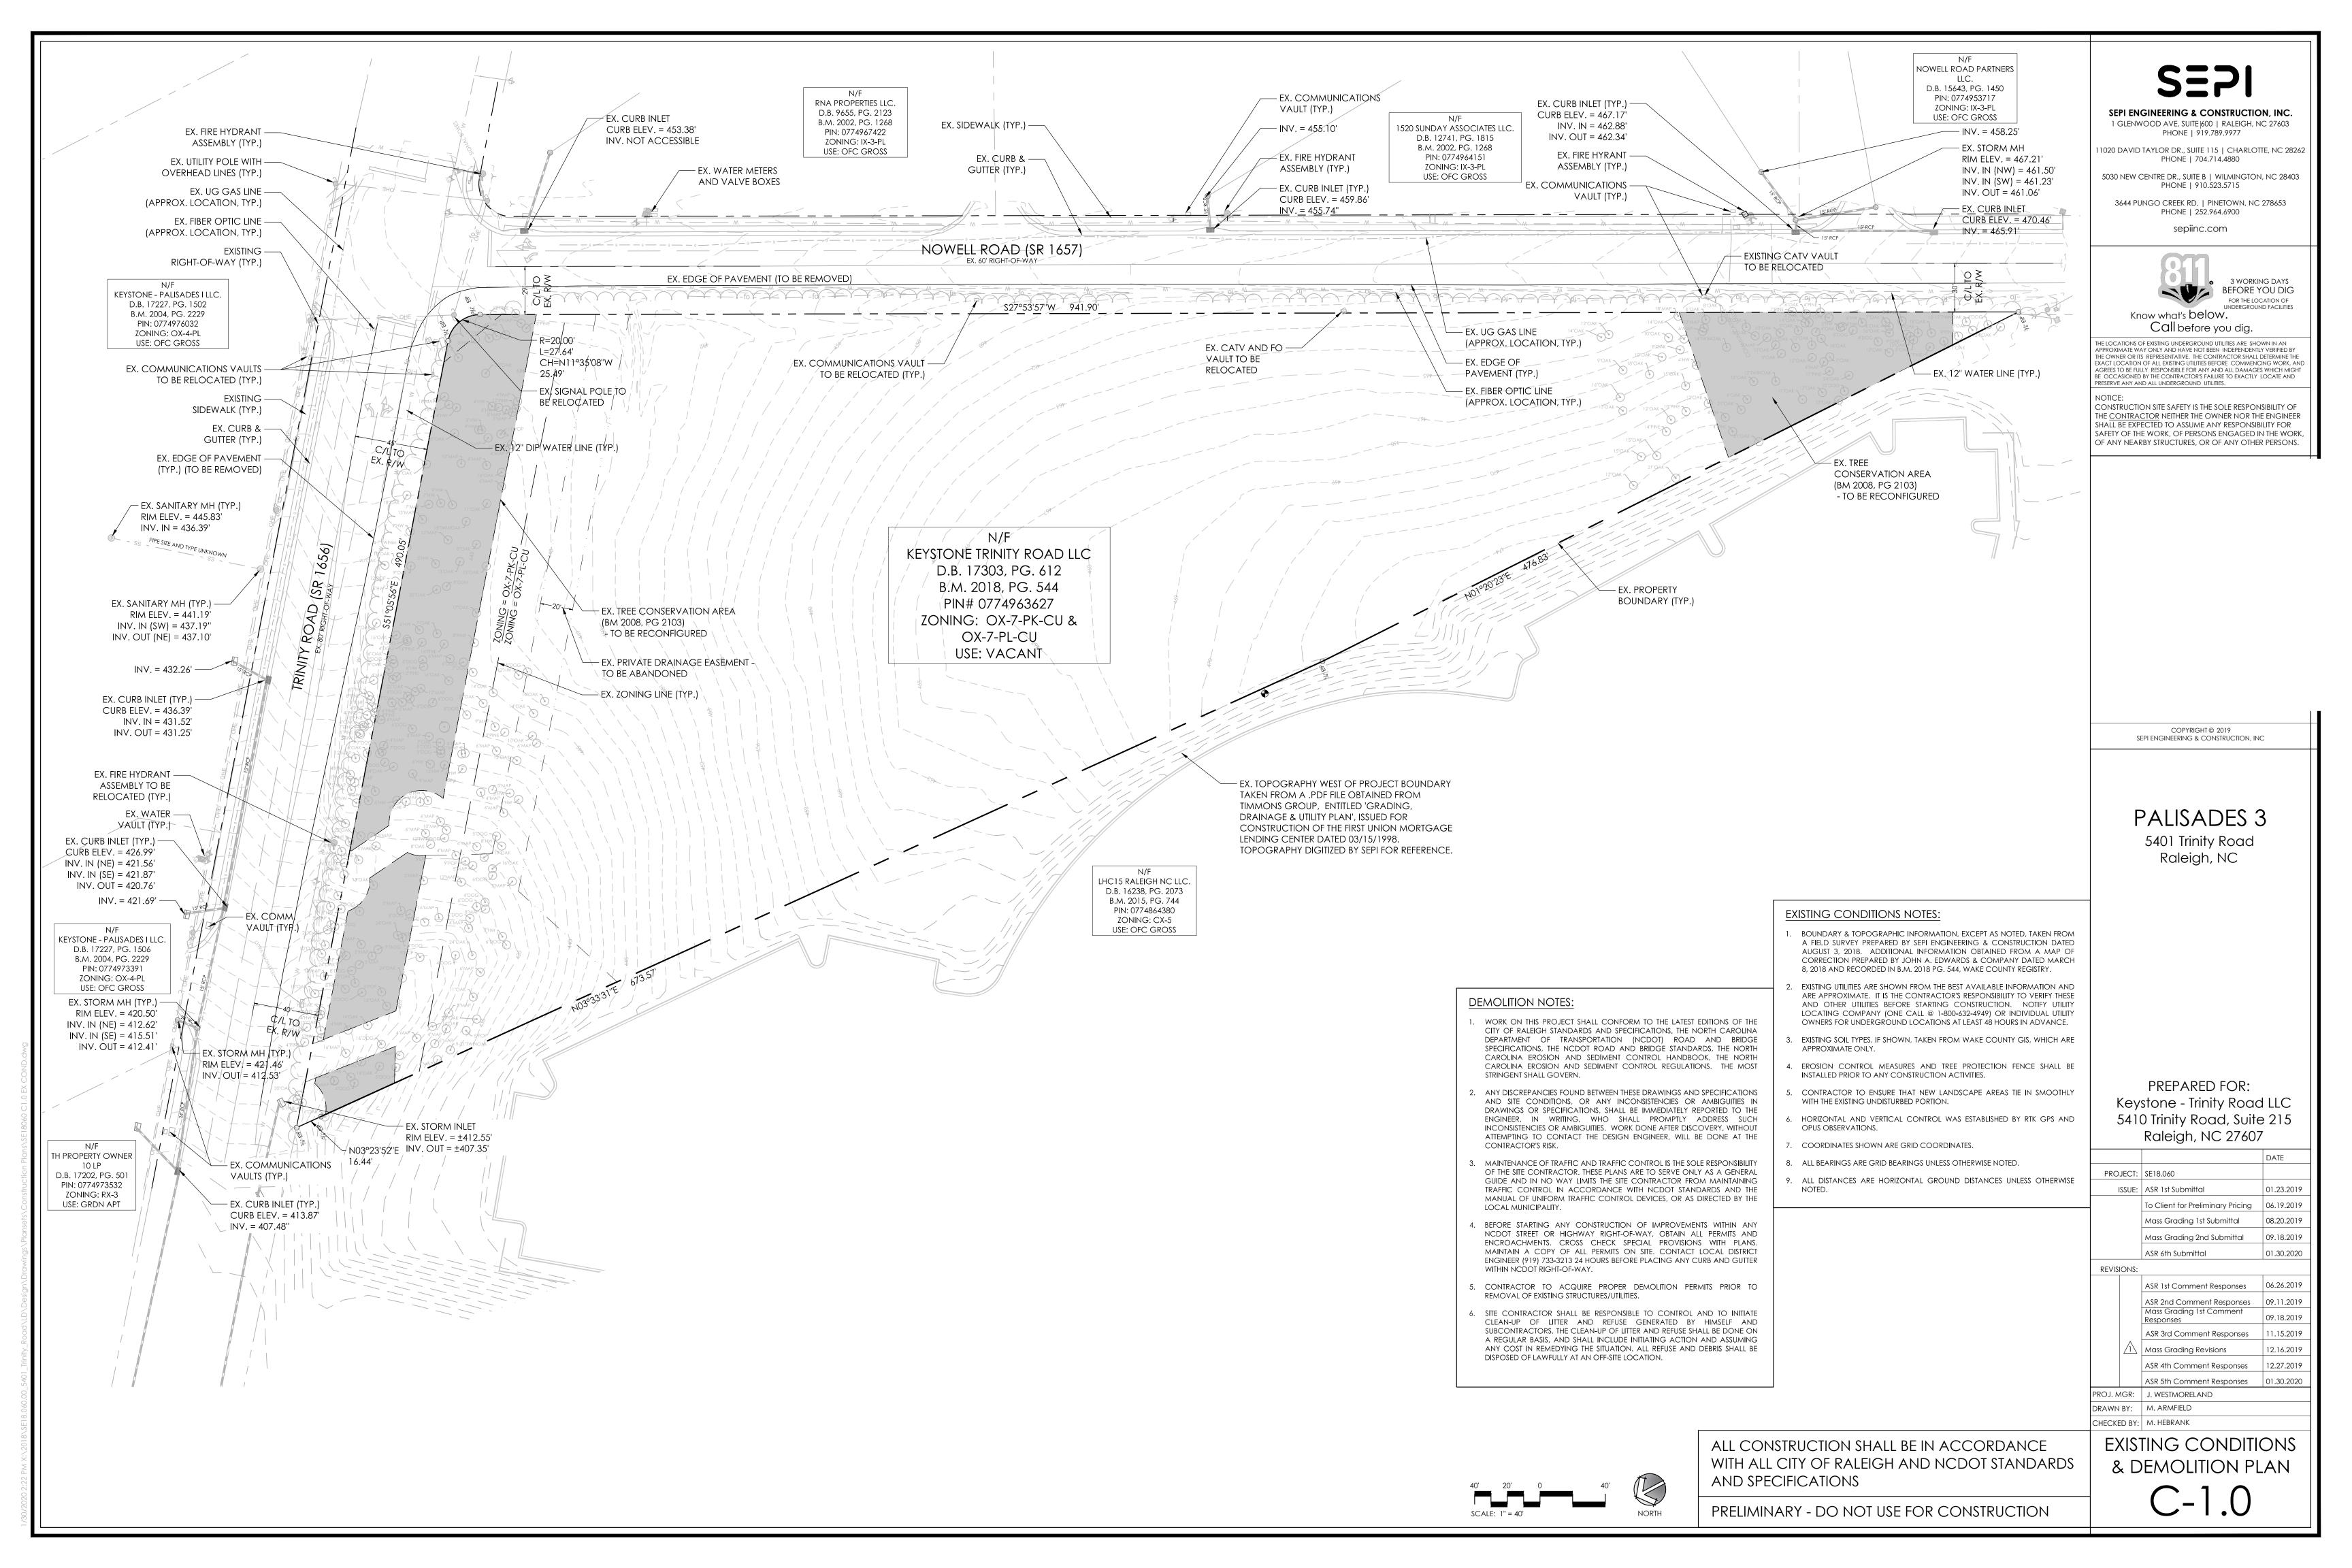

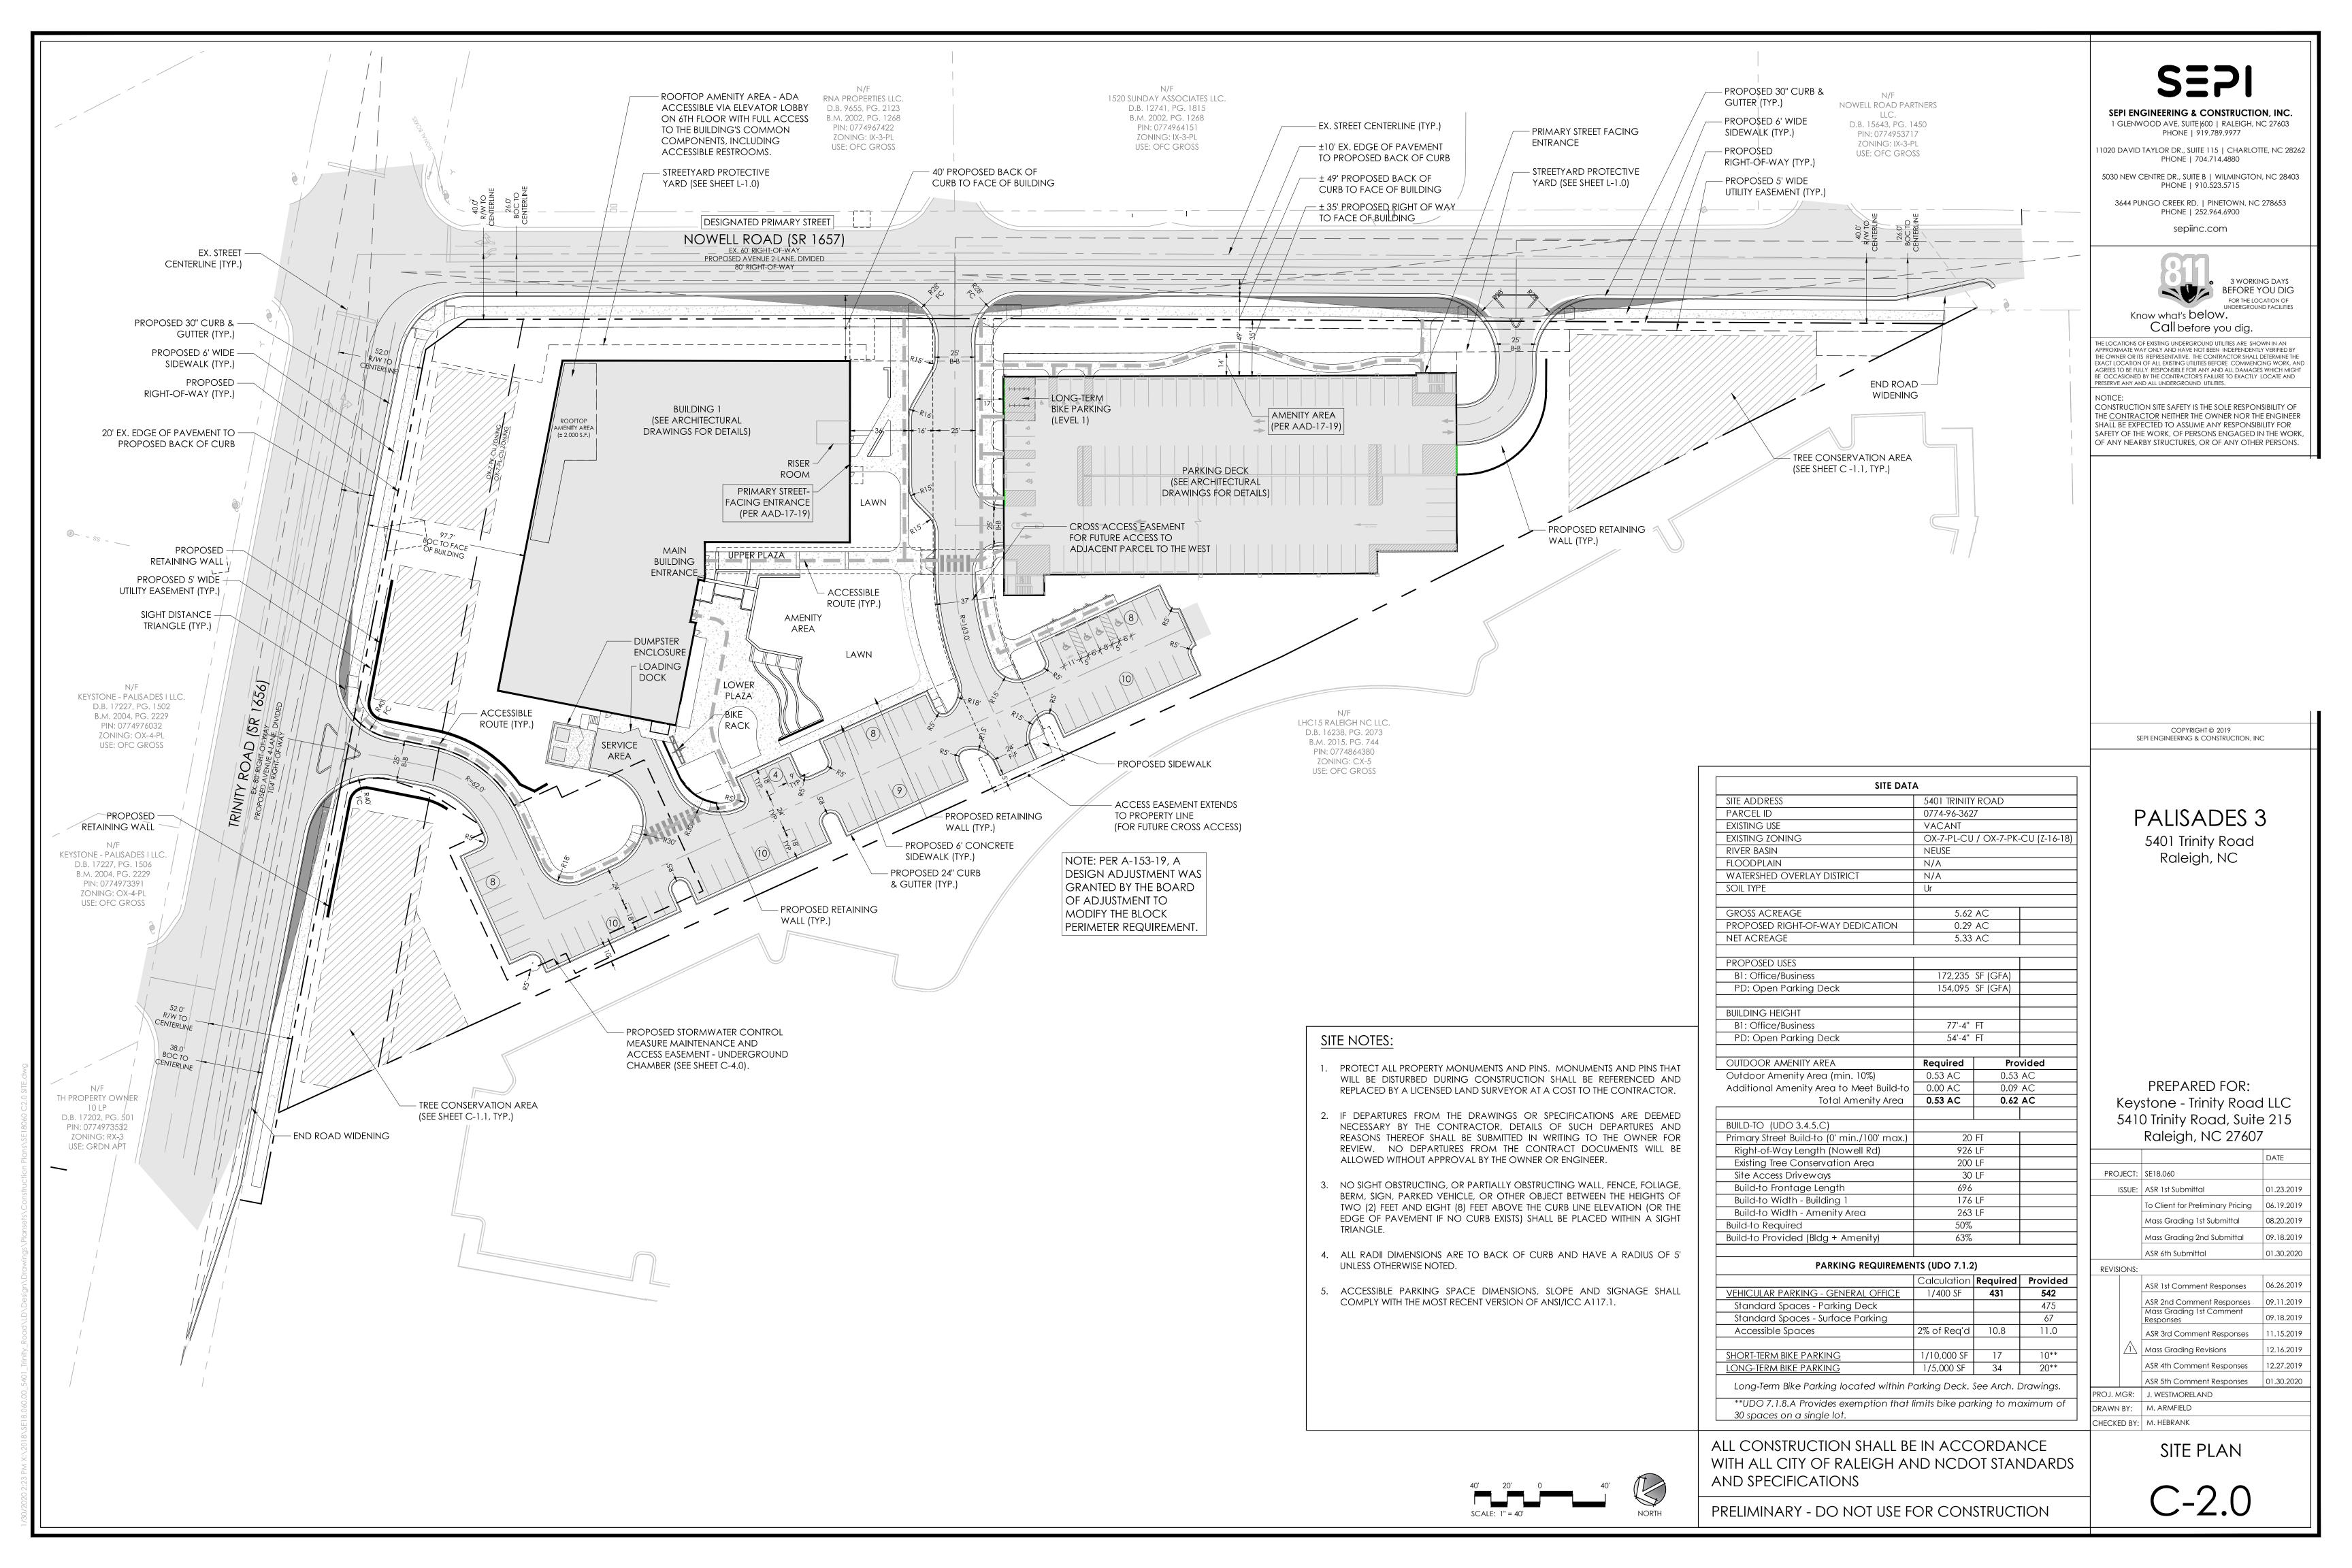

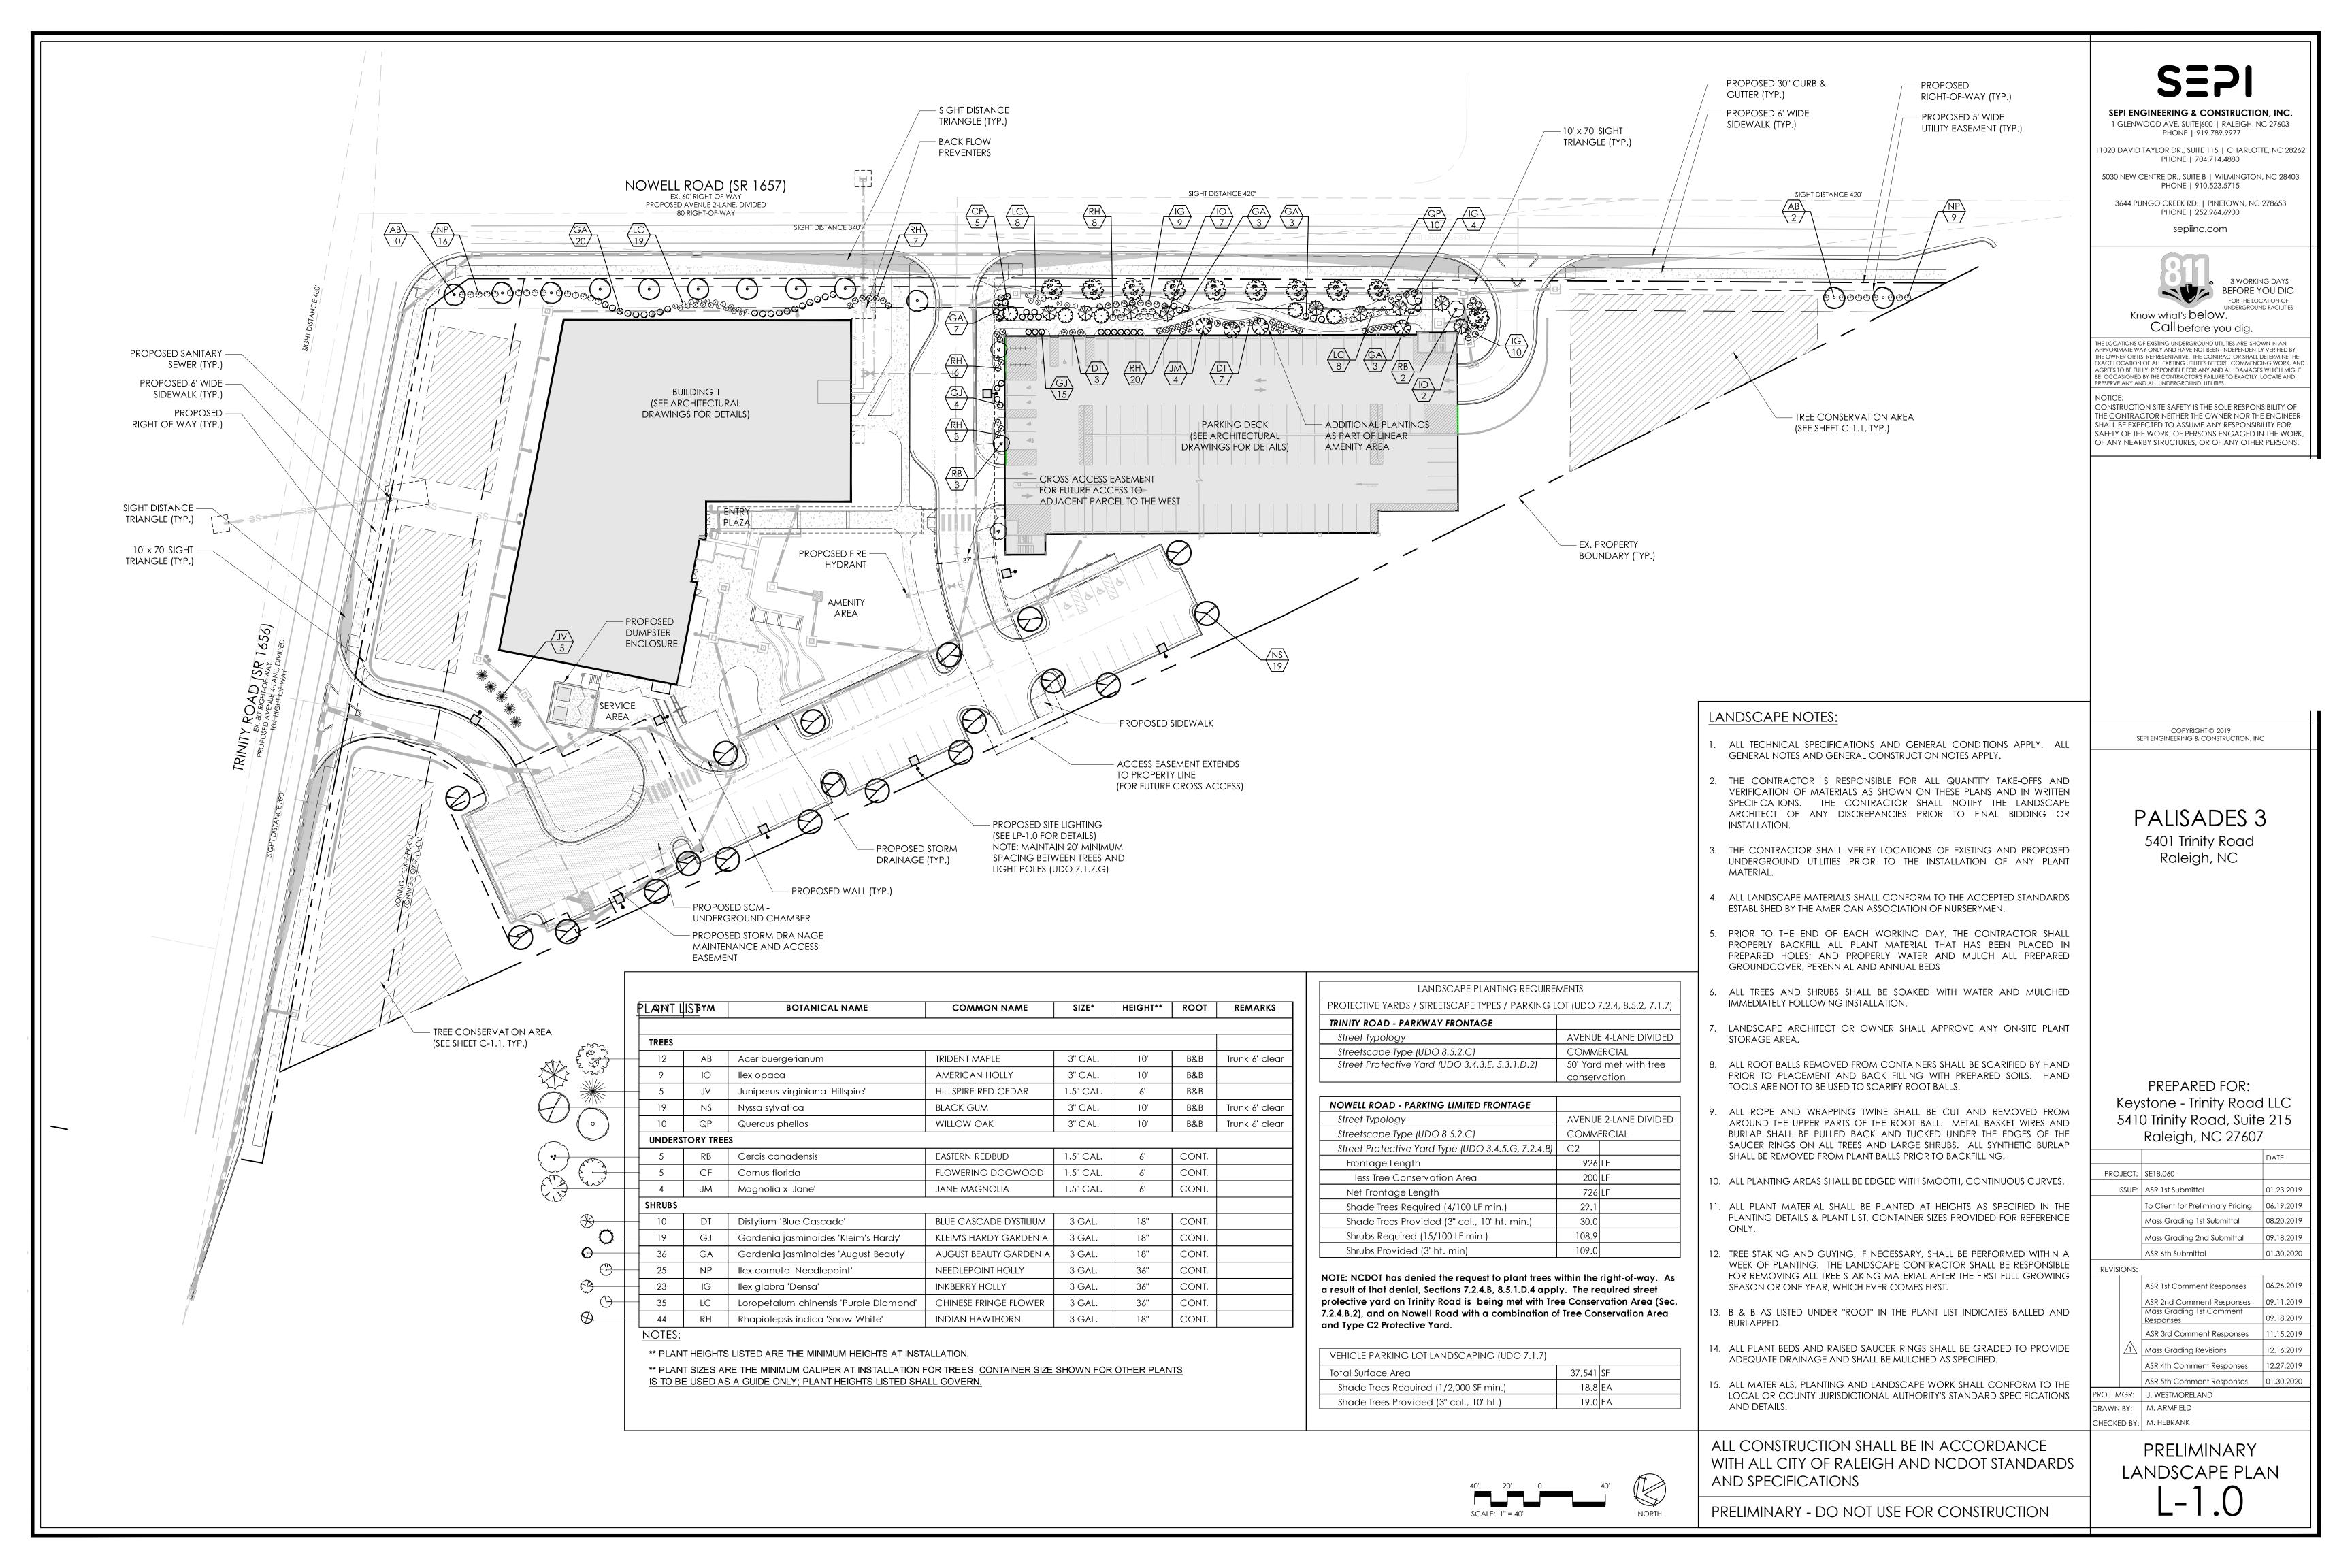


TRANSPARE	NCY CALCULATION
EAS	ST ELEVATION
GROUND STORY SF	3,461 SF
GLASS SF	1,299 SF
TOTAL %	37.5% > 33% REQUIRED
UPPER STORY SF	9,864 SF
GLASS SF	5,508 SF
LOWER %	55.8% > 20% REQUIRED

OVERFLOW ROOF

SCUPPER, TYP.

AVERAGE GRADE CALCULATION								
	PROPOSED GRADE			EXISTING GRADE				
	HIGHEST	LOWEST	AVERAGE	HIGHEST	LOWEST	AVERAG		
EAST ELEVATION	462.5	453	457.75	458.0	451.0	454.50		
NORTH ELEVATION	453	446	449.5	451.0	446.0	449.5		
WEST ELEVATION A	450	446	448	446.0	452.5	449.25		
WEST ELEVATION B	464	463	463.5	457	463	460		
SOUTH ELEVATION A	464	450	457	452.5	457	454.75		
SOUTH-WEST ELEVATION B	464	462.5	463.25	463	458	460.5		
AVERAGE			456.5			454.75		
AVERAGE BLDG HEIGHT			81'-2"			82'-11'		

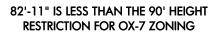

GENERAL NOTE:
1.) THE PROPOSED BUILDING EXTERIOR IS COMPRISED OF +/-95% GLASS, BRICK, STONE, MASONRY AND/OR HARDIPLANK OR SIMILAR CEMENTITIOUS MATERIAL, AND NO EIFS OR VINYL SIDING IS SPECIFIED. 95% IS MORE THAN THE REQUIRED 60%

EAST ELEVATION

HAGERSM DESIG ARCHITECTURE LANDSCAPE ARCHITECTURE PLANNING

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INTERIOR DESIGN

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PROJECT 435-412-000

PALISADES 3 SHELL
OFFICE BUILDING
ASR SET

DRAWINGS FROM THE ORIGINAL DRAWINGS.



DRAWING TITLE EAST ELEVATION

REVISIONS			
NUMBER	DESCRIPTION		0
DRAWN BY	BDG	– A-	つ
CHECKED BY	RDC	_ A-	Z

CHECKED BY BDG

DATE ISSUED 11-15-19

(A1)	EAST ELEVATION
A-201	1/8" = 1'-0"

ACM PANEL - CLEAR

SPANDREL GLASS -

6" MULLION EXTENSION -

2 1/2" X 6" CLEAR ANODIZED

BUTT GLAZED AS SHOWN

PRECAST PANELS

SPANDREL GLASS

BUTT GLAZED VERTICAL MULLION

ALUMINUM PROJECTING -CANOPY BEYOND -

RED/BROWN BRICK W/ METAL STUD BACKUP

1" INSULATED METAL

INFILL PANEL

CURTAINWALL SYSTEM WITH LOW-E

VISION GLASS - VERTICAL MULLIONS

ANODIZED

SSG CORNER —

ROOF SCREEN - -CONCEALED FASTENER METAL PANEL


STANDARD -

MULLION

6" MULLION EXTENSION

OVERFLOW ROOF

SCUPPER, TYP.

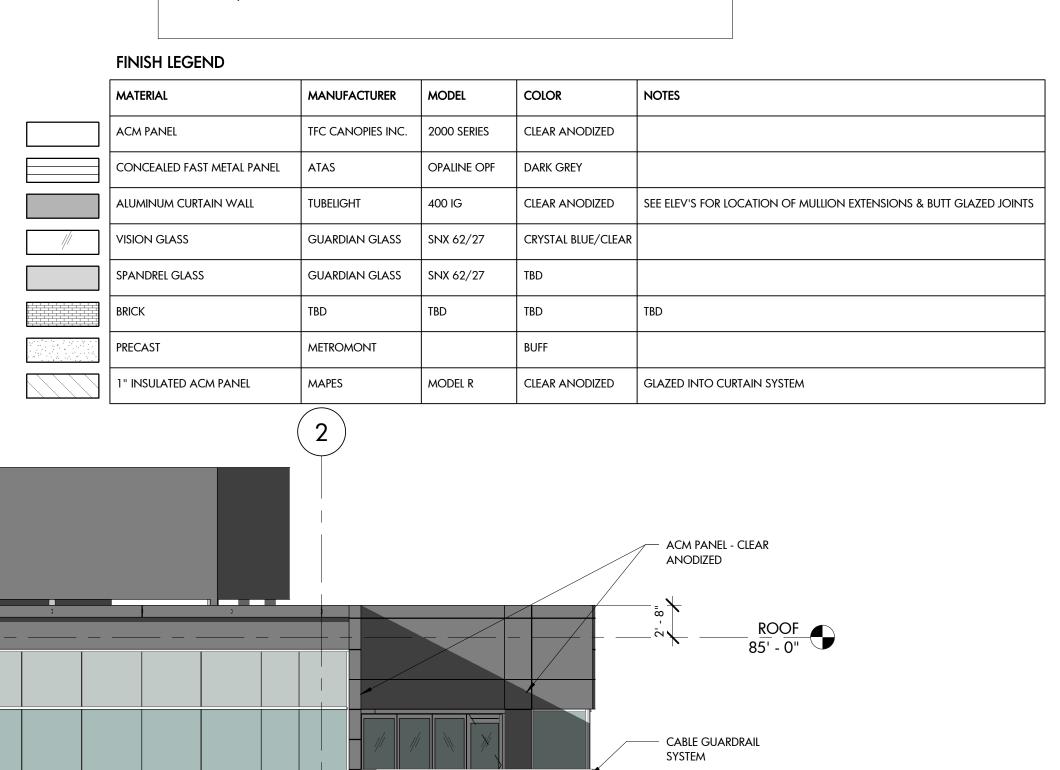

SIXTH FLOOR 70' - 0"

FIFTH FLOOR 56' - 0"

FOURTH FLOOR 42' - 0"

THIRD FLOOR 28' - 0"

SECOND FLOOR 463.50 14' - 0"

> 452.50 GRADE

- 6" MULLION EXTENSION

STANDARD MULLION

ACM PANEL - CLEAR ANODIZED

FINISH LEGEND				
MATERIAL	MANUFACTURER	MODEL	COLOR	NOTES
ACM PANEL	TFC CANOPIES INC.	2000 SERIES	CLEAR ANODIZED	
CONCEALED FAST METAL PANEL	ATAS	OPALINE OPF	DARK GREY	
ALUMINUM CURTAIN WALL	TUBELIGHT	400 IG	CLEAR ANODIZED	SEE ELEV'S FOR LOCATION OF MULLION EXTENSIONS & BUTT GLAZED JOINTS
VISION GLASS	GUARDIAN GLASS	SNX 62/27	CRYSTAL BLUE/CLEAR	
SPANDREL GLASS	GUARDIAN GLASS	SNX 62/27	TBD	
BRICK	TBD	TBD	TBD	TBD
PRECAST	METROMONT		BUFF	
1" INSULATED ACM PANEL	MAPES	MODEL R	CLEAR ANODIZED	GLAZED INTO CURTAIN SYSTEM

A1 NORTH ELEVATION

A-202 1/8" = 1'-0"


TRANSPARENCY CALCULATION						
EA:	ST ELEVATION					
GROUND STORY SF	3,461 SF					
GLASS SF	1,299 SF					
TOTAL %	37.5% > 33% REQUIRED					
UPPER STORY SF	9,864 SF					
GLASS SF	5,508 SF					
LOWER %	55.8% > 20% REQUIRED					

	AVERA	AGE GRAD	E CALCUL	ATION		
	PR	OPOSED GRA	DE	E	KISTING GRAI	DE
	HIGHEST	LOWEST	AVERAGE	HIGHEST	LOWEST	AVERAGE
EAST ELEVATION	462.5	453	457.75	458.0	451.0	454.50
NORTH ELEVATION	453	446	449.5	451.0	446.0	449.5
WEST ELEVATION A	450	446	448	446.0	452.5	449.25
WEST ELEVATION B	464	463	463.5	457	463	460
SOUTH ELEVATION A	464	450	457	452.5	457	454.75
SOUTH-WEST ELEVATION B	464	462.5	463.25	463	458	460.5
AVERAGE			456.5			454.75
AVERAGE BLDG HEIGHT			81'-2"			82'-11"

82'-11" IS LESS THAN THE 90' HEIGHT RESTRICTION FOR OX-7 ZONING

GENERAL NOTE:

1.) THE PROPOSED BUILDING EXTERIOR IS COMPRISED OF +/-95% GLASS, BRICK, STONE, MASONRY AND/OR HARDIPLANK OR SIMILAR CEMENTITIOUS MATERIAL, AND NO EIFS OR VINYL SIDING IS SPECIFIED. 95% IS MORE THAN THE REQUIRED 60%

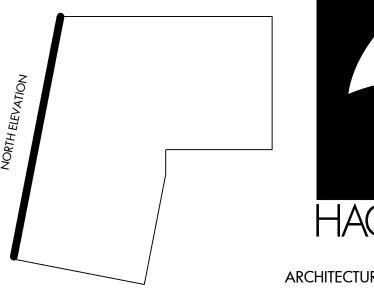

ARCHITECTURE LANDSCAPE ARCHITECTURE PLANNING INTERIOR DESIGN

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PALISADES 3 SHELL OFFICE BUILDING ASR SET



NORTH ELEVATION

REVISIONS NUMBER DESCRIPTION DRAWN BY BDG снескед ву ВДС

DATE ISSUED 11-15-19

FINISH LEGEND				
MATERIAL	MANUFACTURER	MODEL	COLOR	NOTES
ACM PANEL	TFC CANOPIES INC.	2000 SERIES	CLEAR ANODIZED	
CONCEALED FAST METAL PANEL	ATAS	OPALINE OPF	DARK GREY	
ALUMINUM CURTAIN WALL	TUBELIGHT	400 IG	CLEAR ANODIZED	SEE ELEV'S FOR LOCATION OF MULLION EXTENSIONS & BUTT GLAZED JOINTS
VISION GLASS	GUARDIAN GLASS	SNX 62/27	CRYSTAL BLUE/CLEAR	
SPANDREL GLASS	GUARDIAN GLASS	SNX 62/27	TBD	
BRICK	TBD	TBD	TBD	TBD
PRECAST	METROMONT		BUFF	
1" INSULATED ACM PANEL	MAPES	MODEL R	CLEAR ANODIZED	GLAZED INTO CURTAIN SYSTEM

TRANSPARENCY CALCULATION						
EAST ELEVATION						
GROUND STORY SF	3,461 SF					
GLASS SF	1,299 SF					
TOTAL %	37.5% > 33% REQUIRED					
UPPER STORY SF	9,864 SF					
GLASS SF	5,508 SF					
LOWER %	55.8% > 20% REQUIRED					

AVERAGE GRADE CALCULATION							
	PR	OPOSED GRA	/DE	E	XISTING GRAI	DE	
	HIGHEST	LOWEST	AVERAGE	HIGHEST	LOWEST	AVERAGE	
EAST ELEVATION	462.5	453	457.75	458.0	451.0	454.50	
NORTH ELEVATION	453	446	449.5	451.0	446.0	449.5	
WEST ELEVATION A	450	446	448	446.0	452.5	449.25	
WEST ELEVATION B	464	463	463.5	457	463	460	
SOUTH ELEVATION A	464	450	457	452.5	457	454.75	
SOUTH-WEST ELEVATION B	464	462.5	463.25	463	458	460.5	
AVERAGE			456.5			454.75	
AVERAGE BLDG HEIGHT			81'-2"			82'-11"	


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GENERAL NOTE:

THAN THE REQUIRED 60%

82'-11" IS LESS THAN THE 90' HEIGHT

RESTRICTION FOR OX-7 ZONING

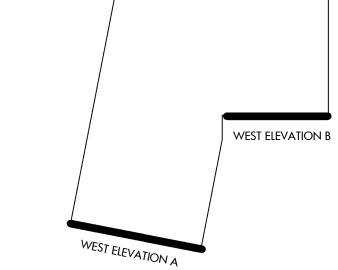

ARCHITECTURE


LANDSCAPE ARCHITECTURE

PLANNING

INTERIOR DESIGN

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	FINISH LEGEND				
	MATERIAL	MANUFACTURER	MODEL	COLOR	NOTES
	ACM PANEL	TFC CANOPIES INC.	2000 SERIES	CLEAR ANODIZED	
	CONCEALED FAST METAL PANEL	ATAS	OPALINE OPF	DARK GREY	
	ALUMINUM CURTAIN WALL	TUBELIGHT	400 IG	CLEAR ANODIZED	SEE ELEV'S FOR LOCATION OF MULLION EXTENSIONS & BUTT GLAZED JOINTS
///	VISION GLASS	GUARDIAN GLASS	SNX 62/27	CRYSTAL BLUE/CLEAR	
	SPANDREL GLASS	GUARDIAN GLASS	SNX 62/27	TBD	
	BRICK	TBD	TBD	TBD	TBD
	PRECAST	METROMONT		BUFF	
	1" INSULATED ACM PANEL	MAPES	MODEL R	CLEAR ANODIZED	GLAZED INTO CURTAIN SYSTEM


TRANSPARENCY CALCULATION				
EA:	ST ELEVATION			
GROUND STORY SF	3,461 SF			
GLASS SF	1,299 SF			
TOTAL %	37.5% > 33% REQUIRED			
UPPER STORY SF	9,864 SF			
GLASS SF	5,508 SF			
LOWER %	55.8% > 20% REQUIRED			

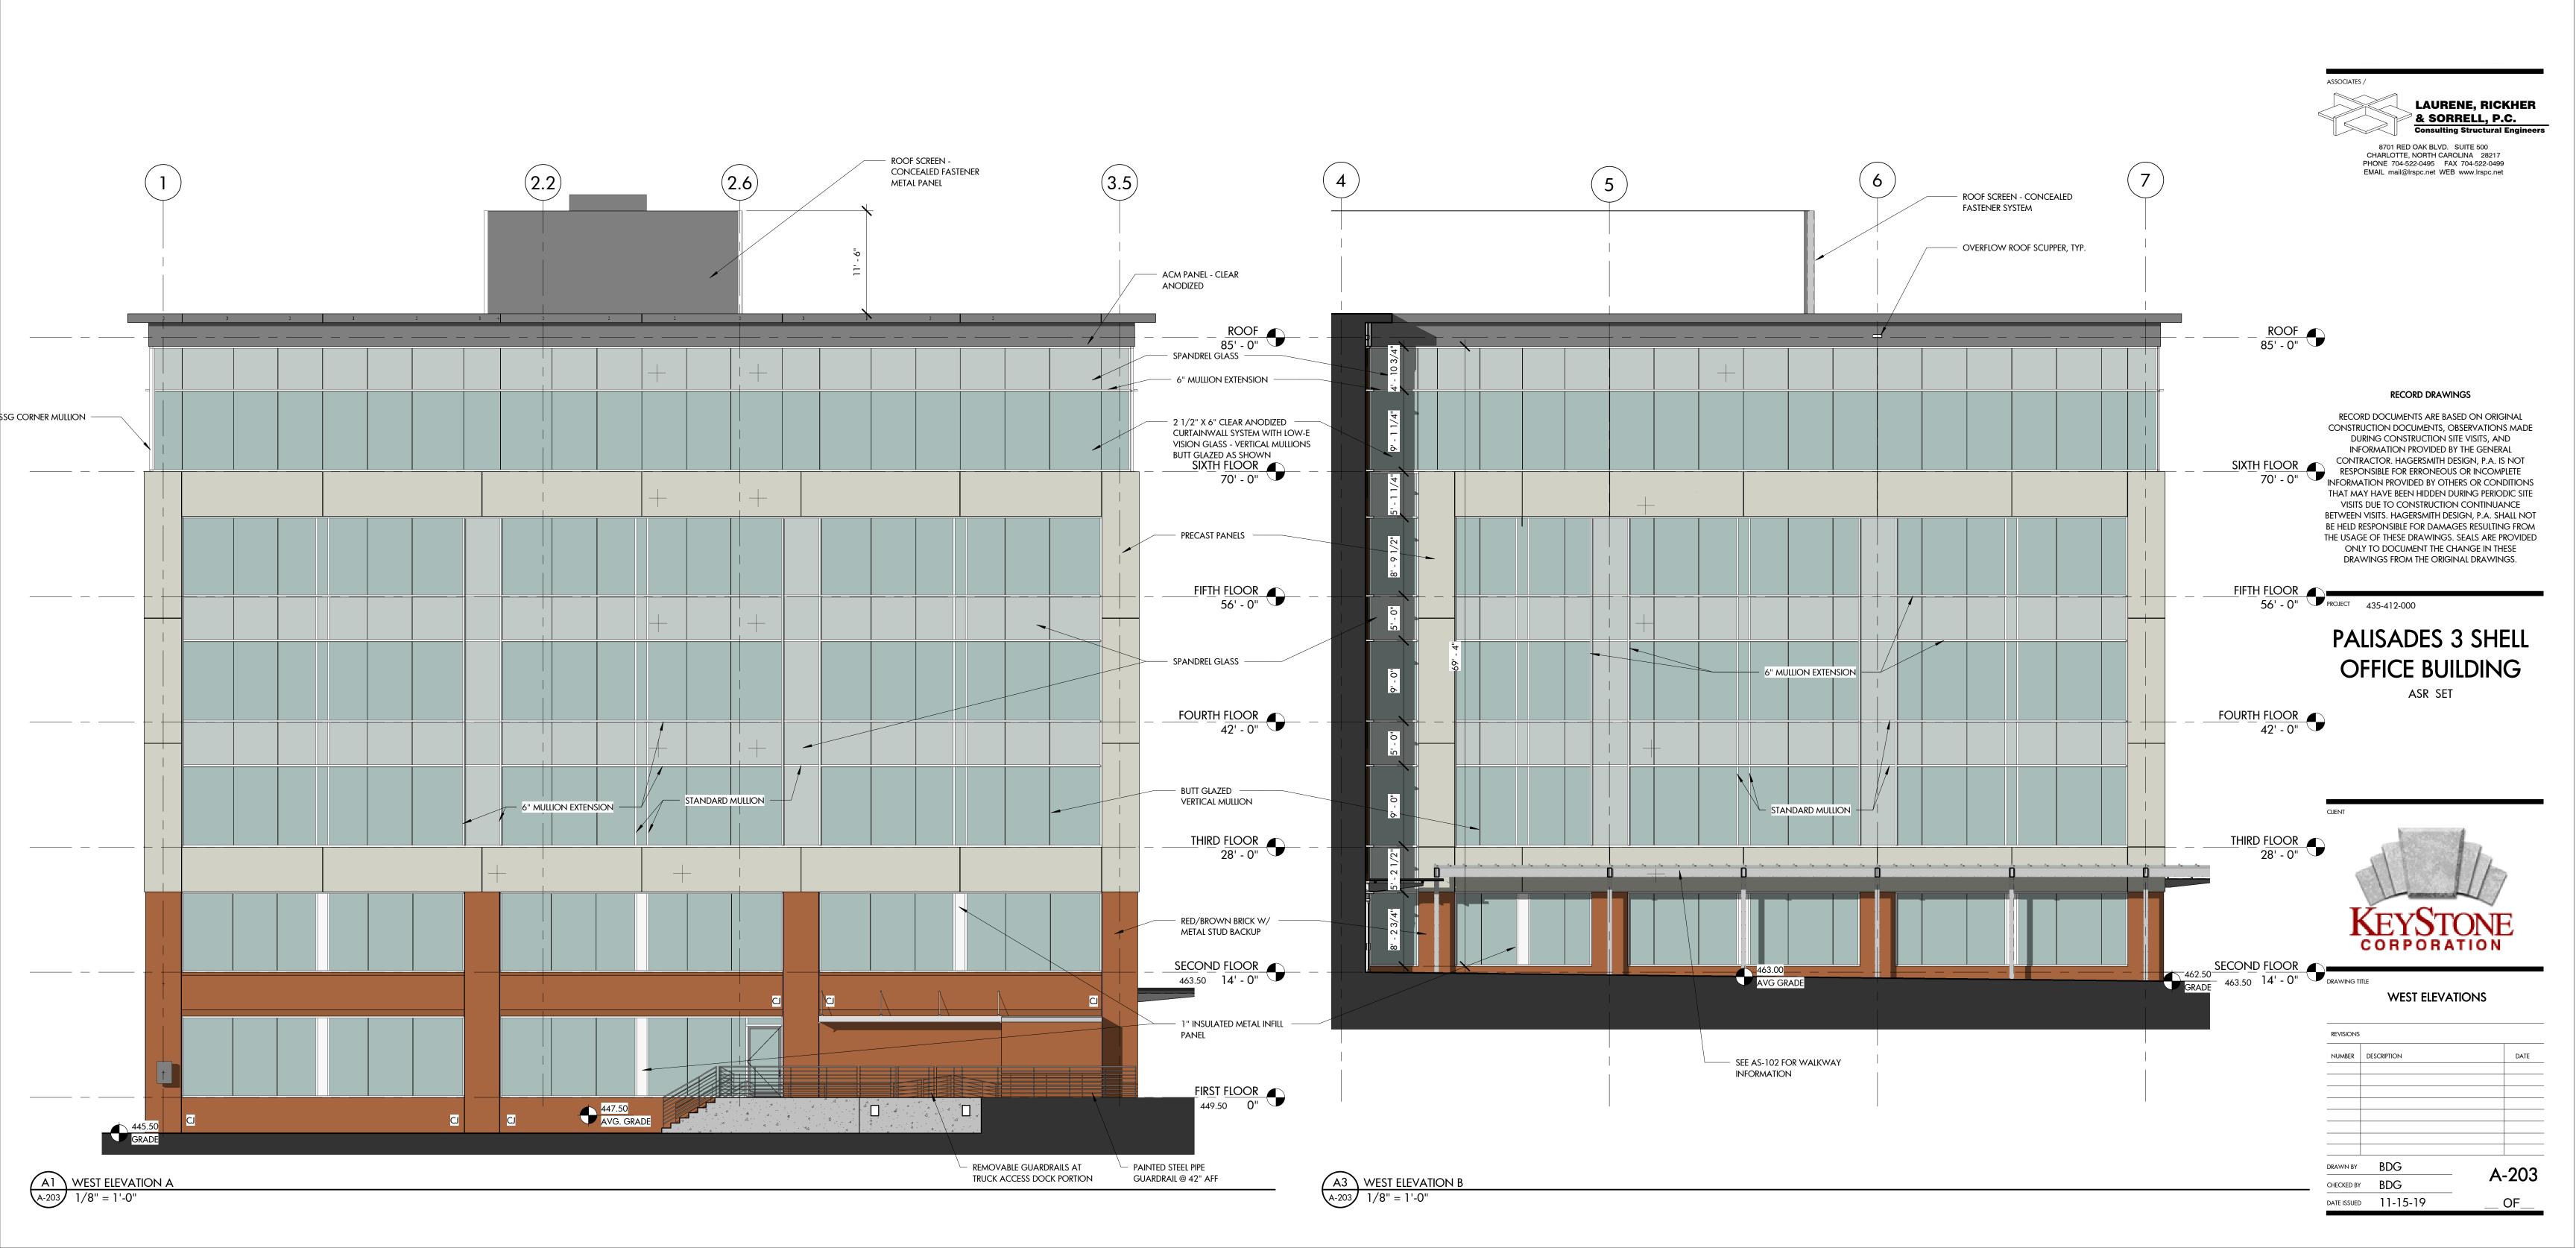AVERAGE GRADE CALCULATION							
	PR	OPOSED GRA	/DE	EXISTING GRADE			
	HIGHEST	LOWEST	AVERAGE	HIGHEST	LOWEST	AVERAGE	
EAST ELEVATION	462.5	453	457.75	458.0	451.0	454.50	
NORTH ELEVATION	453	446	449.5	451.0	446.0	449.5	
WEST ELEVATION A	450	446	448	446.0	452.5	449.25	
WEST ELEVATION B	464	463	463.5	457	463	460	
SOUTH ELEVATION A	464	450	457	452.5	457	454.75	
SOUTH-WEST ELEVATION B	464	462.5	463.25	463	458	460.5	
AVERAGE			456.5			454.75	
AVERAGE BLDG HEIGHT			81'-2"			82'-11"	

82'-11" IS LESS THAN THE 90' HEIGHT RESTRICTION FOR OX-7 ZONING

GENERAL NOTE:

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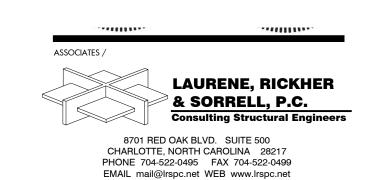


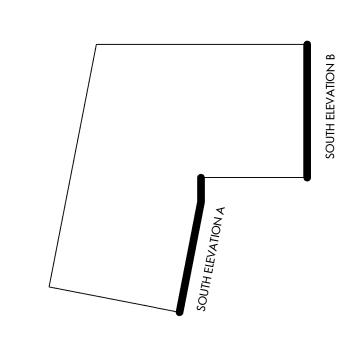

ARCHITECTURE
LANDSCAPE ARCHITECTURE
PLANNING
INTERIOR DESIGN

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PALISADES 3 SHELL OFFICE BUILDING


ASR SET



DRAWING TITLE SOUTH ELEVATIONS

DATE ISSUED 11-15-19

NUMBER	DESCRIPTION	DAT
DRAWN BY	BDG	A 00
CHECKED BY	BDG	- A-20

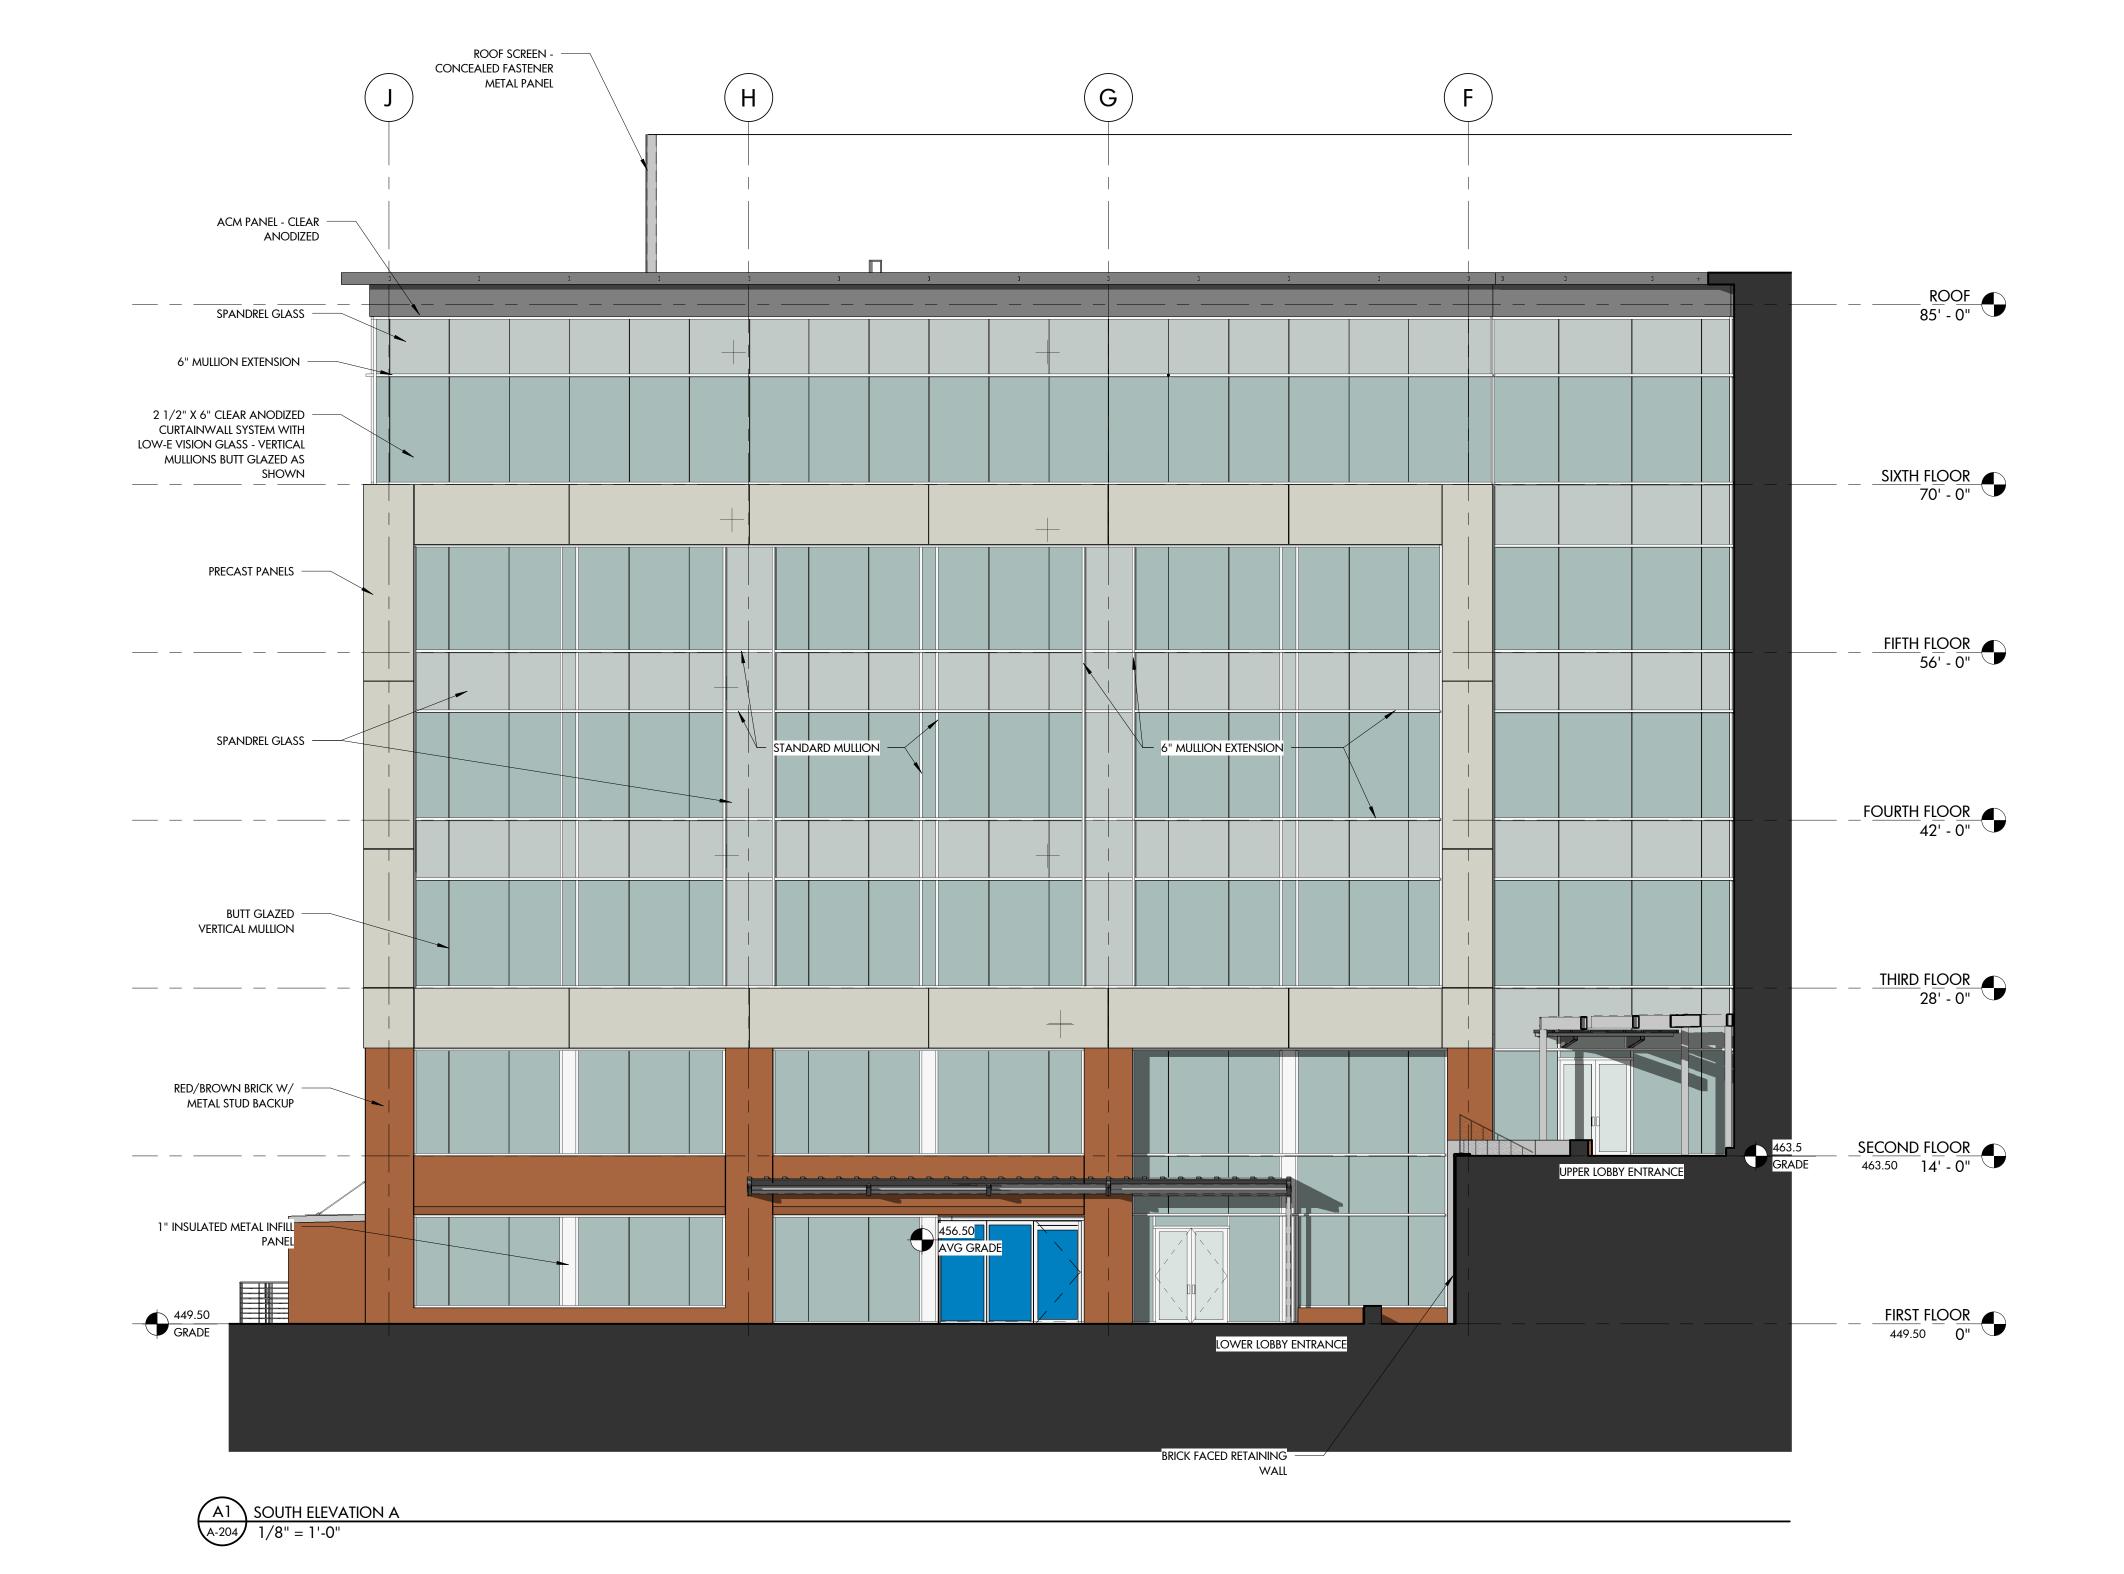

FINISH LEGEND

	FINISH LEGEND				
	MATERIAL	MANUFACTURER	MODEL	COLOR	NOTES
	ACM PANEL	TFC CANOPIES INC.	2000 SERIES	CLEAR ANODIZED	
	CONCEALED FAST METAL PANEL	ATAS	OPALINE OPF	DARK GREY	
	ALUMINUM CURTAIN WALL	TUBELIGHT	400 IG	CLEAR ANODIZED	SEE ELEV'S FOR LOCATION OF MULLION EXTENSIONS & BUTT GLAZED JOINTS
	VISION GLASS	GUARDIAN GLASS	SNX 62/27	CRYSTAL BLUE/CLEAR	
	SPANDREL GLASS	GUARDIAN GLASS	SNX 62/27	TBD	
	BRICK	TBD	TBD	TBD	TBD
	PRECAST	METROMONT		BUFF	
	1" INSULATED ACM PANEL	MAPES	MODEL R	CLEAR ANODIZED	GLAZED INTO CURTAIN SYSTEM
	· · · · · · · · · · · · · · · · · · ·				


TRANSPARENCY CALCULATION						
EAST ELEVATION						
GROUND STORY SF	3,461 SF					
GLASS SF	1,299 SF					
TOTAL %	37.5% > 33% REQUIRED					
UPPER STORY SF	9,864 SF					
GLASS SF	5,508 SF					
LOWER %	55.8% > 20% REQUIRED					

AVERAGE GRADE CALCULATION							
	PROPOSED GRADE			EXISTING GRADE			
	HIGHEST	LOWEST	AVERAGE	HIGHEST	LOWEST	AVERAGE	
EAST ELEVATION	462.5	453	457.75	458.0	451.0	454.50	
NORTH ELEVATION	453	446	449.5	451.0	446.0	449.5	
WEST ELEVATION A	450	446	448	446.0	452.5	449.25	
WEST ELEVATION B	464	463	463.5	457	463	460	
SOUTH ELEVATION A	464	450	457	452.5	457	454.75	
SOUTH-WEST ELEVATION B	464	462.5	463.25	463	458	460.5	
AVERAGE			456.5			454.75	
AVERAGE BLDG HEIGHT			81'-2"			82'-11"	

82'-11" IS LESS THAN THE 90' HEIGHT RESTRICTION FOR OX-7 ZONING

GENERAL N

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LANDSCAPE ARCHITECTURE
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INTERIOR DESIGN
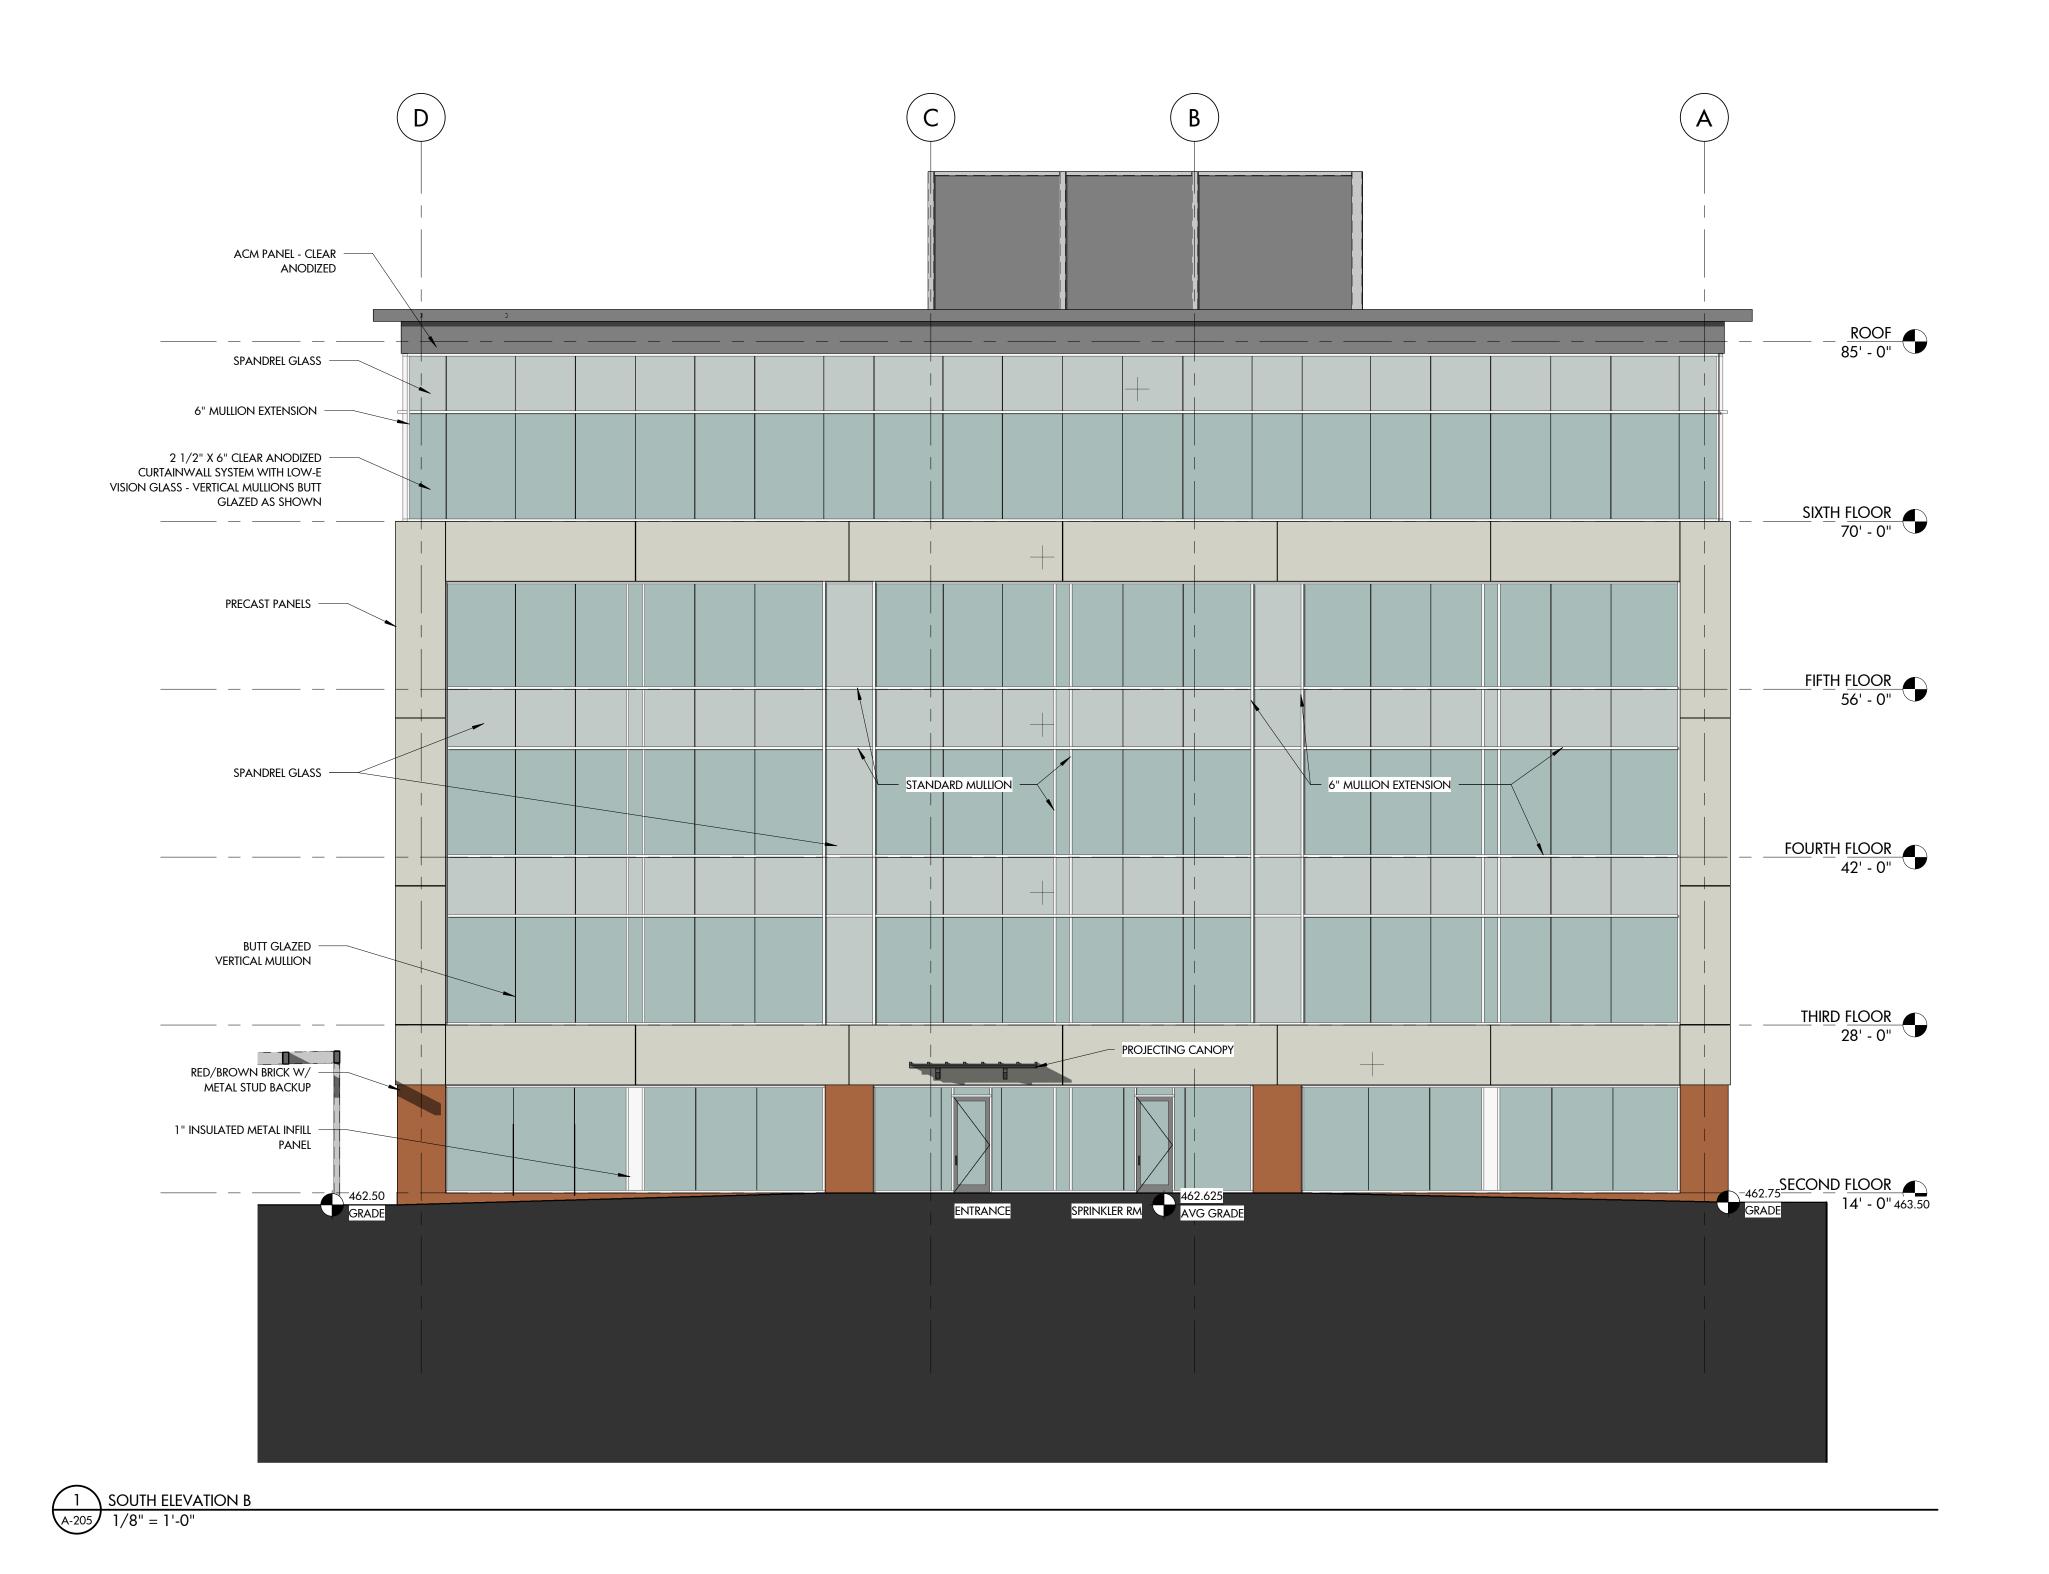
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PROJECT 435-412-000

PALISADES 3 SHELL OFFICE BUILDING

ASR SET





DRAWING TITLE SOUTH ELEVATIONS


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DATE ISSUED 11-15-19

REVISIONS		
NUMBER	DESCRIPTION	DA



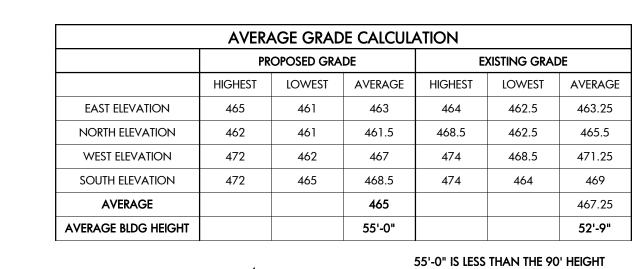

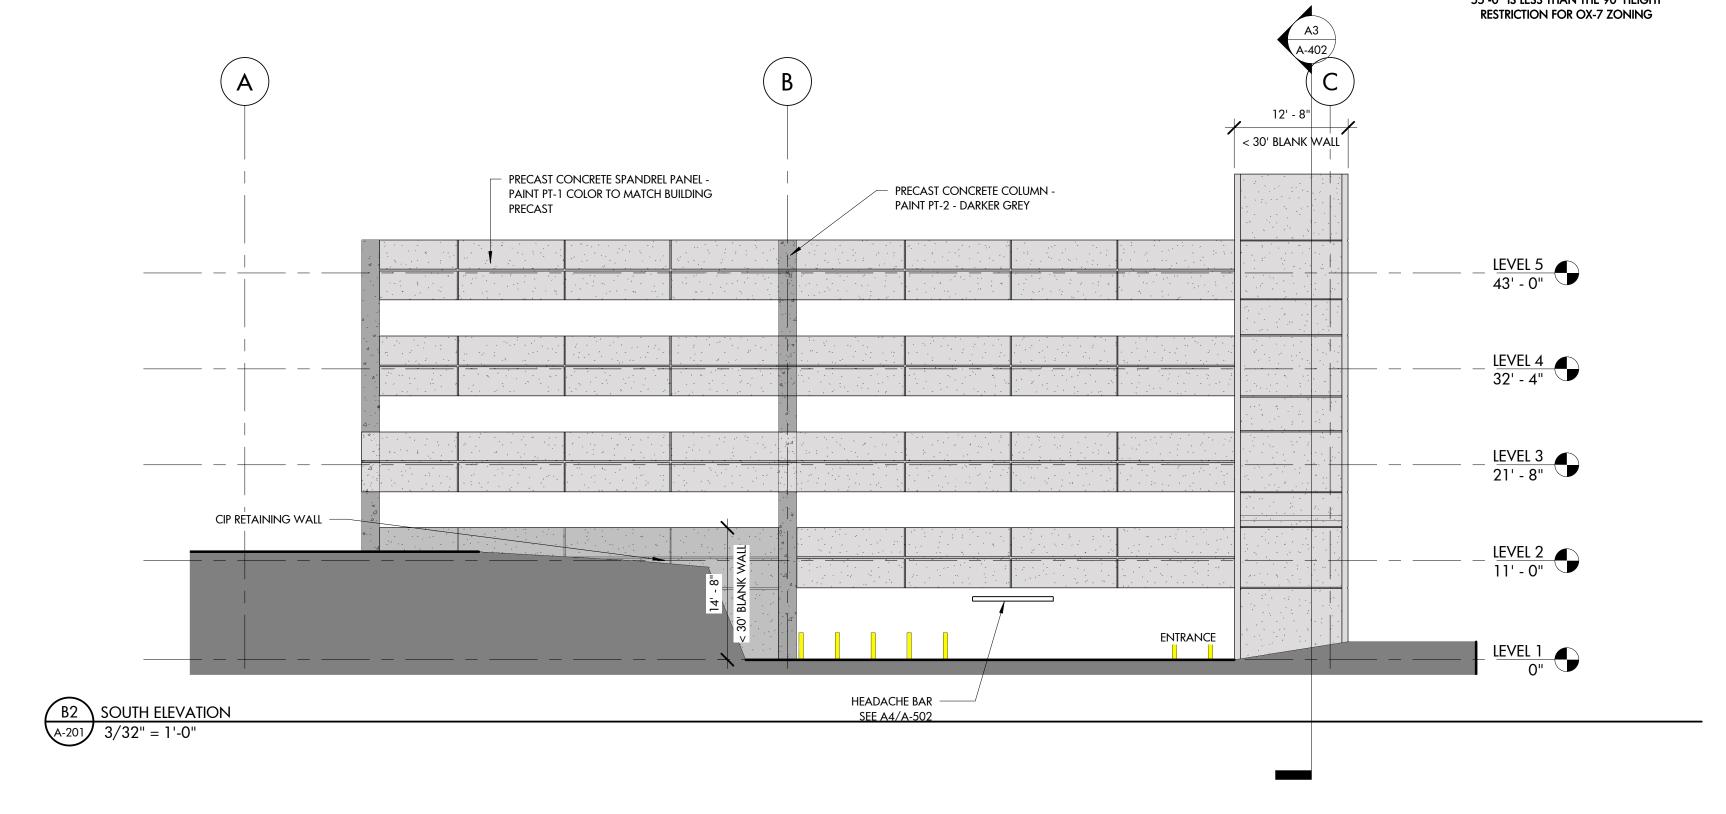

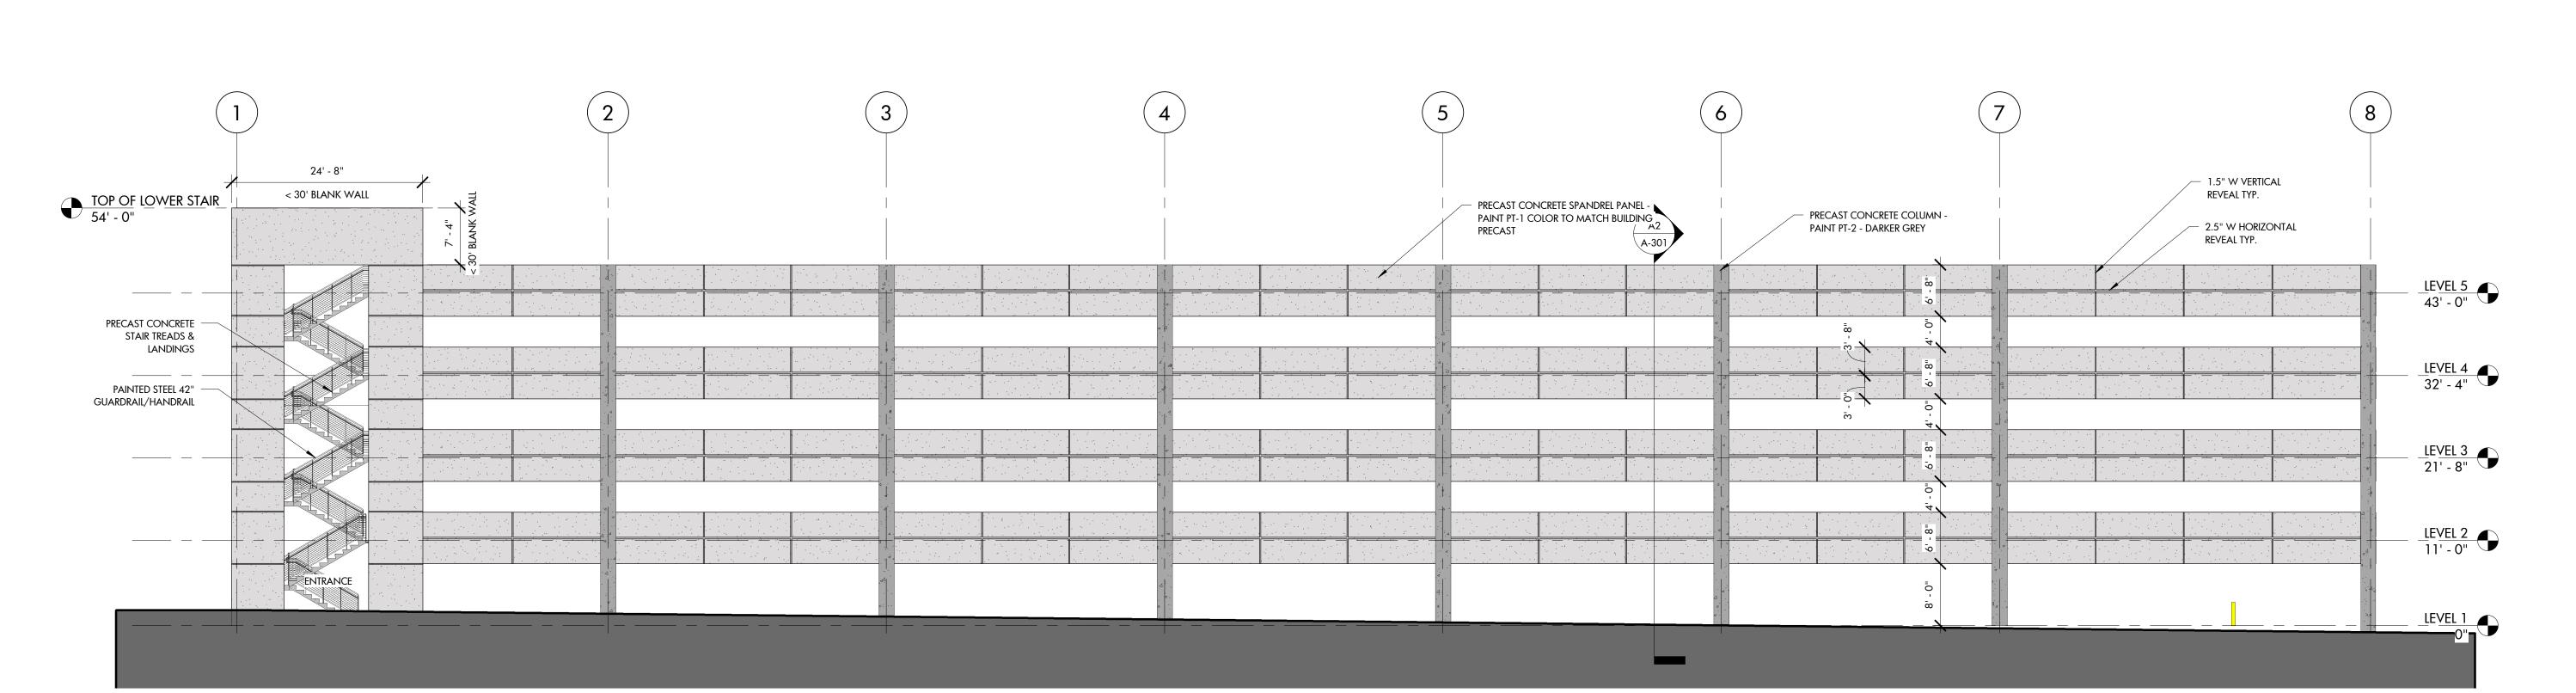PT-1 COLOR TBD
PAINT WALL EXTERIOR PRECAST PANELS &


PT-2 COLOR TBD PAINT EXTERIOR FACE, TOP & BOTTOM OF

1" LOW-E GLASS - MATCH CTI SELECTION

PRECAST PANEL

EXPOSED CONC. RETAINING WALLS. PAINT EXTERIOR FAC, TOP, & BOTTOM OF PANELS

1" CLEAR ANODIZED ALUMINUM INFILL PANEL GLAZED INTO CURTAIN WALL

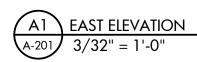



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INTERIOR DESIGN

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PALISADES 3
PARKING DECK
ASR SET




EXTERIOR ELEVATIONS


DATE ISSUED 11/15/19

REVISIONS			
NUMBER	DESCRIPTION		DATE
DRAWN BY	BDG	Λ	-201
CHECKED BY	BDG		-201

	PR	OPOSED GRA	,DE	E	XISTING GRAI	DE
	HIGHEST	LOWEST	AVERAGE	HIGHEST	LOWEST	AVERAGE
EAST ELEVATION	465	461	463	464	462.5	463.25
NORTH ELEVATION	462	461	461.5	468.5	462.5	465.5
WEST ELEVATION	472	462	467	474	468.5	471.25
SOUTH ELEVATION	472	465	468.5	474	464	469
AVERAGE			465			467.25
AVERAGE BLDG HEIGHT			55'-0"			52'-9"

55'-0" IS LESS THAN THE 90' HEIGHT RESTRICTION FOR OX-7 ZONING

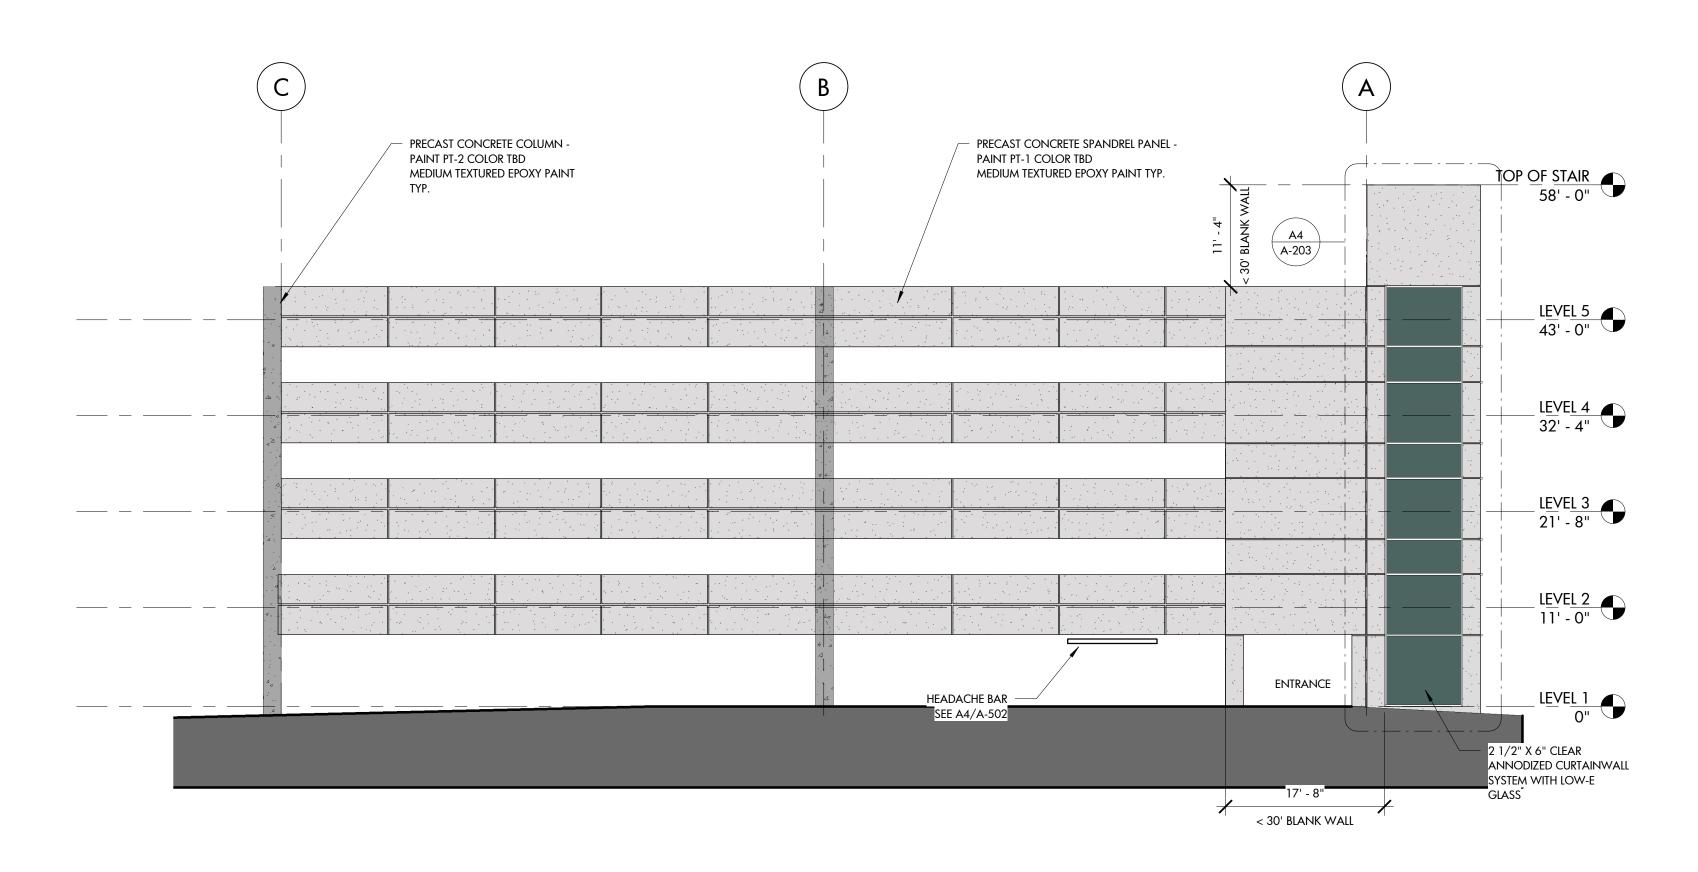

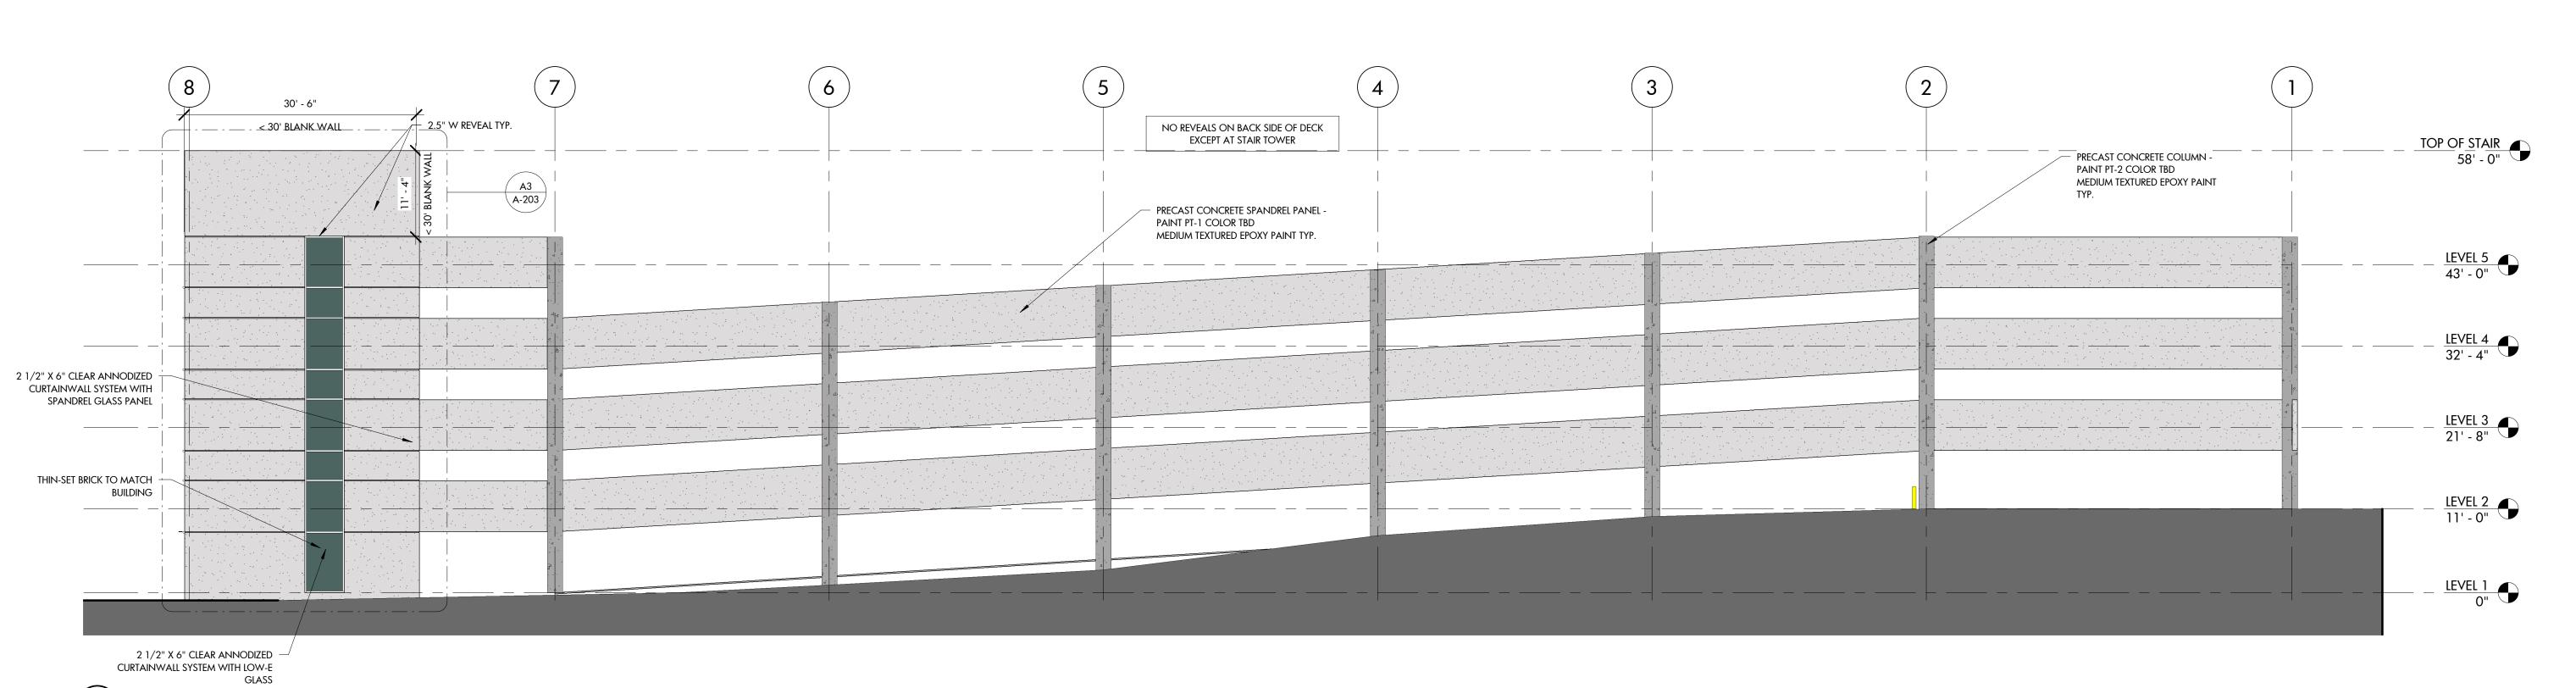

B2 NORTH ELEVATION A-202 3/32" = 1'-0"

COLOR TBD
PAINT WALL EXTERIOR PRECAST PANELS &
EXPOSED CONC. RETAINING WALLS. PAINT
EXTERIOR FAC, TOP, & BOTTOM OF PANELS

PAINT EXTERIOR FACE, TOP & BOTTOM OF

1" CLEAR ANODIZED ALUMINUM INFILL PANEL GLAZED INTO CURTAIN WALL

COLOR TBD

A1 WEST ELEVATION A-202 3/32" = 1'-0" PRECAST PANEL

1" LOW-E GLASS
- MATCH CTI SELECTION



ARCHITECTURE
LANDSCAPE ARCHITECTURE
PLANNING
INTERIOR DESIGN

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PALISADES 3
PARKING DECK
ASR SET



RAWING TITLE

EXTERIOR ELEVATIONS

REVISIONS

NUMBER DESCRIPTION DATE

DATE

DRAWN BY BDG
CHECKED BY BDG
DATE ISSUED 11/15/19 — OF_