

# CERTIFICATE OF APPROPRIATENESS PLACARD

for Raleigh Historic Resources

**Project Description:** 

Change exhaust equipment

200 E Martin St

Address

Moore Square

**Historic District** 

**Historic Property** 

COA-0133-2025

**Certificate Number** 

10/6/2025

Date of Issue

4/6/2026

**Expiration Date** 

This card must be kept posted in a location within public view until all phases of the described project are complete. The work must conform with the code of the City of Raleigh and laws of the state of North Carolina. When your project is complete, you are required to ask for a final zoning inspection in a historic district area. Telephone the RHDC office at 832-7238 and commission staff will coordinate the inspection with the inspections Department. If you do not call for this final inspection, your Certificate of Appropriateness is null and void.

Signature,

Collette K

Raleigh Historic Development Commission

Pending the resolution of appeals, commencement of work is at your own risk.

Applicant name: Matthew Konar A	Type or print t									
Mailing address: 611 W Club Bould	evard									
City: Durham	State: North Card	olina		Zip code: 27701						
Date: Thursday, 18 September 2025		Day	aytime phone #: (919) 801-9736							
Email address: matthewk@matt	hewkonar.com		1							
Applicant signature:	P	7 . U	nti							
Minor work (staff review) – o	ne copy			Office Use Only						
Major work (COA committee	review) – ten	Transaction	#:							
copies		File #:CC	OA-0133-2025							
Additions > 25% of bu	uilding sq. footage	Fee:								
New buildings			Amount paid	d:						
Demolition of building	or structure		Received da	ate:						
All other			Received by	r.						
Post approval re-review of c	onditions of									
approval										
Property street address: 200 E Ma	artin Street, Suite 10	1, Ra	leigh, North Car	rolina 27601						
Historic district: Moore Se	quare Historical Disti	rict								
Historic property/Landmark name (	if applicable):	n∕a								
Owner name: Hakan M	arket Partners									
Owner mailing address: 410 Palm	n Avenue, Suite B4, C	arpin	teria, California	93013						
	For applications that require review by the COA Committee (major work), provide addressed and stamped envelopes for owners for all properties with 100 feet on all sides of the property, as well as the property owner.									
Property Owner Name & A	ddress		Property	Owner Name & Address						

Property Owner Name & Address	Property Owner Name & Address

Page 1 of 2 REVISION 7.2.19

I understand that all major work applications that require review by the Raleigh Historic Development Commission's COA Committee must be submitted by 4 p.m. on the date of the application deadline; otherwise, consideration will be delayed until the following committee meeting. An incomplete application will not be accepted.

Yes No	pplying for rehabilit ult with staff prior to	Office Use Only Type of work: 50, 81	
Desiç	gn Guidelines: please	cite the applicable sections of the d	esign guidelines ( <u>www.rhdc.org</u> ).
Section/Page	Topic	Brief description of work (a	ittach additional sheets as needed).
2.6	Exterior Walls	replace existing hood exhaust fan o	n exterior wall with 'in kind' new exhaust fan
Certificate of Ap Please post the Certificate shall	propriateness. It is vali enclosed placard form not relieve the applicar y law. Minor Works are	Minor Work Approval (office use of the Planning Director or designee, this d until 0400 (office use of the certificate as indicated at the both, contractor, tenant, or property owner is subject to an appeals period of 30 days	tom of the card. Issuance of a Minor Work from obtaining any other permit required by

#### WRITTEN DESCRIPTION

The space at 200 E Martin Street, Suite 101, located on the corner of E Martin Street and S Blount Street and part of the building that is within the Moore Square Historic District, has an existing (over 30 years old and already there when the current Landlord acquired the building in 1995) non-conforming sidewall metal hood exhaust fan (commonly known as a 'mushroom'), approximately 40 inches in diameter, mounted on the exterior wall on the Blount Street side of the building, approximately 12 feet above the sidewalk. (refer to photographs on the Color Photographs page.)

This Minor Certificate of Appropriateness application is for the proposed work to install a new in-kind, similar metal hood exhaust fan, approximately 40 inches in diameter, mounted in the same location on the exterior wall of the building as part of an Interior Alteration for a restaurant renovation. (refer to the enclosed Hood drawings, page 4 for the exterior hood exhaust fan.)

### **PHOTOGRAPHS**









FOR QUESTIONS, CALL THE Eastern North Carolina REGION 36 PHONE: (919) 825 - 3566 EMAIL: reg36@captiveaire.com

OPTION

RIGHT VERTICAL END PANEL 27" TOP WIDTH, 21" BOTTOM WIDTH, 80" HIGH INSULATED 430

1" LAYER OF INSULATION FACTORY INSTALLED IN INTERNAL BACK STANDOFF.

MEETS 0 INCH REQUIREMENTS FOR CLEARANCE TO COMBUSTIBLE SURFACES.

AC-PSP (UNITED STATES) - US PATENT 7963830 B2. AC-PSP WALL (CANADA) - CA PATENT 2820509. AC-PSP ISLAND (CANADA) - CA PATENT 2520330.

 $U \cap O \cap IMF \cap DMATION IOD \#9100051$ 

HUU	) INF	<u>ORMATION </u>	<u> — JUB#819</u>	<u> 10951                                     </u>																
HOOD	TAG	MODEL	MANUFACTURER	LENGTH	MAX COOKING	TYPE	  APPLIANCE		TOTAL				UST P RISER(:	LENUM S)			TOTAL SUPPLY	HOOD	HOOD C	
NΠ	1 1 1 1 1	MODEC	MANOI ACTOREK	LLINGTIT	TEMP	111 6	DUTY	CFM/FT	EXH CFM	WIDTH	LENG	HEIGHT	DIA	CFM	VEL	SP	CFM	CONSTRUCTION	END	R□W
1		5424	CAPTIVEAIRE	7′ 11″	600	т	HEV//A	200	1583			1"	14"	1583	1481	-0.599″	1266	430 SS	AI UNE	AI UNE
1		ND-2-PSP-F	_ CAPTIVEAIRE	/ 11	DEG	1	HEAVY	200	1383				14   138	1363	1401	-0,399	1200	WHERE EXPOSED	ALONE ALON	
2		5424	CAPTIVEAIRE	8′ 11″	600	т	HEAVY	240	21.40			///	14"	2140	2002	-0.986"	1263	430 SS	ALONE	VI UNE
		ND-2-PSP-F CAPTIVEAIRE	-5-b2b-t Cabiliferike 8. II.		DEG	1	IILAVI	240	2140			7	14	L140	בטטב	0,700	1663	WHERE EXPOSED	HLUNE	HLUINE

	ואט ב ו או ו										W	TIERE EXI USED				
HOOD In	<i>IFORMATION</i>															
			FILTER	(2)		LIGHT(S)				UTILITY CABINET(S)						HOOD
HOOD TA	G				EFFICIENCY @ 7			WIRE			FI	RE SYSTEM	ELECTRICAL	SWITCHES	FIRE	1HANGING
ND I F	TYPE	QTY	Y HEIGHT	LENGTH	MICRONS	QTY	TYPE	GUARD	LOCATION	SIZE	TYPE	SIZE	MODEL #	QUANTITY	PIPING	WEIGHT
1	CAPTRATE SOLO FILTER	5	20″	16"	85% SEE FILTER SPEC	2	RECESSED ROUND	NO							YES	522 LBS
2	CAPTRATE SOLO FILTER		20″	16"	85% SEE FILTER SPEC	5	RECESSED ROUND	NO	RIGHT	12"×54"×24"	TANK FS	4.0/4.0/4.0			YES	1067 LBS

EFFICIENCY VS. PARTICLE DIAMETER

FLOW RATE (CFM)

PRESSURE DROP VS. FLOW RATE

CAPTRATE FILTERS ARE BUILT IN COMPLIANCE WITH: NFPA #96. NSF STANDARD #2.

PARTICLE DIAMETER (UM)

SPECIFICATION: CAPTRATE GREASE-STOP SOLD FILTER

TO DELIVER EXCEPTIONAL FILTRATION EFFICIENCY.

2-INCH DEEP HOOD CHANNEL(S).

COMPONENTS WHEN ASSEMBLED.

THE CAPTRATE GREASE-STOP SOLO FILTER IS A SINGLE-STAGE FILTER FEATURING

FILTER IS STAINLESS STEEL CONSTRUCTION, AND SIZED TO FIT INTO STANDARD

A UNIQUE S-BAFFLE DESIGN IN CONJUNCTION WITH A SLOTTED REAR BAFFLE DESIGN,

GREASE EXTRACTION EFFICIENCY PERFORMANCE SHALL REMOVE AT LEAST 75% OF GREASE PARTICLES FIVE MICRONS IN SIZE, AND 85% GREASE PARTICLES SEVEN MICRONS IN SIZE AND LARGER, WITH A CORRESPONDING PRESSURE DROP NOT TO EXCEED 1.0 INCHES OF WATER GAUGE.

THE CAPTRATE GREASE-STOP SOLO WAS TESTED TO ASTM STANDARD ASTM F2519-05. MANUFACTURER APPROVED FOR USE IN SOLID FUEL APPLICATIONS AS A SPARK ARRESTER.

UNITS SHALL INCLUDE STAINLESS STEEL HANDLES AND A FASTENING DEVICE TO SECURE THE TWO

UL STANDARD #1046. INT. MECH. CODE (IMC). ULC-S649.

PERFORATED SUPPLY PLENUM(S)

INSULATION FOR TOP OF HOOD.

INSULATION FOR BACK OF HOOD.

INSULATION FOR TOP OF HOOD. INSULATION FOR BACK OF HOOD.

FIELD WRAPPER 18.00" HIGH

LEFT WALL AS END PANEL.

HOOD OPTIONS TAG

ПППП					RISER(S)		RISER(S)				
HOOD NO	TAG	POS	LENGTH	WIDTH	HEIGHT	TYPE	WIDTH	LENG	DIA	CFM	SP
1		E10.00+	ont 96" 14"		6"	MUA	8″	36″		633	0.179″
1		Front	70	14		MUA	8″	36″		633	0.179″
2		L 19	119″	1 // //	6 <i>"</i>	MUA	8″	36″		631	0.153″
2		Front	117	14"	В	MUA	8″	36″	·	631	0.153″


FIELD WRAPPER 18.00" HIGH FRONT, LEFT.

|FIELD WRAPPER 18.00″ HIGH FRONT, RIGHT.

|BACKSPLASH 80.00" HIGH X 96.00" LONG 430 SS VERTICAL.


|LEFT END-STANDOFF (FINISHED) 1″ WIDE 54″ LONG INSULATED.

FRONT, RIGHT.

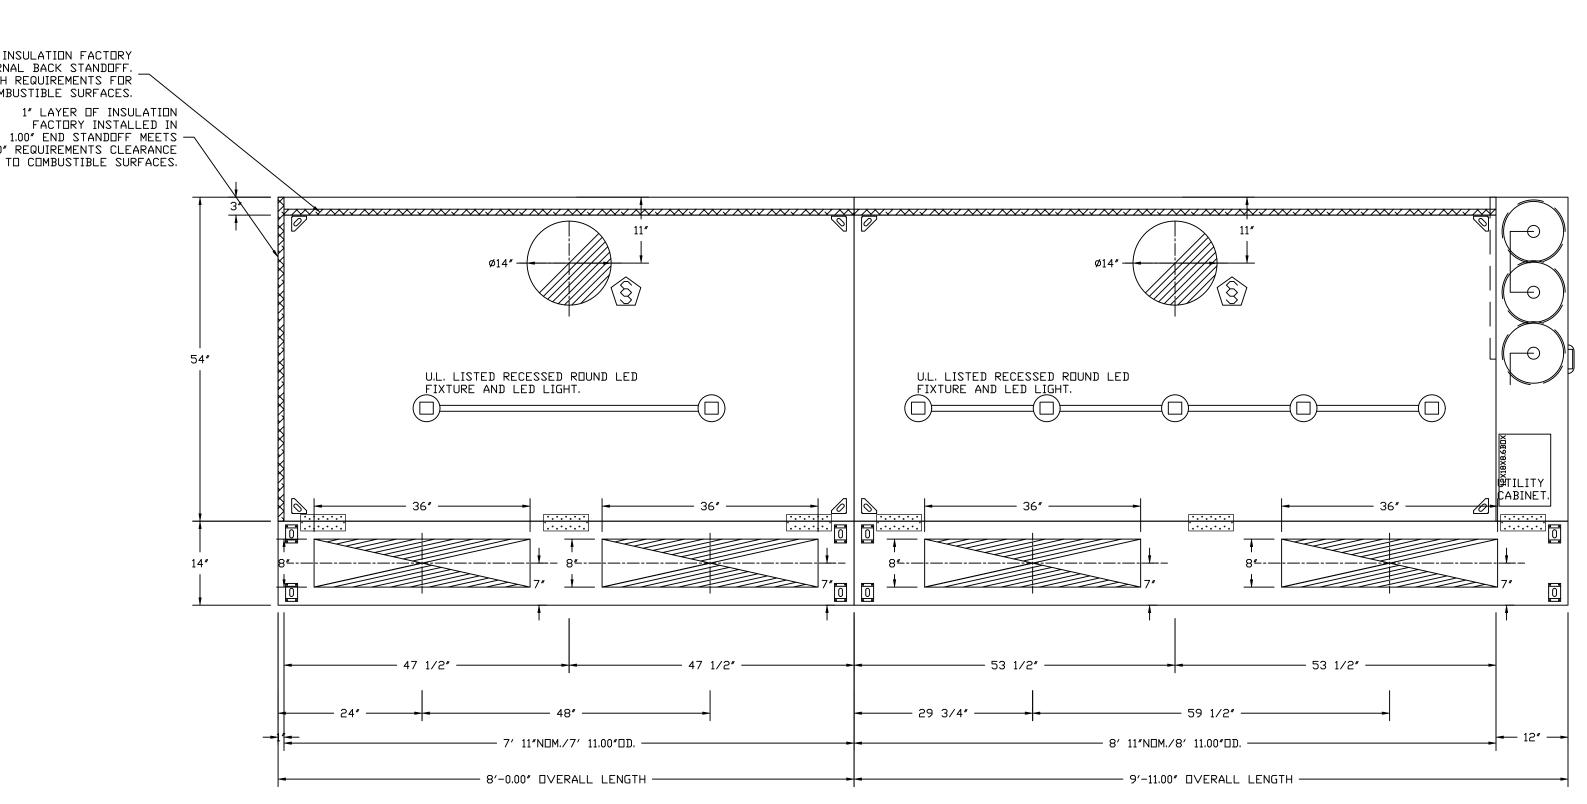

<u> PLAN VIEW — HOOD #1</u> 7' 11.00" LONG 5424ND-2-PSP-F

PLAN VIEW - HOOD #2 8' 11.00" LONG 5424ND-2-PSP-F

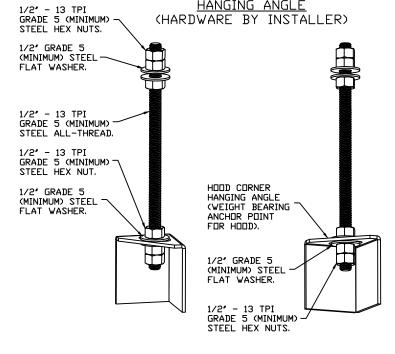


## ASSEMBLY INSTRUCTIONS

HOOD CORNER HANGING ANGLE

HANGING ANGLE MUST BE SUPPORTED WITH 1/2" - 13 TPI GRADE 5 (MINIMUM) ALL-THREAD, SANDWICH HANGING ANGLES AND CEILING ANCHOR POINTS WITH 1/2" GRADE 5 (MINIMUM) STEEL FLAT WASHERS AND 1/2" - 13 TPI GRADE 5 (MINIMUM) HEX NUTS AS SHOWN, MUST USE DOUBLED HEX NUT CONFIGURATION BENEATH HODD HANGING ANGLES AND ABOVE CEILING ANCHORS. MAINTAIN 1/4" OF EXPOSED THREADS BENEATH BOTTOM HEX NUT. TORQUE ALL HEX NUTS TO 57 FT-LBS.

CAPTIVE-AIRE HOODS ARE BUILT IN COMPLIANCE WITH:

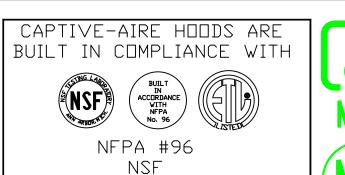

UL 710 & ULC710 STANDARDS E.T.L. LISTED 3054804-001

> \*FOR QUESTIONS\* CONTACT: REGION 36 EASTERN NORTH CAROLINA PHONE: (919) 825-3566 EMAIL: REG36@CAPTIVEAIRE.COM


**REVISIONS** DESCRIPTION DATE:

9  $\bigcap$ eigh 7 M**DATE:** 8/25/2025

DWG.#: 8190951 DRAWN BY: reg36

> SCALE: 3/4" = 1'-0"

**MASTER DRAWING** 

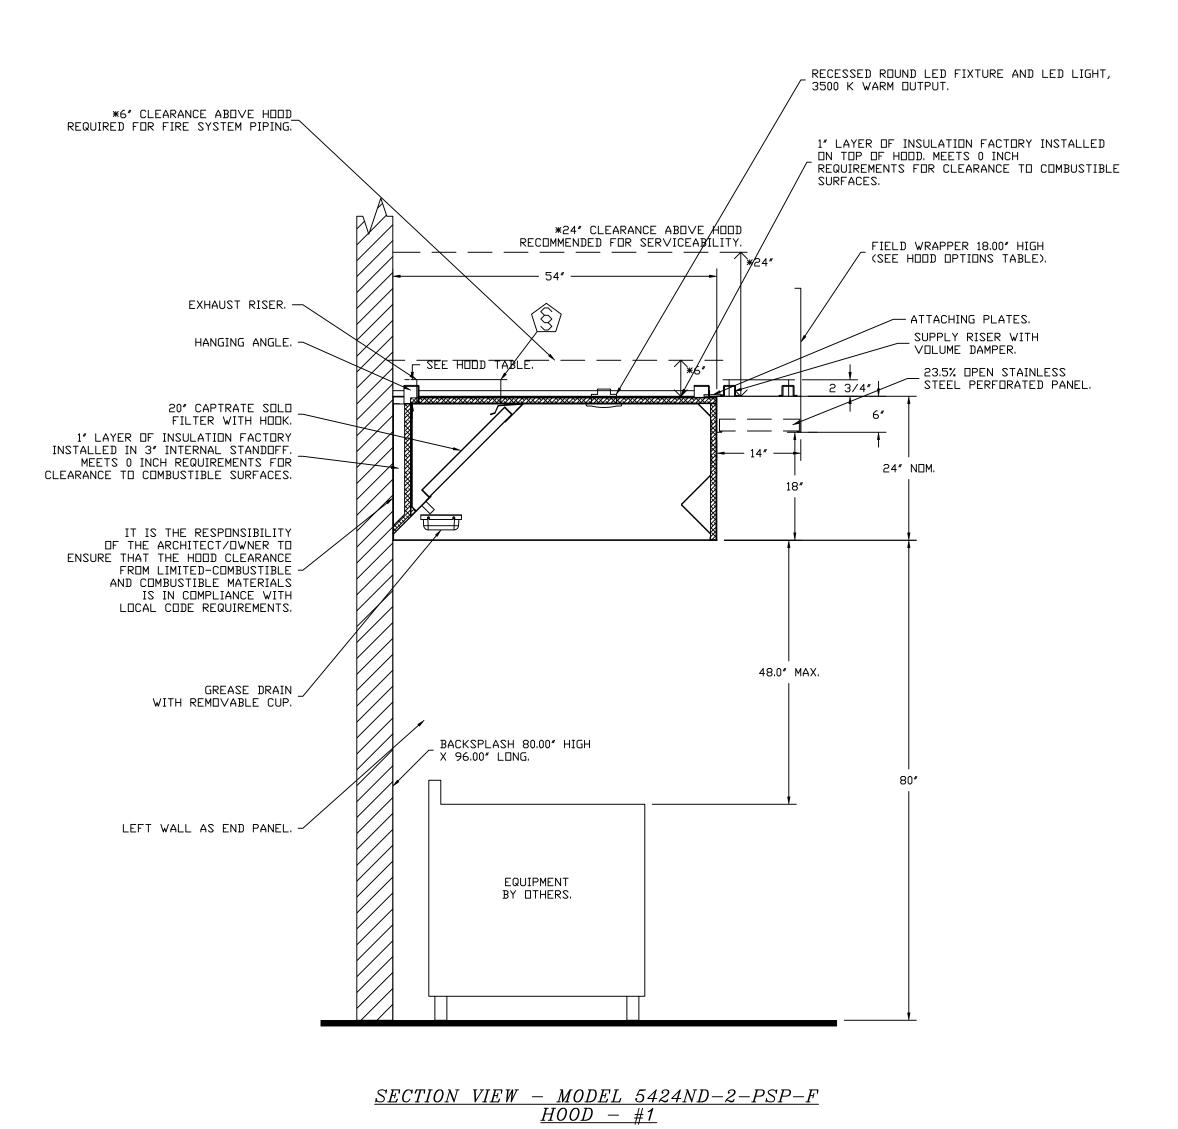

<u>BACKSPLASH</u> NON-COMBUSTIBLE WALL-HEIGHT BACKSPLASH PANELS SLIDE INTO DIVIDER BAR LENGTH - BACKSPLASH IS NOT INSULATED AND IS UNSUITABLE FOR INSTALL AGAINST COMBUSTIBLE WALLS

**REVISIONS** 

 $\sum_{\zeta}$ 27601 200 300 Eas-Raleigh,


**DATE:** 8/25/2025 8190951

DRAWN BY: reg36

**SCALE:** 3/4" = 1'-0"

**MASTER DRAWING** 

EL	<i>ECTRICAL</i>	PACKAGE	- J0B#8190951													
  ND	TAG PAG	PACKAGE #	" LOCATION	SWITCH	HES.	OPTION	FAN	12 CI	CONTROLLED							
				LOCATION	QUANTITY		TYPE	ф	HP	VOLT	FLA					
1		SC-311110MA	WALL MULINIT IN SS DUV	FACE MOUNT RIGHT SIDE OF HOOD	1 LIGHT	SMART CONTROLS THERMOSTATIC CONTROL	EXHAUST	3	3.000	208	9.4					
1	1		SC-311110MA	SC-311110MA	SC-311110MA	SC-311110MA	SC-311110MA	SC-311110MA	WALL MOUNT IN SS BOX	HOOD # 1	1 FAN	W/ RELAY DN/DFF WITH SUPPLY		3	2.000	208

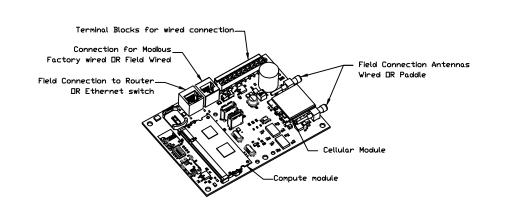



## CASlink Monitor and Control


Hood control panel to support communications to cloud-based Building Management System.
 Hood Control Panel to allow cloud-based Building Management System to monitor real time parameters outlined as MONITOR in the points list.
 Hood Control Panel to allow cloud-based Building Management System to control parameters outlined as CONTROL in the points list.
 Hood Control Panel to allow cloud-based Building Management System to implement SYSTEM ECONOMIZER control strategies for fully integrated Building Management.


#### MONITORING AND CONTROL POINTS LIST

DCV Packages	Function	SC Packages	Function
Room Temperature	MONITOR	Room Temperature(s)	MONITOR
Duct Temperature(s)	MONITOR	Duct Temperature(s)	MONITOR
MUA Discharge Temperature	MONITOR	MUA Discharge Temperature	MONITOR
Kitchen RTU Discharge Temperature	MONITOR	Kitchen RTU Discharge Temperature	MONITOR
Fan Speed	MONITOR	Controller Faults	MONITOR
Fan Amperage	MONITOR	Fan Faults	MONITOR
Fan Power	MONITOR	Fan Status	MONITOR
VFD Faults	MONITOR	PCU Faults	MONITOR
Controller Faults	MONITOR	PCU Filter Clog Percentages	MONITOR
Fan Faults	MONITOR	Fire Condition	MONITOR
Fan Status	MONITOR	CORE Fire System	MONITOR
PCU Faults	MONITOR	Building Pressures	MONITOR
PCU Filter Clog Percentages	MONITOR	Fans Button(s)	MONITOR & CONTROL
Fire Condition	MONITOR	Lights Button(s)	MONITOR & CONTROL
CORE Fire System	MONITOR	Wash Button	MONITOR & CONTROL
Building Pressures	MONITOR		L
Prep Time Button	MONITOR & CONTROL		
Fans Button	MONITOR & CONTROL		
Lighte Button	MONTHOD & GOVERNO		

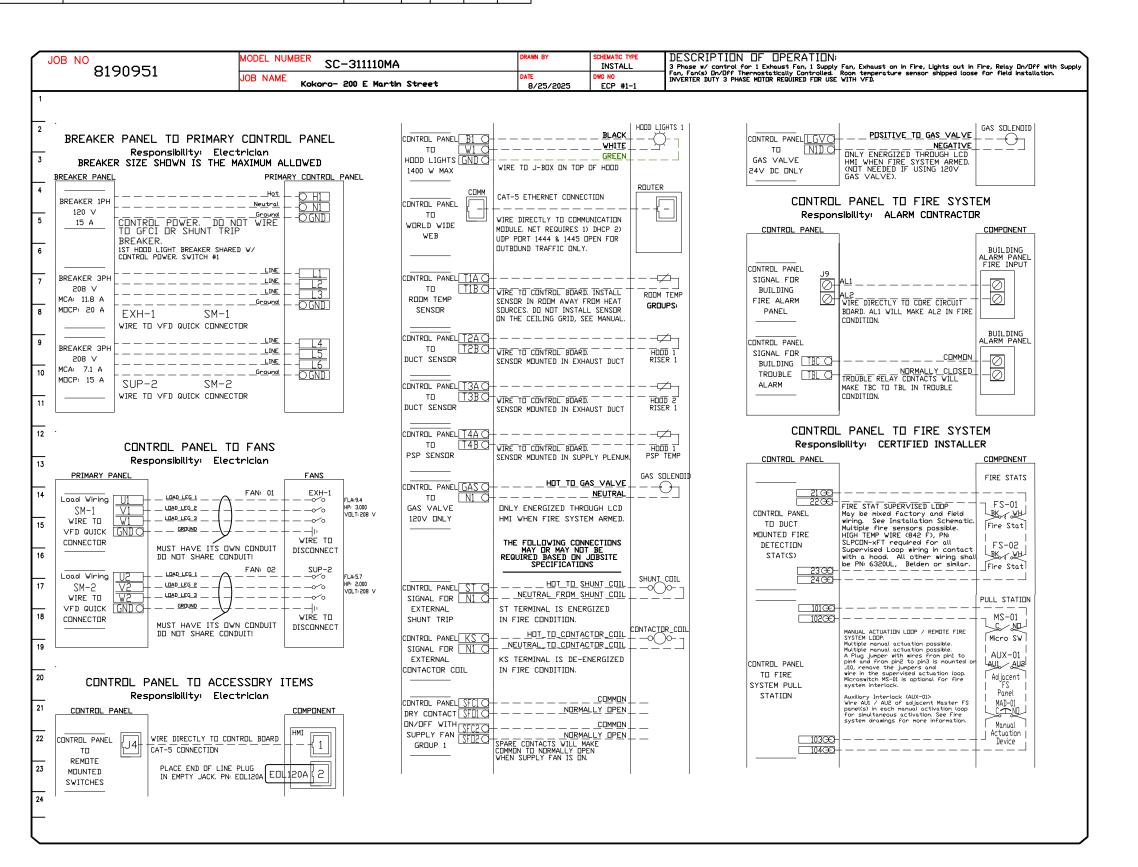

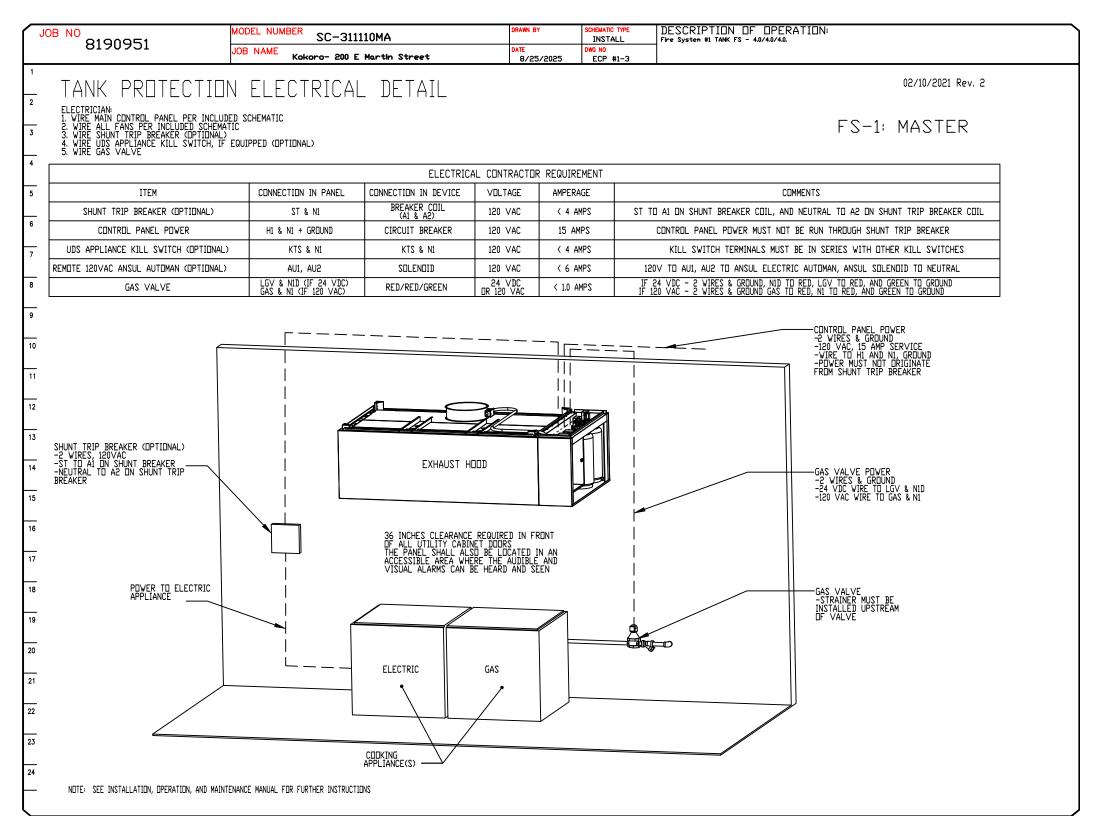

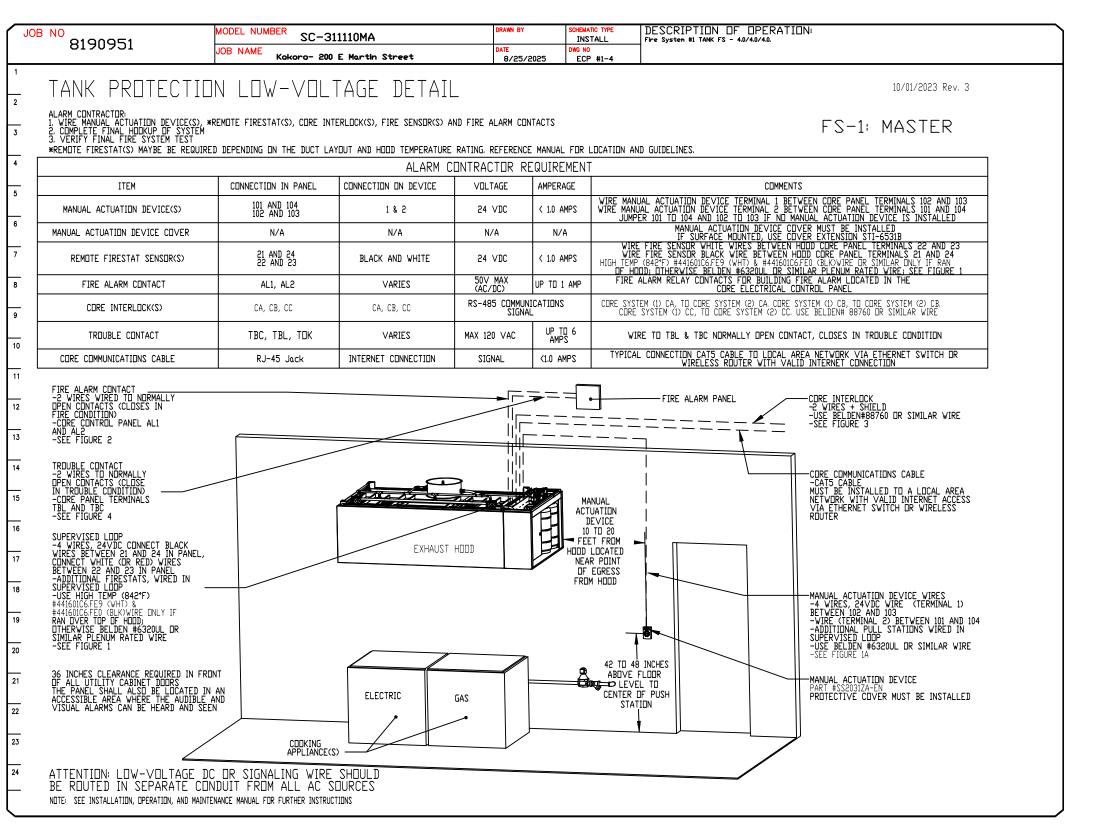

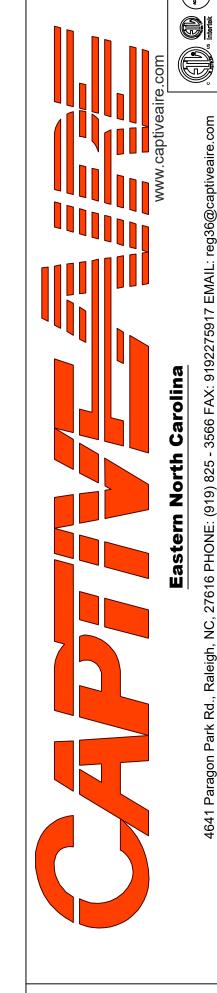

**REVISIONS** 

KOKOPO- 200 E
300 East Mart
Raleigh, NC, 27

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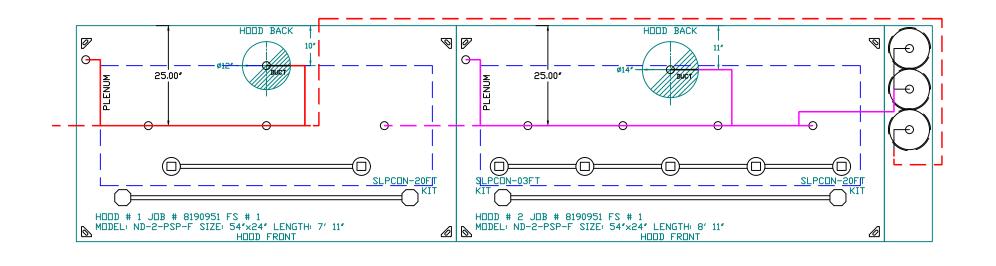
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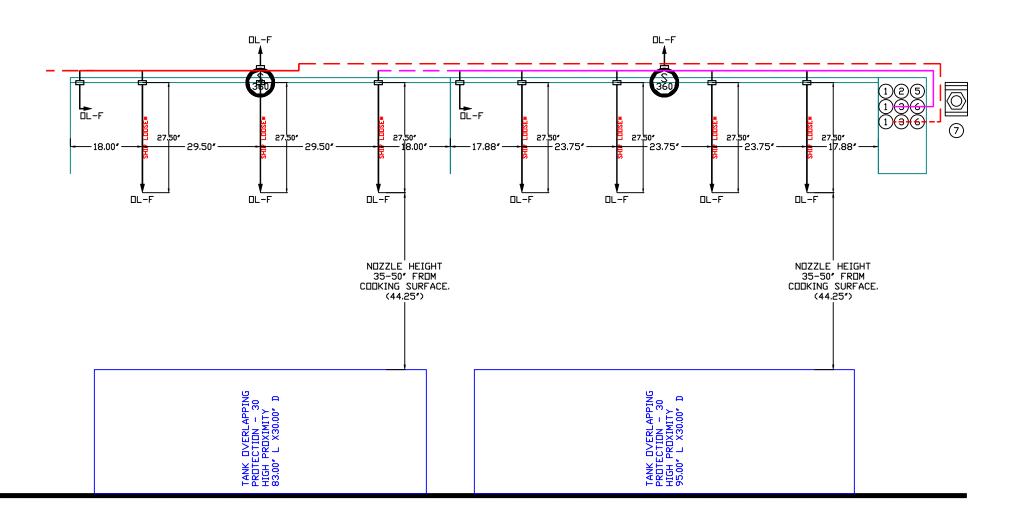
**DWG.#:** 8190951

DRAWN BY: reg36

**SCALE:** 3/4" = 1'-0"

MASTER DRAWING





UL 300 HOOD FIRE SUPPRESSION SYSTEM TANK/CAS ELECTRIC WET CHEMICAL

SEQUENCE OF OPERATIONS
The TANK / CAS-EWC fire system is a self-contained pressurized fire suppression system. TANK / CAS-EWC is activated when the electric firestat contacts close (at determined firestat setting and/or temperature rate-of-rise of 40°F per minute) and/or the manual activation station is pushed, an electric signal is sent to the release solenoid of the fire system. When the release solenoid is opened, it allows stored pressure from the primary tank to travel through the primary actuator kit opening a pneumatic actuator. The pneumatic actuator forces the plunger in the tank valve body to open, allowing the liquid fire suppressant to be distributed throughout the fire system piping network over the protected hazard area.

The TANK / CAS-EWC Fire Suppression System has been tested and certified to the UL 1254 Standard for Pre-Engineered Chemical Extinguishing System Units and UL/ULC 300 Standard for Fire Extinguishing Systems for Protection of Commercial Cooking Equipment and is listed with Underwriters Laboratories (UL) under file number EX3559.

TANK MANUAL ACTIVATION DEVICE DETAIL 1/2" CONDUIT PROVIDED & INSTALLED
BY JOBSITE ELECTRICIAN AND ROUTED BACK
TO ELECTRICAL CONTROL PANEL HOOD FIRE SYSTEM NOTES
- FIELD PIPE DROPS AS SHOWN
PIPING, ELBOWS, TEES, AND NOZZLES SUPPLIED BY CAS.
- FIELD INSTALLED DROP: FACTORY WILL PROVIDE QTY 2 60IN LONG PIECES OF CHROME
PLATED PIPING SHIPPED LOOSE TO BE FIELD-INSTALLED.
- SHIP LOOSE DROP: FACTORY WILL PROVIDE THE EXACT CHROME PIPE LENGTH NEEDED
SHIPPED LOOSE TO BE FIELD-INSTALLED.
- RELOCATE NOZZLES IF FLOW PATTERN IS BLOCKED BY SHELVING,
SALAMANDERS, ETC.
- DVERLAPPING COVERAGE SHALL NOT BE USED ON ANY APPLIANCE WITH AN OBSTRUCTION.
- IF APPLICABLE, EXTENDED PRE-PIPED DROPS ARE SHIPPED LOOSE.
- FACTORY PIPING EXTENDS A MAXIMUM OF 6" ABOVE THE TOP OF THE HOOD. STD SINGLE GANG BOX 2"X4"X2" PROVIDED - & INSTALLED BY JOBSITE ELECTRICIAN AND RECESSED INTO SHEET ROCK 1/4". PUSH MANUAL ACTUATION DEVICE VIRES

- 4 VIRES, 24VDC

- 4 VIRES, 24VDC

- VIRE (TERMINAL 1) BETVEEN 102 AND 103

- VIRE (TERMINAL 2) BETVEEN 101 AND 104

- ADDITIONAL PULL STATIONS VIRED IN

PARALLEL PER SYSTEM SCHEMATICS

- USE BELDEN #6320UL DR SIMILAR VIRE 7-3/8 3-3/16" — 5-3/8' CLEAR PROTECTIVE COVER
MUST BE INSTALLED TO
PROTECT AGAINST
ACCIDENTAL ACTIVATION - APPLIANCE DIMENSIONS LISTED REPRESENT THE COOKING SURFACE SIZE, NOT THE OVERALL APPLIANCE SIZE. MOTE:
MANUAL ACTIVATION DEVICE (MAD) TO BE LOCATED IN THE PATH OF EGRESS,
FREE FROM DBSTRUCTION. COORDINATE LOCATION WITH FIRE SYSTEM CONTRACTOR.

- THIS PRE-ENGINEERED FIRE SYSTEM COMPLIES WITH U.L. 300 REQUIREMENTS.

- DL-F NDZZLE PART NUMBER REPLACES 3070-3/8H-10-SS

JOB #: 8190951. JOB NAME: KOKORO- 200 E MARTIN STREET.

SYSTEM SIZE: TANK-SP-3 DESIGN FP: 51. MAXIMUM FP: 60. HODD # 1 7' 11.00" LONG  $\times$  54" WIDE  $\times$  24" HIGH. RISER # 1 SIZE: 12" DIA. HODD # 1 METAL BLOW-OFF CAPS INCLUDED. HODD # 2 8' 11.00" LONG  $\times$  54" WIDE  $\times$  24" HIGH. RISER # 1 SIZE: 14" DIA. HODD # 2 METAL BLOW-OFF CAPS INCLUDED.

- HEAVY-DUTY APPLIANCES (RATED 600°F) WILL REQUIRE AN ADDITIONAL DOWNSTREAM FIRESTAT IN THE EVENT THAT THE DUCTWORK CONTAINS ANY HORIZONTAL RUNS OVER 25 FT IN LENGTH. - MEDIUM TO LIGHT-DUTY APPLIANCES (RATED 450°F) WILL NOT REQUIRE

ANY ADDITIONAL DOWNSTREAM DETECTION.

AGENT DISTRIBUTION PIPING LIMITATIONS							
PIPE SECTION	MAX PIPE LENGTH (FT)						
MAX SUPPLY LINE TO FIRST OVERLAPPING NOZZLE	42						
OVERLAPPING NOZZLE APPLIANCE BRANCH	10						
DEDICATED NOZZLE APPLIANCE BRANCH	10						

#### <u>LEGEND - FIRE CABINET TANK SYSTEM</u>

4 GALLON TANK.

PRIMARY ACTUATOR RELEASE.

SECONDARY ACTUATOR RELEASE. PRESSURE SUPERVISION SWITCH.

PRIMARY HOSE ASSEMBLY. SECONDARY HOSE ASSEMBLY.

REMOTE MANUAL ACTUATION DEVICE.

FIRE			"	#8190951  NAV. ED. DESIGN INSTALLATION		TION	
SYSTEM NO	TAG	TYPE	SIZE	MAX FP	FP	SYSTEM	LOCATION ON HOOD
1		TANK FS	4.0/4.0/4.0	60	51	FIRE CABINET RIGHT	RIGHT, HOOD 2

**REVISIONS** 

DESCRIPTION DATE:

9  $\bigcirc$ Z eigh d 7 M**DATE:** 8/25/2025

8190951

DRAWN BY: reg36

SCALE: 1/2" = 1'-0"

**MASTER DRAWING** 

EXH	AUST	FAN	INFORMATION - JOB#81	90951												
FAN UNIT ND		QTY	FAN UNIT MODEL #	MANUFACTURER	CFM	ESP	RPM	MOTOR ENCL	HP	BHP	PHASE	VOLT	FLA	DISCHARGE VELOCITY	WEIGHT (LBS)	SONES
1		1	DU200HFA	CAPTIVEAIRE	3723	1.000	1139	TEFC,PREMIUM	3,000	1.5240	3	208	9.4	906 FPM	213	19.9

MUA	FAN	INFO	RMATION - JOB#819095	1		
FAN	TAG	OTY	FAN UNIT MODEL #	RI UWER	HUNZING	MI

71/	021	1 711 1	1111 0	TUMATION OOD#OTOOOO	,															
l	FAN JNIT NO	TAG	QTY	FAN UNIT M□DEL #	BLOWER	HOUSING	MIN CFM	DESIGN CFM	ESP	RPM	MOTOR ENCL	HP	ВНР	PHASE	VOLT	FLA	MCA	МПСР	WEIGHT (LBS)	SONE:
	2		1	A2-20D	20MF-2-MOD	A2	1500	2529	0.700	1110	TEFC,PREMIUM	2.000	0.7360	3	208	5.7	7.2A	15A	503	11.1

FAN	ACCE:	SSORI.	ES				
FAN UNIT	TAG		EXHAUST		PLY		
ND	THU	GREASE CUP	GRAVITY DAMPER	SIDE DISCHARGE	GRAVITY DAMPER	MOTORIZED DAMPER	WAL MDUI
1		YES					


YES


YES

### FAN OPTIONS

$\frac{I'AIV}{}$			
FAN UNIT NO	TAG	QTY	DESCRIPTION
		1	GREASE BOX
		1	UPBLAST FAN WHEEL ACCESS PORT
1		1	FAN BASE CERAMIC SEAL - DU/DR200HFA - SHIP LOOSE - FOR GREASE DUCTS
1		1	HINGE KIT LOCKING (XHD)- SHIPS LOOSE FOR CURB SUPPLIED BY OTHERS
		1	WALL MOUNT CONSTRUCTION 18/20 (D60 ISOLATORS), 70LB MOTOR MAX FOR WALL MOUNTING
		1	2 YEAR PARTS WARRANTY
		1	INSULATION OPTION FOR VBANK FILTER SECTION
٦		1	GRAVITY BACKDRAFT DAMPER FOR SIZE 2 HOUSING
۲		1	A2 INDOOR HANGING OPTION - INCLUDES 2 HSA125 HANGING SPRING ISOLATORS PER UNI-STRUT
		1	2 YEAR PARTS WARRANTY

#### <u>FAN #1 DU200HFA - EXHAUST FAN</u>

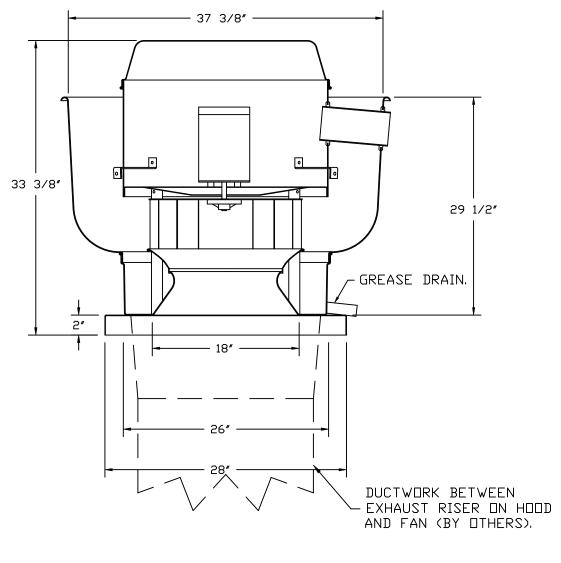

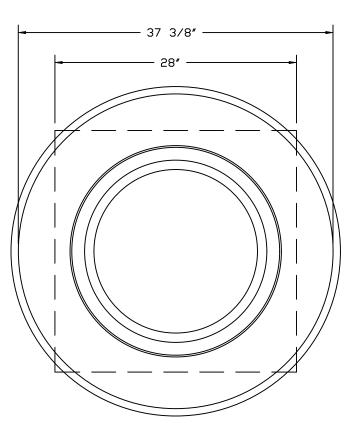

## FEATURES:

- DIRECT DRIVE CONSTRUCTION (NO BELTS/PULLEYS). - ROOF MOUNTED FANS.
- RESTAURANT MODEL.
- UL705 AND UL762 AND ULC-S645
- VARIABLE SPEED CONTROL.
- INTERNAL WIRING. - THERMAL OVERLOAD PROTECTION (SINGLE PHASE).
- HIGH HEAT OPERATION 300°F (149°C).
- GREASE CLASSIFICATION TESTING. - NEMA 3R SAFETY DISCONNECT SWITCH.

## NORMAL TEMPERATURE TEST

EXHAUST FAN MUST OPERATE CONTINUOUSLY WHILE EXHAUSTING AIR AT 300°F (149°C) UNTIL ALL FAN PARTS HAVE REACHED THERMAL EQUILIBRIUM, AND WITHOUT ANY DETERIORATING EFFECTS TO THE FAN WHICH WOULD CAUSE UNSAFE OPERATION.

# ABNORMAL FLARE-UP TEST

EXHAUST FAN MUST OPERATE CONTINUOUSLY WHILE EXHAUSTING BURNING GREASE VAPORS AT 600°F (316°C) FOR A PERIOD OF 15 MINUTES WITHOUT THE FAN BECOMING DAMAGED TO ANY EXTENT THAT COULD CAUSE AN UNSAFE CONDITION.

## <u>OPTIONS</u>

- GREASE BOX.
   UPBLAST FAN WHEEL ACCESS PORT.
   FAN BASE CERAMIC SEAL DU/DR200HFA SHIP LOOSE FOR
  GREASE DUCTS.
   HINGE KIT LOCKING (XHD)- SHIPS
  LOOSE FOR CURB SUPPLIED BY OTHERS.
   WALL MOUNT CONSTRUCTION 18/20 (D60
  ISOLATORS), 70LB MOTOR MAX FOR WALL
  MOUNTING.
- MDUNTING.
   2 YEAR PARTS WARRANTY.



**REVISIONS** DESCRIPTION DATE:

 $\mathbb{X}$ 27601 200 300 Eas-Raleigh,

**DATE:** 8/25/2025


8190951 DRAWN BY: reg36

**SCALE:** 3/4" = 1'-0"

**MASTER DRAWING** 

FAN #2 A2-20D - SUPPLY FAN 1. UNTEMPERED SUPPLY UNIT WITH 20" MIXED FLOW DIRECT DRIVE FAN IN SIZE #2 HOUSING.
2. V-BANK EZ FILTERS - INDOOR.
3. SIDE DISCHARGE - AIR FLOW RIGHT -> LEFT.
4. "INSULATION" FOR V-BANK INTAKE OPTION.
5. GRAVITY BACK DRAFT DAMPER 22" X 24", STANDARD GALVANIZED CONSTRUCTION, 1 1/4" REAR FLANGE, FOR SIZE 2 UNTEMPERED FAN HOUSING (5182). 6. INDOOR HANGING CRADLE FOR THE SIZE 2 UNTEMPERED UNIT. 2 HSA125 HANGING ISOLATORS PER UNI-STRUT INCLUDED.
7. HINGED DOUBLE WALL INSULATED DOOR ASSEMBLY (BURNER/BLOWER SECTION). 8. 2 YEAR PARTS WARRANTY. \*NOTE: SUPPLY DUCT MUST BE INSTALLED TO MEET SMACNA STANDARDS. A MINIMUM STRAIGHT DUCT LENGTH MUST BE MAINTAINED DOWNSTREAM OF UNIT DISCHARGE AS OUTLINED IN AMCA PUBLICATION 201. WHEN USING RECTANGULAR DUCTWORK, ELBOWS MUST BE RADIUS THROAT, RADIUS BACK WITH TURNING VANES. FLEXIBLE DUCTWORK AND SQUARE THROAT/SQUARE BACK ELBOWS SHOULD NOT BE USED. ANY TRANSITION AND/OR TURNS IN THE DUCTWORK WILL CAUSE SYSTEM EFFECT. SYSTEM EFFECT WILL DRASTICALLY INCREASE STATIC PRESSURE AND REDUCE AIRFLOW. DO NOT RELY ON UNIT TO SUPPORT DUCT IN ANY WAY, FAILURE TO PROPERLY SIZE DUCTWORK MAY CAUSE SYSTEM EFFECTS AND REDUCE PERFORMANCE OF THE EQUIPMENT. SUGGESTED STRAIGHT DUCT SIZE IS 26" x 26". BASE RAIL \_ INNER DIMENSION. AIRFLOW. V-BANK FILTER MDDULE. FLEX CONDUIT\_/ FOR FIELD WIRING. MINIMUM \_ STRAIGHT -DUCT PER AMCA\* LIFT<u>ing</u> Lug.— AIRFLOW. MIN. 26" FILTER ACCESS SERVICE DISCONNECT SWITCH. 36 3/4" DOOR. BLOWER/MOTOR ACCESS DOOR 24″ SERVICE CLEARANCE REQ. 10 15/16" 3 3/4"

\_ UNI-STRUT BASE FOR HANGING

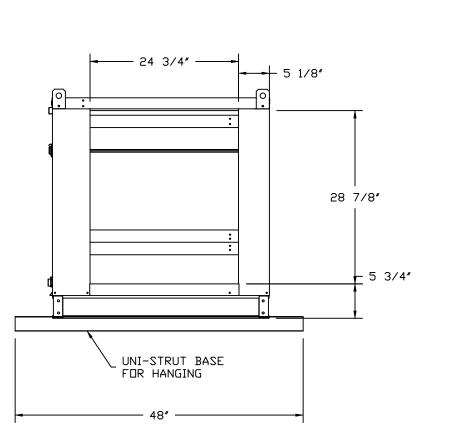

**REVISIONS** DESCRIPTION DATE:

+  $\mathbb{A}$ 27601 200 300 Eas Raleigh,

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