Preliminary Subdivision Plan Application 5-64-18 Pineland

neland DEVELOPMENT SERVICES DEPARTMENT

Development Services Customer Service Center | 1 Exchange Plaza, Suite 400 | Raleigh, NC 27601 | 919-996-2495 | efax 919-996-1831 Litchford Satellite Office | 8320 – 130 Litchford Road | Raleigh, NC 27601 | 919-996-4200

When submitting plans, please check the appropriate review type and include the Plan Checklist document.

Office Use Only: Transaction # 575422 Project Coordinator Na Tosha Team Leader Watters						
PRELIMINARY APPROVALS						
		al Subdivision uncil approval if in a M	Compact Development etro Park Overlay or Historic O	Conservative Subdivision		
If your project has been through t	the Due Dil	igence process, provid	e the transaction #: n/a			
		GENERAL IN	FORMATION			
Development Name Pinelan	d Town	homes		17.00 V 1 1000 Million V 2000 Millio		
Proposed Use Townhome:	s					
Property Address(es) 105 Pine Raleigh,						
Wake County Property Identification Number(s) for each parcel to which these guidelines will apply:						
PIN Recorded Deed 0784610694	PIN Record	ded Deed	PIN Recorded Deed	PIN Recorded Deed		
What is your project type?			············	- 1		
☐ Single family ☐ Townhouse ☐ Subdivision in a non-residential zoning district ☐ Other (describe):						
OWNER/DEVELOPER INFORMATION						
Company Name KR Property Group, LLC			Owner/Developer Name Kassiem Carter			
Address 4242 Six Fork Road, Suite 1550 Raleigh, NC 27609						
Phone 919-578-9058 Email kc@krpropertygroup.com Fax n/a						
	CON	ISULTANT/CONTAC	CT PERSON FOR PLANS			
Company Name Site Collaborative Contact Name Emily Rothrock, PLA						
Address 727 West Hargett St, Suite 101 Raleigh, NC 27603						
Phone 919-805-3586 Email emily@sitecollaborative.com Fax n/a						


DEVELOPMENT TYPE AND SITE DATE TABLE (Applicable to all developments)							
ZONING INFORMATION							
Zoning District(s) R-10							
If more than one district, provide the acreage of each:							
Overlay District? Yes No							
Inside City Limits? 🔳 Yes 🗌 No							
CUD (Conditional Use District) Case # Z- n/a							
COA (Certificate of Appropriateness) Case # n/a							
BOA (Board of Adjustment) Case # A- n/a							
STORMWATER	INFORMATION						
Existing Impervious Surface .17ac/7,489sf acres/sf	Flood Hazard Area] Yes	■ No				
Proposed Impervious Surface . 19ac/8,237sf acres/sf	Neuse River Buffer	Yes	■ No				
	Wetlands [Yes	■ No				
If in a Flood Hazard Area, provide the following:							
Alluvial Soils n/a Flood Study n/a	FEMA Map Panel	# n/a					
NUMBER OF LO	IS AND DENSITY						
Total # of Townhouse Lots: Detached 0	Attached 4						
Total # of Single Family Lots () Total # of All Lots 4							
Overall Unit(s)/Acre Densities Per Zoning Districts 8.8 units/a	cre						
Total # of Open Space and/or Common Area Lots n/a							
SIGNATURE BLOCK (Appli	SIGNATURE BLOCK (Applicable to all developments)						
In filing this plan as the property owner(s), I/we do hereby agree and firmly bind ourselves, my/our heirs, executors, administrators, successors and assigns jointly and severally to construct all improvements and make all dedications as shown on this proposed subdivision plan as approved by the City. I hereby designate Emily Rothrock to serve as my agent regarding this application, to receive and respond to administrative comments, to resubmit plans on my behalf, and to represent me in any public meeting regarding this application. I/we have read, acknowledge, and affirm that this project is conforming to all application requirements applicable with the proposed development use. Signature Date							
Signature Date							

GENERAL REQUIREMENTS	TO BE COMPLETED BY APPLICANT		OFFICE USE ONLY		
	YES	N/A	YES	NO	N/A
Applicant must contact a Planner to determine if a Pre-Application Conference is required prior to application submittal	x				
2. Filing fee for plan review – payments may be made by cash, Visa, Mastercard, or check made payable to the City of Raleigh (no fee for infill recombination)	X				
3. Preliminary Subdivision Plan Application must be completed and signed by the property owner	×				
4. Applicant must complete and print page 1 and 2 of the Preliminary Subdivision Plan Application to the plan cover sheet (not applicable for infill recombination)	х				
5. I have referenced the Preliminary Subdivision Plan Checklist, and by using this as a guide, it will ensure that I receive a complete and thorough first review by the City	×				
6. Provide the following plan sheets:	x				
a) Cover sheet, to include general notes, owner's name, contact's name, phone number, mailing address, email address	×		<u></u>		
b) Existing conditions sheet	x		1		
c) Proposed Subdivision Plan	X				
d) Proposed Grading and Stormwater Plan	×				
e) Proposed Utility Plan, including Fire	x		W		
f) Proposed Tree Conservation Plan		x			\\\\\\\\\\\\\\\\\\\\\\\\\\\\\\\\\\\\\\
g) Proposed Landscaping	х				
h) Transportation Plan		х			-
7. Ten (10) sets of proposed plans to engineering scale (1"=20', 1"=100', etc.) and date of preparation. For re-submittals only, include all revision dates.	×				
8. Plan size must be 18" x 24" or 24" x 36"	х				
9. A vicinity map no smaller/less than 1"=500' and no larger than 1"=1000' to the inch, showing the position of the subdivision with its relation to surrounding streets and properties, and oriented in the same direction as the preliminary plan	х		/		
10. Include sheet index and legend defining all symbols with true north arrow, with north being at the top of the map	×		/		
11. Digital copy of only the plan and elevations – label the CD with the plan name, case file number, and indicate how many times the plan has been resubmitted for review	X		~		
12. Wake County School form, if dwelling units are proposed	×				
13. Preliminary stormwater quantity and quality summary and calculations package	X				
14. For secondary tree conservation areas, include two (2) copies of the tree cover report completed by a certified arborist, North Carolina licensed landscape architect, or North Carolina registered forester		x			

PINELAND TOWNHOMES

PRELIMINARY SUBDIVISION PLAN

CITY OF RALEIGH TRANSACTION #: 575422 / S-64-18

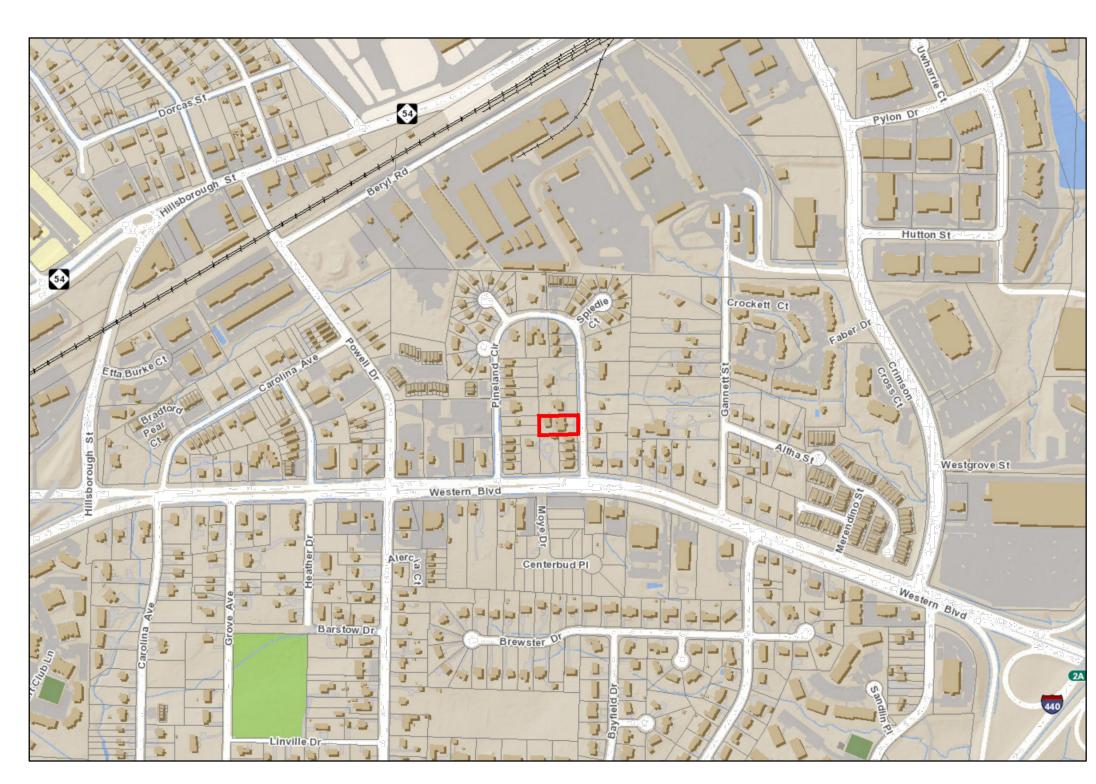

VICINITY MAP

SCALE: 1" =500'

STORMWATER EXEMPTION

1. THIS PROJECT QUALIFIES FOR A STORMWATER EXEMPTION. PER CITY OF RALEIGH UDO SECTION 9.2.2.E.2.b, THE STORMWATER RUNOFF CONTROL REQUIREMENTS DO NOT APPLY IF 'THE INCREASE IN PEAK STORMWATER RUNOFF BETWEEN PRE-DEVELOPMENT AND POST-DEVELOPMENT CONDITIONS FOR THE TWO-YEAR AND TEN-YEAR AND 25-YEAR STORMS IS 10% OR LESS AT EACH POINT OF DISCHARGE. A STORMWATER REPORT HAS BEEN INCLUDED TO PROVIDE NECESSARY CALCULATIONS FOR THIS EXEMPTION QUALIFICATION.

SHEET INDEX				
COV	COVER SHEET			
L100	EXISTING CONDITIONS PLAN			
L200	SUBDIVISION PLAN			
L300	PRELIMINARY GRADING PLAN			
L400	PLANTING PLAN			
L401	PLANTING NOTES & DETAILS			
C500	STORM DRAIN PLAN			
C700	SITE UTILITY PLAN			
A201	BUILDING ELEVATIONS			
A202	BUILDING ELEVATIONS			

Preliminar Plan Appli		livision		The state of the s	DEVELOPMEN SERVICES DEPARTMENT
-			change Plaza, Suite 400 Raleigh, 130 Litchford Road Raleigh, NC 27		·
When submittin	g plans, please	check the appropi	riate review type and includ	le the Plan (Checklist document.
Office Use Only: Transaction #		Project Coc	ordinator	Team	Leader
		PRELIMIN	IARY APPROVALS		
Subdivision *	Convention	al Subdivision	Compact Developr	ment	Conservative Subdivision
*May	require City Co	uncil approval if in	a Metro Park Overlay or Hi	storic Overl	lay District
If your project has been thro	ugh the Due Di	igence process, pr	ovide the transaction #:	n/a	
		GENERA	L INFORMATION		
Development Name Pine	land Towr	homes			
Proposed Use Townho	mes				
	Pineland Circ gh, NC 2760				
Wake County Property Ident	fication Numb	er(s) for each parce	el to which these guidelines	will apply:	
PIN Recorded Deed 0784610694	PIN Recor	ded Deed	PIN Recorded Deed		PIN Recorded Deed
What is your project type?			-		
Single family	■ Townhouse	Subdivis	sion in a non-residential zon	ing district	
Other (describe):					
		OWNER/DEVE	LOPER INFORMATION		
Company Name KR Prop	perty Grou	p, LLC	Owner/Developer Na	me Kass	siem Carter
Address 4242 Six For	k Road, Su	uite 1550 Ra	aleigh, NC 27609		
Phone 919-578-9058		Email kc@krp	oropertygroup.com	Fax n/a	
	CON	ISULTANT/CON	NTACT PERSON FOR PL	ANS	
Company Name Site Col	laborative		Contact Name Emi	ly Rothr	ock, PLA
Address 727 West Ha	rgett St, S	uite 101 Ral	leigh, NC 27603		
Phone 919-805-3586		Email emily@s	sitecollaborative.com	Fax n/a	

ZONING II	NFORMATION
Zoning District(s), R-10, SRPOD	- 11 - 12 - 12 - 12 - 12 - 12 - 12 - 12
If more than one district, provide the acreage of each:	
Overlay District? Yes No	
Inside City Limits? Yes No	
CUD (Conditional Use District) Case # Z- n/a	
COA (Certificate of Appropriateness) Case # n/a	14
BOA (Board of Adjustment) Case # A- n/a	
STORMWATE	RINFORMATION
Existing Impervious Surface 17ac/7,489sf acres/sf	Flood Hazard Area
Proposed Impervious Surface . 19ac/8,237 acres/sf	Neuse River Buffer
	Wetlands Yes No
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Alluvial Soils n/a	FEMA Map Panel # n/a
NUMBER OF L	OTS AND DENSITY
Total # of Townhouse Lots: Detached 0	
Total # of Single Family Lots O	Total # of All Lots 4
Overall Unit(s)/Acre Densities Per Zoning Districts 8.8 units/	
Total # of Open Space and/or Common Area Lots n/a	~~~~~~~~~~~~~~~~~~~~~~~~~~~~~~~~~~~~~~
SIGNATURE BLOCK (App	licable to all developments)
In filing this plan as the property owner(s), I/we do hereby agree successors and assigns jointly and severally to construct all impresubdivision plan as approved by the City.	e and firmly bind ourselves, my/our heirs, executors, administrators, ovements and make all dedications as shown on this proposed
	ny agent regarding this application, to receive and respond to orepresent me in any public meeting regarding this application.
I/we have read, acknowledge, and affirm that this project is condevelopment use.	forming to all application requirements applicable with the proposed

GENERAL SITE NOTES

- 1. ALL CONSTRUCTION IN RIGHT-OF-WAY PER CITY OF RALEIGH STANDARD.
- SIDEWALKS ALONG RIGHT-OF-WAY ARE PUBLIC AND MUST BE ACCESSIBLE TO PERSONS WHO ARE BLIND, HAVE LOW VISION AND PEOPLE WITH MOBILITY DISABILITIES. EXISTING PEDESTRIAN ROUTES AND ALTERNATE PEDESTRIAN ROUTES DURING CONSTRUCTION ARE REQUIRED TO BE COMPLIANT WITH THE PUBLIC RIGHTS OF WAY ACCESSIBILITY GUIDELINES (PROWAG), 2010 ADA STANDARDS FOR ACCESSIBLE DESIGN AND THE MANUAL ON UNIFORM TRAFFIC CONTROL DEVICES (MUTCD).
- 3. ALL PAVEMENTS TO SLOPE POSITIVELY AWAY FROM ALL BUILDINGS.PONDING OF WATER IS PROHIBITED.
- 4. PROVIDE CONSTRUCTION JOINTS IN CONCRETE WALKWAYS AS SHOWN IN PLANS. IF NOT SHOWN ON PLANS MAX SPACING @ 10'
- THROUGHOUT PROJECT SITE, ALL DIMENSIONS TO BE FIELD VERIFIED. NOTIFY THE LANDSCAPE ARCHITECT OF AN DISCREPANCY. ALL DIMENSIONS ARE TO OUTSIDE FACE OF BUILDING, TO CENTERLINE, CENTER TO CENTER ON STRIPES, AND/OR FACE OF CURB, UNLESS OTHERWISE NOTED.
- 6. BUILDING AND PUBLIC ROADWAY STAKE OUT SHALL BE PERFORMED BY A REGISTERED LAND SURVEY
- GUARDRAILS MUST BE INSTALLED ON THE OPEN SIDES OF ELEVATED WALKING SURFACES THAT EXCEED 30 INCHES IN HEIGHT. ALL GUARDRAILS MUST BE A MINIMUM HEIGHT OF 42 INCHES ABOVE THE LEADING EDGE OF THE TREAD OR WALKING SURFACE. GUARDRAILS SHALL HAVE BALUSTERS SUCH THAT A 4 INCH DIAMETER SPHERE CANNOT PASS THROUGH ANY OPENING UP TO A HEIGHT OF 34 INCHES. FROM 34 INCHES TO 42 INCHES ABOVE THE WALKING SURFACE A 8 INCH DIAMETER SPHERE SHALL NOT PASS.
- 8. THE CONTRACTOR, AT ALL TIMES, MUST KEEP THE PREMISES FREE FROM ACCUMULATIONS OF WASTE MATERIALS OR RUBBISH CAUSED BY THE CONTRACTOR, THE CONTRACTOR'S EMPLOYEES OR THE CONTRACTOR'S SUBCONTRACTOR. ALL DEBRIS SHALL BE REMOVED FROM THE PROJECT SITE ON A DAILY BASIS.
- IF DEPARTURES FROM THE DRAWINGS OR SPECIFICATIONS ARE DEEMED NECESSARY BY THE CONTRACTOR, DETAILS OF SUCH DEPARTURES FROM THE CONTRACT DOCUMENTS SHALL BE MADE WITH THE EXPRESS WRITTEN PERMISSION OF THE OWNER.
- 10. LANDSCAPE ARCHITECT AND/OR OWNER DISCLAIM ANY ROLE IN THE CONSTRUCTION MEANS AND/OR METHODS ASSOCIATED WITH THE PROJECT AS SET FORTH IN THESE PLANS.
- 11. EXISTING UTILITIES AND STRUCTURES SHOWN, BOTH UNDERGROUND AND ABOVE, ARE BASED ON A FIELD DATA PROVIDED TO LANDSCAPE ARCHITECT. THE CONTRACTOR SHALL LOCATE EXISTING UTILITIES, UNDERGROUND LINES, AND STRUCTURES AS NECESSARY TO AVOID DAMAGING OR DESTROYING EXISTING SERVICES.
- 12. THE CONTRACTOR IS RESPONSIBLE FOR FIELD VERIFYING THE ACTUAL AND EXACT LOCATION, SIZE, AND MATERIAL COMPOSITION OF ANY EXISTING WATER OR SEWER SERVICE PROPOSED FOR CONNECTION OR USE ON THIS PROJECT THE RELOCATION OF ANY UTILITY SERVICES REQUIRED TO COMPLETE ANY PORTION OF THESE CONSTRUCTION PLANS
- 13. CONTRACTOR SHALL MAINTAIN AN "AS BUILT" SET OF DRAWINGS TO RECORD ANY FIELD CHANGES, ALONG WITH ANY
- 14. THE CONTRACTOR IS RESPONSIBLE FOR OBTAINING ALL REQUIRED PERMITS. ALL CONSTRUCTION SHALL BE IN
- 15. EXISTING IMPROVEMENTS DAMAGED OR DESTROYED DURING CONSTRUCTION SHALL BE REPLACED OR RESTORED TO THEIR ORIGINAL CONDITION, AND TO THE SATISFACTION OF THE OWNER OF THE IMPROVEMENTS.
- 16. THE CONTRACTOR SHALL OBTAIN AND PAY FOR ALL INSPECTIONS, CERTIFICATIONS, AND/OR ANY OTHER REQUIREMENTS
- WHICH MUST BE MET UNDER CONTRACT.
- 17. CONTRACTOR SHALL REFER TO ARCHITECTURAL PLANS FOR DETAILS OF BUILDINGS AND BUILDING DIMENSIONS.
- 18. CONTRACTOR SHALL COORDINATE CONSTRUCTION OF ALL UNDERGROUND UTILITIES FOR THIS PROJECT WITH THE OWNER'S REPRESENTATIVE PER ALL APPLICABLE REGULATIONS.
- 19. CONTRACTOR SHALL COORDINATE WITH OTHER CONTRACTOR'S ON SITE AND UTILITY PROVIDERS DURING CONSTRUCTION TO ENSURE SMOOTH TRANSITION BETWEEN DISCIPLINES.
- 20. ALL DEMOLITION, AND ANY SUBSEQUENT CONSTRUCTION, SHALL BE PERFORMED IN ACCORDANCE WITH THESE PLANS AND SPECIFICATIONS SET FORTH AND APPROVED BY THE CITY OF RALEIGH. THE CONTRACTOR IS RESPONSIBLE FOR OBTAINING ALL REQUIRED PERMITS. ALL TREE PROTECTION FENCING SHALL REMAIN IN PLACE DURING CONSTRUCTION.
- 21. TRAFFIC CONTROLS FOR ANY UTILITY WORK WITHIN THE PUBLIC RIGHT OF WAY SHALL BE PERFORMED IN COMPLIANCE WITH STANDARDS OF THE NORTH CAROLINA MANUAL ON UNIFORM TRAFFIC CONTROL DEVICES (MUTCD).
- 22. ALL CROSSWALK MARKINGS WITHIN RIGHT-OF-WAY SHALL BE CONSTRUCTED OF THERMOPLASTIC MATERIALS AND CONSTRUCTED IN ACCORDANCE WITH NCDOT SPECIFICATIONS. CONTRACTOR TO INSTALL CROSSWALKS IN SUCH A MANNER THAT CROSSWALKS ARE ALIGNED BETWEEN HANDICAP/WALKWAY ACCESS POINTS OR PERPENDICULAR TO THE
- 23. ALL SIGNS AND PAVEMENT MARKINGS ARE TO MEET MUTCD (MANUAL ON UNIFORM TRAFFIC CONTROL DEVICES) AND NCDOT STANDARDS.
- 24. ALL SIGNS SHALL USE PRISMATIC SHEETING THAT MEETS MINIMUM RETROREFLECTIVITY STANDARDS FOUND IN THE

CONTACT INFORMATION

PROPERTY OWNER / CLIENT
KR PROPERTY GROUP, LLC
4242 SIX FORK ROAD, SUITE 1550
RALEIGH, NC 27609

CONTACT: KASSIEM CARTER PHONE: 919.578.9058

EMAIL: KC@KRPROPERTYGROUP.COM

LANDSCAPE ARCHITECT
SITE COLLABORATIVE, INC.
727 W. HARGETT STREET, SUITE 101
RALEIGH, NC 27603
CONTACT: GRAHAM H. SMITH
PHONE: 919.805.3586

EMAIL: GRAHAM@SITECOLLABORATIVE.COM

ARCHITECT
OSTERLUND ARCHITECTS, PLLC
5 W HARGETT STREET 502
RALEIGH, NC 27601
CONTACT: ANDREW OSTERLUND

PHONE: 919.838.9337
EMAIL: ANDY@AOARCHITECT.COM

DATE: 11.01.2018 REV #1 - 11.30.2018 ---

PRELIMINARY

SUBDIVISION PLAN

9 R

PROJECT NUMBER: 18073

SHEET TITLE:

COVER


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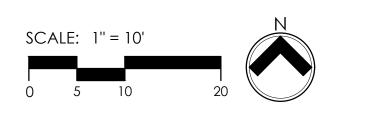
COV




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)MES PINELAND 1 105 PINELAND (KR PROPERTY (

PROJECT NUMBER: 18073

PROJECT PHASE:
PRELIMINARY
SUBDIVISION PLAN

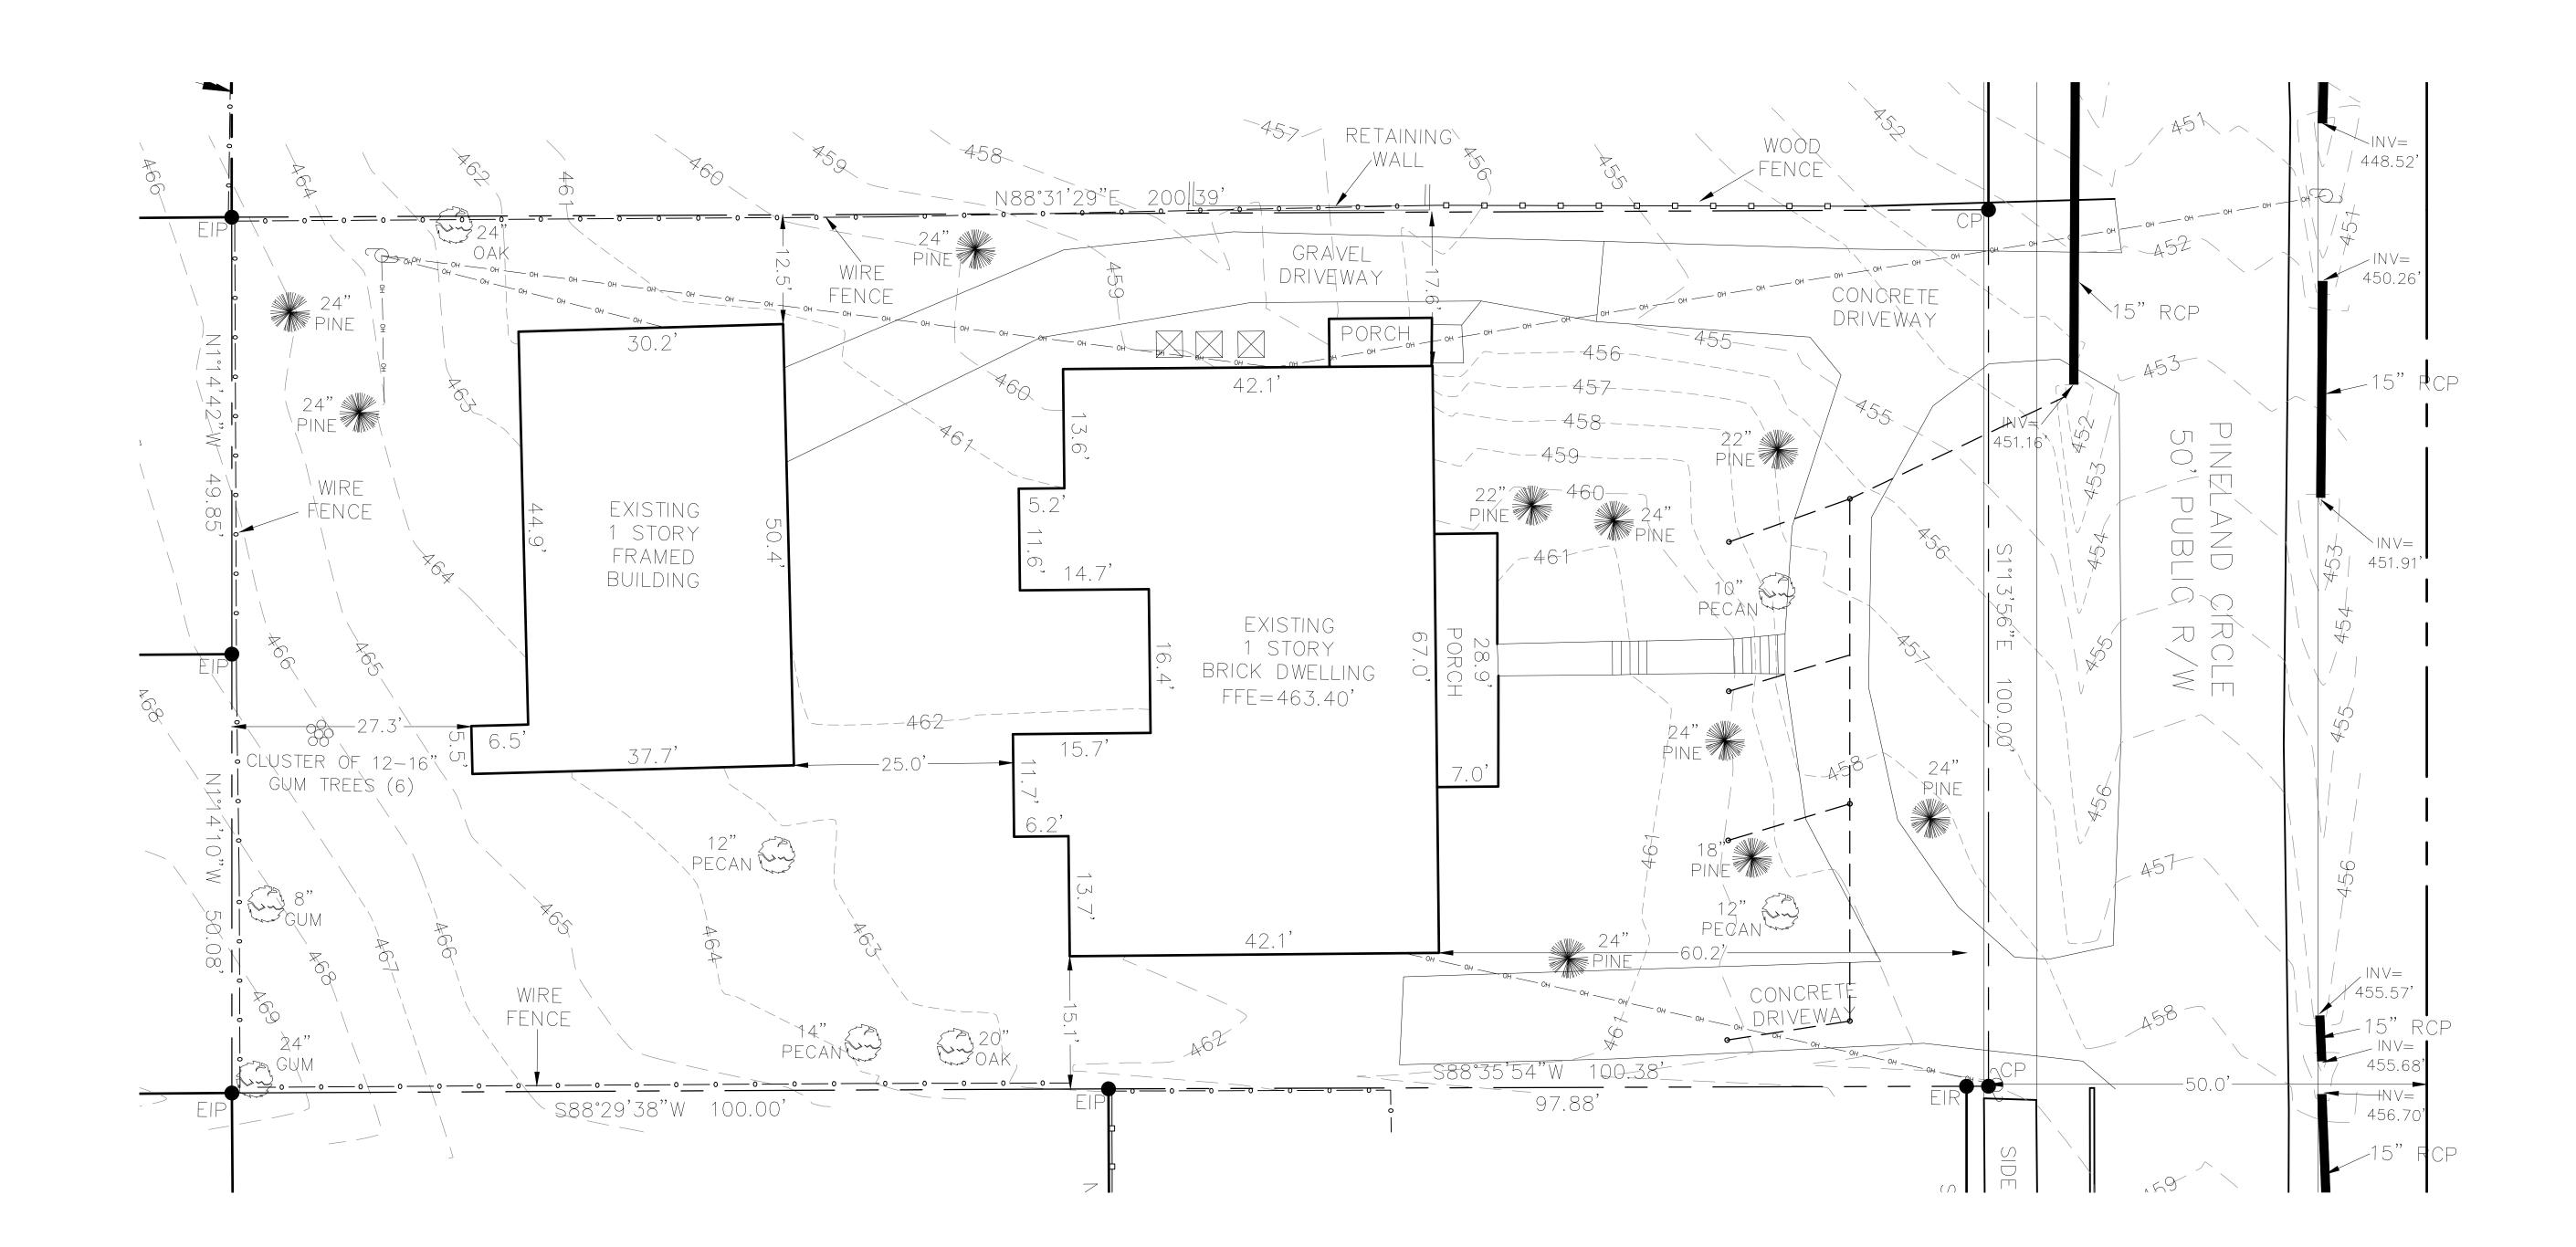11.01.2018

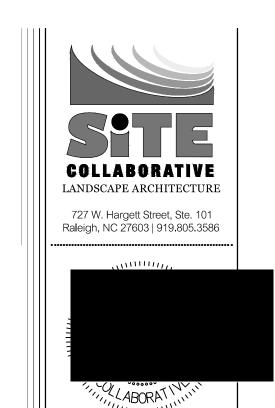REV #1 - 11.30.2018

EXISTING CONDITIONS

SHEET NUMBER:

L100

	SITE LEGEND		
KEY	DESCRIPTION		
1A	CONCRETE APRON PER CITY OF RALEIGH STANDARDS		
1B	6" CONCRETE		
1C	4" CONCRETE		
1D	PERMEABLE DECK SURFACE		
2A	SCREENING FENCE		
2B	SITE PERIMETER FENCE		
3A	HVAC UNIT		
4A	TURF STRIP		
4B	PLANT BED		
5A	LOW RETAINING WALL AS REQUIRED FOR GRADING		
6A	STREET FACING ENTRANCE OF BUILDING - SEE ELEVATIONS		
 	ACCESSIBLE ROUTE		

AMENITY AREA REQUIREMENTS						
ZONING	SITE AREA (SF)	PERCENT (%)	REQUIRED (SF)	PROPOSED (SF)		
R-10 SRPOD	19,780	10	1978	2,160		

SITE NOTES:

DENSITY CALCULATIONS REQUIRED - 10 U/A MAX. PROVIDED - 8 U/A


PARKING CALCULATIONS REQUIRED - 12 RESIDENT SPACES & 1 VISITOR SPACE: 13 TOTAL PROVIDED - 4 GARAGE SPACES / 1 PER UNIT - 2 ON SITE SPACES / 1 RESIDENT & 1 VISITOR - 6 EXISTING TREES OVER 12" CAL. WILL BE PRESERVED ON SITE &


ACCOUNT FOR 6 REQUIRED SPACES PER UDO SECTION 7.1.4.E.1 - A 10% REDUCTION (1 SPACE) PER UDO SECTION 7.1.4.A.1

BUILD TO CALCULATIONS REQUIRED - 10' MINIMUM / 55' MAXIMUM PROVIDED - 27'-6" - SEE PLANS REQUIRED - BUILDING WIDTH IN PRIMARY BUILD TO 70% / 70' PROVIDED - BUILDING WIDTH IN PRIMARY BUILD TO 77% / 76'-6" INFILL CALCULATIONS SEE DIAGRAM THIS SHEET

BLOCK PERIMETER CALCULATIONS REQUIRED - 2,500 L.F. MAXIMUM PROVIDED - 596 L.F.

INFILL DIAGRAM

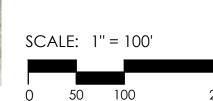

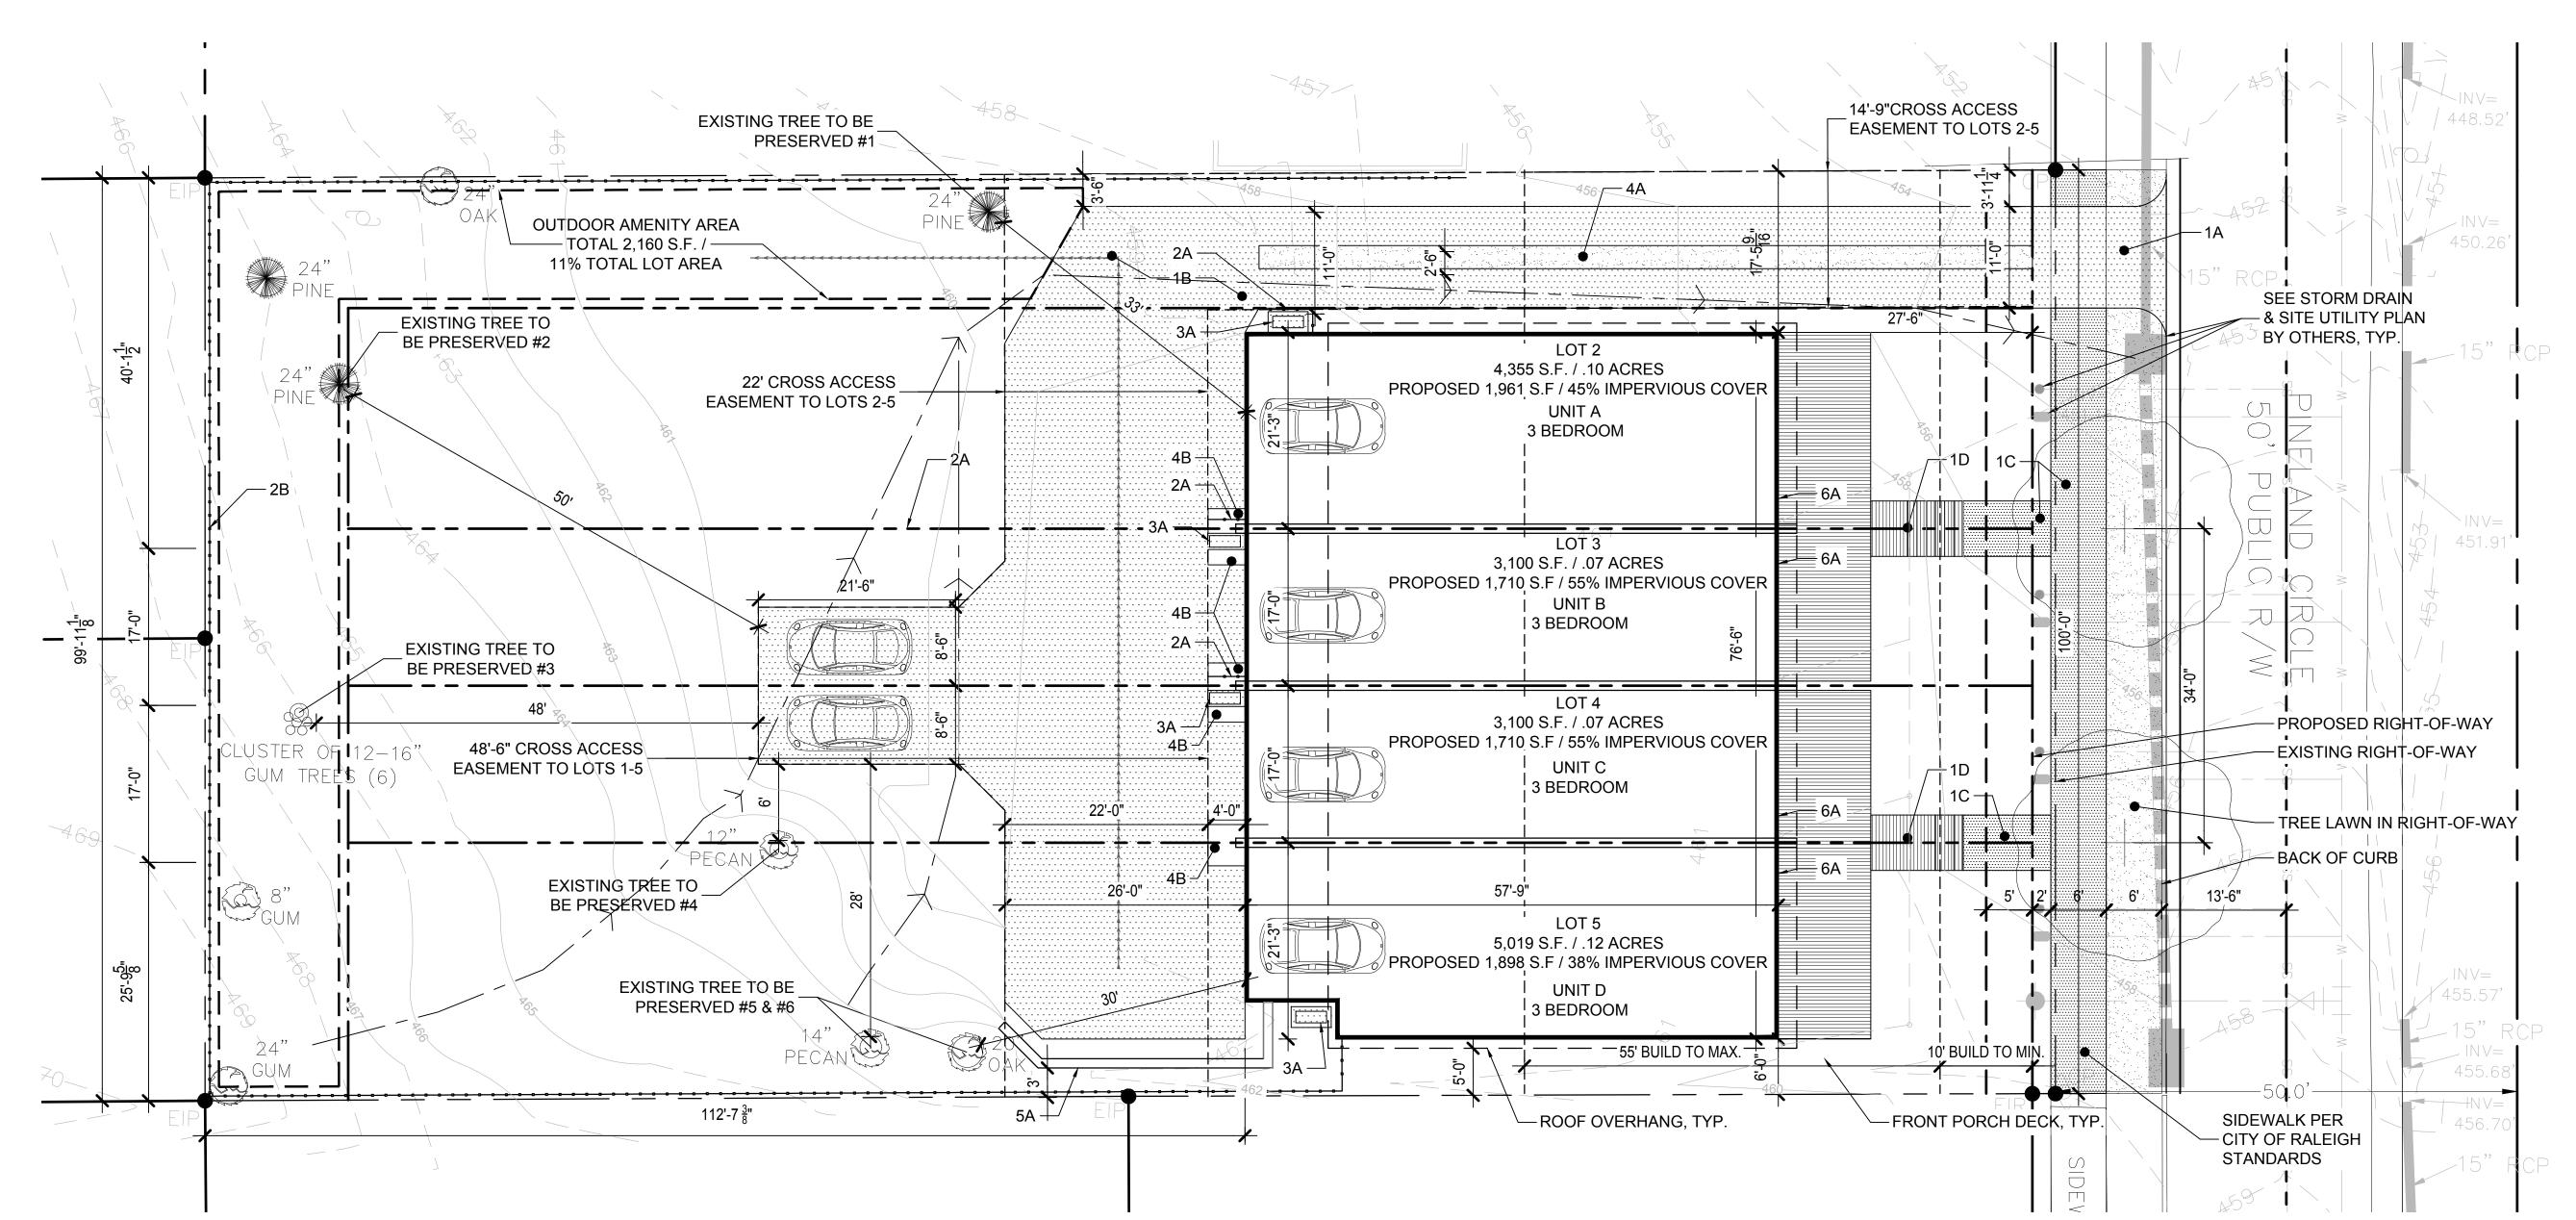





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PINEL 105 PIN KR PRO

PROJECT NUMBER:

PROJECT PHASE: PRELIMINARY SUBDIVISION PLAN

11.01.2018


REV #1 - 11.30.2018


SHEET TITLE: SUBDIVISION

PLAN SHEET NUMBER:

L200

1. STREET TREES SHALL BE INSTALLED AND MAINTAINED IN ACCORDANCE WITH THE REQUIREMENTS OF CHAPTER 2 OF THE CITY TREE MANUAL (SEE TREE PLANTING DETAIL AND ADDITIONAL PLANTING NOTES).

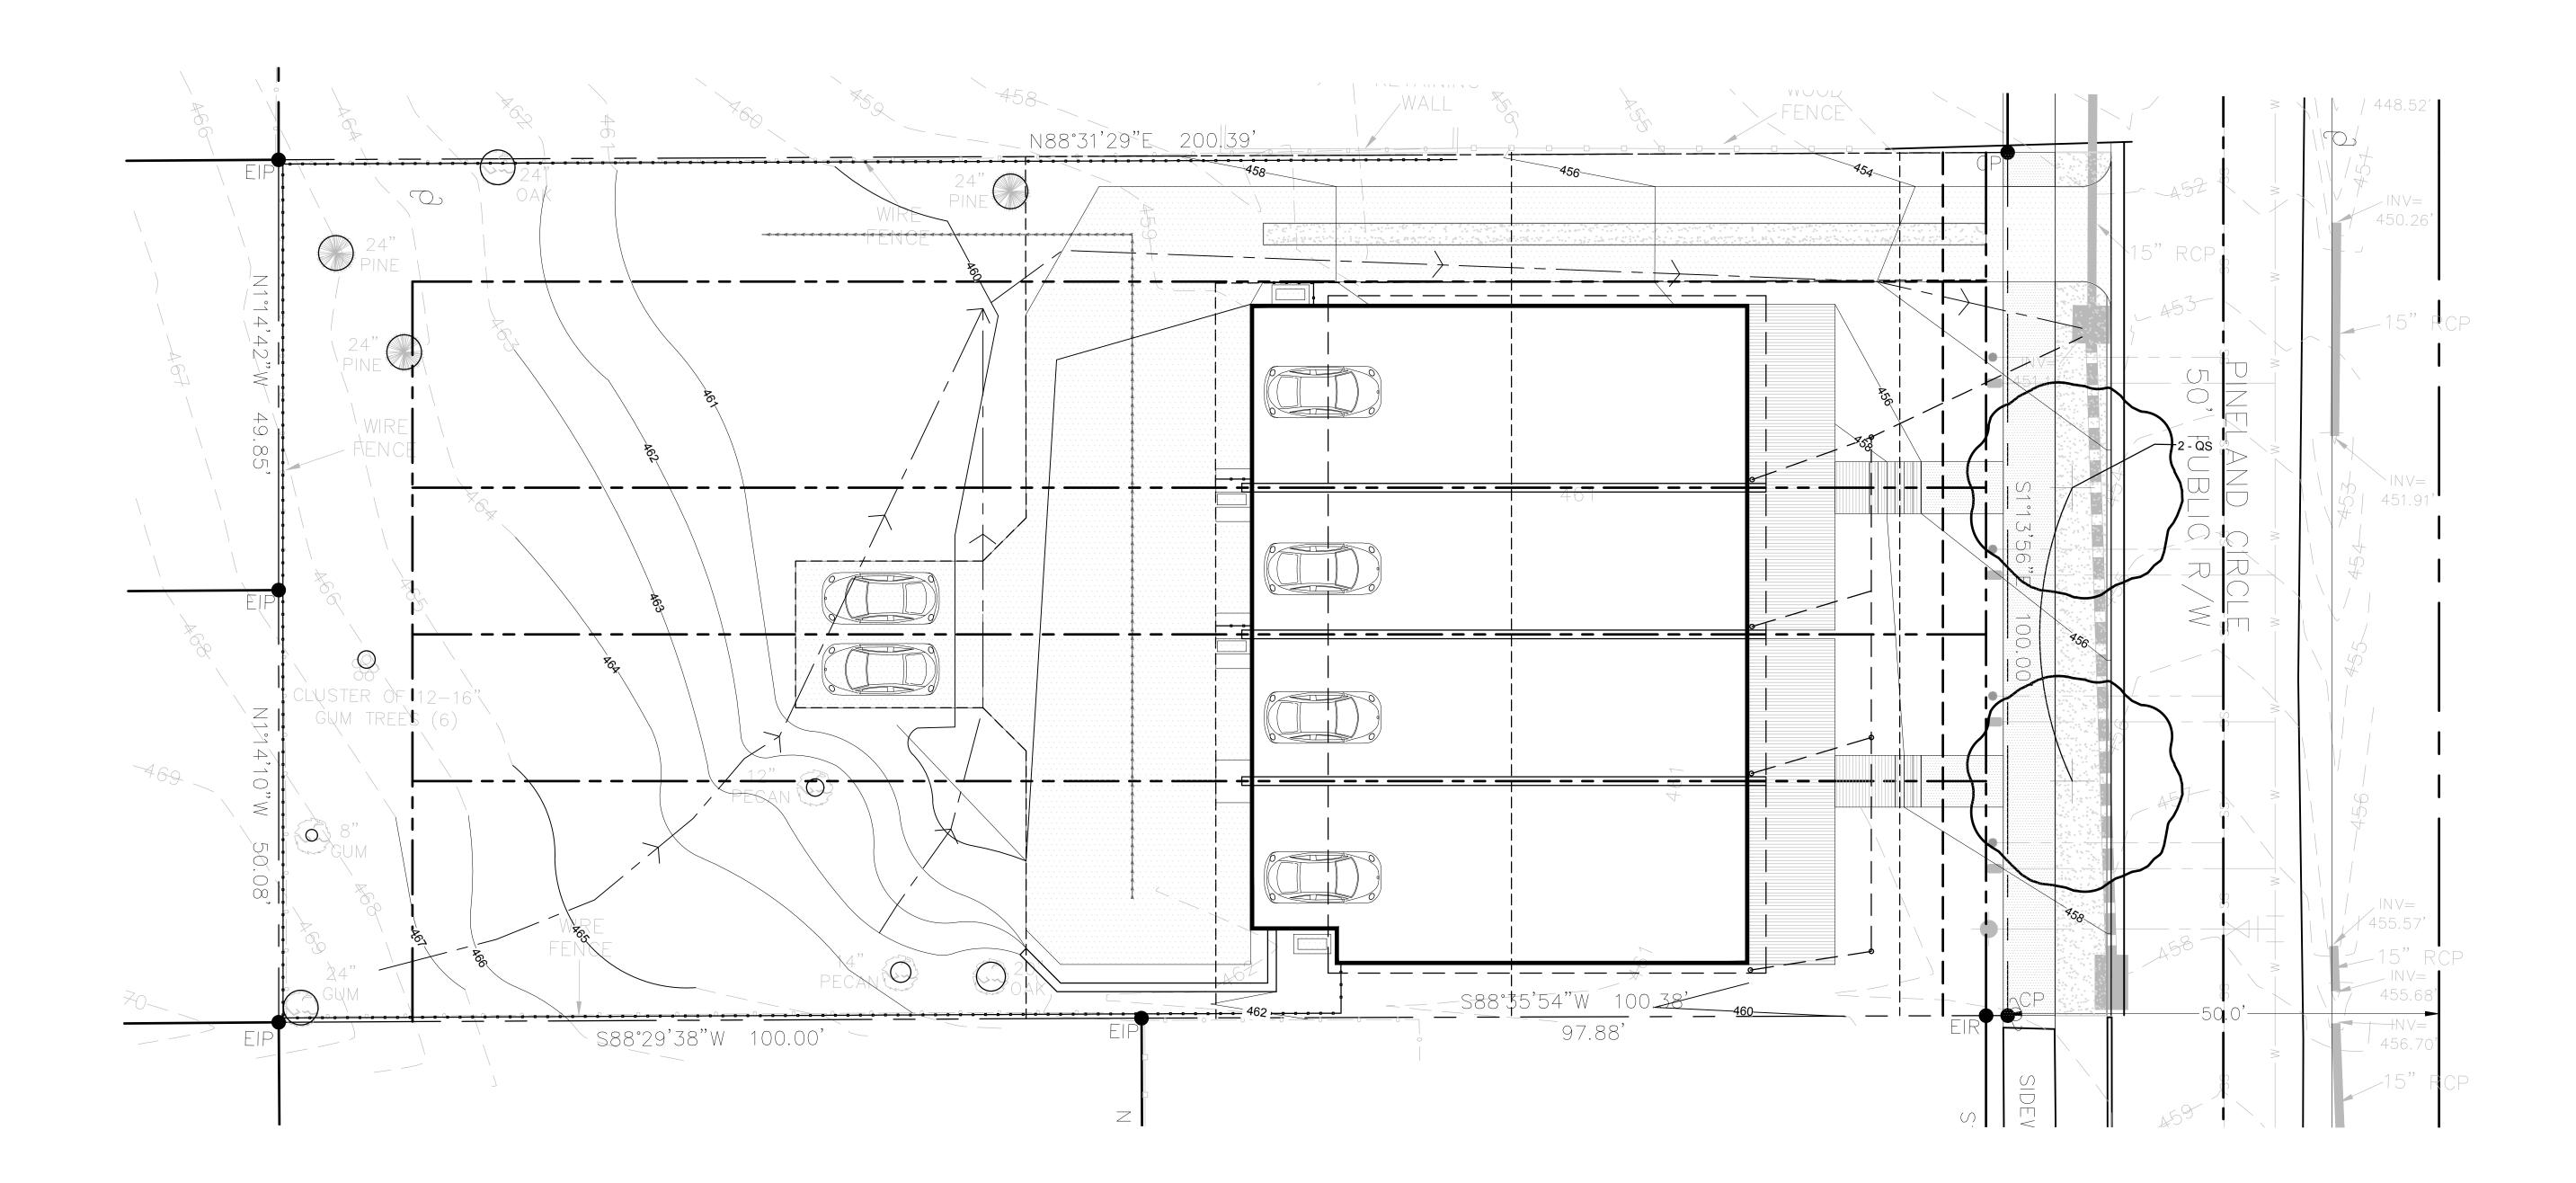

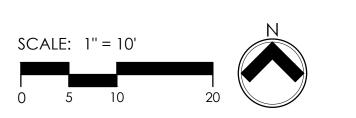



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PINELAND 1 105 PINELAND (KR PROPERTY (PROJECT NUMBER:

PROJECT PHASE:
PRELIMINARY
SUBDIVISION PLAN

11.01.2018

REV #1 - 11.30.2018

PLANTING PLAN

SHEET NUMBER:

L400

CITY OF RALEIGH STANDARD UTILITY NOTES

1. ALL MATERIALS & CONSTRUCTION METHODS SHALL BE IN ACCORDANCE WITH CITY OF RALEIGH DESIGN STANDARDS, DESTAILS, & SPECIFICATIONS (REFERENCE: CORPUD HANDBOOK, CURRENT EDITION).

2. UTILITY SEPARATION REQUIREMENTS: a. A DISTANCE OF 100' SHALL BE MAINTAINED BETWEEN SANITARY SEWER & ANY PRIVATE OR PUBLIC WATER SUPPLY SOURCE SUCH AS AN IMPOUNDED RESERVOIR USED AS A SOURCE OF DRINKING WATER. IF A DEQUATE LATERAL SEPARATION CANNOT BE ACHIEVED, FERROUS SANITARY SEWER PIPE SHALL BE SPECIFIED & INSTALLED TO WATERLINE SPECIFICATIONS. HOWEVER, THE

MINIMUM SEPARATION SHALL NOT BE LESS THAN 25' FROM A PRIVATE WELL OR 50' FROM A PUBLIC WELL; b. WHEN INSTALLING WATER &/OR SEWER MAINS, THE HORIZONTAL SEPARATION BETWEEN UTILITIES SHALL BE 10'. IF THE SEPARATION CANNOT BE MAINTAINED DUE TO EXISTING CONDITIONS, THE VARIATION ALLOWED IS THE WATER MAIN IN A

SEPARATE TRENCH WITH THE ELEVATION OF THE WATER MAIN AT LEAST 18" ABOVE THE TOP OF THE SEWER & MUST BE APPROVED BY THE PUBLIC UTILITIES DIRECTOR. ALL DISTANCES ARE MEASURED FROM OUTSIDE DIAMETER TO OUTSIDE DIAMETER; C. WHERE IT IS IMPOSSIBLE TO OBTAIN PROPER SEPARATION, OR ANYTIME SANITARY SEWER PASSES OVER A WATERMAIN, DIP MATERIALS OR STEEL ENCASEMENT EXTENDED 10' ON EACH SIDE OF CROSSING MUST BE SPECIFIED & INSTALLED TO WATERLINE

d. 5.0' MINIMUM HORIZONTAL SEPARATION IS REQUIRED BETWEEN ALL SANITARY SEWER & STORM SEWER FACILITIES, UNLESS DIP MATERIAL IS SPECIFIED FOR SANITARY SEWER;

e. MAINTAIN 18" MIN. VERTICAL SEPARATION AT ALL WATERMAIN & RCP STORM DRAIN CROSSINGS. MAINTAIN 24" MIN. VERTICAL SEPARATION AT ALL SANITARY SEWER & RCP STORM DRAIN CROSSINGS. WHERE ADEQUATE SEPARATIONS CANNOT BE ACHIEVED, SPECIFY DIP MATERIALS & A CONCRETE CRADLE HAVING 6" MIN. CLEARANCE (PER CORPUD DETAILS W-41 & S-49);

f. ALL OTHER UNDERGROUND UTILITIES SHALL CROSS WATER & SEWER FACILITIES WITH 18" MIN. VERTICAL SEPARATION REQUIRED.

3. ANY NECESSARY FIELD REVISIONS ARE SUBJECT TO REVIEW & APPROVAL OF AN AMENDED PLAN &/OR PROFILE BY THE CITY OF RALEIGH PUBLIC UTILITIES DEPARTMENT PRIOR TO CONSTRUCTION.

4. CONTRACTOR SHALL MAINTAIN CONTINUOUS WATER & SEWER SERVICE TO EXISTING RESIDENCES & BUSINESSES THROUGOUT CONSTRUCTION OF PROJECT. ANY NECESSARY SERVICE INTERRUPTIONS SHALL BE PRECEDED BY A 24 HOUR ADVANCE NOTICE TO THE CITY OF RALEIGH PUBLIC UTILITIES DEPARTMENT.

5. 3.0' MINIMUM COVER IS REQUIRED ON ALL WATER MAINS & SEWER FORCEMAINS. 4.0' MINIMUM COVER IS REQUIRED ON ALL REUSE

6. IT IS THE DEVELOPER'S RESPONSIBILITY TO ABANDON OR REMOVE EXISTING WATER & SEWER SERVICES NOT BEING USED IN REDEVELOPMENT OR A SITE UNLESS OTHERWISE DIRECTED BY THE CITY OF RALEIGH PUBLIC UTILITIES DEPARTMENT. THIS INCLUDES

ABANDONING TAP AT MAIN & REMOVAL OF SERVICE FROM POW OR FASEMENT PER CORPUID THAT OF THE PER CORPUIT THAT

ABANDONING TAP AT MAIN & REMOVALOF SERVICE FROM ROW OR EASEMENT PER CORPUD HANDBOOK PROCEDURE. 7. INSTALL WATER SERVICES WITH METERS LOCATED AT ROW OR WITHIN A 2' X 2' WATERLINE EASEMENT IMMEDIATELY ADJACENT. NOTE: IT IS THE APPLICANT'S RESPONSIBILITY TO PROPERLY SIZE THE WATER SERVICE FOR EACH CONNECTION TO PROVIDE ADEQUATE

FLOW & PRESSURE. 8. INSTALL SANITARY SEWER SERVICES @ 1.0% MINIMUM GRADE WITH CLEANOUTS LOCATED AT ROW OR EASEMENT LINE & SPACED

EVERY 75 LINEAR FEET MAXIMUM. 9. PRESSÚRE REDUCING VALVES ARE REQUIRED ON ALL WATER SERVICES EXCEEDING 8<mark>0 PSI; BACKW</mark>ATER VALVES ARE REQUIRED ON ALL SANITARY SEWER SERVICES HAVING BUILDING DRAINS LOWER THAN 1.0' ABOVE THE NEXT UPSTREAM MANHOLE.

10. ALL ENVIRONMENTAL PERMITS APPLICABLE TO THE PROJECT MUST BE OBTAINED FROM NCDWQ AND USACE &/OR FEMA FOR ANY RIPARIAN BUFFER, WETLAND &/OR FLOODPLAIN IMPACTS (RESPECTIVELY) PRIOR TO CONSTRUCTION.

1. NCDOT / RAILRADD ENCROACHMENT AGREEMENTS ARE REQUIRED FOR ANY UTILITY WORK (INCLUDING MAIN EXTENSIONS &

SERVICE TAPS) WITHIN STATE OR RAILROAD ROW PRIOR TO CONSTRUCTION. 12. GREASE INTERCEPTOR / OIL WATER SEPARATOR SIZING CALCULATIONS & INSTALLATION SPECIFICATIONS SHALL BE APPROVED BY

CORPUD FOG PROGRAM COORDINATOR PRIOR TO ISSUANCE OF A BUILDING PERMIT. CONTACT TIM BEASLEY AT (919) 996-2334 OR TIMOTHY.BEASLEY@RALEIGHNC.GOV FOR MORE INFORMATION.

13. CROSS-CONNECTION CONTROL PROTECTION DEVICES ARE REQUIRED BASED ON DEGREE OF HEALTH HAZARD INVOLVED AS LISTED IN APPENDIX-B ФF THE RULES GOVERNING PUBLIC WATER SYSTEMS IN NORTH CAROLINA. THESE GUIDELINES AR THE MINIMUM requirements. The Devices shall meet merican society of sanitary engineering (asse) standards or be on teh UNIVERSITY OF SOUTHE<u>RN CALIFORNIA.</u> APPROVAL LIST.. THE DEVICES SHALL BE INSTALLED AND TESTED (BOTH INITIAL AND PERIODIC

TESTING THEREAFTER) IN ACCORDANCE WITH THE MANUFACTURER'S RECOMMENDATIONS OR THE LOCAL CROSS-CONNECTION CONTROL PROGRAM, WHICHEVER IS MORE STRINGENT. CONTACT JOANIE HARTLEY AT (919) 996-5923 OR

JOANIE.HARTLEY@RAL#IGHNC.GOV FOR MORE INFORMATION.

UTILITY NOTES

THE PROJECT AS SET FORTH IN THESE PLANS.

1. REFER TO GENERAL NOTES ON SHEETS PROVIDED BY SITE COLLABORATIVE.

2. EXISTING UTILITIES IN CONFLICT WITH PROPOSED IMPROVEMENTS SHALL BE REMOVED OR RELOCATED.

3. THIS PLAN IS DIAGRAMMATIC AND REPRESENTS THE APPROXIMATE LOCATION OF PROPOSED UTILITIES UNLESS SPECIFICALLY DIMENSIONED. THE CONTRACTOR SHALL COORDINATE THE ACTUAL AND PROPOSED LOCATION OF UTILITIES TO AVOID CONFLICTS. 4. PUBLIC WATER AND SANITARY SEWER LINE SIZES AND MATERIALS ARE BASED ON INFORMATION PROVIDED BY THE CITY OF RALEIGH. THE CONTRACTOR SHALL BE RESPONSIBLE FOR FIELD VERIFYING THIS INFORMATION.

S88°29'38"W 100.00'

5. THE CONTRACTOR SHALL COORDINATE THE LOCATION OF ALL ELECTRIC, GAS, AND TELEPHONE SERVICE WITH THE APPROPRIATE UTILITY COMPANY PRIOR TO BEGINNING CONSTRUCTION. THE CONTRACTOR SHALL PROVIDE CONDUITS AS REQUIRED FOR THESE UTILITIES UNDER PAVED AREAS.

6. CONTRACTORS MUST COORDINATE ALL SITE UTILITY INSPECTIONS WITH CITY OF RALEIGH PUBLIC UTILITIES INSPECTOR. THE CITY OF

RALEIGH SHALL BE NOTIFIED BEFORE ANY WORK TAKES PLACE.

7. THE CONTRACTOR IS NOT AUTHORIZED TO USE UNMETERED WATER DURING CONSTRUCTION. THE CONTRACTOR SHALL CONTACT THE CITY OF RALEIGH PUBLIC UTILTIES DEPARTMENT FOR TEMPORARY METER AND SERVICE OPTIONS.

8. THE CONTRACTOR SHALL COORDINATE THE LOCATION OF ALL WATER AND SANITARY SEWER SERVICES WITH THE BUILDING PLANS PROVIDED BY OTHERS TO ENSURE THE CONNECTION LOCATION AND ELEVATION ARE COORDINATED.

9. ALL SANITARY SEWER SERVICES SHALL HAVE A MINIMUM SLOPE OF 2.0%. 10. THE CONTRACTOR SHALL BE RESPONSIBLE FOR COORDINATING ALL UNDERGROUND UTILITIES TO ENSURE THERE ARE NO

CONFLICTS AND THAT ALL UTILITIES MEETING THE MINIMUM CITY OF RALEIGH COVER AND SEPARATION REQUIREMENTS. 11. THE CONTRACTOR SHALL BE RESPONSIBLE FOR CONTACTING, COORDINATING, AND PAYMENT FOR ALL NECESSARY LOCATING SERVICES INCLUDING INDEPENDENT LOCATING SERVICES. THE CONTRACTOR SHALL HAVE ALL EXISTING UTILITIES LOCATED AT LEAST 48 HOURS PRIOR TO BEGINNING DEMOLITION, EXCAVATION, OR ANY OTHER FORM OF CONSTRUCTION. THE

CONTRACTOR SHALL IMMIEDIATELY NOTIFY THE OWNERS REPRESENTATIVES OF ANY DISCREPANCIES OR CONFLICTS. 12. ALL SUB-SURFACE UTILITIES IDENTIFIED ON THE CONSTRUCTION DOCUMENTS ARE SHOWN IN THEIR APPROXIMATE LOCATION BASED ON SURVEY INFORMATION, FIELD OBSERVATIONS, AND OTHER RECORD DRAWINGS WHICH MAY BE AVAILABLE. THESE DRAWINGS DO NOT NECESSARILY SHOW ALL EXISTING UTILITIES.

13. THE CONTRACTOR SHALL MAINTAIN AS-BUILT DRAWINGS TO RECORD THE ACTUAL LOCATION OF ALL PIPING PRIOR TO CONCEALMENT. DRAWINGS WILL BE PROVIDED TO THE OWNER'S REPRESENTATIVE AT REGULAR INTERVALS THROUGHOUT THE PROJECT FOR RECORD KEEPING AND AT THE CONCLUSION OF CONSTRUCTION.

14. IF DEPARTURES FROM THE PROJECT DRAWINGS OR SPECIFICATIONS ARE DEEMED NECESSARY BY THE CONTRACTOR, DETAILS OF SUCH DEPARTURES AND REASONS THERE FOR SHALL BE SUBMITTED TO THE OWNER'S REPRESENTATIVE FOR REVIEW. NO DEPARTURES FROM THE CONTRACT DOCUMENTS SHALL BE MADE WITHOUT THE EXPRESS WRITTEN PERMISSION OF THE OWNER'S

15. THE CONTRACTOR SHALL BE RESPONSIBLE FOR THE RELOCATION OF ANY EXISTING UTILITY INFRASTRUCTURE REQUIRED TO COMPLETE ANY PORTION OF CONSTRUCTION. THE CONTRACTOR SHALL ALSO BE RESPONSIBLE FOR THE COORDINATION AND 16. THE ENGINEER AND/OR OWNER DISCLAIM ANY ROLE IN THE CONSTRUCTION MEANS AND/OR METHODS ASSOCIATED WITH

17. IF CONSTRUCTION MEANS AND METHODS REQUIRE ANY TEMPORARY LANE CLOSURES OR SIDEWALK CLOSURES ALONG PUBLIC ROADWAYS, THE CONTRACTOR SHALL BE RESPONSIBLE FOR OBTAINING ALL NECESSARY PERMITS FROM THE CITY OF RALEIGH.

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727 W. Hargett Street, Ste. 101 Raleigh, NC 27603 |

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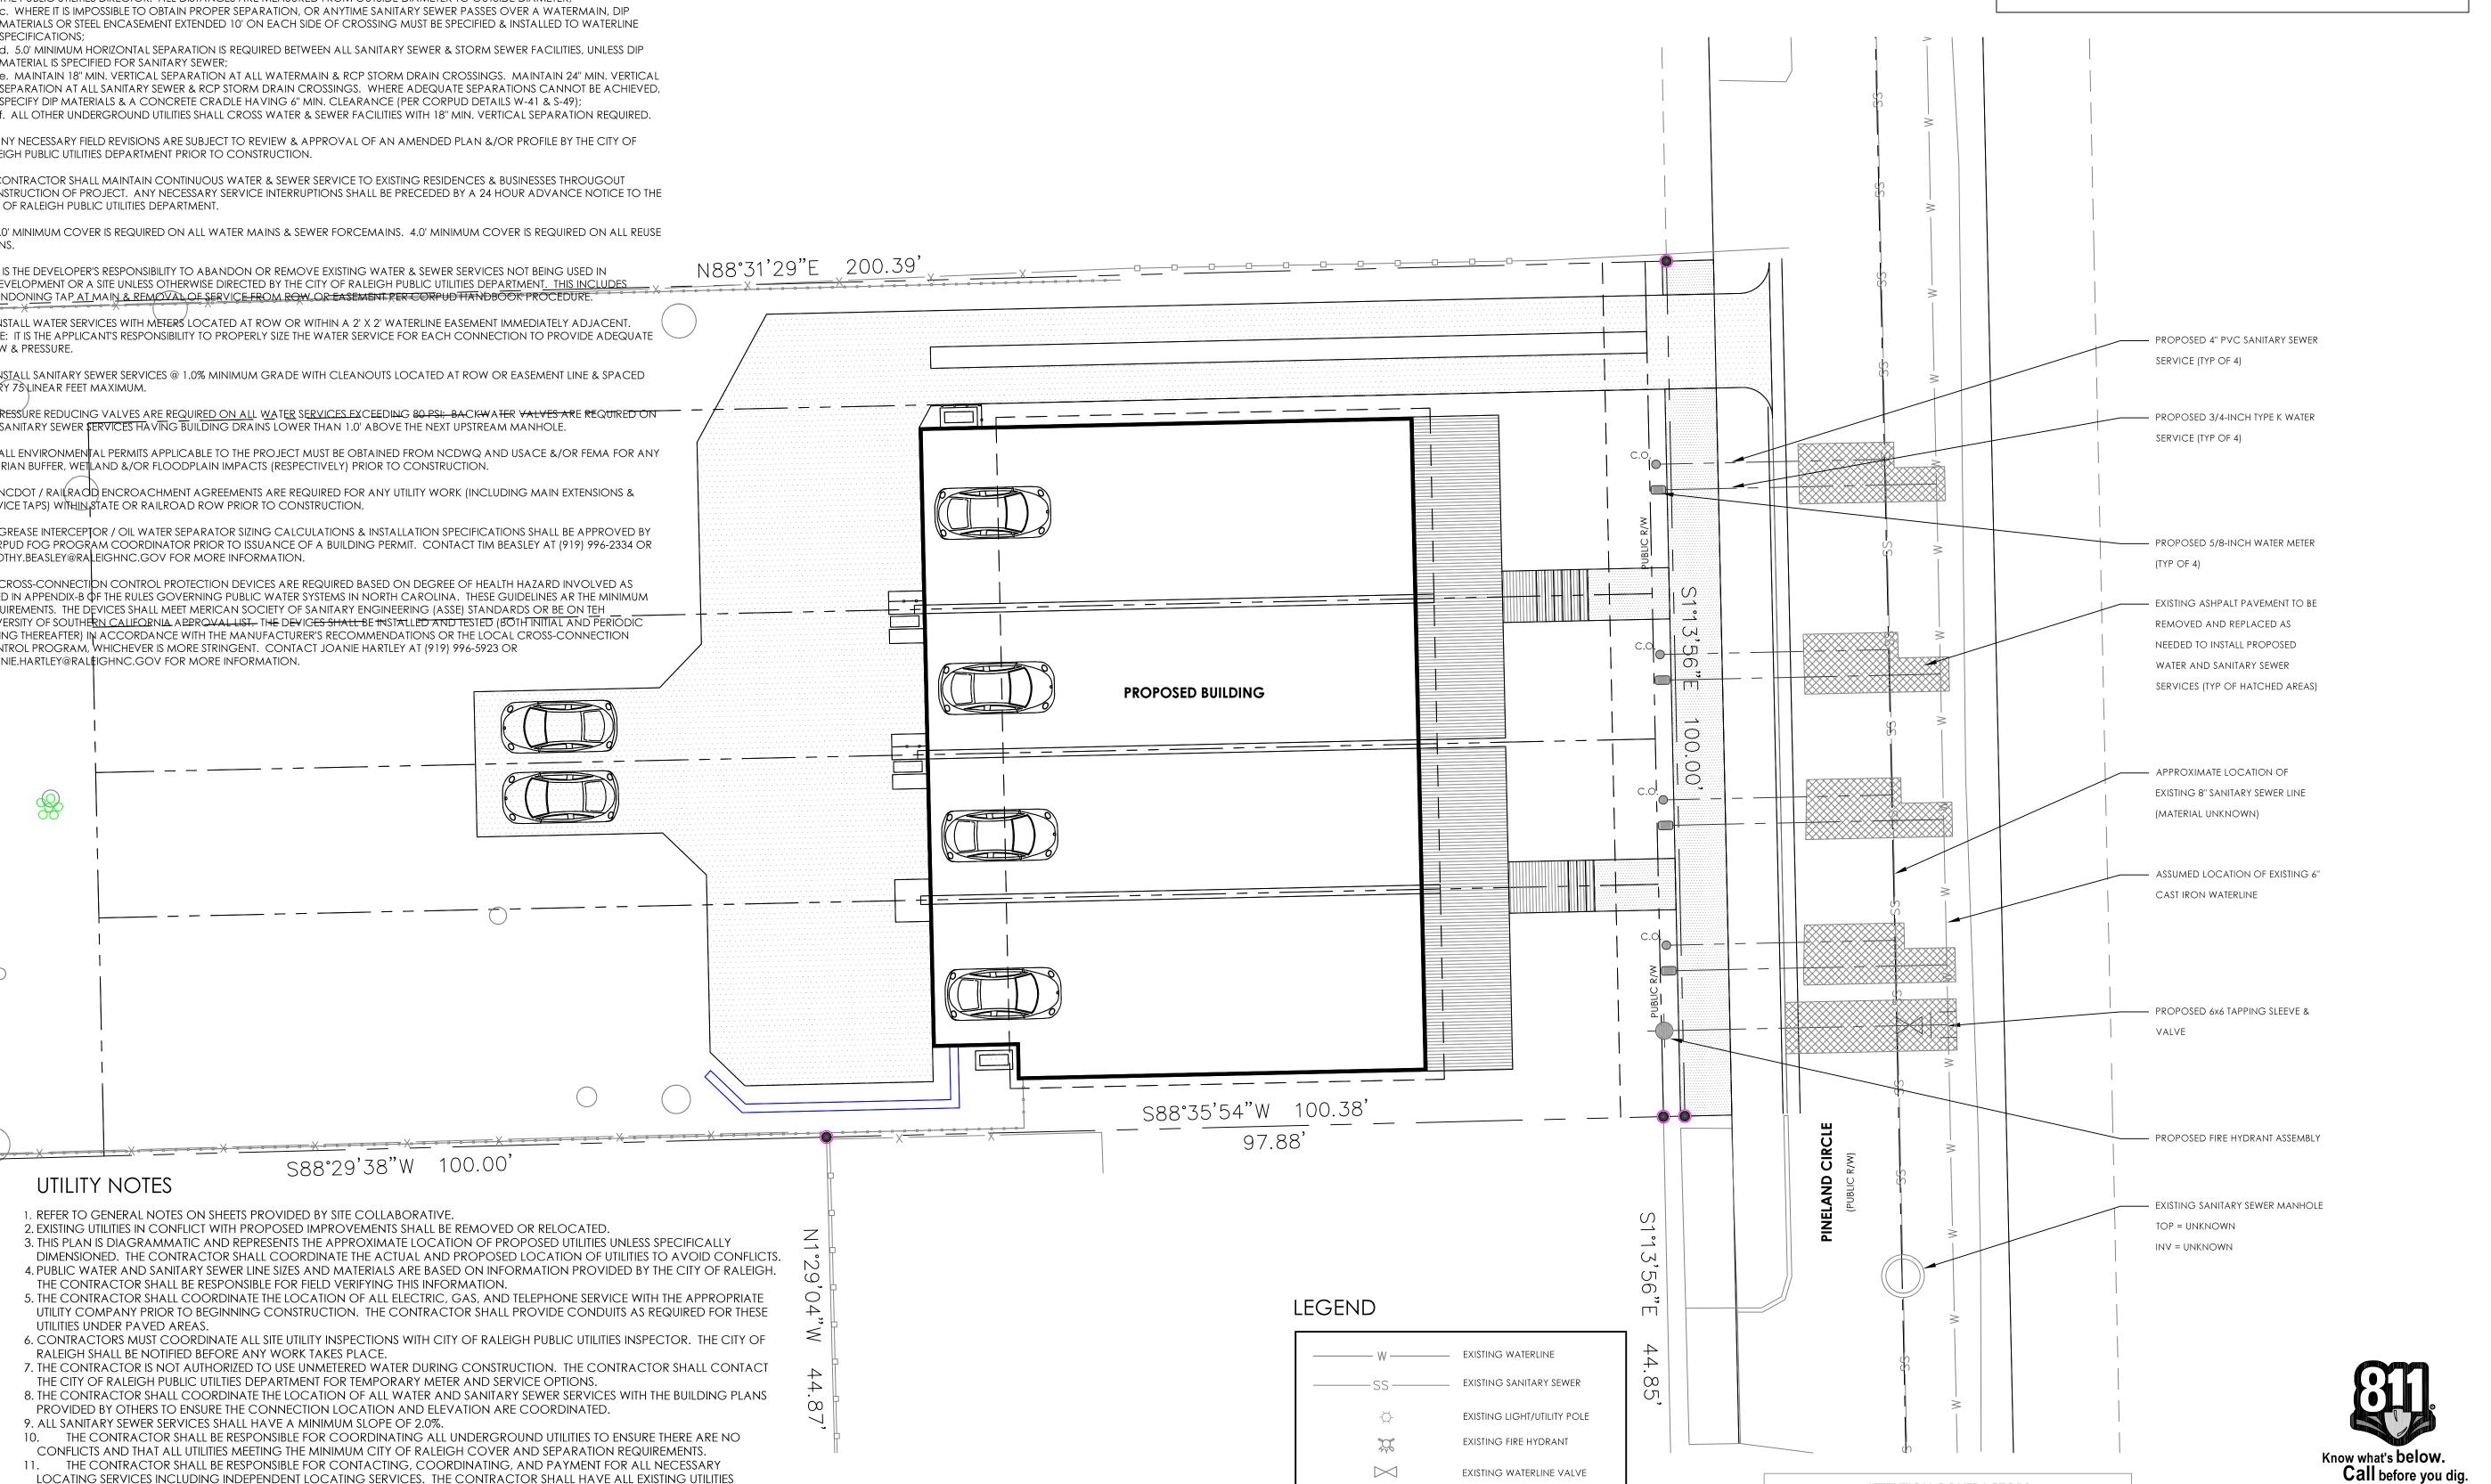
incorporated on this document is an

instrument of professional service and

shall not be used for any other project without written authorization of Site

Collaborative Inc. The ideas and design

ALL CONSTRUCTION SHALL CONFORM WITH CITY OF RALEIGH STANDARDS AND SPECIFICATIONS.



PROPOSED WATERLINE SERVICE

PROPOSED SANITARY

PROPOSED FIRE HYDRANT

PROPOSED SANITARY SEWER

SEWER SERVICE

CLEANOUT

ATTENTION CONTRACTORS

CONTACTING THE PUBLIC WORKS DEPARTMENT AT (919) 996-2409, AND THE

FAILURE TO NOTIFY BOTH CITY DEPARTMENTS IN ADVANCE OF BEGINNING

FAILURE TO CALL FOR INSPECTION, INSTALL A DOWNSTREAM PLUG, HAVE

PUBLIC UTILITIES DEPARTMENT AT (919) 996-5450 AT LEAST TWENTY FOUR HOURS

CONSTRUCTION, WILL RESULT IN THE ISSUANCE OF **MONETARY FINES**, AND REQUIRE

REINSTALLATION OF ANY WATER OR SEWER FACILITIES NOT INSPECTED AS A RESULT

PERMITTED PLANS ON THE JOBSITE, OR ANY OTHER VIOLATION OF CITY OF RALEIGH

STANDARDS WILL RESULT IN A FINE AND POSSIBLE EXCLUSION FROM FUTURE WORK

THE CONSTRUCTION CONTRACTOR RESPONSIBLE FOR THE EXT

PRIOR TO BEGINNING ANY OF THEIR CONSTRUCTION.

OF THIS NOTIFICATION FAILURE.

IN THE CITY OF RALEIGH.

0

PROJECT NUMBER: 18073

PROJECT PHASE: PRELIMINARY SUBDIVISION PLAN

DATE: 11.01.2018

REV #1 - 11.30.2018

SHEET TITLE:

SITE UTILITY PLAN

SHEET NUMBER:

GRAPHIC SCALE

6A A433

9' - 0"

 $\begin{pmatrix} 2 \\ A434 \end{pmatrix}$

S-2

M-1

3 A434

C-1



DISTRIBUTOR/VENDOR

INFORMATION

REP NAME COMPANY

PHONE #

COMPANY

REP NAME

COMPANY PHONE # EMAIL

REP NAME

COMPANY

REP NAME COMPANY PHONE # EMAIL

REP NAME

COMPANY PHONE #

REP NAME

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REP NAME

COMPANY

PHONE # EMAIL

EMAIL

PHONE # EMAIL

EMAIL

PHONE #

EMAIL

PHONE # EMAIL

EMAIL REP NAME

EXTERIOR MATERIAL...

AUTOCLAVE MANUFACTURER: AERCON AERATED AAC

COLLECTION:

COLOR: Black

COLOR: Black

COLLECTION:

Miter at Corners

Miter at Corners

COLOR:

COLOR:

S-2 CEMENTITIOUS MANUFACTURER: HARDIE

SIDING COLLECTION:

COLOR:

COLOR:

METAL MATERIAL: Metal

GR-2 POLYCARBON MATERIAL: Polycarbonate

GR-3 WOOD RAIL MATERIAL: CEDAR WOOD

GR-4 METAL CORDS MATERIAL: Metal

GR-5 METAL FRAME MATERIAL: Metal

M-1 STANDING MANUFACTURER:

SEAM METAL | COLLECTION:

ROOF COLOR:

S-1 CEDAR SIDING MANUFACTURER:

ATE PANELS | COLOR: Clear

GUARDRAIL | COLOR: Black

CONCRETE COLLECTION:

FL FLASHING MANUFACTURER:

ROOF BEARING

UNITS 3&4
25' - 0"
ROOF BEARING
UNITS 1&2

THIRD FLOOR

GR-1

GR-5

GR-2

FL

S-1

SECOND FLOOR

GROUND FLOOR

UNITS 3&4 _____18'_- 0"

UNITS 1&2 24' - 4"


UNITS 1&2 17' - 4"

THIRD FLOOR

UNITS 3&4 SECOND FLOOR
UNITS 1&2
8' - 4"

UNITS 3&4 GROUND FLOOR
UNITS 1&2
-0' - 8"

WEST ELEVATION 1/4" = 1'-0"

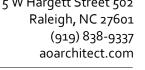

CONSULTANTS: SITE COLLABORATIVE SCHNEIDER & ASSOCIATES MAPLE ENGINEERING, PLLC

1814

PROJECT No.:

HOME 9


PINEL

SEALS:

NOT FOR CONSTRUCTION

ISSUE: DEVELOPMENT DATE: 12/3/2018 DRAWN BY: JFK/RLR **REVISIONS:**

BUILDING ELEVATIONS

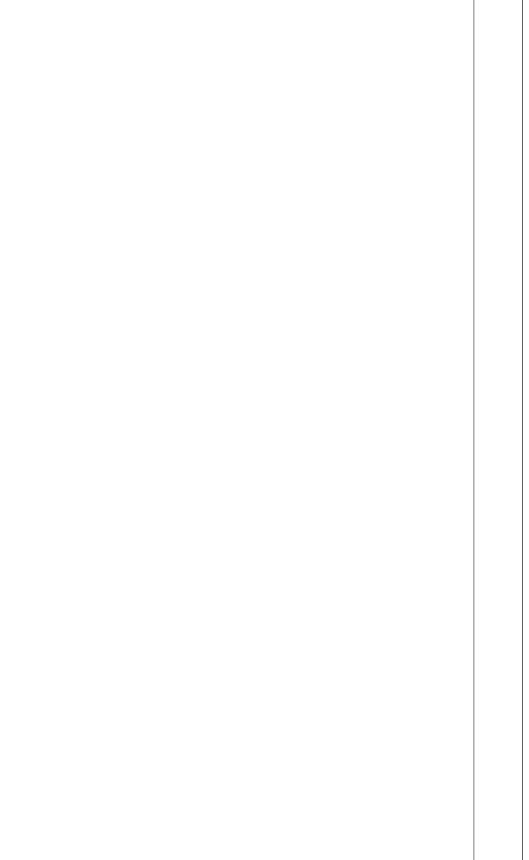



C-1

S-2

M-1

S-2

M-1



5 W Hargett Street 502 Raleigh, NC 27601 (919) 838-9337 aoarchitect.com

CONSULTANTS:

SITE COLLABORATIVE SCHNEIDER & ASSOCIATES MAPLE ENGINEERING, PLLC

1814


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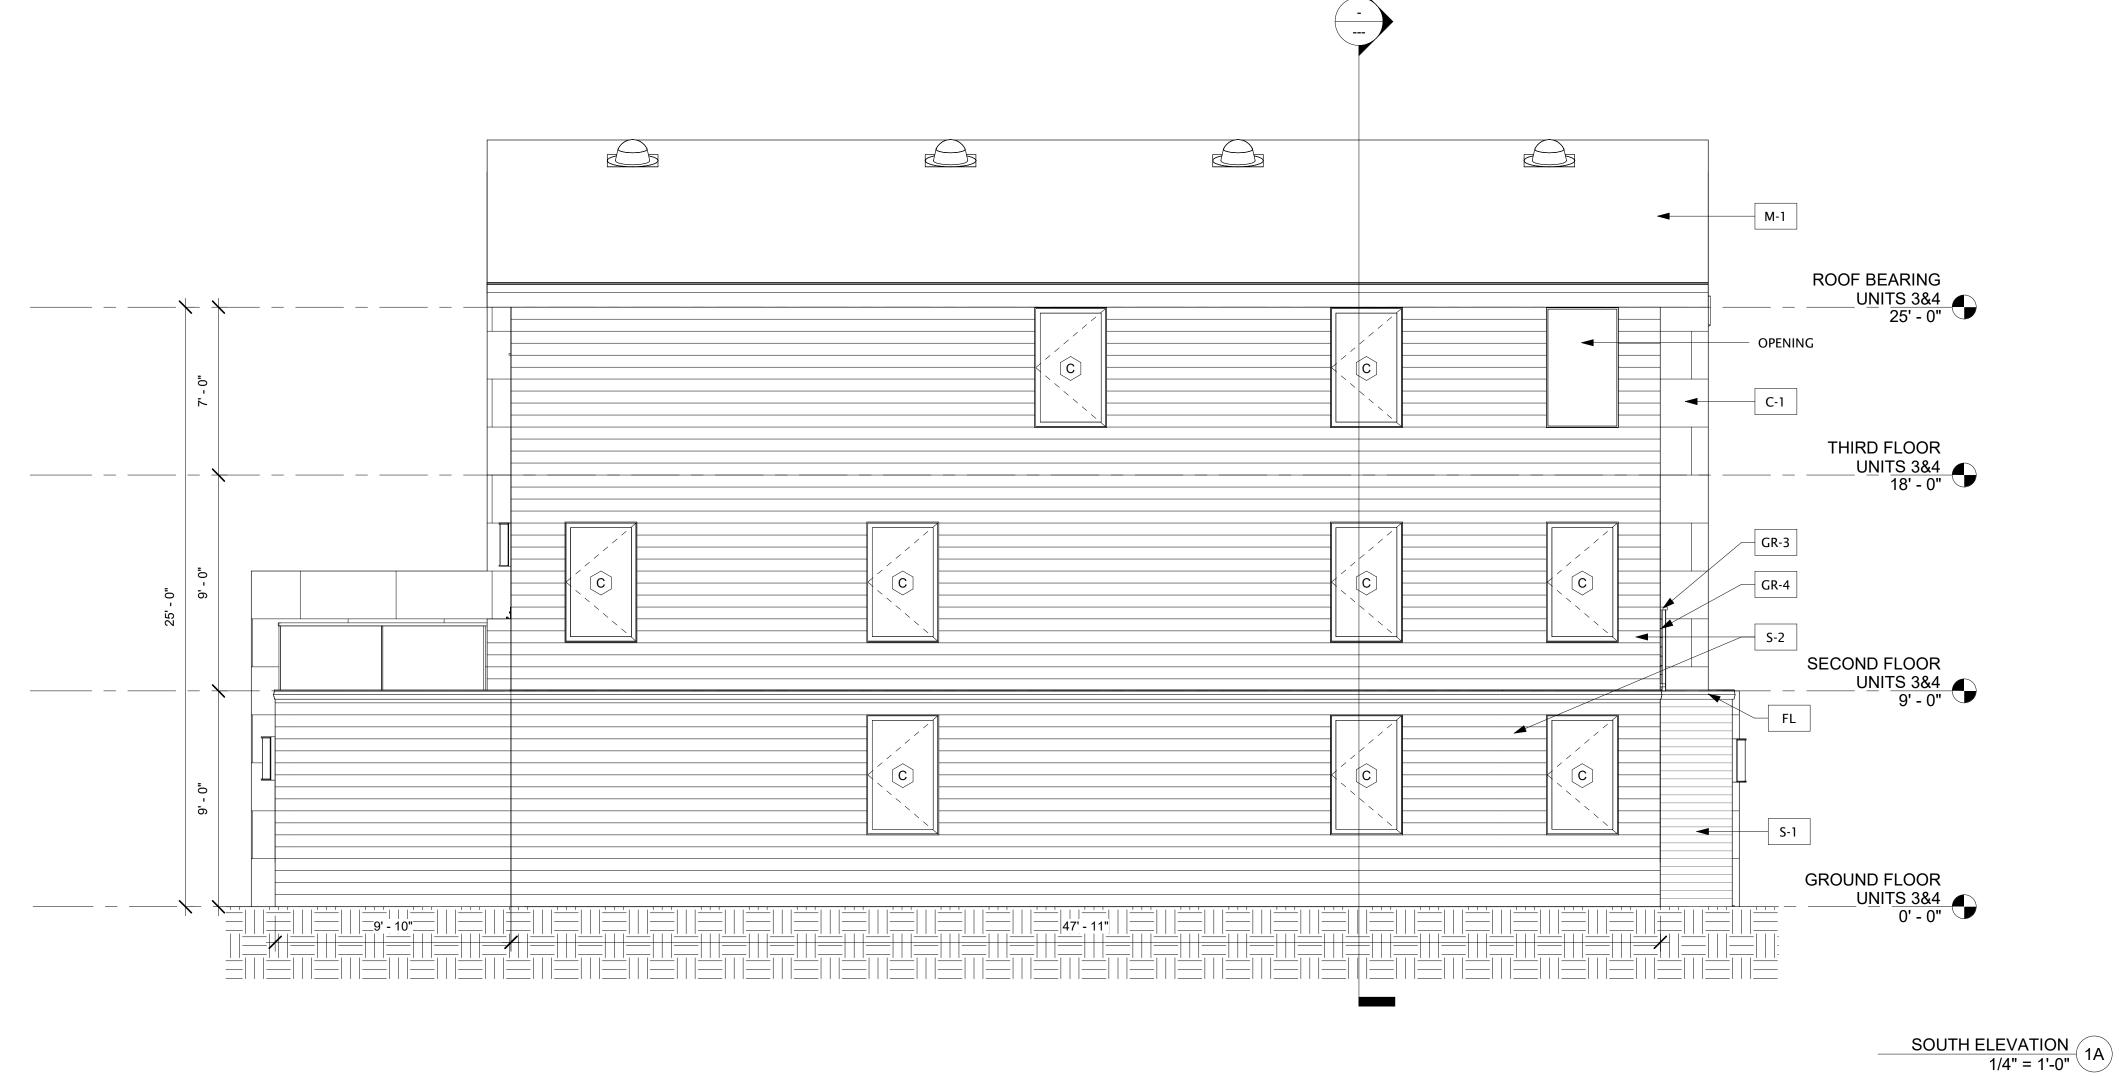
PROJECT No.:

HOME

PINEL

EXTERIOR MATERIAL... DISTRIBUTOR/VENDOR INFORMATION C-1 AUTOCLAVE MANUFACTURER: AERCON AERATED AAC REP NAME COMPANY CONCRETE | COLLECTION: PHONE # EMAIL FL FLASHING MANUFACTURER: REP NAME COLLECTION: COMPANY COLOR: PHONE # EMAIL GR-1 METAL MATERIAL: Metal REP NAME GUARDRAIL | COLOR: Black COMPANY PHONE # EMAIL GR-2 POLYCARBON MATERIAL: Polycarbonate REP NAME ATE PANELS | COLOR: Clear COMPANY PHONE # EMAIL GR-3 WOOD RAIL MATERIAL: CEDAR WOOD REP NAME COMPANY PHONE # EMAIL GR-4 METAL CORDS MATERIAL: Metal REP NAME COLOR: Black COMPANY PHONE # EMAIL GR-5 METAL FRAME MATERIAL: Metal REP NAME COLOR: Black COMPANY PHONE # EMAIL M-1 STANDING MANUFACTURER: REP NAME SEAM METAL COLLECTION: ROOF COLOR: COMPANY PHONE # EMAIL S-1 CEDAR SIDING MANUFACTURER: REP NAME COLLECTION: COMPANY COLOR: PHONE # EMAIL Miter at Corners S-2 CEMENTITIOUS MANUFACTURER: HARDIE REP NAME SIDING COLLECTION: COMPANY COLOR: PHONE # EMAIL Miter at Corners



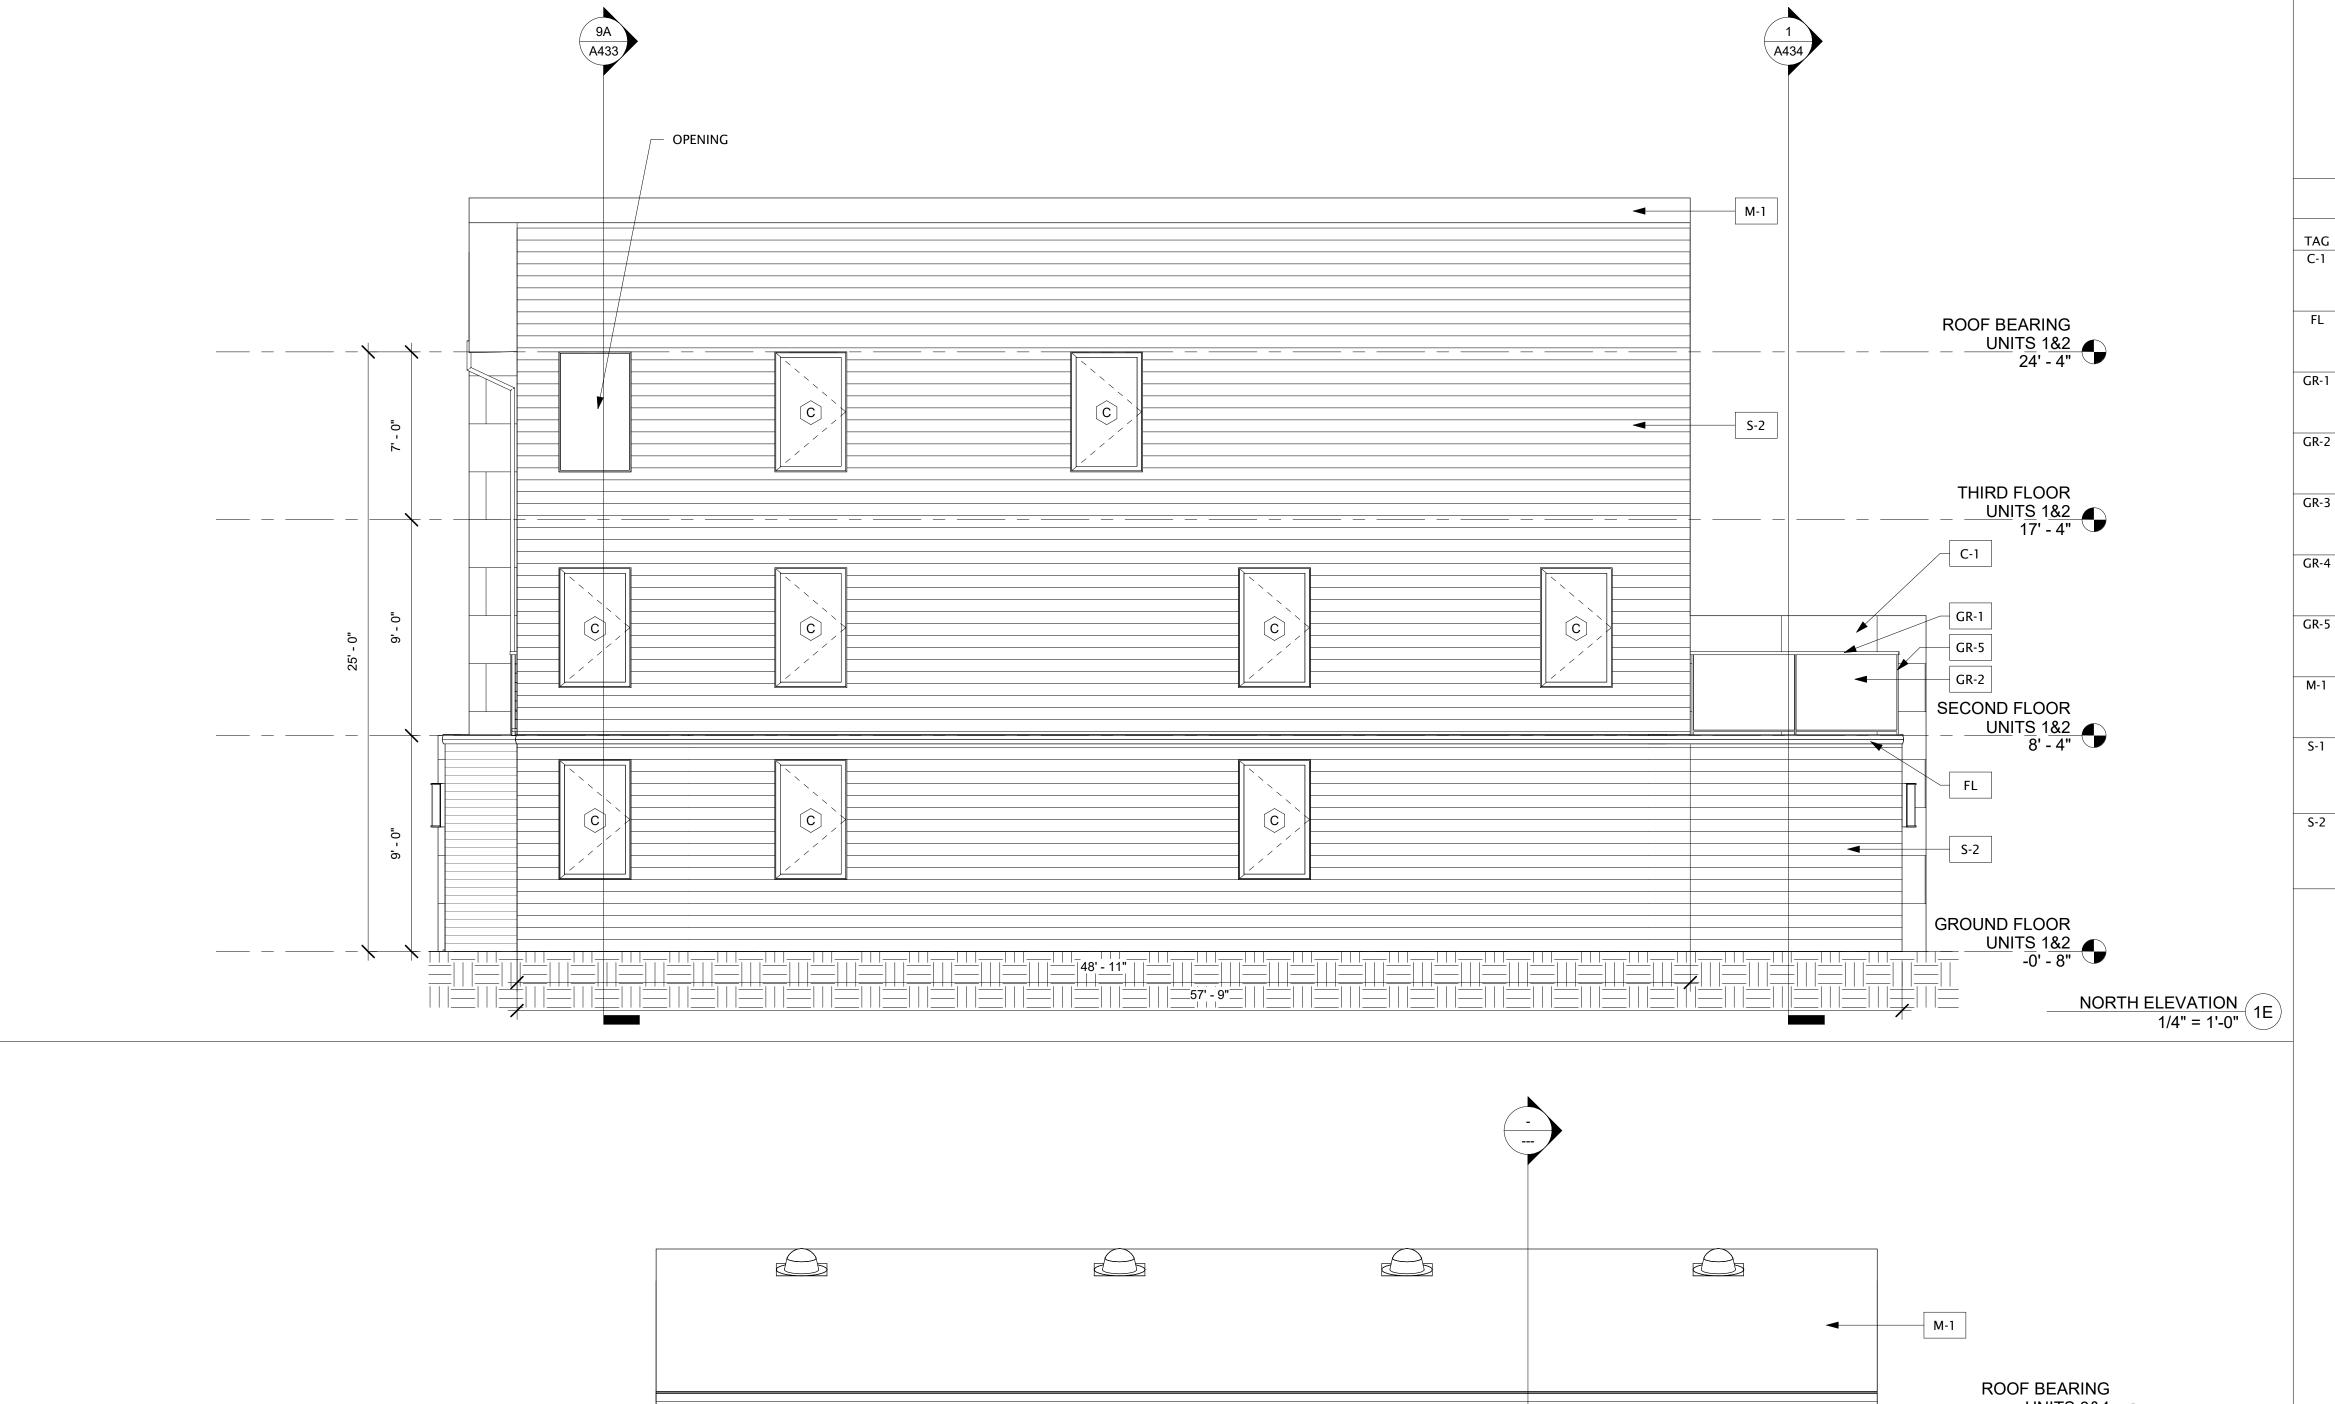

SEALS:

NOT FOR CONSTRUCTION

ISSUE: DEVELOPMENT DATE: 12/3/2018 DRAWN BY: JFK/RLR REVISIONS: BUILDING ELEVATIONS