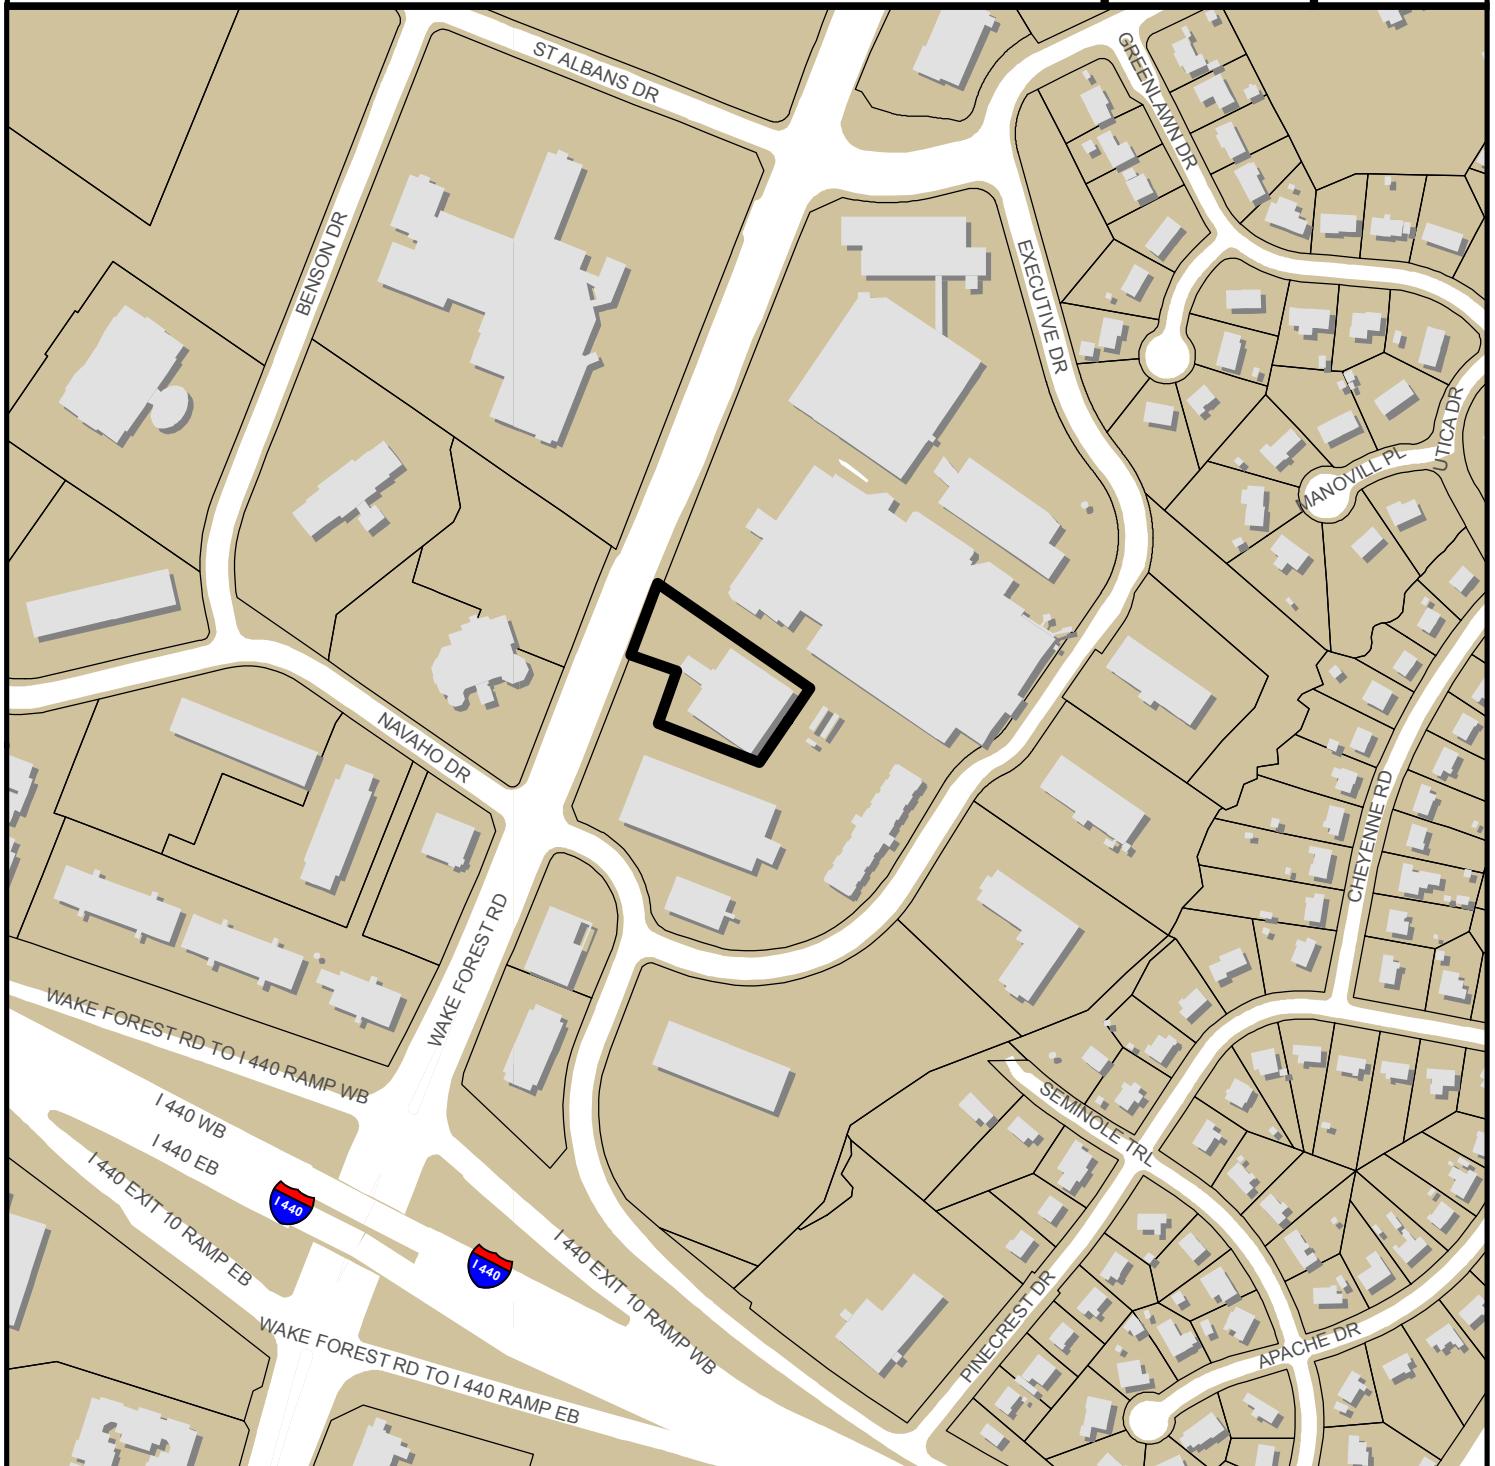


# DUKE RALEIGH HOSPITAL INPATIENT TOWER SR-65-2017



0 300 600 Feet

Zoning: OX-5-PL-CU  
CAC: Atlantic  
Drainage Basin: Big Branch  
Acreage: 17.28  
Sq. Ft.: 210,169

Planner: Michael Walters  
Phone: (919) 996-2636

Applicant: Linda Vasil  
Phone: (919) 645-5979





# Administrative Approval Action

AA # 3693 / SR-65-17, Duke Raleigh Hospital New  
Inpatient Tower and Surgical Expansion  
Transaction# 522658

City of Raleigh  
Development Services Department  
One Exchange Plaza  
Raleigh, NC 27602  
(919) 996-2495  
DS.help@raleighnc.gov  
www.raleighnc.gov

**LOCATION:** This site is located on the east side of Wake Forest Road, between the intersections of Wake Forest Road and Navaho Drive, and Wake Forest Road and St. Albans Drive. The address for the parent tract is 3400 Wake forest Road.

**REQUEST:** Development on a portion of a 17.18 acre tract zone OX-5-PL with the addition of a 174,693 square foot, five-story 75' height, new inpatient and surgery tower expansion containing an additional 38 hospital beds.

**DESIGN**

**ADJUSTMENT(S)/**

**ALTERNATES, ETC:** Hardship Variance (A-16-17) allowing an 8'3" height variance to allow for the construction of an elevator penthouse in excess of the 12' height encroachment allowed above the roof, a 1'10" height variance to allow for the installation of mechanical equipment in excess of the 12' height encroachment allowed above the roof and a 10' variance to allow a stairwell bulkhead to be located at the building edge instead of recessed inward 10' as required by Section 1.5.7.D.3. of the Unified Development Ordinance as well as a 1-story/4'7" increase in the overall building height allowed by Section 3.3.2.A. of the Unified Development Ordinance that results in an elevator penthouse that is 20'3" above the roof and an overall elevator structure height of 79'7", mechanical equipment that is 13'10" above the roof and a stairwell bulkhead.

A Design Adjustment has been approved for this project waiving both the block perimeter requirement and the dedication of additional right of way width.

Administrative Alternates have been approved by the Planning Director granting an additional 2' waiver to the Build To requirement for an addition to an existing building, and also to the landscape and screening requirement specifically in the service area. (AAD 28-17)

**FINDINGS:** City Administration finds that this request, with the below conditions of approval being met, conforms to the Unified Development Ordinance. This approval is based on a preliminary plan submitted by ColeJenest & Stone.

## **CONDITIONS OF APPROVAL and NEXT STEPS:**

**Note:** *This document must be applied to the second sheet of all future submittals with the exception of final plats.*

### **PRIOR TO THE ISSUANCE OF ANY SITE PERMITS OR APPROVAL OF CONCURRENT REVIEW PROCESS, WHICHEVER IS APPLICABLE:**

**ENGINEERING**

1. Required NCDOT encroachment and/or driveway permits must be approved and copies provided to Development Services – Development Engineering prior to concurrent review approval.
2. **Next Step:** A right-of-way obstruction permit must be obtained from Right-of-way Services prior to the commencement of any construction activities within the right-of-way.



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## STORMWATER

3. Next Step: A stormwater control plan with a stormwater operations and maintenance manual and budget shall be approved by the Stormwater Engineer in compliance with Part 10A Chapter 9 of the Unified Development Ordinance.

Next Step: In accordance with Part 10A Section 9.4.4 of the Unified Development Ordinance, a surety equal to of the cost of clearing, grubbing and reseeding a site, shall be paid to the City.

## URBAN FORESTRY

4. Obtain required stub and tree impact permits from the City of Raleigh. (*used with new streets and infrastructure*)
5. Next Step: Prior to the issuance of a mass grading permit or other site permit, whichever comes first, submit a final tree conservation plan with a permit approved by Urban Forestry staff that includes metes and bounds descriptions of all tree conservation areas and tree protection fencing as required.
6. Next Step: Tree protection fence must be located in the field and inspected by Urban Forestry staff prior to the issuance of a mass grading permit or other site permit, whichever comes first.

## PRIOR TO ISSUANCE OF BUILDING PERMITS:

### GENERAL

1. A Final Plat shall be recorded with the Wake County Register of Deeds office for all Subdivisions, Recombinations, Right Of Way and/or Easement Dedications, and Tree Save Areas.

### ENGINEERING

2. The required right of way for proposed and/or existing streets shall be dedicated to the City of Raleigh and is shown on a plat approved for recordation.
3. A 5' general utility easement and associated deed of easement shall be approved by the City and the location of the easement shall be shown on the map approved for recordation. The deed of easement shall be recorded at Wake County Register of Deeds within one (1) day of recordation of the recorded plat. A recorded copy of these documents must be provided to the Development Services Department.
4. In accordance with Part 10A Section 8.1.10, a fee-in-lieu for 1' of sidewalk along Navaho Drive, Executive Drive and Wake Forest Rd shall be paid to the City of Raleigh.
5. That if the proposed public improvements are not installed and inspected by the City to be accepted for maintenance, a surety in the amount of 125% of the cost of construction for the streetscape trees installed on Navaho Drive and Executive Drive is to be paid to the Development Services Department in accordance with code section 8.1.3 of the UDO
6. Required NCDOT encroachment and/or driveway permits must be approved and copies provided to Development Services – Development Engineering.



# Administrative Approval Action

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7. Next Step: A right-of-way obstruction permit shall be obtained from Right-of-way Services for any construction activity within the right-of-way.

## PUBLIC UTILITIES

8. A Final Plat must be recorded at the Wake County Register of Deeds office for all necessary Subdivisions / Recombinations, Right-of-Way, Utility / Stormwater Easement Dedications and/or Tree Save Areas
19. Initiation of the easement exchange process is required (via dedication of new easement on Record Plat, ending with abandonment of old easement on subsequent Deed)
20. Utility re-alignment construction shall be substantially complete (to eliminate conflict with new building)

## STORMWATER

21. Next Step: In accordance with Part 10A Section 8.1.3, a public infrastructure surety shall be provided to the City of Raleigh Development Services – Development Engineering program.

## URBAN FORESTRY

22. A final inspection of required tree conservation and right of way tree protection areas by Urban Forestry staff must be completed.
23. A tree impact permit must be obtained for the approved streetscape tree installation in the right of way.
24. That a final map be recorded showing all tree conservation areas to be established.

## Prior to issuance of building occupancy permit:

1. All Water, Sanitary Sewer and Reuse facilities shall be installed, inspected, tested and accepted by the City of Raleigh Public Utilities Department for operations and maintenance.
2. Next Step: Required public right-of-way infrastructure improvements shall be, at a minimum, sufficiently completed to provide the necessary, safe emergency and vehicular access.
3. Next Step: Required underground storm drainage improvements shall be completed and as-built plan(s) and certification(s) reviewed and accepted by the City of Raleigh Development Services – Development Engineering program.
4. Next Step: All street lights and street signs required as part of the development approval are installed.
5. Next Step: Copies of certified inspection reports for alleys and internal access ways are submitted to the City of Raleigh Development Services – Development Engineering program.
6. Next Step: As-built drawings and associated forms for all Stormwater devices are accepted by the Engineering Services Department
7. Next Step: Final inspection of all required Tree Conservation and right of way tree protection areas by Urban Forestry Staff.



# Administrative Approval Action

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Inpatient Tower and Surgical Expansion  
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**EXPIRATION DATES:** The expiration provisions of UDO Section 10.2.8 E, including the ability to request extensions in the expiration date, apply to this site plan. If significant construction has not taken place on a project after administrative site review approval, that approval may expire and be declared void, requiring re-approval before permits may be issued. To avoid allowing this plan approval to expire the following must take place by the following dates:

**3-Year Expiration Date:** 12-20-2020

Obtain a valid building permit for the total area of the project, or a phase of the project.

**4-Year Completion Date:**

Within four years after issuance of the first building permit for the site plan, the construction of the entire site plan must be completed unless an applicant has been granted vested rights. Failure to complete construction within this specified time frame shall automatically void the approved site plan for which no building permits have been issued.

I hereby certify this administrative decision.

**Signed:** (Planning Dir./Designee) Austin Bily Zl **Date:** 12/20/2017

**Staff Coordinator:** Michael Walters

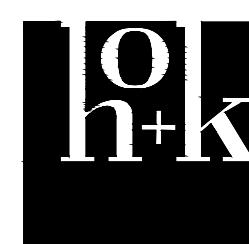


Project  
**NEW INPATIENT TOWER AND SURGERY EXPANSION**  
3400 Wake Forest Road  
Raleigh, North Carolina 27609

Prepared For  
**Duke Raleigh Hospital**  
Duke University Medical Center & Health System  
2200 West Main Street, Suite 650  
Durham, North Carolina 27705

**Duke Raleigh Hospital**  
DUKE UNIVERSITY HEALTH SYSTEM

Contract No



Hellmuth, Obata + Kassabaum, Inc.  
Canal House, 3223 Grace Street, N.W.  
Washington, DC 20007 USA  
t +1 202 339 8700 f +1 202 339 8800

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Key Plan

SCALE: 1"=60'  
0 30' 60' 120'

Professional Seals  
2ND CAROLINA  
LINDA J. VAST  
10/10/17  
NOT FOR CONSTRUCTION

No. Description Date  
1 ADMIN. SITE PLAN - 3RD SUBMITTAL 10/10/17

NEW INPATIENT TOWER AND SURGERY EXPANSION

Date of First Issue: 2017-07-21

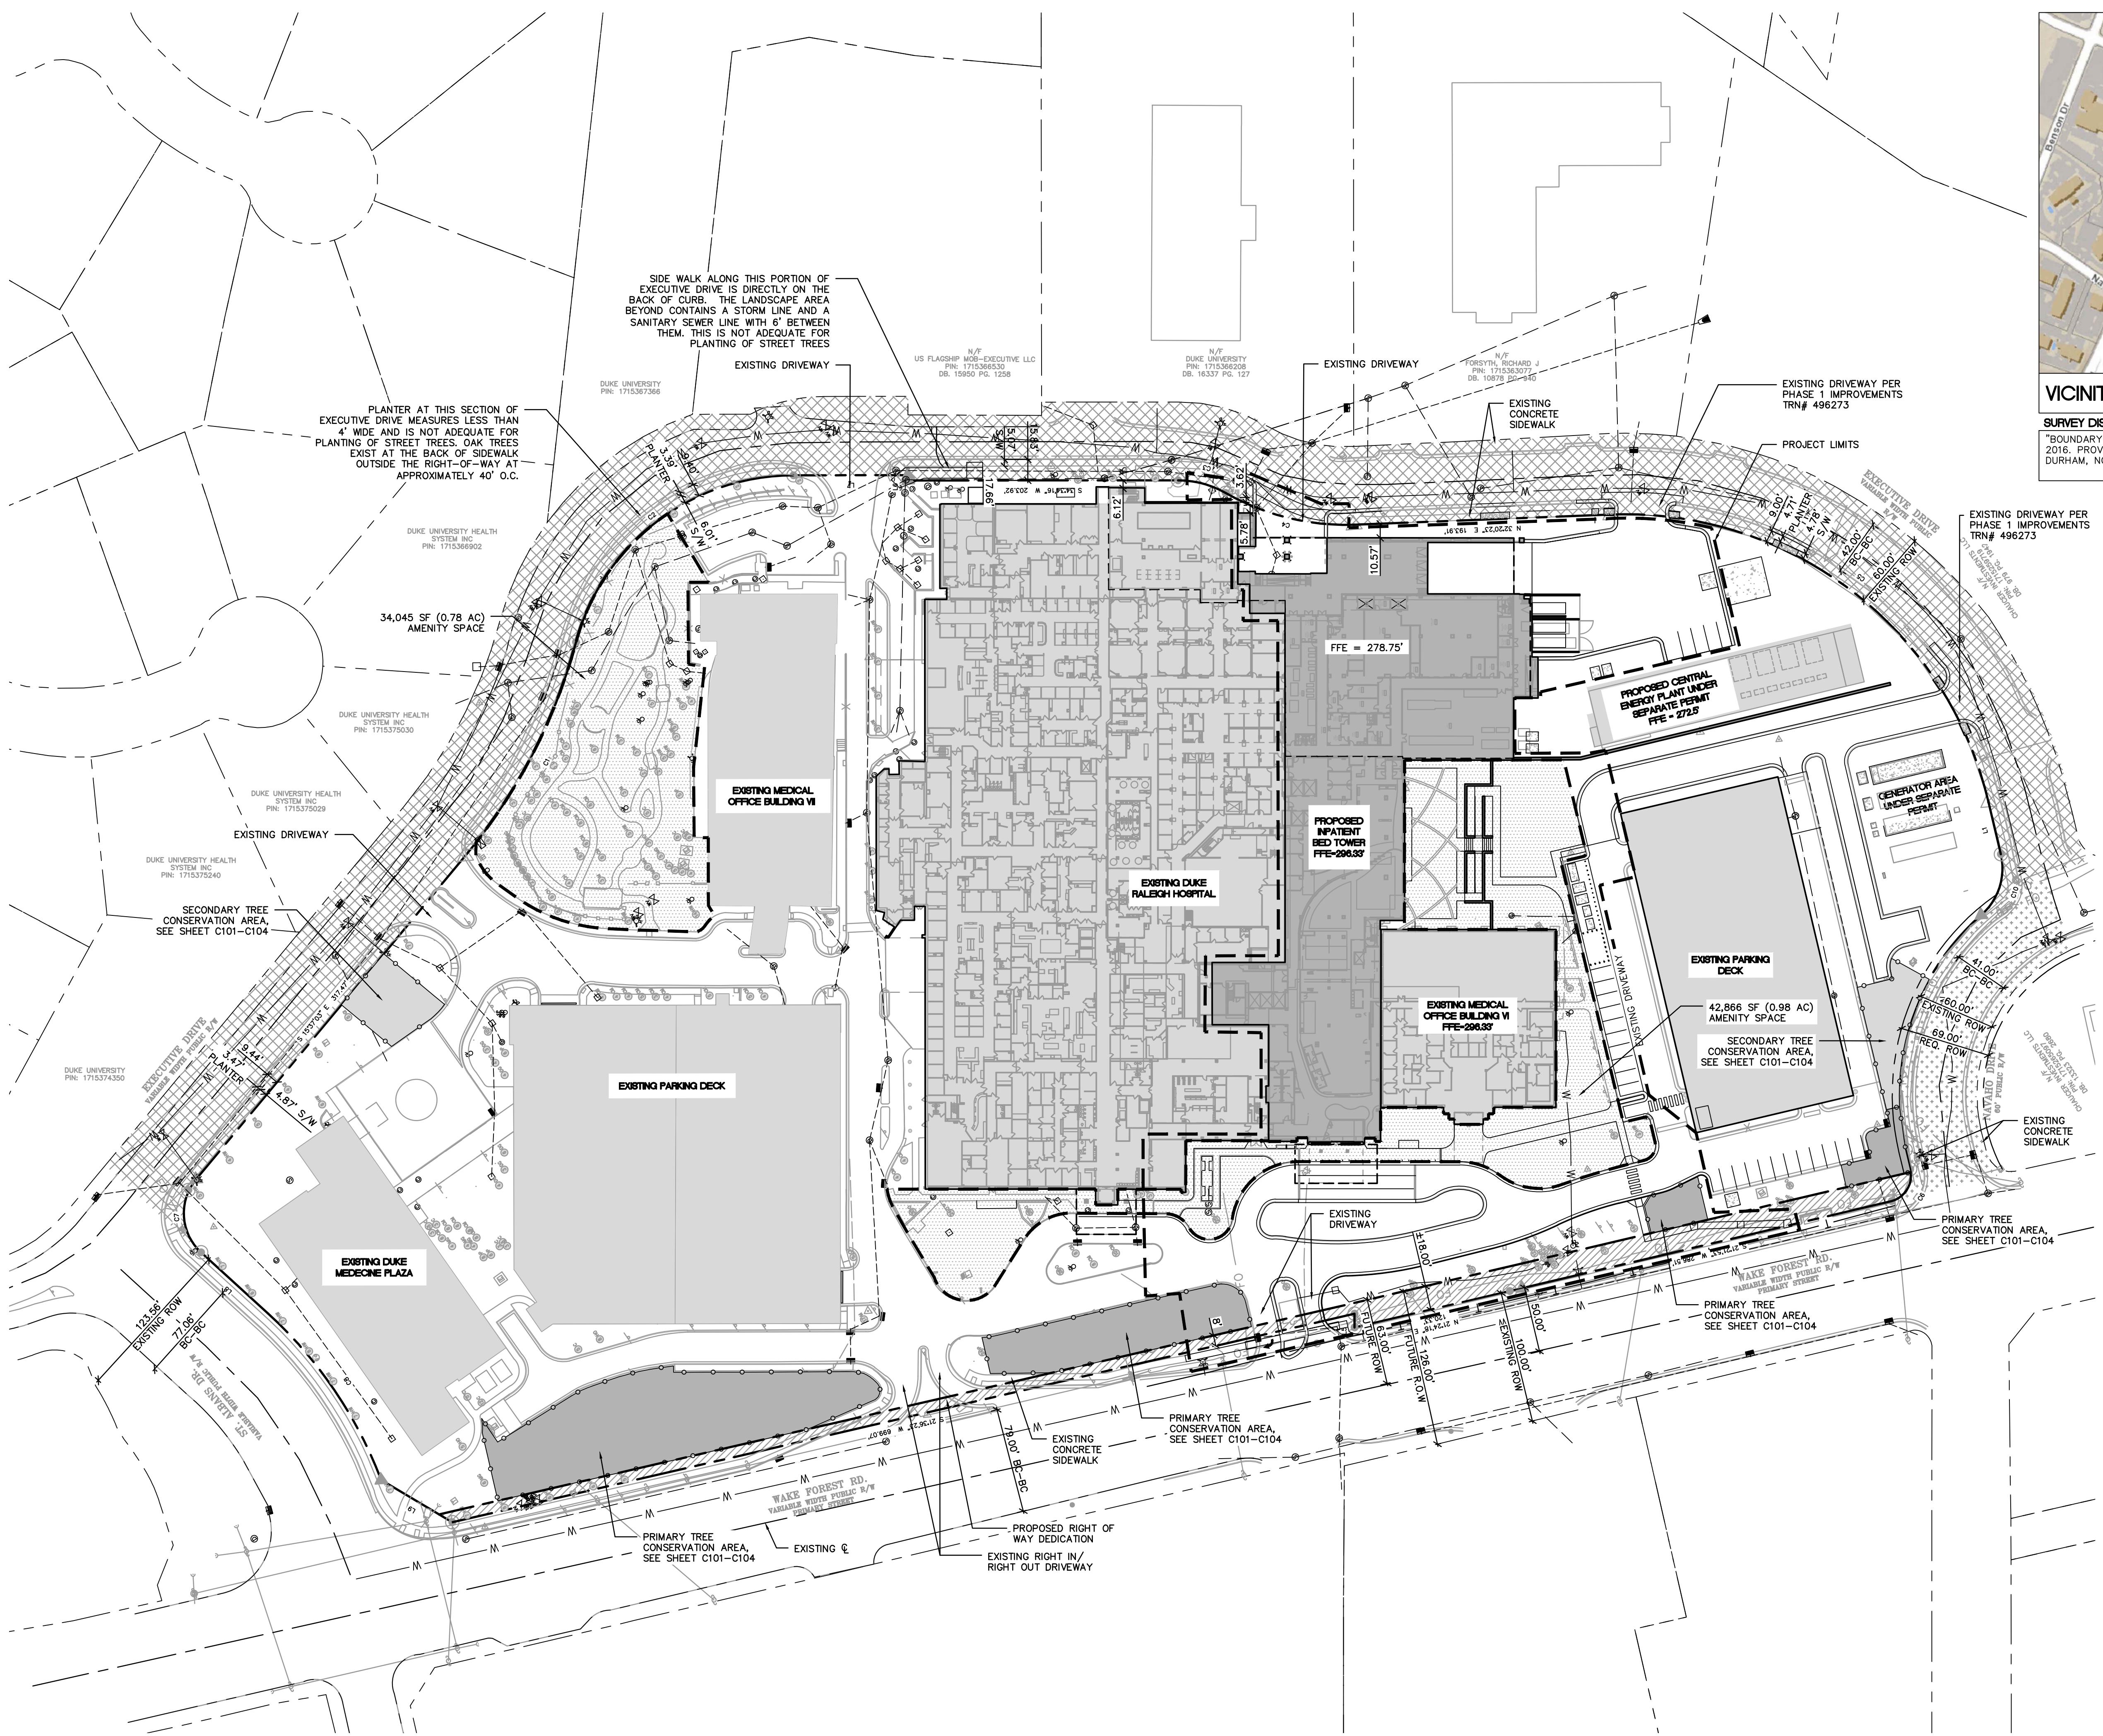
Project No.: 50425.00

Sheet Title

OVERALL  
CAMPUS PLAN

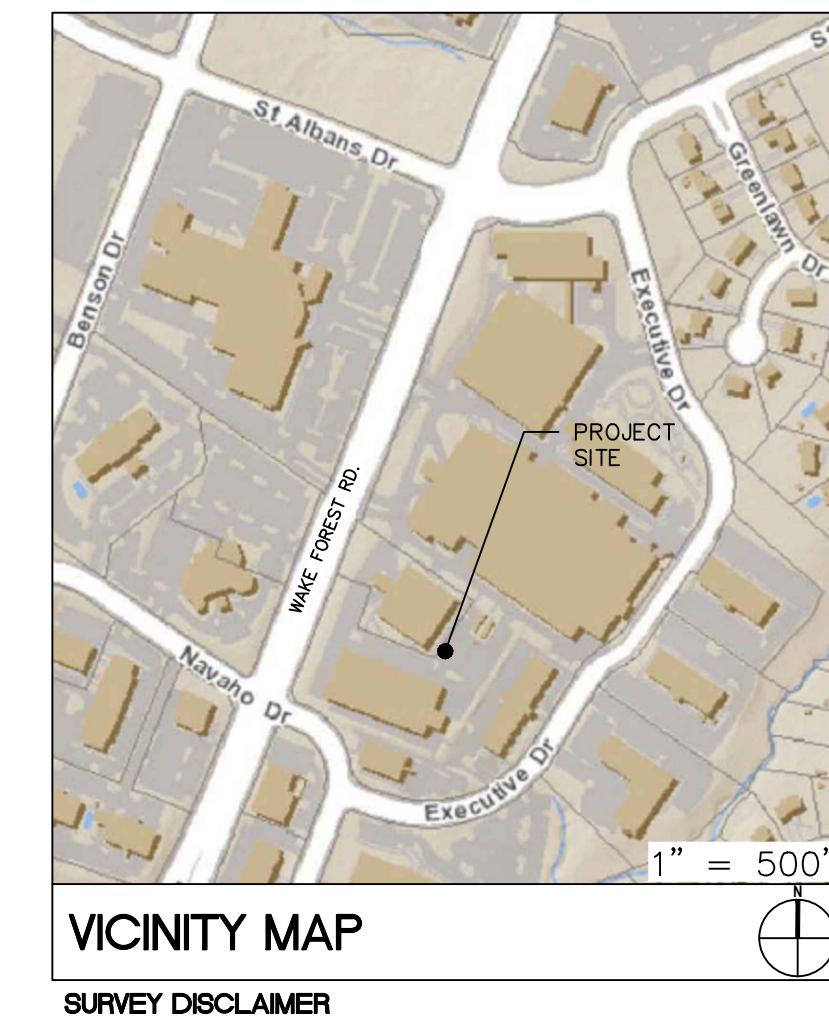
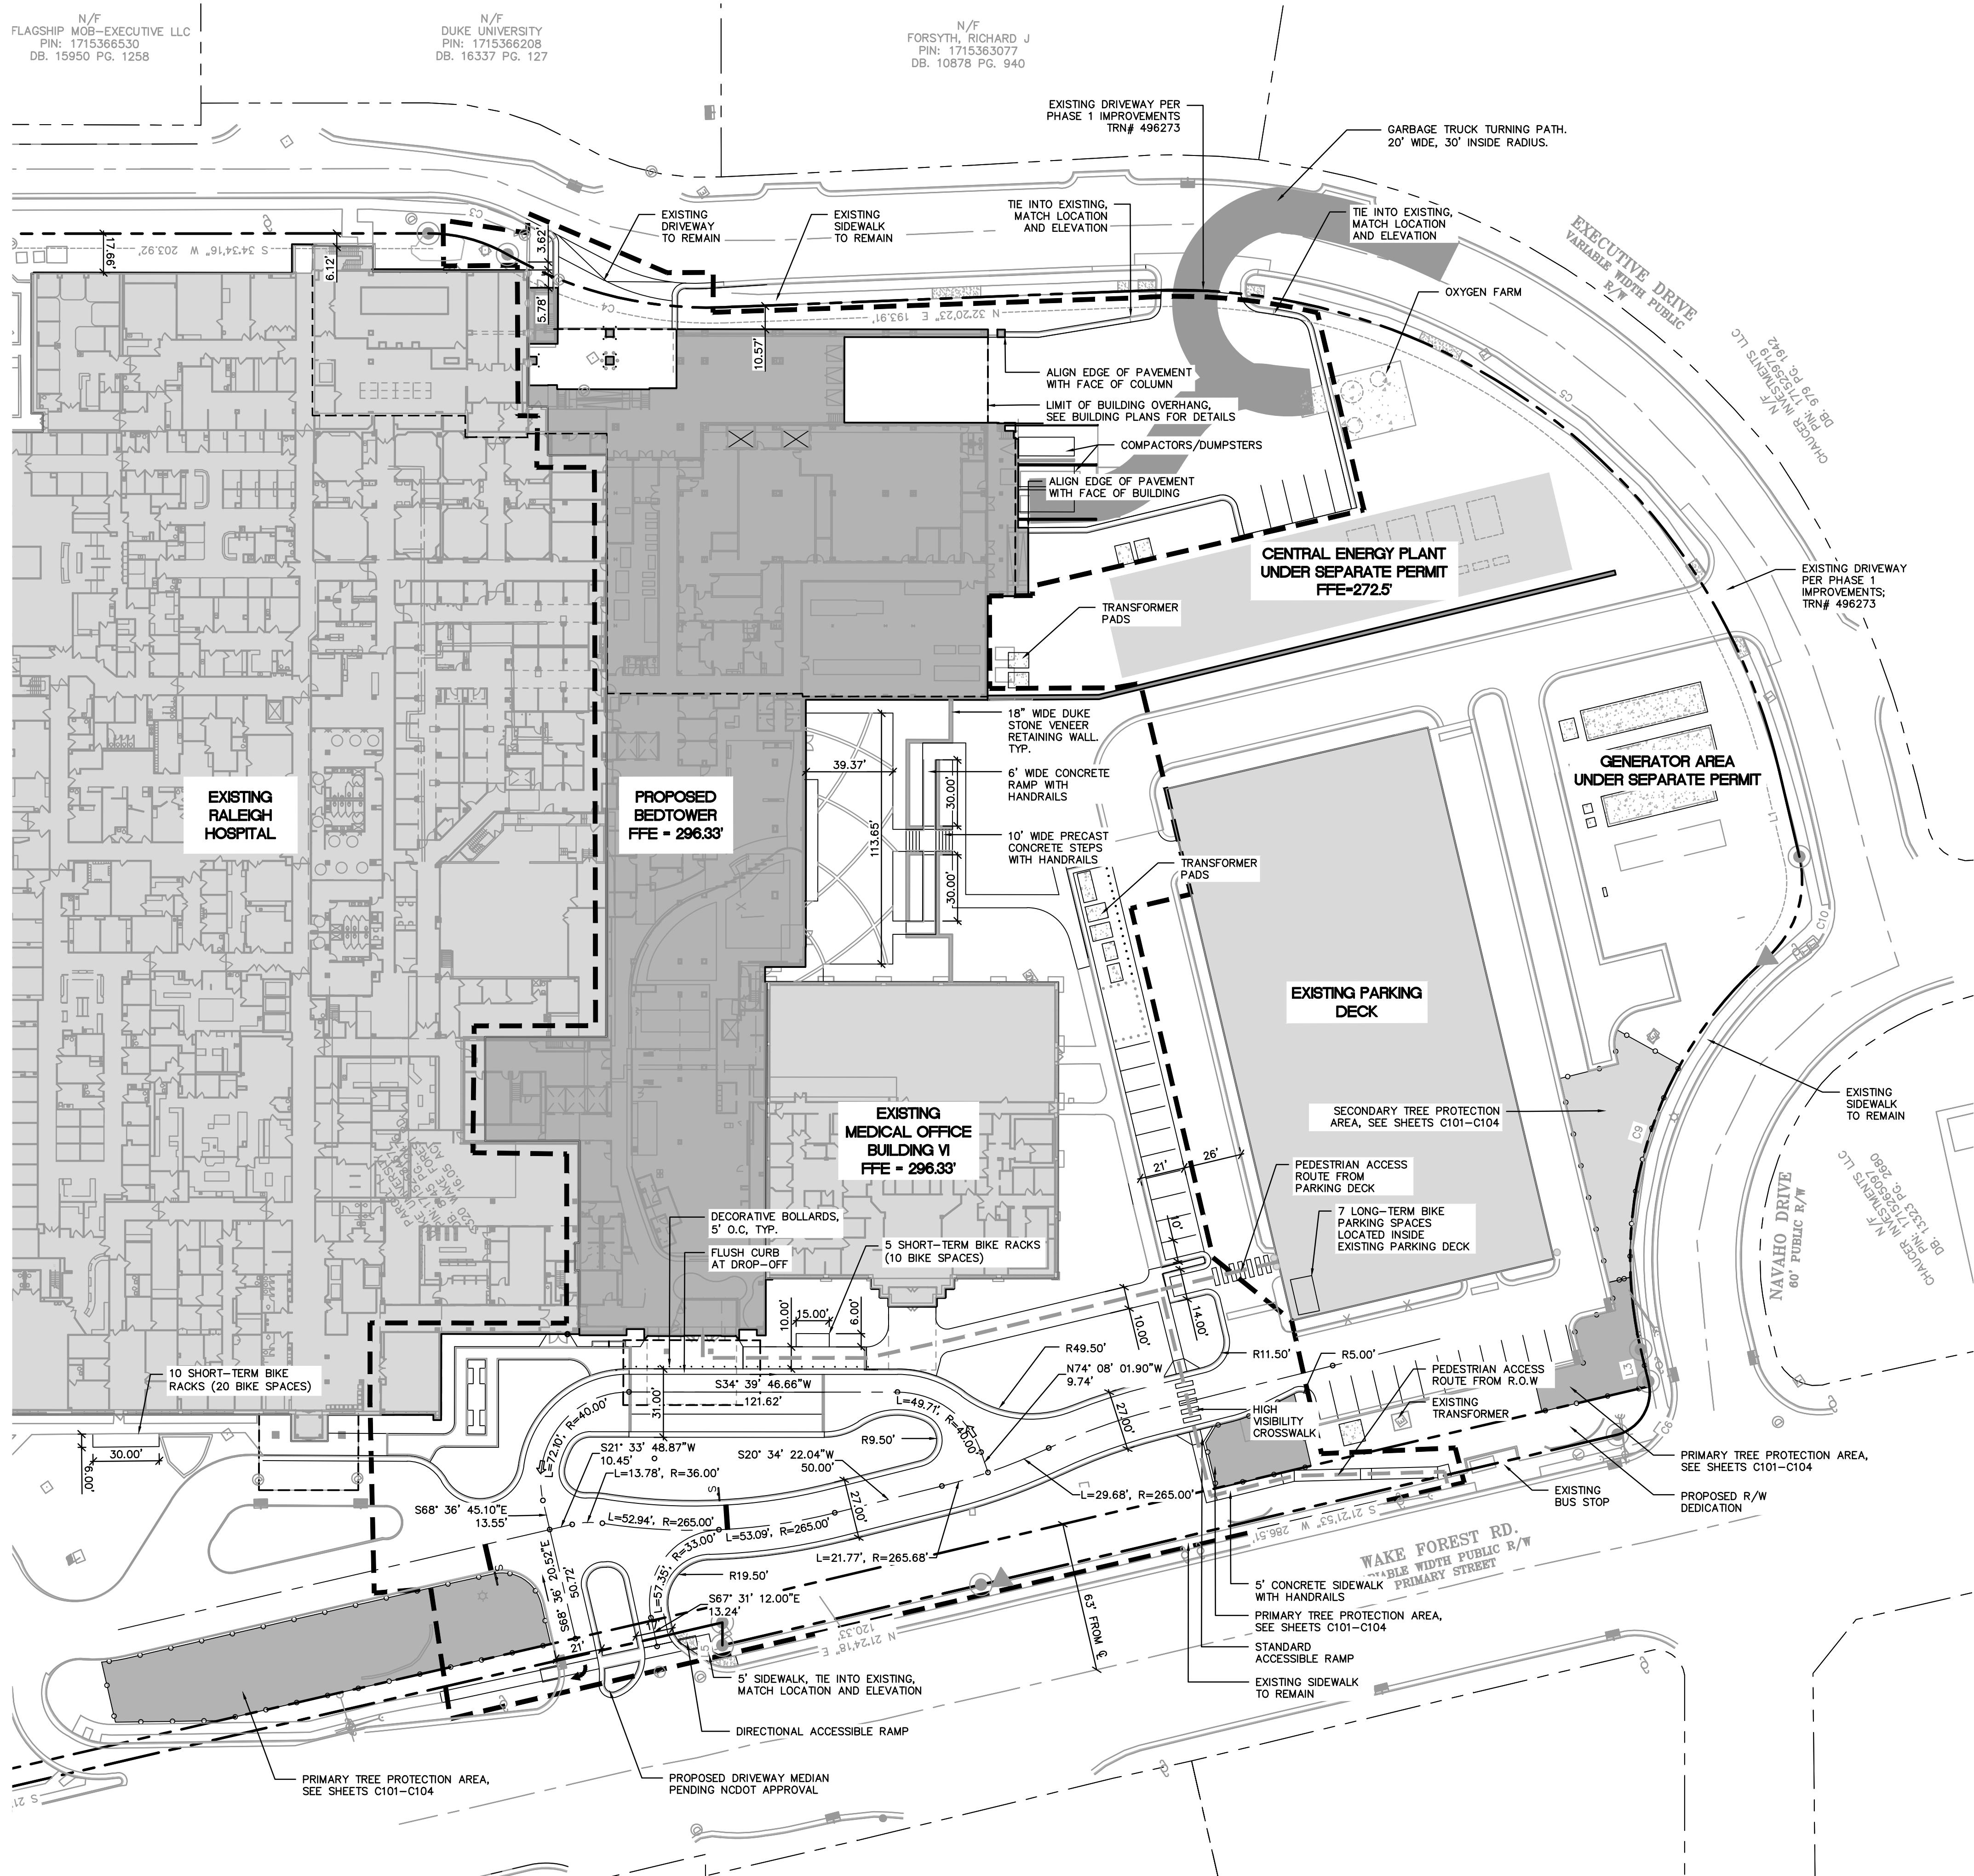
Original drawing is 24 x 36. Do not scale contents of this drawing.  
Sheet Number

**C100**



N/F FLAGSHIP MOB-EXECUTIVE LLC PIN: 1715366530 DB. 15950 PG. 1258		N/F DUKE UNIVERSITY PIN: 1715366208 DB. 16337 PG. 127
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N/F  
FORSYTH, RICHARD J  
PIN: 1715363077  
DB: 10878 PG: 940

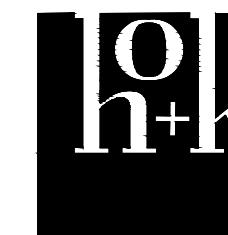


Project  
**NEW INPATIENT TOWER  
AND SURGERY EXPANSION**

Prepared For  
**Duke Raleigh Hospital**  
Duke University Medical Center & Health  
System  
2200 West Main Street, Suite 650  
Durham, North Carolina 27705

Duke Raleigh Hospital  
DUKE UNIVERSITY HEALTH SYSTEM

**Contract No**



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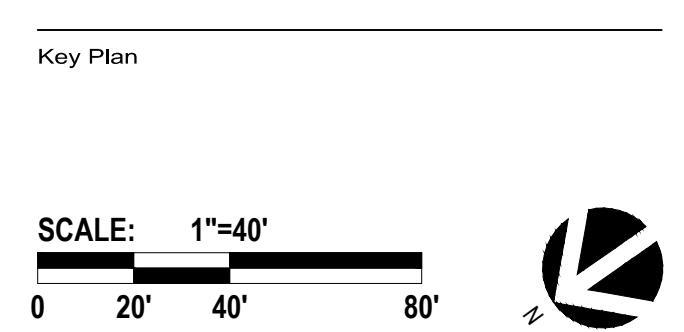


**ColeJenest  
& Stone**  
119 East Hargett Street, Suite 300  
Raleigh, North Carolina 27601  
P: 919 719 1800

MEP Engineers

The logo for Affiliated Engineers features a stylized 'AE' monogram where the 'A' and 'E' are interconnected. To the right of the monogram, the word 'Affiliated' is written in a bold, sans-serif font, and 'Engineers' is written below it in a slightly smaller, bold, sans-serif font. A registered trademark symbol (®) is located at the top right corner of the 'Engineers' word.

P: 919 41



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NEW INPATIENT TOWER AND  
SURGERY EXPANSION

Date of First Issue: 2017-

Project No: 50425.00

## Sheet Title

1. CONTRACTOR IS FULLY RESPONSIBLE FOR CONTACTING APPROPRIATE PARTIES AND ENSURING THAT ALL EXISTING UTILITIES ARE LOCATED PRIOR TO CONSTRUCTION.
  2. CONTRACTOR IS RESPONSIBLE FOR PLACING BARRICADES, USING FLAG MEN, ETC., AS NECESSARY TO ENSURE THE SAFETY OF THE PUBLIC.
  3. ALL PAVEMENT CUTS, CONCRETE OR ASPHALT, ARE TO BE REPLACED ACCORDING TO THE STANDARDS OF THE NORTH CAROLINA DEPARTMENT OF TRANSPORTATION, OR LOCAL JURISDICTION, WHICHEVER IS MORE STRINGENT.
  4. SHORING SHALL BE IN ACCORDANCE WITH OSHA TRENCHING STANDARDS, 29 CFR, PART 1926, SUBPART P, OR AS AMENDED.

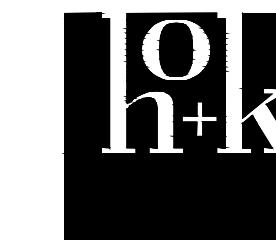
C200

Project  
**NEW INPATIENT TOWER AND SURGERY EXPANSION**  
 3400 Wake Forest Road  
 Raleigh, North Carolina 27609

Prepared For  
**Duke Raleigh Hospital**  
 Duke University Medical Center & Health System  
 2200 West Main Street, Suite 650  
 Durham, North Carolina 27705

**Duke Raleigh Hospital**  
 DUKE UNIVERSITY HEALTH SYSTEM

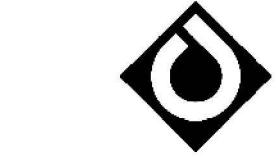
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 P: 919 419 9802

Key Plan

SCALE: 1"=40'  
 0 20' 40' 80'

Professional Seals  
 STATE OF NORTH CAROLINA  
 ENGINEER IN CHIEF  
 LINDA J. VASL  
 MCARL  
 10/10/17

NOT FOR CONSTRUCTION

No. Description Date  
 1 ADMIN. SITE PLAN - 3RD SUBMITTAL 10/10/17

NEW INPATIENT TOWER AND SURGERY EXPANSION  
 Date of First Issue: 2017-07-21

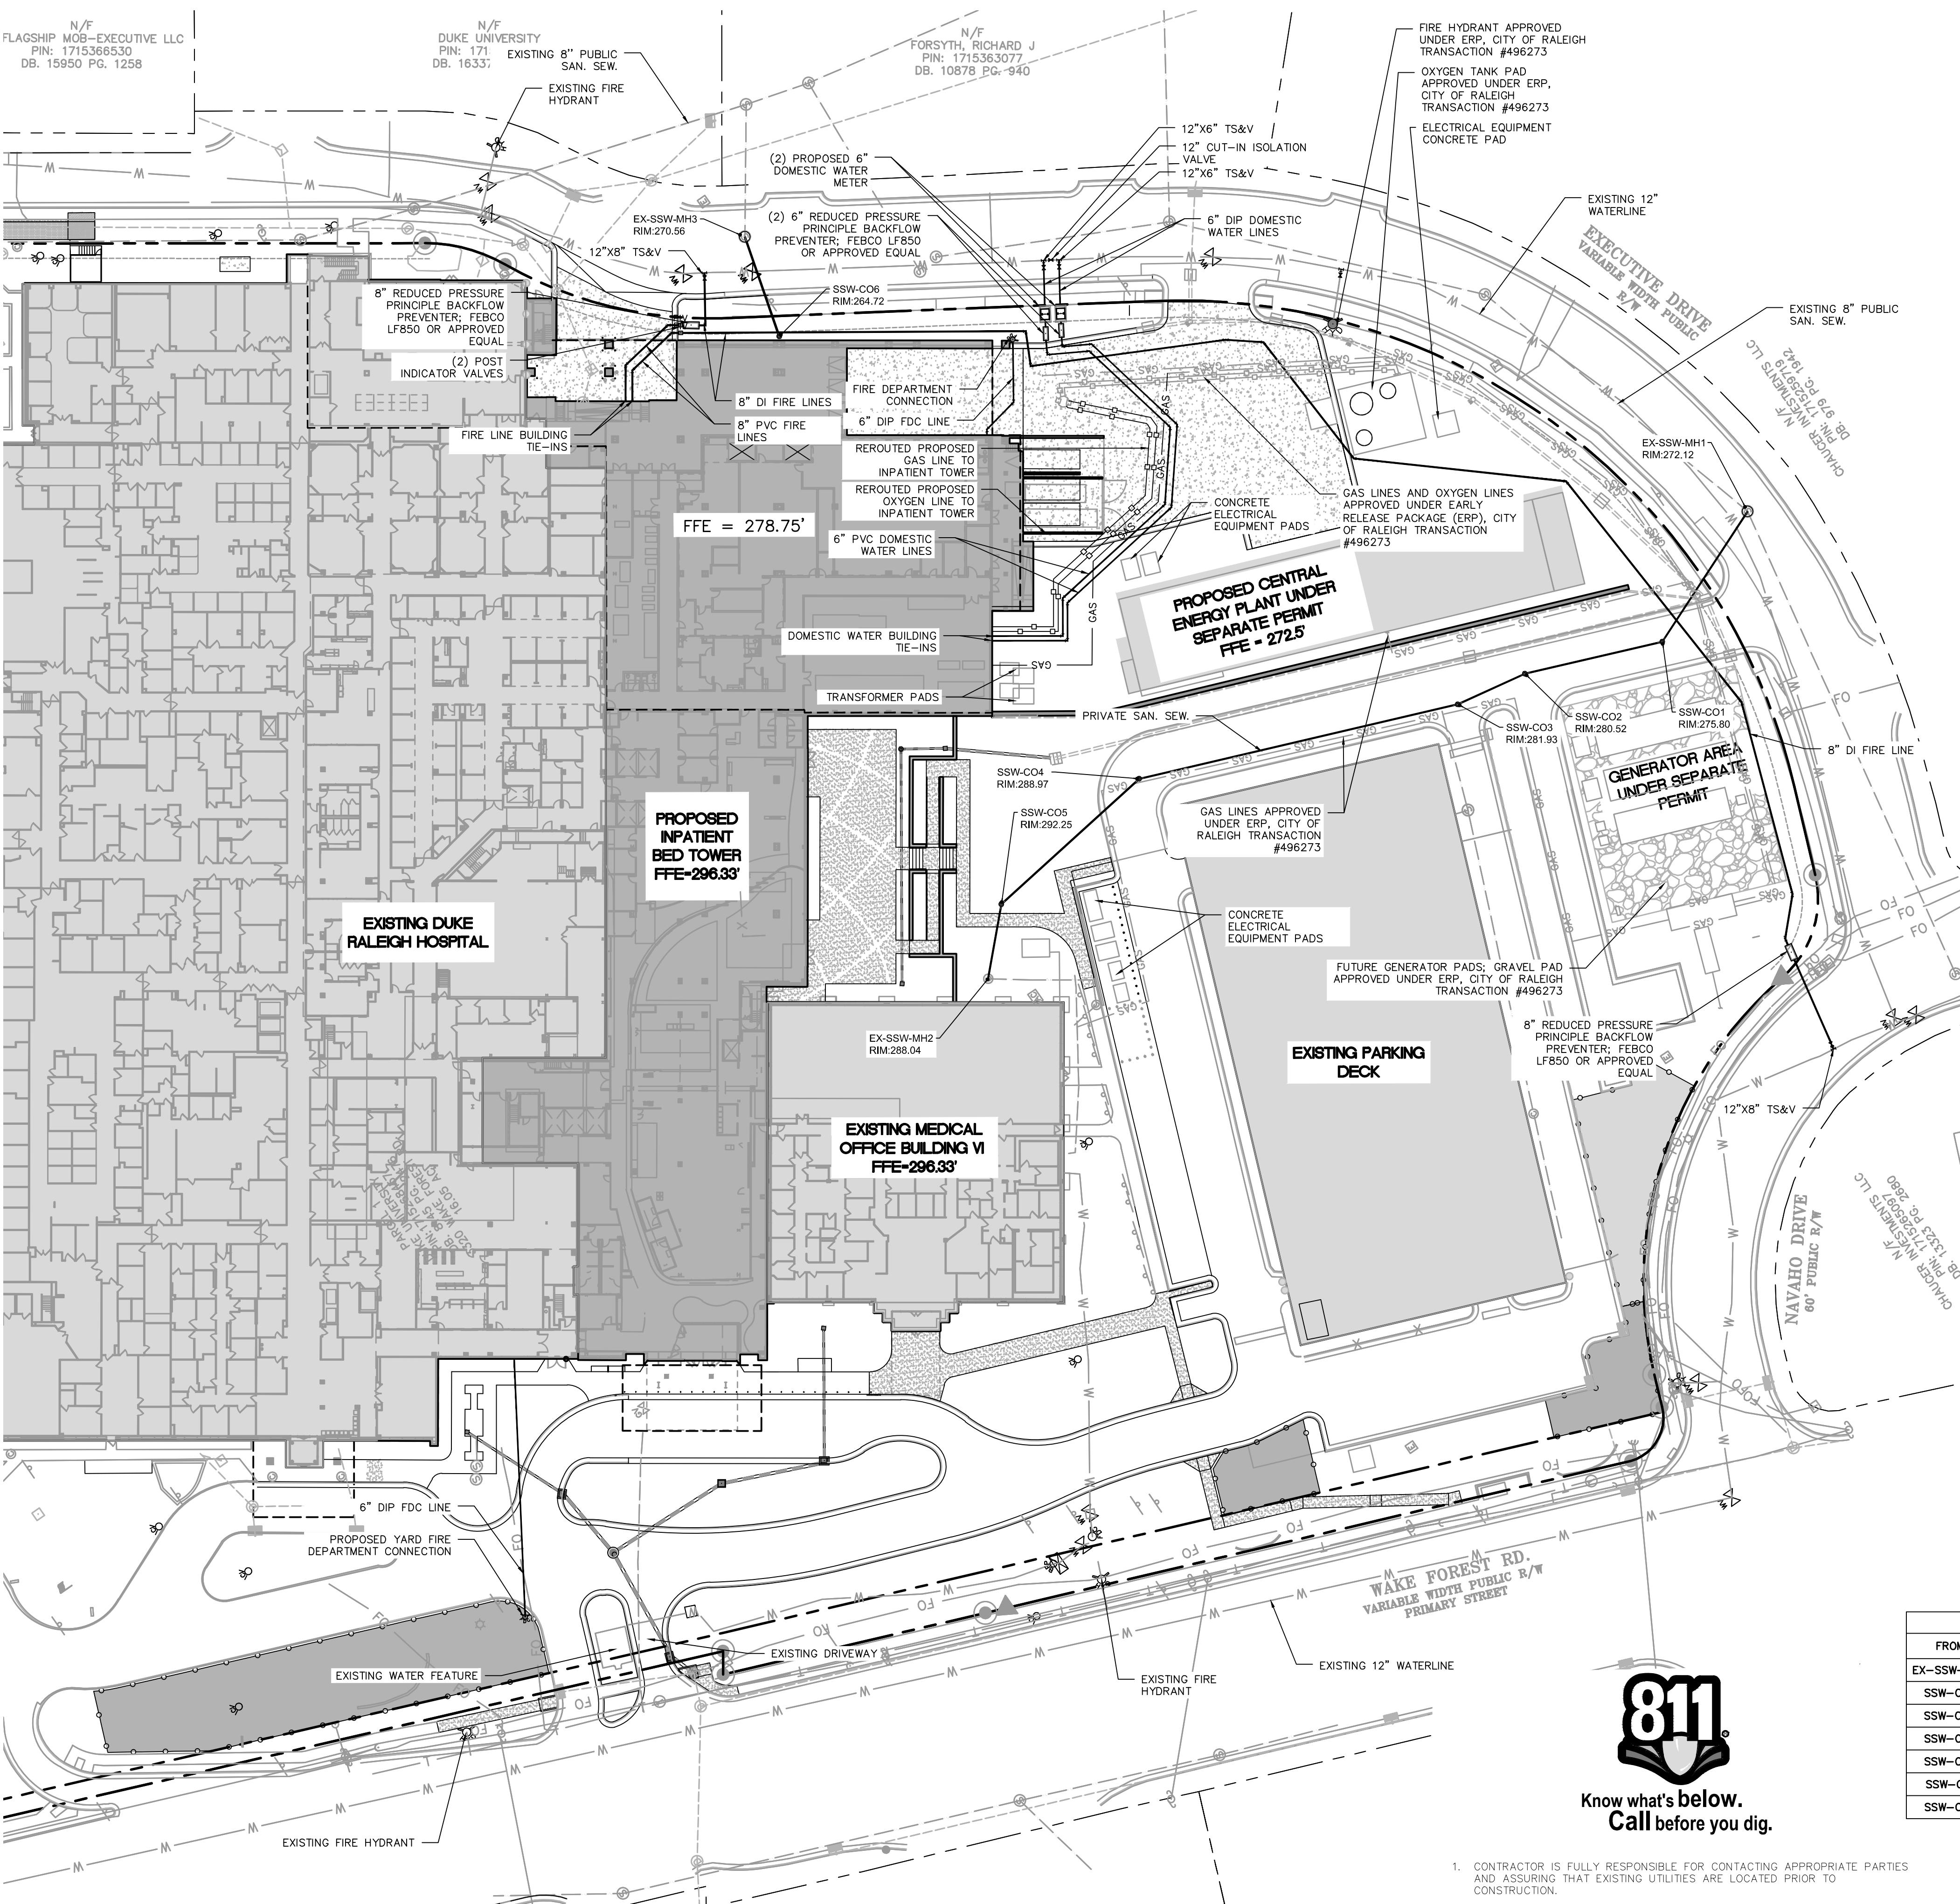
Project No.: 50425.00

Sheet Title

SITE UTILITY PLAN

Original drawing is 24 x 36. Do not scale contents of this drawing.  
 Sheet Number

**C500**

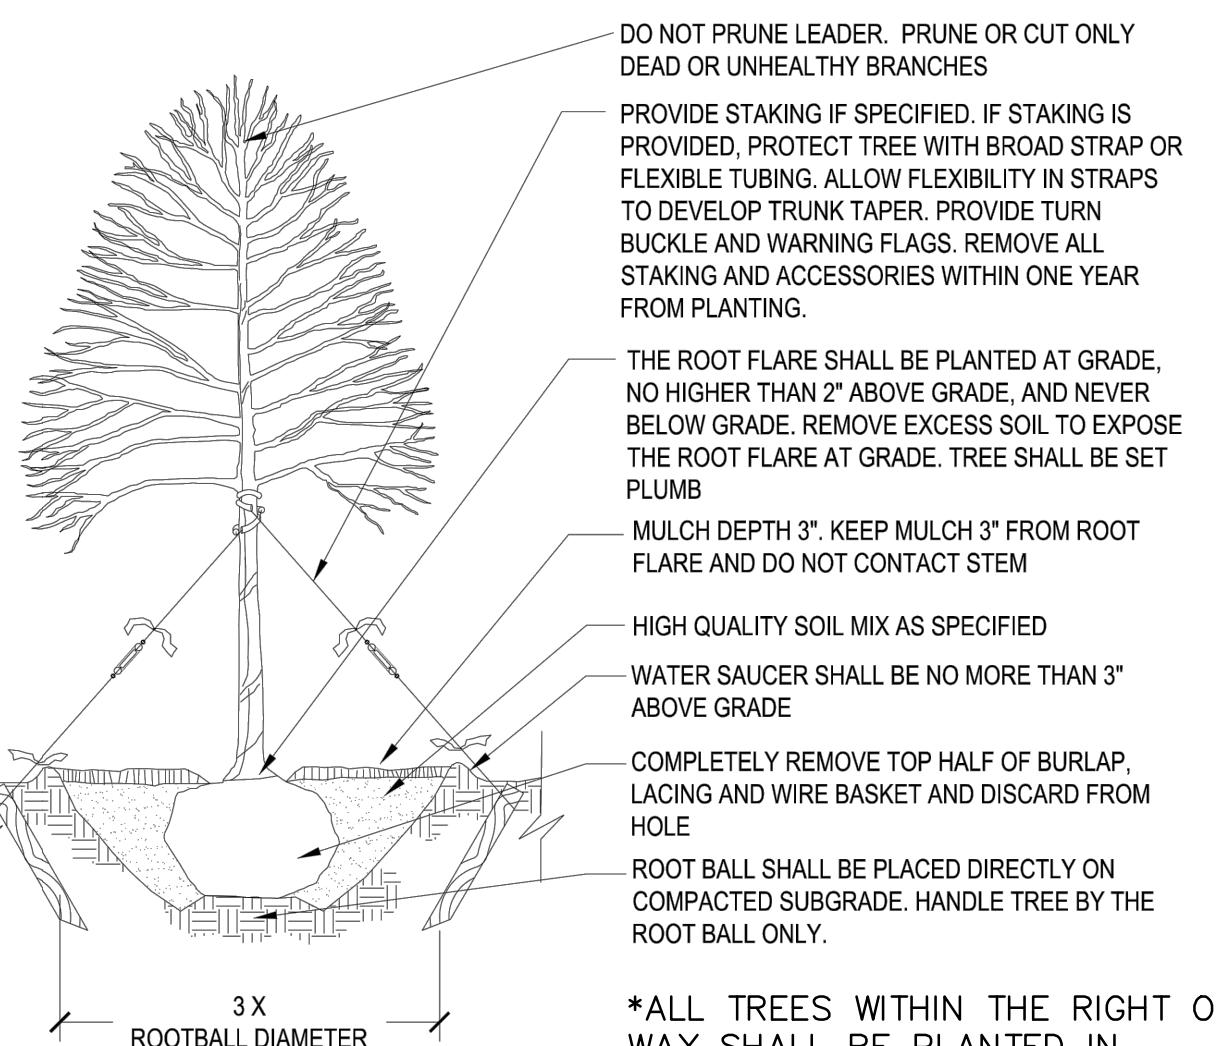
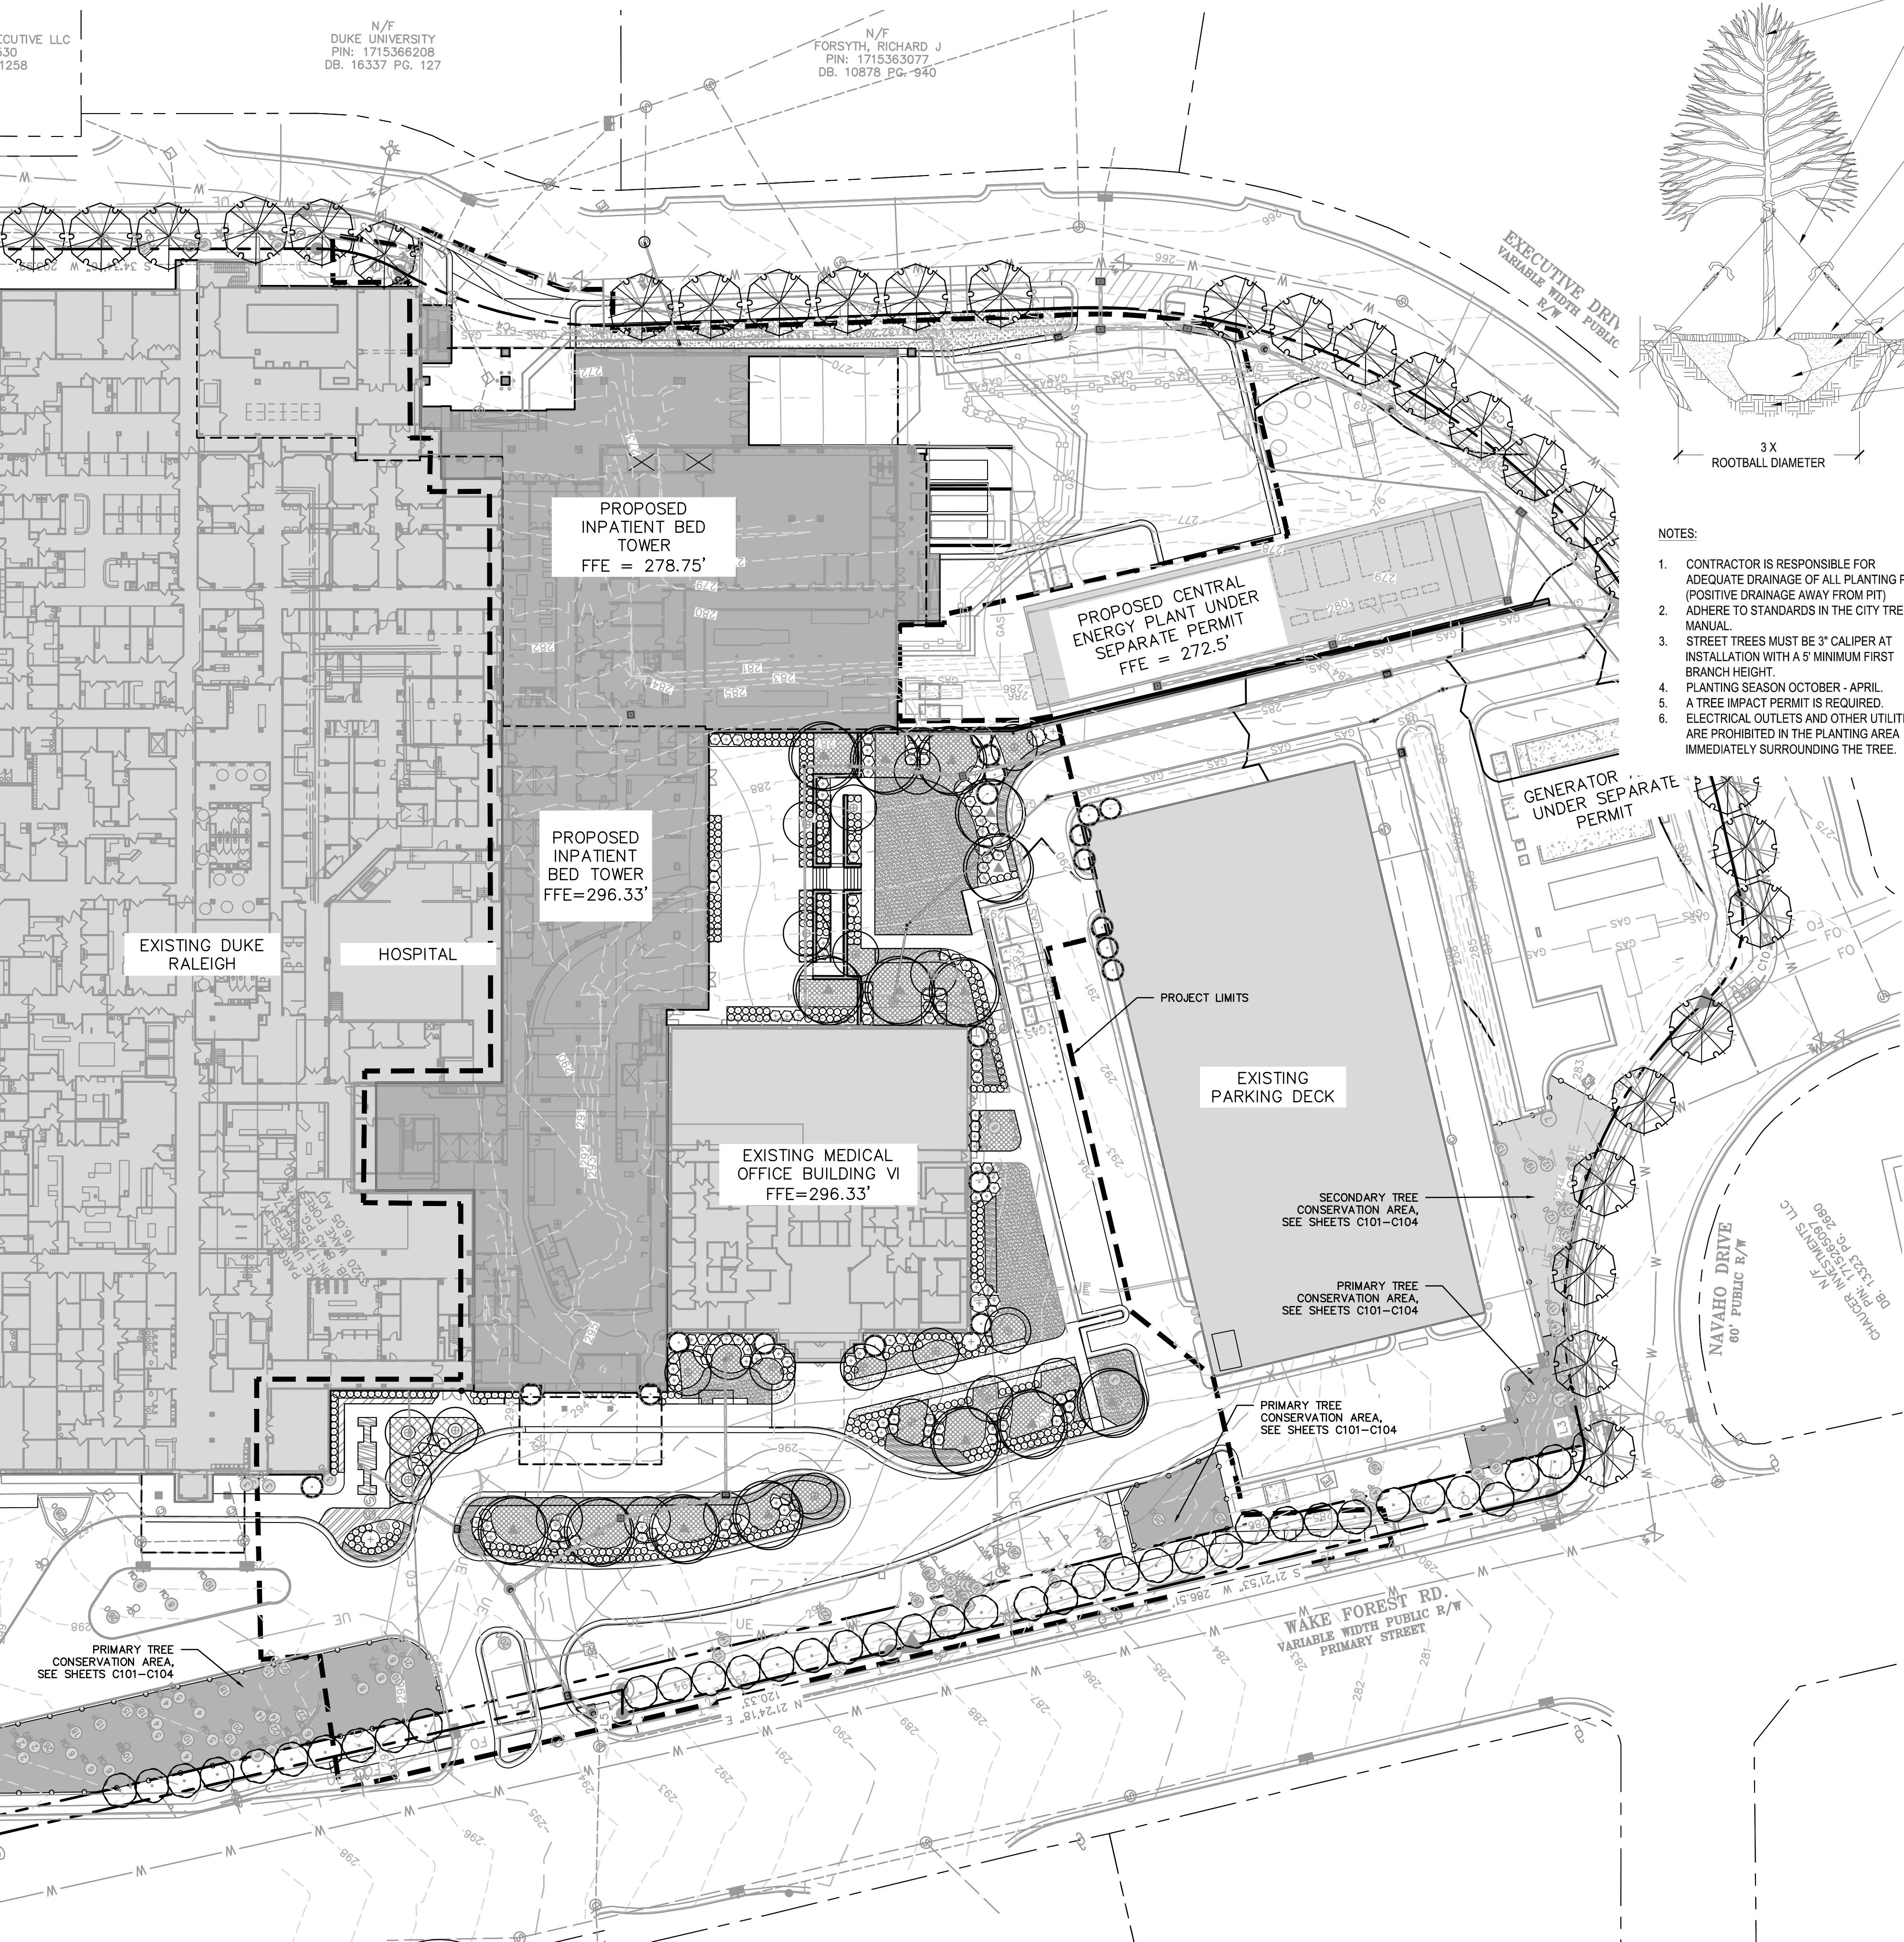


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2. CONTRACTOR IS RESPONSIBLE FOR PLACING BARRICADES USING FLAG MEN, ETC. AS NECESSARY TO INSURE SAFETY TO THE PUBLIC.
3. ALL PAVEMENT CUTS, CONCRETE OR ASPHALT, ARE TO BE REPLACED ACCORDING TO STANDARDS OF THE NORTH CAROLINA DEPARTMENT OF TRANSPORTATION AND CITY OF RALEIGH SPECIFICATIONS.
4. SHORING WILL BE ACCORDING TO OSHA TRENCHING STANDARDS PART 1926 SUBPART P, OR AS AMENDED.

SANITARY SEWER SCHEDULE							
FROM	TO	SIZE (IN)	MATERIAL	LENGTH (FT)	SLOPE (FT/FT)	INV UP (FT)	INV DN (FT)
EX-SSW-MH2	SSW-C05	6"	PVC	34	0.0089	287.50	287.20
SSW-C05	SSW-C04	6"	PVC	83	0.0270	287.00	284.75
SSW-C04	SSW-C03	6"	PVC	146	0.0318	279.85	275.20
SSW-C03	SSW-C02	6"	PVC	33	0.0304	275.00	274.00
SSW-C02	SSW-C01	6"	PVC	63	0.0516	271.25	268.00
SSW-C01	EX-SSW-MH1	6"	PVC	70	0.0431	265.00	262.00
SSW-C06	EX-SSW-MH3	8"	PVC	47	0.0140	261.20	260.54

CUTIVE LLC  
i30  
1258  
N/F  
DUKE UNIVERSITY  
PIN: 1715366208  
DB: 16337 PG. 127

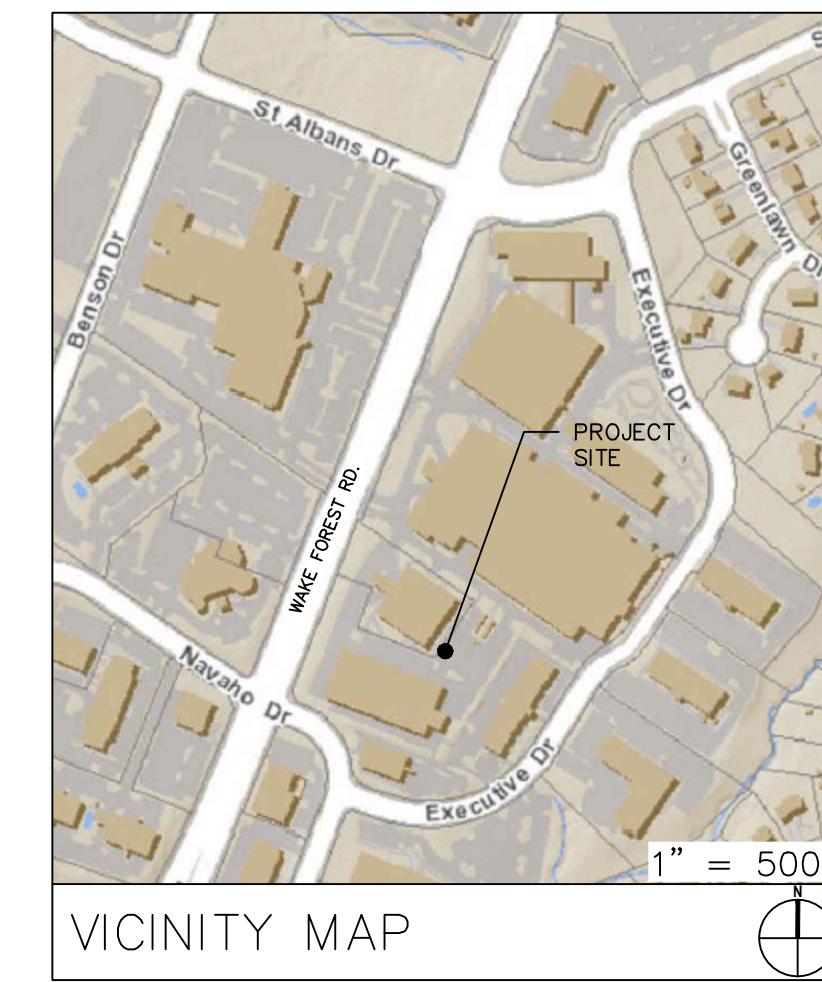
N/A  
FORSYTH, RICHARD J  
PIN: 1715363077  
DB: 10878 PG. 940



\*ALL TREES WITHIN THE RIGHT OF WAY SHALL BE PLANTED IN ACCORDANCE WITH THIS DETAIL.

NOTES:

1. CONTRACTOR IS RESPONSIBLE FOR ADEQUATE DRAINAGE OF ALL PLANTING PITS. (POSITIVE DRAINAGE AWAY FROM PIT)
2. ADHERE TO STANDARDS IN THE CITY TREE MANUAL.
3. STREET TREES MUST BE 3" CALIPER AT INSTALLATION WITH A 5" MINIMUM FIRST BRANCH HEIGHT.
4. PLANTING SEASON OCTOBER - APRIL
5. A TREE IMPACT PERMIT IS REQUIRED
6. ELECTRICAL OUTLETS AND OTHER UTILITIES ARE PROHIBITED IN THE PLANTING AREA IMMEDIATELY SURROUNDING THE TREE.



VICINITY MAP  
SURVEY DISCLAIMER  
"BOUNDARY AND TOPOGRAPHIC SURVEY" ISSUE DATE MAY 18, 2016. PROVIDED BY MCADAMS, 2905 MERIDIAN PARKWAY, DURHAM, NC 27713.

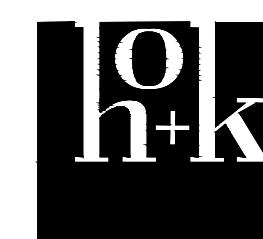


Project  
**NEW INPATIENT TOWER AND SURGERY EXPANSION**  
3400 Wake Forest Road  
Raleigh, North Carolina 27609

Prepared For  
**Duke Raleigh Hospital**  
Duke University Medical Center & Health System  
2200 West Main Street, Suite 650  
Durham, North Carolina 27705

**Duke Raleigh Hospital**  
DUKE UNIVERSITY HEALTH SYSTEM

Contract No \_\_\_\_\_



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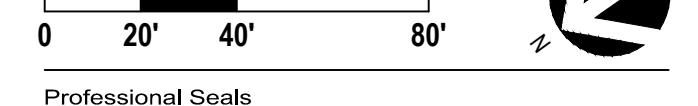
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1414 Raleigh Road, Suite 305  
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Key Plan

SCALE: 1"=40'



NOT FOR CONSTRUCTION  
ROBERT T. BEAL  
7/21/17

No.	Description	Date
1	ADMIN. SITE PLAN - 3RD SUBMITTAL	10/10/17

NEW INPATIENT TOWER AND SURGERY EXPANSION  
Date of First Issue: 2017-07-21

Project No.: 50425.00  
Sheet Title

## OVERALL PLANTING PLAN

Original drawing is 24 x 36. Do not scale contents of this drawing.  
Sheet Number



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4. SHORING SHALL BE IN ACCORDANCE WITH OSHA TRENCHING STANDARDS, 29 CFR, PART 1926, SUBPART P, OR AS AMENDED.

L300



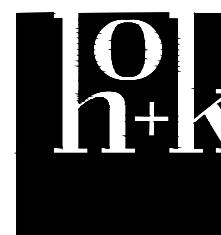
DukeHealth

Project  
**NEW INPATIENT TOWER  
AND SURGERY EXPANSION**  
3400 Wake Forest Road  
Raleigh, North Carolina 27609

Prepared For  
**Duke Raleigh Hospital**  
Duke University Medical Center & Health  
System  
2200 West Main Street, Suite 650  
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 Duke Raleigh Hospital  
DUKE UNIVERSITY HEALTH SYSTEM

**Contract No**



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## Key Plan



# NOT FOR CONSTRUCTION

No.	Description	Date
1	ADMIN. SITE PLAN - 3RD SUBMITTAL	10/10/17

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## **NEW INPATIENT TOWER AND SURGERY EXPANSION**

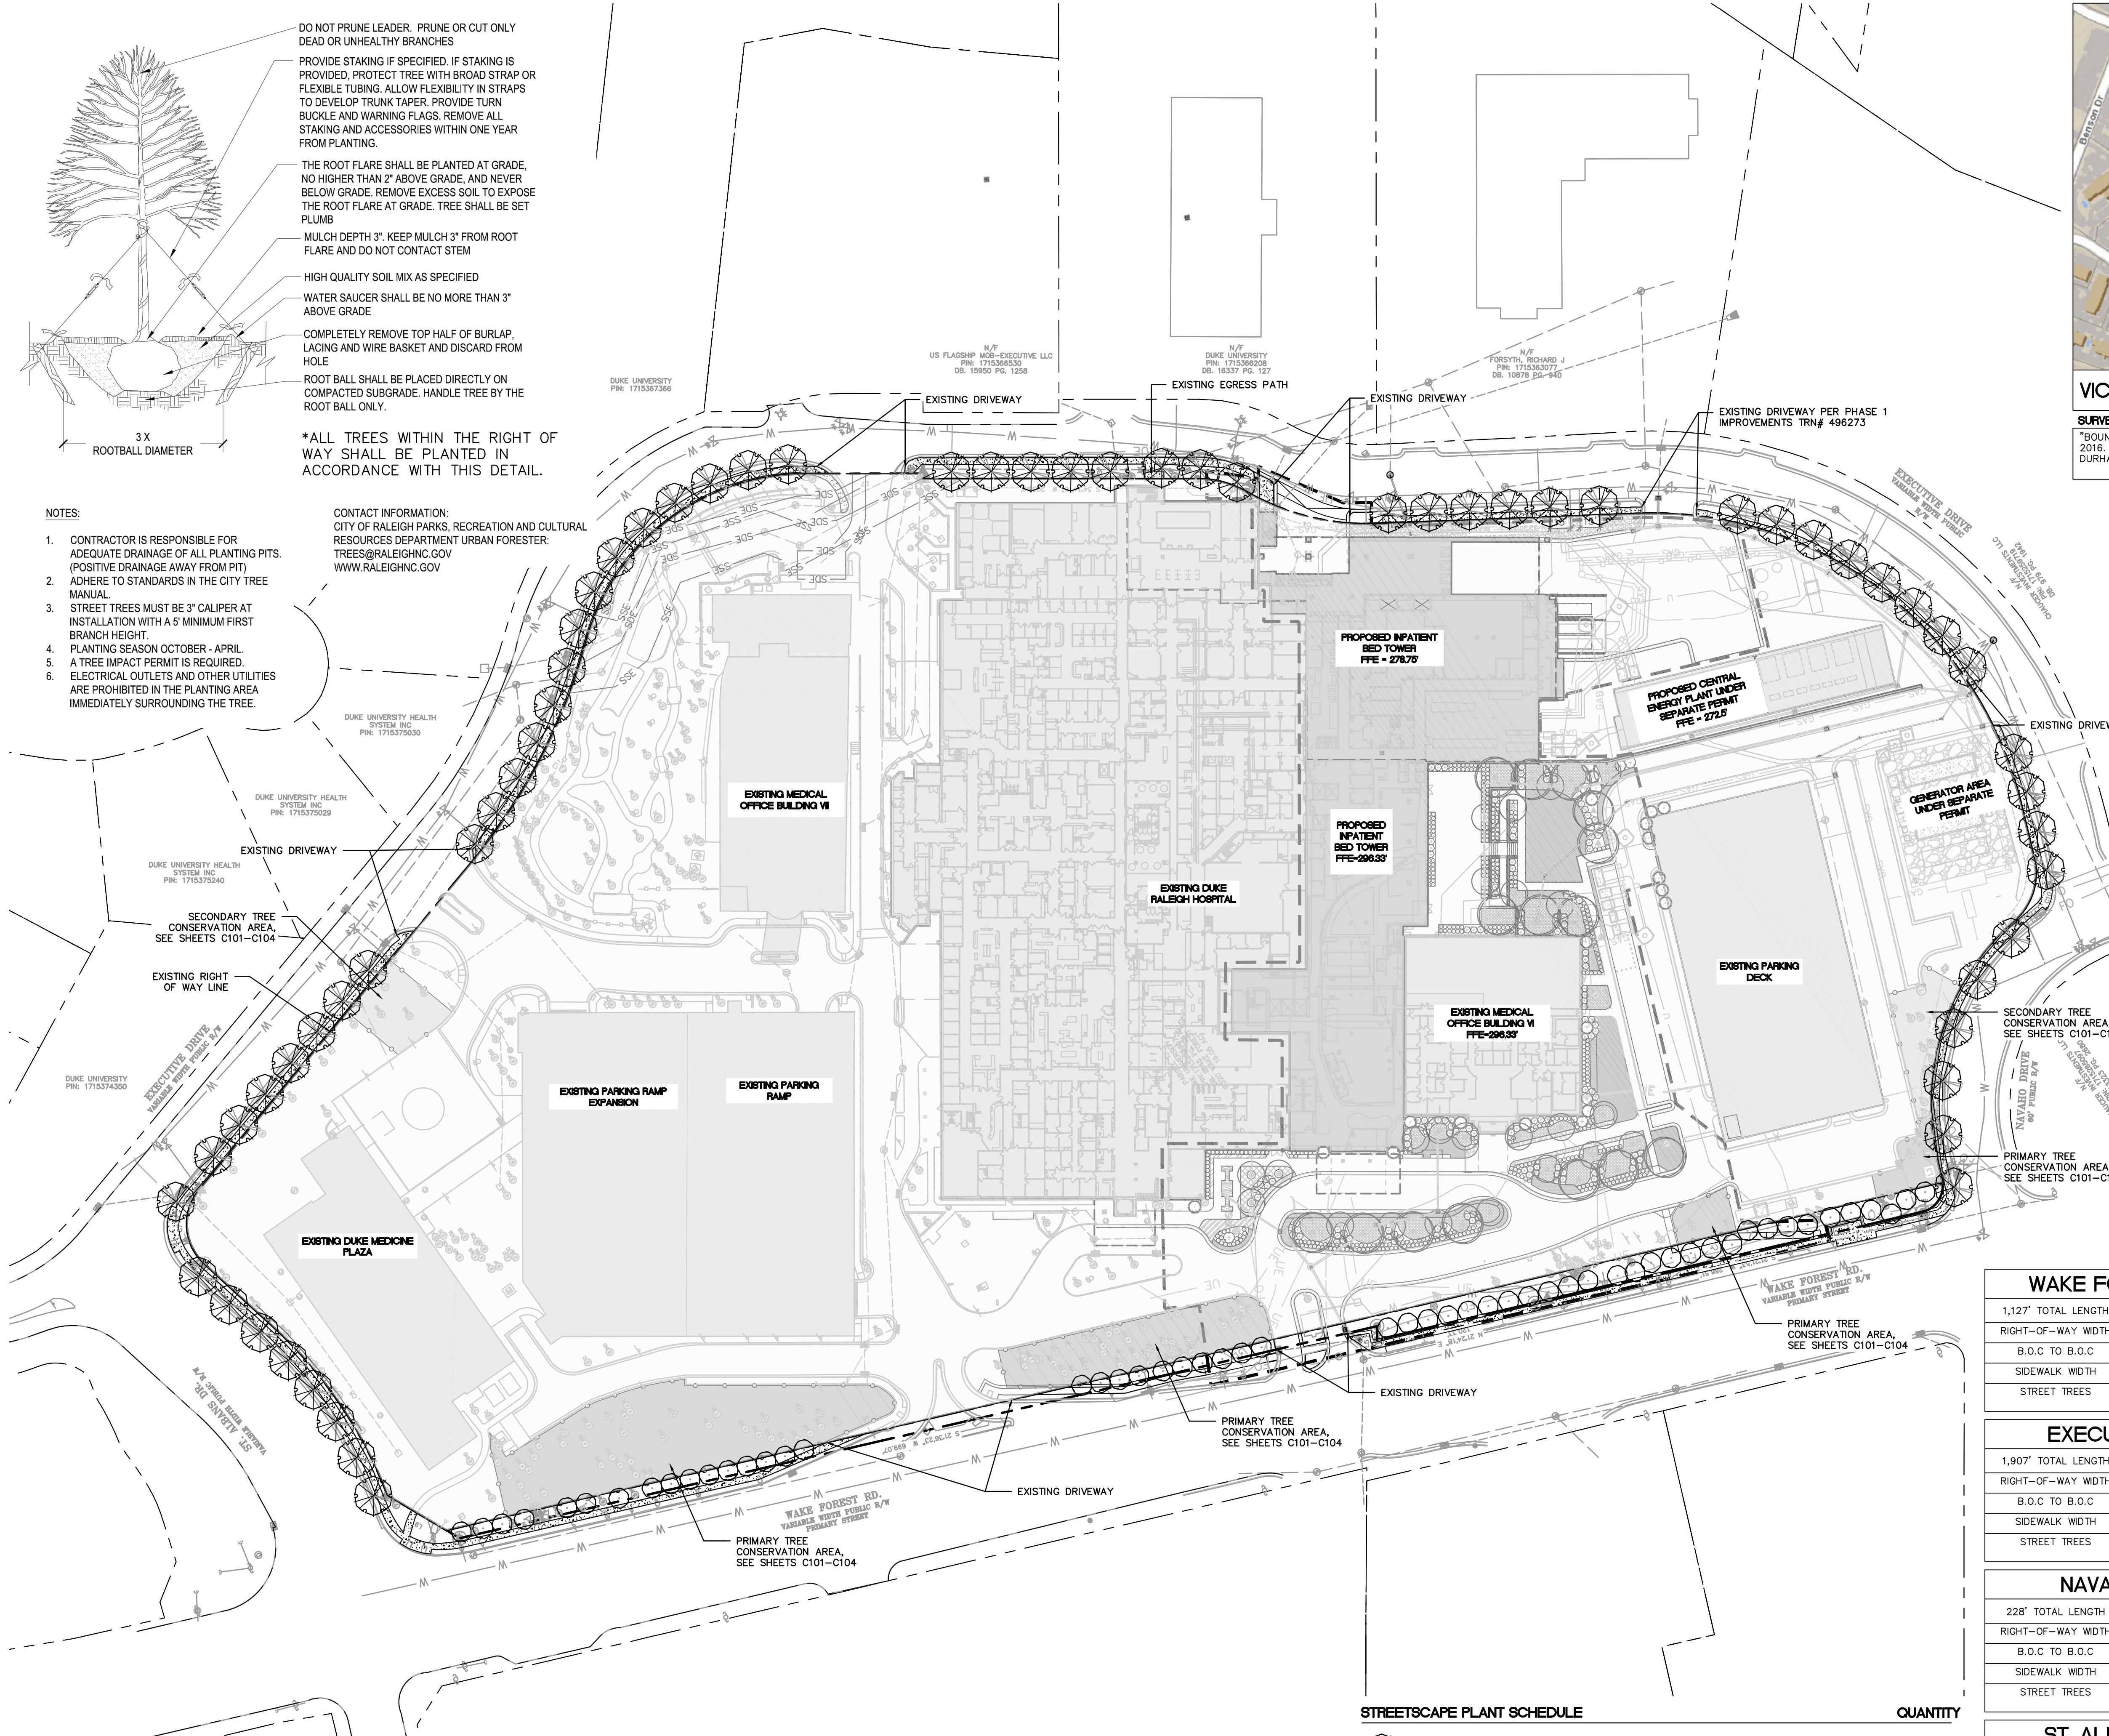
Date of First Issue: 2017-07-21

## Sheet Title

# LANDSCAPE CODE COMPLIANCE PLAN

Original drawing is 24 x 36. Do not scale contents of this drawing.

L301

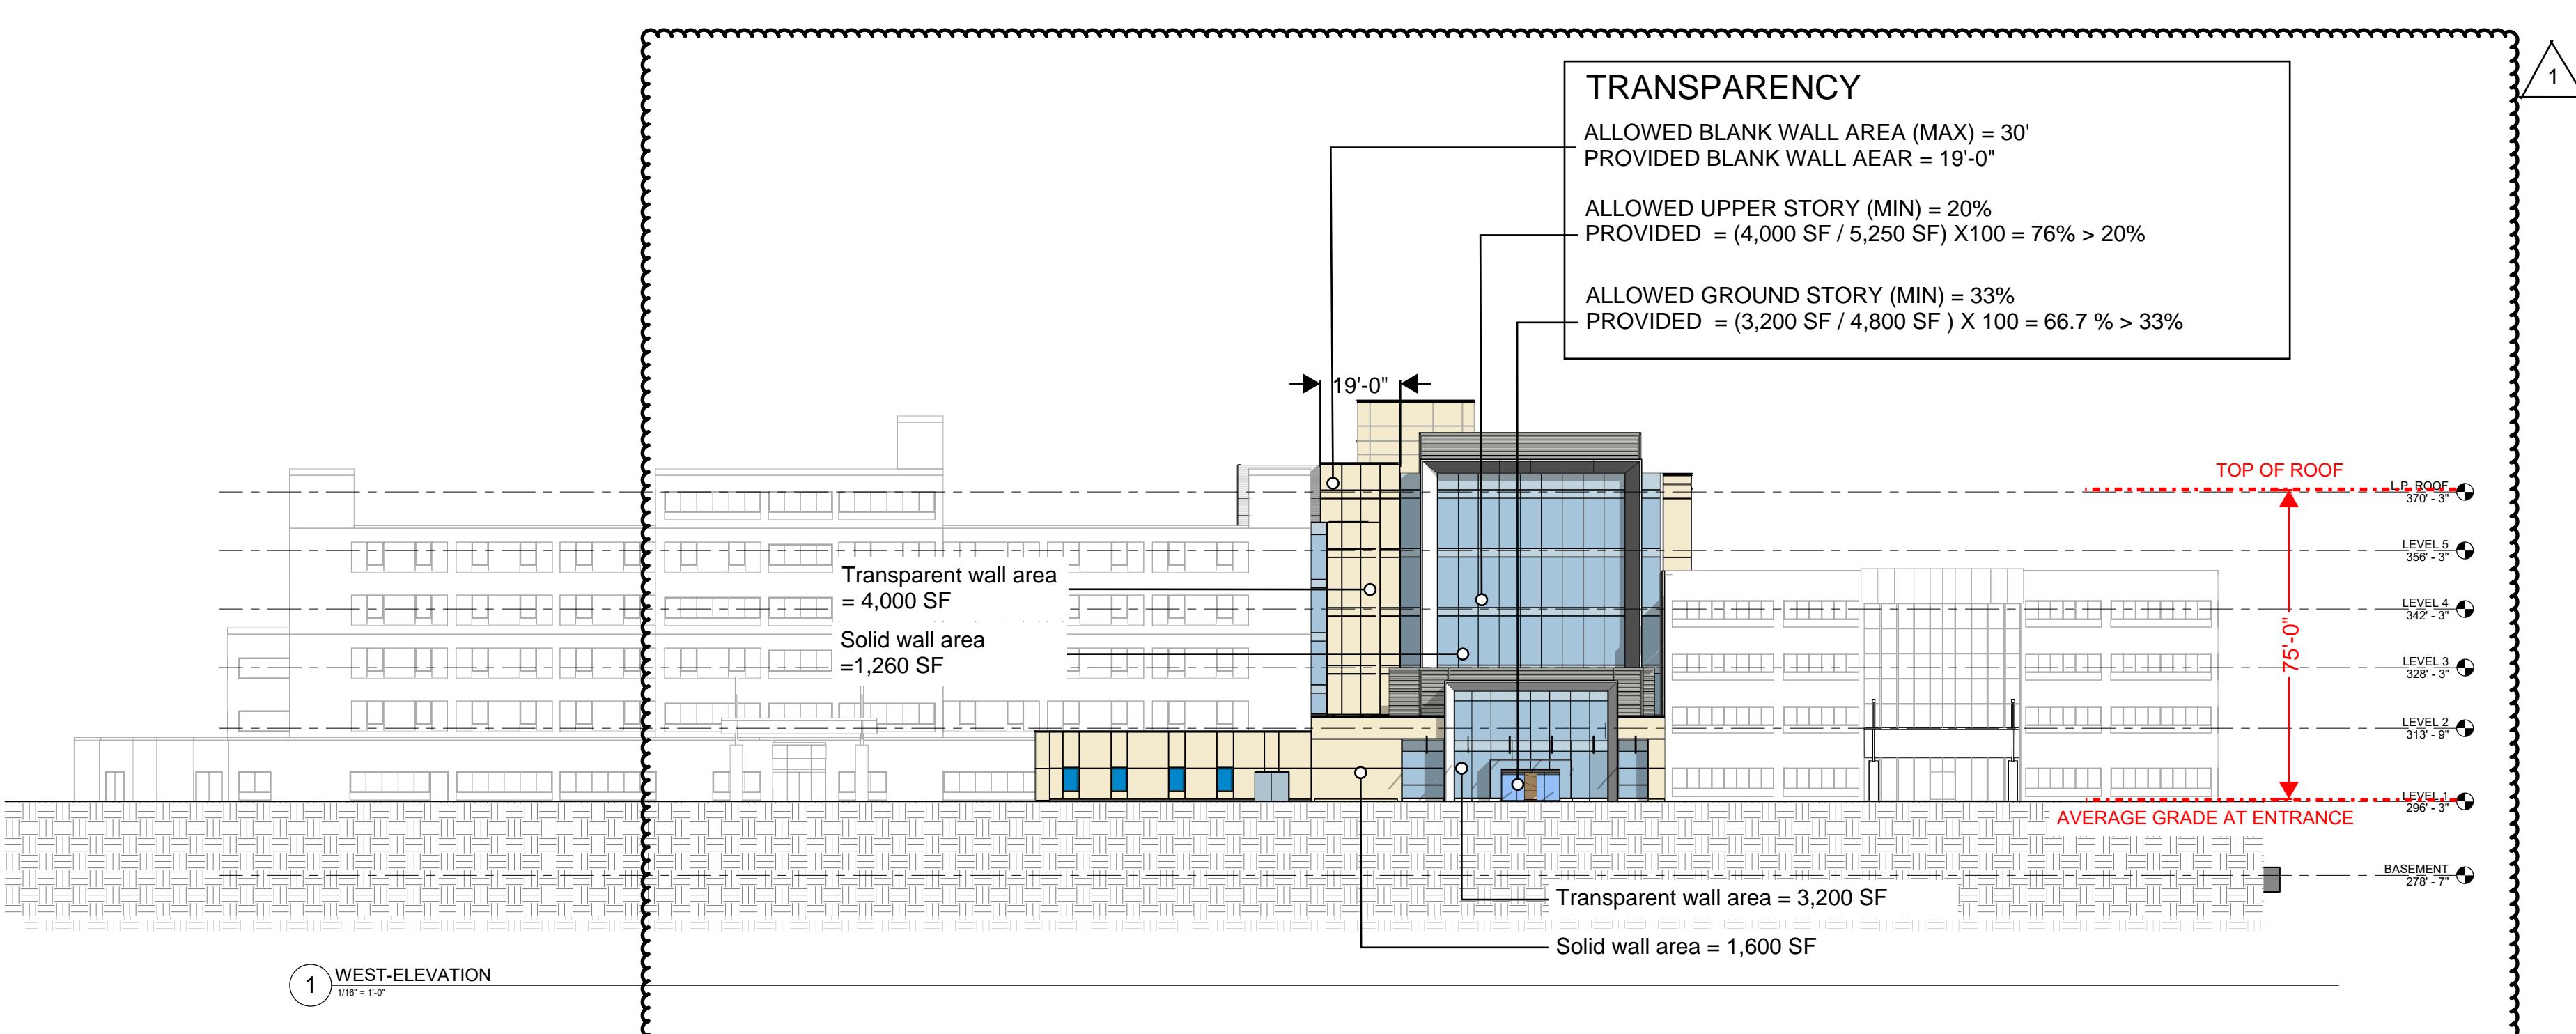
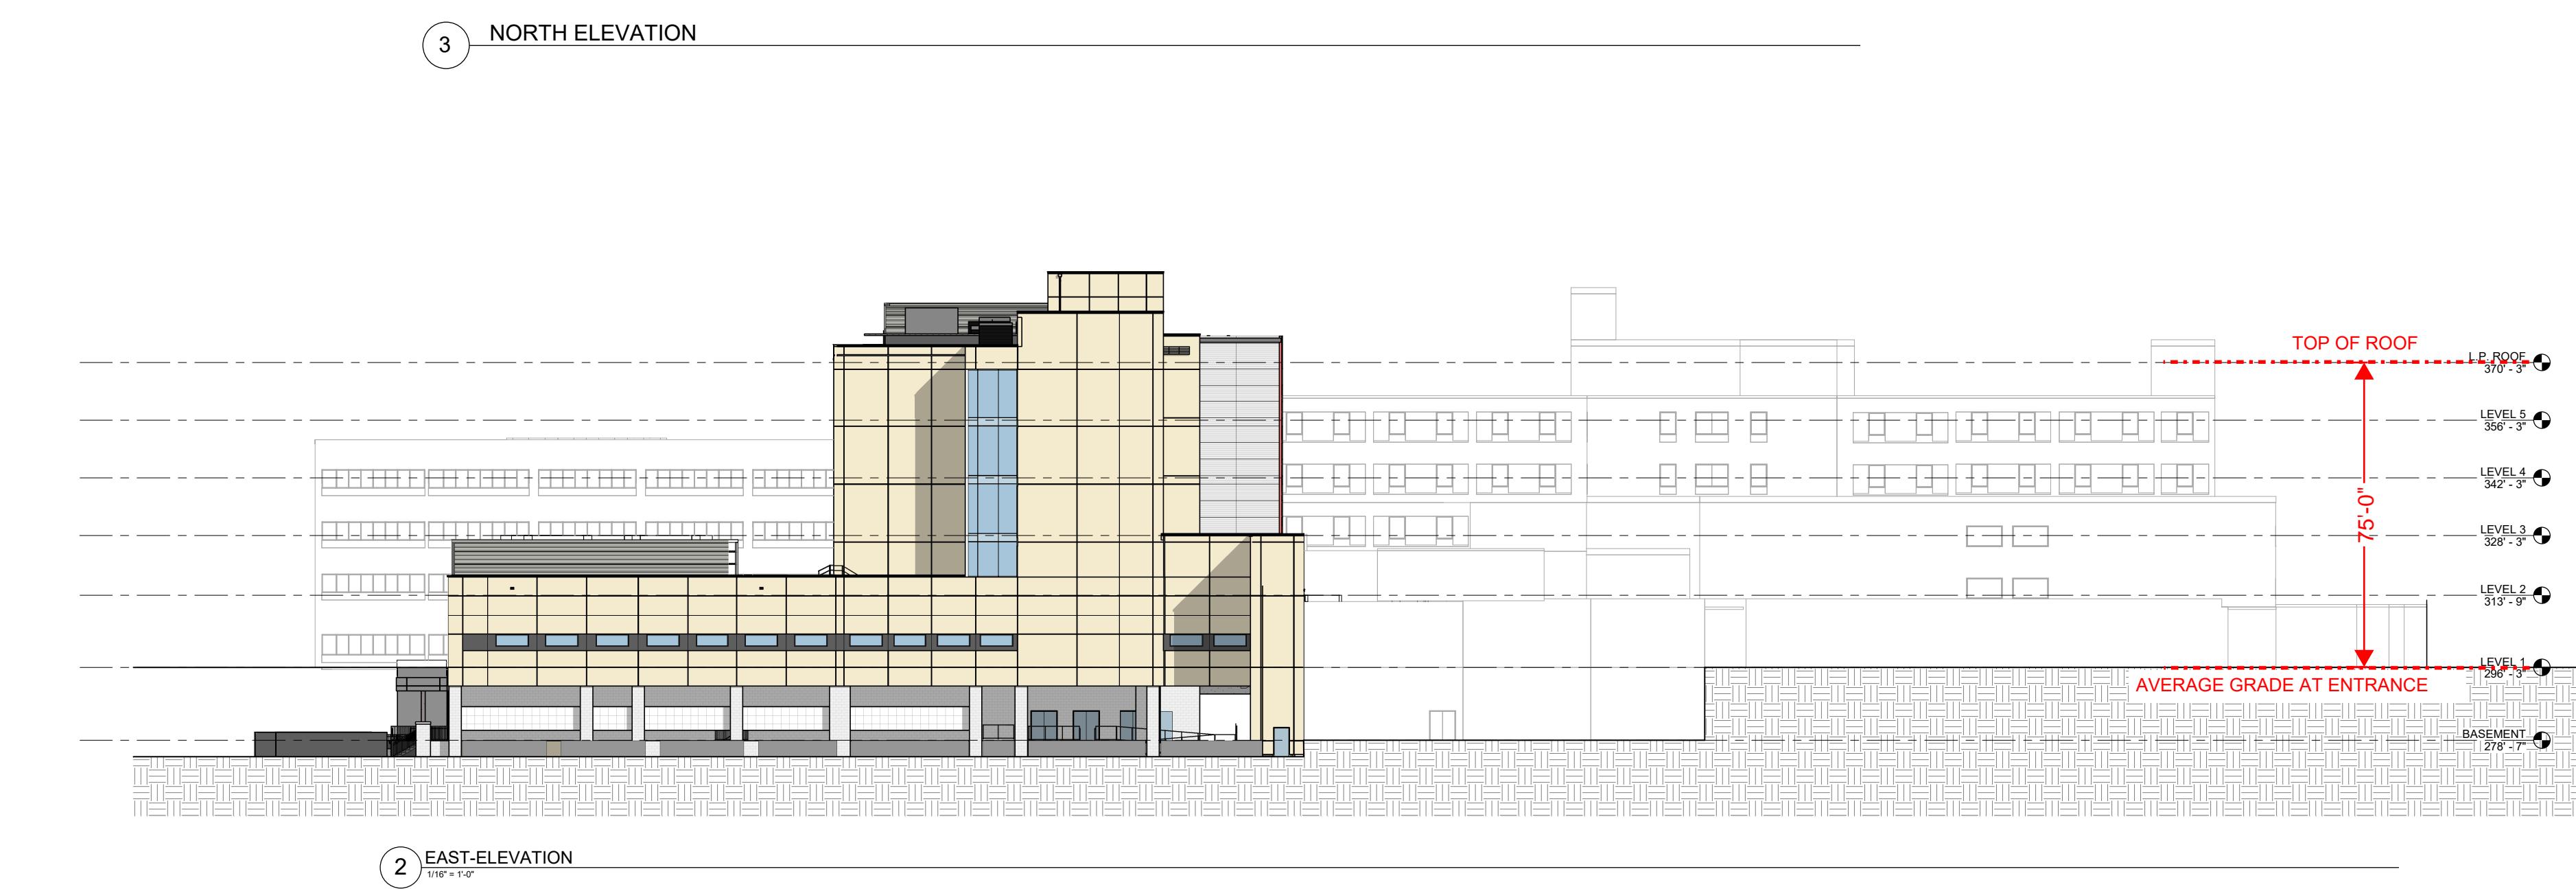
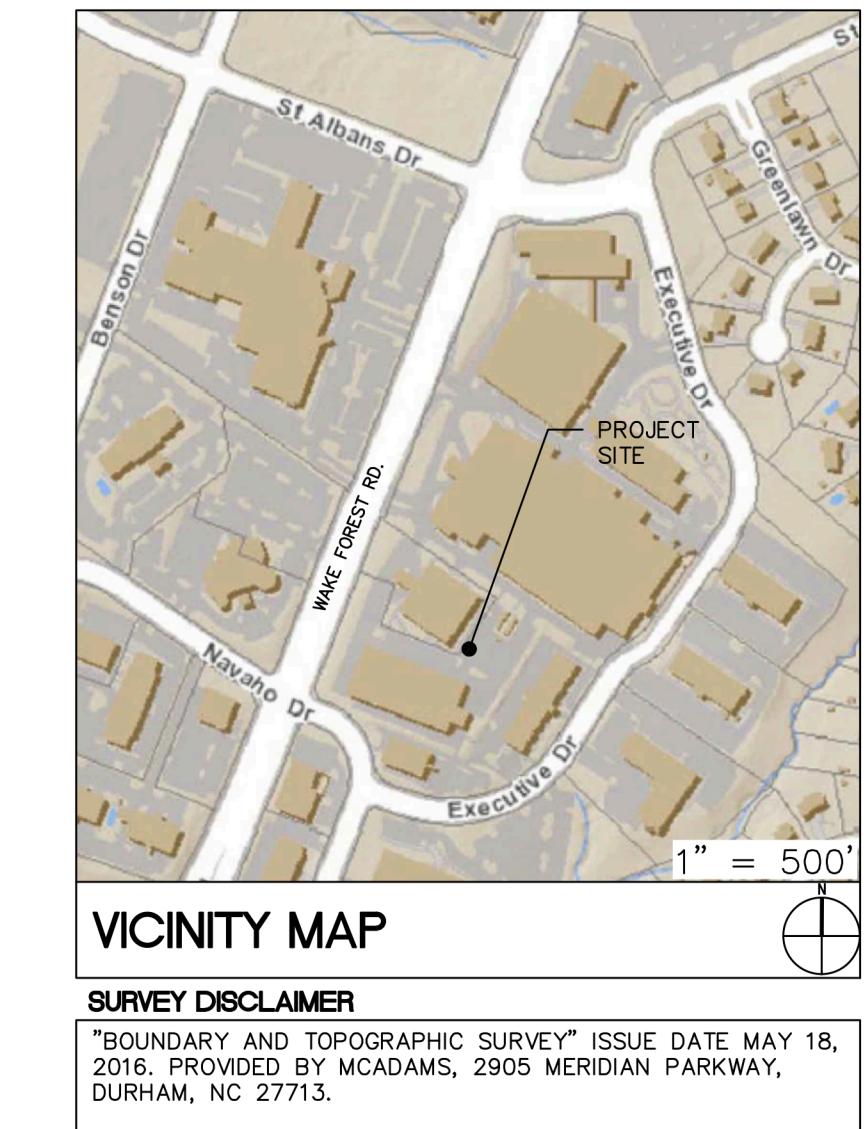


WAKE FOREST ROAD STREETSCAPE			
1,127' TOTAL LENGTH	EXISTING	REQUIRED	PROVIDED
RIGHT-OF-WAY WIDTH	100'	126'-0"	SHOWN ON PLANS
B.O.C TO B.O.C	79'-0"	N/A	N/A
SIDEWALK WIDTH	5'-0"	6'-0"	FEE-IN-LIEU
STREET TREES	1 PER 20 LINEAR FEET	1,127 LF/20 = 56 TREES	56 UNDERSTORY TREES

EXECUTIVE DRIVE STREETSCAPE			
1,907' TOTAL LENGTH	EXISTING	REQUIRED	PROVIDED
RIGHT-OF-WAY WIDTH	VARIES (60' MIN.)	64'-0"	DESIGN ADJUSTMENT
B.O.C TO B.O.C	42'-0"	36'-0"	42'-0"
SIDEWALK WIDTH	5'-0"	6'-0"	FEE-IN-LIEU
STREET TREES	1 PER 40 LINEAR FEET	1,907 LF/40 = 48 TREES	48 STREET TREES

NAVAHO DRIVE STREETSCAPE			
228' TOTAL LENGTH	EXISTING	REQUIRED	PROVIDED
RIGHT-OF-WAY WIDTH	VARIES (60' MIN.)	69'-0"	DESIGN ADJUSTMENT
B.O.C TO B.O.C	41'-0"	41'-0"	41'-0"
SIDEWALK WIDTH	5'-0"	6'-0"	FEE-IN-LIEU
STREET TREES	1 PER 40 LINEAR FEET	228 LF/40 = 6 TREES	6 STREET TREES

<b>ST. ALBANS DRIVE STREETSCAPE</b>			
<b>293' TOTAL LENGTH</b>	<b>EXISTING</b>	<b>REQUIRED</b>	<b>PROVIDED</b>
RIGHT-OF-WAY WIDTH	VARIES (123' MIN.)	80'-0"	N/A
B.O.C TO B.O.C	77'-0"	41'-0"	77'-0"
SIDEWALK WIDTH	5'-0"	6'-0"	FEE-IN-LIEU
STREET TREES	1 PER 40 LINEAR FEET	293 LF/40 = 7 TREES	8 STREET TREES



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Key Plan

**NOT TO SCALE**



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No. Description Date  
1 RESPONSE TO REVIEW COMMENTS 2017-08-18

**NEW INPATIENT TOWER AND SURGERY EXPANSION**

Date of First Issue: 2017-07-21

Project No.: 50425.00

Sheet Title

**ELEVATIONS**

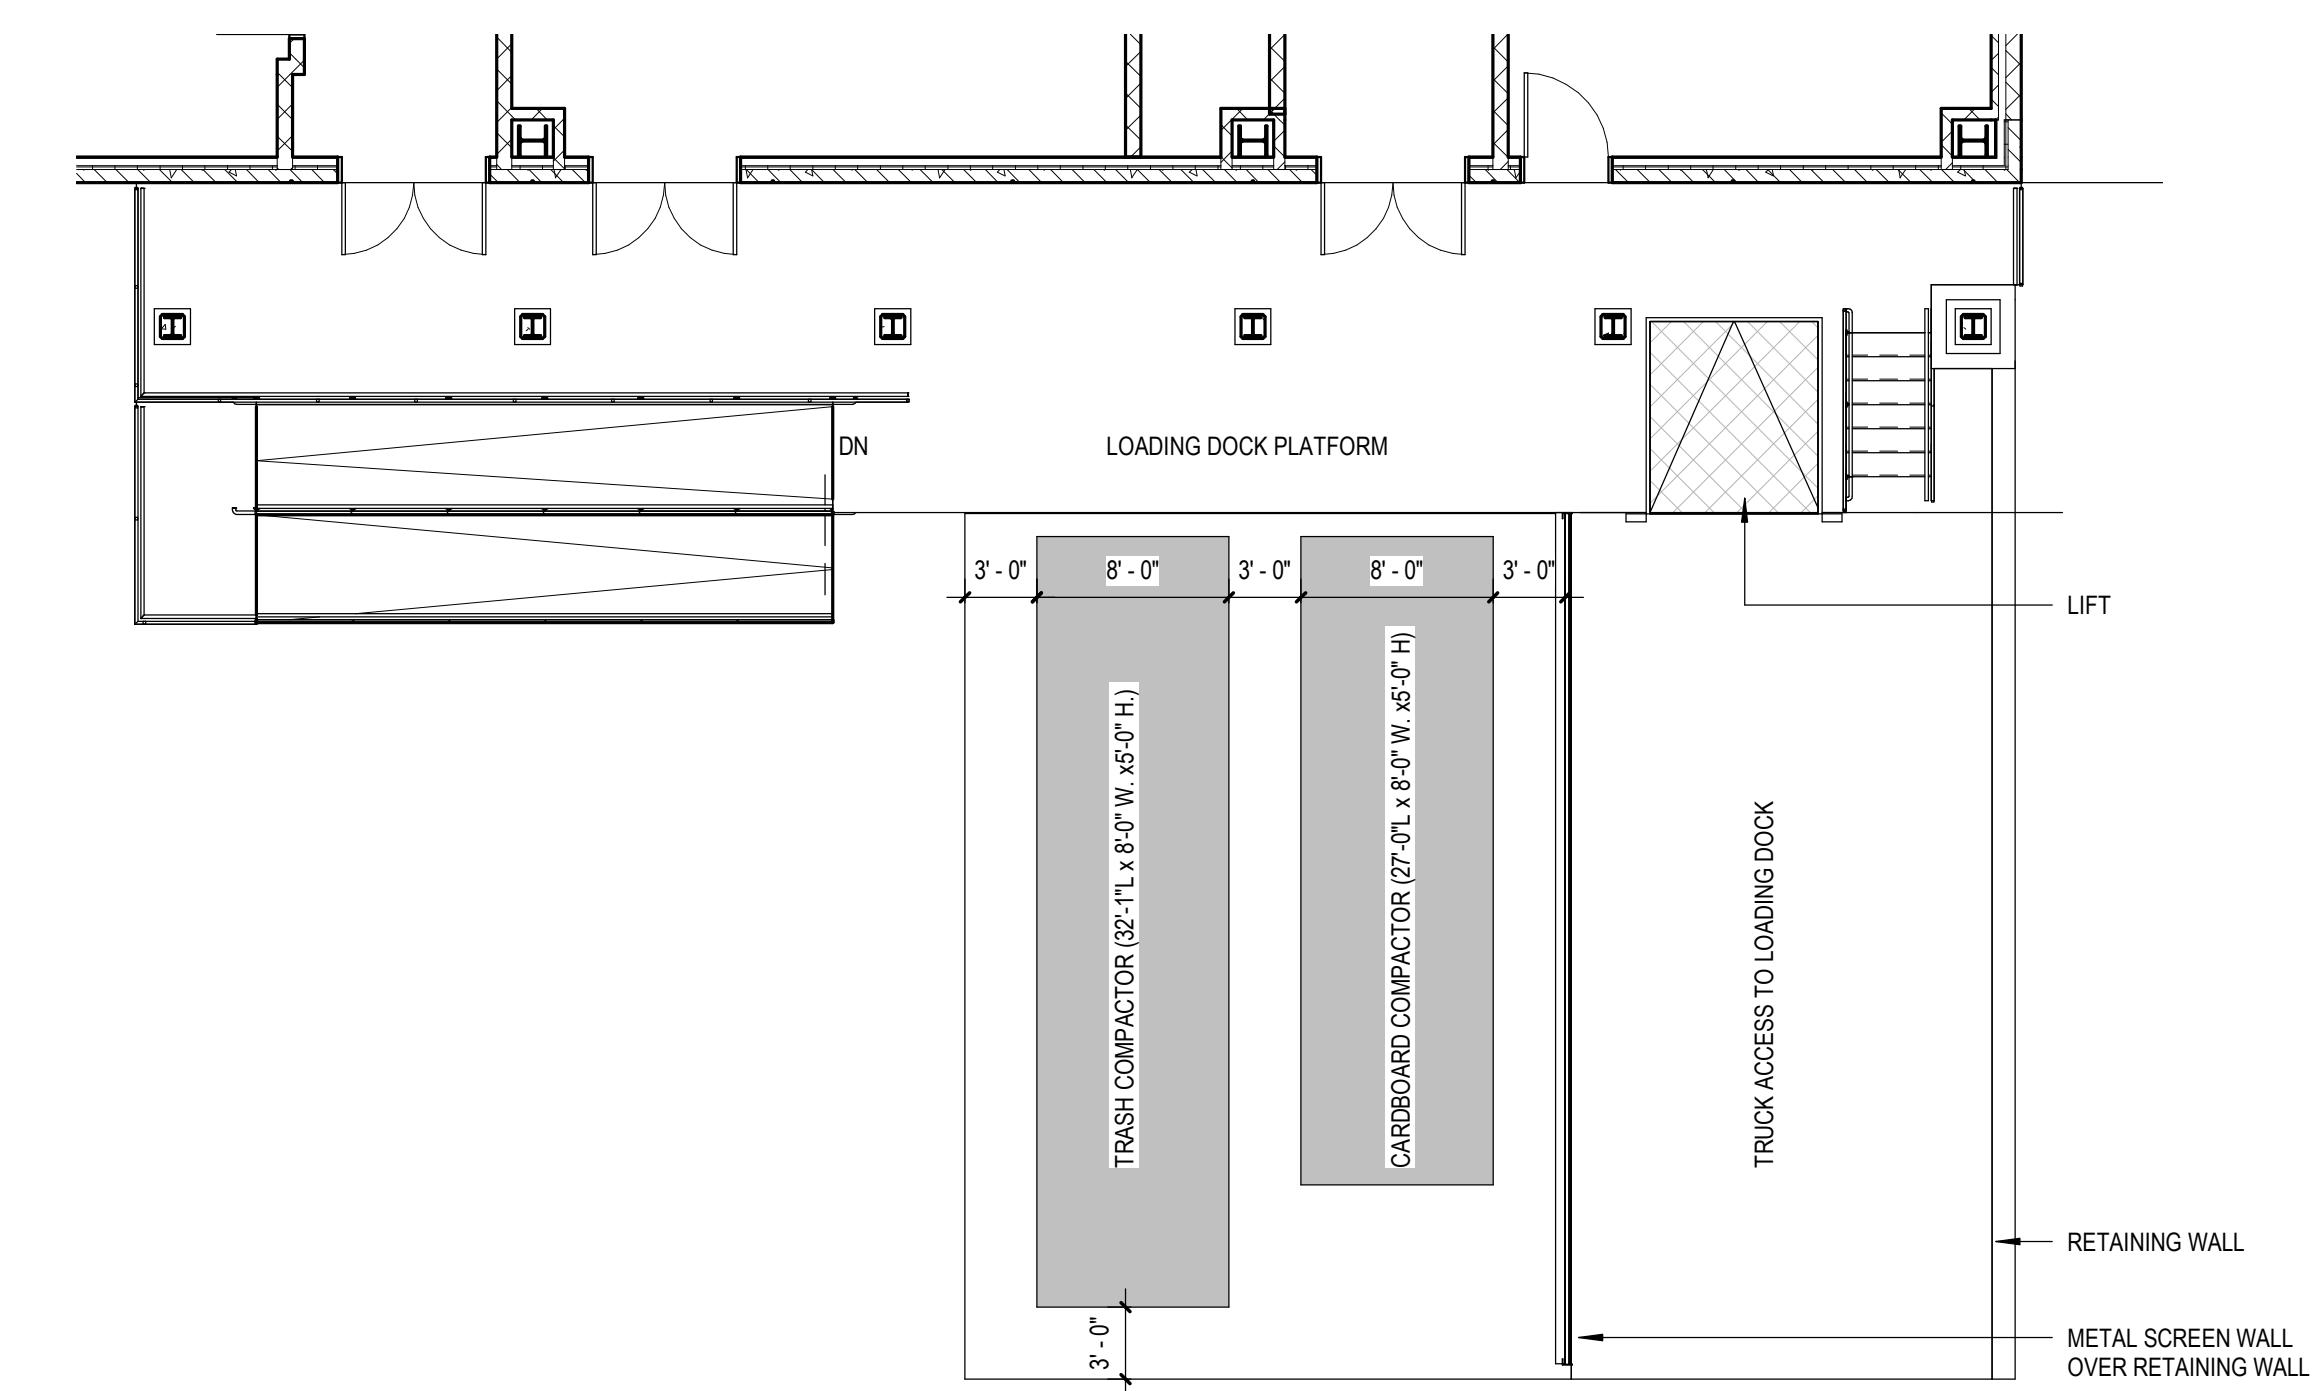
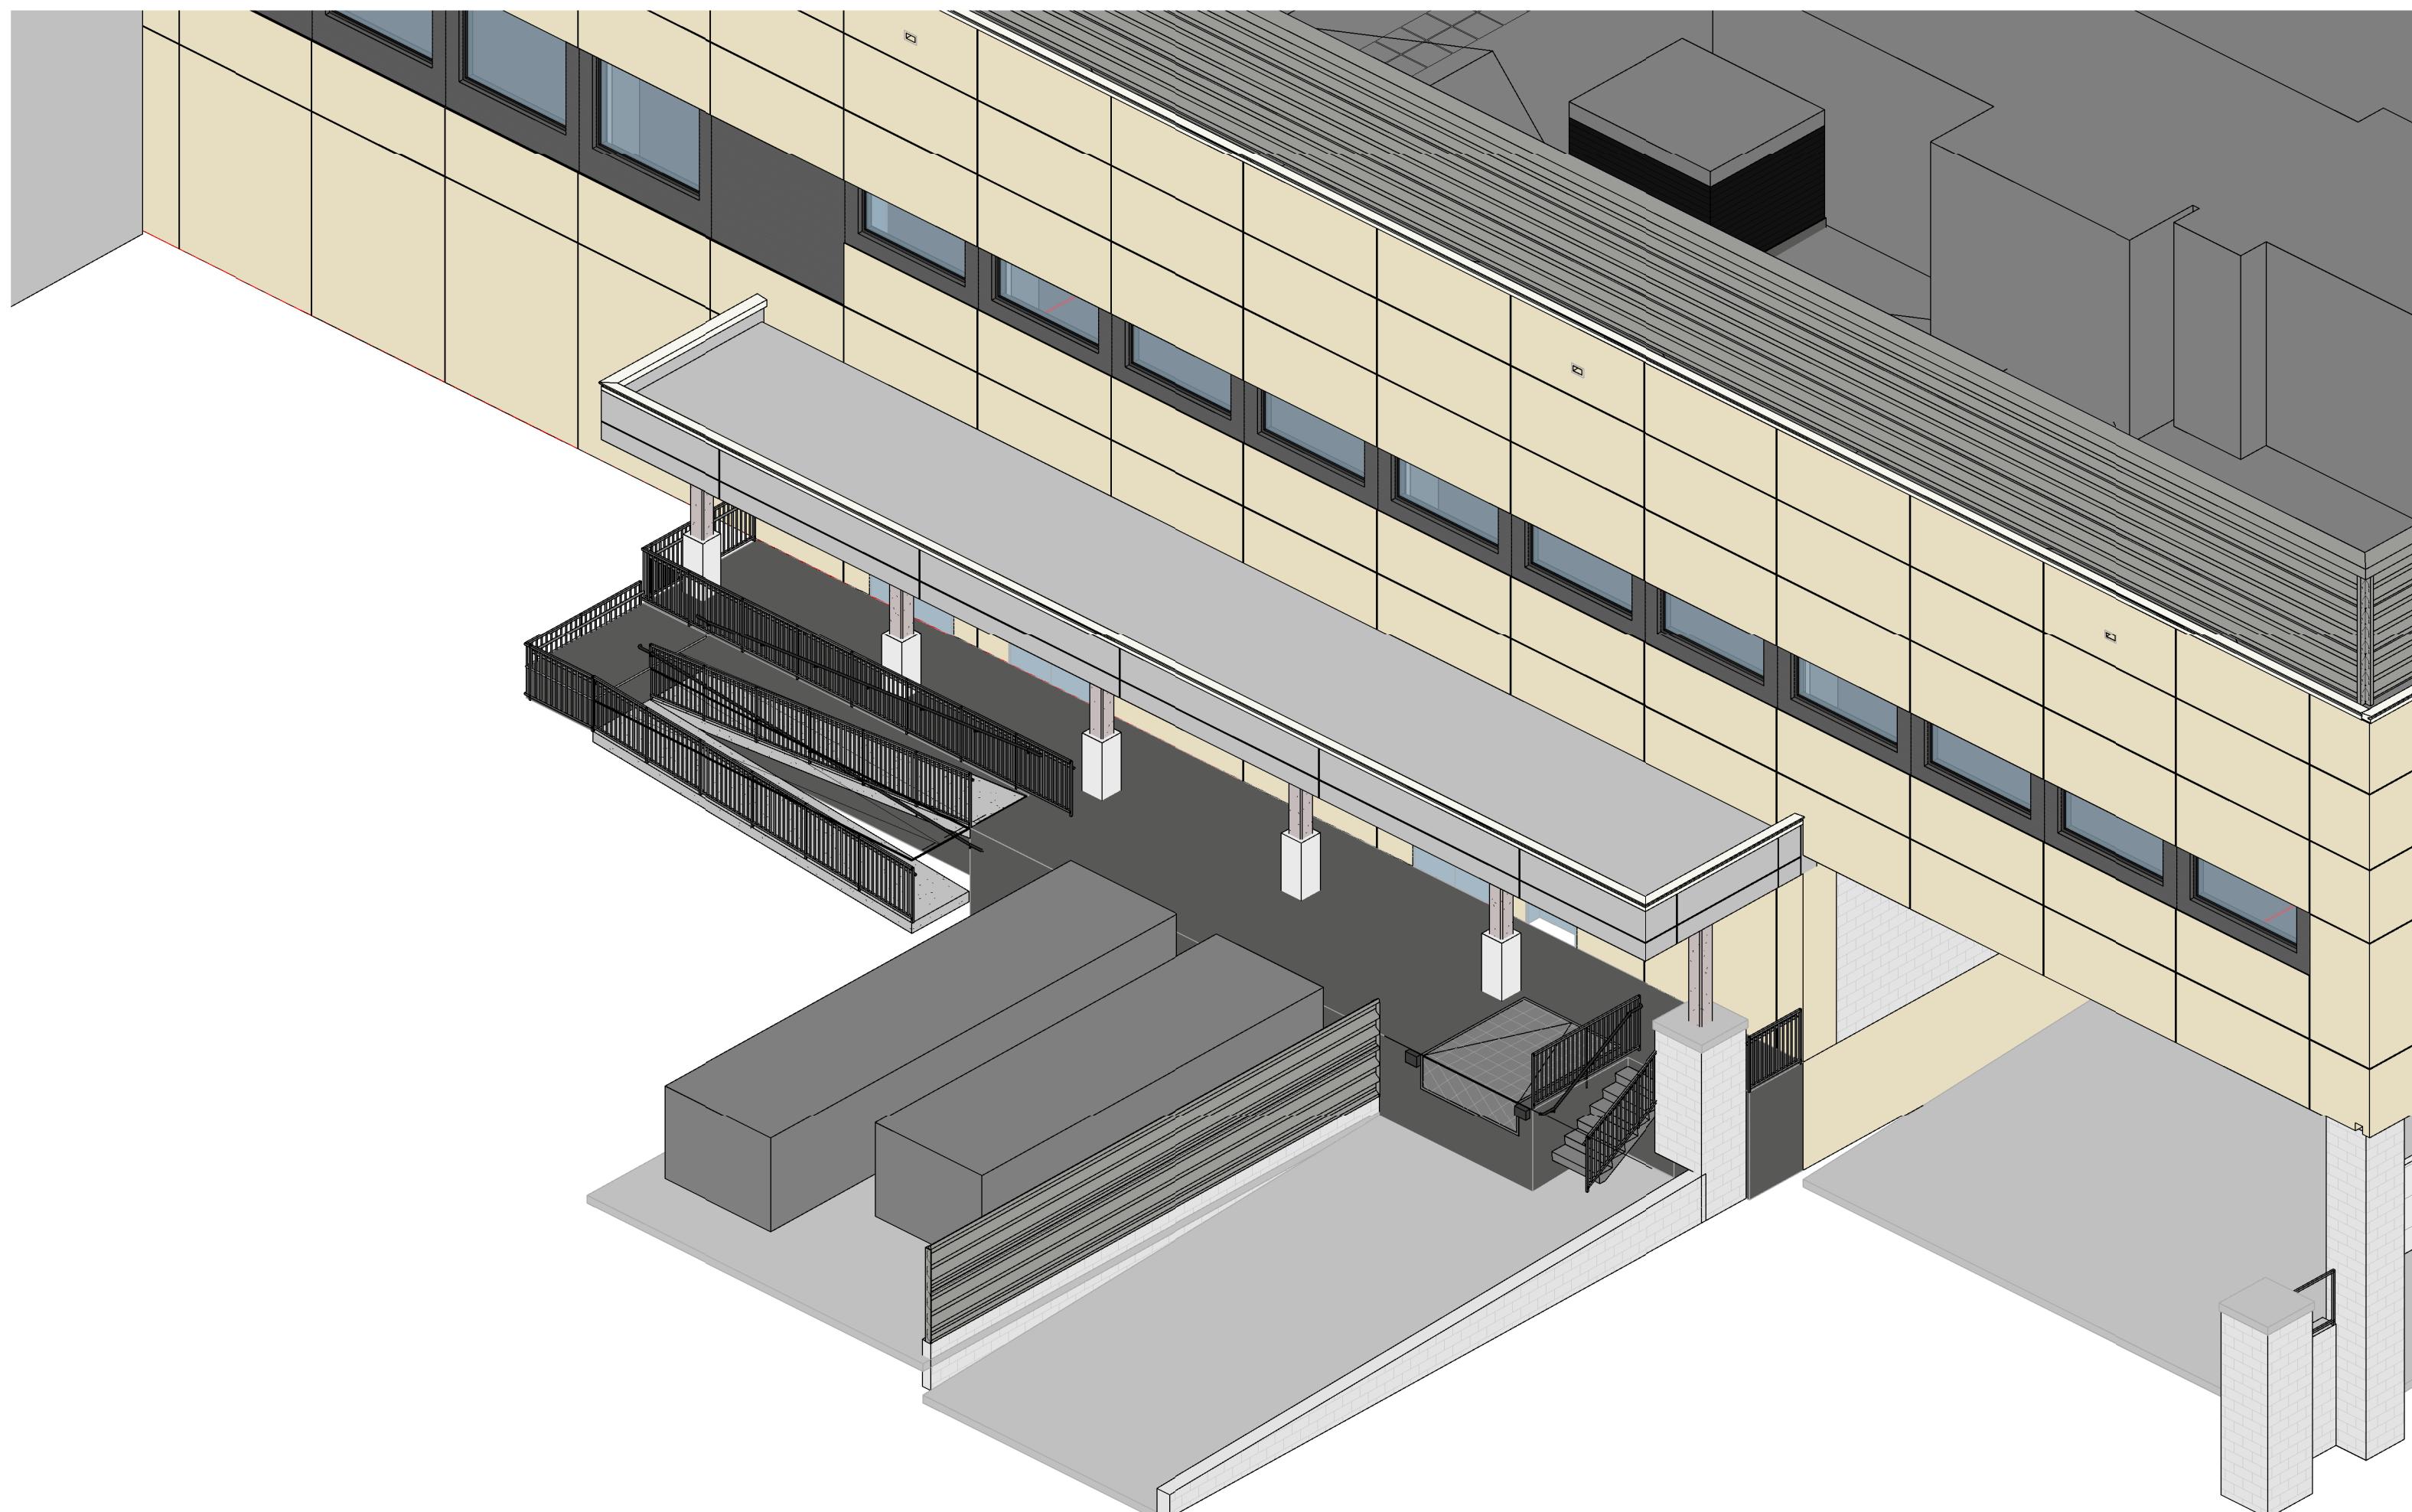
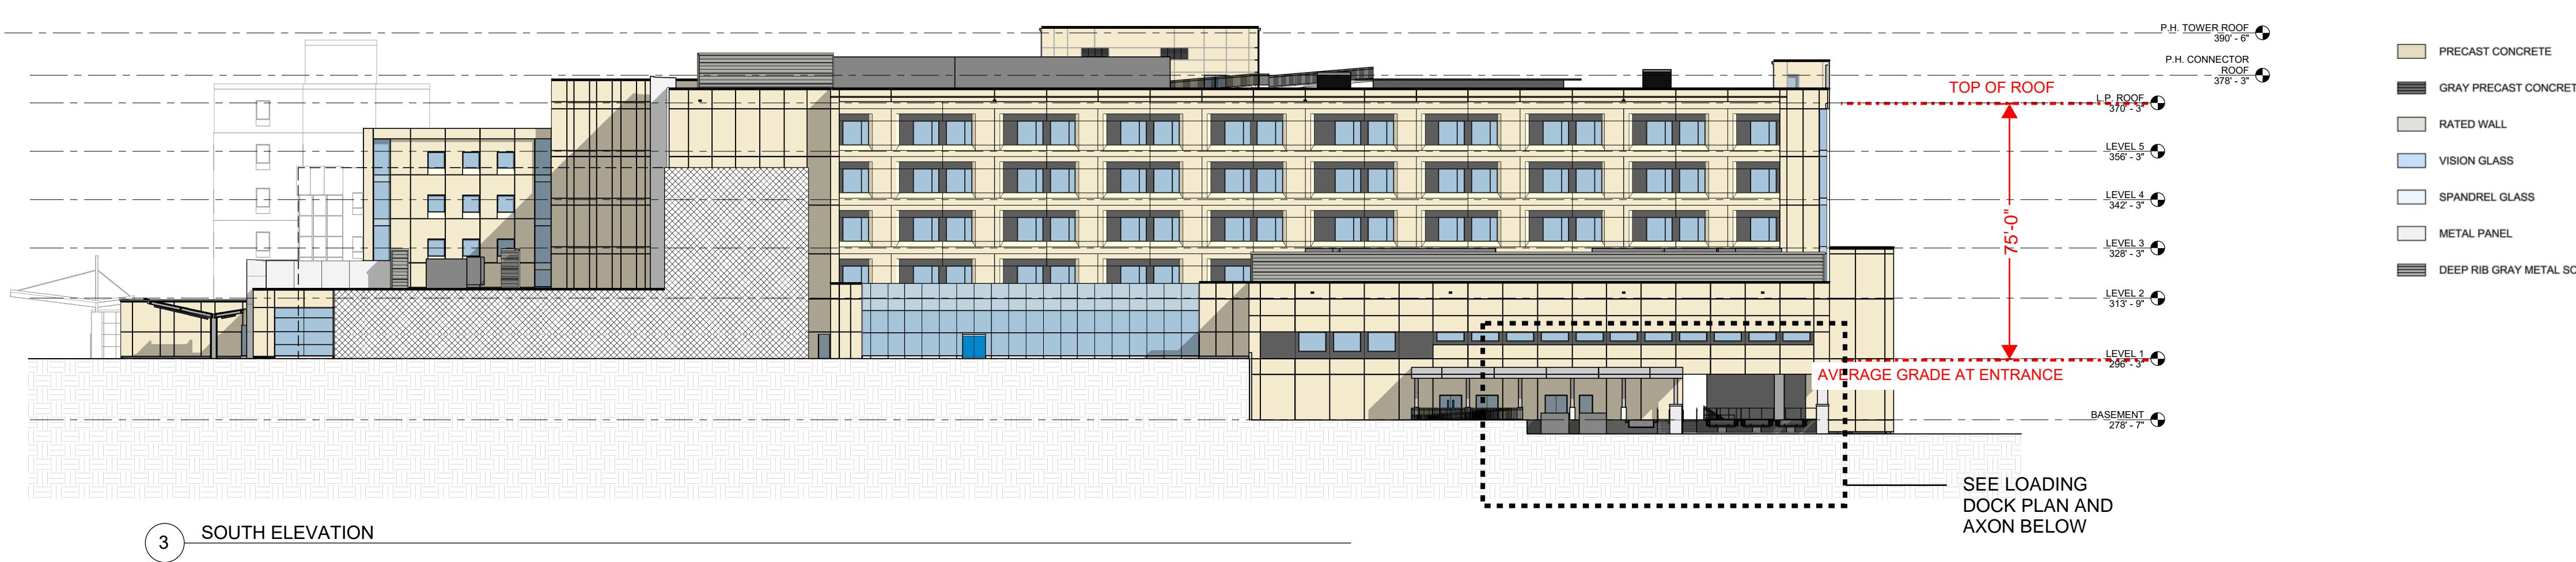
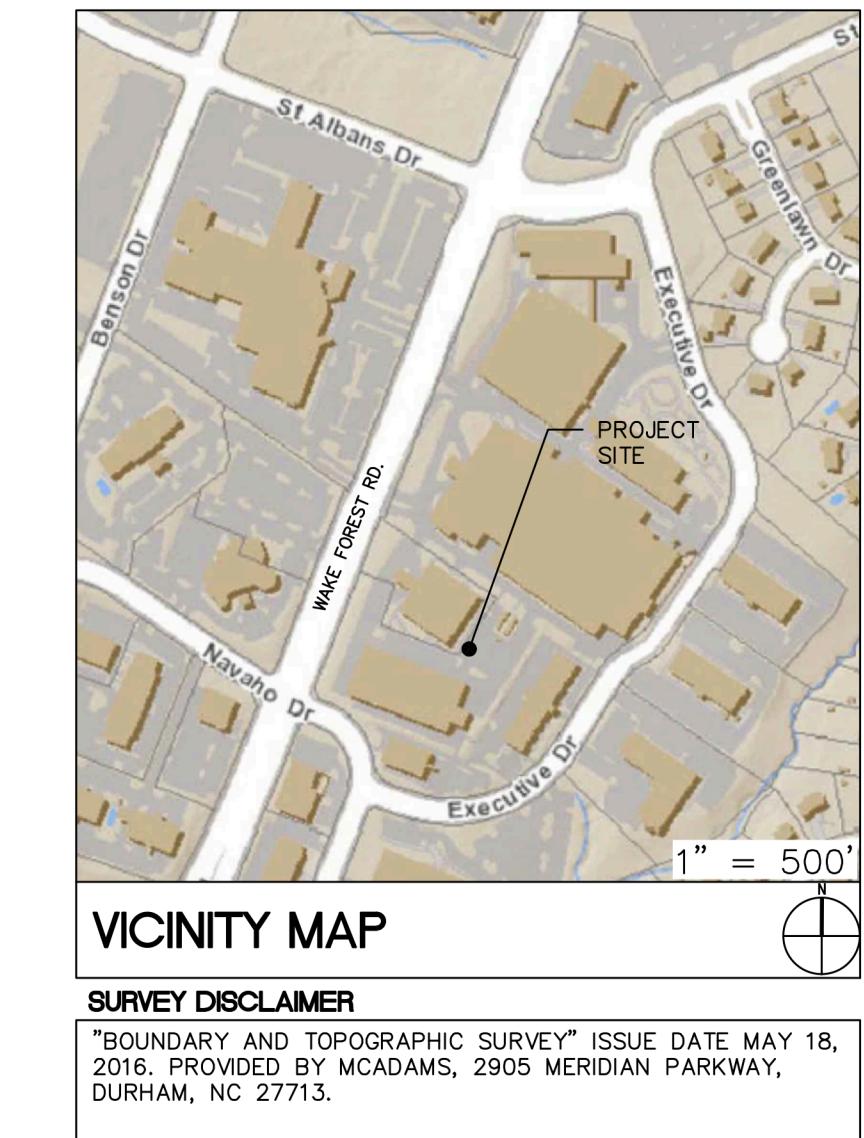
Original drawing is 24 x 36. Do not scale contents of this drawing.  
Sheet Number

Project  
**NEW INPATIENT TOWER AND SURGERY EXPANSION**  
 3400 Wake Forest Road  
 Raleigh, North Carolina 27609

Prepared For  
**Duke Raleigh Hospital**  
 Duke University Medical Center & Health System  
 2200 West Main Street, Suite 650  
 Durham, North Carolina 27705

 Duke Raleigh Hospital  
 DUKE UNIVERSITY HEALTH SYSTEM

Contract No



**1 LOADING DOCK SCREEN WALL PLAN AT COMPACTORS**

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NEW INPATIENT TOWER AND SURGERY EXPANSION

Date of First Issue: 2017-07-21

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Sheet Title

**ELEVATION AND LOADING DOCK PLAN**

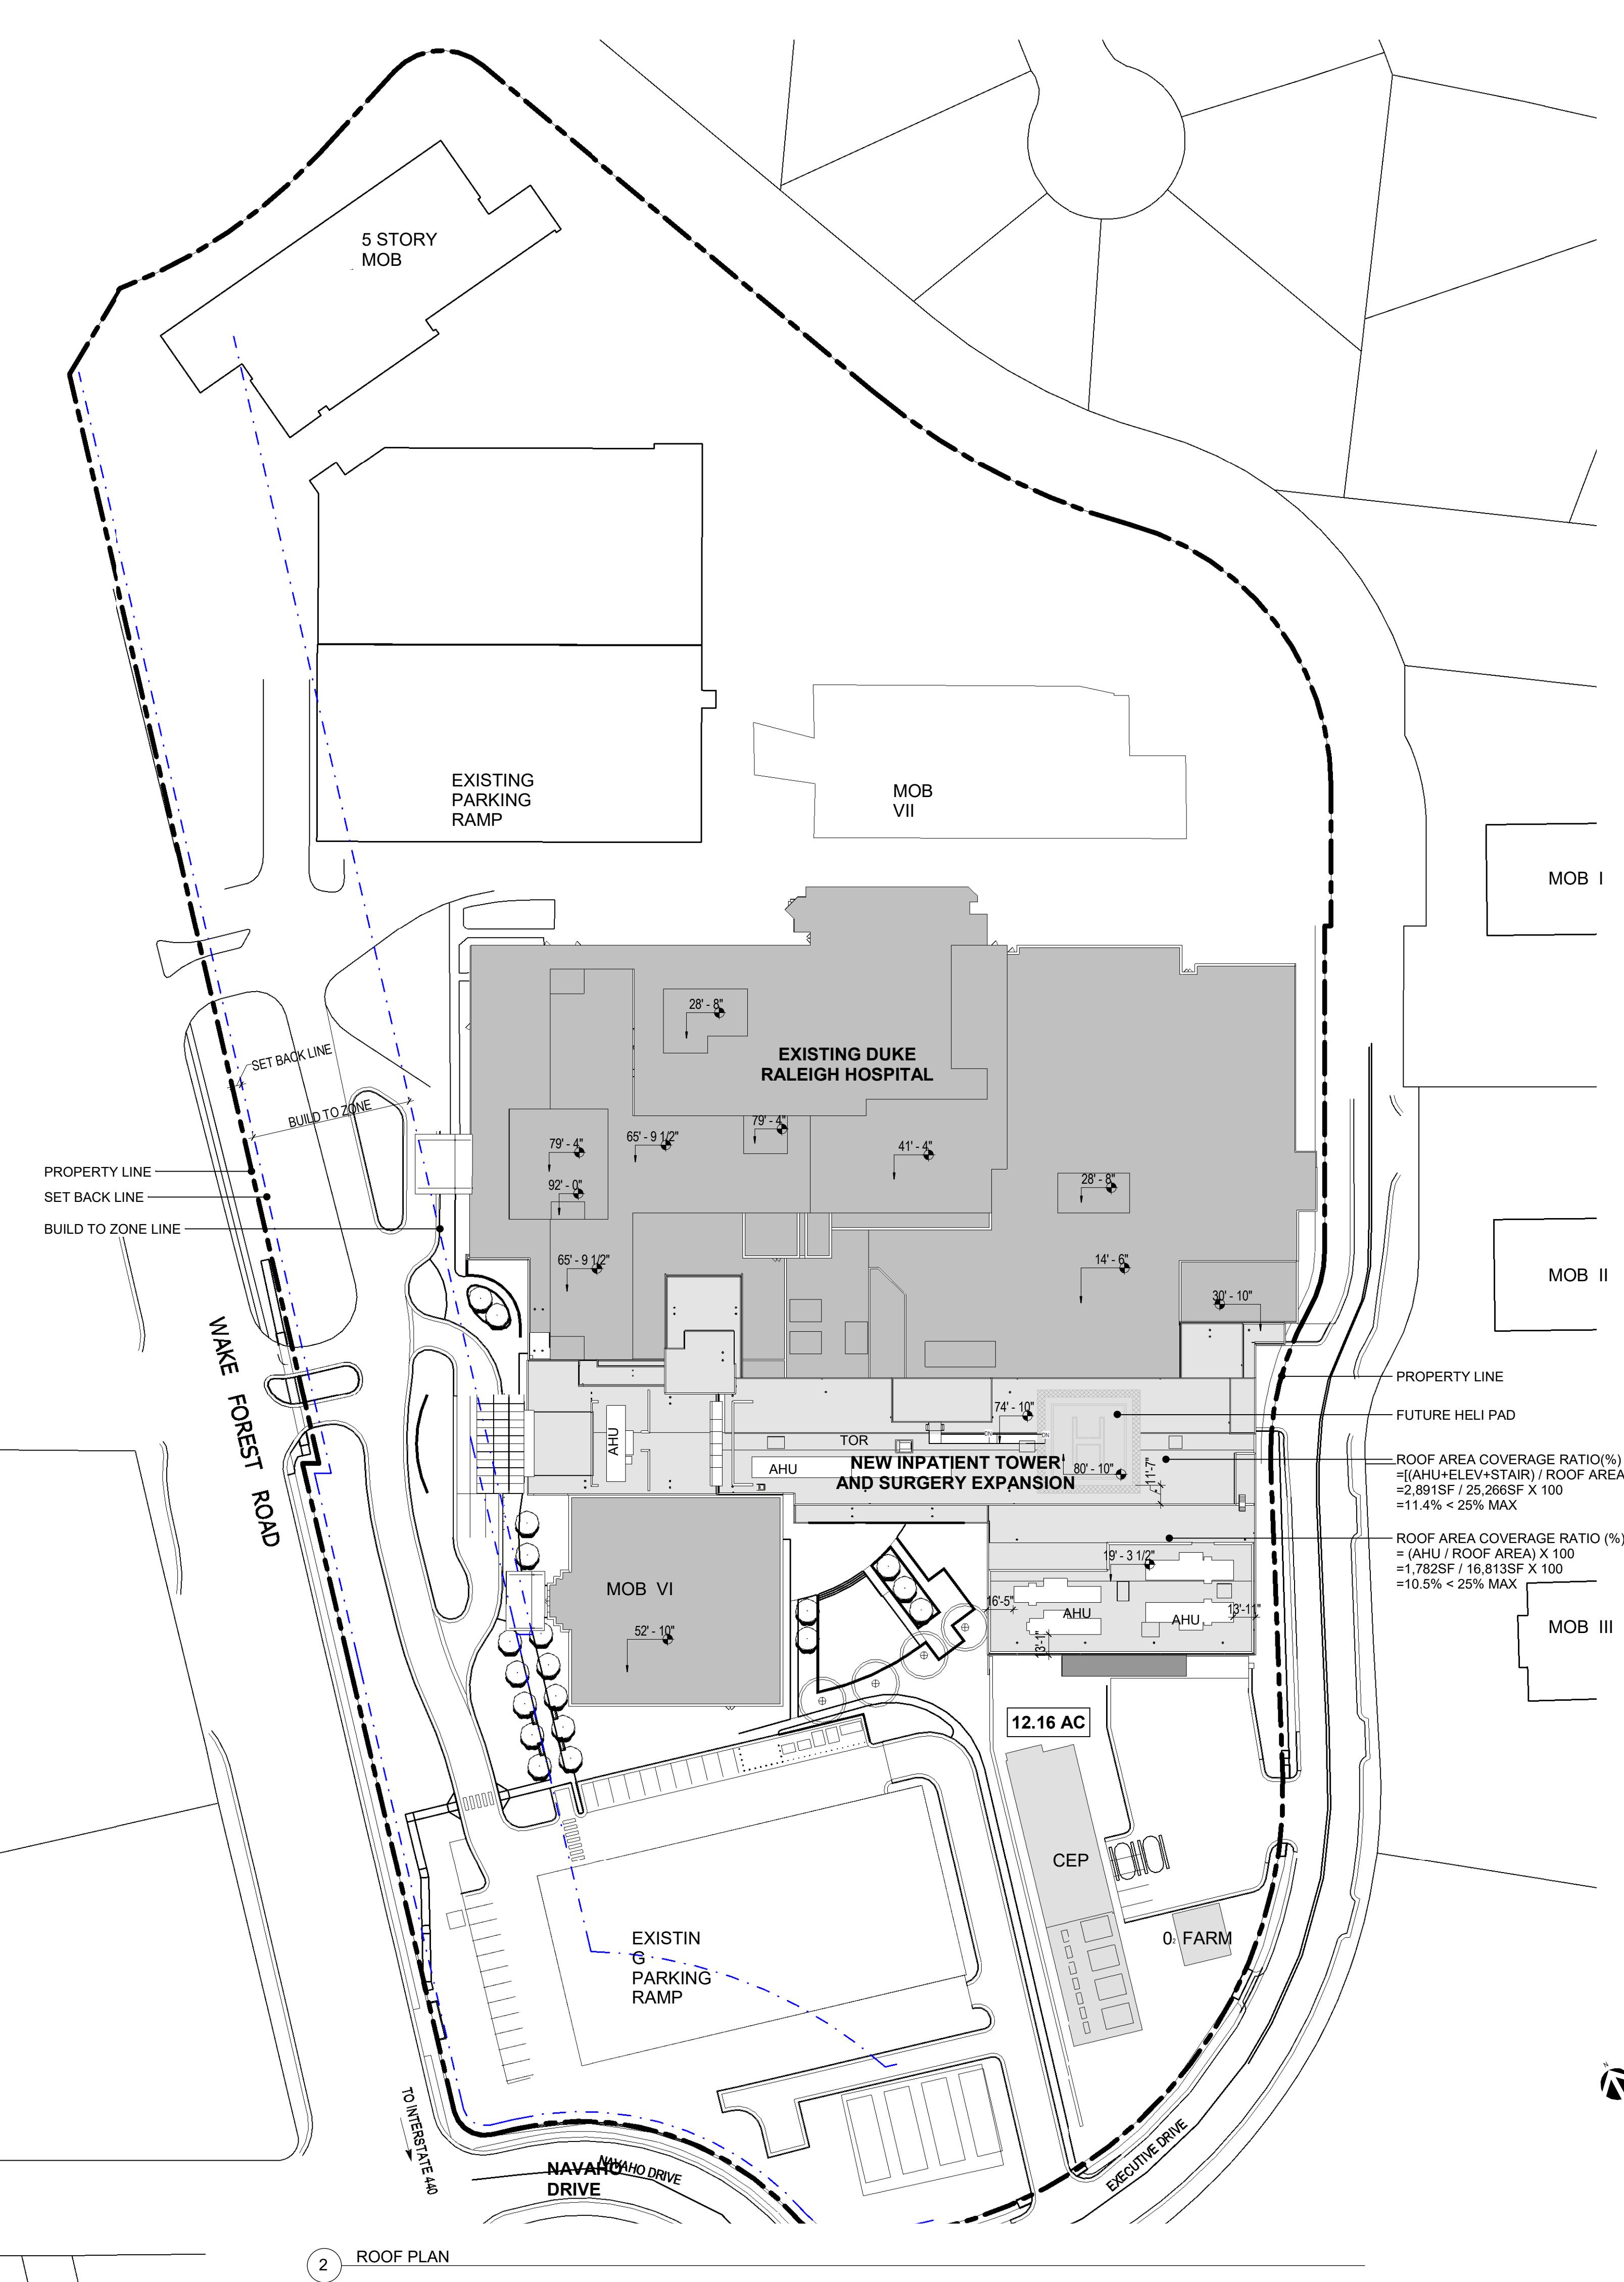
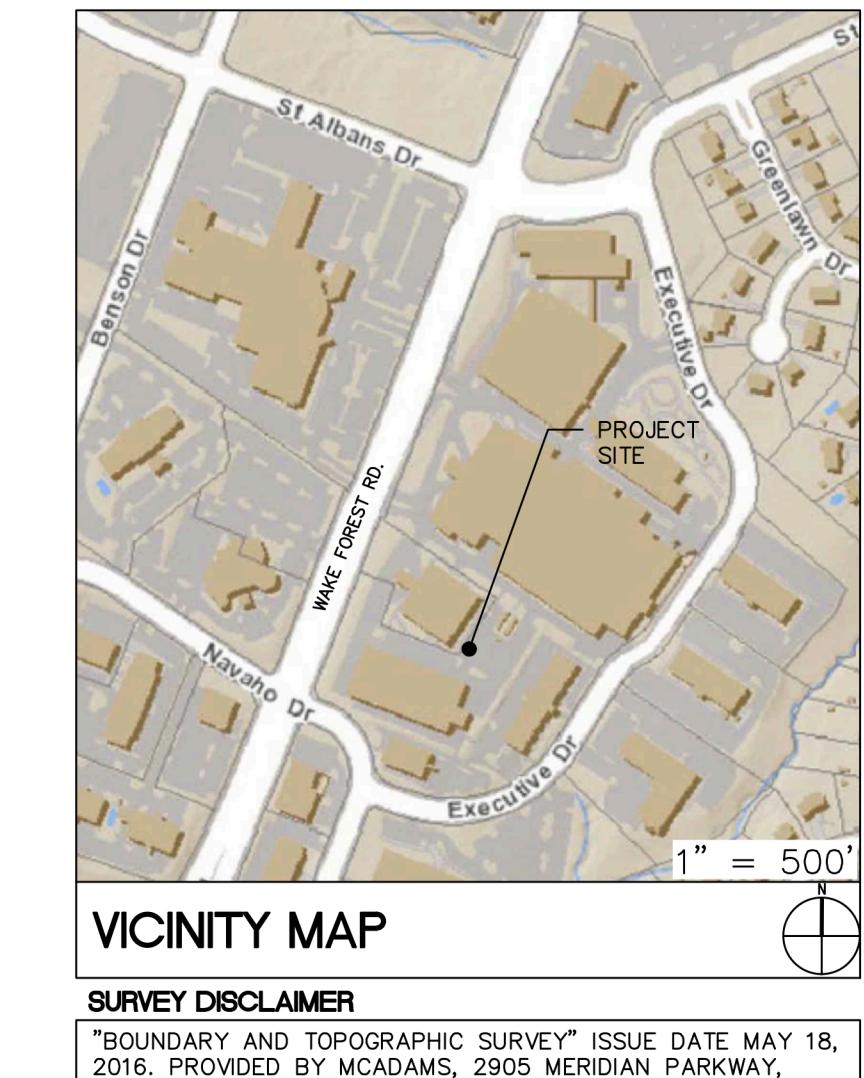
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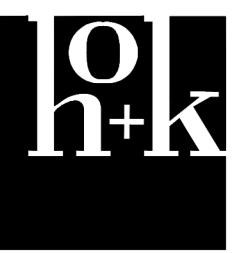
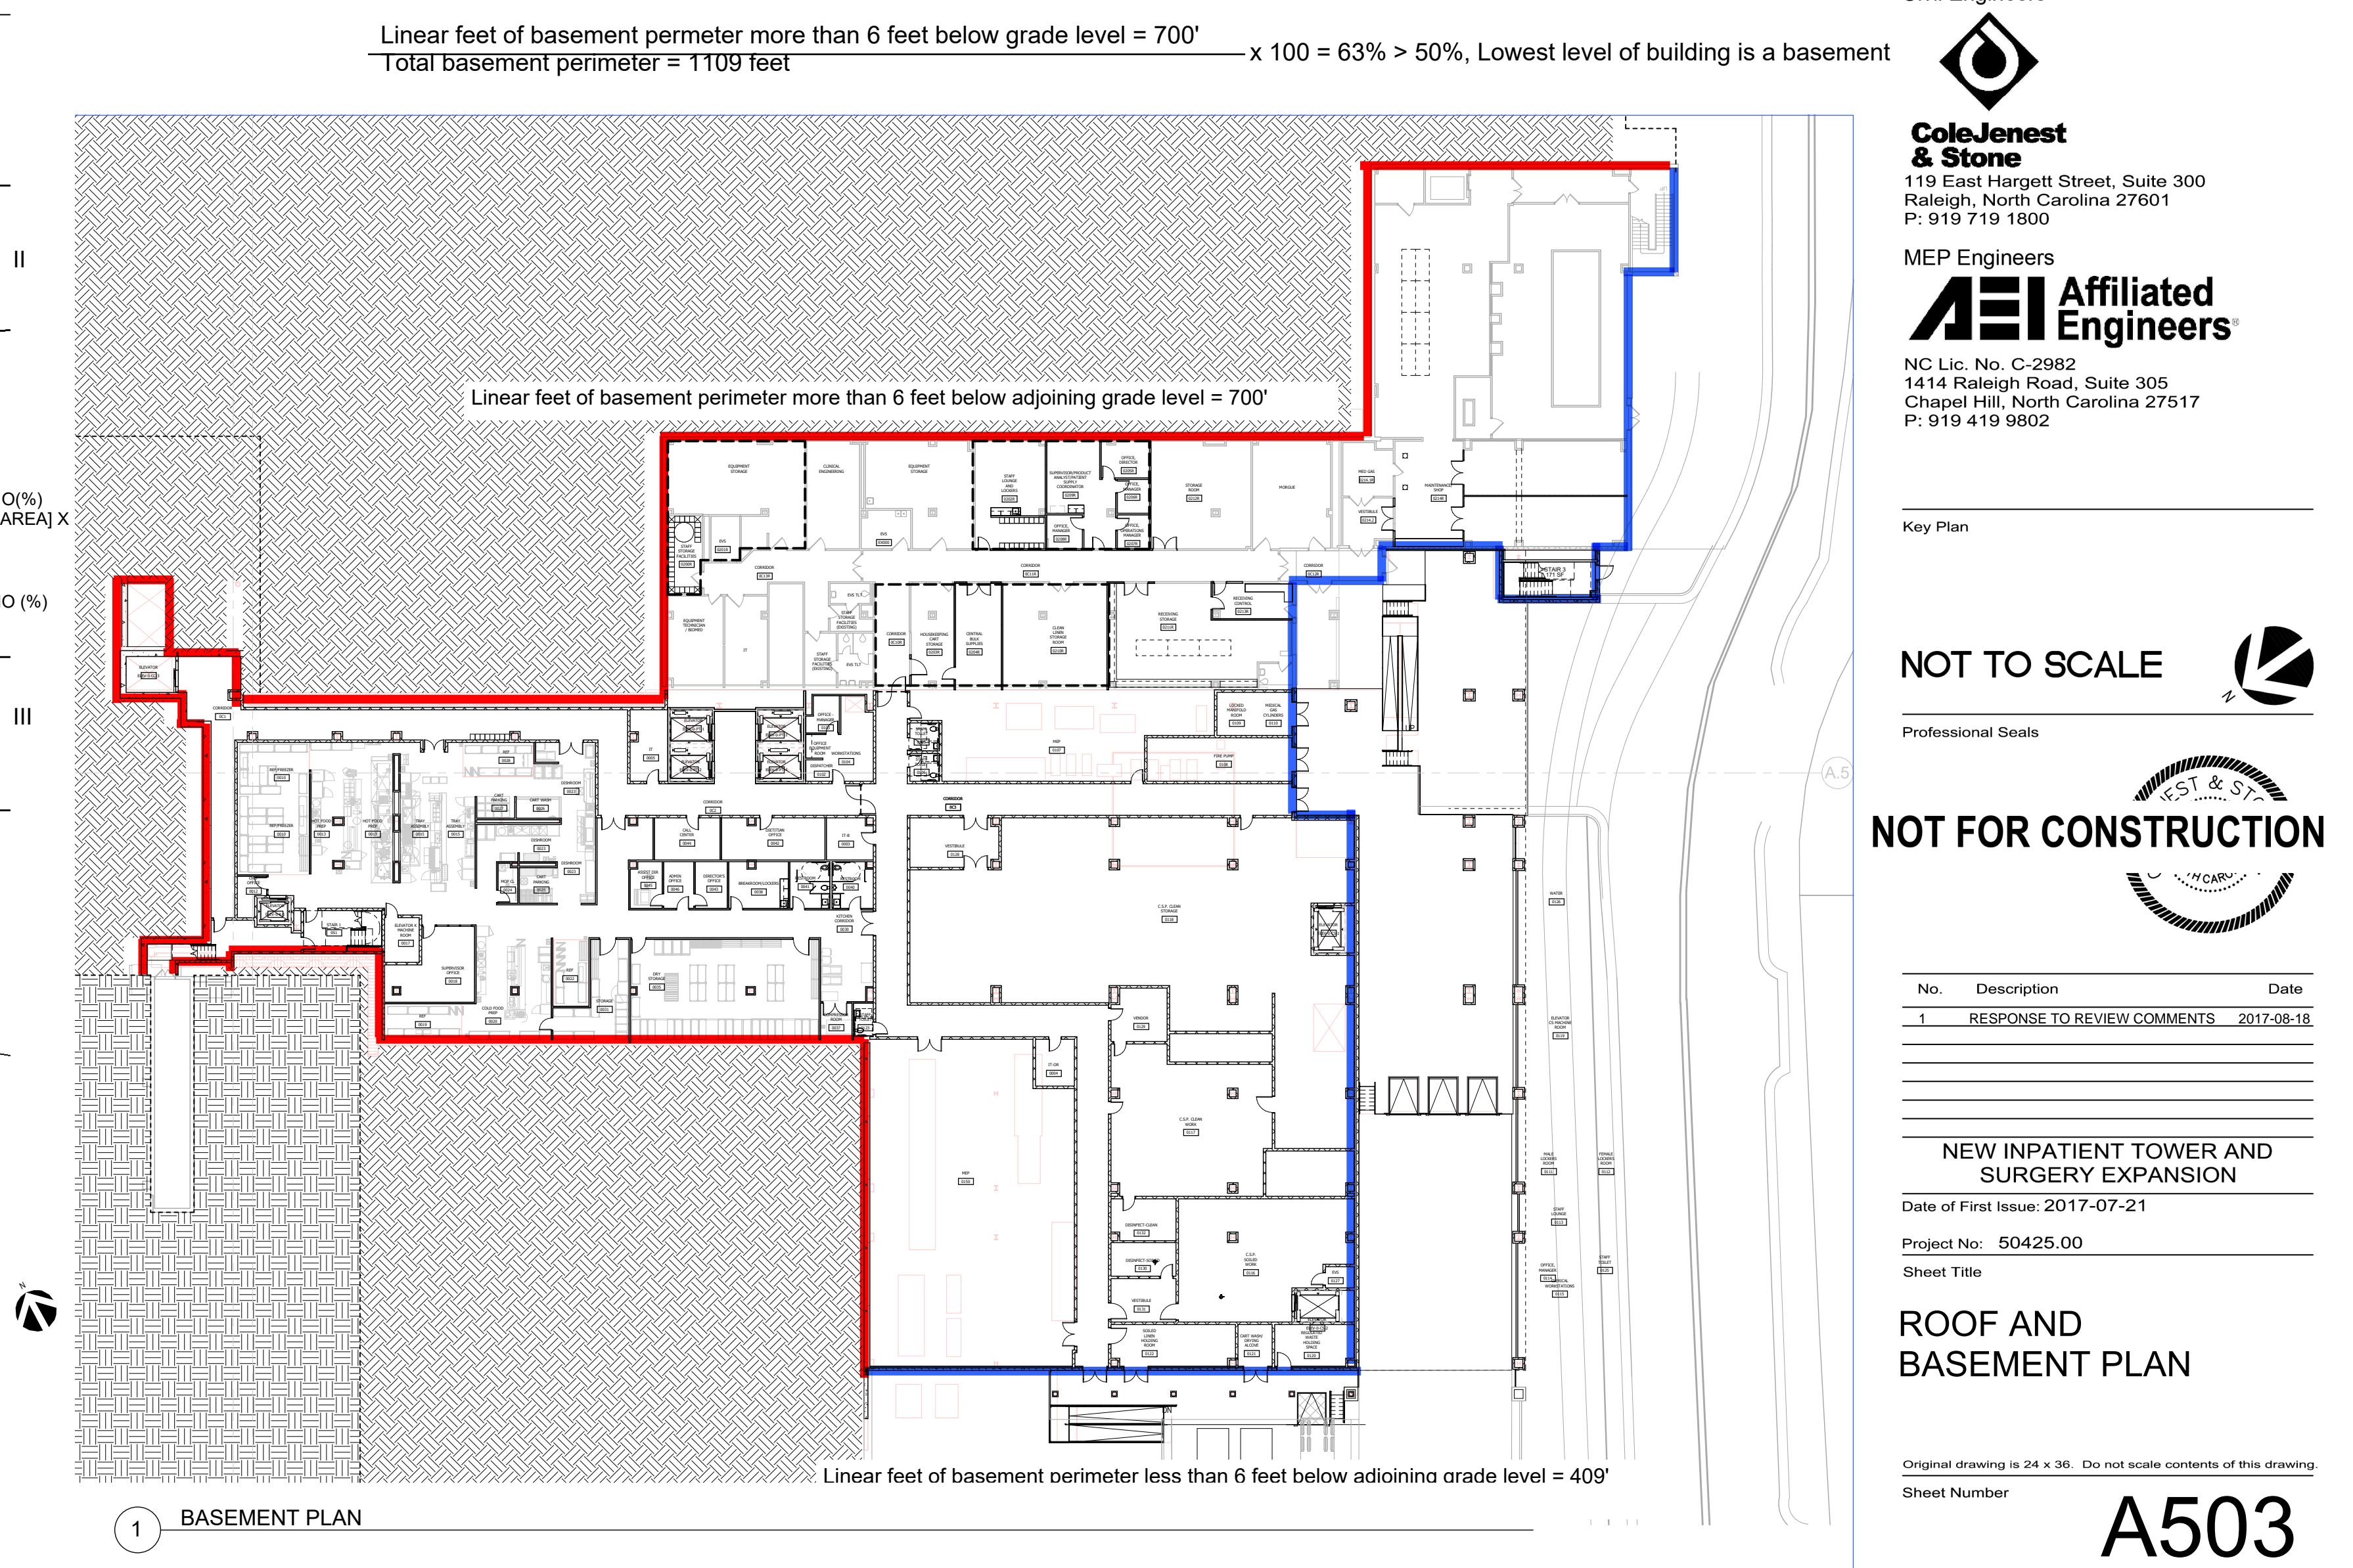
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- [ ] PRECAST CONCRETE
- [ ] GRAY PRECAST CONCRETE
- [ ] RATED WALL
- [ ] VISION GLASS
- [ ] SPANDEL GLASS
- [ ] METAL PANEL
- [ ] DEEP RIB GRAY METAL SCREEN



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