

Zoning: **DX-20-SH** CAC: **Central** 

Drainage Basin: Rocky Branch

Acreage: **1.85** 

Sq. Ft .: 1,121,576

Planner: Michael Walters Phone: (919) 996-2636

Applicant: Lundy Group Phone: (919) 821-7890



# Administrative Site Review Application (for UDO Districts only)




Development Services Customer Service Center | 1 Exchange Plaza. Suite 400 | Raleigh, NC 27601 | 919-996-2495 | efax 919-996-1831 Litchford Satellite Office | 8320 – 130 Litchford Road | Raleigh, NC 27601 | 919-996-4200


When submitting plans, please check the appropriate building type and include the Plan Checklist document.

BUILDING TYPE							FOR OFFICE USE ONLY		
Detached Attached	General  Mixed Use				Transaction Number				
Apartment Townhouse		□ 0	pen Lot	トプニ	) 14	7	Assigned 1	Fear Leader	
Has your project previou	usiy been through	the Due Diligence or S	Sketch Plan Review	process? If yes	, provide the	transacti	ion #		
		GEI	NERAL INFORMA	TION			**************************************	A.V.	
Development Name 3	01 Hillsbor	ough Street							
Zoning District DX-20-SH Overlay District (if applicable) Inside			Inside City	ty Limits? Yes $\square_{No}$					
Proposed Use Mixed	d Use Offic	ce, Retail, Re	sidential a	nd Hotel					
Property Address(es) 301 & 327 Hillsborough Street  Major Street Locator: Hillsborough Street							Street		
Wake County Property I	dentification Nun	nber(s) for each parcel	to which these gui	delines will app	ily:		15		
P.I.N. 1703593193, 1703594000 P.I.N. 1703594073 P.I.N. 1703595066 P.I.				P.I.N.	<sup>.N.</sup> 1703596095				
What is your project type?  Mixed Residential  Duplex  Other: If other, please of	Apartment ☐ Elderly Faciliti ☐ Non-Residential Condo ☐ School ☐ Telecommunication Tower ☐ Religious Institute ise describe:			Hospitals Hote Shopping Center Bank Residential Condo			<u> </u>		
WORK SCOPE  Per City Code Section 10.2.8.D.1, summarize the project work scope. For additions, changes of use, or occupancy (per Chapter 6 of the UDO), indicate impacts on parking requirements.  Mixed use building with approximately 220,007 +/- sf office; 242 residential units; 40,382 sf retail, 176 hotel units; and structured parking (991 +/- spaces)							ınits;		
DESIGN ADJUSTMENT OR ADMIN ALTERNATE	Per City Code Chapter 8, summarize if your project requires either a design adjustment, or Section 10 - Alternate Administrative AE  Building massing								
CLIENT/DEVELOPER/ OWNER	Company Lundy Group LAND OWNERS LLC Name (s) Jon Keener								
	Address 4600 Lake Boone Trail, SUITE 210 Raleigh, NC 27607								
	Phone 919-	-821-7890	<sup>Emall</sup> jkeene	r@lundyg	roup.co	m F	<sup>a×</sup> 919-	821-2070	
	Company Stewart Name (s) Joe Puckett								
CONSULTANT (Contact Person for	Address 421 Fayetteville St, Suite 400, Raleigh, NC 27601								
Pians)	Phone 919-	866-4829	<sup>Email</sup> jpuck	ett@stev	vartinc.c	om F	<sup>ax</sup> 919-	380-8752	

TO BE COMPLETED BY APPLICANT				TO BE COMPLETED BY CITY STAFF			
General Requirements	YES	N/A	YES	NO	N/A		
Filing Fee for Plan Review – Payments may be made by cash, Visa, Master Card or check made payable to the City of Raleigh							
2. Administrative Site Review Application_completed and signed by the property owner(s)			and the same of th				
Client must complete and adhere page 1 and 2 of the Administrative Site Review     Application to the plan cover sheet							
4. I have referenced the <b>Administrative Site Review Checklist</b> and by using this as a guide, it will ensure that I receive a complete and thorough first review by the City of Raleigh							
5. Provide the following plan sheets:							
a) Cover sheet: includes general notes, owner's name, contact's name, telephone number, mailing address and email address							
b) Existing Conditions Sheet, including, but not limited to, structures, buildings, utilities, infrastructure, and vegetation			V				
c) Proposed Site Plan							
d) Proposed Grading Plan							
e) Proposed Stormwater Plan, including preliminary stormwater quantity and quality summary and calculations package. If not required, provide City Code section on front cover.							
f) Proposed Utility Plan, including Fire							
g) Proposed Tree Conservation Plan – For secondary Tree Conservation Areas, include two copies of the tree cover report completed by a certified arborist, North Carolina licensed landscape architect, or North Carolina register forester. If not required, provide City Code section on front cover.		,					
h) Proposed Landscape Plan			V				
i) Building elevations that show existing and/or proposed building height. If demolition, do not include buildings to be demolished.			<b>U</b>				
j) Transportation Plan							
6. Ten (10) sets of proposed plans to engineering scale (1" = 20', 1" =100', etc.), and date of preparation. For re-submittals – include all revision dates							
7. Minimum plan size 18"x24" not to exceed 36"x42"							
8. A vicinity map no smaller/less than 1"=500' and no larger than 1"=1000' to the inch, showing the position of the plan with its relation to surrounding streets and properties, and oriented in the same direction as the preliminary plan							
9. Include sheet index and legend defining all symbols with true north arrow, with north being at the top of the map							
10. Digital copy of only the plan and elevations. Label the CD or flash drive with the plan name, case file number, and indicate the review cycle #.							
11. Wake County School Form, if dwelling units are proposed							
12. If applicable, zoning conditions adhered to the plan cover sheet							

DEVELOPMENT TYPE & SITE DATA TA	ABLE (Applicable to all developments)			
Zoning Information	Building Information			
Zoning District(s) DX-20-SH	Proposed building use(s) Mixed Use			
If more than one district, provide the acreage of each:	Existing Building(s) sq. ft. gross 6,792 S.F.			
Overlay District	Proposed Building(s) sq. ft. gross 1,121,576 S.F.			
Total Site Acres Inside City Limits Yes No 1.85 AC	Total sq. ft. gross (existing & proposed) 1,121,576			
Off street parking: Required 883 Provided 991	Proposed height of building(s) 245'-4"			
COA (Certificate of Appropriateness) case #	# of stories 20			
BOA (Board of Adjustment) case # A-	Ceiling height of 1st Floor Varies (18'-28')			
CUD (Conditional Use District) case # Z- 038-14 & Z-039-14				
Stormwater	rInformation			
Existing Impervious Surface 1.81 AC/ 78,893 S F acres/square feet	Flood Hazard Area 🔲 Yes 🔳 No			
Proposed Impervious Surface 2.16 AC/ 🔐 acres/square feet	If Yes, please provide:			
Neuse River Buffer Yes No Wetlands Yes No	Alluvial Soils Flood Study FEMA Map Panel #			
FOR RESIDENTIA	L DEVELOPMENTS			
Total # Of Apartment, Condominium or Residential Units 242	5. 8edroom Units: 1br 17 2br 67 3br 0 4br or more 0			
2. Total # Of Congregate Care Or Life Care Dwelling Units 0	6. Infill Development 2.2.7 <b>()</b>			
3. Total Number of Hotel Units 176	7. Open Space (only) or Amenity 18,408 S.F.			
4. Overall Total # Of Dwelling Units (1-6 Above) 418	8. Is your project a cottage court?   Yes No			
SIGNATURE BLOCK (Appli	cable to all developments)			
In filing this plan as the property owner(s), I/we do hereby agree and firm and assigns jointly and severally to construct all improvements and make approved by the City.  I hereby designate	to serve as my agent regarding this application, to behalf and to represent me in any public meeting regarding this			
ise.	, ,			
Signed The Control of	Manager Date 10/11/16			
Printed Name JONATHON M KETNOR	Lung Group Sul 11/17/16			
igned III a Cenx	Manager Date 11/17/16			
Printed Name 30 IN ATHON IN FEBRUAR	301 Holldrough Landervers LCC			
1205H Drainage Rocky boverlay 1.85 acres	Central CAC			

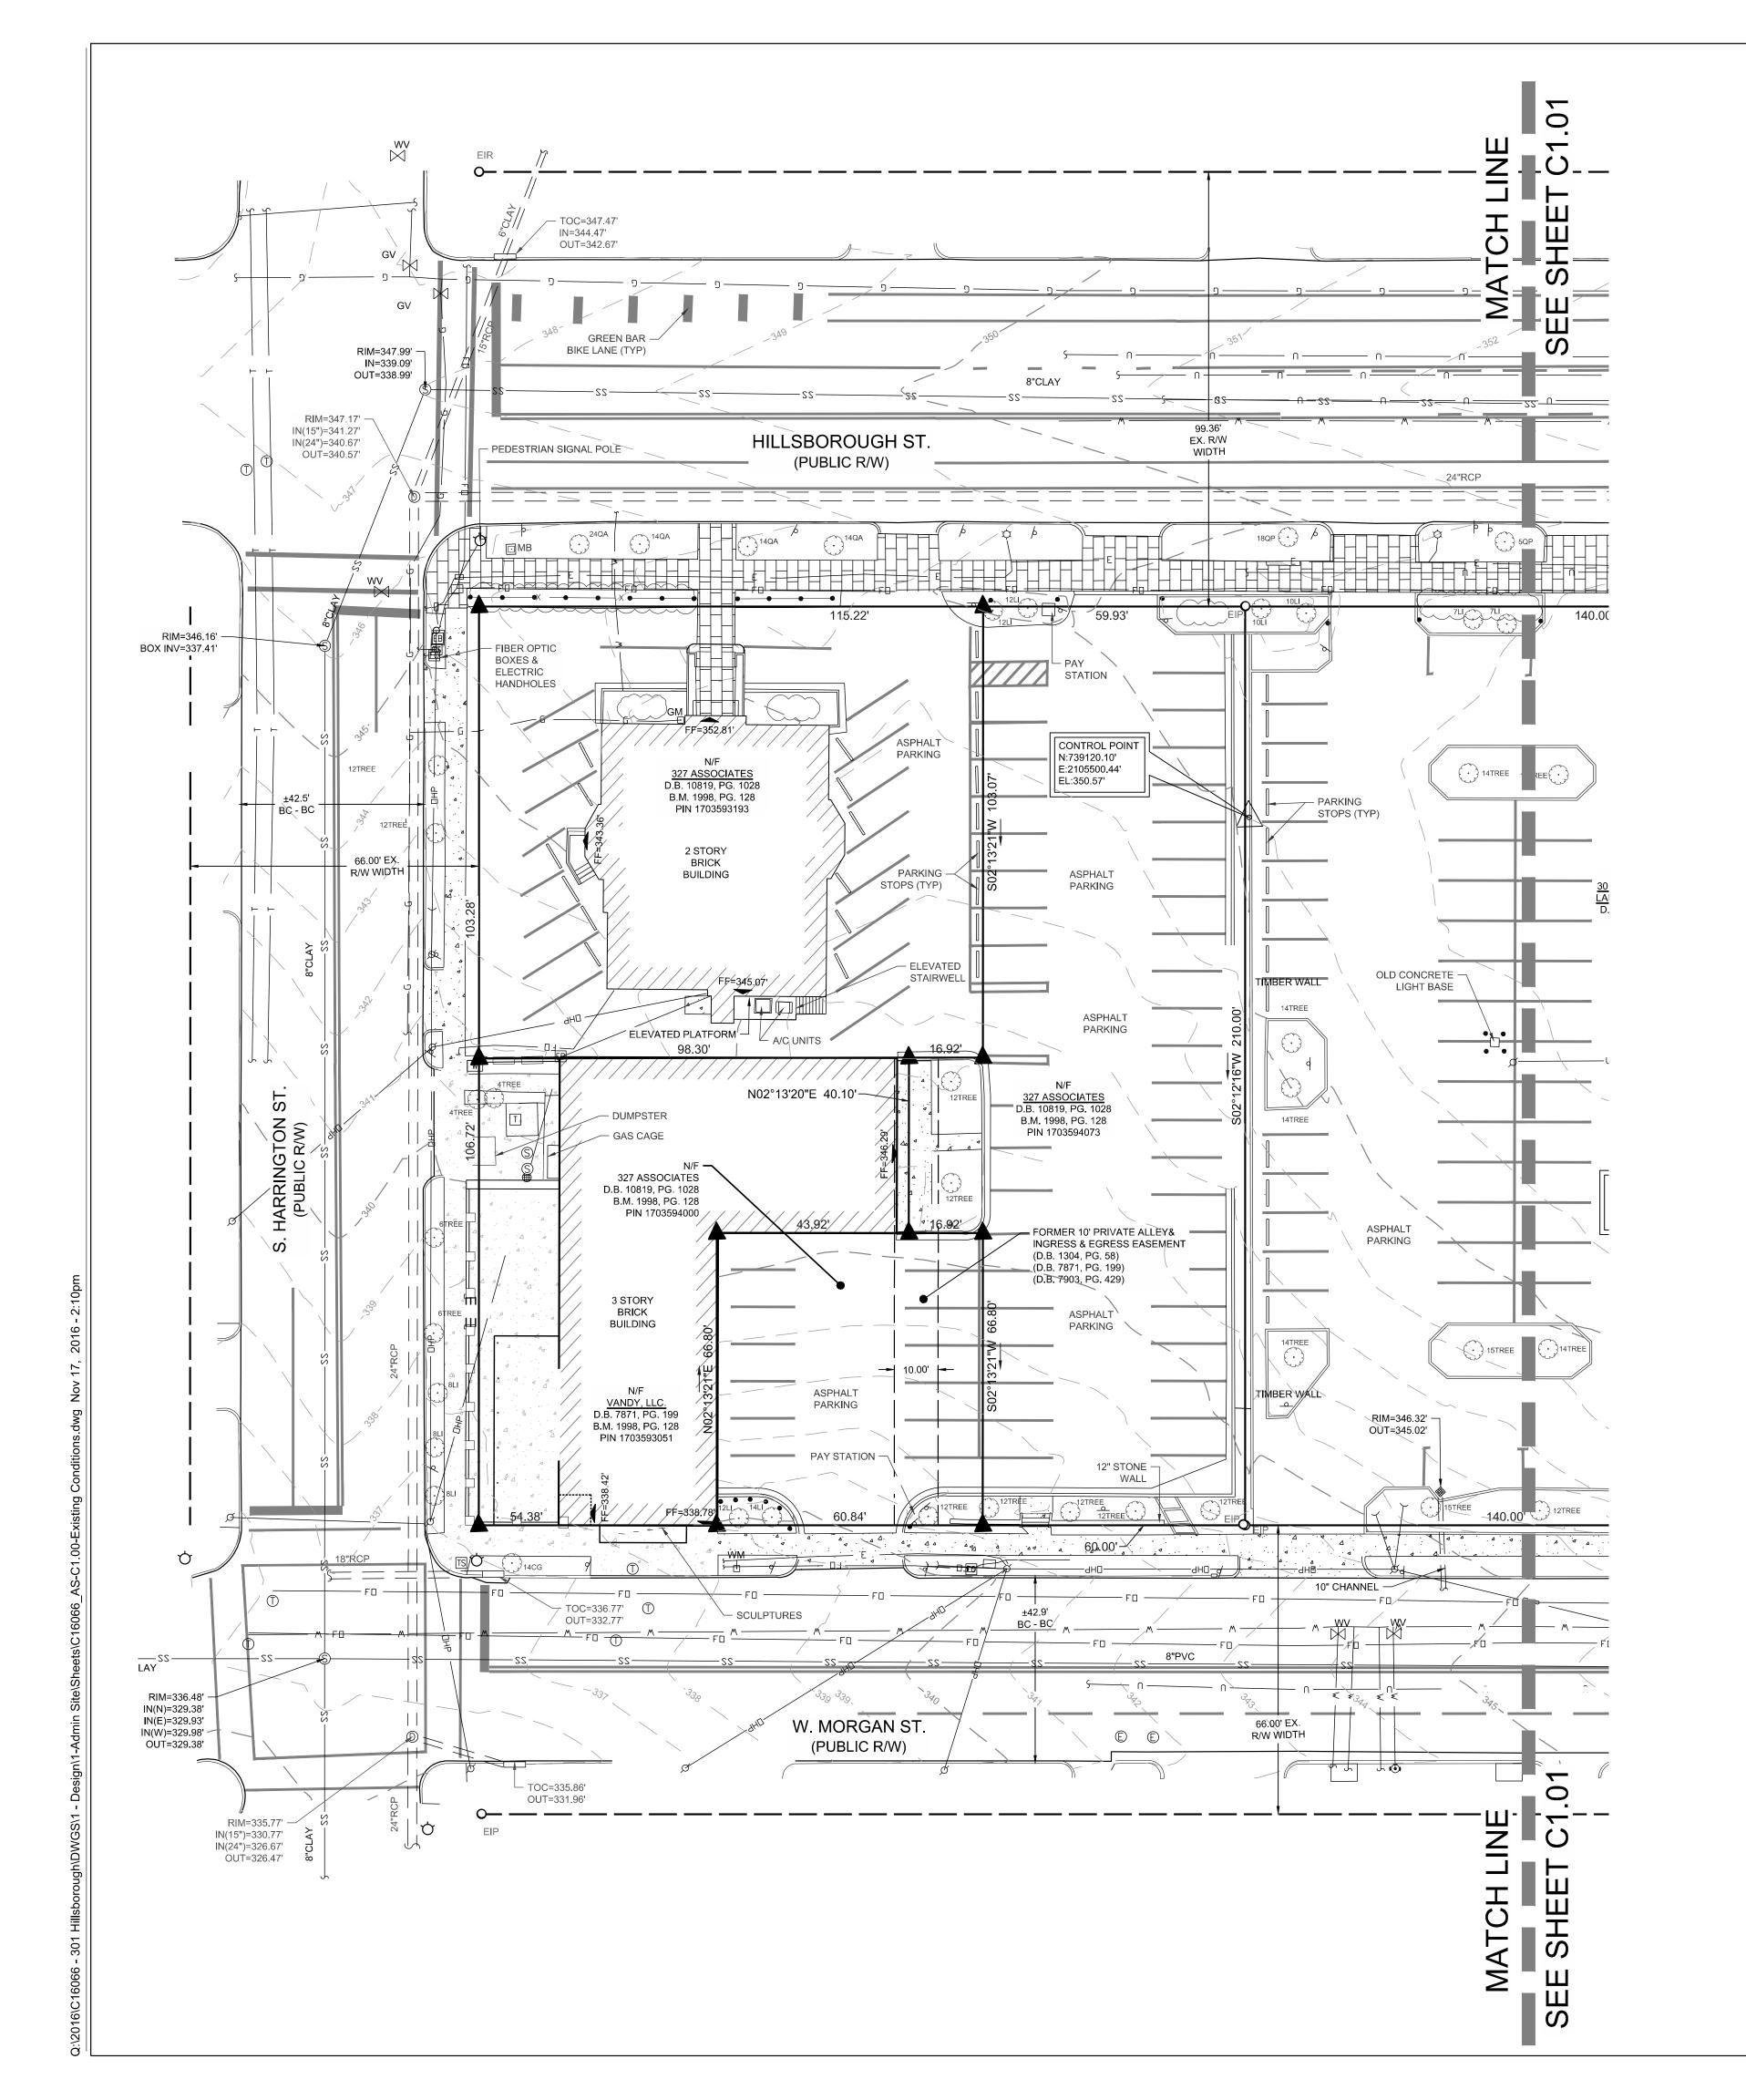

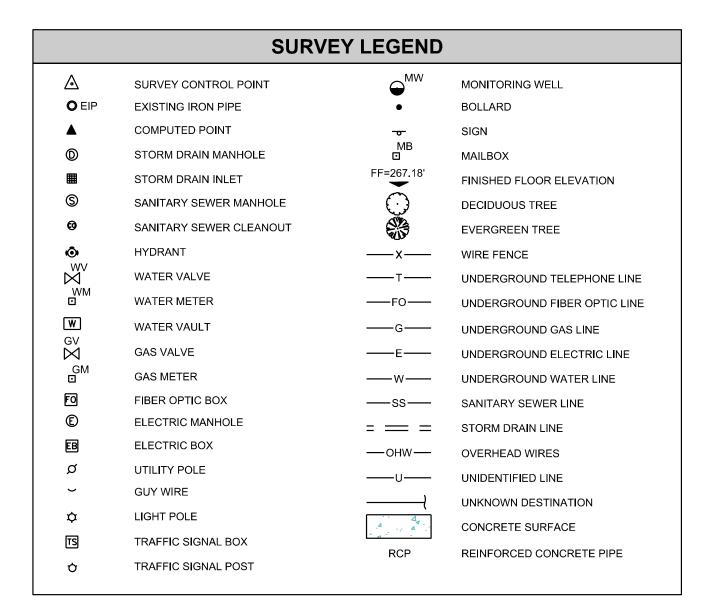


#### **SURVEY GENERAL NOTES:**


- 1. THIS SURVEY MAP IS INTENDED TO REPRESENT THE EXISTING CONDITIONS/TOPOGRAPHY ON A PORTION OF THE PROPERTIES SHOWN HEREON, PINS 1703593193, 1703594000, 1703595006, 1703595066, AND IS NOT A BOUNDARY SURVEY. THIS SURVEY WAS PERFORMED WITHOUT THE BENEFIT OF A TITLE REPORT AND THEREFORE ALL ENCUMBRANCES UPON THE PROPERTY MAY NOT BE SHOWN.
- 2. THE PROPERTY LINES SHOWN HEREON HAVE BEEN CONFIRMED FROM A PARTIAL SURVEY BY STEWART INC. PROPERTY LINES SHOWN TAKEN FROM REFERENCES SHOWN HEREON.
- 3. THE STATE PLANE COORDINATES (SPC) FOR THIS PROJECT WERE PRODUCED WITH STATIC GPS OBSERVATIONS AND PROCESSED WITH ONLINE POSITIONING USER SERVICE(OPUS). THE NETWORK POSITIONAL ACCURACY OF THE OPUS DERIVED POSITION INFORMATION IS 0.70CM. THE FOLLOWING CORS WERE USED BY OPUS-RS:

AM7024 SNFD SANFORD CORS ARP DK7576 NCNA NASHVILLE CORS ARP DK5550 NCGO GOLDSBORO CORS ARP

- 4. THIS DRAWING DOES NOT CONFORM TO N.C. GS47-30 AND THEREFORE IS NOT FOR RECORDATION.
- 5. UTILITIES SHOWN HEREON ARE BASED ON ABOVE-GROUND VISIBLE EVIDENCE AND UTILITY DESIGNATION/MARKING SERVICES PERFORMED BY STEWART INC AS A PART OF THIS SURVEY. CONTRACTOR SHALL FIELD VERIFY THE LOCATION OF ALL UTILITIES BEFORE COMMENCING CONSTRUCTION.
- 6. TREES SHOWN HEREON MAY NOT REPRESENT ALL VEGETATION ON THE SUBJECT PROPERTY.
- 7. THE SUBJECT PROPERTY IS ZONED "DX-20-SH" (PER WAKE COUNTY IMAPS).
- 8. THE SUBJECT PROPERTY LIES IN ZONES X (AREA DETERMINED TO BE OUTSIDE THE 0.2% ANNUAL CHANCE AND FUTURE CONDITIONS 1% ANNUAL CHANCE FLOODPLAIN). BASED ON THE FLOOD INSURANCE RATE MAP COMMUNITY MAP NUMBER 3720170300J DATED 05/02/06. FLOOD HAZARD LINES SHOWN HEREON ARE FROM NCFLOODMAPS.COM.

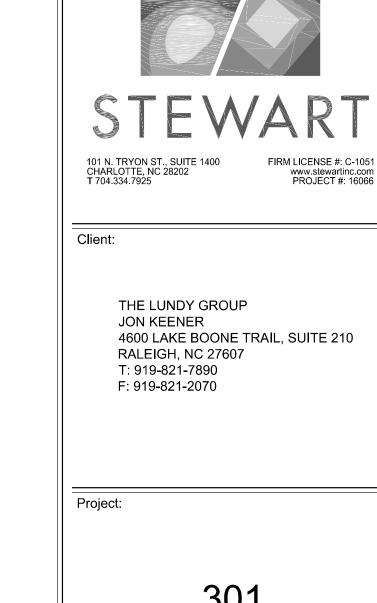


# HILLSBOROUGH

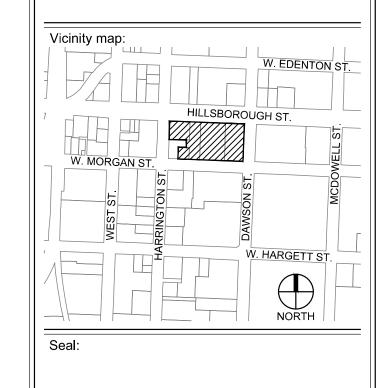

PRELIMINARY - DO NOT USE FOR CONSTRUCTION

### ADMINISTRATIVE SITE

No. Date Description

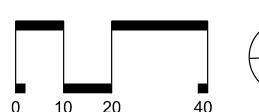

SCALE: 1"=20'

Issued for:

**EXISTING CONDITIONS PLAN** (WEST)


Project number: C16066 Sheet: 11.17.2016 Drawn by: NBC / RS Approved by: JWP Approved by:


 $\frac{\text{KEY PLAN}}{\text{N.T.S.}}$ :

HILLSBOROUGH STREET

C1.00


C1.01

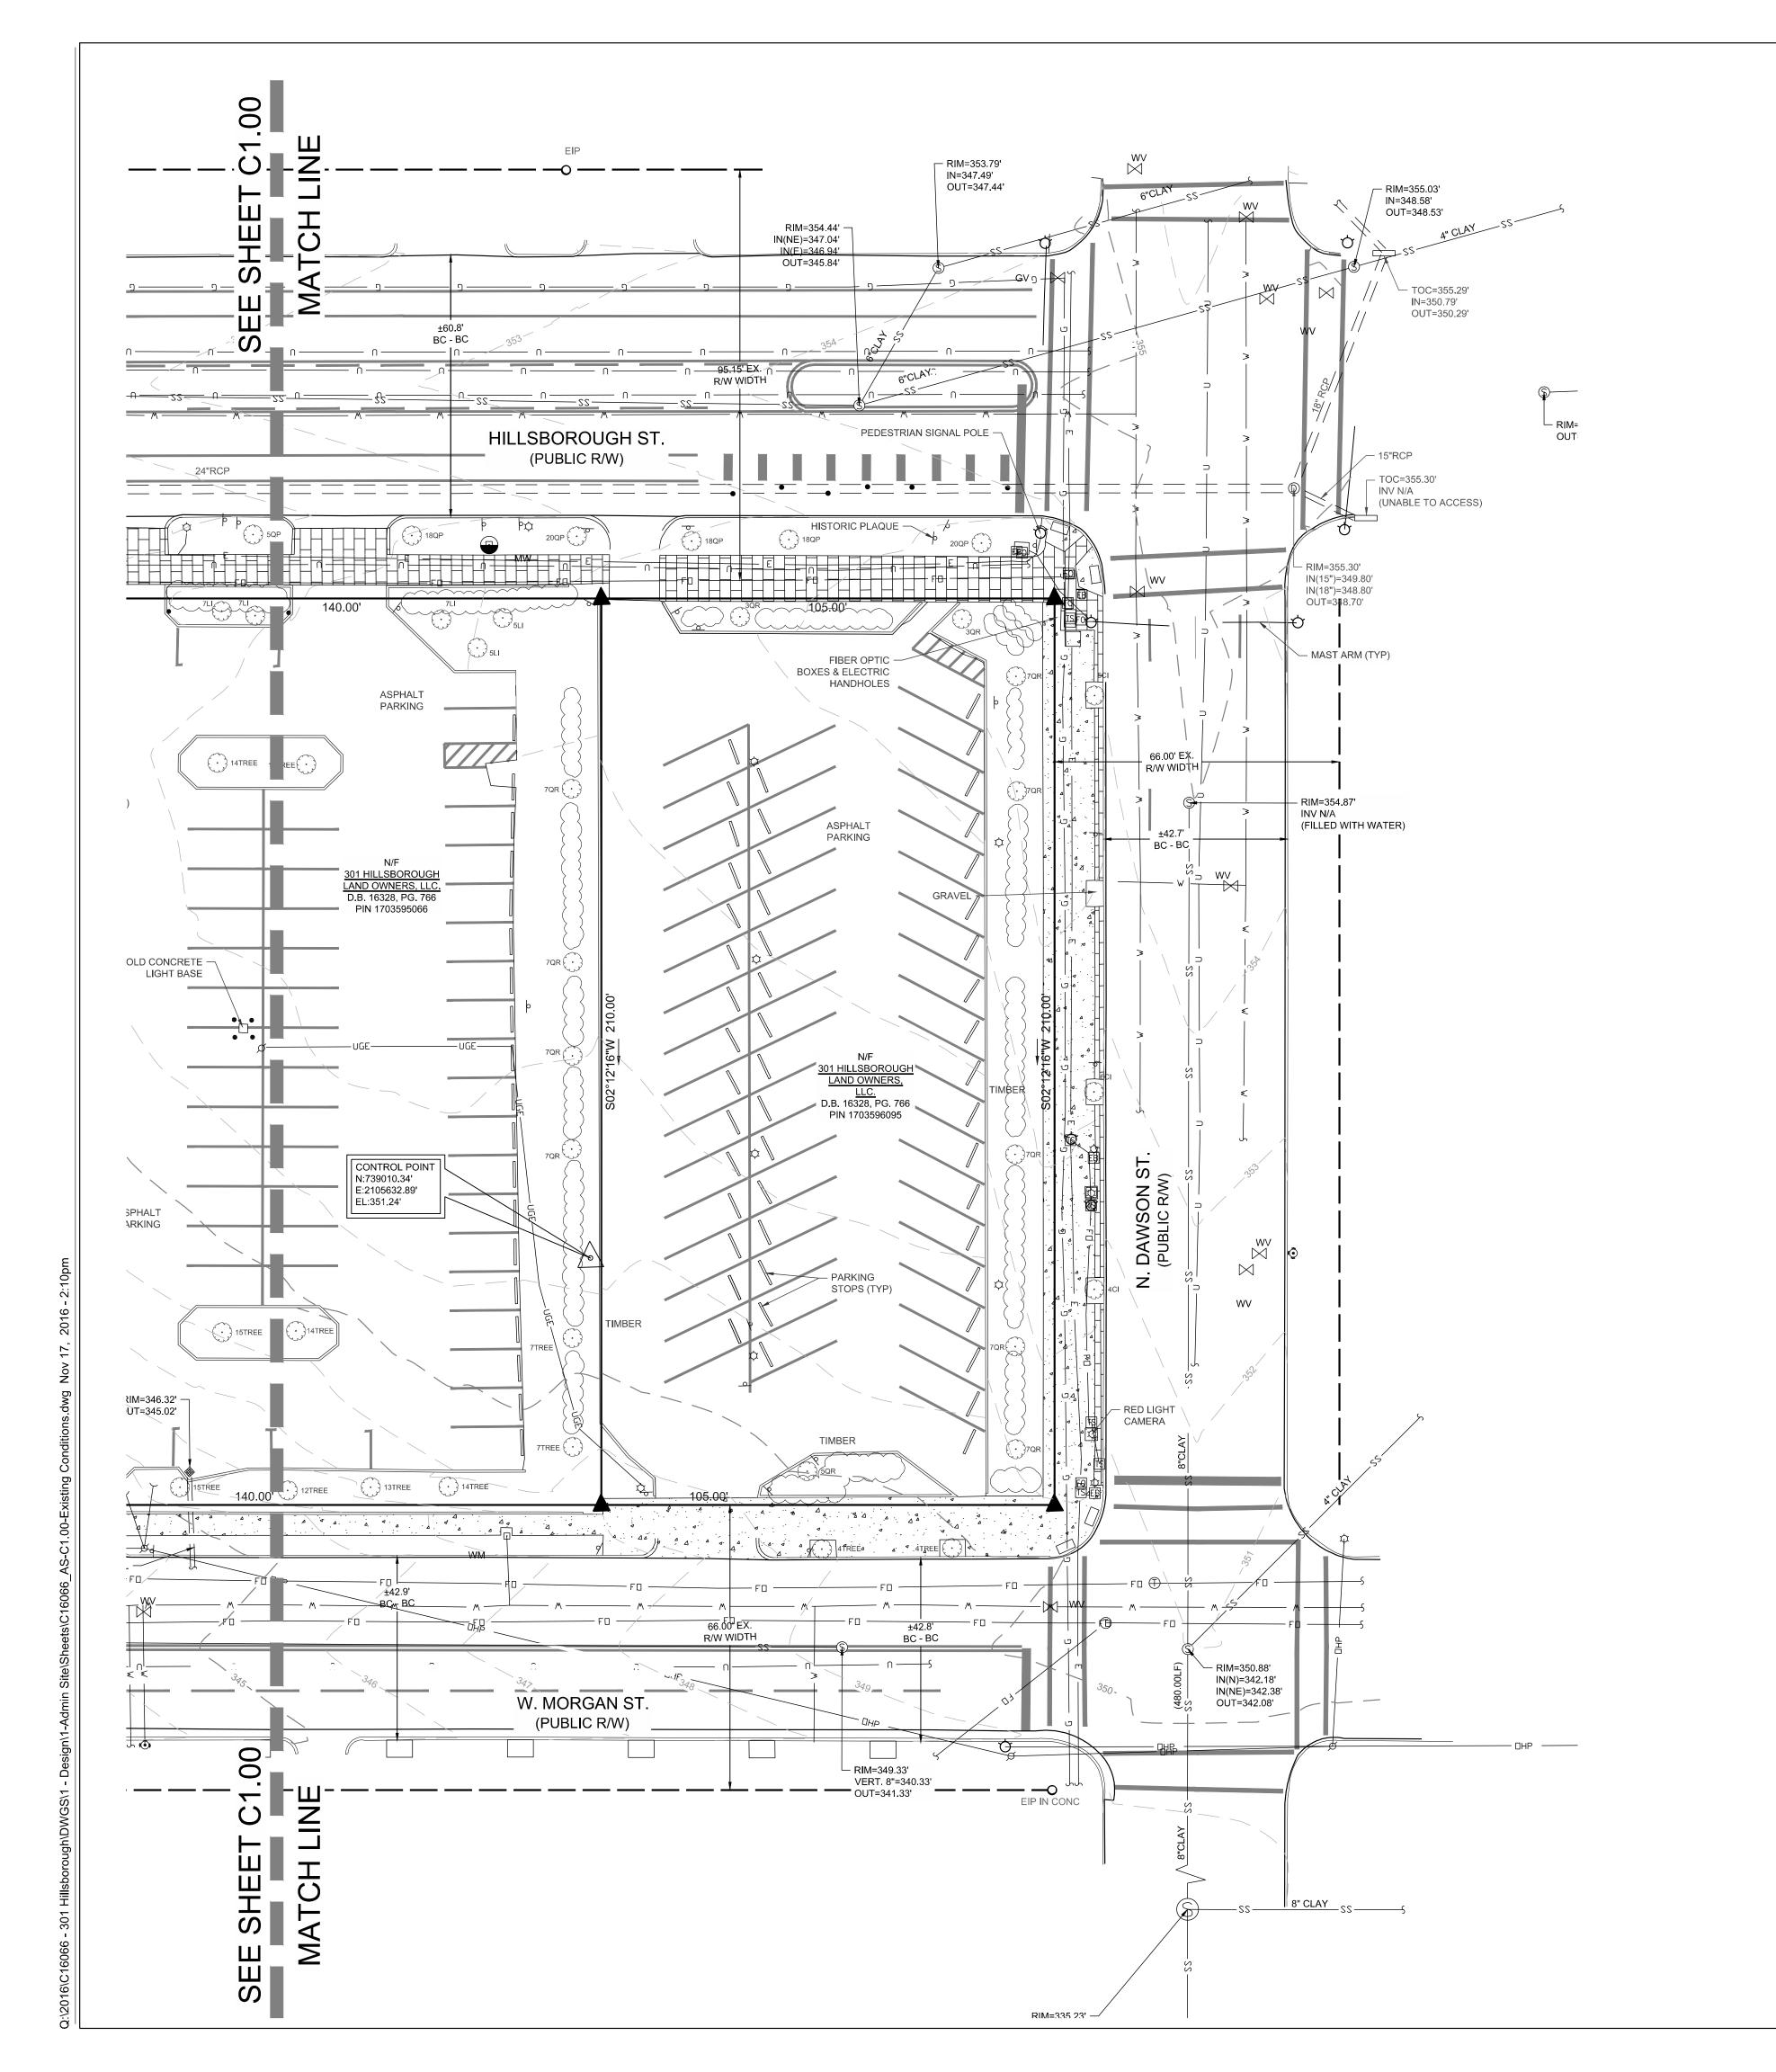


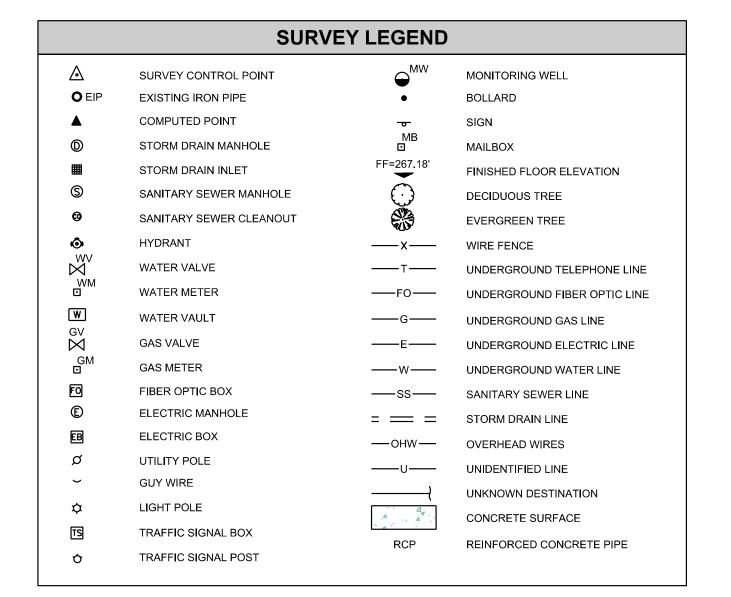

### NOTES:


- 1. SEE SHEET C1.00 FOR SURVEY GENERAL NOTES.
- SEE SHEET C2.00 FOR DEMOLITION PLAN AND NOTES.
- 3. SEE SHEET C3.00 FOR SITE PLAN AND GENERAL NOTES.

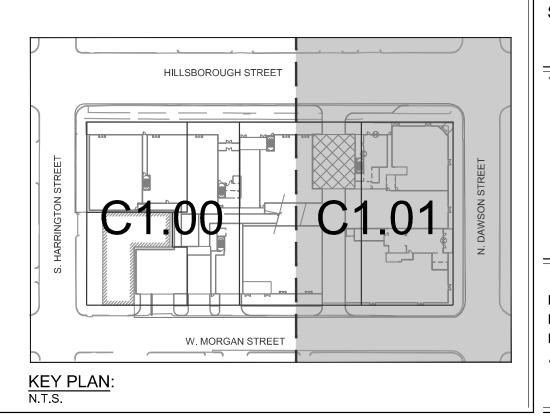

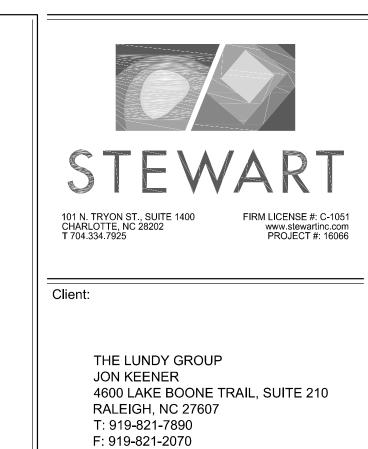


Project:

### 301 HILLSBOROUGH

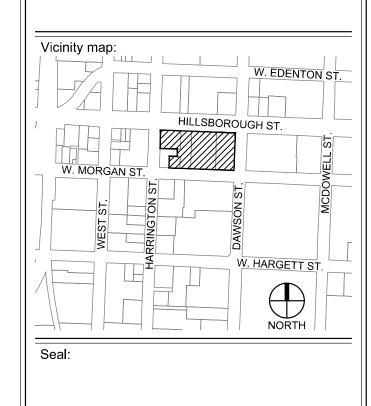

PRELIMINARY - DO NOT USE FOR CONSTRUCTION

### ADMINISTRATIVE SITE

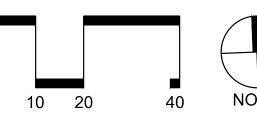

SCALE: 1"=20'

No. Date Description

Title:


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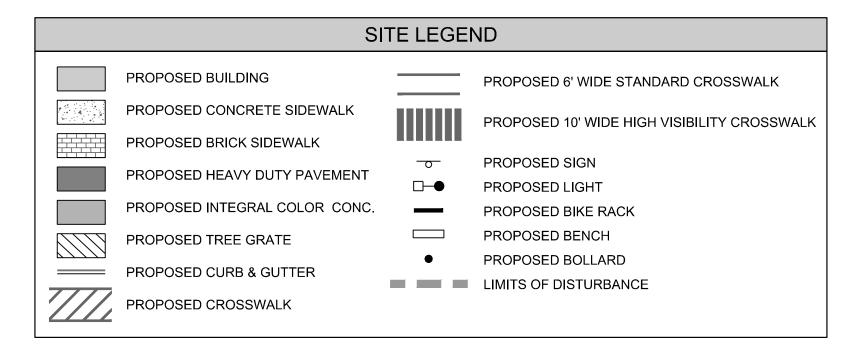
EXISTING CONDITIONS PLAN (EAST)

Project number: C16066 Sheet:

Date: 11.17.2016

Drawn by: NBC / RS
Approved by: JWP



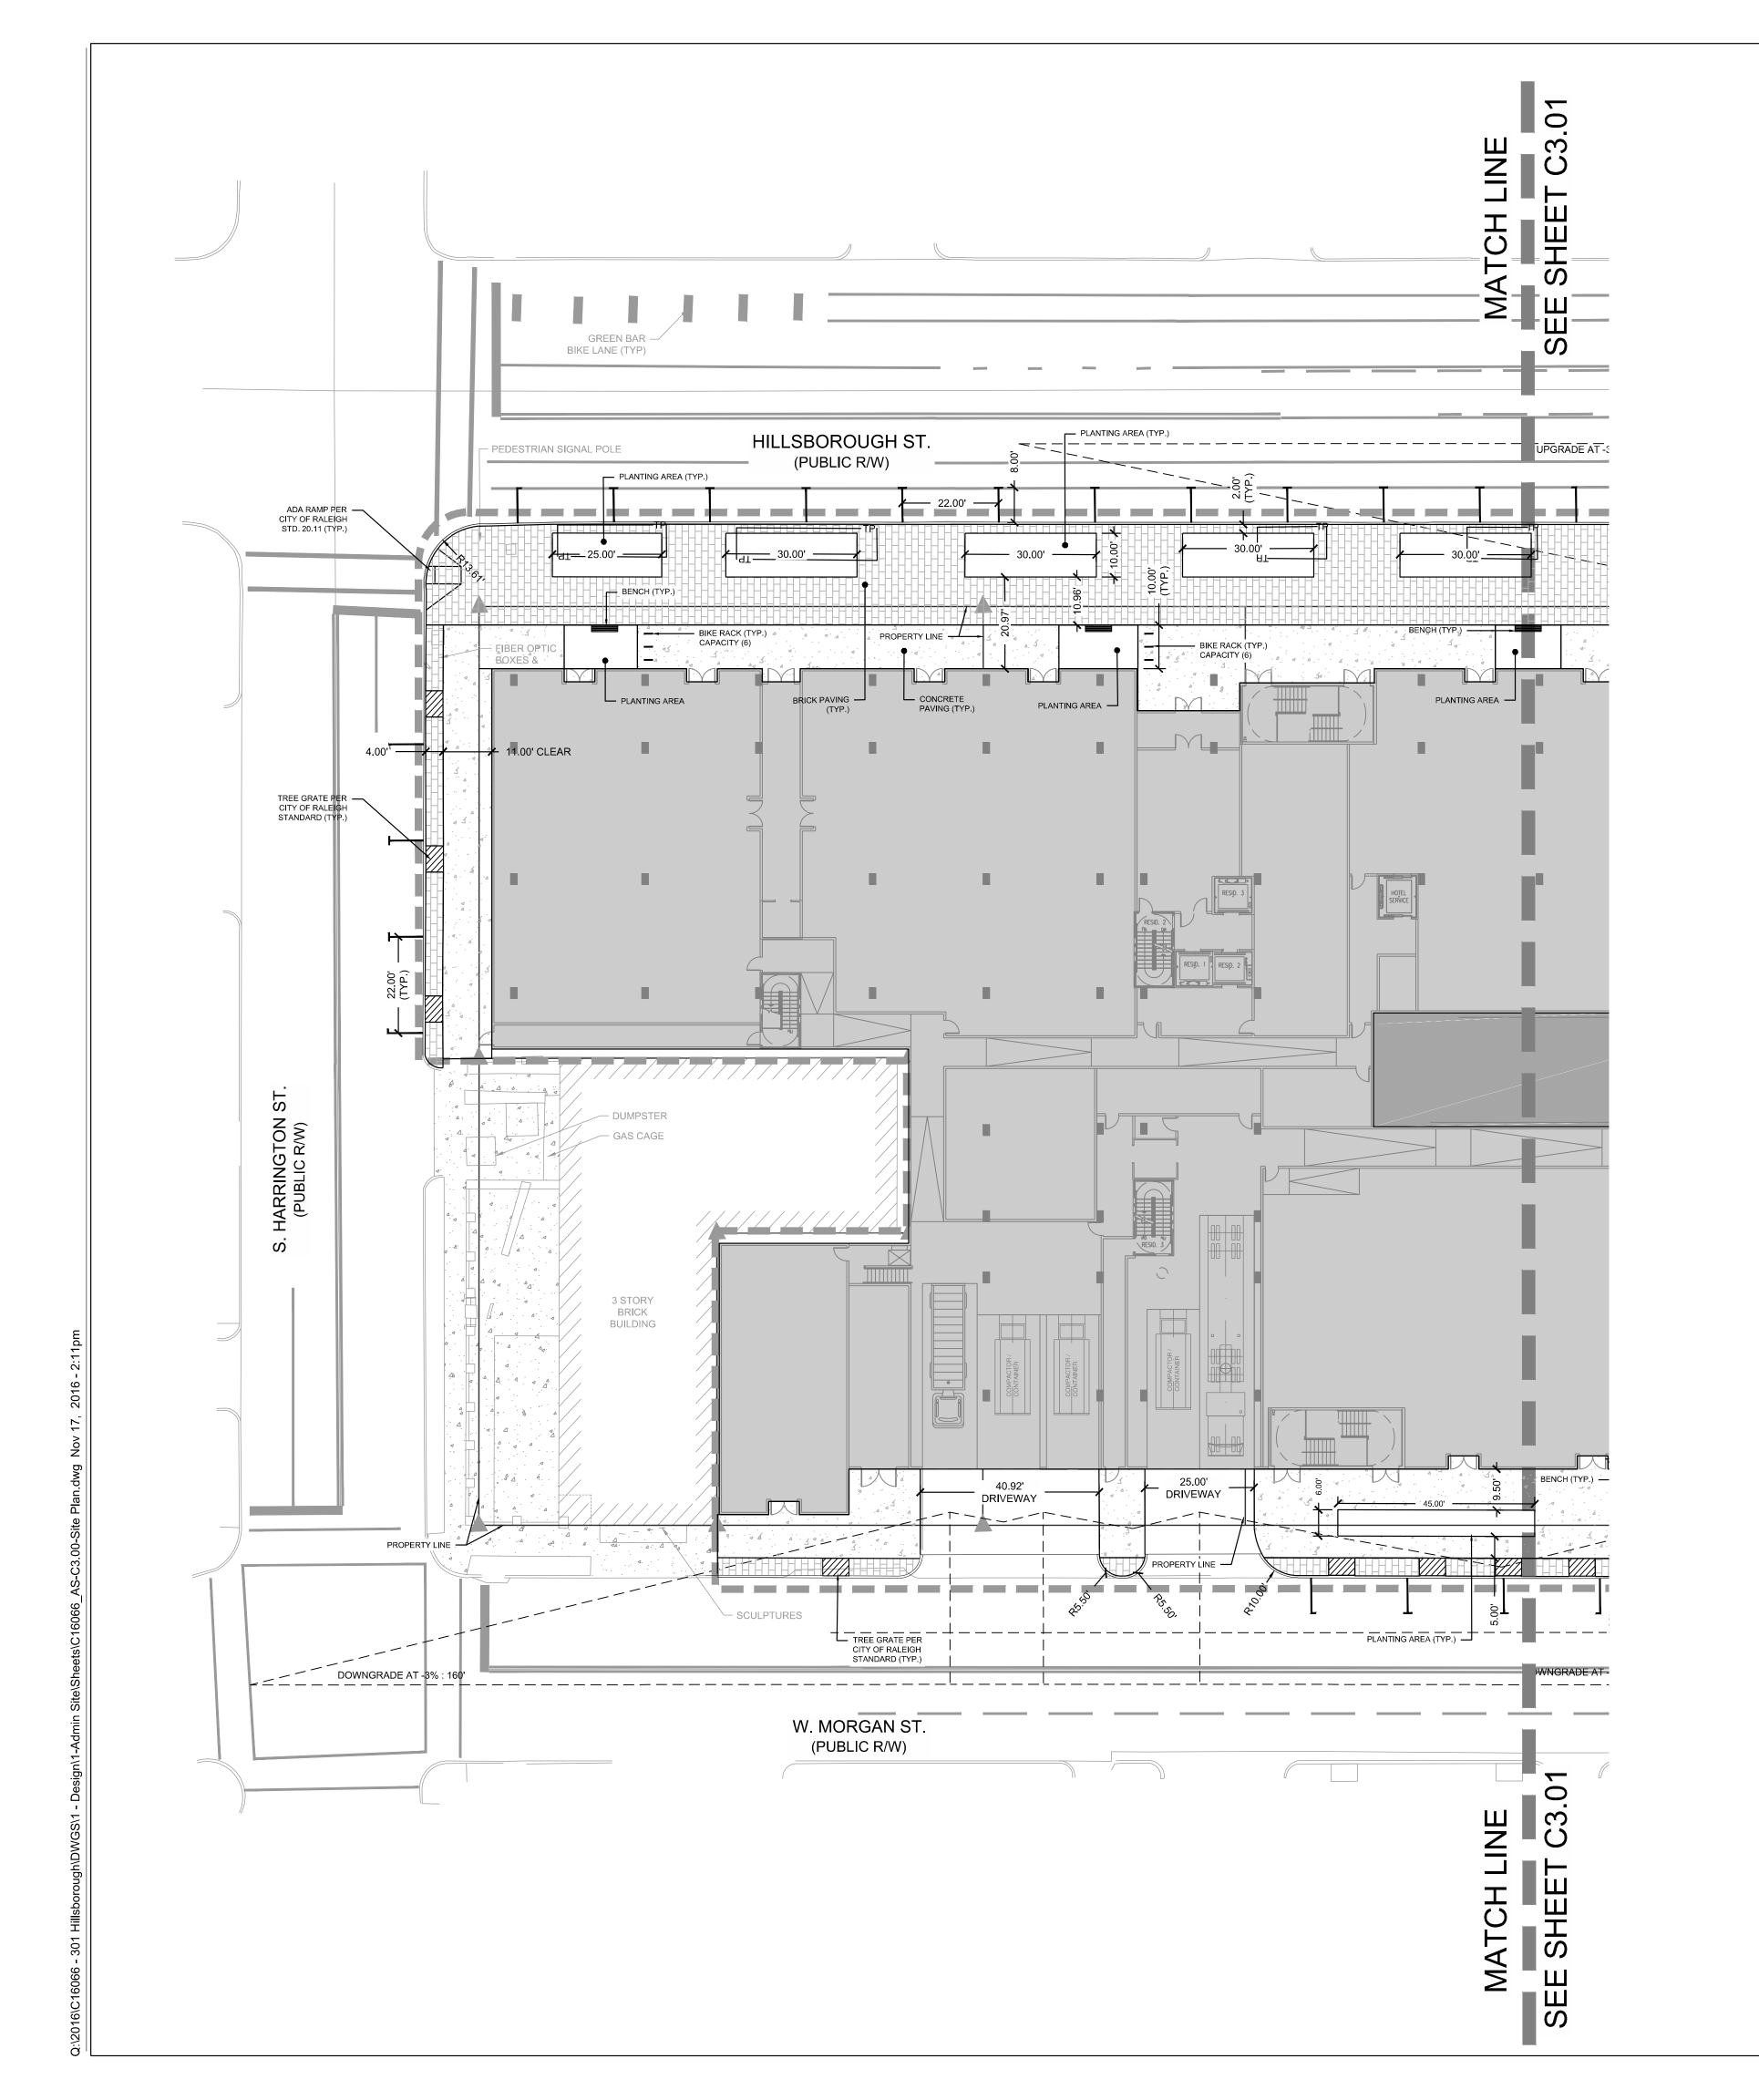

#### **GENERAL NOTES**:

- 1. ALL MATERIALS AND METHODS OF CONSTRUCTION SHALL BE IN COMPLIANCE WITH THE OFFICE OF STATE CONSTRUCTION, DEPARTMENT OF INSURANCE, NCDENR, AND ALL OTHER APPLICABLE LOCAL, STATE AND FEDERAL GUIDELINES. ALL UTILITY CONSTRUCTION SHALL COMPLY WITH APPLICABLE LOCAL JURISDICTIONAL STANDARDS AND SPECIFICATIONS.
- 2. EXISTING SURVEY INFORMATION INCLUDING TOPOGRAPHIC INFORMATION PROVIDED BY STEWART, UNLESS OTHERWISE NOTED. THE CONTRACTOR SHALL BE RESPONSIBLE FOR FIELD VERIFYING EXISTING CONDITIONS PRIOR TO COMMENCEMENT OF ANY WORK. THE CONTRACTOR SHALL IMMEDIATELY NOTIFY THE OWNER'S REPRESENTATIVE OF ANY DISCREPANCIES OR CONFLICTS.
- 3. THE CONTRACTOR SHALL BE RESPONSIBLE FOR CONTACTING, COORDINATING AND PAYMENT FOR ALL NECESSARY LOCATING SERVICES INCLUDING INDEPENDENT LOCATING SERVICES. THE CONTRACTOR SHALL PROVIDE NOTICE OF EXCAVATION TO NOTIFICATION CENTER AND FACILITY OWNERS (PER NC STATUTE) NO LESS THAN 3 BUSINESS DAYS AND NO MORE THAN 12 WORKING DAYS PRIOR TO BEGINNING DEMOLITION, EXCAVATION OR ANY OTHER FORM OF CONSTRUCTION. THE CONTRACTOR SHALL IMMEDIATELY NOTIFY THE OWNER'S REPRESENTATIVE OF ANY DISCREPANCIES OR CONFLICTS. NO EXCAVATION OR DEMOLITION SHALL BE STARTED WITHOUT ALL UTILITIES BEING LOCATED.
- 4. ALL SUB-SURFACE UTILITIES IDENTIFIED ON THE CONSTRUCTION DOCUMENTS ARE SHOWN IN THEIR APPROXIMATE LOCATION BASED ON SURVEY INFORMATION GATHERED FROM FIELD INSPECTION AND/OR ANY OTHER APPLICABLE RECORD DRAWINGS WHICH MAY BE AVAILABLE. THE CONTRACTOR SHALL IMMEDIATELY NOTIFY THE OWNER'S REPRESENTATIVE OF ANY DISCREPANCIES OR CONFLICTS.
- 5. EXISTING IMPROVEMENTS DAMAGED OR DESTROYED BY THE CONTRACTOR DURING CONSTRUCTION SHALL BE RESTORED OR REPLACED TO ORIGINAL CONDITION AND TO THE SATISFACTION OF THE OWNER'S REPRESENTATIVE AT THE CONTRACTOR'S EXPENSE.
- 6. THE CONTRACTOR SHALL BE RESPONSIBLE FOR OBTAINING AND COORDINATING PERMITS, INSPECTIONS, CERTIFICATIONS AND OTHER REQUIREMENTS WHICH MUST BE MET UNDER THIS CONTRACT.
- 7. THE CONTRACTOR SHALL MAINTAIN "AS-BUILT" DRAWINGS TO RECORD THE ACTUAL LOCATION OF ALL PIPING PRIOR TO CONCEALMENT, VALVE AND MANHOLE CHANGES, AND HARDSCAPE OR LANDSCAPE CHANGES. DRAWINGS SHALL BE PROVIDED TO THE OWNER'S REPRESENTATIVE AT REGULAR INTERVALS, OR AS REQUESTED THROUGHOUT THE PROJECT FOR RECORD KEEPING.
- 8. IF DEPARTURES FROM THE PROJECT DRAWINGS OR SPECIFICATIONS ARE DEEMED NECESSARY BY THE CONTRACTOR, DETAILS OF SUCH DEPARTURES AND REASONS THERE OF SHALL BE SUBMITTED TO THE OWNER'S REPRESENTATIVE FOR REVIEW. NO DEPARTURES FROM THE CONTRACT DOCUMENTS SHALL BE MADE WITHOUT THE EXPRESS WRITTEN PERMISSION OF THE OWNER'S REPRESENTATIVE.
- 9. THE CONTRACTOR SHALL BE RESPONSIBLE FOR THE RELOCATION OF ANY EXISTING UTILITY LINES REQUIRED TO COMPLETE ANY PORTION OF CONSTRUCTION. THE CONTRACTOR SHALL ALSO BE RESPONSIBLE FOR THE COORDINATION AND COSTS OF THE RELOCATION AND ASSOCIATED WORK.
- 10. THE CONTRACTOR SHALL BE RESPONSIBLE FOR KEEPING THE PREMISES FREE FROM ACCUMULATIONS OF WASTE MATERIALS AND RUBBISH CAUSED BY THE CONTRACTOR. ALL DEBRIS SHALL BE REMOVED FROM THE PROJECT SITE ON A DAILY BASIS.
- 11. THE ENGINEER AND/OR OWNER DISCLAIM ANY ROLE IN THE CONSTRUCTION MEANS AND/OR METHODS ASSOCIATED WITH THE PROJECT AS SET FORTH IN THESE PLANS
- 12. ROADWAYS (TEMPORARY OR PERMANENT) MUST BE CAPABLE OF SUPPORTING FIRE FIGHTING APPARATUS (85,000 LBS) DURING ALL PHASES OF CONSTRUCTION ONCE VERTICAL CONSTRUCTION HAS BEGUN.


#### SITE NOTES:

- 1. THE CONTRACTOR SHALL BE RESPONSIBLE FOR THE INSTALLATION AND MAINTENANCE OF THE CONSTRUCTION LAYDOWN AREA, PERIMETER FENCE, AND ASSOCIATED GATES. THE CONTRACTOR SHALL ALSO BE RESPONSIBLE FOR THE REMOVAL OF THE CONSTRUCTION LAYDOWN AREA PERIMETER FENCE AND ASSOCIATED GATES AT THE COMPLETION OF THE PROJECT.
- 2. THE CONTRACTOR SHALL REFERENCE THE DESIGN PLANS FOR DIMENSIONS, JOINT LOCATIONS, AND INLAY SPECIFICATIONS NEAR BUILDINGS AND IN COURTYARDS. CONTRACTOR SHALL PROVIDE JOINTS IN WALKWAYS AND HARDSCAPE PER DETAILS OR AS INDICATED ON LANDSCAPE/HARDSCAPE PLAN SHEETS.
- 3. ALL CONSTRUCTION TRAFFIC SHALL ENTER SITE FROM HARRINGTON STREET UNLESS OTHERWISE APPROVED IN WRITING FROM THE OWNER'S REPRESENTATIVE FOR AN ALTERNATE POINT OF ACCESS.
- 4. REFER TO ARCHITECTURAL PLANS FOR BUILDING INFORMATION.
- 5. ALL DIMENSIONS ARE IN DECIMAL FEET TO OUTSIDE FACE OF BUILDINGS, TO CENTERLINES, AND/OR FACE OF CURB UNLESS OTHERWISE NOTED.
- 6. THE CONTRACTOR SHALL VERIFY ALL DIMENSIONS AND COORDINATES AND REPORT ANY DISCREPANCIES TO THE OWNER'S REPRESENTATIVE PRIOR TO ANY CONSTRUCTION.
- 7. ALL WRITTEN DIMENSIONS SHALL PREVAIL. DO NOT SCALE FROM DRAWINGS.
- 8. ALL UTILITIES WITH SURFACE ACCESS SHALL BE LOCATED WITHIN THE PAVING PATTERN AND SHALL BE COORDINATED WITH LANDSCAPE ARCHITECT PRIOR TO CONSTRUCTION. REFER TO LAYOUT DRAWINGS.
- 9. ALL ANGLES ARE 90 DEGREES UNLESS OTHERWISE NOTED.
- 10. ALIGN ALL JOINTS, CORNERS, AND EDGES AS SHOWN
- 11. CONTRACTOR SHALL REFER TO AND COORDINATE WITH ARCHITECTURAL, STRUCTURAL, AND MEP DRAWINGS AT ALL TIMES PRIOR TO AND DURING CONSTRUCTION
- 12. ALL CURB TAPERS ARE SIX (6') FEET LONG UNLESS OTHERWISE SHOWN ON PLAN.
- 13. WHERE NEW SIDEWALK ADJOINS EXISTING WALK, PROVIDE EXPANSION JOINT BY DRILLING INTO THE FACE OF THE EXISTING WALK FOR PLACEMENT OF DOWELS. TIE NEW SIDEWALKS INTO NEAREST EXISTING PAVEMENT JOINT; MATCH WIDTH OF EXISTING WALKWAY.
- 14. MAXIMUM RUNNING SLOPE FOR WALKING SURFACES CANNOT BE GREATER THAN 1:20 AND CROSS SLOPES CANNOT BE GREATER THAN 1:48. HANDICAP SPACES SURFACE SLOPES SHALL NOT EXCEED 1:48 IN <u>ALL DIRECTIONS.</u>
- 15. SIGHT TRIANGLES NOTHING OVER 30" HIGH SHALL BE ALLOWED WITHIN THE SIGHT DISTANCE TRIANGLES.
- 16. THE SITE SHALL BE FULLY STABILIZED (90% COVERAGE) PRIOR TO ISSUANCE OF A BUILDING CERTIFICATE OF OCCUPANCY OR PROJECT APPROVAL
- 17. HANDICAP RAMPS SHALL BE INSTALLED PER LATEST EDITION OF THE NC BUILDING CODE AND ANSI 117.11 WITH DETECTABLE WARNING DOMES WITH A COLOR CONTRAST OF 70% MINIMUM. SEE DETAILS AND GRADING SPOT ELEVATIONS, IF THE EXISTING CONDITIONS PRECLUDE THE ABILITY TO PROVIDE A MAXIMUM SLOPE 1/12 FOR 6-FEET OR A MAXIMUM CROSS SLOPE OF 1:48 AND A 36" MINIMUM LANDING, THE CONTRACTOR SHALL NOTIFY ENGINEER OR
- 18. THE TESTING AGENCY SHALL BE RESPONSIBLE FOR PROVIDING THE ASPHALT AND CONTRACTOR CERTIFICATION MEMO TO NCDOT FOR ALL ROADWAY IMPROVEMENTS WITHIN THE PUBLIC RIGHT-OF-WAY.

### SIGNAGE, STRIPING, AND MARKING NOTES

OWNER REPRESENTATIVE PRIOR TO INSTALLATION.

- ALL INTERNAL SIGNAGE SHALL BE COORDINATED WITH OWNER FOR ACTUAL LOCATION AT TIME OF INSTALLATION. SIGNAGE LEADING ONTO PUBLIC THOROUGHFARE SHALL BE INSTALLED AT RIGHT OF WAY PER DOT STANDARDS
- 2. ALL PAVEMENT STRIPING (EXCEPT INDIVIDUAL PARKING BAY STRIPING)
  SHALL BE THERMOPLASTIC REFLECTIVE PAINT. MATERIALS AND
  DIMENSIONS SHALL CONFORM TO NCDOT STANDARDS AND
  SPECIFICATIONS. PARKING BAY STRIPING SHALL BE WHITE REFLECTIVE PAINT.
- 3. CROSSWALKS SHALL BE CONSTRUCTED OF THERMOPLASTIC MATERIALS AND CONSTRUCTED IN ACCORDANCE WITH STATE DOT SPECIFICATIONS. CONTRACTOR TO INSTALL CROSSWALKS IN SUCH A MANNER THAT CROSSWALKS ARE ALIGNED BETWEEN HANDICAP/WALKWAY ACCESS POINTS OR PERPENDICULAR TO THE ROADWAY / DRIVE LANE.
- 4. ADA SYMBOLS SHOWN THESE DRAWINGS ARE FOR LOCATION PURPOSES ONLY AND NOT INTENDED TO BE PAINTED. CONTRACTOR RESPONSIBLE FOR INSTALLING ALL REQUIRED ADA SIGNAGE

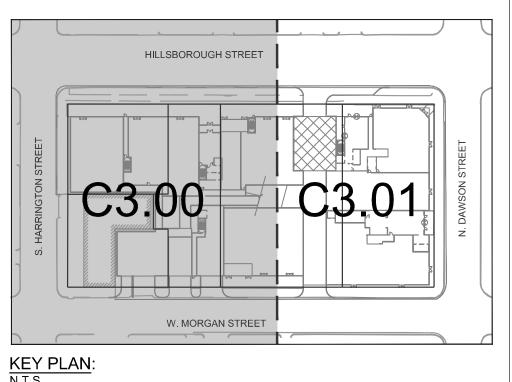




lient:

THE LUNDY GROUP
JON KEENER
4600 LAKE BOONE TRAIL, SUITE 210
RALEIGH, NC 27607
T: 919-821-7890
F: 919-821-2070

Project

## 301 HILLSBOROUGH

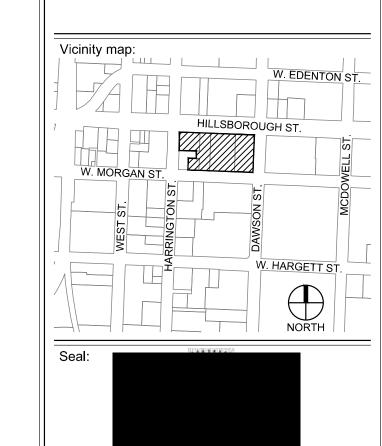

PRELIMINARY - DO NOT USE FOR CONSTRUCTION

ADMINISTRATIVE SITE

No.	Date	Description	
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			_
			_
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			-
			_
1			



SCALE: 1"=20'


Title:

Issued for:

SITE PLAN (WEST)


Project number: C16066 Sheet:
Date: 11.17.2016
Drawn by: NBC / RS

11.17.2016 NBC / RS JWP **C3.0** 

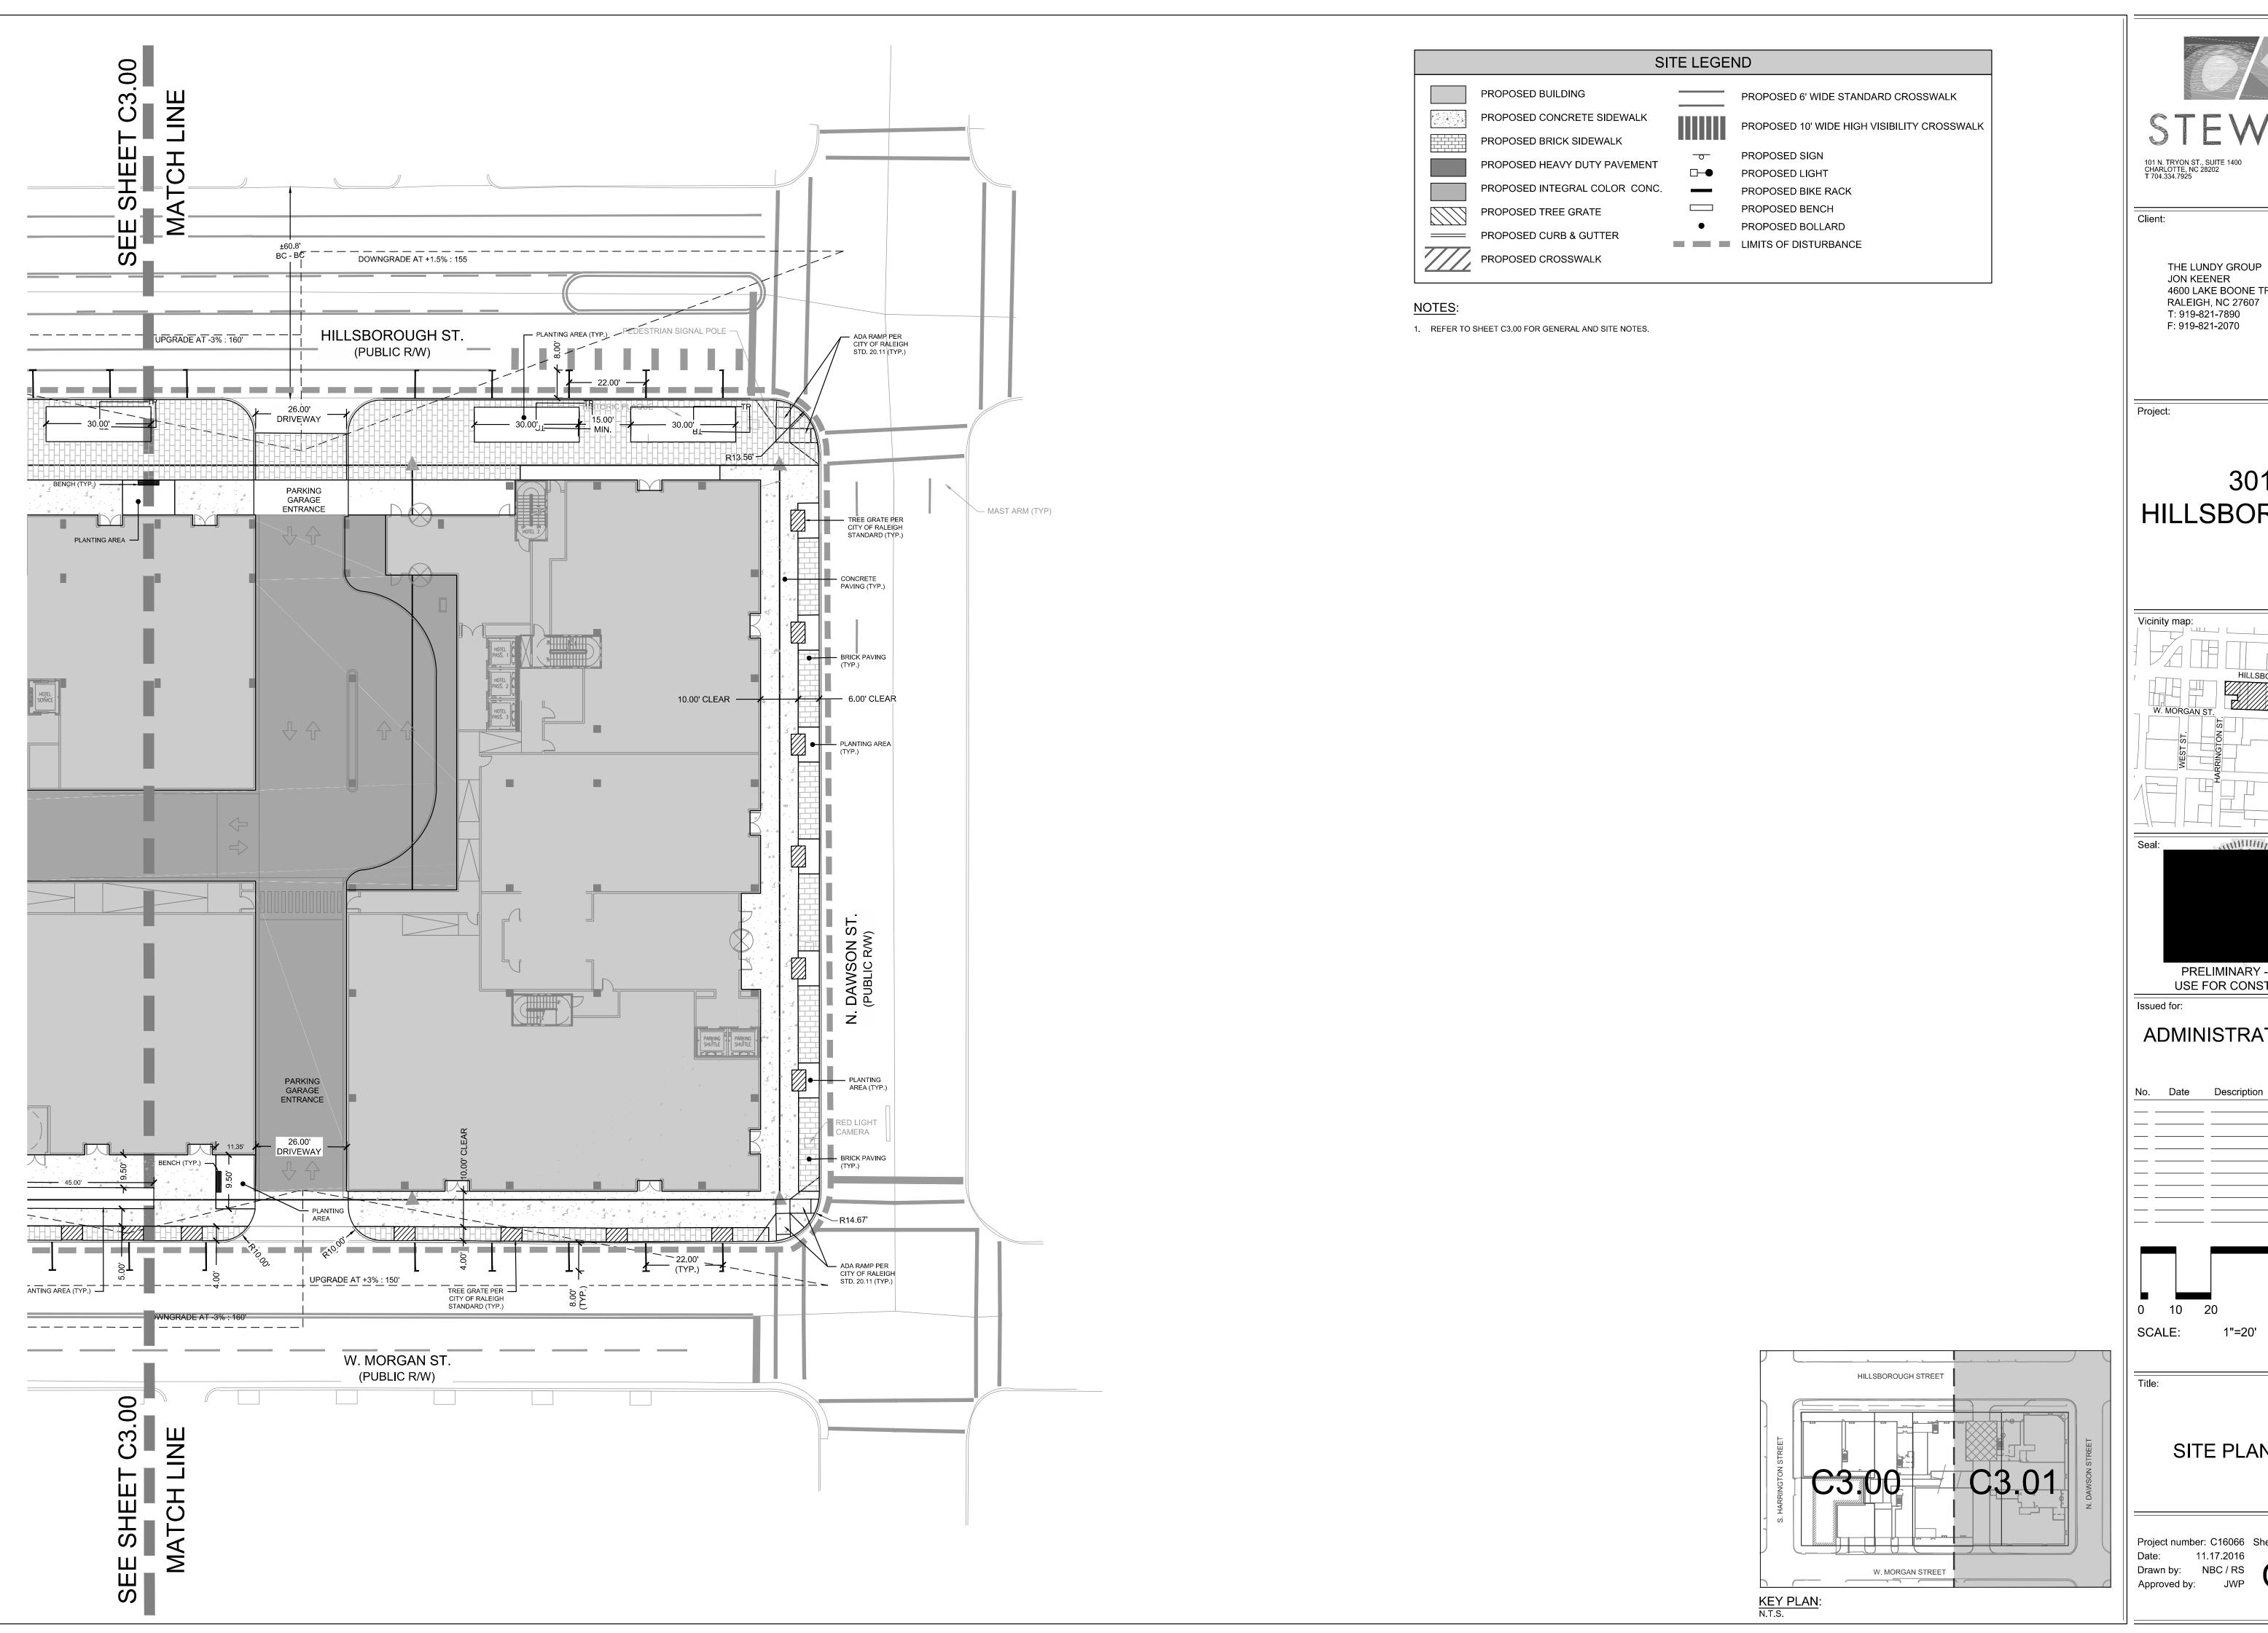

Client: THE LUNDY GROUP JON KEENER 4600 LAKE BOONE TRAIL, SUITE 210 RALEIGH, NC 27607

## 301 HILLSBOROUGH

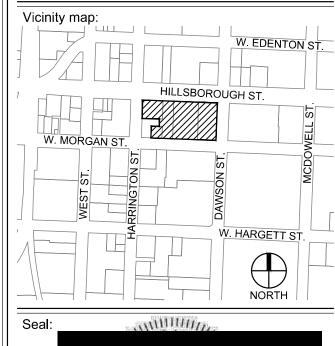



ADMINISTRATIVE SITE



SCALE: 1"=20'


SITE PLAN (EAST)

Project number: C16066 Sheet:

Date: 11.17.2016

Drawn by: NBC / RS
Approved by: JWP

C3.01

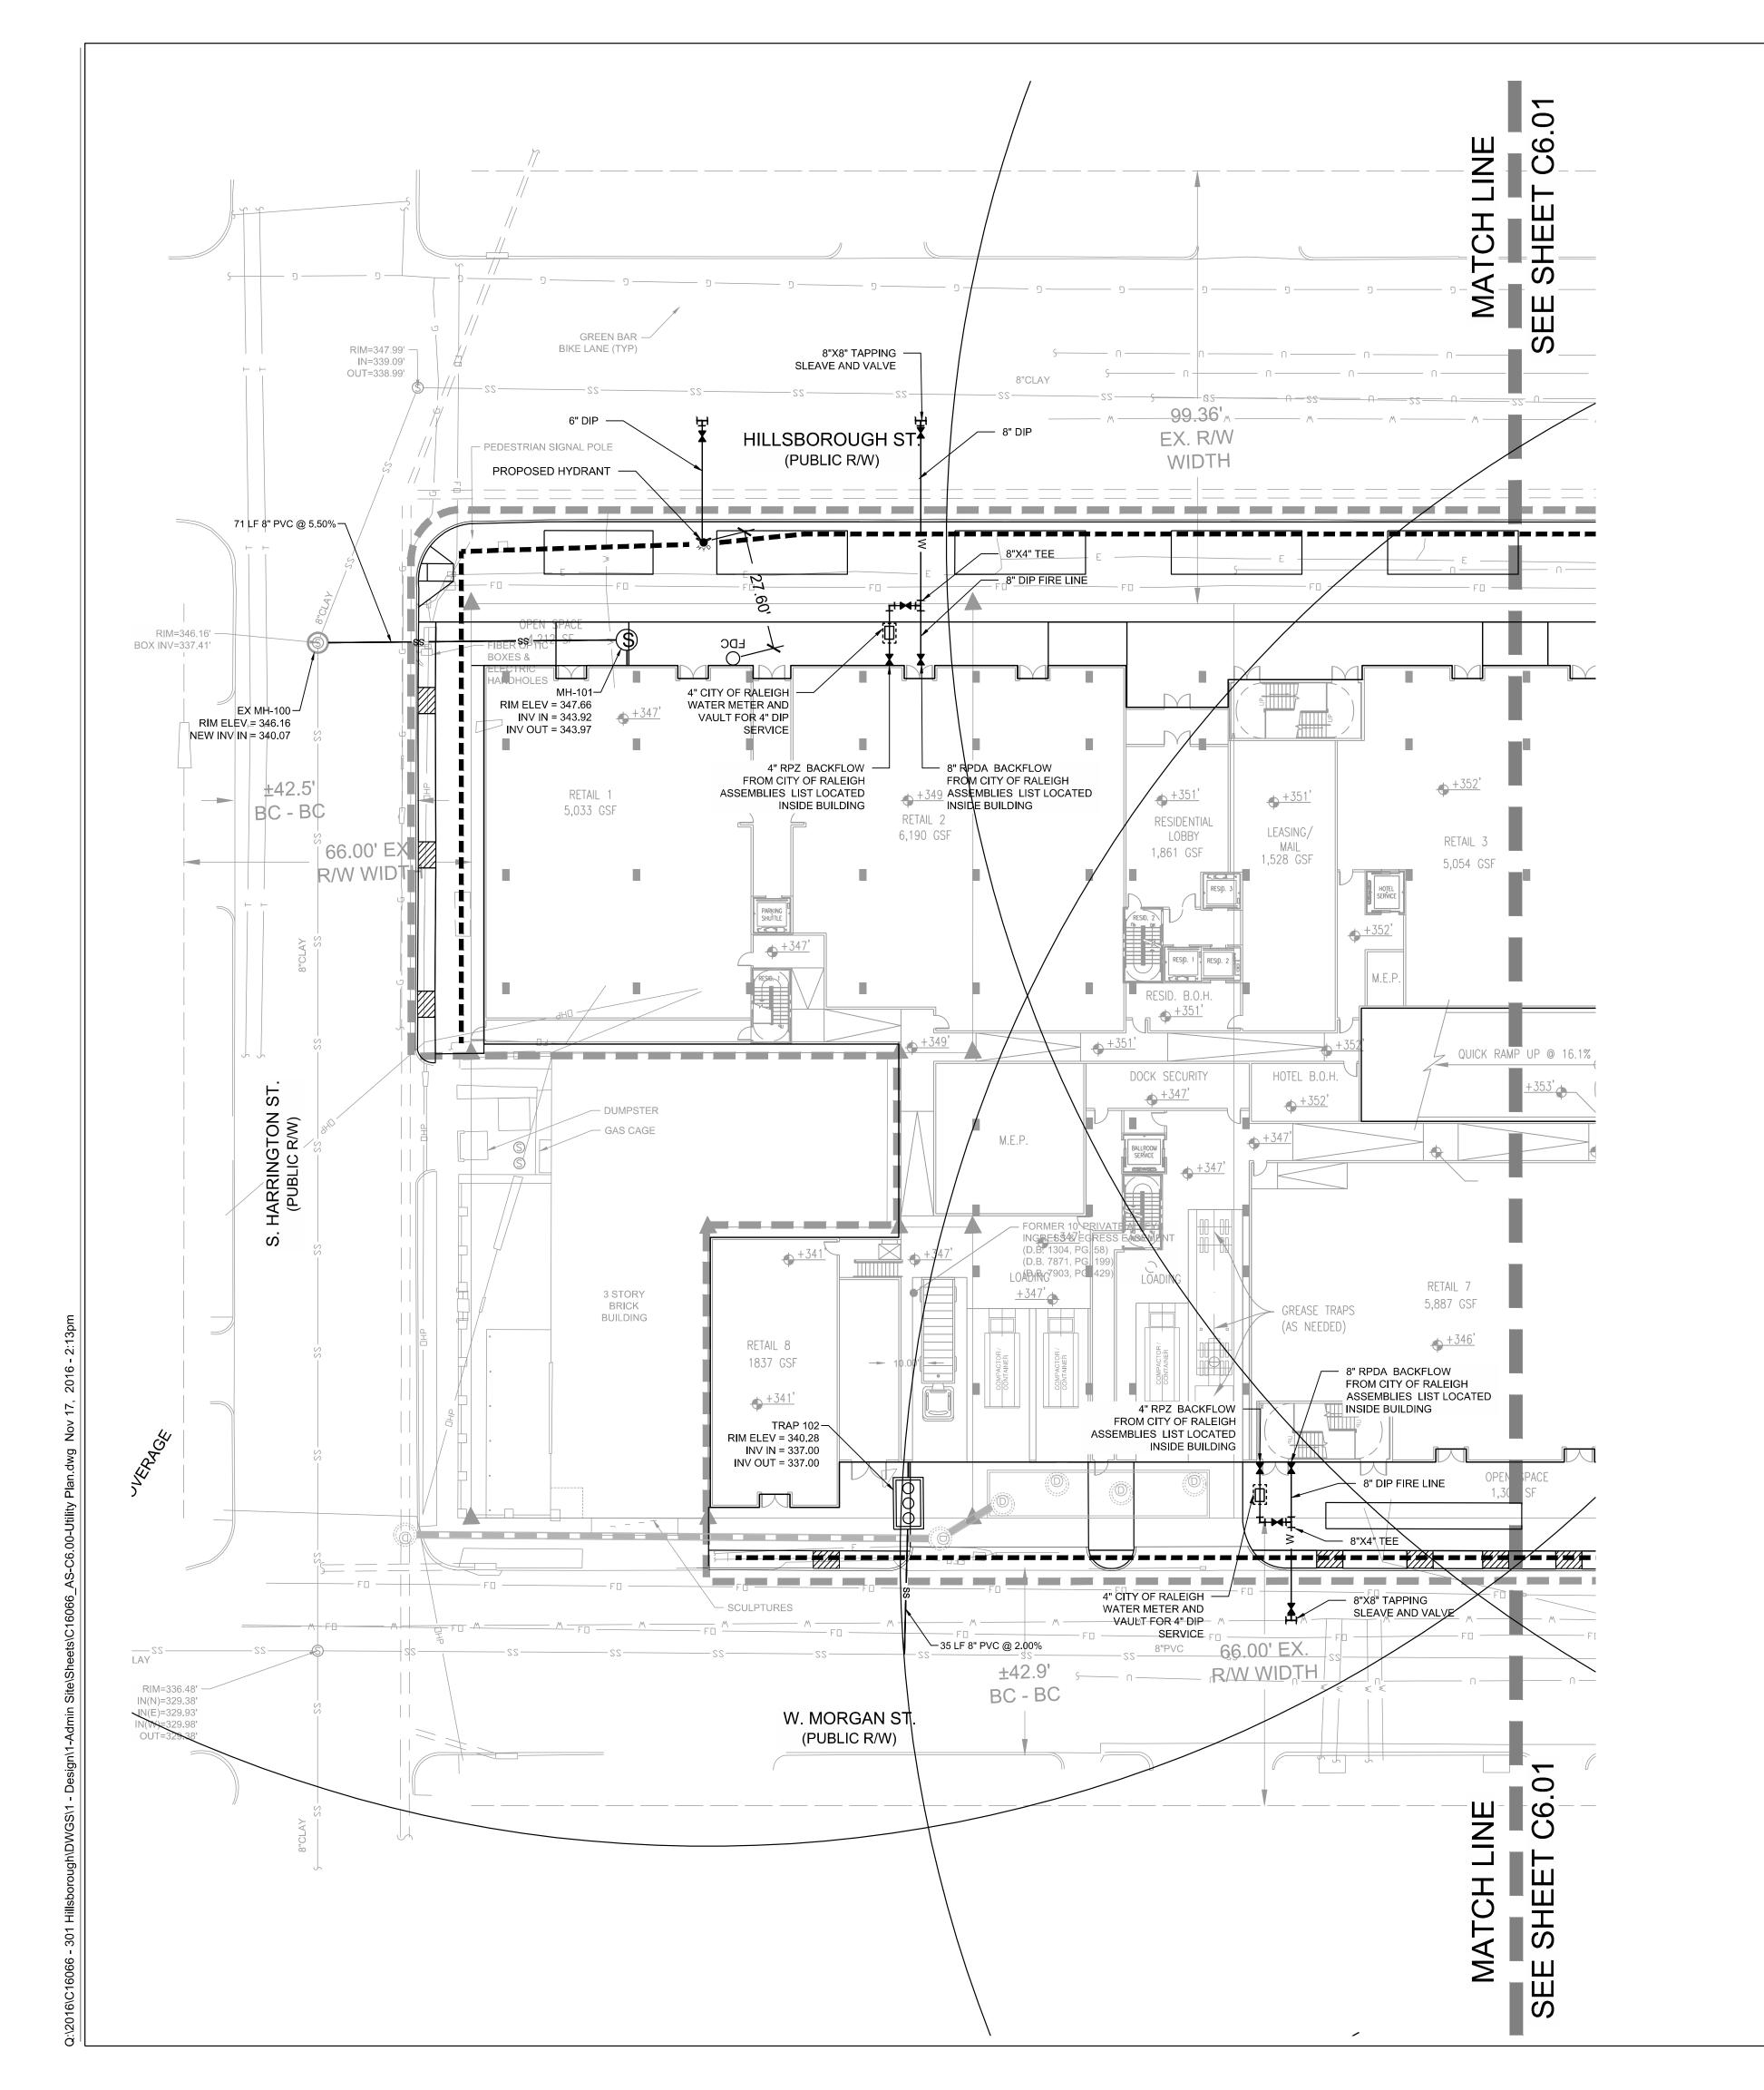

### **UTILITY LEGEND** —— w —— EXISTING WATER LINE —— ss —— PROPOSED SANITARY SEWER LINE PROPOSED FIRE HYDRANT PROPOSED WATER VALVE EXISTING SANITARY SEWER MANHOLE PROPOSED SANITARY SEWER MANHOLE PROPOSED CLEANOUT PROPOSED FDC PROPOSED BACKFLOW METER PROPOSED POST INDICATOR VALVE (PIV) GREASE INTERCEPTOR — — 300' HYDRANT COVERAGE CIRCLE LIMITS OF DISTURBANCE

#### **UTILITY NOTES**

- 1. REFER TO SHEET C3.00 FOR GENERAL AND SITE NOTES.
- 2. UNLESS OTHERWISE NOTED, ALL MANHOLES SHALL BE PRE-CAST CONCRETE STRUCTURES.
- 3. THE CONTRACTOR SHALL COORDINATE THE CONSTRUCTION OF UNDERGROUND UTILITIES (WATER, SEWER, STORM, ELECTRICAL, GAS, OR OTHER) FOR THIS PROJECT WITH THE BUILDING PLANS. THE UTILITY CONTRACTOR SHALL ALSO BE RESPONSIBLE FOR THE INSTALLATION OF ALL UTILITY SERVICES TO WITHIN FIVE (5) FEET OF THE BUILDING CONNECTION POINT.
- 4. THE CONTRACTOR SHALL COORDINATE WITH OTHER CONTRACTORS ON SITE AND UTILITY PROVIDERS DURING CONSTRUCTION TO ENSURE SMOOTH TRANSITION BETWEEN DISCIPLINES.
- 5. THE CONTRACTOR SHALL COORDINATE ALL PEDESTRIAN AND VEHICULAR INTERRUPTIONS WITH OWNER'S REPRESENTATIVE AT LEAST 72 HOURS PRIOR TO BEGINNING WORK.
- 6. THE CONTRACTOR SHALL NOT PROCEED WITH ANY WORK INSIDE THE PUBLIC RIGHT OF WAY PRIOR TO RECEIPT AND COMPLIANCE WITH ALL APPLICABLE NCDOT PERMITS. ADDITIONALLY, THE CONTRACTOR SHALL BE RESPONSIBLE FOR PROVIDING ALL NECESSARY FLAGGERS AND TRAFFIC CONTROL DURING ALL WORK INSIDE THE PUBLIC RIGHTS OF WAY.
- 7. THE CONTRACTOR SHALL NOT RE-USE ANY FIRE HYDRANT REMOVED AS PART OF THIS PROJECT. ANY FIRE HYDRANT SHOWN TO BE REMOVED OR RELOCATED SHALL BE REPLACED WITH A NEW FIRE HYDRANT MEETING THE LOCAL JURISDICTIONAL REQUIREMENTS AND STANDARDS.
- 8. ALL EXISTING SUB-SURFACE UTILITIES IDENTIFIED ON THE CONSTRUCTION DOCUMENTS ARE SHOWN IN THEIR APPROXIMATE LOCATION BASED ON SURVEY INFORMATION GATHERED FROM FIELD INSPECTION AND/OR ANY OTHER APPLICABLE RECORD DRAWINGS WHICH MAY BE AVAILABLE. DEPTHS OF EXISTING UTILITIES SHOWN IN PROFILE VIEWS ARE BASED ON STANDARD ASSUMPTIONS. THE CONTRACTOR SHALL FIELD VERIFY THE EXACT LOCATION, DEPTH, SIZE AND MATERIAL OF ANY AND ALL SUB-SURFACE CONDITIONS REFERENCED IN THESE PLANS PRIOR TO ANY EXCAVATION OR CONSTRUCTION ACTIVITY. THE CONTRACTOR SHALL IMMEDIATELY NOTIFY THE OWNER'S REPRESENTATIVE OF ANY DISCREPANCIES OR CONFLICTS.
- 9. ELEVATIONS OF UTILITIES ARE GIVEN TO THE EXTENT OF INFORMATION AVAILABLE, WHERE ELEVATIONS ARE NOT GIVEN AT POINTS OF EXISTING UTILITY CROSSINGS, SUCH ELEVATIONS SHALL BE DETERMINED BY THE CONTRACTOR AND REPORTED TO THE ENGINEER, WHEN UNKNOWN LINES ARE EXPOSED, THEIR LOCATIONS AND ELEVATIONS SHALL ALSO BE REPORTED TO THE ENGINEER.
- 10. UNDERGROUND UTILITIES SHOWN ON THIS PLAN SHALL BE INSTALLED PRIOR TO ANY CONSTRUCTION OF PARKING AREA, DRIVES, CURB AND GUTTER OR CONCRETE WALKS / PADS. IF UTILITIES SHOWN ON THIS PLAN CANNOT BE INSTALLED PRIOR TO INSTALLATION OF IMPERVIOUS (ASPHALT / CONCRETE) CONDUIT SHALL BE INSTALLED FOR THE "FUTURE" UTILITY INSTALLATION.
- 11. AS-BUILT DOCUMENTATION REQUIREMENTS: PRIOR TO APPROVAL FROM LOCAL JURISDICTION OR ENGINEER THE CONTRACTOR SHALL PROVIDE AS-BUILT DRAWINGS (IN BOTH PAPER AND ELECTRONIC FORMAT (CAD / PDF) PREPARED AND SEALED BY A PROFESSIONAL LAND SURVEYOR SHOWING ALL UTILITY INSTALLATION. HORIZONTAL AND VERTICAL INFORMATION SHALL BE PROVIDED FOR WATER, SEWER, STORM INCLUDING ALL STRUCTURES, VALVES, HYDRANTS, AND OTHER APPURTENANCES.

#### PROPOSED UTILITY SEPARATION:

- 1. WATER MAINS SHALL BE LAID AT LEAST 10 FEET HORIZONTALLY FROM EXISTING OR PROPOSED SEWERS, UNLESS LOCAL CONDITIONS OR BARRIERS PREVENT A 10-FOOT HORIZONTAL SEPARATION IN WHICH CASE;
  - a. THE WATER MAIN IS LAID IN A SEPARATE TRENCH, WITH THE ELEVATION OF THE BOTTOM OF THE WATER MAIN AT LEAST 18 INCHES ABOVE THE TOP OF THE SEWER; OR
- b. THE WATER MAIN IS LAID IN THE SAME TRENCH AS THE SEWER WITH THE WATER MAIN LOCATED AT ONE SIDE OF A BENCH OF UNDISTURBED EARTH, AND WITH THE ELEVATION OF THE BOTTOM OF THE WATER MAIN AT LEAST 18 INCHES ABOVE THE TOP TO THE SEWER.
- 2. CROSSING A WATER MAIN OVER A SEWER. WHENEVER IT IS NECESSARY FOR A WATER MAIN TO CROSS OVER A SEWER, THE WATER MAIN SHALL BE LAID AT SUCH AN ELEVATION THAT THE BOTTOM OF THE WATER MAIN IS AT LEAST 18 INCHES ABOVE THE TOP OF THE SEWER, UNLESS LOCAL CONDITIONS OR BARRIERS PREVENT AN 18 INCH VERTICAL SEPARATION, IN WHICH CASE BOTH THE WATER MAIN AND SEWER SHALL BE CONSTRUCTED OF FERROUS MATERIALS AND WITH JOINTS THAT ARE EQUIVALENT TO WATER MAIN STANDARDS FOR A DISTANCE OF 10 FEET ON EACH SIDE OF THE POINT OF CROSSING.
- CROSSING A WATER MAIN UNDER A SEWER. WHENEVER IT IS NECESSARY FOR A WATER MAIN TO CROSS UNDER A SEWER, BOTH THE WATER MAIN AND THE SEWER SHALL BE CONSTRUCTED OF FERROUS MATERIALS AND WITH JOINTS EQUIVALENT TO WATER MAIN STANDARDS FOR A DISTANCE OF 10 FEET ON EACH SIDE OF THE POINT OF CROSSING. A SECTION OF WATER MAIN PIPE SHALL BE CENTERED AT THE POINT OF CROSSING.

### SEPARATION OF SANITARY SEWERS AND STORM SEWERS:


1. A 24" VERTICAL SEPARATION SHALL BE PROVIDED BETWEEN STORM SEWER AND SANITARY SEWER LINES OR BOTH THE SANITARY AND THE STORM LINES SHALL BE CONSTRUCTED OF FERROUS MATERIALS.

### **SEWER NOTES:**

- 1. SANITARY SEWER CLEANOUTS LOCATED IN PAVEMENT AREAS SHALL BE HEAVY DUTY TRAFFIC BEARING CASTINGS
- 2. UNLESS OTHERWISE NOTED, ALL SANITARY SEWER MANHOLES ARE 4' DIA.
- 3. MANHOLES LOCATED IN PAVEMENT, CONCRETE OR OTHER TRAFFIC AREAS SHALL BE SET AT GRADE. MANHOLES LOCATED IN OTHER AREAS (I.E. GRASS OR WOODED AREAS) SHALL HAVE THEIR RIMS RAISED SIX INCHES ABOVE THE SURROUNDING GRADE. MANHOLES SUBJECT TO POSSIBLE WATER INFILTRATION SHALL HAVE WATERTIGHT, BOLTED LIDS.
- 4. MINIMUM REQUIRED SLOPES FOR SEWER SERVICES:
- 4" SEWER SERVICE 2.00% SLOPE 6" SEWER SERVICE - 1.00% SLOPE
- 8" SEWER SERVICE 0.50% SLOPE
- 5. UNLESS OTHERWISE NOTED, LOCATE SANITARY SERVICE CLEANOUTS AT ALL HORIZONTAL OR VERTICAL CHANGES IN DIRECTION. MAXIMUM SPACING BETWEEN CLEANOUTS SHALL BE 75 FEET.
- 6. SEWER LINES LESS THAN 3 FEET OF COVER SHALL BE CLASS 50 DUCTILE IRON PIPE. SEWER LINES WITH GREATER THAN 3 FEET OF COVER SHALL BE AS NOTED
  - 4" SEWER SERVICE SCH 80
  - 6" SEWER SERVICE SCH 80 8" SEWER SERVICE - SDR-35
- 7. SEWER LINES UNDER CONSTRUCTION SHALL BE PROTECTED FROM DIRT, DEBRIS OR OTHER CONTAMINANTS ENTERING THE NEW SYSTEM. A MECHANICAL PLUG SHALL BE UTILIZED BOTH IMMEDIATELY UPSTREAM OF THE NEW CONSTRUCTION AND AT THE FIRST MANHOLE DOWNSTREAM IN THE EXISTING SYSTEM. EXISTING STRUCTURES, PIPING AND APPURTENANCES SHALL BE PROTECTED FROM ANY INFLOW OF WATER, DIRT OR DEBRIS DUE TO NEW CONSTRUCTION CONNECTING TO OR IN THE VICINITY OF THE EXISTING SYSTEM. CONTRACTOR TO REMOVE DEBRIS AND PLUG PRIOR TO OCCUPANCY.
- 8. ALL MANHOLES COVERS SHALL BE PAINTED TO LOCAL JURISDICTIONAL REQUIREMENTS.

### **WATER NOTES:**


- 1. AS INDICATED, ALL WATERLINES SHALL BE DUCTILE IRON PIPE MEETING THE REQUIREMENTS OF ANSI-AWWA C151 PRESSURE CLASS 350 OR SOFT COPPER TYPE K
  PIPE PER ASTM B88. IF PVC WATERLINE IS INDICATED ON THE PLANS IT SHALL MEET THE REQUIREMENTS OF AWWA C-900; CLASS 200.
- 2. ALL WATERLINES SHALL HAVE A MINIMUM OF 3.5 FEET OF COVER.
- TESTING NOTES:
  - PRESSURE:
    LEAKAGE SHALL NOT EXCEED THE MAXIMUM ALLOWABLE LEAKAGE SPECIFIED IN AWWA C 600. MINIMUM TEST PRESSURE SHALL BE 150 PSI FOR DOMESTIC AND 200 PSI FOR FIRE PROTECTION
  - BACTERIOLOGICAL:
    TWO SAMPLES FOR BACTERIOLOGICAL SAMPLING SHALL BE COLLECTED AT LEAST 24 HOURS APART. IF CONTAMINATION IS INDICATED. THEN THE DISINFECTION PROCEDURE AND TESTING SHALL BE REPEATED UNTIL SATISFACTORY RESULTS ARE
- 4. THE CHLORINE IN HEAVILY CHLORINATED WATER FLUSHED FROM MAINS NEEDS TO BE NEUTRALIZED BEFORE DISCHARGE. CONTRACTORS SHALL NEUTRALIZE HEAVILY CHLORINATED WATER FLUSHED FROM MAINS PRIOR TO DISCHARGE OR TRANSPORT ALL HEAVILY CHLORINATED WATER OFFSITE FOR PROPER DISPOSAL.
- 5. PAINT VALVE COVERS, FIRE HYDRANTS AND OTHER WATER APPARATUS TO MEET THE LOCAL JURISDICTIONAL REQUIREMENTS.

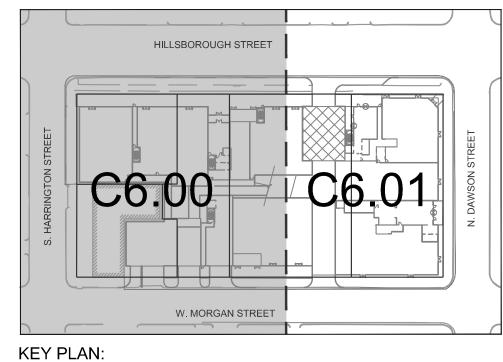

THE LUNDY GROUP JON KEENER 4600 LAKE BOONE TRAIL, SUITE 210 RALEIGH, NC 27607 T: 919-821-7890 F: 919-821-2070

Vicinity map:

# HILLSBOROUGH

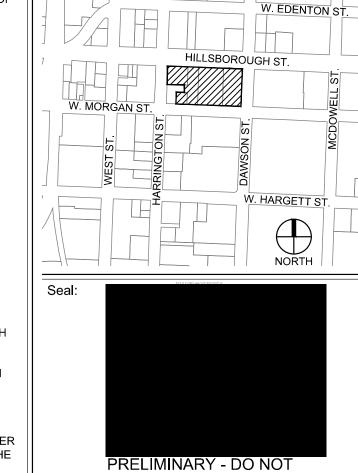


ADMINISTRATIVE SITE

USE FOR CONSTRUCTION

No. Date Description

Issued for:

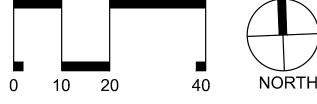



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UTILITY PLAN (WEST)

Project number: C16066 Sheet:

Drawn by:




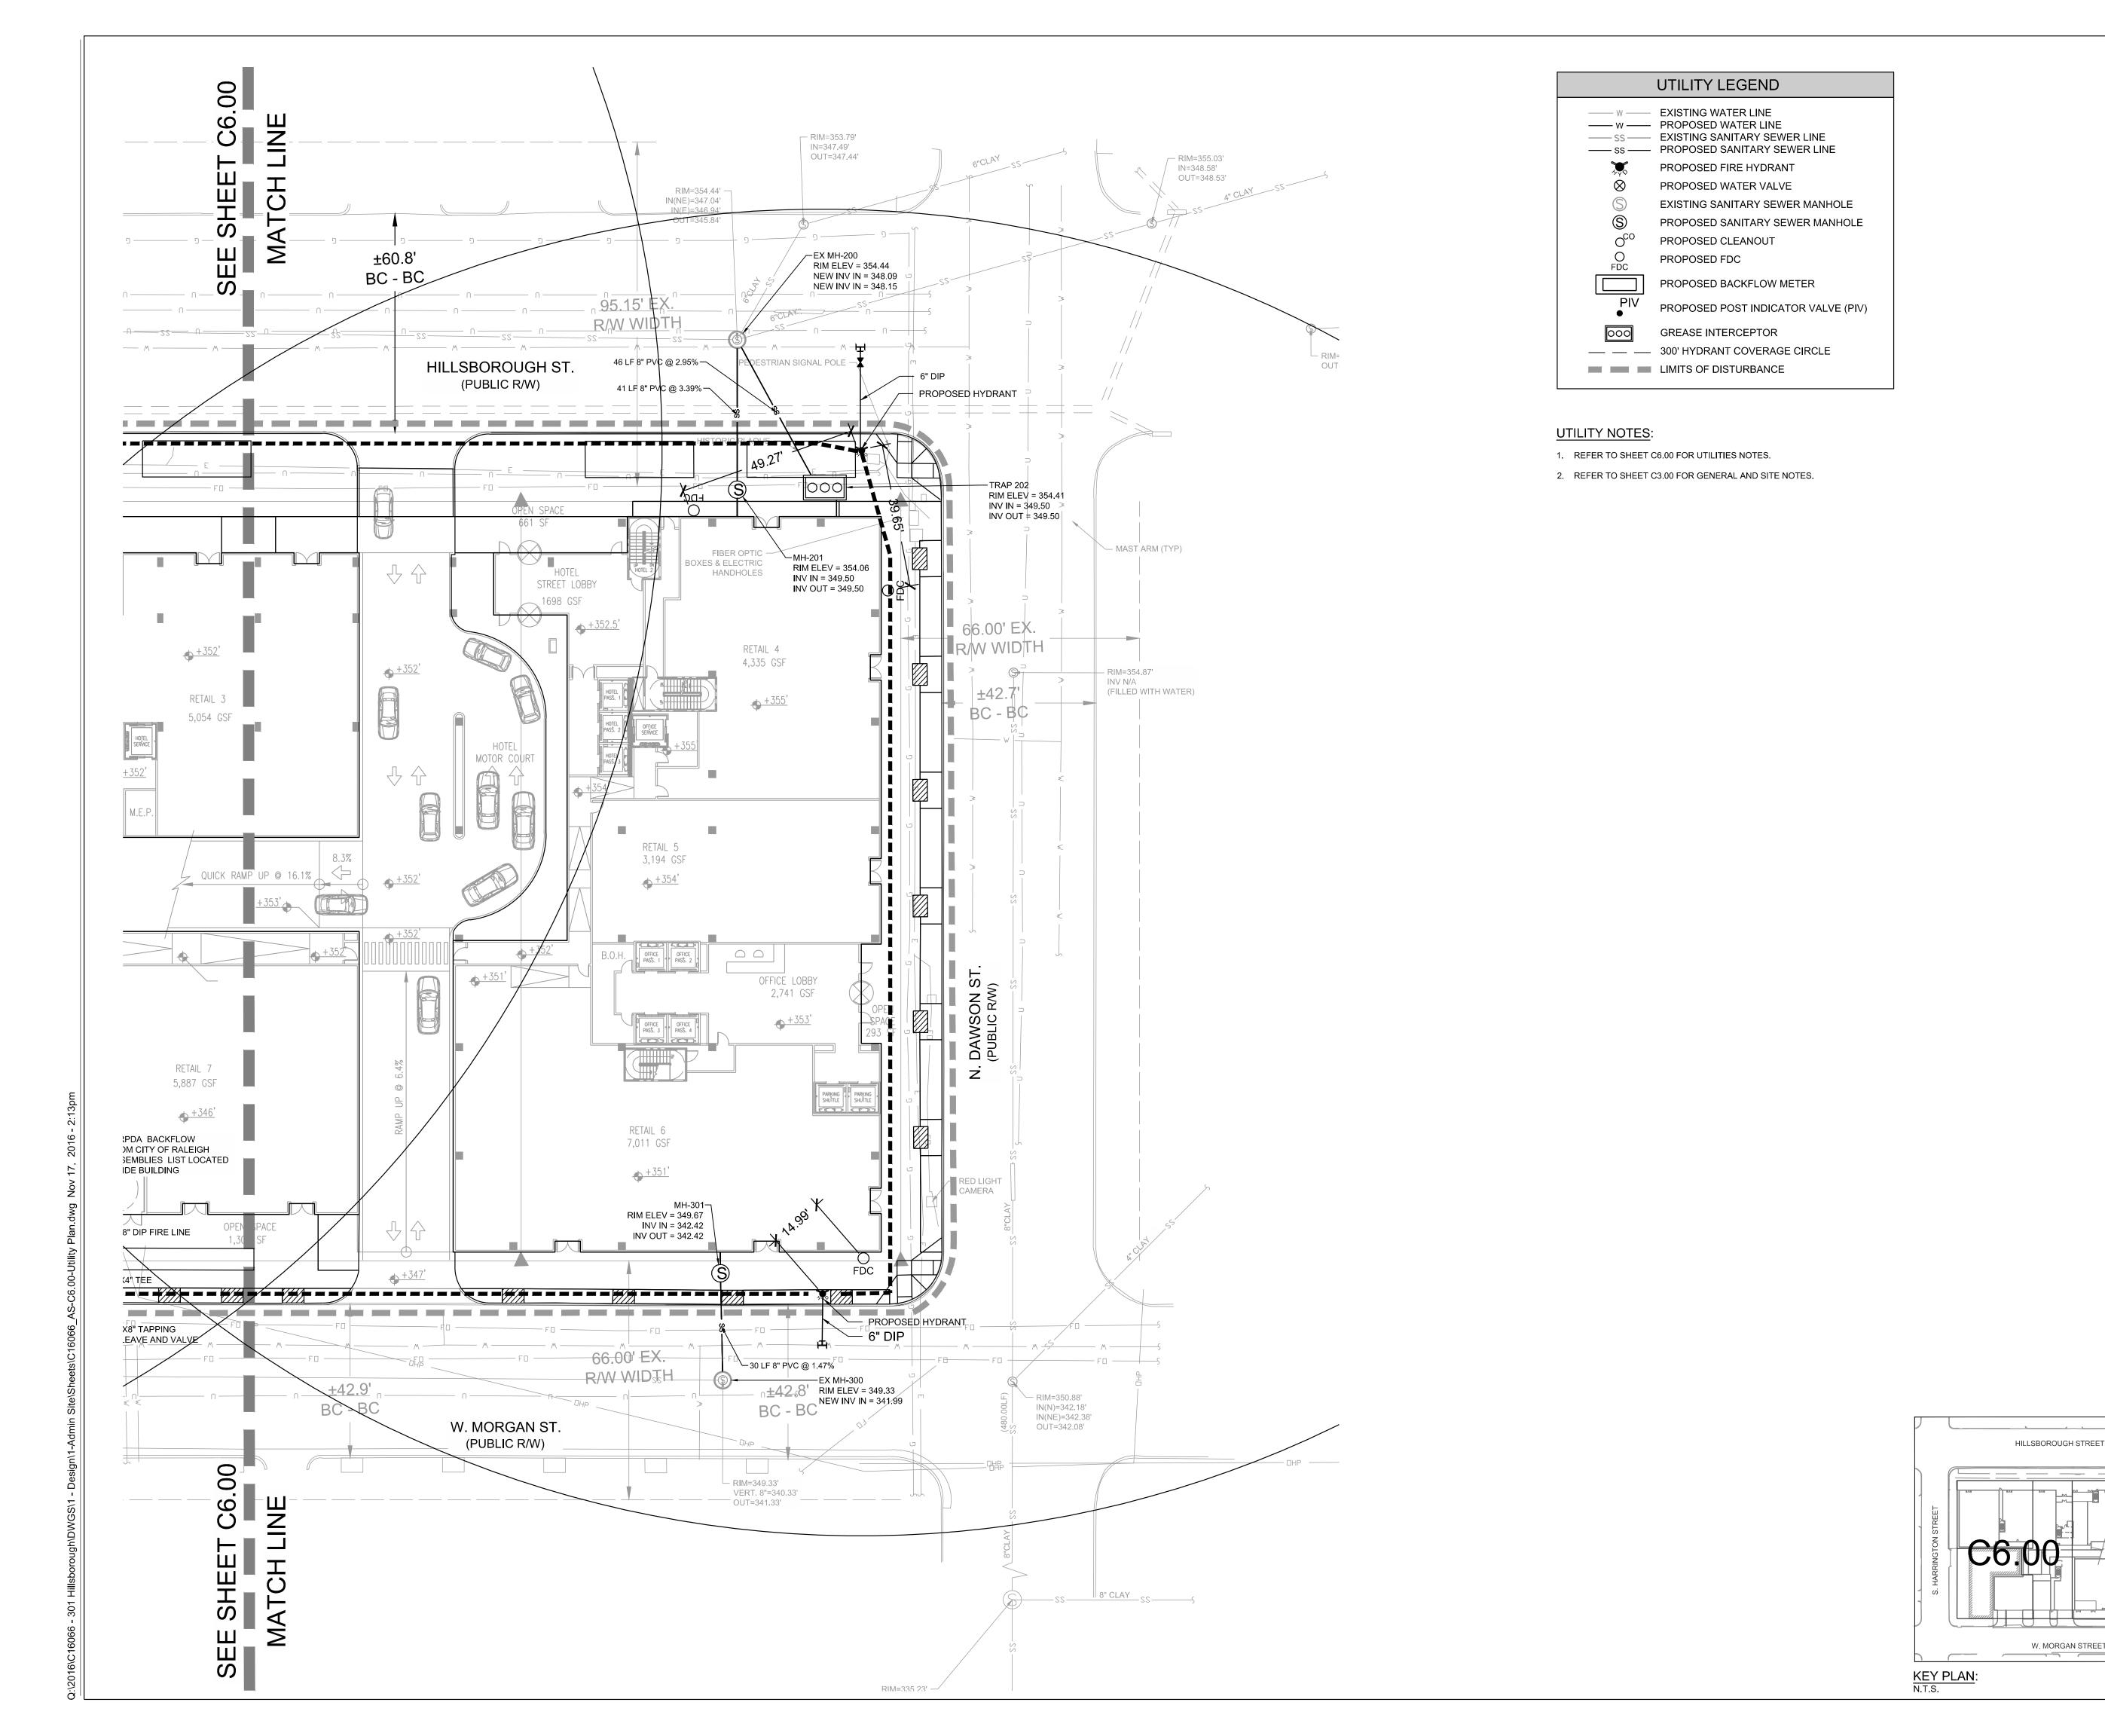

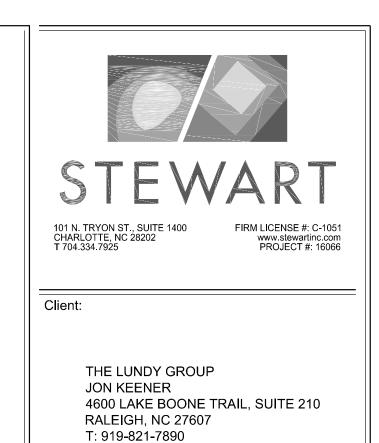
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### 301 HILLSBOROUGH



No. Date Description

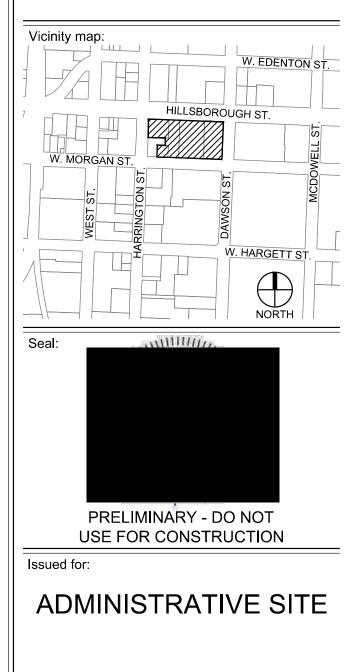

SCALE: 1"=20'

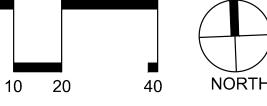Title:

C6.01

UTILITY PLAN (EAST)

Project number: C16066 Sheet:

Date: 11.17.2016

Drawn by: LAP

LAP C6.0