

SR-106-16 /Duraleigh Road Storage Transaction# 498892 AA#3879 City of Raleigh
Development Services Department
One Exchange Plaza
Raleigh, NC 27602
(919) 996-2495
DS.help@raleighnc.gov
www.raleighnc.gov

**LOCATION:** This site is located on the west side of Duraleigh Road, south of Glenwood

Avenue at 6101 Duraleigh Road.

**REQUEST:** Development of a 2.76-acre tract zoned CX-3-PL into a 124,740 square foot 3-

story self storage building.

DESIGN

ADJUSTMENT(S)/

ALTERNATES, ETC: N/A

FINDINGS: City Administration finds that this request, with the below conditions of approval

being met, conforms to the Unified Development Ordinance. This approval is based on a preliminary plan dated 10/10/2018 by *Piedmont Land Design, LLP*.

# **CONDITIONS OF APPROVAL and NEXT STEPS:**

This document must be applied to the second sheet of all future submittals except for final plats. This is a preliminary plan and as such no permits have been issued with this approval. To obtain permits and/or completion of the project, the following steps are required:

□ CONCURRENT SITE REVIEW NOT REQUIRED AT THIS TIME – However, plan revisions or further development that includes land disturbance of 12,000 square feet or greater, public or private infrastructure, shared stormwater devices, etc. will require concurrent site review.

☑ <u>CONCURRENT SITE REVIEW</u> - For land disturbance of 12,000 square feet or greater, public or private infrastructure, shared stormwater devices, etc. Concurrent Site Review may be submitted upon receipt of this signed approval document.

The following items are required prior to approval of Concurrent Site Review plans:

# **Engineering**

- 1. Required NCDOT encroachment and/or driveway permits must be approved and copies provided to Development Services Development Engineering prior to concurrent review approval.
- 2. A right-of-way obstruction permit must be obtained from Right-of-way Services prior to the commencement of any construction activities within the right-of-way.

# Stormwater

- 3. A stormwater control plan with a stormwater operations and maintenance manual and budget shall be approved (UDO 9.2).
- 4. A surety equal to of the cost of clearing, grubbing and reseeding a site, shall be paid to the City (UDO 9.4.4).
- 5. That a nitrogen offset payment must be made to a qualifying mitigation bank;



SR-106-16 /Duraleigh Road Storage Transaction# 498892 AA#3879 City of Raleigh
Development Services Department
One Exchange Plaza
Raleigh, NC 27602
(919) 996-2495
DS.help@raleighnc.gov
www.raleighnc.gov

# **Urban Forestry**

- 6. Show all existing tree conservation areas with reference to Book of Maps and page number where recorded and show tree protection fencing.
- 7. Tree protection fence must be inspected by Urban Forestry staff prior to the issuance of a grading permit.

approved, executed, and recorded prior to or in conjunction with the recorded plat on which the
associated easements are shown. Copies of recorded documents must be returned to the City within one
business day of recording to avoid withholding of further permit issuance.

	City Code Covenant		Slope Easement
	Stormwater Maintenance		Transit Easement
	Covenant		
$\boxtimes$	Utility Placement Easement	$\boxtimes$	Cross Access Easement
	Sidewalk Easement		Public Access Easement
			Other:

⊠ <u>RECORDED MAP(S)</u> - Submit plat to record new property lines, easements, tree conservation areas, etc.). Plats may be submitted for review when the Concurrent Site Review plans, if required, have been deemed ready for mylar signature.

The following items must be approved prior to recording the plat:

# General

1. A Type C2 Street Protective Yard is required for this project and a note shall be placed on the final plat stating this requirement (only use for subdivisions).

# **Engineering**

- 2. The required right of way for proposed and/or existing streets shall be dedicated to the City of Raleigh and shown on the map approved for recordation.
- 3. A 5' general utility easement and associated deed of easement shall be approved by the City and the location of the easement shall be shown on the map approved for recordation. The deed of easement shall be recorded at Wake County Register of Deeds within one day of recordation of the recorded plat. A recorded copy of these documents must be provided to the Development Services Department within one day from authorization of lot recordation. If recorded copies of the documents are not provided, further recordings and building permit issuance will be withheld.



SR-106-16 /Duraleigh Road Storage Transaction# 498892 AA#3879 City of Raleigh Development Services Department One Exchange Plaza Raleigh, NC 27602 (919) 996-2495 DS.help@raleighnc.gov www.raleighnc.gov

4. A cross access agreement shall be approved by the Development Services Department for recording in the Wake County Registry, and a copy of the recorded cross access easement shall be returned to the Development Services Department within one day of plat recordation. If a recorded copy of the document is not provided within this time, further recordings and building permit issuance will be withheld.

### Stormwater

5. All stormwater control measures and means of transporting stormwater runoff to and from any nitrogen and stormwater runoff control measures shall be shown on all plats for recording as private drainage easements (UDO 9.2).

# **Urban Forestry**

6. Show all existing tree conservation areas with reference to Book of Maps and page number where previously recorded.

⊠BUILDING PERMITS – For buildings and structures shown on the approved plans. Commercial building permit plans must include the signed, approved Concurrent Site Review plans attached, if applicable. Permit sets may be reviewed prior to the recordation of required plats, but cannot be approved.

# The following items must be approved prior to the issuance of building permits:

1. A Type C2 Street Protective Yard is required for this project and a note shall be placed on the final plat stating this requirement.

# **Engineering**

- 2. The required right of way for proposed and/or existing streets shall be dedicated to the City of Raleigh and is shown on a plat approved for recordation.
- 3. A 5' general utility easement and associated deed of easement shall be approved by the City and the location of the easement shall be shown on the map approved for recordation. The deed of easement shall be recorded at Wake County Register of Deeds within one day of recordation of the recorded plat. A recorded copy of this document must be provided to the Development Services Department within one day from authorization of lot recordation. If a recorded copy of the document is not provided within this time, further recordings and building permit issuance will be withheld.
- 4. A fee-in-lieu for pavement and 6' sidewalk on Barrowood Dr shall be paid to the City of Raleigh (UDO 8.1.10).
- 5. A public infrastructure surety shall be provided to the City of Raleigh Development Services Development Engineering (UDO 8.1.3).



SR-106-16 /Duraleigh Road Storage Transaction# 498892 AA#3879 City of Raleigh
Development Services Department
One Exchange Plaza
Raleigh, NC 27602
(919) 996-2495
DS.help@raleighnc.gov
www.raleighnc.gov

- 6. Required NCDOT encroachment and/or driveway permits must be approved and copies provided to Development Services Development Engineering.
- 7. A cross access agreement shall be approved by the Development Services Department for recording in the Wake County Registry, and a copy of the recorded cross access easement shall be returned to the Development Services Department within one day of plat recordation. If a recorded copy of the document is not provided, further recordings and building permit issuance will be withheld.
- 8. A right-of-way obstruction permit shall be obtained from Right-of-way Services for any construction activity within the right-of-way.

### **Public Utilities**

9. An Easement Plat must be recorded at the Wake County Register of Deeds office

### Stormwater

10. A payment equal to twenty-four percent (24%) of the estimated cost of constructing all stormwater control facilities shown on the development plans shall be paid by the developer to the City stormwater facility replacement fund (UDO 9.2.2.G.3).

# **Urban Forestry**

11. Show on the recorded plat all existing tree conservation areas with reference to Book of Maps and page number where previously recorded (UDO 9.1).

# The following are required prior to issuance of building occupancy permit:

- 1. All Water & Sanitary Sewer facilities shall be installed, inspected, tested and accepted by the City of Raleigh Public Utilities Department for operations and maintenance.
- 2. Required public right-of-way infrastructure improvements shall be, at a minimum, sufficiently completed to provide the necessary, safe emergency and vehicular access.
- 3. Copies of certified inspection reports for alleys and internal access ways are submitted to the City of Raleigh Development Services Development Engineering program.
- 4. As-built drawings and associated forms for all Stormwater devices are accepted by the Engineering Services Department (UDO 9.2.2.D.3).
- 5. Final inspection of all tree conservation areas by Urban Forestry Staff.



SR-106-16 /Duraleigh Road Storage Transaction# 498892 AA#3879

City of Raleigh Development Services Department One Exchange Plaza Raleigh, NC 27602 (919) 996-2495 DS.help@raleighnc.gov www.raleighnc.gov

EXPIRATION DATES: The expiration provisions of UDO Section 10.2.8 E, including the ability to request extensions in the expiration date, apply to this site plan. If significant construction has not taken place on a project after administrative site review approval, that approval may expire and be declared void, requiring reapproval before permits may be issued. To avoid allowing this plan approval to expire the following must take place by the following dates:

3-Year Expiration Date: 10-17-2021

Obtain a valid building permit for the total area of the project, or a phase of the project.

4-Year Completion Date:

Within four years after issuance of the first building permit for the site plan, the construction of the entire site plan must be completed unless an applicant has been granted vested rights. Failure to complete construction within this specified time frame shall automatically void the approved site plan for which no building permits have been issued.


I hereby certify this administrative decision.		
Signed:(Planning Dir./Designee)	Date:	10/11/18
Staff Coordinator: Jermont Purifov	-	

# ADMINISTRATIVE SITE REVIEW SUBMITTAL FOR:

# DURALEIGH ROAD STORAGE

SR-106-16

# 6101 DURALEIGH ROAD RALEIGH, NORTH CAROLINA WAKE COUNTY

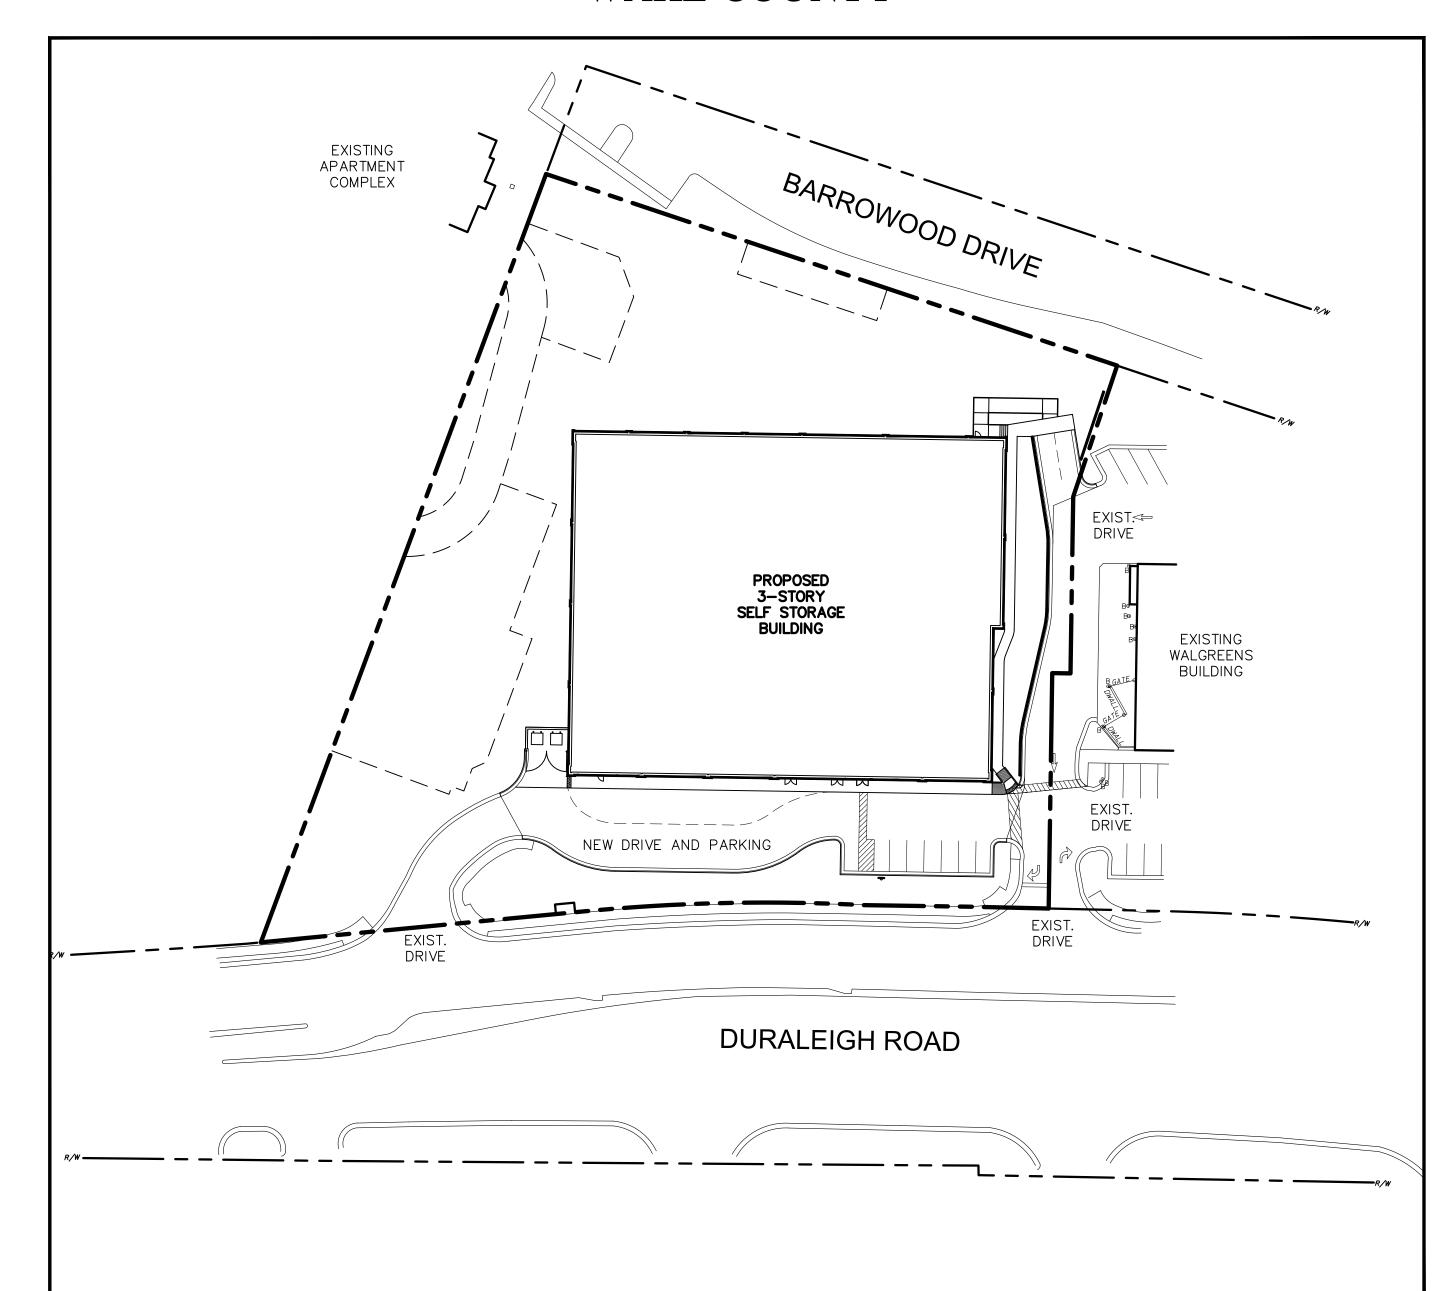

# **SOLID WASTE COMPLIANCE STATEMENT:**

TWO NEW DUMPSTERS WITH HEAVY DUTY CONCRETE PAD AND A 6' HIGH ENCLOSURE WITH LOCKABLE GATES WILL BE PROVIDED BESIDE THE BUILDING AS SHOWN ON THE SITE PLAN. THE OWNER WILL USE A PRIVATE HAULER.

# **BUILDING HEIGHT CALCULATIONS:**

AVG EXISTING GROUND ELEVATION-BARROWOOD = (408.5+404.0)/2 = 406.25AVG PROPOSED GROUND ELEVATION-BARROWOOD= (411+408.7)/2 = 409.85AVERAGE EXISTING GROUND ON BARROWOOD CONTROLS

# (ALONG NORTHERN PROPERTY LINE PER DEED AND CENTERED ON UNDERGROUND LINES)

**REFERENCES:** 

1. B.M. 2006, PG. 2433

2. D.B. 9565, PG. 2074

3. D.B. 12847, PG. 2737

D.B. 12847, PG. 2737

D.B. 12953, PG. 1298

AND EASEMENT CORRIDOR

4. DECLARATION OF EASEMENTS, COVENANTS,

ACCESS AND UTILITY BLANKET EASEMENT


CONDITIONS AND RESTRICTIONS

5. PROGRESS ENERGY CONSTRUCTION

# **SHEET INDEX:**

EXISTING CONDITIONS AND DEMOLITION PLAN PROPOSED STAKING PLAN PROPOSED GRADING PLAN

PROPOSED UTILITY PLAN PROPOSED LANDSCAPE PLAN PROPOSED BUILDING ELEVATIONS

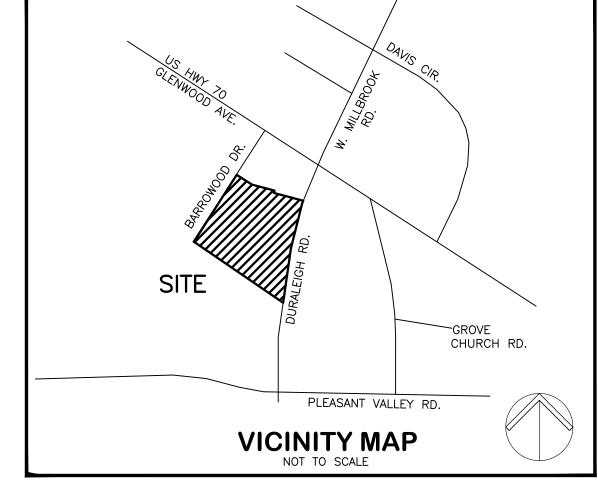

# CITY OF RALEIGH SITE PLAN INFORMATION

BASIS OF DETERMINATION:

DURALEIGH ROAD STORAGE DEVELOPMENT NAME 6101 DURALEIGH ROAD 2. STREET ADDRESS: RALEIGH, NORTH CAROLINA 0786.06-48-9672 WAKE COUNTY P.I.N.: 2.76 AC.± (120,069 SF.)

124,740 GSF - SELF STORAGE BUILDING SQUARE FOOTAGE & USE: PARKING SUMMARY:

TOTAL REQUIRED: 8 SPACES TOTAL PROVIDED: 8 SPACES 17,071 SF (NEW) + 11,993 SF (EXIST.) = 29,064 S VEHICULAR SURFACE AREAS TOTAL ACCESSIBLE SPACES: 1 VAN SPACE IMPERVIOUS SURFACE AREA:

0.81 ACRES BASED ON PREVIOUSLY APPROVED CALCS EXISTING IMPERVIOUS SURFACE AREA: 0.64 ACRES NEW IMPERVIOUS SURFACE AREA: 10. INSIDE CITY LIMITS:

1 SPACE/100 STORAGE UNITS (849 UNITS)

11. INSIDE FLOOD HAZARD BOUNDARY 12. FLOOR AREA RATIO: BUILDING LOT COVERAGE: 13. INSIDE FALLS LAKE OR SWIFT CREEK DRAINAGE AREAS 14. DEDICATED STREET RIGHT OF WAY: 15. BUILD-TO REQUIREMENTS:

50% WITHIN 0/100' 211.48' (MEASURED ALONG ARC) BUILDING WIDTH WITHIN 100' OF PRIMARY STREET: BUILDING WIDTH IN PRIMARY BUILD-TO RATIO:

PRIMARY STREET FRONTAGE LENGTH (BARROWOOD DR.): BUILDING WIDTH WITHIN 100' OF PRIMARY STREET: BUILDING WIDTH IN PRIMARY BUILD-TO RATIO: 50.61%

16. OUTDOOR AMENITY AREA: 0.28 ACRES REQUIRED (10%) 0.28 ACRES PROVIDED

17. OWNER/DEVELOPER: JAMES T. STREET - MANAGER COLONIAL DURALEIGH OUTPARCEL LLC 5306 SIX FORKS ROAD, SUITE 101 RALEIGH, NC 27609 (919) 782-8499 (PHONE)

jstreétbiz@gmail.com (E-MAIL) 18. CONTACT PERSON: RON HENDRICKS PIEDMONT LAND DESIGN, LLP 8522-204 SIX FORKS ROAD RALEIGH. NORTH CAROLINA 27615 (919) 845-7600 (PHONE)

# **GENERAL NOTES**

ALL MATERIALS AND METHODS OF CONSTRUCTION SHALL BE IN ACCORDANCE WITH THE CITY OF RALEIGH AND THE STATE OF NORTH CAROLINA STANDARDS AND SPECIFICATIONS.

CONTRACTOR SHALL HAVE NORTH CAROLINA ONE CALL (1-800-632-4949) LOCATE ALL EXISTING UTILITIES PRIOR TO BEGINNING CONSTRUCTION.

CONTRACTOR SHALL VERIFY THE LOCATION AND DEPTH OF ALL EXISTING UTILITIES AND NOTIFY THE ENGINEER OF ANY DISCREPANCIES OR CONFLICTS PRIOR TO BEGINNING

BOUNDARY AND TOPOGRAPHIC SURVEY INFORMATION IS TAKEN FROM A SURVEY BY ROBINSON & PLANTE, PC. VERTICAL ESTABLISHED OFF BMP AND SANITARY SEWER AS-BUILTS PROVIDED BY PIEDMONT LAND DESIGN, LLP.

5. ALL CONSTRUCTION SHALL CONFORM TO A.D.A. STANDARDS.

SIDEWALK PRIOR TO THE ISSUANCE OF BUILDING PERMITS.

6. NO OBSTRUCTIONS BETWEEN 2 FEET AND 8 FEET IN HEIGHT ABOVE THE CURB LINE ELEVATION SHALL BE LOCATED IN WHOLE OR IN PART WITHIN THE SIGHT TRIANGLES SHOWN ON THIS PLAN.

7. THIS PROPERTY IS NOT LOCATED IN A SPECIAL FLOOD HAZARD AREA ACCORDING TO FEMA MAP# 3720078600J EFFECTIVE DATE: MAY 2, 2006

8. SIGN PERMITTING IS A SEPARATE APPROVAL PROCESS AND HAS NOT BEEN REVIEWED OR APPROVED AS A PART OF THIS SITE PLAN. A SIGN PERMIT SHALL BE OBTAINED PRIOR TO THE INSTALLATION OF SIGNAGE.


9. A FEE-IN-LIEU OF CONSTRUCTION PAYMENT SHALL BE MADE FOR DURALEIGH ROAD 1'


10. A FEE-IN-LIEU OF CONSTRUCTION PAYMENT SHALL BE MADE FOR THE BARROWOOD DRIVE OF A 31' B/B STREET WITH 6' SIDEWALK PRIOR TO THE ISSUANCE OF BUILDING

11. HVAC AND MECHANICAL UNITS SHALL BE MOUNTED ON THE ROOF OF THE BUILDING.

12. LIGHTING PLAN SHALL BE SUBMITTED FOR REVIEW DURING CONCURRENT REVIEW

13. SCREEN WALLS AND SERVICE AREA (DUMPSTER) WALLS SHALL MATCH BUILDING MATERIAL AND COLORS. SEGMENTAL RETAINING WALLS SHALL BE GRAY OR TAN BLOCK.

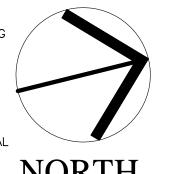

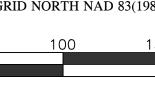





**PRELIMINARY** 

ISSUED: 22 DEC. 2016

**REVISIONS:** /1\ 3 JULY 2018

/2\ 24 AUG 2018 REVISED PER CITY COMMENTS

/3\ 24 SEPT 2018 REVISED PER CITY COMMENTS

> ∕4\ 10 OCT 2018 REVISED PER CITY COMMENTS

REVISED PER CITY COMMENTS

DRAWN BY: CRP CHECKED BY: RPH

PROJECT: **DRS** 

COVER SHEET

**REVISION 05.13.16** 

WWW.RALEIGHNC.GOV

**DEVELOPMENT** 

Inside City Limits? Yes No

**REVISION 05.13.16** 

Proposed building use(s) SELF STORAGE

Existing Building(s) sq. ft. gross NONE

Ceiling height of 1st Floor 10.83'

Flood Hazard Area Yes No

5. Bedroom Units: 1br 2br 3br 4br or more

8. Is your project a cottage court? Yes No

\_\_\_\_ to serve as my agent regarding this application, to

If Yes, please provide:

FEMA Map Panel #

6. Infill Development 2.2.7

Proposed Building(s) sq. ft. gross 124,740

Proposed height of building(s) 44.75

Major Street Locator: GLENWOOD AVENUE

SERVICES

**Administrative Site Review Application** 

(for UDO Districts only)

relopment Name Duraleigh Road Storage

Property Address(es) 6101 DURALEIGH ROAD

roposed Use SELF STORAGE

P.I.N. 0786.06-48-9672 P.I.N.

OR ADMIN ALTERNAT

PAGE 1 OF 3

Zoning District(s) CX-3-PL

Off street parking: Required 8

COA (Certificate of Appropriateness) case # N/A

BOA (Board of Adjustment) case # A- N/A

Existing Impervious Surface 0.81

Proposed Impervious Surface 1.45

Neuse River Buffer 🗏 Yes 🗀 No

CUD (Conditional Use District) case # Z- N/A

Overlay District N/A

If more than one district, provide the acreage of each: N/A

Total # Of Apartment, Condominium or Residential Units

2. Total # Of Congregate Care Or Life Care Dwelling Units

4. Overall Total # Of Dwelling Units (1-6 Above)

Printed Name 44mes T. Street

PAGE 2 OF 3

**BUILDING TYPE** 

General Mixed Use

☐ Open Lot

Development Services Customer Service Center | 1 Exchange Plaza, Suite 400 | Raleigh, NC 27601 | 919-996-2495 | efax 919-996-1831

Litchford Satellite Office | 8320 – 130 Litchford Road | Raleigh, NC 27601 | 919-996-4200

When submitting plans, please check the appropriate building type and include the Plan Checklist document.

Per City Code Section 10.2.8.D.1, summarize the project work scope. For additions, changes of use, or

Per City Code Chapter 8, summarize if your project requires either a design adjustment, or Section 10 - Alternate

Address 5306 SIX FORKS ROAD, SUITE 101, RALEIGH, NC 27609

ANY PIEDMONT LAND DESIGN, LLP Name (s) RON HENDRICKS

Phone 919-782-8499 | Email JSTREETBIZ@GMAIL.COM | Fax

Address 8522-204 SIX FORKS ROAD, RALEIGH, NC 27615

WWW.RALEIGHNC.GOV

Total Site Acres Inside City Limits Yes No 2.76 (120,069 SF.) Total sq. ft. gross (existing & proposed) 124.740

Stormwater Information

FOR RESIDENTIAL DEVELOPMENTS

SIGNATURE BLOCK (Applicable to all developments)

In filing this plan as the property owner(s), I/we do hereby agree and firmly bind ourselves, my/our heirs, executors, administrators, successors

and assigns jointly and severally to construct all improvements and make all dedications as shown on this proposed development plan as

receive and respond to administrative comments, to resubmit plans on my behalf and to represent me in any public meeting regarding this

I/we have read, acknowledge and affirm that this project is conforming to all application requirements applicable with the proposed development

acres/square feet

PIEDMONT LAND DESIGN, LLP

OMPANY COLONIAL DURALEIGH OUTPARCEL LLC Name (5) JAMES T. STREET MANAGER

Phone 919-845-7600 Email RONH@PIEDMONTLANDDESIGN.COM Fax 919-845-7703

DEVELOPMENT TYPE & SITE DATA TABLE (Applicable to all developments)

occupancy (per Chapter 6 of the UDO), indicate impacts on parking requirements

FIN. FLOOR ELEVATION = 411.00AVG EXISTING GROUND ELEVATION-DURALEIGH = (410.5+408.5)/2 = 409.5AVG PROPOSED GROUND ELEVATION-DURALEIGH= (411+408.5)/2 = 409.75

HEIGHT ABOVE FINISHED FLOOR = 40.0'

BUILDING HEIGHT = 411.0 + 40.0' - 406.25 = 44.75'


A1.02 PROPOSED BUILDING ELEVATIONS

(919) 845-7703 (FAX)

ronh@piedmontlanddesign.com (E-MAIL)

NC GRID NORTH NAD 83(1986)

# **LEGEND**

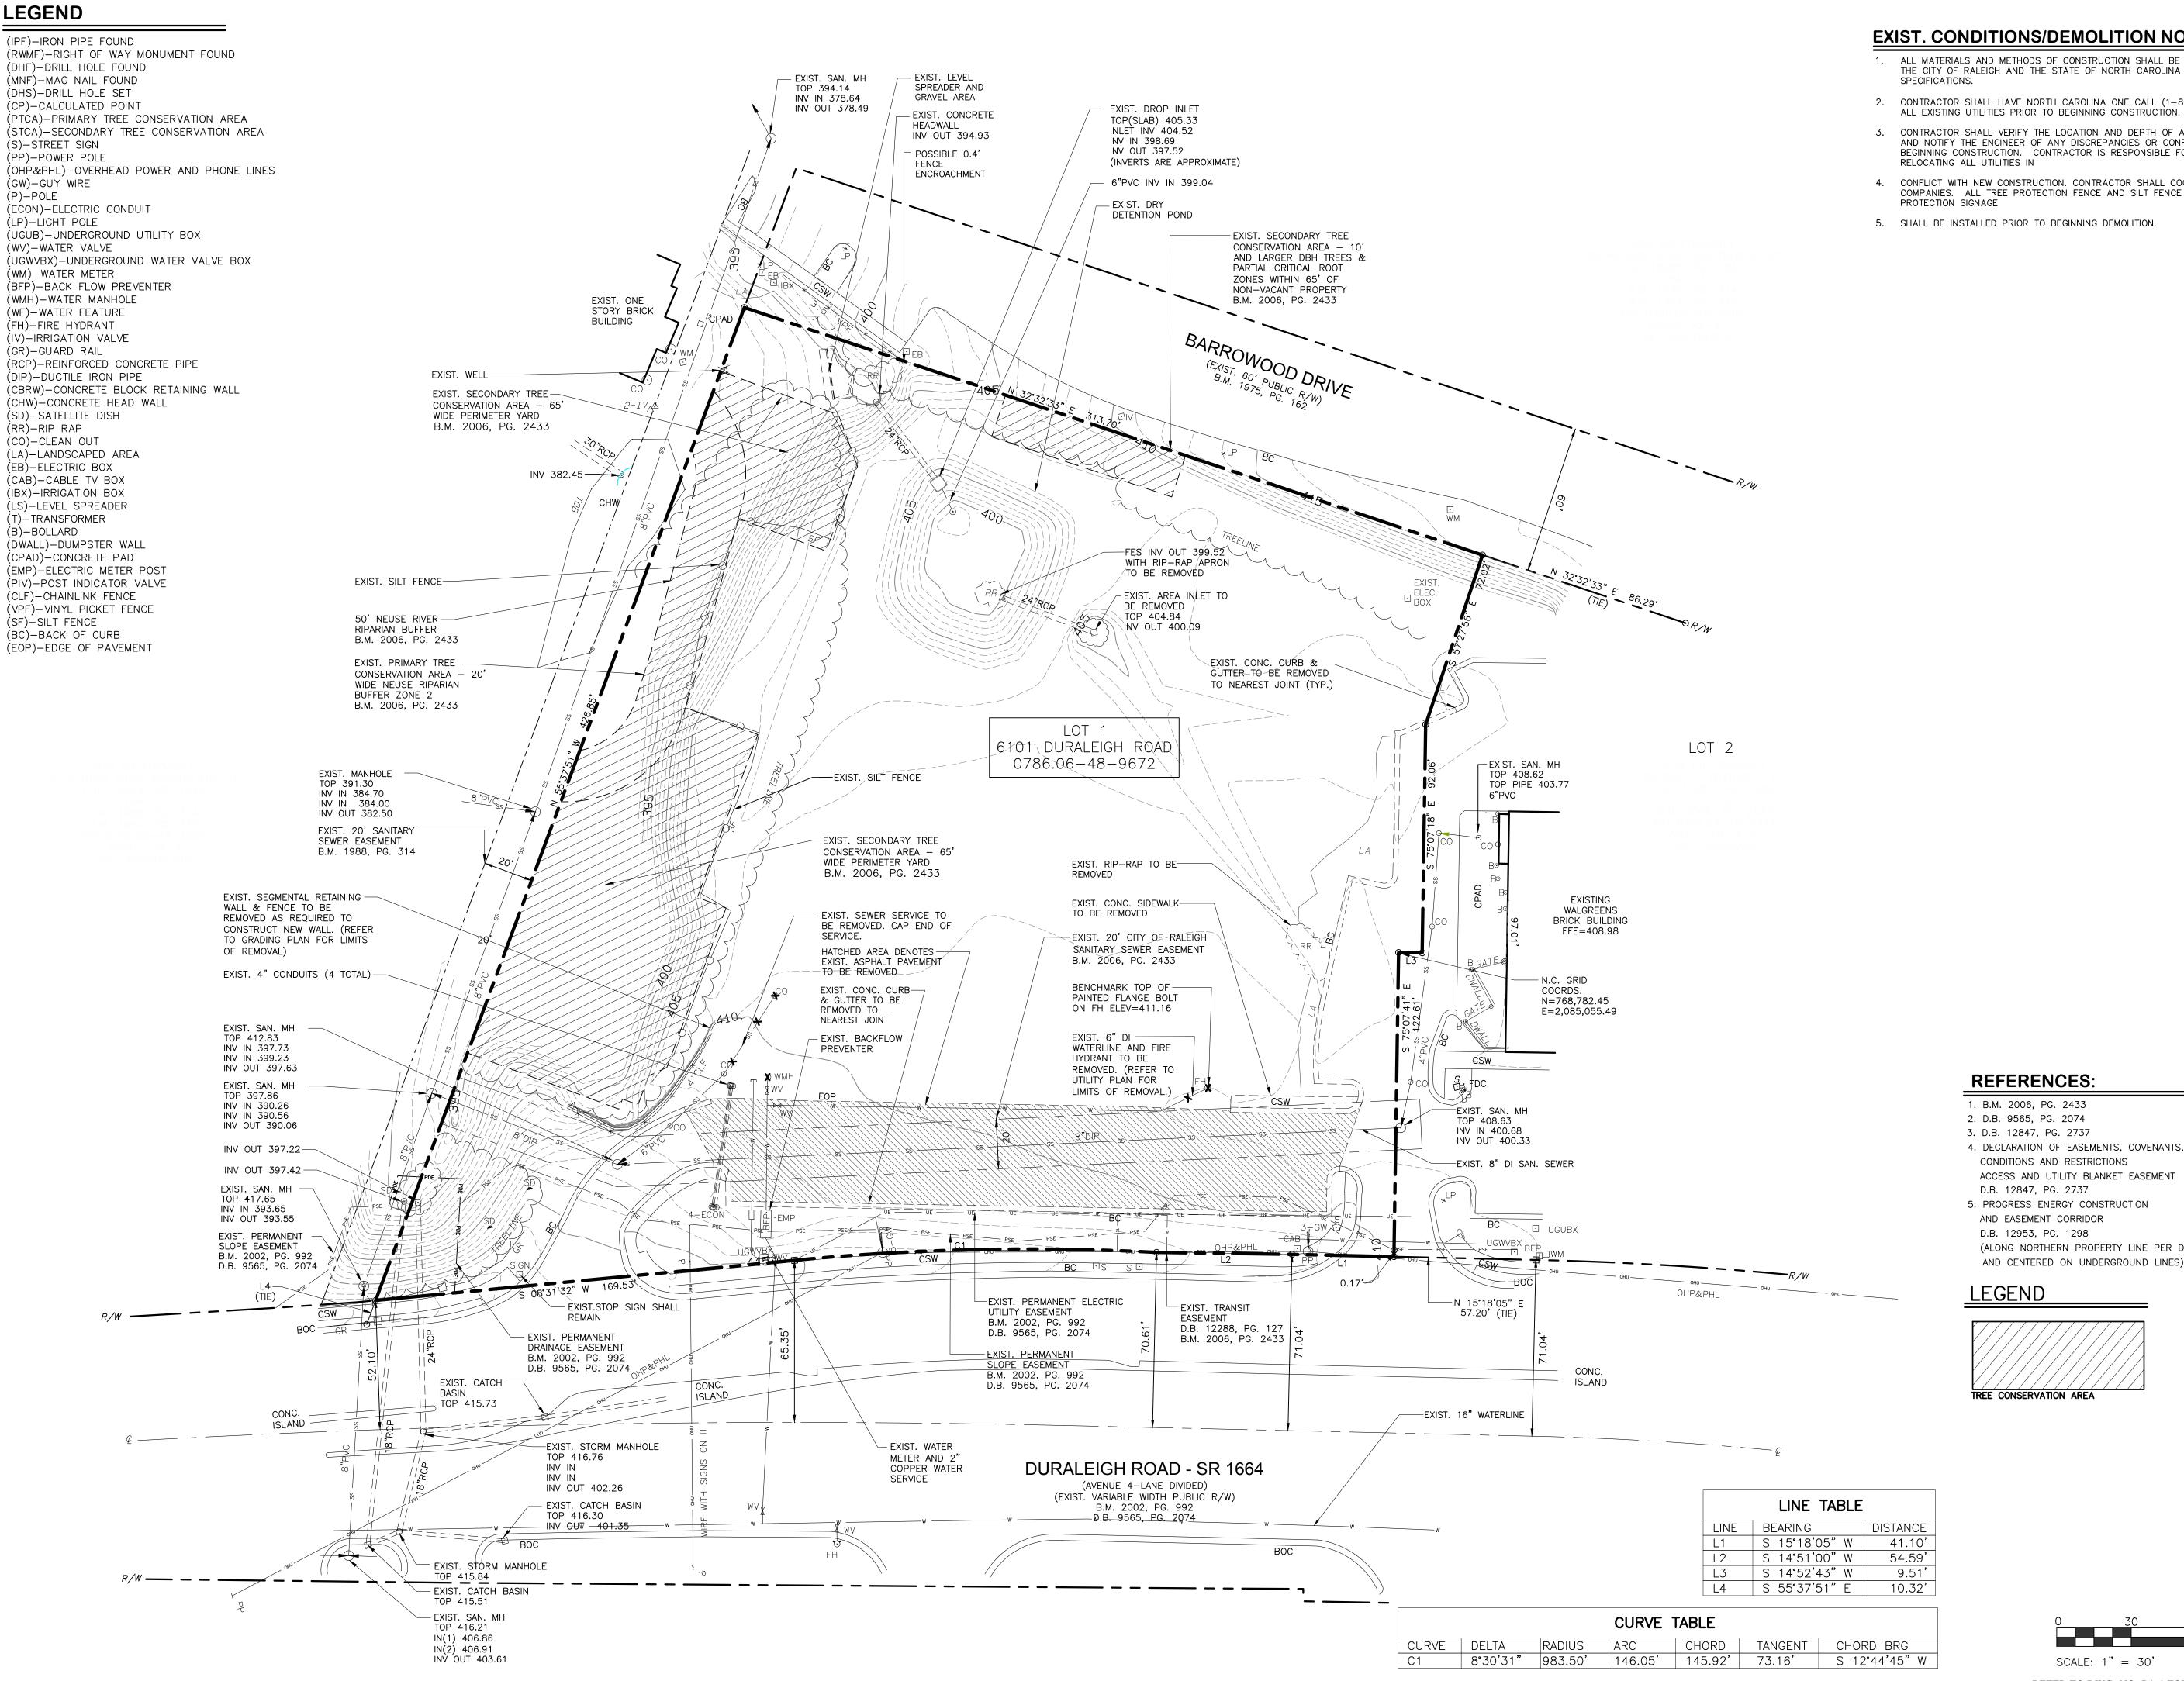

# **EXIST. CONDITIONS/DEMOLITION NOTES**

- 1. ALL MATERIALS AND METHODS OF CONSTRUCTION SHALL BE IN ACCORDANCE WITH THE CITY OF RALEIGH AND THE STATE OF NORTH CAROLINA STANDARDS AND
- 2. CONTRACTOR SHALL HAVE NORTH CAROLINA ONE CALL (1-800-632-4949) LOCATE
- 3. CONTRACTOR SHALL VERIFY THE LOCATION AND DEPTH OF ALL EXISTING UTILITIES AND NOTIFY THE ENGINEER OF ANY DISCREPANCIES OR CONFLICTS PRIOR TO BEGINNING CONSTRUCTION. CONTRACTOR IS RESPONSIBLE FOR REMOVING OR
- 4. CONFLICT WITH NEW CONSTRUCTION. CONTRACTOR SHALL COORDINATE WITH UTILITY COMPANIES. ALL TREE PROTECTION FENCE AND SILT FENCE WITH TREE PROTECTION SIGNAGE
- 5. SHALL BE INSTALLED PRIOR TO BEGINNING DEMOLITION.





**PRELIMINARY** NOT FOR CONSTRUCTION

# ر ٥

ISSUED: **22 DEC. 2016** 

REVISED PER CITY COMMENTS

REVISED PER CITY COMMENTS

REVISED PER CITY COMMENTS

**REVISIONS:** 

1 3 JULY 2018

/2\ 24 AUG 2018

∕3\ 10 OCT 2018

1. B.M. 2006, PG. 2433


2. D.B. 9565, PG. 2074

3. D.B. 12847, PG. 2737 4. DECLARATION OF EASEMENTS, COVENANTS, CONDITIONS AND RESTRICTIONS


ACCESS AND UTILITY BLANKET EASEMENT D.B. 12847, PG. 2737 5. PROGRESS ENERGY CONSTRUCTION

AND EASEMENT CORRIDOR D.B. 12953, PG. 1298 (ALONG NORTHERN PROPERTY LINE PER DEED AND CENTERED ON UNDERGROUND LINES)

# **LEGEND**

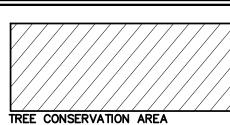



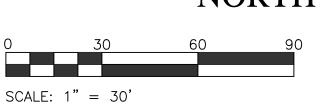


REFER TO DWG. NO. PA 1 FOR GENERAL NOTES

DRAWN BY: JNB CHECKED BY: RPH PROJECT: **DRS** 

> **EXISTING CONDITIONS AND DEMOLITION PLAN**

DWG. NO.

PA. 2

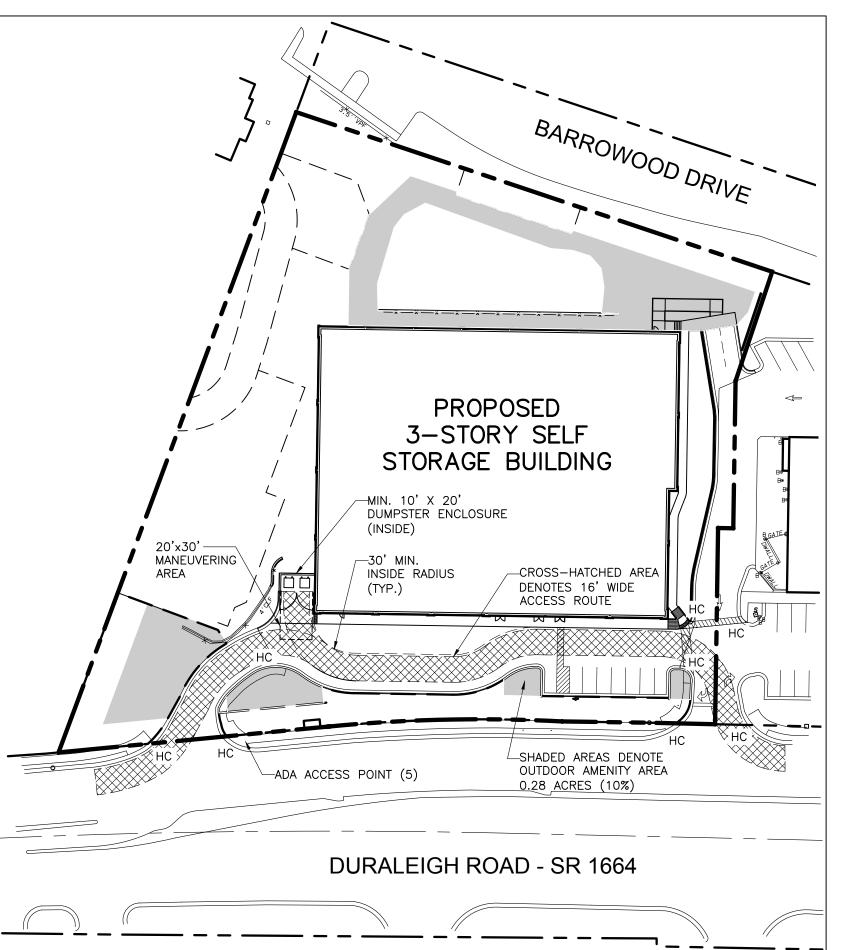

LINE TABLE

L1 S 15\*18'05" W 41.10'

L2 S 14\*51'00" W 54.59'

L3 S 14\*52'43" W 9.51'

L4 S 55°37'51" E 10.32'


LINE BEARING

CURVE TABLE

 CURVE
 DELTA
 RADIUS
 ARC
 CHORD
 TANGENT
 CHORD BRG

 C1
 8\*30'31"
 983.50'
 146.05'
 145.92'
 73.16'
 \$ 12\*44'45" W

SOLID WASTE COLLECTION ROUTING AND OUTDOOR AMENITY AREA SCALE: 1"=40'

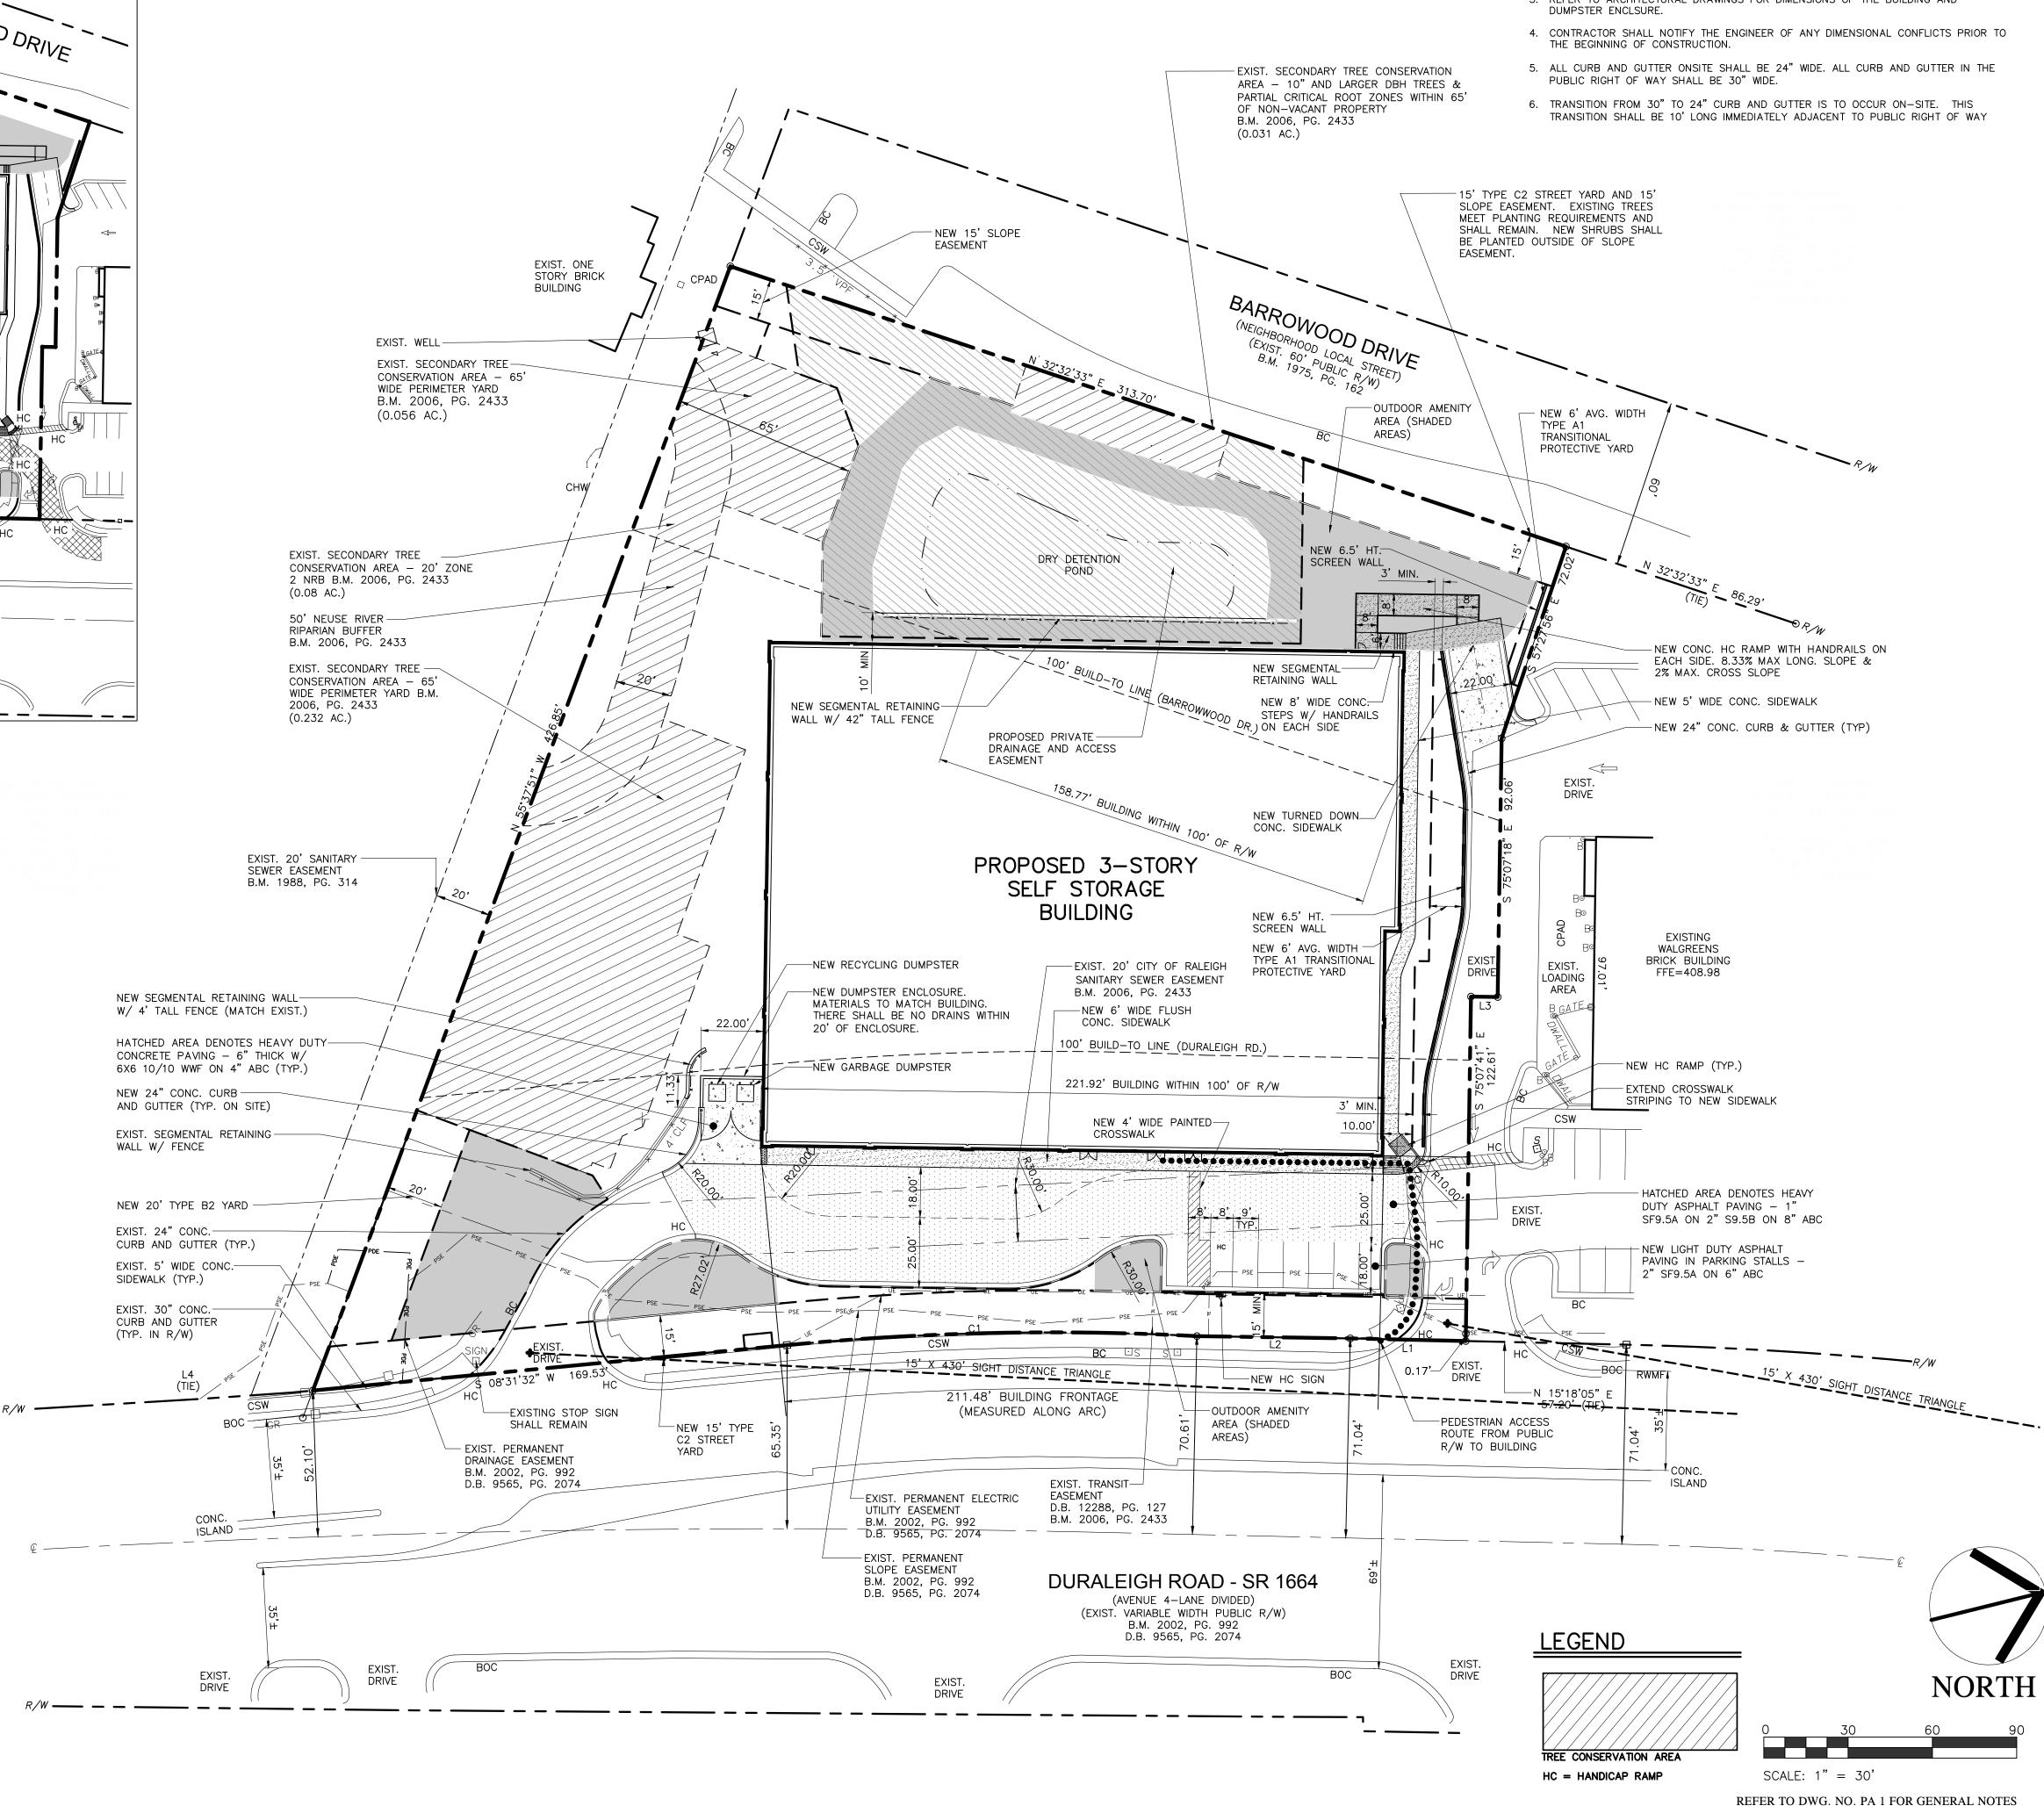

**STAKING NOTES** 

1. ALL DIMENSIONS ARE TO BACK OF CURB, FACE OF TURNED DOWN WALK, EDGE OF PAVING, BUILDING WALL FACE OR PROPERTY LINE.

2. PARKING SPACES ARE 9.0' WIDE MINIMUM EXCEPT HANDICAP SPACES WHICH ARE 8.0' WIDE MINIMUM WITH 5.0' AISLES (8.0' AISLES - VAN).

3. REFER TO ARCHITECTURAL DRAWINGS FOR DIMENSIONS OF THE BUILDING AND

PIEDMONT LANDDESIGN, LLP



**PRELIMINARY** NOT FOR CONSTRUCTION

ÖÎ

ISSUED: **22 DEC. 2016** 

**REVISIONS:** 

1 3 JULY 2018 REVISED PER CITY COMMENTS

REVISED PER CITY COMMENTS

2 24 AUG 2018

3 24 SEPT 2018 REVISED PER CITY COMMENTS

10 OCT 2018

REVISED PER CITY COMMENTS

DRAWN BY: JNB CHECKED BY: RPH

PROJECT: DRS

**PROPOSED STAKING** 

**PLAN** 

PA. 3 DWG. NO.

# **UTILITY NOTES**

- . ALL MATERIALS AND METHODS OF CONSTRUCTION SHALL BE IN ACCORDANCE WITH THE CITY OF RALEIGH AND THE STATE OF NORTH CAROLINA STANDARDS AND SPECIFICATIONS.
- 2. CONTRACTOR SHALL HAVE NORTH CAROLINA ONE CALL (1-800-632-4949) LOCATE ALL EXISTING UTILITIES PRIOR TO BEGINNING CONSTRUCTION.
- 3. CONTRACTOR SHALL VERIFY THE LOCATION AND DEPTH OF ALL EXISTING UTILITIES AND NOTIFY THE ENGINEER OF ANY DISCREPANCIES OR CONFLICTS PRIOR TO BEGINNING CONSTRUCTION.
- 4. CONTRACTOR SHALL COORDINATE THE LOCATION OF THE ELECTRIC, GAS, AND TELEPHONE SERVICE WITH THE APPROPRIATE UTILITY COMPANY PRIOR TO BEGINNING CONSTRUCTION. CONTRACTOR SHALL PROVIDE CONDUITS AS REQUIRED FOR THESE UTILITIES UNDER PAVED AREAS.
- 5. THIS PLAN IS DIAGRAMMATIC AND REPRESENTS THE APPROXIMATE LOCATION OF UTILITIES UNLESS SPECIFICALLY DIMENSIONED. THE CONTRACTOR SHALL COORDINATE THE ACTUAL AND PROPOSED LOCATION OF UTILITIES TO AVOID CONFLICTS.
- CONTRACTOR SHALL COORDINATE THE LOCATION OF THE WATER AND SEWER SERVICE TO THE BUILDINGS WITH THE BUILDING PLUMBING CONTRACTOR AND THE BUILDING PLANS.
- ALL CLEAN—OUTS SHALL BE PROVIDED IN CAST IRON FRAME AND COVER SIMILAR TO WATER VALVE BOX. PROVIDE HEAVY DUTY FRAME AND COVER IN PAVED AREAS.
- 8. ALL MANHOLE AND CLEAN OUT FRAMES AND COVERS/GRATES SHALL BE PAINTED BLACK SEMI-GLOSS ENAMEL AFTER INSTALLATION.
- 9. CONTRACTOR SHALL PROVIDE CONDUITS FOR IRRIGATION LINES UNDER PAVED AREAS.
- 10. IRRIGATION METER, REDUCED PRESSURE ZONE DEVICE, AND SERVICE SHALL BE PROVIDED. (DESIGN—BUILD.)
- 11. CONTRACTOR SHALL PROVIDE PVC CONDUIT(S) UNDER PAVED AREAS FOR POWER TO LIGHT POLES AND MONUMENT SIGN.

# **LEGEND**

(IPF)-IRON PIPE FOUND (RWMF)-RIGHT OF WAY MONUMENT FOUND (DHF)-DRILL HOLE FOUND (MNF)-MAG NAIL FOUND (DHS)-DRILL HOLE SET (CP)-CALCULATED POINT (PTCA)-PRIMARY TREE CONSERVATION AREA (STCA)—SECONDARY TREE CONSERVATION AREA (S)-STREET SIGN (PP)-POWER POLE (OHP&PHL)-OVERHEAD POWER AND PHONE LINES (GW)-GUY WIRE (P)-POLE (ECON)-ELECTRIC CONDUIT (LP)-LIGHT POLE (UGUB)-UNDERGROUND UTILITY BOX (WV)-WATER VALVE (UGWVBX)-UNDERGROUND WATER VALVE BOX (WM)-WATER METER (BFP)-BACK FLOW PREVENTER BARROWOOD DRIVE (WMH)-WATER MANHOLE (WF)-WATER FEATURE (FH)-FIRE HYDRANT (IV)-IRRIGATION VALVE (GR)-GUARD RAIL (RCP)-REINFORCED CONCRETE PIPE (DIP)-DUCTILE IRON PIPE (CBRW)-CONCRETE BLOCK RETAINING WALL (CHW)-CONCRETE HEAD WALL (SD)-SATELLITE DISH (RR)-RIP RAP (CO)-CLEAN OUT RICB (LA)-LANDSCAPED AREA (EB)-ELECTRIC BOX (CAB)-CABLE TV BOX (IBX)-IRRIGATION BOX (LS)-LEVEL SPREADER (T)-TRANSFORMER DRY DETENTION (B)-BOLLARD (DWALL)-DUMPSTER WALL (CPAD)-CONCRETE PAD (EMP)-ELECTRIC METER POST (PIV)-POST INDICATOR VALVE RD RD RD RD (CLF)-CHAINLINK FENCE (VPF)-VINYL PICKET FENCE (SF)-SILT FENCE (BC)-BACK OF CURB (EOP)-EDGE OF PAVEMENT € DITCH < NEW PVC ROOF DRAIN-W/ CLEAN-OUTS AS SHOWN TREE CONSERVATION AREA PROPOSED BUILDING PRIVATE DRAINAGE AND ACCESS EASEMENT FFE - 411.00 **EXISTING** WALGREENS - EXIST. 20' CITY OF RALEIGH BRICK BUILDING SANITARY SEWER EASEMENT FFE=408.98 B.M. 2006, PG. 2433 -ADJUST CLEAN-OUT TO NEW NEW 4" PVC SAN. SEWER -GRADE IN VALVE BOX. EXIST. 4" CONDUITS (4 TOTAL)-SERVICE @ 1.04% MIN. W/ ADJUST TOPS TO NEW GRADE CLEAN-OUTS AS SHOWN -REMOVE EXIST. BLOW-OFF ASSY, INSTALL 45° BEND & BLOCKING AND EXTEND 6" DI FIRE LINE. CONTRACTOR EXIST. FIRE DEPARTMENT TO ADJUST LOCATION AS NEEDED TO EXIST. SAN. MH ---NEW FIRE DEPARTMENT CONNECTION TOP 412.83 AVOID FOOTING CONFLICTS. CONNECTION (WITHIN 150' INV IN 397.73 OF FIRE HYDRANT INV IN 399.23 INV OUT 397.63 EXIST. SAN. MH TOP 397.86 INV IN 390.26 EXIST. SAN. MH TOP 408.63 6" DI W/L INV IN 390.56 INV OUT 390.06 INV IN 400.68 INV OUT 400.33 -EXIST. 8" DI SAN. SEWER -EXIST. GUY WIRES TO BE RELOCATED. CONTRACTOR OHP&PHL -NEW FIRE HYD. ASSY. TO COORDINATE WITH POWER COMPANY. & 6" DI WATERLINE CONNECT NEW 1.5" PVC WATER SERVICE TO EXIST. 2" -EXIST. 8" WATTS 709 DCDA IN AN ABOVE GROUND HEATED VAULT. -NEW 45° BEND & BLOCKING (TYP.) REPLACE DCA WITH NEW WATTS 909 RPDA OR CITY APPROVED EQUAL. WATER SERVICE. C2 STREET -NEW 1.5" WATER SERVICE NEW 5' x 10' CITY OF RALEIGH WATER METER EASEMENT -EXIST. WATER METER BOX AND 2" COPPER WATER SERVICE. NEW 2" METER TO BE INSTALLED. OUTDOOR AMENITY AREA NEW 2" WATTS 007M2QT OR CITY APPROVED EQUAL TO BE PROVIDED IN AN ABOVE GROUND HEATED VAULT. —EXIST. 16" WATERLINE EXIST. 8" DI WATER SERVICE DURALEIGH ROAD - SR 1664 (EXIST. VARIABLE WIDTH PUBLIC R/W) B.M. 2002, PG. 992 D.B. 9565, PG. 2074 





PRELIMINARY NOT FOR CONSTRUCTION

Щ

OURALEIGH ROAD STOF SALEIGH, NORTH CAROLINA

ISSUED: **22 DEC. 2016** 

**REVISIONS:** 

7 3 JULY 2018

REVISED PER CITY COMME

REVISED PER CITY COMMENTS

24 AUG 2018

REVISED PER CITY COMMENTS

3 24 SEPT 2018

REVISED PER CITY COMMENTS

A 10 OCT 2018

REVISED PER CITY COMMENTS

DRAWN BY: JNB

CHECKED BY: RPH

PROJECT: DRS


PROPOSED UTILITY PLAN

DWG. NO.

SCALE: 1" = 30'

DEEED TO DWC NO DA 1 EOD CENEDAI NOTEC

PA. 5

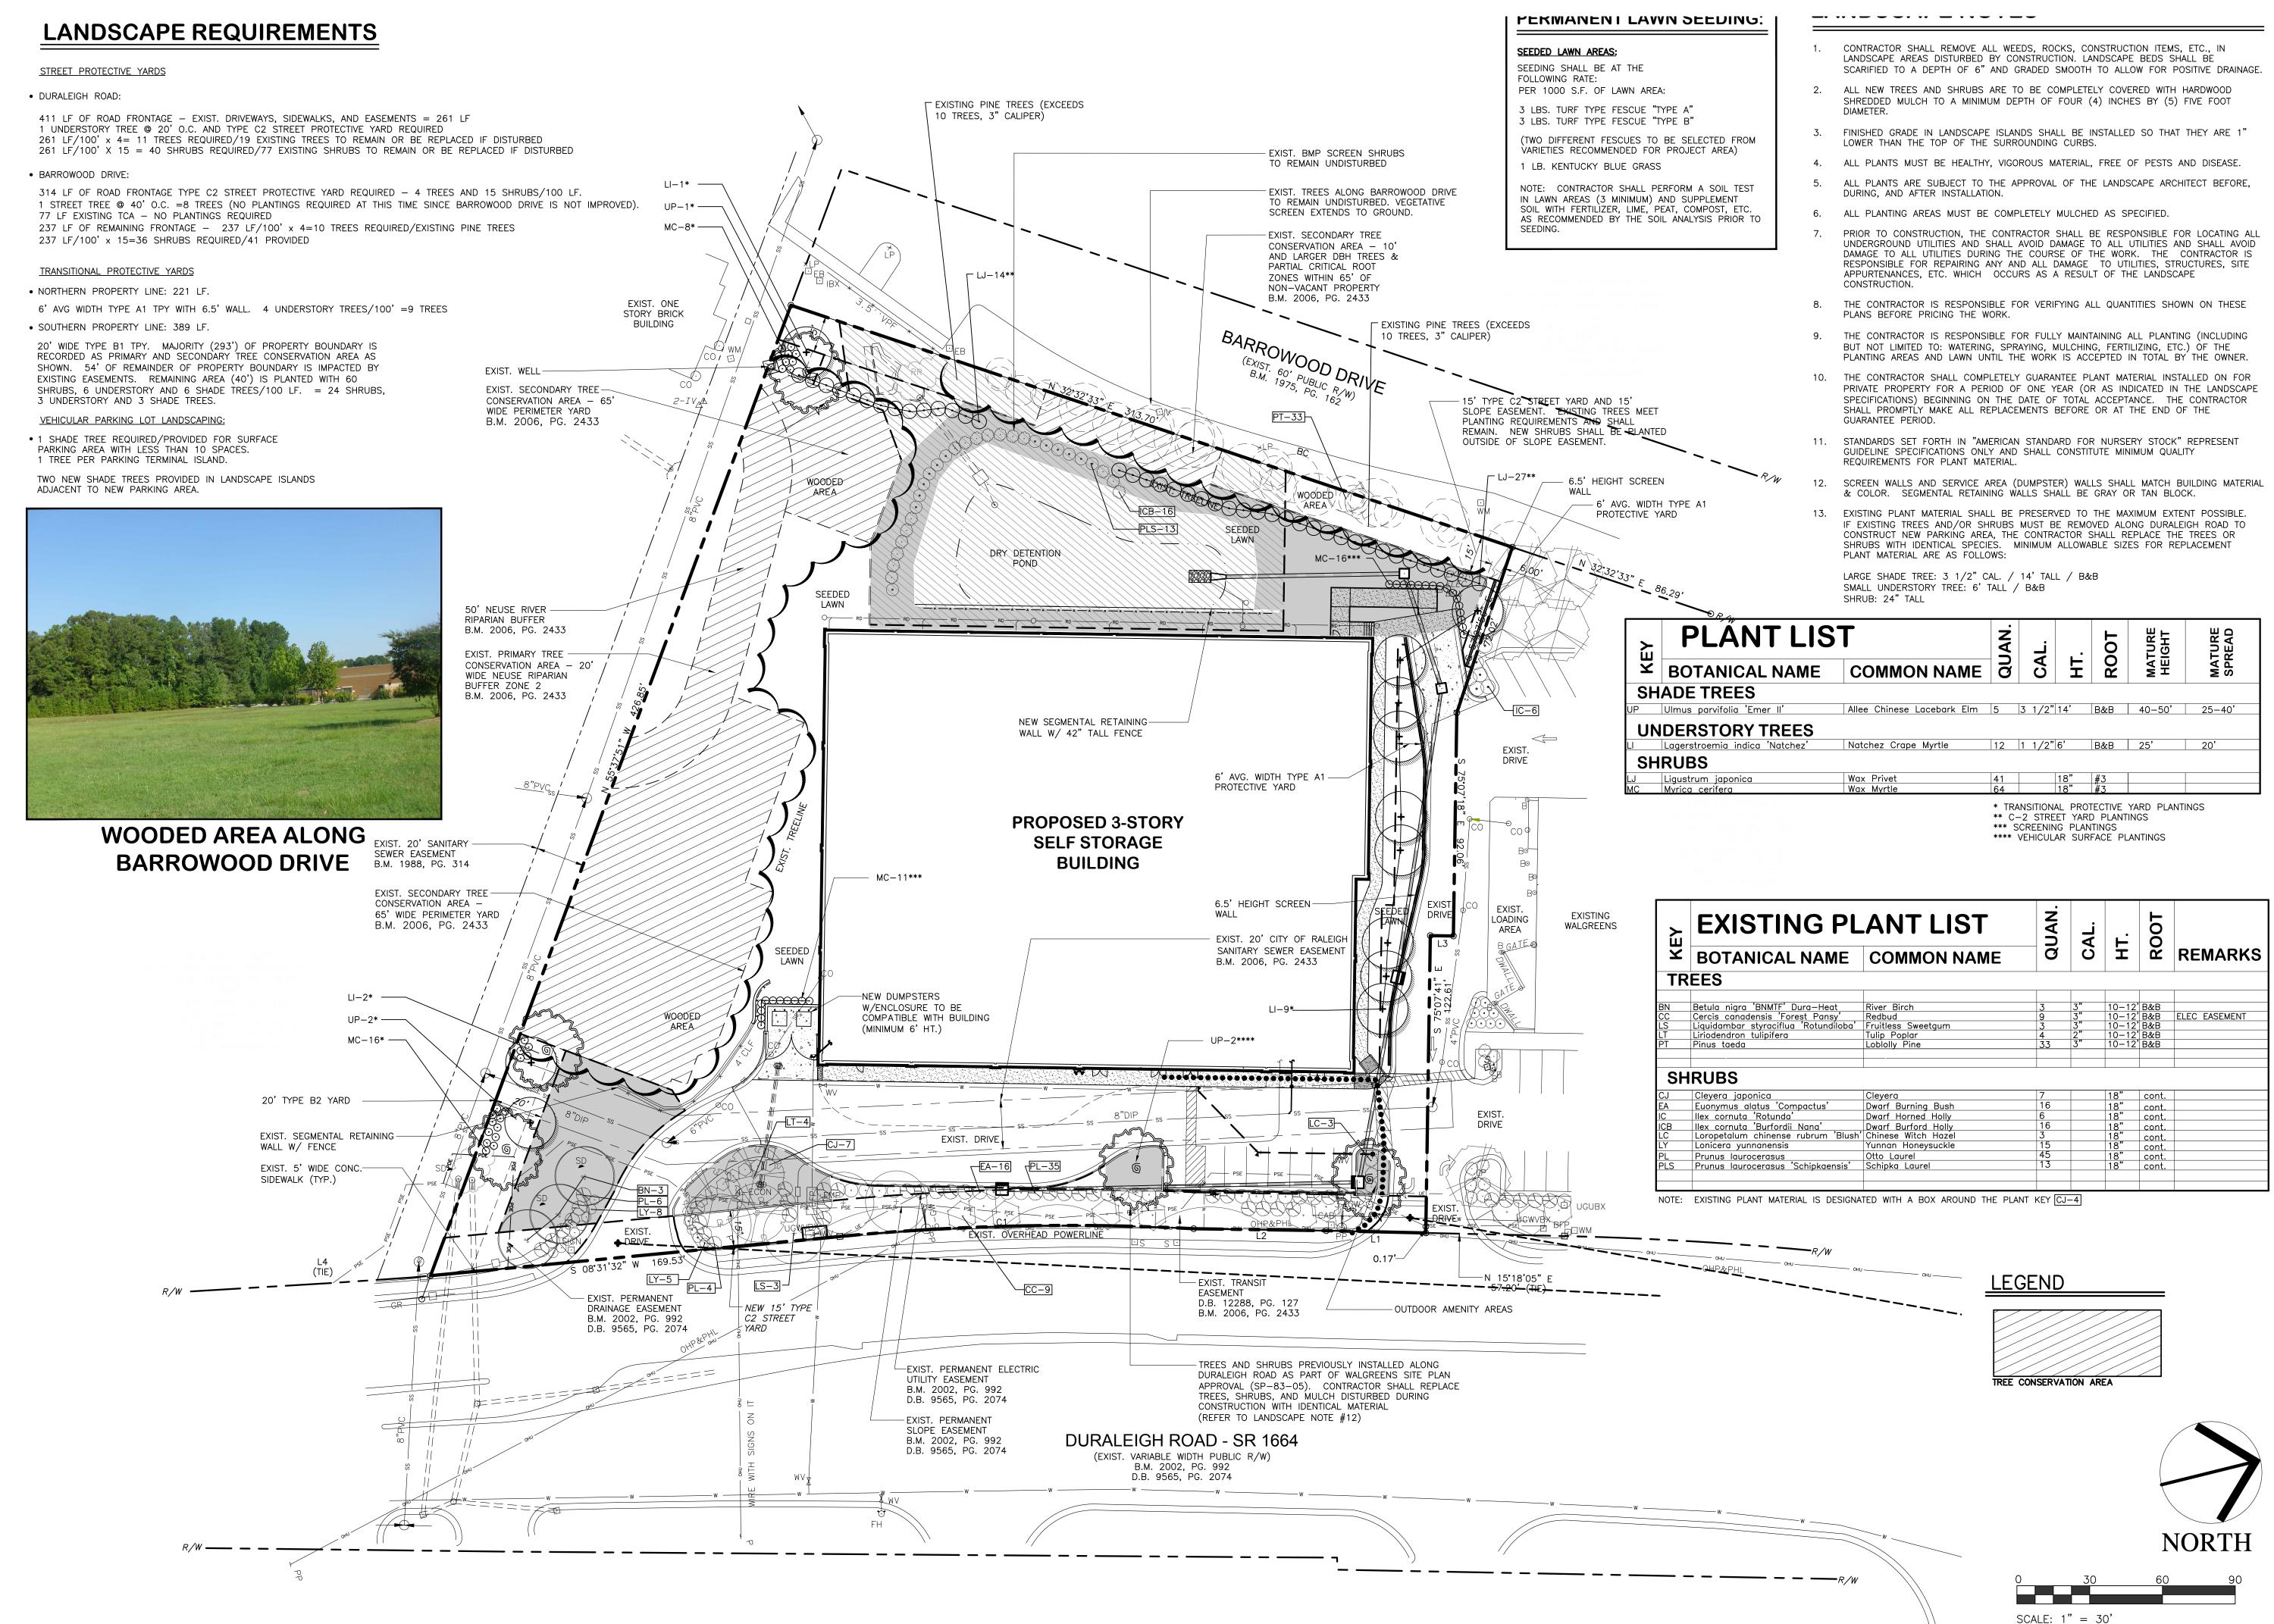

PEDMNI AND DESIGN IIP



PRELIMINARY NOT FOR CONSTRUCTION

# IGH ROAD RTH CAROLINA

4

Ш

ISSUED: 22 DEC 2016

\_\_\_\_\_

REVISIONS:

3 JULY 2018

24 AUG 2018

REVISED PER CITY COMMENTS

A 24 SERT 2018

REVISED PER CITY COMMENTS

24 SEPT 2018

REVISED PER CITY COMMENTS

10 OCT 2018

REVISED PER CITY COMMENTS

DRAWN BY: MGD CHECKED BY: RPH

PROJECT: DRS

REFER TO DWG. NO. PA. 1 FOR GENERAL NOTES

REFER TO DWG. NO. PA. 2 FOR LINE AND CURVE TABLE

PROPOSED LANDSCAPE PLAN

5.4



rn Design iction, Inc. Southes and Con


PRELIMINARY FOR REVIEW ONLY


_	_	_
_	_	
_	-	
_	-	
No.	Revision	Date
L	Raleigh 3rd Round Comments	9/18/2018
K	Raleigh 2nd Round Comments	8/20/2018
J	Update Elevations	6/29/2018
$\overline{}$	Update Plan and Elevations	5/30/2018
Н	Planning Review	
G	Update plan and elevations	2/14/2017
F	Update plan and elevations	12/22/2016
E	Civil Coordination	12/20/2016
D	Duraleigh Elevation Revisions	8/10/2016
	Moved Entry Tower	7/21/2016
В	Update for Unity of Dev.	7/20/2016
	Preliminary Elevations	
No.	Issued	Date
16022	2 A-101.dwg	CDP
File	Name:	Drawn By

Southeastern Design and Construction/
NEW STORAGE DURALEIGH RD.

PROPOSED ELEVATIONS

Drawing No.
A-1.01

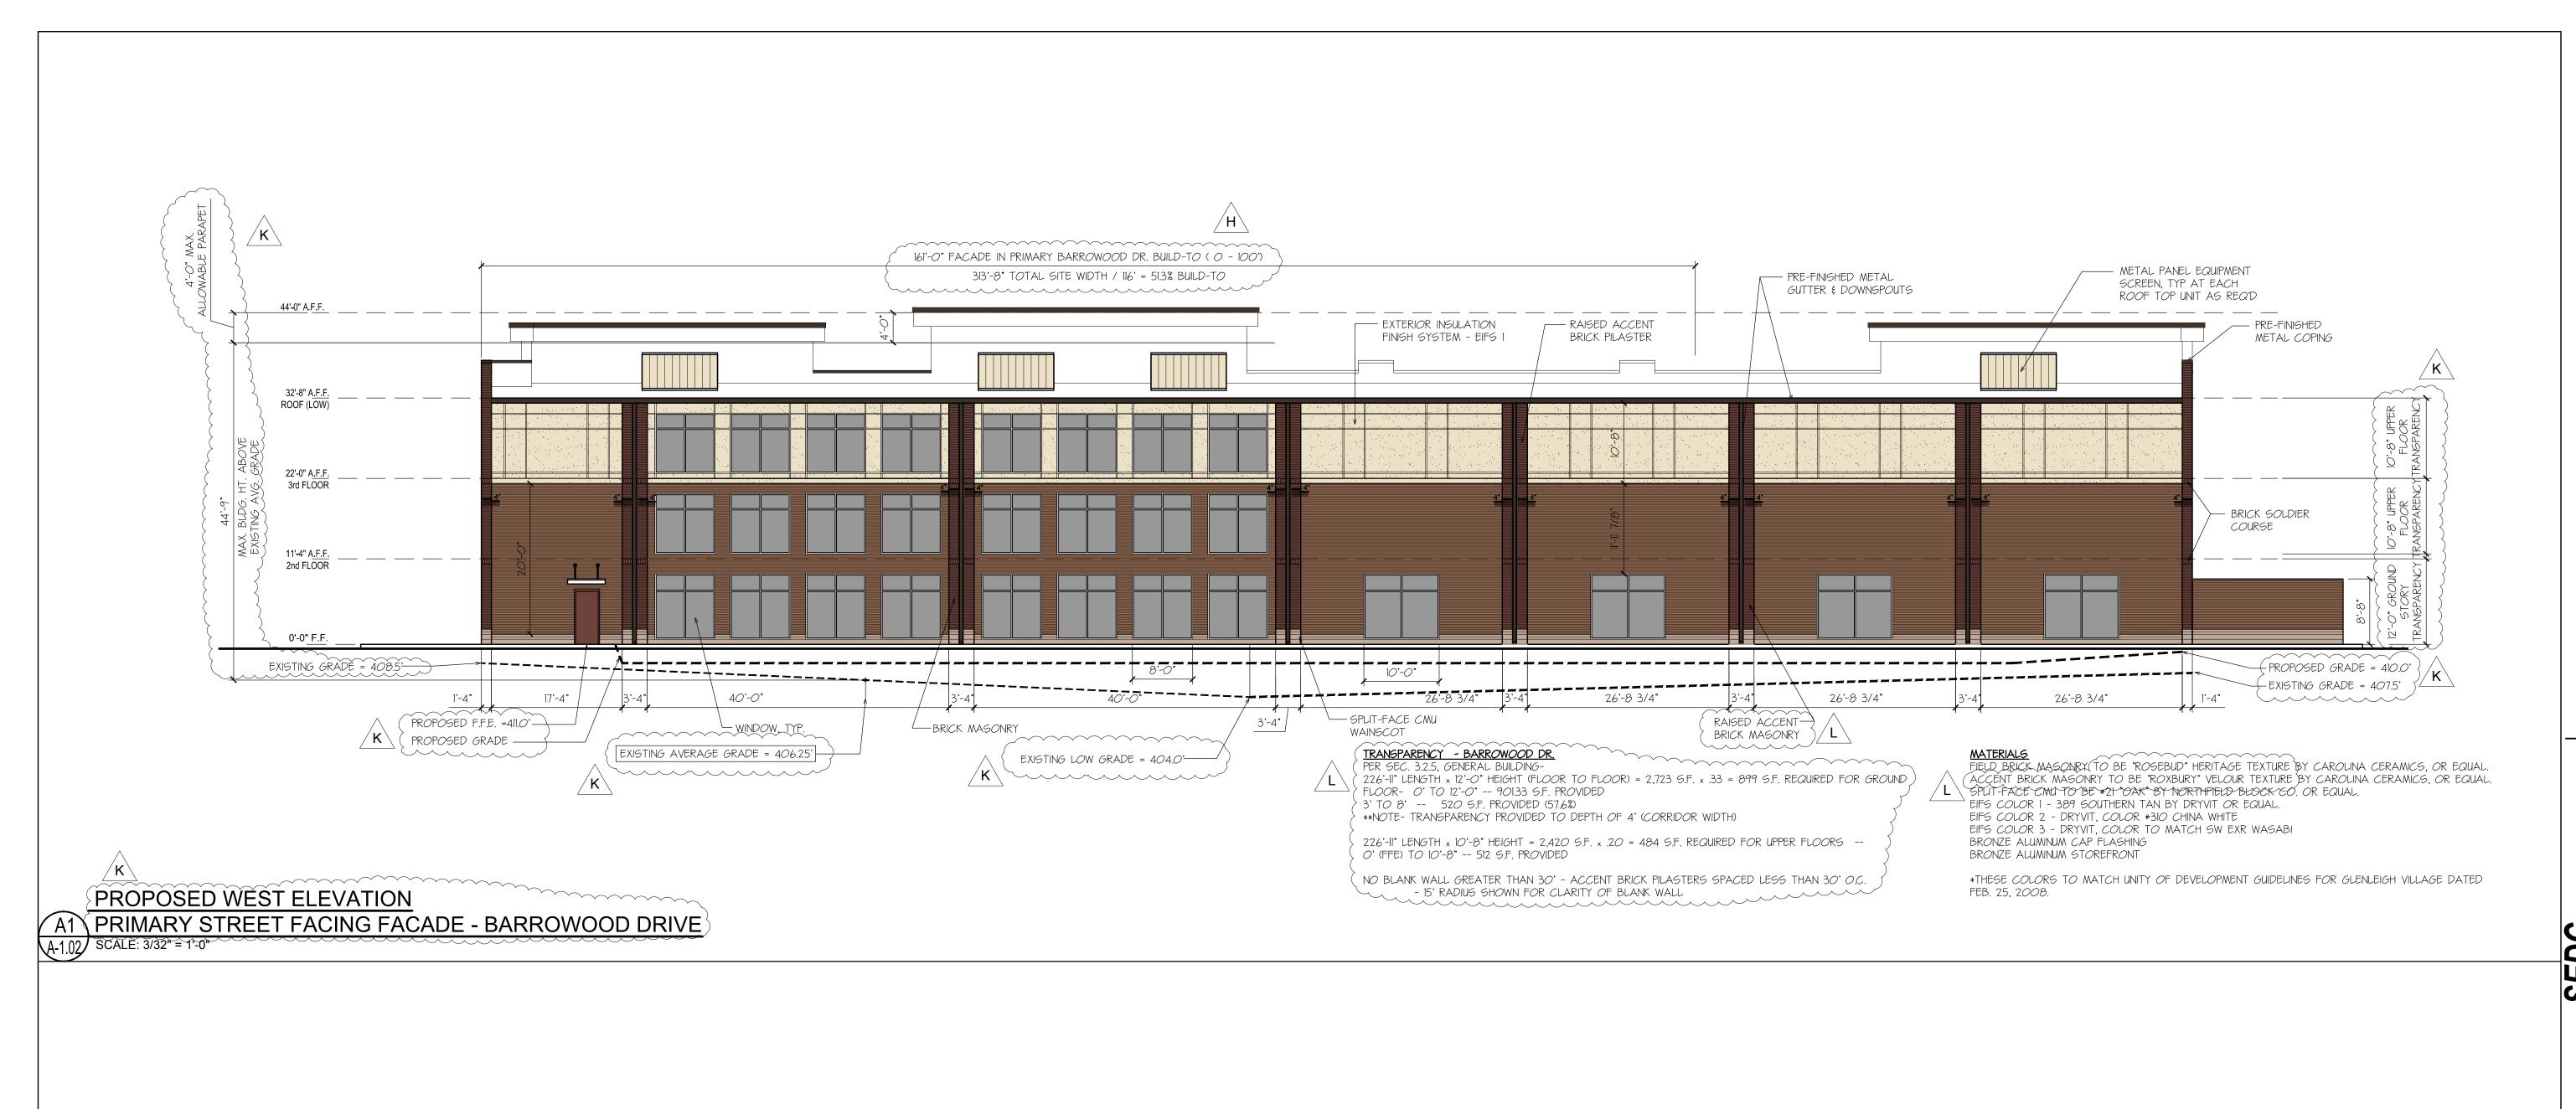

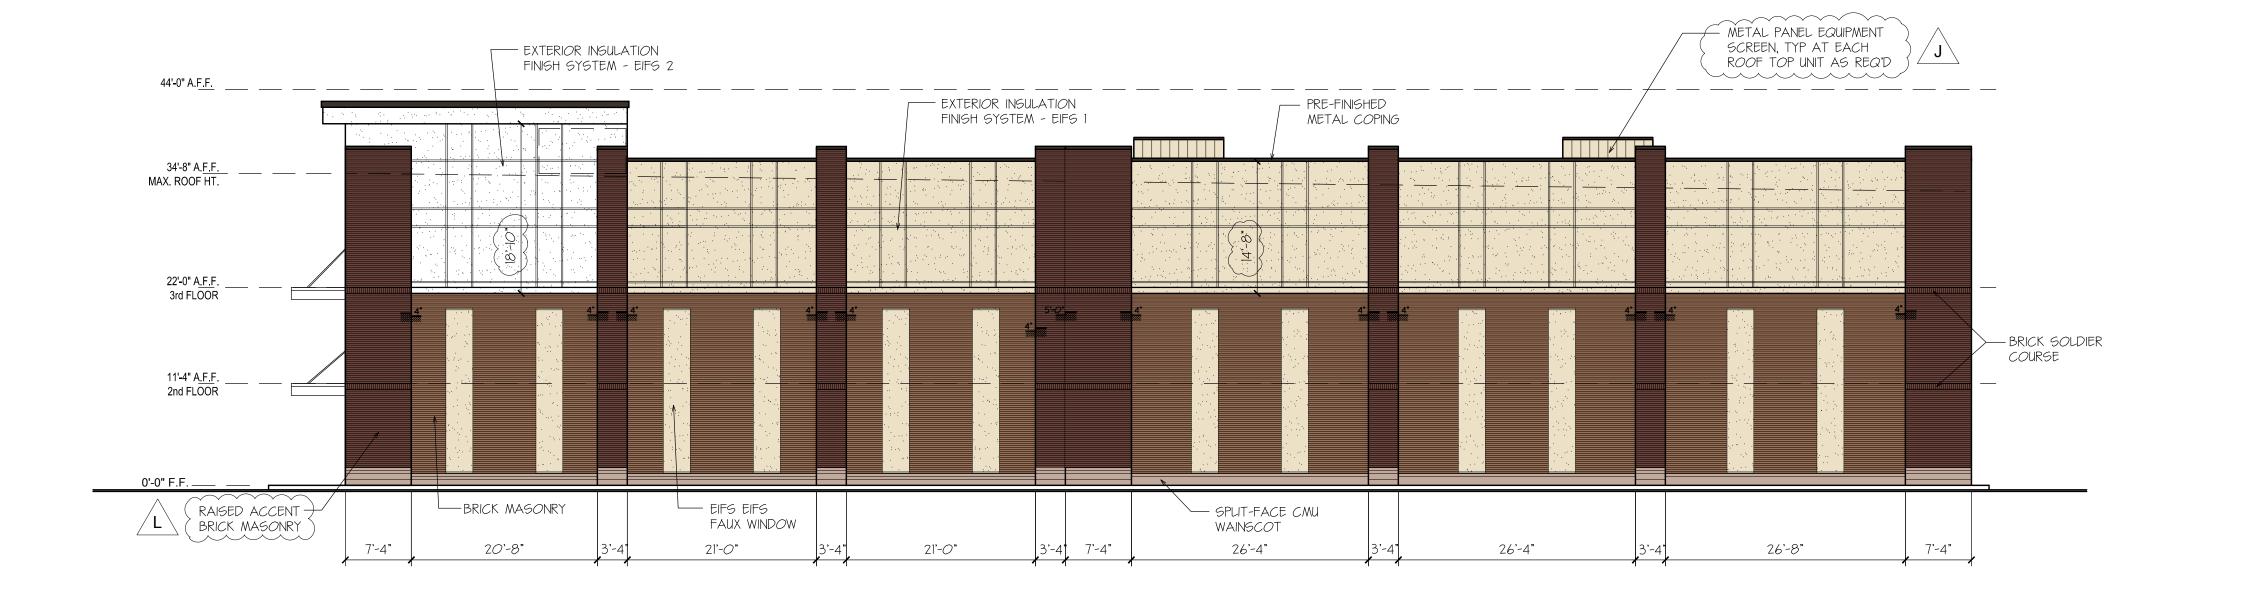

Design ion, Inc. Southes and Con

PRELIMINARY FOR REVIEW ONLY

_	_	_
_		
_	_	
_	_	
No.	Revision	Date
L	Raleigh 3rd Round Comments	9/18/2018
K	Raleigh 2nd Round Comments	8/20/2018
J	Update Elevations	6/29/2018
T	Update Plan and Elevations	5/30/2018
Н	Planning Review	3/28/2017
G	Update plan and elevations	2/14/2017
F	Update plan and elevations	12/22/2016
E	Civil Coordination	12/20/2016
D	Duraleigh Elevation Revisions	8/10/2016
С	Moved Entry Tower	7/21/2016
В	Update for Unity of Dev.	7/20/2016
Α	Preliminary Elevations	7/13/2016
No.	Issued	Date
16022	2 A-102.dwg	CDP
File	Name:	Drawn By

Southeastern Design and Construction/
NEW STORAGE FACILITY
DURALEIGH RD. Raleigh, North Carolina

Sheet Title PROPOSED ELEVATIONS

Project No. 16022

Drawing No.
A-1.02

D1 PROPOSED NORTH ELEVATION SCALE: 3/32" = 1'-0"

© 2018 Christopher Patrick, Architect