



# Administrative Approval Action

Case File / Name: SUB-0010-2022  
DSLCL - Everlee Subdivision Phase Lines Revision

City of Raleigh  
Development Services Department  
One Exchange Plaza  
Raleigh, NC 27602  
(919) 996-2492  
currentplanning@raleighnc.gov  
www.raleighnc.gov

**LOCATION:**

This site is located on the west side of Watkins Road, north of Old Milburnie Road, at 2932, 2933, 3013, 3029 & 3033 Watkins Town Rd, 1505 Old Watkins.

**REQUEST:**

Development of a 104.98-acre tract composed of multiple parcels zoned R-6 CU into a Conservation Development Subdivision. The development includes 18.31 acres of right-of-way dedication with a net area of 86.68 acres. The proposed subdivision consists of 275 lots: 167 detached single-family lots, 94 townhomes, and 14 HOA Common Lots.

The sole purpose of this subdivision resubmittal is to revise the previous preliminary subdivision plan, Everlee Subdivision SUB-0010-2022, approved on 3/7/23, by adding 4 new phases to the development. Phase 1 is 43.11 acres (1,877,736.78 sf); Phase 2 is 14.62 acres (636,762.78 sf); Phase 3 is 30.44 acres (1,326,137.78 sf) and Phase 4 is 14.48 acres (630,883.78 sf). No other changes are being made from the original approved preliminary subdivision. The sunset date for the plan approval has not changed.

Z-28-21 - Adopted 12/07/21 - Old Watkins Rd rezoning to R-6.

**DESIGN**

**ADJUSTMENT(S)/**

**ALTERNATES, ETC:**

SUR-0318-2023: DSENG - Surety/Infrastructure

SPR-0068-2023: DSLCL - Site Permitting Review/Major [Signature Set]

RCMP-0172-2023: DSLCL - Recorded Maps/Recombination

**FINDINGS:**

City Administration finds that this request, with the below conditions of approval being met, conforms to the Unified Development Ordinance. This approval is based on a preliminary plan dated June 26, 2023 by BGE.

## **CONDITIONS OF APPROVAL and NEXT STEPS:**

*This document must be applied to the second sheet of all future submittals except for final plats. This is a preliminary plan and as such no permits have been issued with this approval. To obtain permits and/or completion of the project, the following steps are required:*

☒ **SITE PERMITTING REVIEW** - For land disturbance of 12,000 square feet or greater, public or private infrastructure, shared stormwater devices, etc. Site Permitting Review may be submitted upon receipt of this signed approval document.

***The following items are required prior to approval of Site Permitting Review plans:***

**General**

1. The greenway connection located at 2932 Watkins Town Road will meet all Greenway trail design standards, be located within a bicycle & pedestrian easement, and include a seating area for the neighborhood and any future pedestrian traffic once the greenway corridor is improved.





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2. A detail for the 6 foot fence and split rail fence notation across the site's northern border is provided with the Site Permit Review plans set or the note label is removed from sheets C3-7, C4 of the plans set.
3. All lot dimensions (width and depth details) are provided and shown in the Site Permit Review plans set.
4. Civil plans set demonstrate and show lot chords, distances, metes and bounds, and demonstrate residential lot setbacks, including design requirements for townhome internal lots.
5. All previous approved plat recordings, signed, sealed with book map & pg.#, are inserted and provided with the civil Site Permit Review plans set.
6. Revised civil Site Permit Review plans are updated to show new phase lines for the subdivision.
7. The existing conditions sheet in the civil Site Permit Review plans set is revised and updated to reflect and show the existing land configuration and conditions.
8. Applicant reviews site data table and updates parcel PIN#s and also revises the PIN # for parcel #1222. And the overall gross area sf/acreage for the development and phase areas is reviewed, revised & updated on the site data table.
9. A copy of the revised preliminary subdivision Administrative Action (AA) letter is transposed into the civil Site Permit Review plans set sheets.
10. The overall gross area acreages for phases 1-4 are reviewed and revised to match the overall gross acreage for the development and the reference for the Perry Partial Land Sale right-of-way PIN # is updated.
11. Applicant reviews and revises PIN#1747711222 on the site data table on the civil Site Permit Review plans set, and insert all plat recordings, with book map/pgs., into the civil SPR plans set.

## Engineering

12. Required NCDOT encroachment and/or driveway permits must be approved and copies provided to the City of Raleigh Transportation Department – Mobility Strategy and Infrastructure Division prior to Site Permit review approval.

## Public Utilities

13. A Downstream Sewer Capacity Study in compliance with the City of Raleigh Public Utilities Department Handbook shall be submitted by the Project Engineer for review and approval.
14. A Water Model in compliance with the City of Raleigh Public Utilities Department Handbook shall be submitted by the Project Engineer for review and approval prior to concurrent approval.

## Stormwater





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15. The State of North Carolina shall approve any proposed disturbance within the riparian buffer prior to the issuance of any grading or site permit (UDO 9.2.3.E).
16. A surety equal to of the cost of clearing, grubbing and reseeding a site, shall be paid to the City (UDO 9.4.4).
17. A stormwater control plan with a stormwater operations and maintenance manual and budget shall be approved (UDO 9.2).
18. A nitrogen offset payment must be made to a qualifying mitigation bank (UDO 9.2.2.B).

## Urban Forestry

19. Submit a final tree conservation plan that includes metes and bounds descriptions of all tree conservation areas and tree protection fencing as required (UDO 9.1.5).
20. Tree protection fence must be inspected by Urban Forestry staff prior to the issuance of a grading permit.

☒ **LEGAL DOCUMENTS** - Email to [legaldocumentreview@raleighnc.gov](mailto:legaldocumentreview@raleighnc.gov). Legal documents must be approved, executed, and recorded prior to or in conjunction with the recorded plat on which the associated easements are shown. Copies of recorded documents must be returned to the City within one business day of recording to avoid withholding of further permit issuance.

<input checked="" type="checkbox"/>	Stormwater Maintenance Covenant Required
<input checked="" type="checkbox"/>	Slope Easement Deed of Easement Required
<input checked="" type="checkbox"/>	Pedestrian and Bicycle Access Deed of Easement Required

<input checked="" type="checkbox"/>	Utility Placement Deed of Easement Required
<input checked="" type="checkbox"/>	Right of Way Deed of Easement Required

☒ **RECORDED MAP(S)** - Submit plat to record new property lines, easements, tree conservation areas, etc.). Plats may be submitted for review when the Site Permitting Review plans, if required, have been deemed ready for mylar signature.

***The following items must be approved prior to recording the plat:***

## General

1. Street names for this development shall be approved by the Raleigh GIS Division and by Wake County.
2. A recombination plat is recorded before or in conjunction with any residential lots or phase recordation.
3. Provide documentation indicating a Property Owner's Association has been established for the subject development.





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4. A demolition permit shall be issued and this building permit number shown on all maps for recording.
5. All plat recording demonstrate compliance with UDO Section 2.5.7 for required open space per a Compact Development subdivision.
6. Comply with applicable zoning conditions in Z-28-22 & Sec.2.4.1.
7. The greenway easement as shown on the preliminary plan shall be dedicated prior to, or in conjunction with the recording of a map in any phase affected by the greenway.
8. The final subdivision maps to be recorded shall include a note on all sheets showing common area and open space lots which states "All common area and open space lots are to be owned and maintained by the Property Owners' Association for this development."
9. The subdivision recorded plat shows new phase lines and land area acreage/sf per the revised preliminary subdivision.

## Engineering

10. A public street right-of-way deed of easement, in addition to a plat showing the location of the easement, shall be submitted to the Planning and Development Services Department for review, and if acceptable, approved for recordation. Approved plats must be recorded at the Wake County Register of Deeds Office on or before the 14th day following approval by the City. The 14-day expiration date shall be clearly indicated on the plat. By the end of the next business day following recordation of the plat, all required legal instruments (including deeds of easement) shall be recorded, and recorded copies of the plat and all legal instruments required by the City in association with development approval shall be provided to the City. (Reference: UDO 8.1.7.A; 10.2.5.F.4.d)
11. A fee-in-lieu for any portion of public infrastructure required of the development that is not being provided with the approved SPR plan is paid to the City of Raleigh (UDO 8.1.10).
12. A slope easement (locations and size determined during SPR review) deed of easement, in addition to a plat showing the location of the easement, shall be submitted to the Planning and Development Services Department for review, and if acceptable, approved for recordation. Approved plats must be recorded at the Wake County Register of Deeds Office on or before the 14th day following approval by the City. The 14-day expiration date shall be clearly indicated on the plat. By the end of the next business day following recordation of the plat, all required legal instruments (including deeds of easement) shall be recorded, and recorded copies of the plat and all legal instruments required by the City in association with development approval shall be provided to the City. (Reference: UDO 8.1.7.A; 10.2.5.F.4.d)
13. A public infrastructure surety shall be provided to City of Raleigh Transportation – Development Engineering Division (UDO 8.1.3) in the amount of 100% of the improvement cost for the NCDOT portion and 125% of the improvement cost for the City of Raleigh infrastructure.
14. A sight distance easement shall be approved by the Transportation Department for recording in the Wake County Registry and shown on a plat approved for recordation.





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15. A 5' utility placement easement deed of easement, in addition to a plat showing the location of the easement, shall be submitted to the Planning and Development Services Department for review, and if acceptable, approved for recordation. Approved plats must be recorded at the Wake County Register of Deeds Office on or before the 14th day following approval by the City. The 14-day expiration date shall be clearly indicated on the plat. By the end of the next business day following recordation of the plat, all required legal instruments (including deeds of easement) shall be recorded, and recorded copies of the plat and all legal instruments required by the City in association with development approval shall be provided to the City. (Reference: UDO 8.1.7.A; 10.2.5.F.4.d)
16. A pedestrian and bicycle deed of easement, in addition to a plat showing the location of the easement, shall be submitted to the Planning and Development Services Department for review, and if acceptable, approved for recordation. Approved plats must be recorded at the Wake County Register of Deeds Office on or before the 14th day following approval by the City. The 14-day expiration date shall be clearly indicated on the plat. By the end of the next business day following recordation of the plat, all required legal instruments (including deeds of easement) shall be recorded, and recorded copies of the plat and all legal instruments required by the City in association with development approval shall be provided to the City. (Reference: UDO 8.1.7.A; 10.2.5.F.4.d)

## Public Utilities

17. A fee-in-lieu of construction shall be paid to the City of Raleigh Public Utilities Department for the construction of a new water main in airmax drive
18. Infrastructure Construction Plans (concurrent submittal) must be approved by the City of Raleigh Public Utilities Department for all public water, public sewer and/or private sewer extensions.

## Stormwater

19. A payment equal to twenty-four percent (24%) of the estimated cost of constructing all stormwater control facilities shown on the development plans shall be paid by the developer to the City stormwater facility replacement fund (UDO 9.2.2.G.3).
20. The maximum allocated impervious area for all applicable lots in the subdivision should be identified on all maps for recording.
21. The riparian buffers, in accordance with the preliminary plan and the State of North Carolina regulations, shall be shown on plats for recording along with required buffer statement (Recorded Map Checklist).
22. The flood prone areas, as approved by the City Stormwater Engineer and shown on the preliminary plan, shall be shown on the recorded map (UDO 9.3.3.G).
23. A surety equal to 125% of the cost of the construction of a stormwater device shall be paid to the Engineering Services Department (UDO 9.2.2.D.1.d).





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24. All stormwater control measures and means of transporting stormwater runoff to and from any nitrogen and stormwater runoff control measures shall be shown on all plats for recording as private drainage easements (UDO 9.2).
25. The City form document entitled Declaration of Maintenance Covenant and Grant of Protection Easement for Stormwater Control Facilities shall be approved by the City and recorded with the county register of deeds office (UDO 9.2.2.G).

## Urban Forestry

26. A tree conservation plat shall be recorded with metes and bounds showing the designated tree conservation areas (UDO 9.1). This development proposes 11.64 acres of tree conservation area.

☒ **BUILDING PERMITS** - For buildings and structures shown on the approved plans. Commercial building permit plans must include the signed, approved Site Permitting Review plans attached, if applicable. Permit sets may be reviewed prior to the recordation of required plats, but cannot be approved.

***The following items must be approved prior to the issuance of building permits:***

## General

1. Comply with all conditions of Z-28-21 & UDO Sec.2.4.1.

## Public Utilities

2. A plat must be recorded at the Wake County Register of Deeds office for all utility easement dedications.

## Urban Forestry

3. A public infrastructure surety for the required 535 street trees shall be provided to City of Raleigh Transportation – Development Engineering Division (UDO 8.1.3) in the amount of 125% of the improvement cost for the City of Raleigh infrastructure.
4. A tree impact permit must be obtained for the approved streetscape tree installation in the right of way. This development proposes 23 street trees along Sandy Bluff Rd, 43 trees along Gray Alder Ln, 60 trees along Cedar Elm Way, Hickory Field Dr 31, 7 tree along Vasey Oak Dr, 96 Golden Ash Way, 74 trees along Laurel Pond Way, 27 trees along Blue Jack Ln, 45 trees along Yellow Beech Dr, 76 trees along Peachford Ln, and 53 trees along Arden Branch Ln.

***The following are required prior to issuance of building occupancy permit:***

## General

1. All street lights and street signs required as part of the development approval are installed.





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2. All Water, Sanitary Sewer and Reuse facilities shall be installed, inspected, tested and accepted by the City of Raleigh Public Utilities Department for operations and maintenance.
3. Prior to issuance of the final CO in the development, signal warrant analyses at the intersections of Mitchell Mill Road and Watkins Road, and Forestville Road and Old Watkins Road are required and shall be conducted by the developer. Studies shall be conducted prior to the final acceptance of the streets and sidewalks in the final phase of development, and prior to the release of any surety associated with the work for the streets and sidewalks associated with the subdivision plan.

Details of the analysis shall be coordinated in advance, and subsequently submitted to NCDOT District Office and City of Raleigh Transportation Department for evaluation. If either study finds signalization warrants have been met, then the development shall be responsible for improving the associated intersection(s) accordingly. At the time of permitting the final phase of development, the developer shall put forth a separate surety with the City, covering the cost of signalization in the amount calculated by a licensed professional.

## Stormwater

4. As-built drawings and associated forms for all Stormwater devices are accepted by the Engineering Services Department (UDO 9.2.2.D.3).

**EXPIRATION DATES:** If significant construction has not taken place on a project after preliminary subdivision approval, that approval may "sunset" and be declared void, requiring re-approval before permits may be issued. To avoid allowing this preliminary approval to "sunset", the following must take place by the following dates:

**3-Year Sunset Date: March 7, 2026**  
**Record at least ½ of the land area approved.**

**5-Year Sunset Date: March 7, 2028**  
**Record entire subdivision.**

I hereby certify this administrative decision.

Signed: *Daniel L. Stegall* Date: 07/26/2023  
Development Services Dir/Designee  
Staff Coordinator: **Jermont Purifoy**











# GENERAL NOTES:

1. THE PROPERTY AS SHOWN HEREON IS BASED ON A FIELD-RUN BOUNDARY SURVEY WITH A CLOSURE OF 1:18,300.
2. THE IMPROVEMENTS SHOWN HEREON ARE BASED ON A FIELD-RUN PLANIMETRIC SURVEY PERFORMED BY JOHNSON, MIRAMAN & THOMPSON FROM FEBRUARY 15, 2021 THROUGH DECEMBER 20, 2021 AND REFLECTS SITE CONDITIONS AS OF THAT DATE.
3. THE SURVEY IS REFERENCED TO THE NORTH CAROLINA STATE PLANE COORDINATE SYSTEM (NCSPOS), NORTH AMERICAN DATUM, 1983, 2011 ADJUSTMENT, NAD83(2011).
4. ALL DISTANCES ARE HORIZONTAL GROUND USING PROJECT COORDINATES THAT APPROXIMATE NORTH CAROLINA STATE PLANE COORDINATES. COMBINED SCALE FACTOR = 0.9999223051 AND PROJECT SCALE POINT = NORTHING(Y) 770,800 EASTING(X) 2,147,500
5. ELEVATIONS ARE BASED ON NAVD83 DATUM.
6. THE SUBJECT PROPERTY IS LOCATED IN FLOOD ZONE X, AREA OF ANNUAL FLOODING, AND FLOOD ZONE AE, AREA WITH BASE FLOOD ELEVATIONS DETERMINED, AS SHOWN ON NATIONAL FLOOD INSURANCE RATE MAP (FIRM), WAKE COUNTY, NORTH CAROLINA, PANEL 17472, MAP NO. 3720174700A, EFFECTIVE DATE: MAY 2, 2006.
7. LENNAR TITLE, LLC, TITLE COMMITMENT NO. 189011-006698-NC, WITH AN EFFECTIVE DATE OF SEPTEMBER 10, 2020 AT 8:00 A.M. WAS USED IN THE PREPARATION OF THIS SURVEY.

NOTE: ALL SANITARY SEWER LINES ARE 8" PVC

SANITARY SEWER	STORM DRAIN	EASEMENTS
<p>121 208.61 RM 199.60 INV IN (E) 199.66 INV OUT (N)</p> <p>122 213.28 RM 205.13 INV IN (E) 204.99 INV OUT (N)</p> <p>123 220.36 RM 212.79 INV IN (N) 212.76 INV IN (S) 212.63 INV IN (E) 212.48 INV OUT (W)</p> <p>124 219.33 RM 214.68 INV OUT (N)</p> <p>125 234.41 RM 223.40 INV IN (N) 223.35 INV OUT (W)</p> <p>126 251.30 RM 242.65 INV IN (S) 241.66 INV IN (E) 241.59 INV OUT (N)</p> <p>127 254.38 RM 244.78 INV OUT (N)</p> <p>128 254.00 RM 246.90 INV IN (E) 243.46 INV IN (N) 243.42 INV OUT (W)</p> <p>129 263.66 RM 257.64 INV IN (E) 267.56 INV OUT (W)</p> <p>130 278.09 RM 268.41 INV IN (E) 266.28 INV IN (N) 266.21 INV OUT (W)</p> <p>131 284.38 RM 277.68 INV IN (E) 277.63 INV OUT (W)</p> <p>132 292.50 RM 283.24 INV IN (E) 283.31 INV OUT (N)</p> <p>133 298.06 RM 291.41 INV OUT (N)</p>	<p>1 15" RCP 264.21 INV IN (N) 263.77 INV OUT (S)</p> <p>2 15" RCP 265.15 INV IN (N) 264.36 INV OUT (S)</p> <p>3 18" RCP 274.28 INV IN (N) 273.49 INV OUT (S)</p> <p>4 18" RCP 280.25 INV IN (SE) 278.87 INV OUT (NW)</p> <p>5 15" RCP 282.90 INV IN (NE) 282.29 INV OUT (SW)</p> <p>6 12" RCP 284.05 INV IN (NE) 283.63 INV OUT (SW)</p> <p>7 15" RCP 286.29 INV IN (SW) 286.04 INV OUT (NE)</p> <p>8 18" RCP 285.09 INV IN (NW) 283.69 INV OUT (SE)</p> <p>9 15" RCP 287.01 INV IN (NE) 286.87 INV OUT (SW)</p> <p>10 15" RCP 289.15 INV IN (NE) 288.75 INV OUT (SW)</p> <p>11 15" RCP 298.54 INV IN (N) 295.36 INV OUT (S)</p> <p>12 18" RCP 298.72 INV IN (N) 298.41 INV OUT (S)</p>	<p>1 30' CPBL EASEMENT DB 2709 PG 329</p> <p>2 TIME WARNER ENTERTAINMENT EASEMENT DB 12725 PG 457</p> <p>3 30' CPBL EASEMENT DB 4600 PG 136 DB 3478 PG 953 DB 1943 PG 695</p> <p>4 30' CPBL EASEMENT DB 6085 PG 162</p> <p>5 CPBL EASEMENT ALONG POWER LINE DB 1467 PG 527 DB 539 PG 607 (WORTH NOT SPECIFIED)</p> <p>6 PRIVATE DRAINAGE EASEMENT BM 1999 PG 1870</p> <p>7 30' ACCESS EASEMENT DB 2704 PG 457 DB 3497 PG 86</p>

# AREA TABULATION

PIN#	NET (AC.)	GROSS (AC.)
1747-70-9196	2.893	3.393
1746-78-8664	0.109	0.180
1747-70-2102	26.742	26.742
1746-89-4842	17.574	18.329
1747-70-4639	1.690	1.783
1747-71-1222	35.164	35.320
1747-70-1824	19.105	19.240
TOTALS:	103.277	104.992

TOTAL NET ACREAGE ON WEST SIDE OF WATKINS TOWN ROAD: 88.311  
TOTAL NET ACREAGE ON EAST SIDE OF WATKINS TOWN ROAD: 14.686

# NOTE:

AREAS LISTED FOR PIN# 1746-89-4842 INCLUDE BOTH SIDES OF WATKINS TOWN ROAD.  
AREAS LISTED FOR PIN# 1747-71-1222 INCLUDE THE ENTIRE TAX PARCEL. THE PORTION EAST OF THE PROPOSED NEW PROPERTY LINE CONTAINS 2.488 GROSS ACRES AND 2.325 NET ACRES. THE PORTION WEST OF THE PROPOSED NEW PROPERTY LINE CONTAINS 32.839 ACRES.

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1747-70-9196	2.893	3.393
1746-78-8664	0.109	0.180
1747-70-2102	26.742	26.742
1746-89-4842	17.574	18.329
1747-70-4639	1.690	1.783
1747-71-1222	35.164	35.320
1747-70-1824	19.105	19.240
TOTALS:	103.277	104.992

# PROPERTY OWNER INFORMATION

<p>(A) DONALD L. ZEIGLER DB 4168 PG 0754 BM 1986 PG 2058 BM 2004 PG 2404 PIN# 1747804539</p> <p>(B) L. L. WATKINS &amp; FANNIE M. WATKINS (WATKINS FAMILY CEMETERY) DB 1328 PG 0130 DB 1482 PG 0592 BM 1997 PG 639 BM 2004 PG 2404 PIN# 1747805408</p> <p>(C) ROBERT WATKINS DUKE RONALD EDWARD DUKE &amp; ROGER DUKE DB 1328 PG 0130 DB 1482 PG 0592 BM 1997 PG 639 BM 2004 PG 2404 PIN# 1747805408</p> <p>(D) HILDA W. WATKINS DB 8628 PG 1022 PIN# 1746798864 (NO ADDRESS LISTED) 0.180 AC. (GROSS) 0.109 AC. (NET)</p> <p>(E) RANDOLPH H. WHITE &amp; BRENDA D. WHITE DB 2808 PG 0035 BM 1978 VOL. 8 PG 897 PIN# 1746795434</p> <p>(F) CHARLES MITCHELL GIBBS, III &amp; KENDRA CAMPBELL GIBBS DB 8494 PG 1138 BM 1998 PG 1381 PIN# 1747610782</p> <p>(G) LINDA ARMOUR DB 11884 PG 2733 BM 1998 PG 1381 PIN# 1747612613</p> <p>(H) TOMMY AUSTIN &amp; SUZANNE AUSTIN DB 5028 PG 1479 BM 1998 PG 1381 PIN# 1747613612</p> <p>(I) JEFFREY PETERSEN &amp; GRETCHEN PETERSEN DB 10843 PG 1362 BM 1998 PG 1381 PIN# 1747614500</p> <p>(J) JOHN D. BARRETT &amp; JENNIFER J. BARRETT DB 8303 PG 0367 BM 1998 PG 1381 PIN# 1747615579</p>	<p>(F6) STEPHEN GORDON RADFORD DB 14116 PG 2008 BM 1998 PG 1381 PIN# 1747616597</p> <p>(F7) JAMES M. STENBERSON &amp; KATHRYN C. STENBERSON DB 12870 PG 0001 BM 1998 PG 1381 PIN# 1747617298</p> <p>(G1) JOSEPH L. WHITNEY &amp; ROSEMARY A. WHITNEY DB 7875 PG 0231 BM 1997 PG 0849 PIN# 1747619515</p> <p>(G2) DINH HO &amp; HANNA HO DB 16824 PG 1928 BM 1997 PG 0849 PIN# 1747710073</p> <p>(G3) SUSAN GERTRUDE LEGATOWICZ DB 14280 PG 1714 BM 1997 PG 0849 PIN# 1747711562</p> <p>(G4) MARY J. DUNCAN DB 18318 PG 1938 BM 1997 PG 0849 PIN# 1747712580</p> <p>(G5) D.E. BORDEAUX DB 9839 PG 2703 BM 1997 PG 0849 PIN# 1747713478</p> <p>(G6) JOSHUA KEMP &amp; ELISHA KEMP DB 16457 PG 0024 BM 1997 PG 0849 PIN# 1747714477</p> <p>(H1) JOSETTE D. GREENE DB 14508 PG 2733 BM 1998 PG 1381 PIN# 1747715484</p> <p>(H2) GARRY D. O'NEILL &amp; MARY M. O'NEILL DB 8817 PG 1464 BM 1999 PG 1870 PIN# 1747716483</p> <p>(H3) BERNARD N. OKORORIE &amp; IFOMA C. OKORORIE DB 15527 PG 1674 BM 1999 PG 1870 PIN# 1747717471</p> <p>(H4) THOMAS E. SAVAGE &amp; PENNY C. SAVAGE DB 8503 PG 0367 BM 1999 PG 1870 PIN# 1747718480</p>	<p>(H5) DWIGHT ALLEN MYERS &amp; BUE ANNA MYERS DB 15670 PG 0751 BM 1999 PG 1870 PIN# 1747810336</p> <p>(H6) JEROME GLENN &amp; KAREN L. BRANNON-GLENN DB 8763 PG 0843 BM 1999 PG 1870 PIN# 1747811336</p> <p>(H7) MELISSA A. THORNTON DB 16358 PG 0318 BM 1999 PG 1870 PIN# 1747812325</p> <p>(H8) JACLYNN SZWAGIEL DB 17684 PG 1998 BM 1999 PG 1870 PIN# 1747813315</p> <p>(H9) RAYMOND J. BOYDEN &amp; KATHLEEN PICKAMONY DB 17681 PG 2408 BM 1999 PG 1870 PIN# 1747813394</p> <p>(J1) JESSE D. HERRERA &amp; CHRISTINA R. LEE-HERRERA DB 8811 PG 1578 BM 1999 PG 1870 PIN# 1747814373</p> <p>(J2) ALLEN G. JOHNSON &amp; MAKAYLA R. JOHNSON DB 18318 PG 1938 BM 1999 PG 1870 PIN# 1747815343</p> <p>(J3) AMANDA ISBOTT DB 15435 PG 0148 BM 1999 PG 1870 PIN# 1747816312</p> <p>(J4) STEPHEN B. SNOWDEN &amp; REBECCA LYNN SNOWDEN DB 13407 PG 2471 BM 1999 PG 1870 PIN# 1747816381</p> <p>(L) FERNANDO LUGO DB 13593 PG 2435 PIN# 1747818209</p> <p>(L1) LINDA WATKINS STELL DB 2332 PG 0239 PIN# 1747818131</p> <p>(L2) DONALD LAWRENCE ZEIGLER, TRUSTEE JAMES EDWARD MURRAY, TRUSTEE KEITH EARL MURRAY, TRUSTEE DB 11829 PG 1677 BM 2004 PG 2404 PIN# 1747807677</p>
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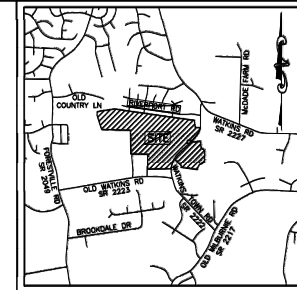
# CERTIFICATE OF SURVEY

I, MICHAEL W. ZIUDA, CERTIFY THAT THIS PROJECT WAS COMPLETED UNDER MY DIRECT AND RESPONSIBLE CHARGE FROM AN ACTUAL SURVEY MADE UNDER MY SUPERVISION. THAT THIS GROUND SURVEY WAS PERFORMED AT THE 95% CONFIDENCE LEVEL TO MEET FEDERAL GEOGRAPHIC DATA COMMITTEE STANDARDS; THAT THIS SURVEY WAS PERFORMED TO MEET THE REQUIREMENTS FOR A TOPOGRAPHIC/PLANNIMETRIC SURVEY TO THE ACCURACY OF CLASS "A" AND VERTICAL ACCURACY WHEN APPLICABLE TO THE CLASS "C" STANDARD, AND THAT THE ORIGINAL DATA WAS OBTAINED ON FEBRUARY 15, 2021; THAT THE SURVEY WAS COMPLETED ON DECEMBER 20, 2021; AND ALL COORDINATES ARE BASED ON "NAD 83" AND REALIZATION 2011 AND ALL ELEVATIONS ARE BASED ON NAVD 88.

I CERTIFY THAT THIS MAP WAS DRAWN UNDER MY SUPERVISION FROM AN ACTUAL SURVEY MADE UNDER MY SUPERVISION BASED ON THE DEEDS AND PLATS REFERENCED HEREON; THAT THE ADJOINING BOUNDARIES NOT SURVEYED ARE INDICATED AS DRAWN FROM THE DEEDS AND PLATS REFERENCED HEREON; THAT THE RATIO OF PRECISION IS 1:18,300; AND THAT THIS MAP MEETS THE REQUIREMENTS OF THE STANDARDS OF PRACTICE FOR LAND SURVEYING IN NORTH CAROLINA (21 NCAC 06-1600).

THIS \_\_\_\_\_ DAY OF \_\_\_\_\_, \_\_\_\_\_.

MICHAEL W. ZIUDA  
PLS# L-5205



VICINITY MAP  
SCALE: 1"=200'

- LEGEND
- FOUNDED CONCRETE MONUMENT
  - FOUNDED IRON PIPE
  - FOUNDED MONUMENT AS NOTED
  - IPB - IRON PIN SET
  - DIMENSION POINT (NOTHING SET)

- C&G CURB AND GUTTER
- CP&L CAROLINA POWER AND LIGHT COMPANY
- CPP CORRUGATED PLASTIC PIPE
- RCP REINFORCED CONCRETE PIPE
- R/W RIGHT OF WAY

- TV CABLE TV RISER
- TELEPHONE RISER
- ELECTRIC METER
- LIGHT POLE
- POWER POLE
- GUY WIRE
- SANITARY SEWER MANHOLE
- FIRE HYDRANT
- WATER MANHOLE
- WATER VALVE
- IRRIGATION VALVE
- WELL

- WETLAND FLAG (W/FLAG #)
- EASEMENT KEYNOTE - SEE SHEET 1
- SANITARY SEWER KEYNOTE - SEE SHEET 1
- STORM DRAIN KEYNOTE - SEE SHEET 1
- FENCE
- OVERHEAD ELECTRIC LINE
- SANITARY SEWER LINE
- EDGE OF WATER
- TREE LINE

**JMT**

9201 ARBORETUM PARKWAY, SUITE 310 | RICHMOND, VA 23236  
P: (804) 323-8800 | F: (804) 323-2696 | www.jmt.com

REVISION # DATE REASON FOR REVISION

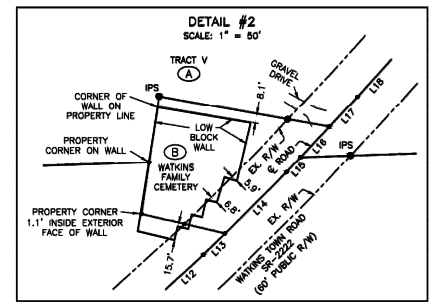
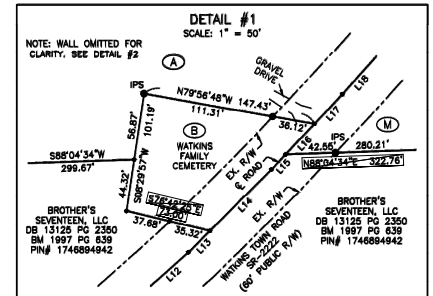
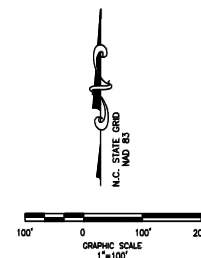
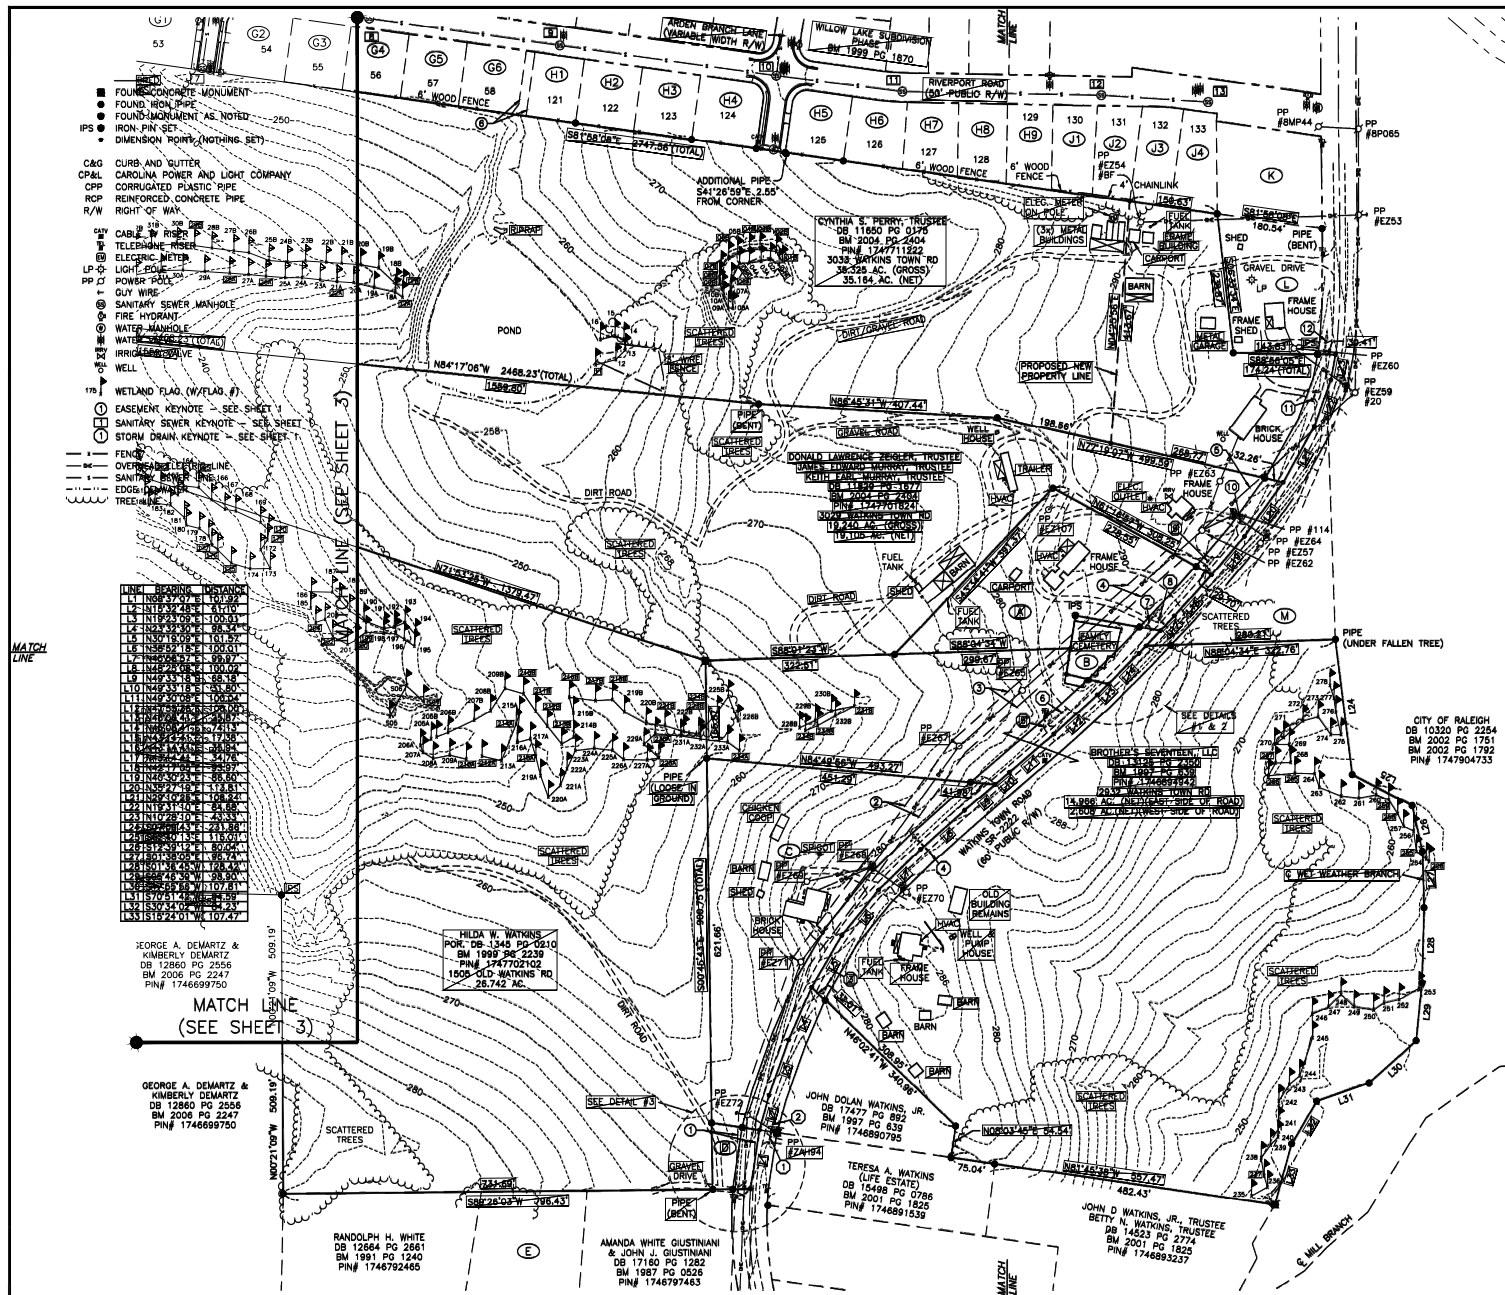
# BOUNDARY & TOPOGRAPHIC SURVEY

PREPARED FOR  
LENNAR CAROLINAS, LLC  
EVERLEE SUBDIVISION

WAKE FOREST TOWNSHIP, WAKE COUNTY, NORTH CAROLINA

DRAWN BY: JZ PROJECT: JMT# 20-05848-002  
CHECKED BY: MWZ CONTRACTOR: JMT# 20-05848-002  
DATE: 01/22/2021 SCALE: 1"=100' SHEET 1 OF 3





**JMT**

6201 ARBORETRUM PARKWAY, SUITE 310 | RICHMOND, VA 23236  
P: (804) 323-9600 | F: (804) 323-9599 | www.jmt.com

REVISION #	DATE	REASON FOR REVISION

**BOUNDARY & TOPOGRAPHIC SURVEY**  
PREPARED FOR  
LENNAR CAROLINAS, LLC  
EVERLEE SUBDIVISION  
WAKE FOREST TOWNSHIP, WAKE COUNTY, NORTH CAROLINA

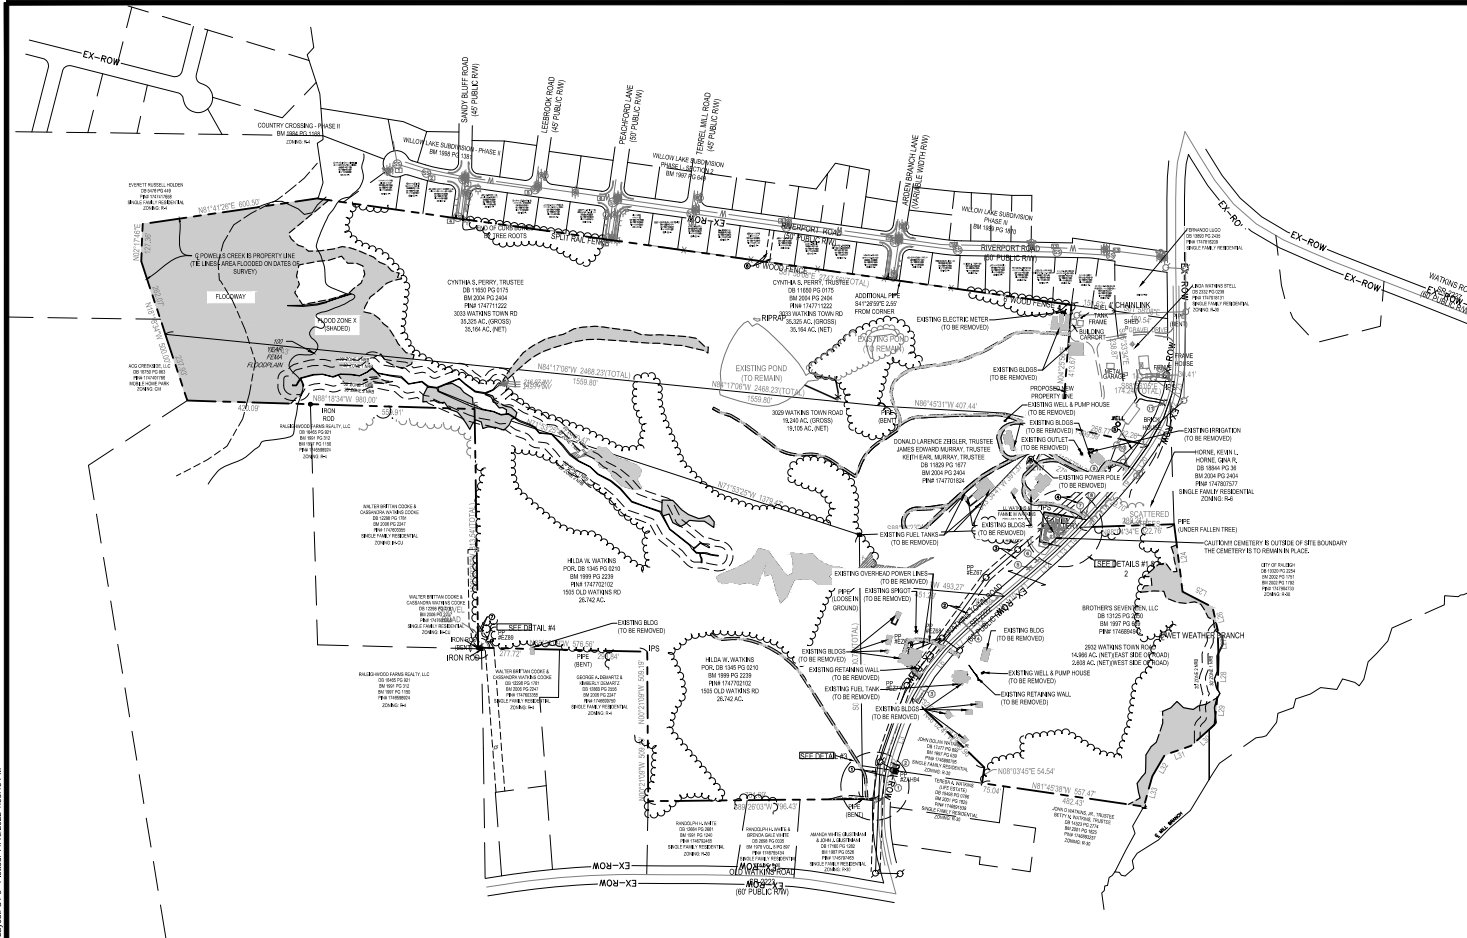
DRAWN BY: JMT  
CHECKED BY: MJK  
DATE: 01/22/2021  
SCALE: 1"=100'

PROJECT: JMT# 20-03949-002  
CONTRACT: 20-03949-002  
SHEET 2 OF 3









NO TEMPORARY OR PERMANENT ENCROACHMENTS INCLUDING BUT NOT LIMITED TO CLEARING, GRADING, FENCING, AND THE INSTALLATION OF RETAINING WALLS OR OTHER STRUCTURES ARE PERMITTED WITHIN THE GREENWAY EASEMENT AREA WITHOUT PRIOR APPROVAL BY THE CITY OF RALEIGH.

- DEMOLITION NOTES:**
1. ALL WORK SHALL BE IN ACCORDANCE WITH CITY OF RALEIGH STANDARDS AND SPECIFICATIONS.
  2. THE CONTRACTOR SHALL COORDINATE ALL REMOVAL EFFORTS WITH THE OWNER PRIOR TO COMMENCING WORK.
  3. SPECIAL CARE SHALL BE TAKEN TO PROTECT AND MAINTAIN ALL EXISTING FEATURES INCLUDING BELOW GROUND, NOT MARKED FOR REMOVAL, IN THE EVENT OF ANY IMPACT TO SUCH FEATURES, THE CONTRACTOR SHALL PERFORM REPAIR AND/OR RESTORE TO ORIGINAL CONDITION AS OF START OF WORK.
  4. NO DEMOLITION DEBRIS IS TO BE STORED ON SITE. ALL DEMOLITION MATERIAL TO BE PROMPTLY REMOVED FROM THE SITE OR PLACED IN APPROPRIATE CONTAINERS.
  5. TRAFFIC CONTROL IS CONTRACTOR'S RESPONSIBILITY.
  6. SAWCUT DIRTING ASPHALT AT LOCATION SHOWN ON PLANS.
  7. SITE DEMOLITION SEQUENCE TO BE PROVIDED BY THE CONTRACTOR.
  8. THE CONTRACTOR SHALL OBTAIN A RIGHT-OF-WAY PERMIT FOR ANY WORK WHICH REQUIRES THE CLOSURE OF A TRAVEL LANE AND/OR SIDEWALK FROM THE TRANSPORTATION OPERATION DIVISION/PUBLIC WORKS DEPARTMENT.
  9. ALL SIDEWALKS MUST BE ACCESSIBLE TO PERSONS WHO ARE BLIND, HAVE LOW VISION AND PEOPLE WITH MOBILITY DISABILITIES. PEDESTRIAN EXISTING ROUTES AND ALTERNATE PEDESTRIAN ROUTES DURING CONSTRUCTION WILL BE REQUIRED TO BE COMPLIANT WITH THE PUBLIC RIGHTS OF WAY ACCESSIBILITY GUIDELINES (IPWAG), 2010 ADA STANDARDS FOR ACCESSIBLE DESIGN AND THE MANUAL ON UNIFORM TRAFFIC CONTROL DEVICES (MUTCD).
  10. IF UNFORESEEN CONDITIONS DEVELOP DURING CONSTRUCTION, REFER TO "CITY OF RALEIGH STREET DESIGN MANUAL" AND CONTACT PUBLIC WORKS DEPARTMENT FOR FURTHER GUIDANCE.
  11. PRIOR TO START OF CONSTRUCTION, THE CONTRACTOR SHALL SCHEDULE A PRE-CONSTRUCTION MEETING WITH THE CITY OF RALEIGH PUBLIC WORKS DEPARTMENT / TRANSPORTATION FIELD SERVICES STAFF TO REVIEW THE SPECIFIC COMPONENTS OF THE PLAN AND OPERATION OF THESE FACILITIES DURING CONSTRUCTION. CONTACT ENGINEERING INSPECTIONS AT 919.996.2409 TO SET UP THE MEETING.
  12. THE CONTRACTOR SHALL CONDUCT THE WORK IN A SAFE MANNER AND WITH A MINIMUM AMOUNT OF INTERFERENCE TO TRAFFIC.
  13. THE CONTRACTOR SHALL BE RESPONSIBLE FOR ALL TRAFFIC CONTROL AND SHALL ADHERE TO THE PROVISIONS OF THE MUTCD (MOST CURRENT EDITION). ANY TEMPORARY STREET CLOSURE MUST BE SUBMITTED A MINIMUM OF 2 WEEKS PRIOR TO THE START OF WORK. SEE "RIGHT-OF-WAY CLOSURES" ON [WWW.RALEIGHNC.GOV](http://WWW.RALEIGHNC.GOV), COMPLETE AND SEND THE RIGHT-OF-WAY OBSTRUCTION PERMIT TO [RIGHTOFWAYPERMITS@RALEIGHNC.GOV](mailto:RIGHTOFWAYPERMITS@RALEIGHNC.GOV).
  14. PRIOR TO CONSTRUCTION BEGINNINGS, ALL SIGNAGE AND TRAFFIC CONTROL SHALL BE IN PLACE.
  15. CONTRACTOR IS EXPLICITLY ADVISED TO FIELD LOCATE AND VERIFY LOCATION OF ALL EXISTING UTILITIES PRIOR TO CONSTRUCTION. LOCATION OF EXISTING UNDERGROUND UTILITIES SHOWN ON PLANS IS APPROXIMATE BASED ON BEST AVAILABLE INFORMATION AND SHOULD BE CONSIDERED APPROXIMATE.
  16. CONTRACTOR TO REPORT ANY DISCREPANCIES TO LANDSCAPE ARCHITECTURAL ENGINEER PRIOR TO ANY CONSTRUCTION ACTIVITIES. CONTACT NC ONE AT 811 FOR FIELD LOCATION OF UNDERGROUND UTILITIES.
  17. ALL SURVEY INFORMATION PROVIDED TO BUREAU OF RALEIGH NORTH CAROLINA OFFICE BY ENR IN DIGITAL FORMAT IN MARCH 2021, AND SUPPLEMENTAL INFORMATION WAS OBTAINED FROM WAKE COUNTY GIS IN JUNE 2021. CONTRACTOR SHALL COORDINATE WITH NC ONE FOR ANY WELLS TO BE REMOVED/CAPPED IN ORDER TO TRANSITION THEM TO INACTIVE STATUS.

DEMOLITION LEGEND	
	REMOVE BUILDING
	REMOVE DRIVEWAY
	REMOVE DIRT ROAD
	WETLANDS
	REMOVE OVERHEAD ELECTRIC LINE
	REMOVE STORM DRAINAGE
	REMOVE FENCE
	TREE PROTECTION FENCE
	LIMITS OF DISTURBANCE
	COORDINATE LIGHT POLE REMOVAL STRUCTURE
	REMOVE TREE LINE
	REMOVE SIGN

**ATTENTION CONTRACTORS**

The Construction Contractor responsible for the extension of water, sewer, and/or gas, as approved in these plans, is responsible for contacting the **Public Works Department** at (919) 996-2409 and the **Public Utilities Department** at (919) 996-2409 at least twenty four hours prior to beginning any of their construction.

Failure to notify both City Departments in advance of beginning construction, will result in the issuance of monetary fines, and require consultation of any water or sewer facilities not impacted as a result of this notification failure.

Failure to call for inspection, install a Downstream Plug, have Permitted Plans on the jobsite, or any other Violation of City of Raleigh Standards will result in a Fine and Possible Exclusion from future work in the City of Raleigh.



Know what's below.  
Call before you dig.

10/4/2022	CITY OF RALEIGH COMMENTS - THIRD REVIEW
7/22/2022	CITY OF RALEIGH COMMENTS - SECOND REVIEW
3/16/2022	CITY OF RALEIGH COMMENTS - FIRST REVIEW
DATE	DESIGNER
DESIGNED BY:	WTWAP
DRAWN BY:	CDIAP
REVIEWED BY:	JDU
1100 PERIMETER PARK DRIVE, SUITE 112 MONROEVILLE, NC 27060	LENAR CORPORATION
PHASE 1 SUBMITTAL PLAN	EVERLEE SUBDIVISION
WATKINS CREEK ROAD RALEIGH, NC 27606	DEMOLITION PLAN
FILE NUMBER: 8430-00	DATE: 11/16/2022
C1-3	



[illegible][illegible]

<u><b>TREE CONSERVATION AREA DATA</b></u>	
TOTAL ACREAGE	104.98 ACRES (4,573,451.52 SF)
NET SITE ACRES (ACRES)	86.68 ACRES (3,775,687.52 SF)
THREE SAVE REQUIRED (ACRES)	8.67 ACRES (10% OF NET SITE AREA) (377,665.20 SF)
TREE SAVE PROVIDED (ACRES)	12.39 ACRES (14.30% OF NET SITE AREA) (530,708.40 SF)

<p align="center"><b>USPS MAIL DELIVERY</b></p> <p>MAIL DELIVERY SERVICES AND LOCATION OF CUSTOMER BOX DUMP IS BEING APPROVED FOR SUBSCRIPTION ON AUGUST 1, 2022 BY CITY OF PALMDALE POSTMASTERS OFFICE</p>
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<u><b>OPEN SPACE SITE DATA</b></u>	
TOTAL ACREAGE	104.98 ACRES (4,573,451.52 SF)
NET SITE ACRES (ACRES)	86.68 ACRES (3,775,687.52 SF)
OPEN SPACE REQUIRED (ACRES)	41.99 ACRES (40% OF TOTAL SITE AREA) (1,829,084.00 SF)
OPEN SPACE PROVIDED (ACRES)	54.60 ACRES (62.89% OF TOTAL SITE AREA) (2,378,444.52 SF)

STREET TABLE			
STREET NAME	TYPE	ROW WIDTH	BOC-BOC WIDTH
LAUREL FOND WAY	NEIGHBORHOOD VELO	55'-0"	27'-0"
GOLDEN ASH HWY	NEIGHBORHOOD VELO	55'-0"	27'-0"
YELLOW BEECH DRIVE	NEIGHBORHOOD VELO	55'-0"	27'-0"
CEDAR ELM LANE	NEIGHBORHOOD VELO	55'-0"	27'-0"
PEACHFORD LANE	NEIGHBORHOOD LOCAL	58'-0"	31'-0"
BLUE JACK LANE	NEIGHBORHOOD VELO	55'-0"	27'-0"
GRAY ALDER LANE	NEIGHBORHOOD VELO	55'-0"	27'-0"
GRANITE BRANCH LANE	NEIGHBORHOOD LOCAL	58'-0"	31'-0"
HICKORY DRIVE	NEIGHBORHOOD LOCAL	58'-0"	31'-0"
VASEY OAK DRIVE	NEIGHBORHOOD LOCAL	58'-0"	31'-0"
SANDY BLUFF ROAD	NEIGHBORHOOD VELO	55'-0"	27'-0"

[illegible]

ADJOINING PROPERTY TABLE				
#	OWNER	PH	CD, BEM PS	PRIORITY USE
1	THOMAS R. SWANE & PENT C. SWANE	17/07/0600	CD 000 002 000 000	SINGLE FAMILY
2	HOCH REIS INC	17/07/0600	CD 000 002 000 000	SINGLE FAMILY
3	PROGRESS INVESTORS LLC	17/07/0100	CD 000 002 000 000	SINGLE FAMILY
4	MEUBSA A. THORNTON	17/07/0100	CD 000 002 000 000	SINGLE FAMILY
5	JACLYN DEWEEL	17/07/0100	CD 000 002 000 000	SINGLE FAMILY
6	MOH DUBOWITZ INC	17/07/0100	CD 000 002 000 000	SINGLE FAMILY
7	JESSIE E. HENNING & CHRISTINE M. HENNING	17/07/0100	CD 000 002 000 000	SINGLE FAMILY
8	AILEEN K. JOHNSON & KIMBERLY A. JOHNSON	17/07/0100	CD 000 002 000 000	SINGLE FAMILY
9	STANLEY B. BROWER	17/07/0100	CD 000 002 000 000	SINGLE FAMILY
10	ALAN H. BUCHHEIT & REBECCA L. BUCHHEIT	17/07/0100	CD 000 002 000 000	SINGLE FAMILY
11	BERNARD L. JOHNSON	17/07/0100	CD 000 002 000 000	SINGLE FAMILY
12	KEVIN HORN & JANA R. HORN	17/07/0100	CD 000 002 000 000	MOBILE HOME

COMMON ABBREVIATION	
R/W	RIGHT-OF-WAY
B-B	BACK-TO-CURB TO BACK-TO-CURB
S/D/T	SIGHT-DISTANCE TRIANGLE
SDE	SIDE ACCESS, INTERFERENCE, AND OBSTRUCTION ASSESSMENT
RXX	RADIAL DIVERSION
SCM	STOPWATCHER CONTROL MEASURE (REF. PAGE)

0 100' 200' 300' 400'

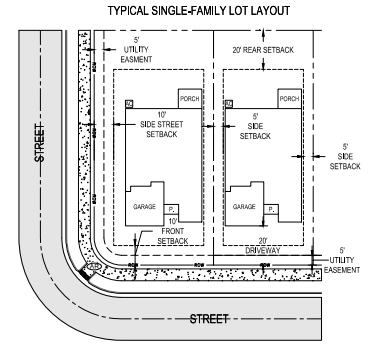
SCALE: 1" = 10'

**811**

Know what's below.  
Call before you dig.

	<b>CONSTRUCTION</b>	C3-0
	FILE NUMBER: 8430-00	DATE:11/16/2022
	<b>OVERALL SITE PLAN</b>	
	<b>EVERLEE SUBDIVISION</b> PRELIMINARY SUBDIVISION PLAN  WATKINS TOWN ROAD RALEIGH / NC 27616	
	<b>LENNAR CORPORATION</b>  1100 PERimeter PARK DRIVE, SUITE 112 MORRISVILLE / NC 27560	
	 6440 WALKER RD., SUITE 102 WWW.BGEC.COM NO LICENSE #C-4597 @2022	
DESIGNED BY:	TWAP	
DRAWN BY:	CD/AP	
REVIEWED BY:	JDU	
		CITY OF RALEIGH COMMENTS - THIRD REVIEW 10/4/2022
		CITY OF RALEIGH COMMENTS - SECOND REVIEW 7/22/2022
		CITY OF RALEIGH COMMENTS - FIRST REVIEW 3/18/2022
	REV	DATE DESCRIPTION





GENERAL NOTES:




1. NO TEMPORARY OR PERMANENT ENCROACHMENTS (INCLUDING BUT NOT LIMITED TO CLEARING, GRADING, FENCING, AND THE INSTALLATION OF RETAINING WALLS OR OTHER STRUCTURES) ARE PERMITTED WITHIN THE GREENWAY EASEMENT AREA WITHOUT PRIOR APPROVAL BY THE CITY OF RALPHIA.

## **ATTENTION CONTRACTORS**

The *Construction Contractor* responsible for the extension of water, sewer and/or storm, as approved in these terms, is responsible for contacting the **Public Works Department** at (919) 996-2409, and the **Public Utilities Department** at (919) 996-4340 at least twenty four hours prior to beginning any of their construction.

**Failure** to notify both City Departments in advance of beginning construction, will result in the issuance of monetary fines, and require reinstallation of any water or sewer facilities not inspected as a result of this notification failure.

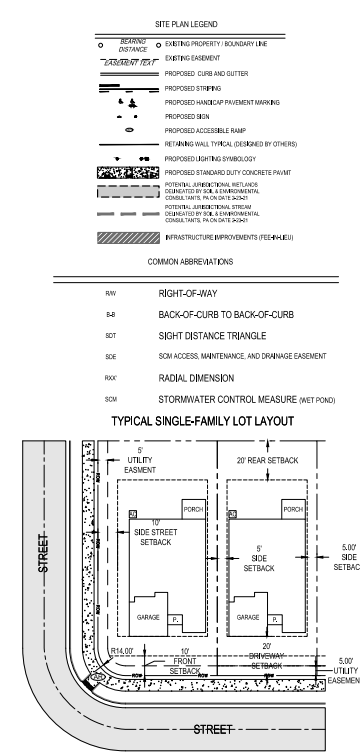
**Failure** to call for Inspection, *Install a Downstream City, have Permitted Plans on the Jobsite, or any other Violation of City of Raleigh Standards* will result in a *Fine and Possible Exclusion* from future work in the City of Raleigh.

<div> <div>  <div> <div>EVERLEE</div> <div>SUBDIVISION</div> <div>PRELIMINARY SUBDIVISION PLAN</div> </div> </div> <div> <div>ENLARGED SITE PLAN</div> <div>(1 OF 5)</div> </div> </div>		<div> <div>  <div> <div>LENNAR</div> <div>CORPORATION</div> </div> </div> <div> <div>1100 PEWEEBERRY PARK DRIVE, SUITE 112</div> <div>RALEIGH, NC 27606</div> <div>WWW.LENNAR.COM</div> </div> </div>		<div> <div>  <div> <div>BGE</div> <div>5440 WAVER PARK BLVD, SUITE 102</div> <div>RALEIGH, NC 27606</div> <div>WWW.BGE.COM</div> <div>NC LICENSE #C-4387</div> </div> </div> <div> <div>DESIGNED BY:</div> <div>TWNP</div> </div> <div> <div>DRAWN BY:</div> <div>CDAP</div> </div> <div> <div>REVIEWED BY:</div> <div>JDJ</div> </div> </div>		<div> <div> <div> <div>10/4/2022</div> <div>CITY OF RALEIGH COMMENTS - THIRD REVIEW</div> </div> <div> <div>7/22/2022</div> <div>CITY OF RALEIGH COMMENTS - SECOND REVIEW</div> </div> <div> <div>3/18/2022</div> <div>CITY OF RALEIGH COMMENTS - FIRST REVIEW</div> </div> </div> <div> <div>REVISION DATE</div> <div>DESCRIPTION</div> </div> </div>	
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### TRAFFIC IMPACT ANALYSIS NOTES PER RAMEY KEMP ASSOCIATES

<b><u>WESTINGHOUSE CONTROLLED AND SETI DRIVE (1) SETI DRIVE (1)</u></b>
1. PROHIBIT EASTBOUND APPROACH WITH ONE (1) BUSINESS LANE AND ONE (1) EXPRESS LANE.
2. PROHIBIT WESTBOUND APPROACH WITH ONE (1) BUSINESS LANE AND ONE (1) EXPRESS LANE.
3. PROHIBIT EASTBOUND APPROACH WITH ONE (1) BUSINESS LANE AND ONE (1) EXPRESS LANE.
4. PROVIDE STOP-CONTROL FOR THE EASTBOUND AND THE WESTBOUND APPROACHES.
5. PROVIDE AN EXCLUSIVE NORTHBOUND LEFT-LANE WITH A MINIMUM OF 80 FEET OF STORAGE AND APPROPRIATE DECELERATION AND TAPER.
6. PROVIDE AN EXCLUSIVE SOUTHBOUND LEFT-LANE WITH A MINIMUM OF 80 FEET OF STORAGE AND APPROPRIATE DECELERATION AND TAPER.
<b><u>WESTINGHOUSE CONTROLLED AND SETI DRIVE (1) SETI DRIVE (1)</u></b>
1. PROHIBIT WESTBOUND APPROACH WITH ONE (1) BUSINESS LANE AND ONE (1) EXPRESS LANE.
2. PROVIDE STOP-CONTROL FOR THE EASTBOUND APPROACH.
<b><u>WESTINGHOUSE CONTROLLED AND SETI DRIVE (1) SETI DRIVE (1)</u></b>
1. PROHIBIT EASTBOUND APPROACH WITH ONE (1) BUSINESS LANE AND ONE (1) EXPRESS LANE.
2. PROVIDE STOP-CONTROL FOR THE EASTBOUND APPROACH.

5. NO TEMPORARY OR PERMANENT ENCROACHMENTS (INCLUDING BUT NOT LIMITED TO CLEARING, GRADING, FENCING, AND THE INSTALLATION OF RETAINING WALLS OR OTHER STRUCTURES) ARE PERMITTED WITHIN THE GREENWAY EASEMENT AREA WITHOUT PRIOR APPROVAL BY THE CITY OF RALEIGH.



NO TEMPORARY OR PERMANENT ENCROACHMENTS (INCLUDING BUT NOT LIMITED TO CLEARING, GRADING, FENCING, AND THE INSTALLATION OF RETAINING WALLS OR OTHER STRUCTURES) ARE PERMITTED WITHIN THE GREENWAY EASEMENT AREA WITHOUT PRIOR APPROVAL BY THE CITY OF RALEIGH.


The *Construction Contractor* responsible for the extension of water, sewer, and/or reuse, as approved in these plans, is responsible for contacting the **Public Works Department** at (919) 996-2409, or the **Public Utilities Department** at (919) 996-4540 at least twenty-four hours prior to beginning any of their construction.

**Failure** to notify both City Departments in advance of beginning construction, will result in the issuance of monetary fines, and require reinstatement of any water or sewer facilities not inspected as a result of this notification failure.

**Failure** to call for Inspection, Install a Downstream Plug, have Permitted Plans on the Jobsite, or any other Violation of City of Raleigh Standards will result in a Fine and Possible Exclusion from future work in the City of Raleigh.

ENLARGED SITE PLAN (3 OF 5)		EVERLEE SUBDIVISION PRELIMINARY SUBDIVISION PLAN		LENNAR CORPORATION		 5440 WALKER PARK DRIVE, SUITE 102 RALEIGH NC 27607 WWW.BGECOM.COM		DESIGNED BY: TWA/AA DRAWN BY: CD/AD REVIEWED BY: JDU		CITY OF RALEIGH COMMENTS - THIRD REVIEW 10/14/2022 CITY OF RALEIGH COMMENTS - SECOND REVIEW 7/22/2022 CITY OF RALEIGH COMMENTS - FIRST REVIEW 3/18/2022
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The diagram illustrates a corner lot with the following setbacks and easements:

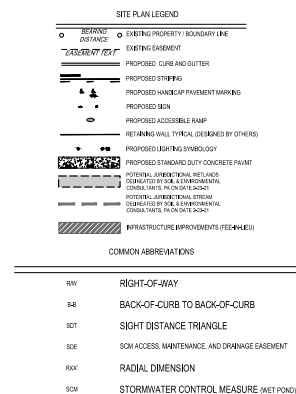- Utility Easement:** 6' along the top and right boundaries.
- Side Street Setback:** 10' along the left boundary.
- 20' Rear Setback:** 20' along the top boundary.
- 5' Side Setback:** 5' along the right boundary.
- Front Setback:** 30' along the bottom boundary.
- Utility Easement:** 5.00' along the bottom boundary.

The lot contains a **Garage** and a **Porch**. The diagram also shows a **14.00' 30'** dimension for the front setback area and a **20' SIDEWALK** area.

Diagram illustrating a building footprint with setbacks and setbacks. The diagram shows a building layout with setbacks and setbacks. Key features include:

- 10' SIDE STREET SETBACK**: Setback from the side street.
- 10' INTERNAL BUILDING SEPARATION SETBACK**: Setback between buildings.
- 20' MIN**: Minimum setback.
- 3' (TYP)**: Typical setback.
- SCREEN PORCH**: Screened porch area.
- GARAGE**: Garage area.
- FRONT SETBACK**: Front setback.
- 20' MINIMUM SETBACK**: Minimum setback.
- STREET**: The street in front of the building.
- PUE**: Public Use Easement line.
- RTA**: Right of Way line.

1. NO TEMPORARY OR PERMANENT ENCROACHMENTS (INCLUDING BUT NOT LIMITED TO CLEARING, GRADING, FENCING, AND THE INSTALLATION OF RETAINING WALLS OR OTHER STRUCTURES) ARE PERMITTED WITHIN THE GREENWAY EASEMENT AREA WITHOUT PRIOR APPROVAL BY THE CITY OF RALEIGH.



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**Failure** to notify both *City Departments* in advance of beginning construction, will result in the issuance of *monetary fines*, and require reinstallation of any water or sewer facilities not inspected as a result of this notification failure.

**Failure** to call for Inspection, Install a Downstream Plug, have Permitted Plans on the Jobsite, or any other Violation of City of Raleigh Standards will result in a Fine and Possible Exclusion from future work in the City of Raleigh.

CONSTRUCTION  
FILE NUMBER:  
8430-00  
DATE:11/16/2022

C3-4

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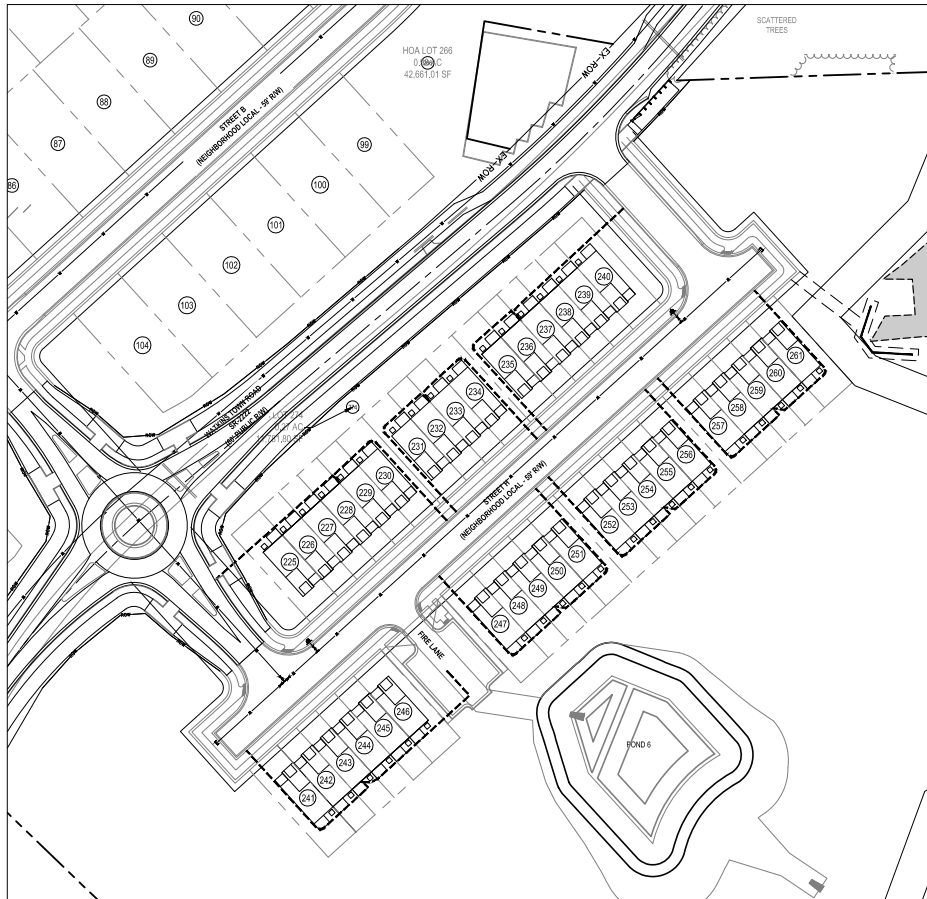




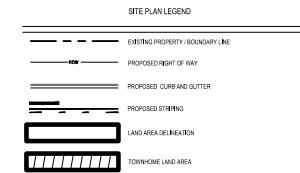
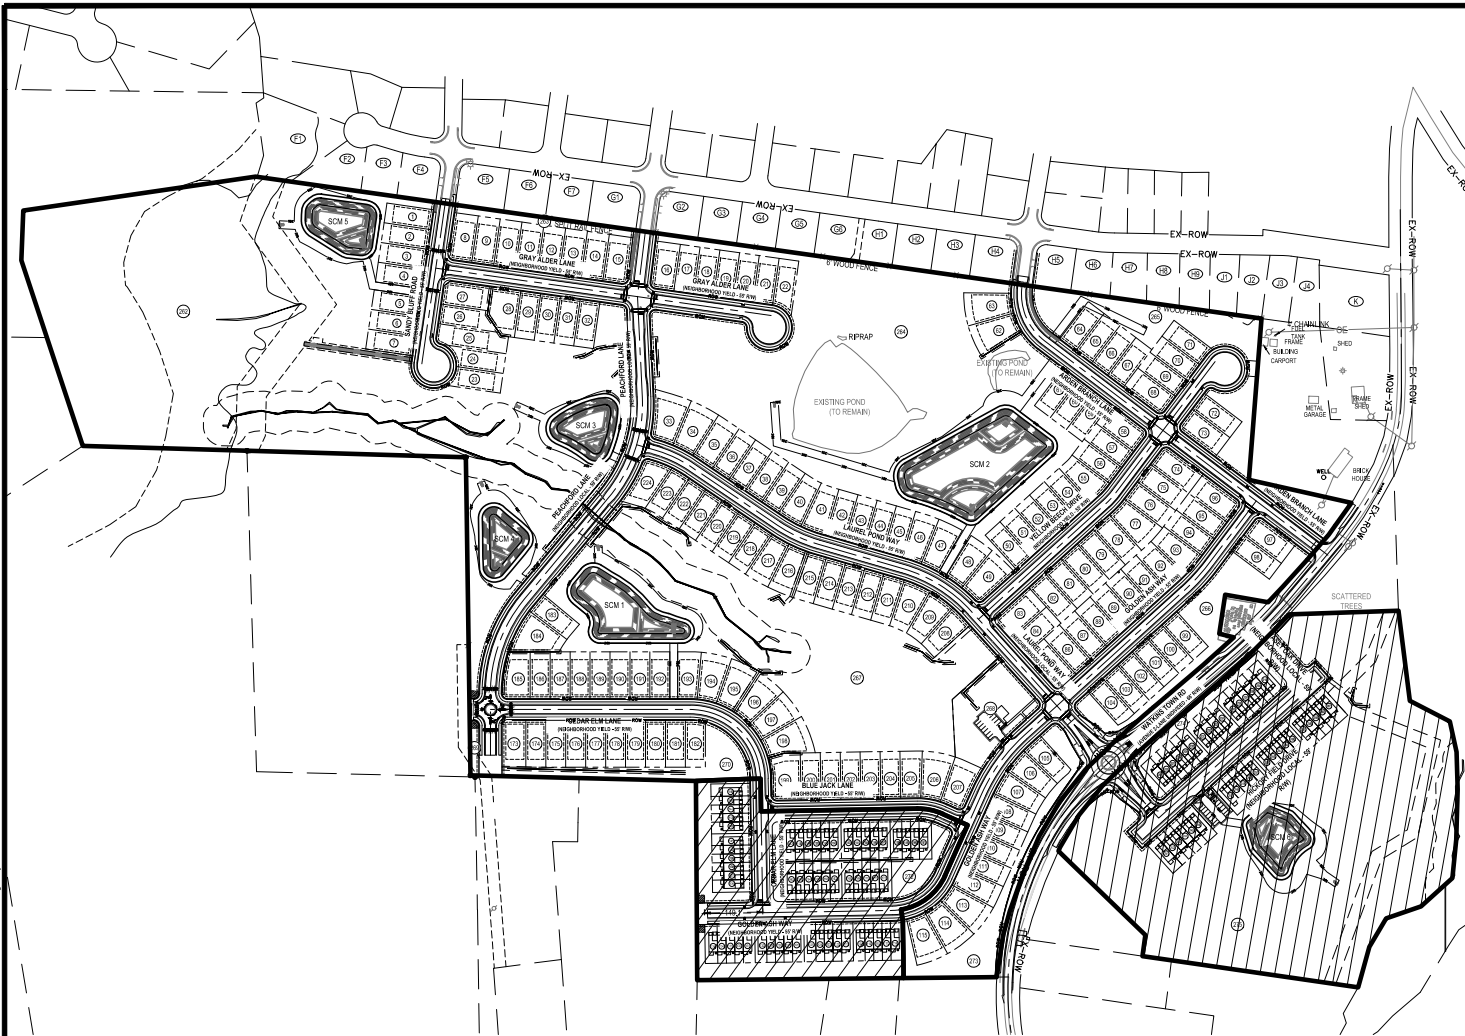


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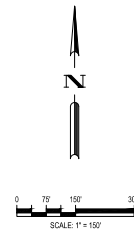
- RESIDENTIAL
- FIRE HYDRANT SHALL BE SPACED NOT MORE THAN 600' ALONG NAMED ROADS. ALTERNATE SIDES ON DIVIDED ROADS.
  - FIRE HYDRANTS SHALL BE AT EVERY NAMED STREET INTERSECTION.
  - ADDITIONAL FIRE HYDRANTS MAY BE REQUIRED BY FIRE DEPARTMENT.
- FIRE DEPARTMENT VEHICLE ACCESS
- ALL BUILDINGS AND FACILITIES SHALL REQUIRE FIRE DEPARTMENT VEHICLE ACCESS COMPLYING WITH NORTH CAROLINA FIRE PREVENTION CODE (NCFPC), CHAPTER 6, AND ALL CITY ORDINANCES AND ORDINANCES. SOME EXAMPLES ARE SHOWN IN APPENDIX D OF NCFPC.
  - MINIMUM UNRESTRICTED STREET WIDTH OF 30 FEET BACK TO BACK CURB MUST BE MAINTAINED THE ENTIRE TRAVEL ROUTE OF THE FIRE TRUCK. ENTRANCES, GATED ENTRANCES, ISLANDS, AND TRAFFIC CIRCLES ARE OF SPECIAL CONCERN. SEE ALTERNATIVE ACCESS FOR ENTRIES WITH GUARD SHADES (FP-29).
  - MINIMUM RIGHT TURNING RADIUS OF 30 FEET MUST BE MAINTAINED THROUGHOUT THE SITE PLAN FOR ANY ACCESS Lanes THAT WOULD COMMONLY BE USED BY FIRE APPARATUS.
  - FIRE DEPARTMENT ACCESS Lanes MUST ALLOW FIRE APPARATUS TO DRIVE WITHIN 100 FEET OF ALL PORTIONS OF THE FIRST FLOOR. BUILDINGS THAT DO NOT COMPLY SHALL BE REQUIRED TO INSTALL FIRE PRIMER/ELBOW TECHNICAL RALLY IN L.S.
  - DEAD END STREETS AND ACCESS Lanes 120 FEET OR MORE SHALL HAVE AN APPROVED FIRE APPARATUS TURN-A-ROUND PROVIDED.
  - APPARATUS ACCESS ROAD GRADE SHALL NOT EXCEED 12 PERCENT IN GRADE, EXCEPT AS APPROVED BY THE FIRE CHIEF (PROHIBIT USE OF DRIVEWAY ON GRAVEL).







LAND AREA DELINEATION TABLE	
OVERALL SITE GROSS ACRES (TOTAL)	4,573,451.52 SF (104.36 ACRES)
WATKINS TOWN ROAD (EXISTING RIGHT OF WAY DEDICATION)	74,052.00 SF (1.70 ACRES)
CYNTHIA S. PERRY PARTIAL LAND SALE (PIN #1747711222)	101,494.80 SF (2.33 ACRES)
REMAINING SITE AREA	4,397,904.72 (100.36 ACRES)
SINGLE FAMILY LAND AREA	3,476,565.88 SF (79.81 ACRES)
TOWNHOME LAND AREA	921,338.84 SF (21.15 ACRES)
PROPOSED TOWNHOME UNITS	94 UNITS
PROPOSED TOWNHOME DENSITY	9,891.48 SF PER UNIT
MINIMUM TOWNHOME DENSITY	3,000 SF PER UNIT



**ATTENTION CONTRACTORS**

The Construction Contractor responsible for the extension of water, sewer, and/or gas, as approved in these plans, is responsible for contacting the **Public Works Department** at (919) 996-2409 and the **Public Utilities Department** at (919) 996-2340 at least twenty-four hours prior to beginning any of their construction.

**Failure** to notify both City Departments in advance of beginning construction, will result in the issuance of monetary fines, and require resubmission of any water or sewer facilities not inspected as a result of this notification failure.

**Failure** to call for inspection, install a Downstream Plug, have Permitted Plans on the jobsite, or any other Violation of City of Raleigh Standards will result in a Fine and Possible Exclusion from future work in the City of Raleigh.

10/4/2022	CITY OF RALEIGH COMMENTS - THIRD REVIEW	DESIGNED BY:	TIW/AP
7/22/2022	CITY OF RALEIGH COMMENTS - SECOND REVIEW	DRAWN BY:	CD/AP
3/18/2022	CITY OF RALEIGH COMMENTS - FIRST REVIEW	REVIEWED BY:	JDU
REV	DATE	DESCRIPTION	
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Parcel #	Description	Area (SF)	Area (AC)
1	SINGLE FAMILY LOT	6,120.00	0.14
2	SINGLE FAMILY LOT	6,120.00	0.14
3	SINGLE FAMILY LOT	6,120.00	0.14
4	SINGLE FAMILY LOT	6,120.00	0.14
5	SINGLE FAMILY LOT	6,120.00	0.14
6	SINGLE FAMILY LOT	6,120.00	0.14
7	SINGLE FAMILY LOT	6,120.00	0.14
8	SINGLE FAMILY LOT	7,313.01	0.17
9	SINGLE FAMILY LOT	6,763.87	0.16
10	SINGLE FAMILY LOT	6,763.87	0.16
11	SINGLE FAMILY LOT	6,763.87	0.16
12	SINGLE FAMILY LOT	6,763.87	0.16
13	SINGLE FAMILY LOT	6,763.87	0.16
14	SINGLE FAMILY LOT	6,763.87	0.16
15	SINGLE FAMILY LOT	7,418.54	0.17
16	SINGLE FAMILY LOT	7,422.38	0.17
17	SINGLE FAMILY LOT	6,120.00	0.14
18	SINGLE FAMILY LOT	6,120.00	0.14
19	SINGLE FAMILY LOT	6,120.00	0.14
20	SINGLE FAMILY LOT	6,120.00	0.14

Parcel #	Description	Area (SF)	Area (AC)
121	TOWNHOME LOT	2,983.33	0.07
122	TOWNHOME LOT	2,200.00	0.05
123	TOWNHOME LOT	2,200.00	0.05
124	TOWNHOME LOT	2,200.00	0.05
125	TOWNHOME LOT	2,985.79	0.07
126	TOWNHOME LOT	2,983.33	0.07
127	TOWNHOME LOT	2,200.00	0.05
128	TOWNHOME LOT	2,200.00	0.05
129	TOWNHOME LOT	2,200.00	0.05
130	TOWNHOME LOT	2,985.79	0.07
131	TOWNHOME LOT	2,983.33	0.07
132	TOWNHOME LOT	2,200.00	0.05
133	TOWNHOME LOT	2,200.00	0.05
134	TOWNHOME LOT	2,200.00	0.05
135	TOWNHOME LOT	3,183.33	0.07
136	TOWNHOME LOT	3,183.33	0.07
137	TOWNHOME LOT	2,200.00	0.05
138	TOWNHOME LOT	2,200.00	0.05
139	TOWNHOME LOT	2,200.00	0.05
140	TOWNHOME LOT	2,200.00	0.05

Parcel #	Description	Area (SF)	Area (AC)
21	SINGLE FAMILY LOT	6,120.00	0.14
22	SINGLE FAMILY LOT	6,532.31	0.15
23	SINGLE FAMILY LOT	6,415.87	0.15
24	SINGLE FAMILY LOT	6,767.49	0.16
25	SINGLE FAMILY LOT	9,064.88	0.21
26	SINGLE FAMILY LOT	6,857.52	0.16
27	SINGLE FAMILY LOT	7,313.97	0.17
28	SINGLE FAMILY LOT	8,180.13	0.19
29	SINGLE FAMILY LOT	6,120.00	0.14
30	SINGLE FAMILY LOT	6,120.00	0.14
31	SINGLE FAMILY LOT	6,120.00	0.14
32	SINGLE FAMILY LOT	6,120.00	0.14
33	SINGLE FAMILY LOT	9,470.10	0.22
34	SINGLE FAMILY LOT	8,403.81	0.19
35	SINGLE FAMILY LOT	7,418.53	0.17
36	SINGLE FAMILY LOT	6,222.00	0.14
37	SINGLE FAMILY LOT	6,222.00	0.14
38	SINGLE FAMILY LOT	6,222.00	0.14
39	SINGLE FAMILY LOT	6,222.00	0.14
40	SINGLE FAMILY LOT	6,984.13	0.16

Parcel #	Description	Area (SF)	Area (AC)
141	TOWNHOME LOT	2,983.33	0.07
142	TOWNHOME LOT	2,985.79	0.07
143	TOWNHOME LOT	2,200.00	0.05
144	TOWNHOME LOT	2,200.00	0.05
145	TOWNHOME LOT	2,200.00	0.05
146	TOWNHOME LOT	3,185.79	0.07
147	TOWNHOME LOT	3,249.50	0.07
148	TOWNHOME LOT	2,244.00	0.05
149	TOWNHOME LOT	2,244.00	0.05
150	TOWNHOME LOT	2,244.00	0.05
151	TOWNHOME LOT	2,244.00	0.05
152	TOWNHOME LOT	3,043.00	0.07
153	TOWNHOME LOT	3,045.50	0.07
154	TOWNHOME LOT	2,244.00	0.05
155	TOWNHOME LOT	2,244.00	0.05
156	TOWNHOME LOT	2,244.00	0.05
157	TOWNHOME LOT	3,043.00	0.07
158	TOWNHOME LOT	3,045.50	0.07
159	TOWNHOME LOT	2,244.00	0.05
160	TOWNHOME LOT	2,243.95	0.05

Parcel #	Description	Area (SF)	Area (AC)
41	SINGLE FAMILY LOT	7,043.78	0.16
42	SINGLE FAMILY LOT	6,222.00	0.14
43	SINGLE FAMILY LOT	6,222.00	0.14
44	SINGLE FAMILY LOT	6,222.00	0.14
45	SINGLE FAMILY LOT	6,222.00	0.14
46	SINGLE FAMILY LOT	6,958.64	0.16
47	SINGLE FAMILY LOT	7,134.09	0.16
48	SINGLE FAMILY LOT	7,134.08	0.16
49	SINGLE FAMILY LOT	8,488.68	0.19
50	SINGLE FAMILY LOT	6,120.00	0.14
51	SINGLE FAMILY LOT	6,120.00	0.14
52	SINGLE FAMILY LOT	6,120.00	0.14
53	SINGLE FAMILY LOT	6,120.00	0.14
54	SINGLE FAMILY LOT	6,120.00	0.14
55	SINGLE FAMILY LOT	7,037.05	0.16
56	SINGLE FAMILY LOT	6,120.00	0.14
57	SINGLE FAMILY LOT	6,120.00	0.14
58	SINGLE FAMILY LOT	7,277.94	0.17
59	SINGLE FAMILY LOT	6,120.00	0.14
60	SINGLE FAMILY LOT	6,120.00	0.14

Parcel #	Description	Area (SF)	Area (AC)
161	TOWNHOME LOT	3,187.72	0.07
162	TOWNHOME LOT	3,247.00	0.07
163	TOWNHOME LOT	2,244.00	0.05
164	TOWNHOME LOT	2,244.00	0.05
165	TOWNHOME LOT	2,244.00	0.05
166	TOWNHOME LOT	2,244.00	0.05
167	TOWNHOME LOT	3,045.50	0.07
168	TOWNHOME LOT	3,043.00	0.07
169	TOWNHOME LOT	2,244.00	0.05
170	TOWNHOME LOT	2,244.00	0.05
171	TOWNHOME LOT	2,244.00	0.05
172	TOWNHOME LOT	3,250.72	0.07
173	SINGLE FAMILY LOT	7,277.94	0.17
174	SINGLE FAMILY LOT	6,120.00	0.14
175	SINGLE FAMILY LOT	6,120.00	0.14
176	SINGLE FAMILY LOT	6,120.00	0.14
177	SINGLE FAMILY LOT	6,120.00	0.14
178	SINGLE FAMILY LOT	6,120.00	0.14
179	SINGLE FAMILY LOT	6,120.00	0.14
180	SINGLE FAMILY LOT	6,120.00	0.14

Parcel #	Description	Area (SF)	Area (AC)
241	TOWNHOME LOT	3,183.31	0.07
242	TOWNHOME LOT	2,200.00	0.05
243	TOWNHOME LOT	2,200.00	0.05
244	TOWNHOME LOT	2,200.00	0.05
245	TOWNHOME LOT	2,200.00	0.05
246	TOWNHOME LOT	3,183.33	0.07
247	TOWNHOME LOT	3,183.29	0.07
248	TOWNHOME LOT	2,200.00	0.05
249	TOWNHOME LOT	2,200.00	0.05
250	TOWNHOME LOT	2,200.00	0.05
251	TOWNHOME LOT	2,983.33	0.07
252	TOWNHOME LOT	2,985.79	0.07
253	TOWNHOME LOT	2,200.00	0.05
254	TOWNHOME LOT	2,200.00	0.05
255	TOWNHOME LOT	2,200.00	0.05
256	TOWNHOME LOT	2,983.33	0.07
257	TOWNHOME LOT	2,985.79	0.07
258	TOWNHOME LOT	2,200.00	0.05
259	TOWNHOME LOT	2,200.00	0.05
260	TOWNHOME LOT	2,200.00	0.05

Parcel #	Description	Area (SF)	Area (AC)
61	SINGLE FAMILY LOT	6,120.00	0.14
62	SINGLE FAMILY LOT	8,217.16	0.19
63	SINGLE FAMILY LOT	8,217.16	0.19
64	SINGLE FAMILY LOT	6,118.16	0.14
65	SINGLE FAMILY LOT	6,120.00	0.14
66	SINGLE FAMILY LOT	6,120.00	0.14
67	SINGLE FAMILY LOT	6,120.00	0.14
68	SINGLE FAMILY LOT	7,277.94	0.17
69	SINGLE FAMILY LOT	6,120.00	0.14
70	SINGLE FAMILY LOT	6,120.00	0.14
71	SINGLE FAMILY LOT	6,145.53	0.14
72	SINGLE FAMILY LOT	6,120.00	0.14
73	SINGLE FAMILY LOT	7,277.94	0.17
74	SINGLE FAMILY LOT	7,399.94	0.17
75	SINGLE FAMILY LOT	6,779.32	0.16
76	SINGLE FAMILY LOT	6,779.32	0.16
77	SINGLE FAMILY LOT	8,171.66	0.19
78	SINGLE FAMILY LOT	6,779.32	0.16
79	SINGLE FAMILY LOT	6,779.32	0.16
80	SINGLE FAMILY LOT	6,779.32	0.16

Parcel #	Description	Area (SF)	Area (AC)
181	SINGLE FAMILY LOT	6,120.00	0.14
182	SINGLE FAMILY LOT	6,054.60	0.14
183	SINGLE FAMILY LOT	6,327.89	0.15
184	SINGLE FAMILY LOT	9,349.89	0.21
185	SINGLE FAMILY LOT	8,044.49	0.18
186	SINGLE FAMILY LOT	6,120.00	0.14
187	SINGLE FAMILY LOT	6,120.00	0.14
188	SINGLE FAMILY LOT	6,120.00	0.14
189	SINGLE FAMILY LOT	6,120.00	0.14
190	SINGLE FAMILY LOT	6,120.00	0.14
191	SINGLE FAMILY LOT	6,120.00	0.14
192	SINGLE FAMILY LOT	6,120.00	0.14
193	SINGLE FAMILY LOT	6,630.06	0.15
194	SINGLE FAMILY LOT	7,753.78	0.18
195	SINGLE FAMILY LOT	7,753.78	0.18
196	SINGLE FAMILY LOT	7,753.78	0.18
197	SINGLE FAMILY LOT	7,753.78	0.18
198	SINGLE FAMILY LOT	8,546.68	0.20
199	SINGLE FAMILY LOT	8,947.10	0.21
200	SINGLE FAMILY LOT	6,120.00	0.14

Parcel #	Description	Area (SF)	Area (AC)
261	TOWNHOME LOT	3,183.33	0.07
262	HOA LOT	840,561.98	19.30
263	HOA LOT	9,199.22	0.21
264	HOA LOT	467,819.15	10.74
265	HOA LOT	77,788.92	1.79
266	HOA LOT	42,661.01	0.98
267	HOA LOT	316,570.47	7.27
268	HOA LOT	36,502.95	0.84
269	HOA LOT	3,152.05	0.07
270	HOA LOT	43,563.78	1.00
271	HOA LOT	5,253.88	0.12
272	HOA LOT	12,868.97	0.30
273	HOA LOT	61,559.78	1.41
274	HOA LOT	11,781.80	0.27
275	HOA LOT	485,694.21	11.15

Parcel #	Description	Area (SF)	Area (AC)
81	SINGLE FAMILY LOT	6,779.32	0.16
82	SINGLE FAMILY LOT	6,779.32	0.16
83	SINGLE FAMILY LOT	8,009.94	0.18
84	SINGLE FAMILY LOT	6,832.00	0.16
85	SINGLE FAMILY LOT	7,643.94	0.18
86	SINGLE FAMILY LOT	6,467.37	0.15
87	SINGLE FAMILY LOT	6,467.37	0.15
88	SINGLE FAMILY LOT	6,467.37	0.15
89	SINGLE FAMILY LOT	6,467.37	0.15
90	SINGLE FAMILY LOT	6,467.37	0.15
91	SINGLE FAMILY LOT	6,467.37	0.15
92	SINGLE FAMILY LOT	6,768.12	0.16
93	SINGLE FAMILY LOT	7,102.46	0.16
94	SINGLE FAMILY LOT	8,054.95	0.18
95	SINGLE FAMILY LOT	6,467.37	0.15
96	SINGLE FAMILY LOT	7,399.94	0.17
97	SINGLE FAMILY LOT	7,277.94	0.17
98	SINGLE FAMILY LOT	6,120.00	0.14
99	SINGLE FAMILY LOT	6,120.00	0.14
100	SINGLE FAMILY LOT	6,120.00	0.14

Parcel #	Description	Area (SF)	Area (AC)
201	SINGLE FAMILY LOT	6,120.00	0.14
202	SINGLE FAMILY LOT	6,120.00	0.14
203	SINGLE FAMILY LOT	6,120.00	0.14
204	SINGLE FAMILY LOT	6,120.00	0.14
205	SINGLE FAMILY LOT	6,482.90	0.15
206	SINGLE FAMILY LOT	8,217.16	0.19
207	SINGLE FAMILY LOT	8,078.76	0.19
208	SINGLE FAMILY LOT	6,758.52	0.16
209	SINGLE FAMILY LOT	7,274.23	0.17
210	SINGLE FAMILY LOT	7,274.23	0.17
211	SINGLE FAMILY LOT	6,379.78	0.15
212	SINGLE FAMILY LOT	6,222.00	0.14
213	SINGLE FAMILY LOT	6,222.00	0.14
214	SINGLE FAMILY LOT	6,222.00	0.14
215	SINGLE FAMILY LOT	6,619.31	0.15
216	SINGLE FAMILY LOT	7,134.27	0.16
217	SINGLE FAMILY LOT	7,134.27	0.16
218	SINGLE FAMILY LOT	6,264.63	0.14
219	SINGLE FAMILY LOT	6,222.00	0.14
220	SINGLE FAMILY LOT	6,222.00	0.14

Parcel #	Description	Area (SF)	Area (AC)
101	SINGLE FAMILY LOT	6,120.00	0.14
102	SINGLE FAMILY LOT	6,120.00	0.14
103	SINGLE FAMILY LOT	6,120.00	0.14
104	SINGLE FAMILY LOT	6,042.45	0.14
105	SINGLE FAMILY LOT	6,412.44	0.15
106	SINGLE FAMILY LOT	6,886.26	0.16
107	SINGLE FAMILY LOT	6,886.26	0.16
108	SINGLE FAMILY LOT	6,274.68	0.14
109	SINGLE FAMILY LOT	6,120.00	0.14
110	SINGLE FAMILY LOT	6,120.00	0.14
111	SINGLE FAMILY LOT	6,120.00	0.14
112	SINGLE FAMILY LOT	6,594.46	0.15
113	SINGLE FAMILY LOT	8,054.95	0.18
114	SINGLE FAMILY LOT	8,054.95	0.18
115	SINGLE FAMILY LOT	8,054.95	0.18
116	TOWNHOME LOT	3,200.32	0.07
117	TOWNHOME LOT	2,200.00	0.05
118	TOWNHOME LOT	2,200.00	0.05
119	TOWNHOME LOT	2,200.00	0.05
120	TOWNHOME LOT	2,985.79	0.07

Parcel #	Description	Area (SF)	Area (A)
221	SINGLE FAMILY LOT	6,222.00	0.14
222	SINGLE FAMILY LOT	6,222.00	0.14
223	SINGLE FAMILY LOT	6,244.20	0.14
224	SINGLE FAMILY LOT	8,121.41	0.19
225	TOWNHOME LOT	3,183.33	0.07
226	TOWNHOME LOT	2,200.00	0.05
227	TOWNHOME LOT	2,200.00	0.05
228	TOWNHOME LOT	2,200.00	0.05
229	TOWNHOME LOT	2,200.00	0.05
230	TOWNHOME LOT	2,985.79	0.07
231	TOWNHOME LOT	2,983.33	0.07
232	TOWNHOME LOT	2,200.00	0.05
233	TOWNHOME LOT	2,200.00	0.05
234	TOWNHOME LOT	2,985.79	0.07
235	TOWNHOME LOT	2,983.33	0.07
236	TOWNHOME LOT	2,200.00	0.05
237	TOWNHOME LOT	2,200.00	0.05
238	TOWNHOME LOT	2,200.00	0.05
239	TOWNHOME LOT	2,200.00	0.05
240	TOWNHOME LOT	3,183.30	0.07











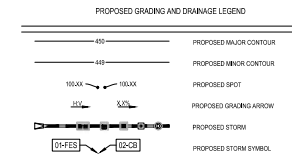
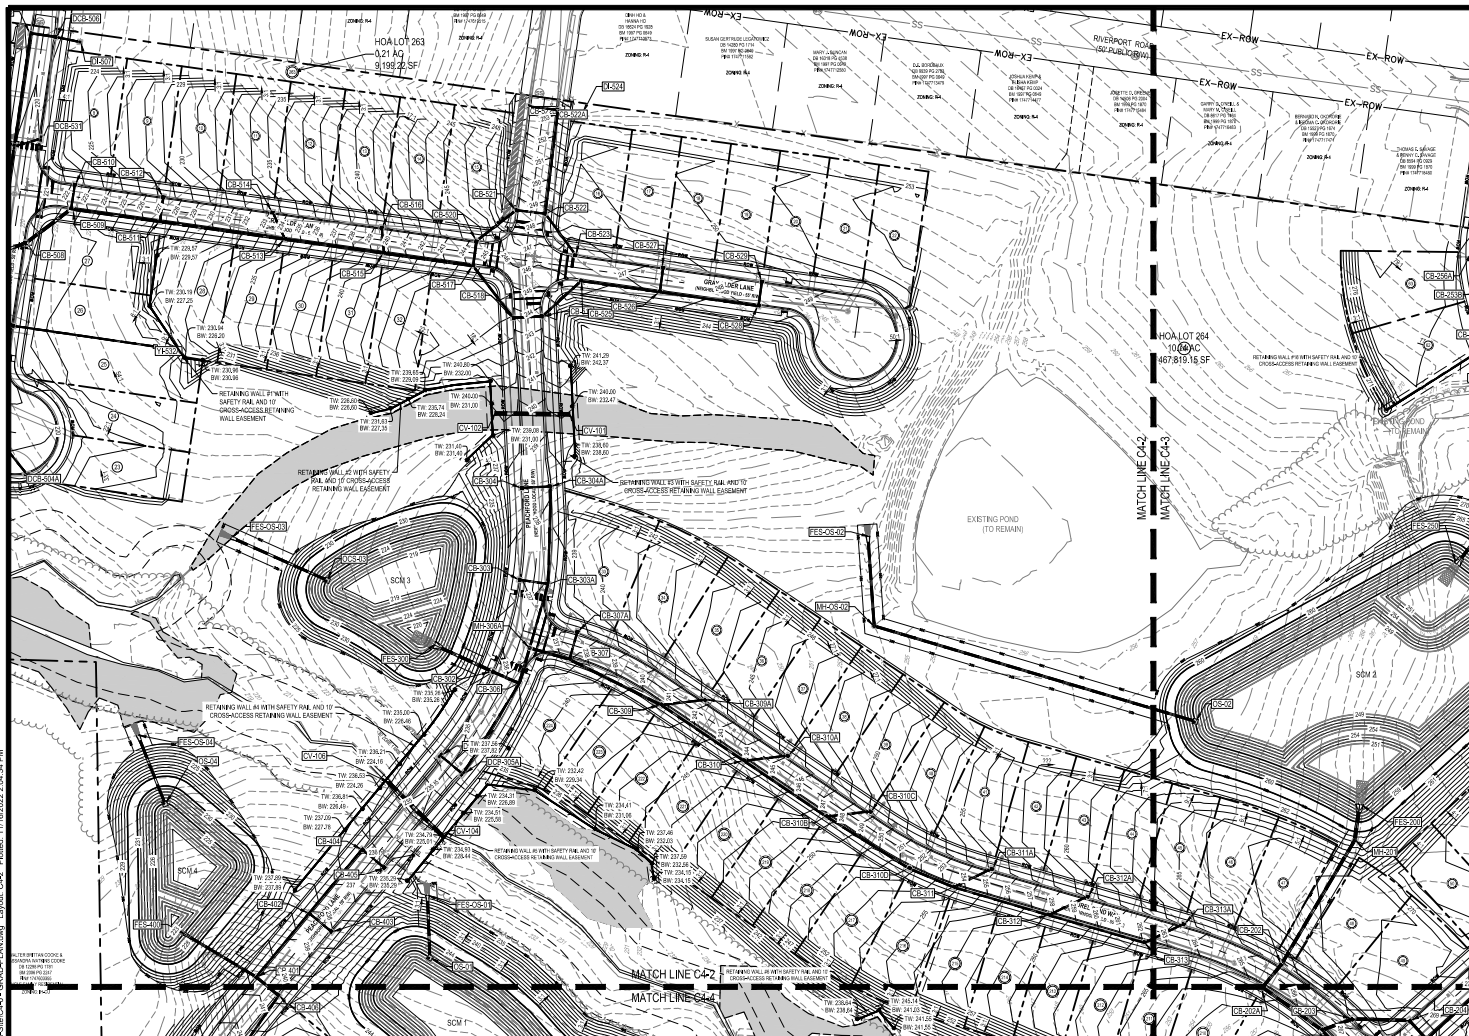








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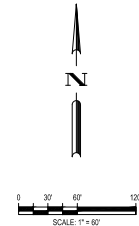


STRUCTURES ABBREVIATIONS:

- CB CATCH BASIN - CITY OF RALEIGH STANDARD BR-100
- DOB DOUBLE CATCH BASIN - CITY OF RALEIGH STANDARD BR-100
- MI MANHOLE - CITY OF RALEIGH STANDARD BR-100
- DI DROP INLET - CITY OF RALEIGH STANDARD BR-100
- FES FLARED END SECTION
- Y YARD INLET

GRADING ABBREVIATIONS:

- TH TOP OF RETAINING WALL
- BW BOTTOM OF RETAINING WALL



ATTENTION CONTRACTORS

The Construction Contractor responsible for the extension of water, sewer, and/or gas, as approved in these plans, is responsible for contacting the **Public Works Department** at (919) 996-2409 and the **Public Utilities Department** at (919) 996-2340 at least twenty-four hours prior to beginning any of their construction.

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Know what's below.  
Call before you dig.

FILE NUMBER:	8430-00
DATE:	11/16/2022
C4-2	

DESIGNED BY:	TDI/AP
DRAWN BY:	CD/AP
REVIEWED BY:	JDU

REVISION	DATE	DESCRIPTION
1	11/16/2022	CITY OF RALEIGH COMMENTS - THIRD REVIEW
2	11/16/2022	CITY OF RALEIGH COMMENTS - SECOND REVIEW
3	11/16/2022	CITY OF RALEIGH COMMENTS - FIRST REVIEW


LENNAR CORPORATION	EVERLEE SUBDIVISION	GRADING PLAN (2 OF 5)
1100 PERIMETER PARK DRIVE, SUITE 112 KANNHILLVILLE, NC 27606	1100 PERIMETER PARK DRIVE, SUITE 112 KANNHILLVILLE, NC 27606	

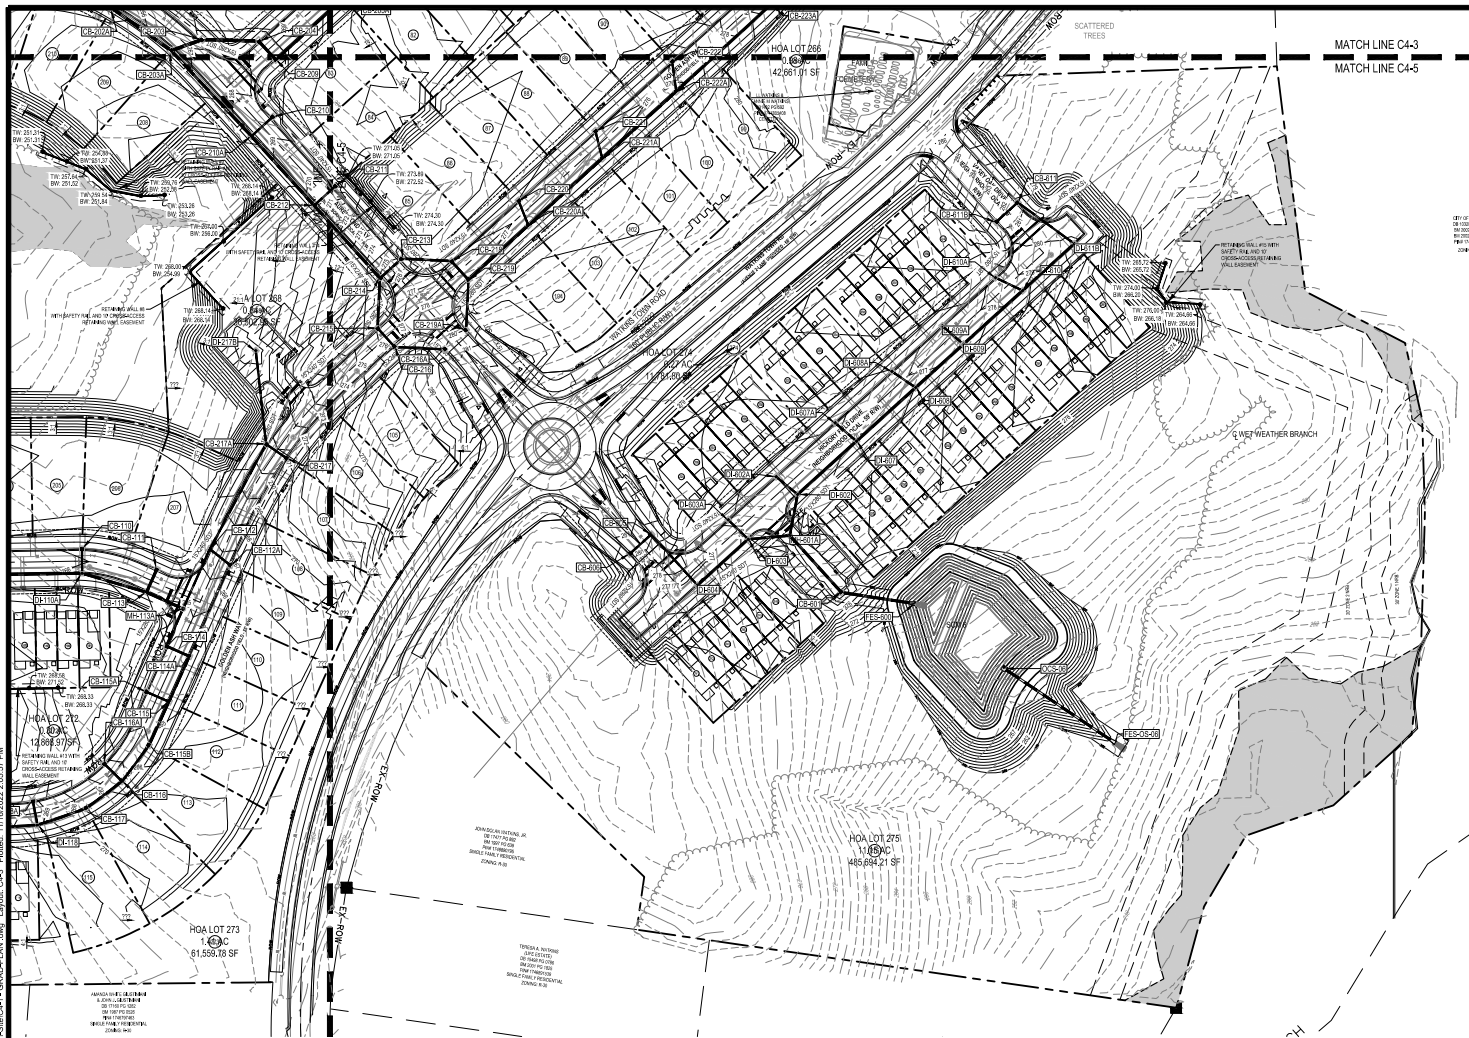EGE	8440 VALLEY PARK BLVD, SUITE 102 RALEIGH, NC 27607 NC LICENSE #C-4387
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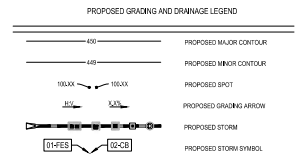
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MATCH LINE C4-3  
MATCH LINE C4-5



**STRUCTURES ABBREVIATIONS**  
CDB CATCH BASIN - CITY OF RALEIGH STANDARD BRICK/CLAY  
DCB DOUBLE CATCH BASIN - CITY OF RALEIGH STANDARD BRICK/CLAY  
HWH HATCH - CITY OF RALEIGH STANDARD BRICK/CLAY  
DRAINAGE - CITY OF RALEIGH STANDARD BRICK/CLAY  
FES FLARED END SECTION  
H HATCH

**GRADING ABBREVIATIONS**  
TW TOP OF RETAINING WALL  
BW BOTTOM OF RETAINING WALL

CITY OF RALEIGH  
800 SOUTH MAIN  
RALEIGH, NC 27601  
919.996.2400  
WWW.CITYOFRALEIGH.ORG



**ATTENTION CONTRACTORS**  
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FILE NUMBER:	8430-00
DATE:	11/16/2022
C4-3	

DATE	REV	DESCRIPTION
11/16/2022	1	CITY OF RALEIGH COMMENTS - THIRD REVIEW
11/16/2022	2	CITY OF RALEIGH COMMENTS - SECOND REVIEW
11/16/2022	3	CITY OF RALEIGH COMMENTS - FIRST REVIEW


DESIGNED BY:	TDW/AP
DRAWN BY:	CD/AP
REVIEWED BY:	JDU

EVERLEE SUBDIVISION PRELIMINARY GRADING AND DRAINAGE PLAN 1100 PERIMETER PARK DRIVE, SUITE 112 RALEIGH, NC 27607 KONNISTVILLE, NC 27608	LENNAR CORPORATION	8440 VALLEY PARK BLVD, SUITE 102 RALEIGH, NC 27607 NC LICENSE #C-4387
---	--------------------	---







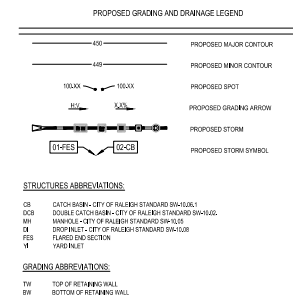

**STRUCTURES ABBREVIATIONS:**

CB	CATCH BASIN - CITY OF RALEIGH STANDARD SW-10.06.1
DCB	DOUBLE CATCH BASIN - CITY OF RALEIGH STANDARD SW-10.02
MH	MANHOLE - CITY OF RALEIGH STANDARD SW-10.05
DI	DROP INLET - CITY OF RALEIGH STANDARD SW-10.08

**GRADING ABBREVIATIONS:**

TW	TOP OF RETAINING WALL
RW	BOTTOM OF RETAINING WALL

△			
△			
△	10/4/2022		CITY OF RALEIGH COMMENTS - THIRD REVIEW
△	7/22/2022		CITY OF RALEIGH COMMENTS - SECOND REVIEW
△	3/18/2022		CITY OF RALEIGH COMMENTS - FIRST REVIEW
REV	DATE		DESCRIPTION

DESIGNED BY:	TWI/AP
DRAWN BY:	CD/AP
REVIEWED BY:	JD/J



5440 WADE PARK BLVD, SUITE 102  
 RALEIGH NC 27607  
 WWW.BGENC.COM  
 NC LICENSE #C-4387 ©2022

LENNAR  
CORPORATION  
100 PERIMETER PARK DRIVE, SUITE 112  
MORRISVILLE / NC / 27560

**EVERLEE  
SUBDIVISION**  
PRELIMINARY SUBDIVISION PLAN

WATKINS TOWN ROAD  
RALEIGH / NC / 27616

GRADING PLAN (3 OF 5)

**ATTENTION CONTRACTORS**

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FILE NUMBER:  
8430-00

DATE:11/16/2022

C4-3

G:\NCA\Projects\Lennar\8430-00 - Lennar - Everfee - Rateigh03 - DWG\PlanSheets\On-Site\C4-1 - GRAD-PLAN.dwg Layout: C4-5 Plotted: 11/16/2022 2:06:37 PM



Know what's below.  
Call before you dig.



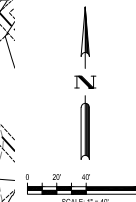
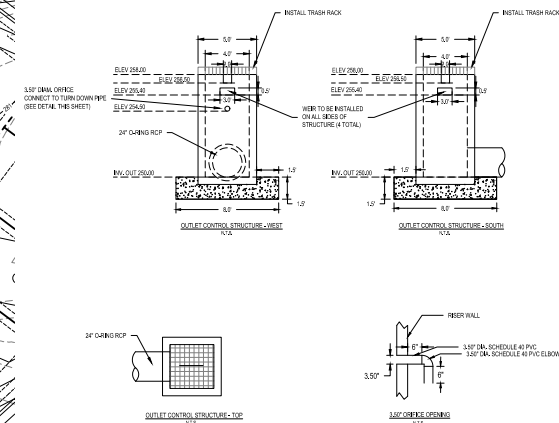
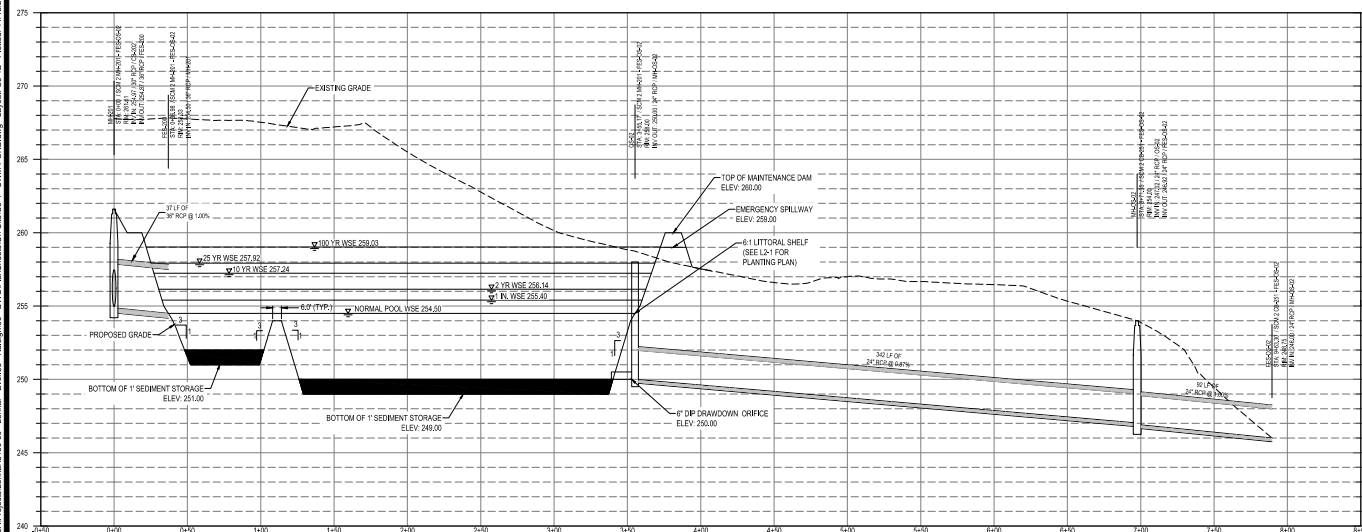








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NOTE:  
ALL SCM EMBANKMENTS AND SURROUNDING AREAS MUST BE STABILIZED WITH NON-CLUMPING TURF GRASS

NO TEMPORARY OR PERMANENT ENCROACHMENTS (INCLUDING BUT NOT LIMITED TO CLEARING, GRADING, FENCING, AND THE INSTALLATION OF RETAINING WALLS OR OTHER STRUCTURES) ARE PERMITTED WITHIN THE GREENWAY EASEMENT AREA WITHOUT PRIOR APPROVAL BY THE CITY OF RALEIGH.

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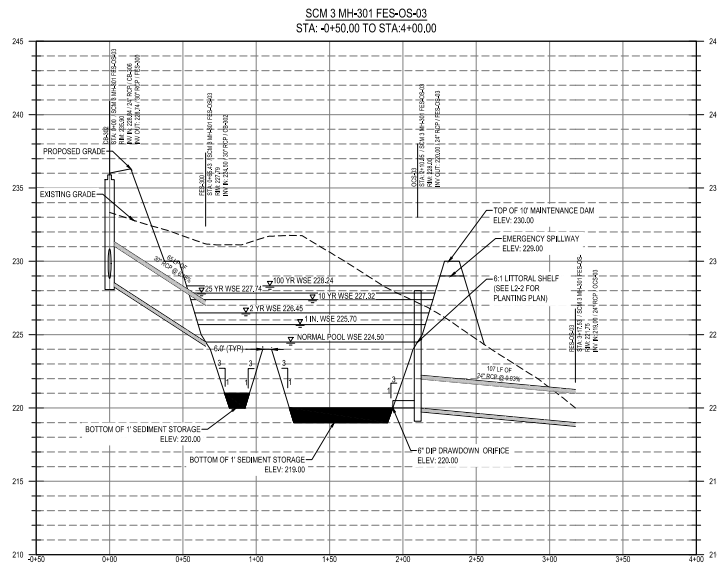
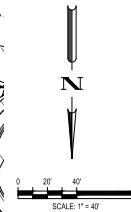
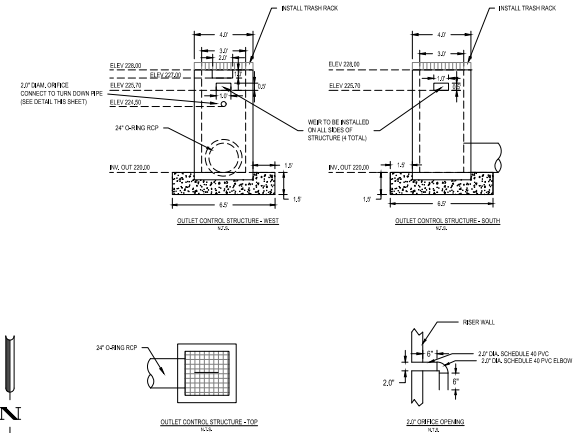
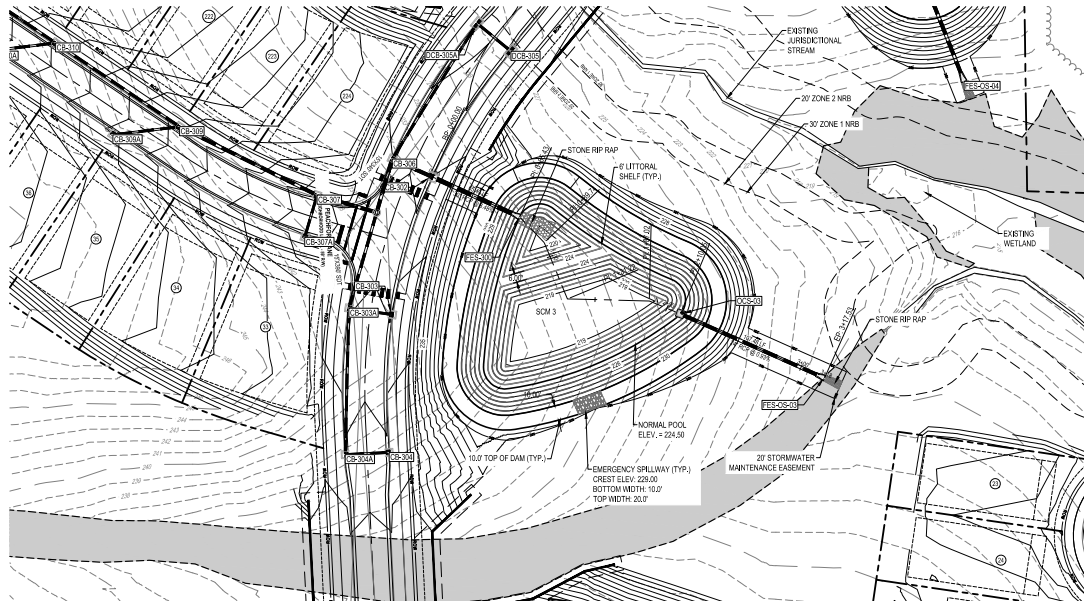
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10/4/2022	CITY OF RALEIGH COMMENTS - THIRD REVIEW	DESIGNED BY:	TIW/AP
7/22/2022	CITY OF RALEIGH COMMENTS - SECOND REVIEW	DRAWN BY:	CD/AP
3/16/2022	CITY OF RALEIGH COMMENTS - FIRST REVIEW	REVIEWED BY:	JDU
REV	DATE	DESCRIPTION	
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3	11/16/2022	SCM 2 PLAN & PROFILE (2 OF 2)	
4	11/16/2022	SCM 2 PLAN & PROFILE (2 OF 2)	
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NOTE:  
ALL SCM EMBANKMENTS AND SURROUNDING AREAS MUST BE STABILIZED WITH NON-CLUMPING TURF GRASS

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Know what's below.  
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FILE NUMBER:  
8430-00  
DATE: 11/16/2022

C5-3

SCM 3 PLAN & PROFILE

EVERLEE  
SUBDIVISION  
PRELIMINARY SUBMITTAL PLAN  
1100 PERIMETER PARK DRIVE, SUITE 112  
RALEIGH, NC 27607  
NC LICENSE #C-27806

LENNAR  
CORPORATION  
1100 PERIMETER PARK DRIVE, SUITE 112  
RALEIGH, NC 27607  
NC LICENSE #C-27806

BCE


5440 VALLEY PARK BLVD, SUITE 102  
RALEIGH, NC 27607  
NC LICENSE #C-4397

DESIGNED BY: TWIAP  
DRAWN BY: CD/AP  
REVIEWED BY: JDU



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CITY OF RALEIGH COMMENTS - FIRST REVIEW  
CITY OF RALEIGH COMMENTS - SECOND REVIEW  
CITY OF RALEIGH COMMENTS - FIRST REVIEW  
DATE: 11/16/2022



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SCM4 CB-401 - OS-2  
STA: -0+50.00 TO STA: 4+00.00

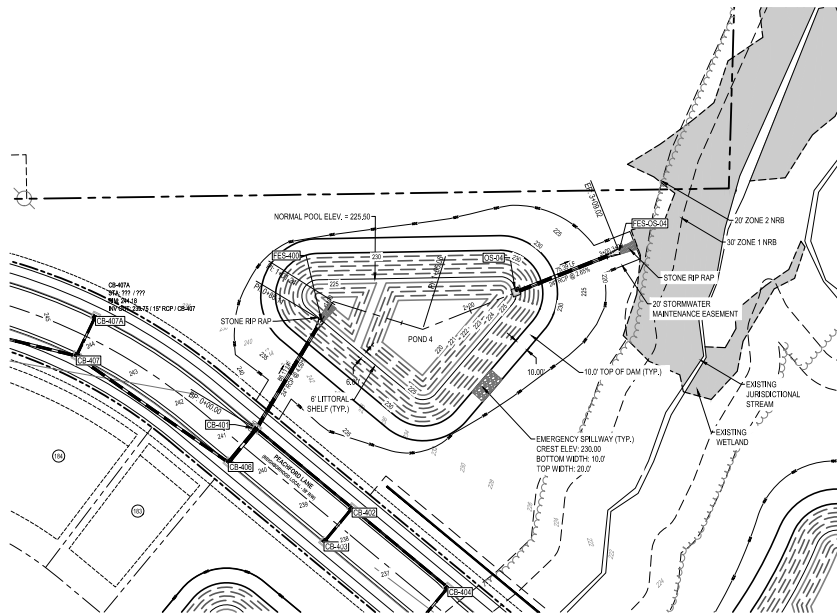
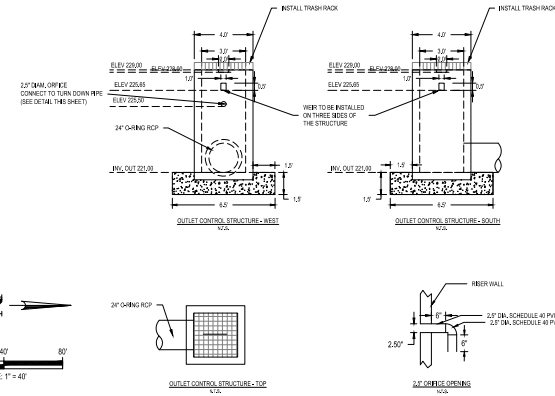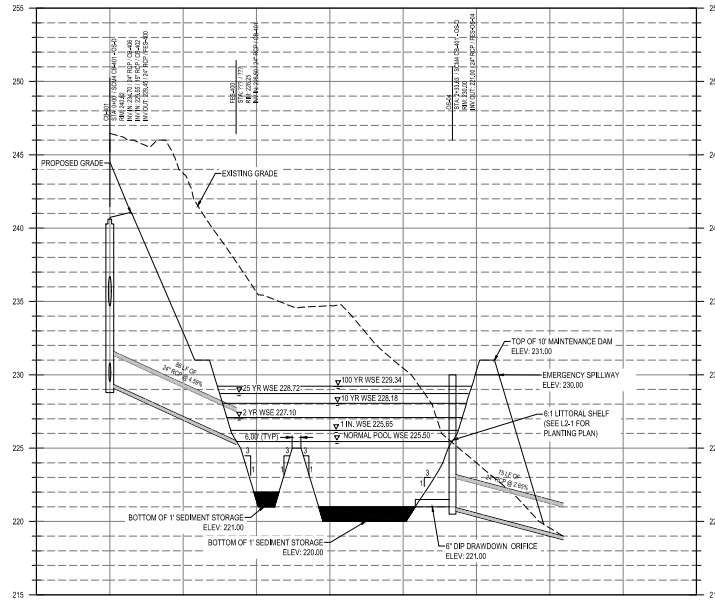
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Know what's below.  
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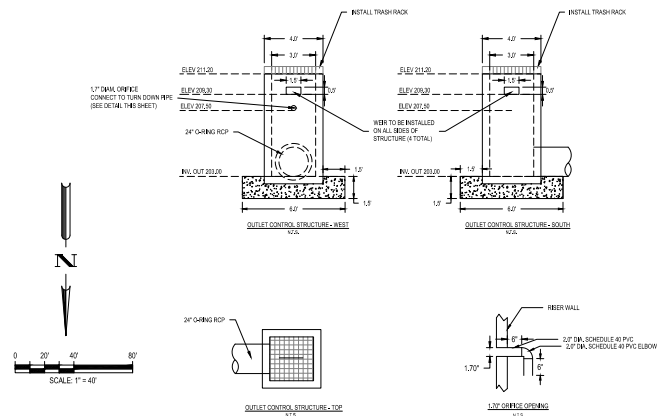
FILE NUMBER:	8430-00
DATE:	11/16/2022
C5-4	

REVISION	DATE	DESCRIPTION
1	11/16/2022	CITY OF RALEIGH COMMENTS - THIRD REVIEW
2	11/16/2022	CITY OF RALEIGH COMMENTS - SECOND REVIEW
3	11/16/2022	CITY OF RALEIGH COMMENTS - FIRST REVIEW

DESIGNED BY:	TD/AP
DRAWN BY:	CD/AP
REVIEWED BY:	JDU

LENNAR CORPORATION	EVERLEE SUBDIVISION
5440 VALLEY PARK DRIVE, SUITE 112	1100 PERIMETER PARK DRIVE, SUITE 112
MONROVIE, NC 27050	MONROVIE, NC 27050





NOTE:  
ALL SCM EMBANKMENTS AND SURROUNDING AREAS MUST BE STABILIZED WITH NON-CLUMPING TURF GRASS

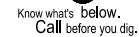
NO TEMPORARY OR PERMANENT ENCROACHMENTS (INCLUDING BUT NOT LIMITED TO CLEARING, GRADING, FENCING, AND THE INSTALLATION OF RETAINING WALLS OR OTHER STRUCTURES) ARE PERMITTED WITHIN THE GREENWAY EASEMENT AREA WITHOUT PRIOR APPROVAL BY THE CITY OF RALEIGH.


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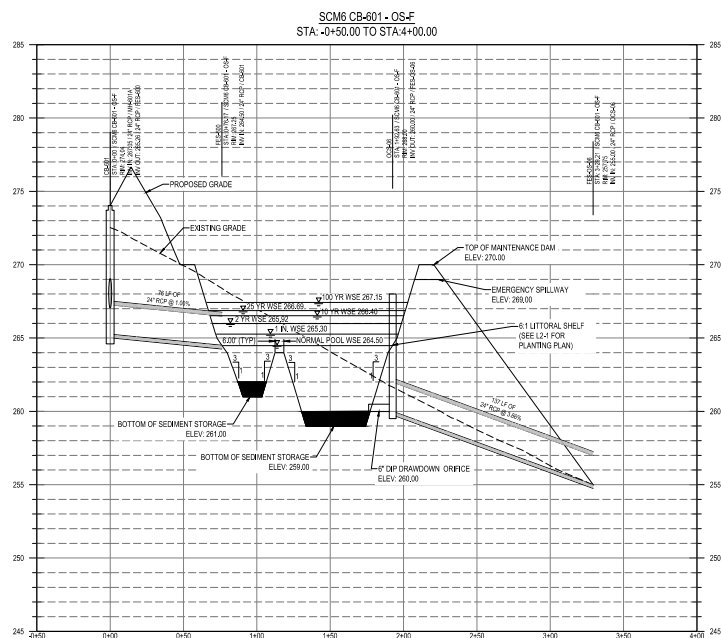
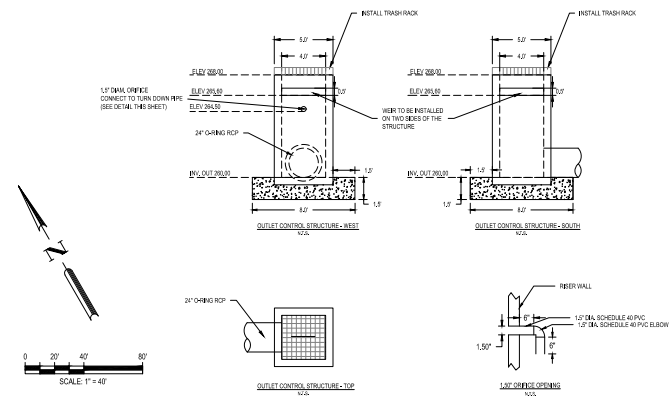
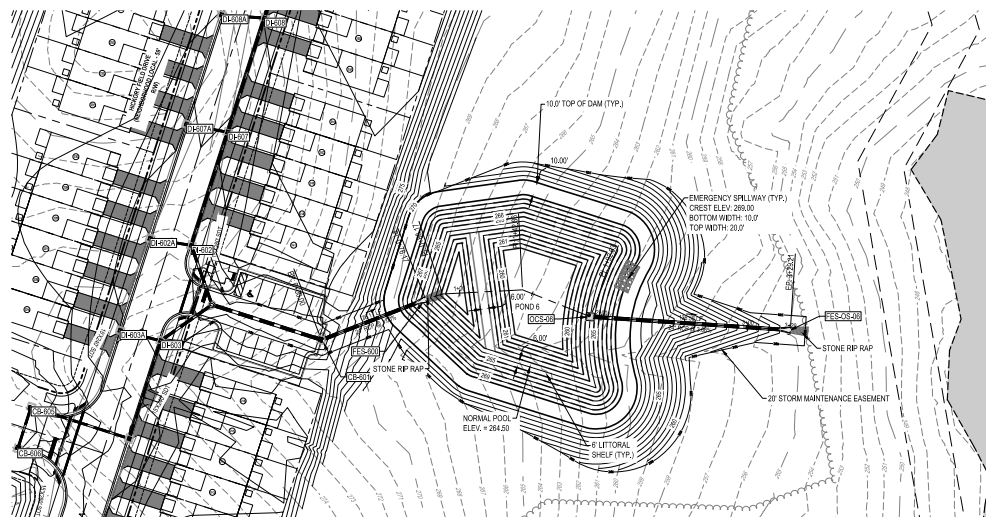
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<div>FILE NUMBER: 8430-00</div> <div>DATE: 11/16/2022</div> <div>C5-5</div>	<div>SCM 5 PLAN &amp; PROFILE</div>	<div>EVERLEE SUBDIVISION PRELIMINARY SUBDIVISION PLAN WATKINS TOWN ROAD RALEIGH / NC 27616</div>	<div>LENNAR CORPORATION 1100 PERIMETER PARK DRIVE, SUITE 112 MORRISVILLE / NC 27560 WWW.LENNAR.COM</div>	<div> 6440 MADEIRA LANE, SUITE 102 WWW.BGE.NC.COM NCL LICENSE #C-43907</div>	<div>DESIGNED BY: TWAP DRAWN BY: CDAIP REVIEWED BY: JDU</div>	<div>10/6/2022</div>	<div>7/22/2022</div>	<div>3/18/2022</div>	<div>10/6/2022</div>	<div>CITY OF RALEIGH COMMENTS - THIRD REVIEW</div>	<div>CITY OF RALEIGH COMMENTS - SECOND REVIEW</div>	<div>CITY OF RALEIGH COMMENTS - FIRST REVIEW</div>
						<div>REVIEW</div>	<div>DATE</div>	<div>DESCRIPTION</div>				





NO TEMPORARY OR PERMANENT ENCROACHMENTS (INCLUDING BUT NOT LIMITED TO CLEARING, GRADING, FENCING, AND THE INSTALLATION OF RETAINING WALLS OR OTHER STRUCTURES) ARE PERMITTED WITHIN THE GREENWAY EASEMENT AREA WITHOUT PRIOR APPROVAL BY THE CITY OF RALEIGH.




Know what's below.  
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FILE NUMBER: 8430-06  DATE:11/16/2022	SCM 6 PLAN & PROFILE	EVERLEE SUBDIVISION PRELIMINARY SUBDIVISION PLAN  WATSON TOWN ROAD RALEIGH, NC 27616	LENNAR CORPORATION  100 PERIMETER PARK DRIVE, SUITE 112 MORRISVILLE, NC 27560	 5440 WALK PARK DRIVE, SUITE 102 RALEIGH, NC 27601 NC LICENSE #C-4397 @0002	DESIGNED BY:	TIWAP	
					DRAWN BY:	CD/ADP	
					REVIEWED BY:	JDJ	
					10/4/2022	△	CITY OF RALEIGH COMMENTS - THIRD REVIEW
					7/23/2022	△	CITY OF RALEIGH COMMENTS - SECOND REVIEW
3/10/2022	△	CITY OF RALEIGH COMMENTS - FIRST REVIEW					
					REV	DATE	DESCRIPTION







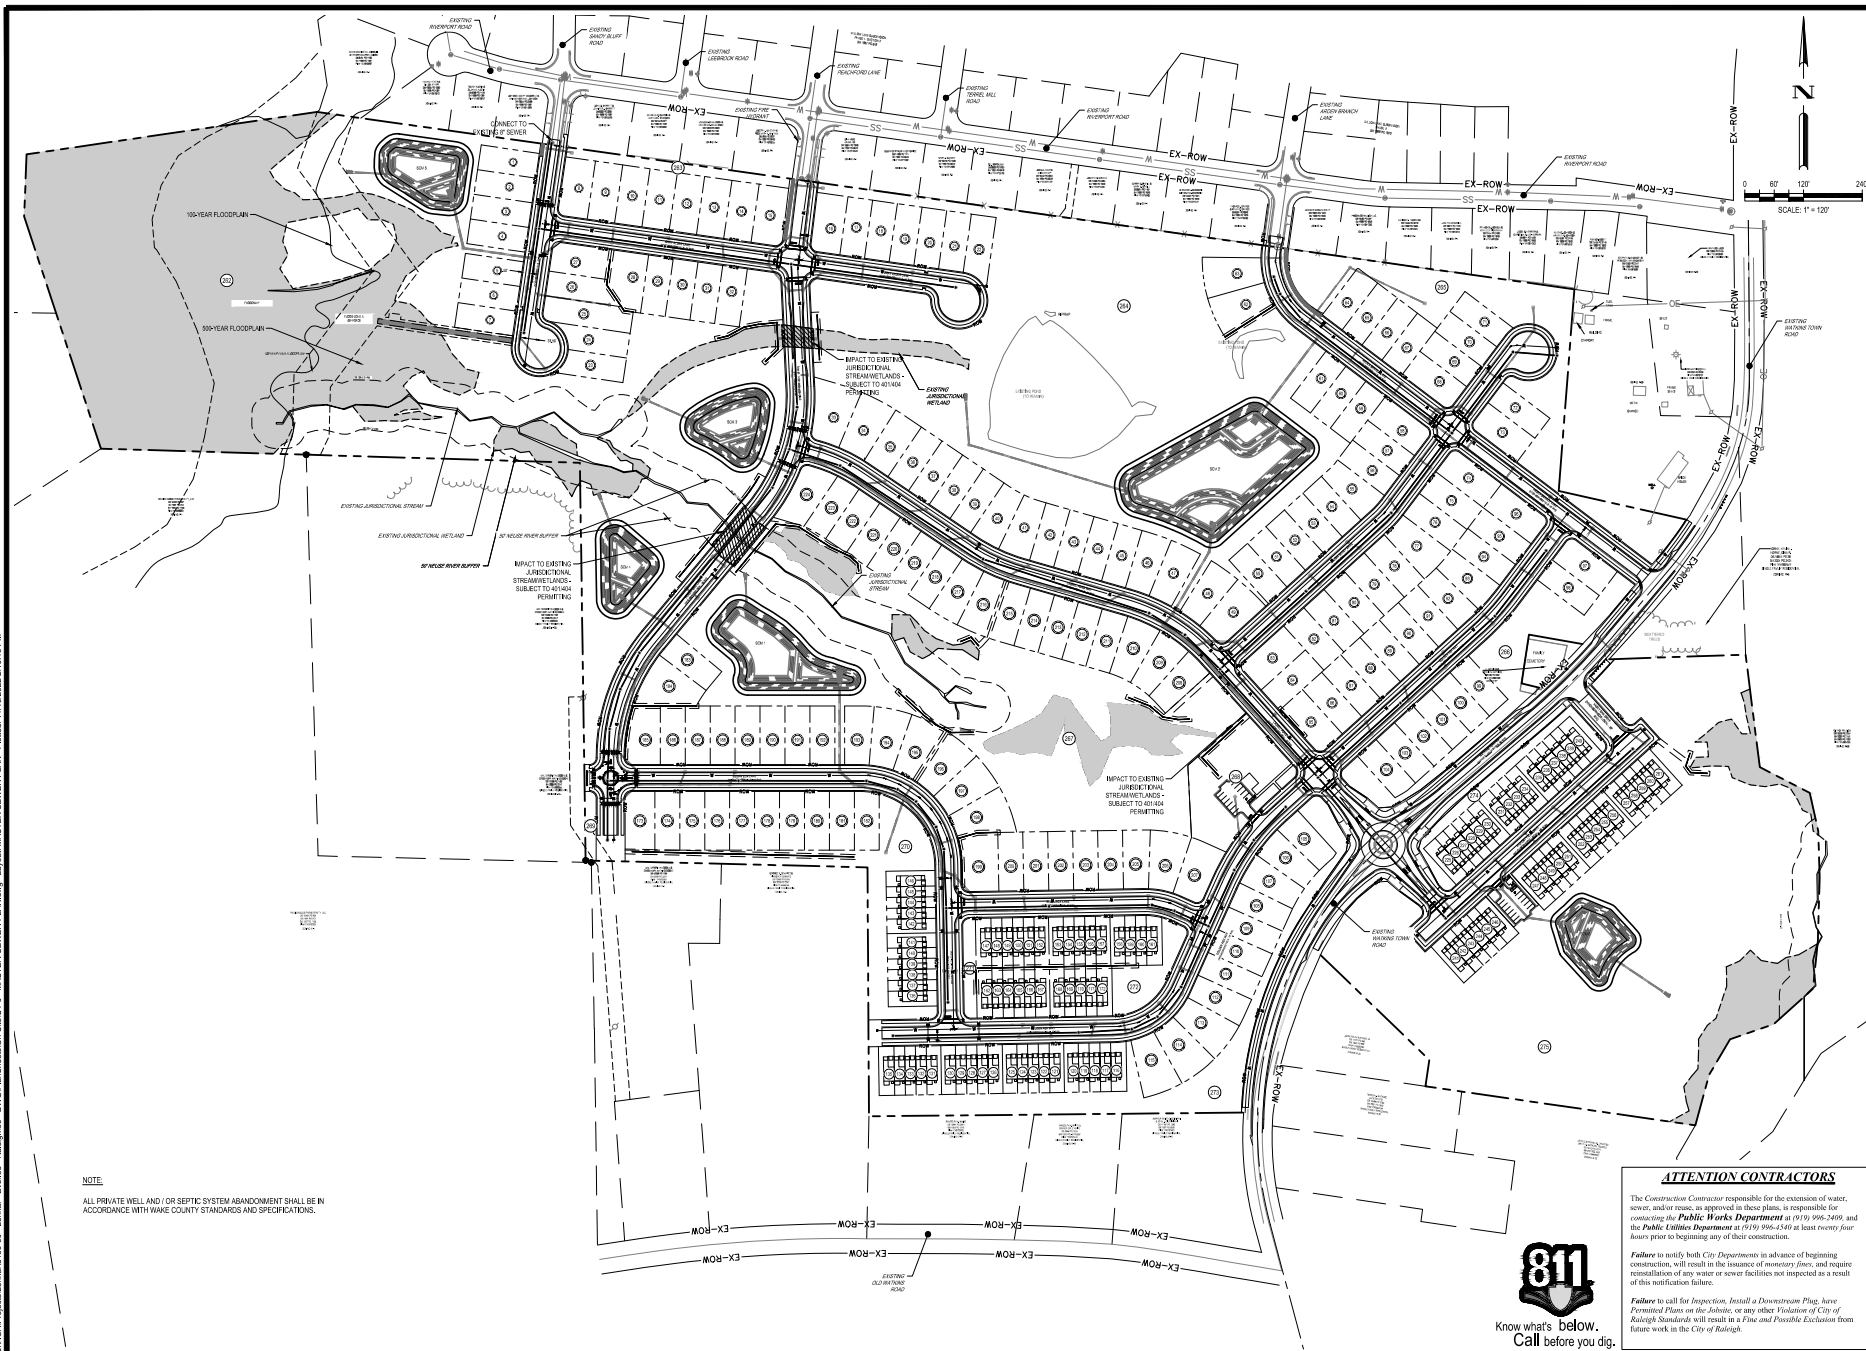


**NOTE:**
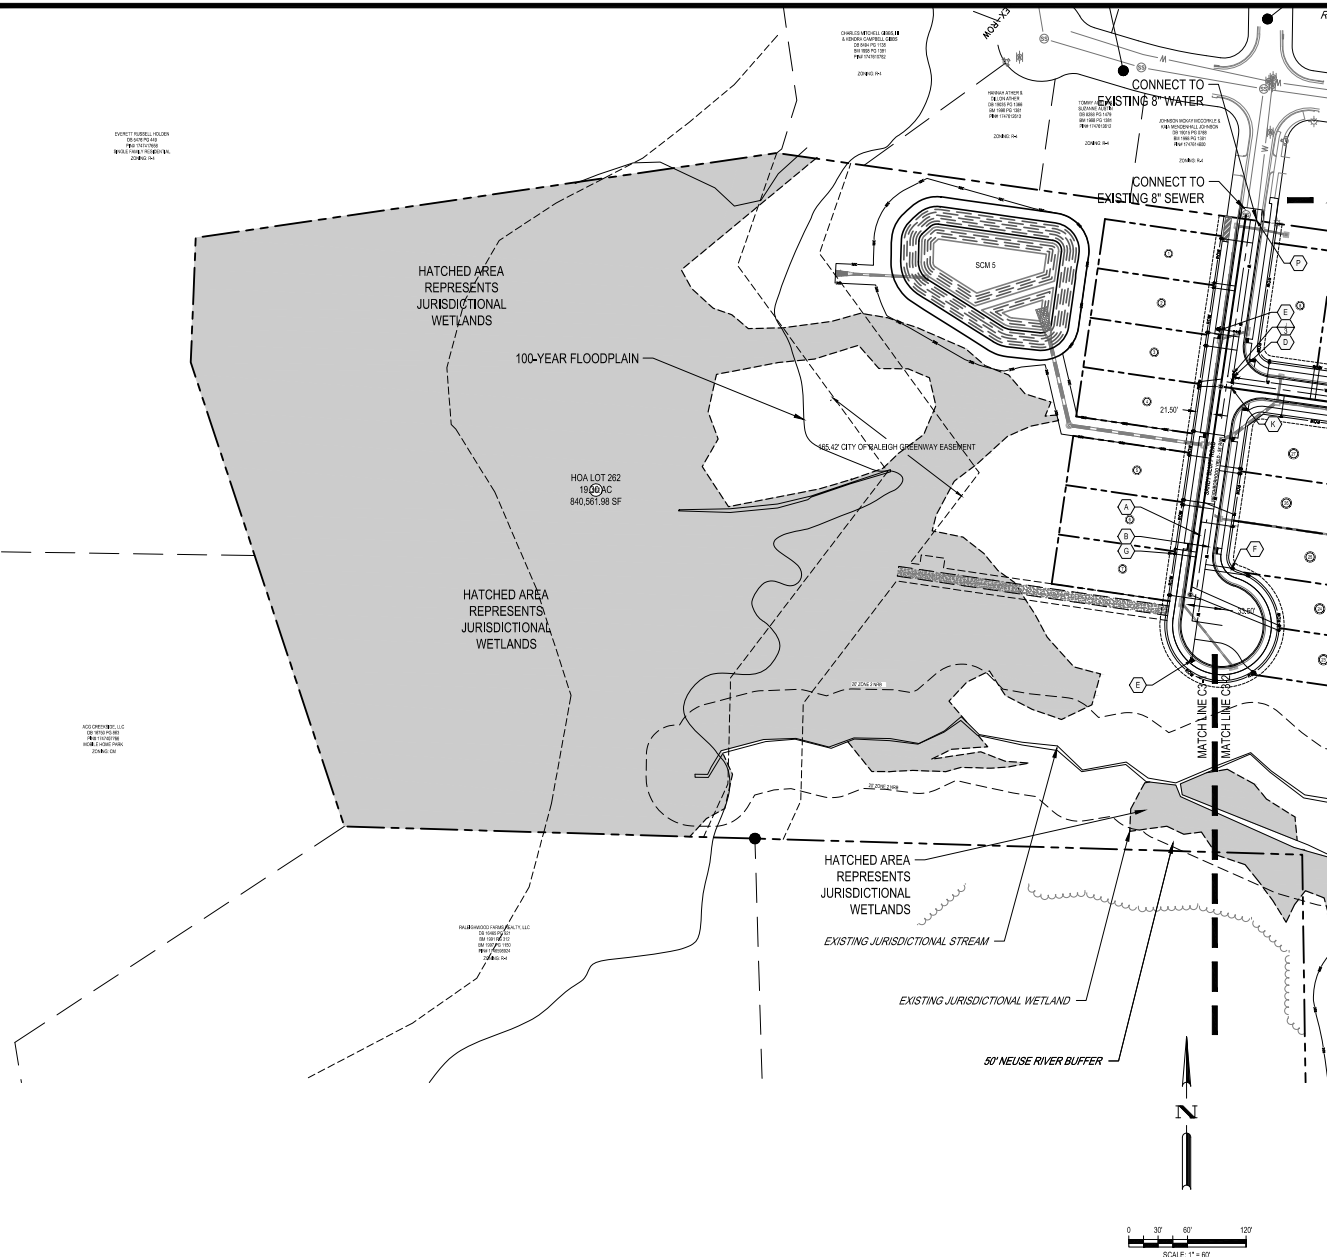
<p><b>MASTER SEWER PLAN</b></p> <p><b>EVERLEE SUBDIVISION</b></p> <p>PRELIMINARY SUBDIVISION PLAN</p> <p>WALKTOWN TOWN ROAD RALEIGH / NC 27616</p>	<p><b>LENNAR CORPORATION</b></p> <p>1100 PENNINGTON PARK DRIVE, SUITE 112 MONROVILLE / NC 27660</p>	<p><b>BGE</b></p> <p>5440 WALKER PARK BLVD, SUITE 102 RALEIGH / NC 27616 WWW.BGE.COM NC LICENSE #C-4397</p>	DESIGNED BY:	TWNP	10/4/2022	CITY OF RALEIGH COMMENTS - THIRD REVIEW
			DRAWN BY:	CDAP	7/22/2022	CITY OF RALEIGH COMMENTS - SECOND REVIEW
			REVIEWED BY:	JDU	3/18/2022	CITY OF RALEIGH COMMENTS - FIRST REVIEW
						REVISION DATE










PROPOSED UTILITY LEGEND	
	PROPOSED SANITARY
	PROPOSED FIRE WATER
	PROPOSED DOMESTIC WATER
	PROPOSED WATER LATERAL
	PROPOSED SEWER LATERAL

UTILITY LEGEND	
UTILITY KEY NOTES	
	8" SANITARY SEWER LINE
	8" SP WATER LINE
	8" 22.5' BEND W/ CONC. BLOCKING
	8" TEE W/ CONC. BLOCKING
	8" FIRE HYDRANT ASSEMBLY WITH 8" VALVE (TYP.)
	PROPOSED 8" DOMESTIC METER SERVICE LATERAL (TYP.)
	PROPOSED 8" SEWER SERVICE LATERAL
	8" BLOW OFF ASSEMBLY
	8" 45' BEND W/ CONC. BLOCKING
	8" VALVE
	WATERSANITARY SEWER CROSSING
	8" CROSS W/ CONC. BLOCKING
	8" TAPPING SLEEVE AND VALVE
	12"X6" TAPPING SLEEVE AND VALVE
	12" X 8" TSV
	8" WATERLINE CAP
	8" 11.25' BEND W/ CONC. BLOCKING

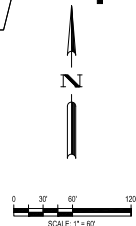NOTE:  
POSSIBLE WATER MARKS MAXIMUM ALLOWABLE JOINT DEFLECTIONS 8" MINIMUM RADIUS OF DEFLECTION FOR 8" DUCTILE IRON PIPE IS 230'. RADII ARE PRODUCED BY A SUCCESSION OF NOMINAL LENGTH OF PIPE FULLY DEFLECTED.



**ATTENTION CONTRACTORS**

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FILE NUMBER: 8430-00		DATE: 11/16/2022		C8-1	
UTILITY PLAN (1 OF 5)		EVERLEE SUBDIVISION PREMIER PARK DRIVE, SUITE 112 RALEIGH, NC 27606		LENNAR CORPORATION 1100 PERIMETER PARK DRIVE, SUITE 112 KANNISTVILLE, NC 27606	
DESIGNED BY: TWI/AP		DRAWN BY: CD/AP		REVIEWED BY: JDU	
CITY OF RALEIGH COMMENTS - THIRD REVIEW		CITY OF RALEIGH COMMENTS - SECOND REVIEW		CITY OF RALEIGH COMMENTS - FIRST REVIEW	
11/16/2022		11/16/2022		11/16/2022	
DATE		DATE		DATE	
REV		REV		REV	
DESCRIPTION		DESCRIPTION		DESCRIPTION	

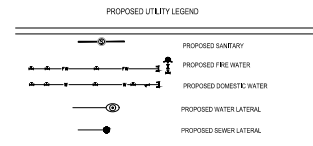
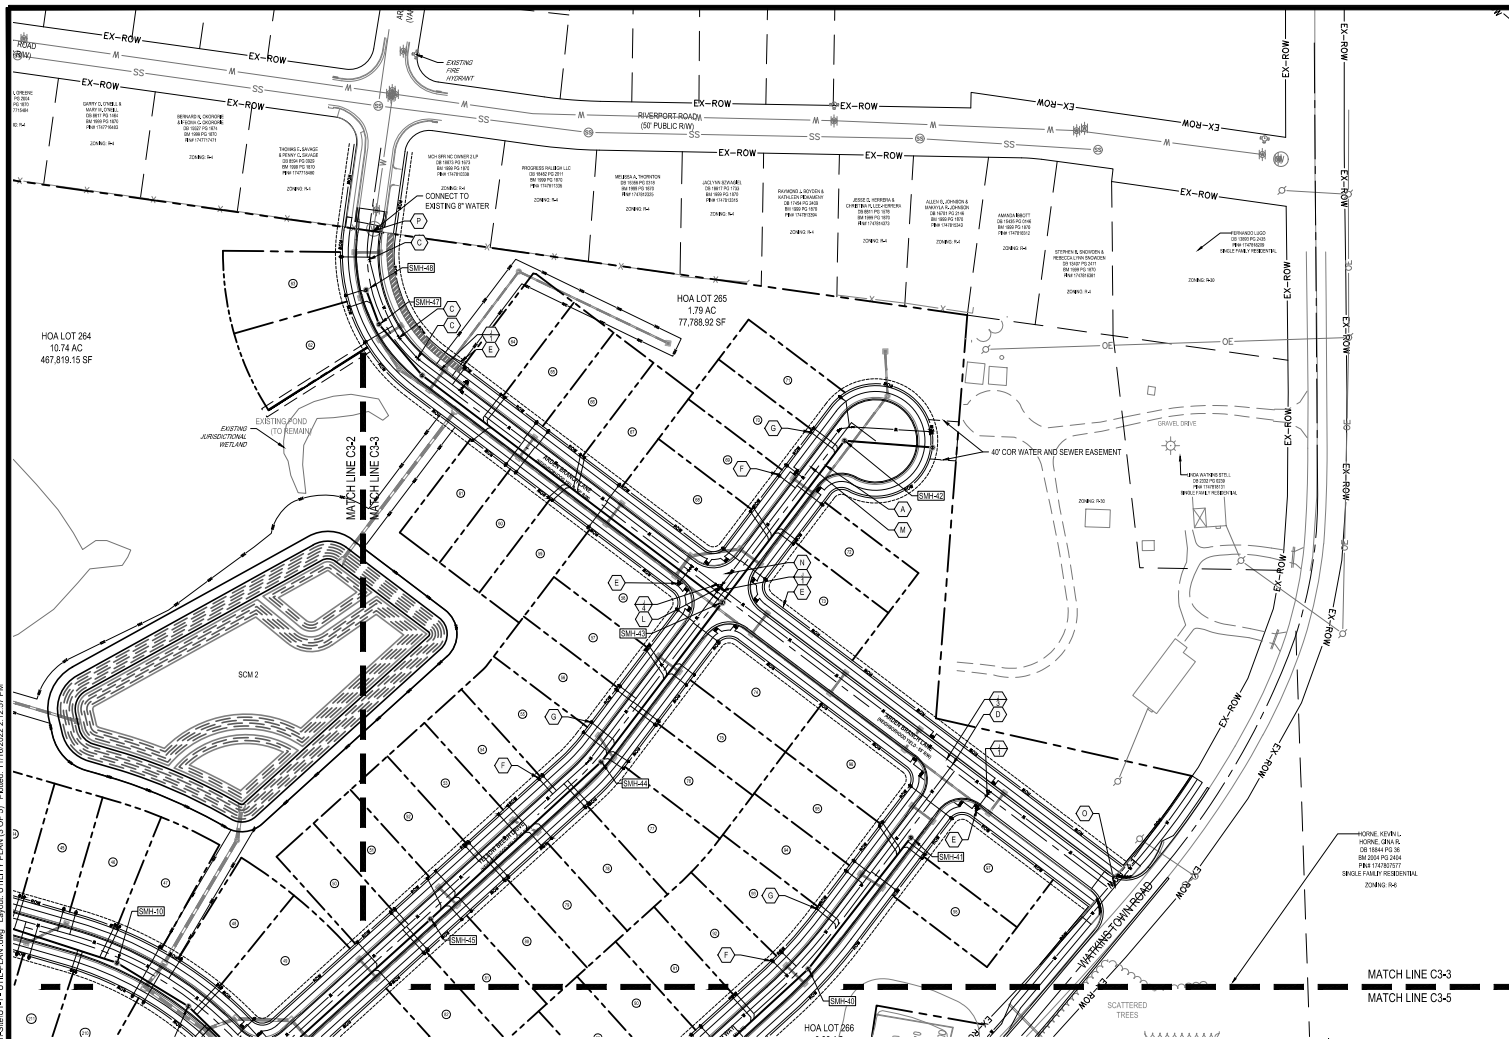




UTILITY PLAN (2 of 5)		FILE NUMBER: 84390-00	
EVERLEE SUBDIVISION PRELIMINARY SUBDIVISION PLAN		DATE: 11/16/2022	
1109 PERIMETER PARK DRIVE, SUITE 112 MCKINNVILLE / NC 27660 WWW.BCEINC.COM		C8-2	
LENNAR CORPORATION		DESIGNED BY: TWP/AF	
BCE		DRAWN BY: CDA/AD	
5440 WALKER PARK BLVD, SUITE 102 RALEIGH NC 27607 WWW.BCEINC.COM NC LICENSE #4-4987		REVIEWED BY: JDU	
		CITY OF RALEIGH COMMENTS - FIRST REVIEW	
		CITY OF RALEIGH COMMENTS - SECOND REVIEW	
		CITY OF RALEIGH COMMENTS - THIRD REVIEW	
		REV. DATE	
		DESCRIPTION	



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UTILITY KEY NOTES

A	8" SANITARY SEWER LINE
B	8" DP WATER LINE
C	8" 22.5° BEND IN CONC. BLOCKING
D	8" TEE IN CONC. BLOCKING
E	8" FIRE HYDRANT ASSEMBLY WITH 8" VALVE (TYP.)
F	PROPOSED 30' DOMESTIC METER SERVICE LATERAL (TYP.)
G	PROPOSED 4" SEWER SERVICE LATERAL
H	8" BLOW OFF ASSEMBLY
I	8" 45° BEND IN CONC. BLOCKING
J	8" VALVE
K	WATER/SANITARY SEWER CROSSING
L	8" CROSS IN CONC. BLOCKING
M	8" DP WATER LINE
N	8" 1/4" REDUCER
O	12" X 8" T&B
P	8" WATERLINE CAP
Q	8" 120° BEND IN CONC. BLOCKING
R	12" DP WATERLINE

NOTE: POTABLE WATER MAINT. MAXIMUM ALLOWABLE JOINT DEFLECTION IS 5" MINIMUM. RADIUS OF DEFLECTION FOR 8" SCHEDULE 80 PIPE IS 200'. AS SHOWN, PRODUCED BY A SUCCESSION OF NOMINAL LENGTH OF PIPE FULLY DEFLECTED.

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FILE NUMBER:  
8430-00  
DATE: 11/16/2022

C8-3

LENNAR  
CORPORATION

EVERLEE  
SUBDIVISION  
PRELIMINARY SUBDIVISION PLAN  
1100 PERIMETER PARK DRIVE, SUITE 112  
RALEIGH, NC 27606

UTILITY PLAN (3 OF 5)





5440 VALLEY PARK BLVD, SUITE 102  
RALEIGH, NC 27607  
NC LICENSE #C-4397

DESIGNED BY: TW/AP  
DRAWN BY: CD/AP  
REVIEWED BY: JDU

DATE	REV	DESCRIPTION
11/16/2022	1	CITY OF RALEIGH COMMENTS - THIRD REVIEW
11/16/2022	2	CITY OF RALEIGH COMMENTS - SECOND REVIEW
11/16/2022	3	CITY OF RALEIGH COMMENTS - FIRST REVIEW



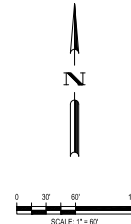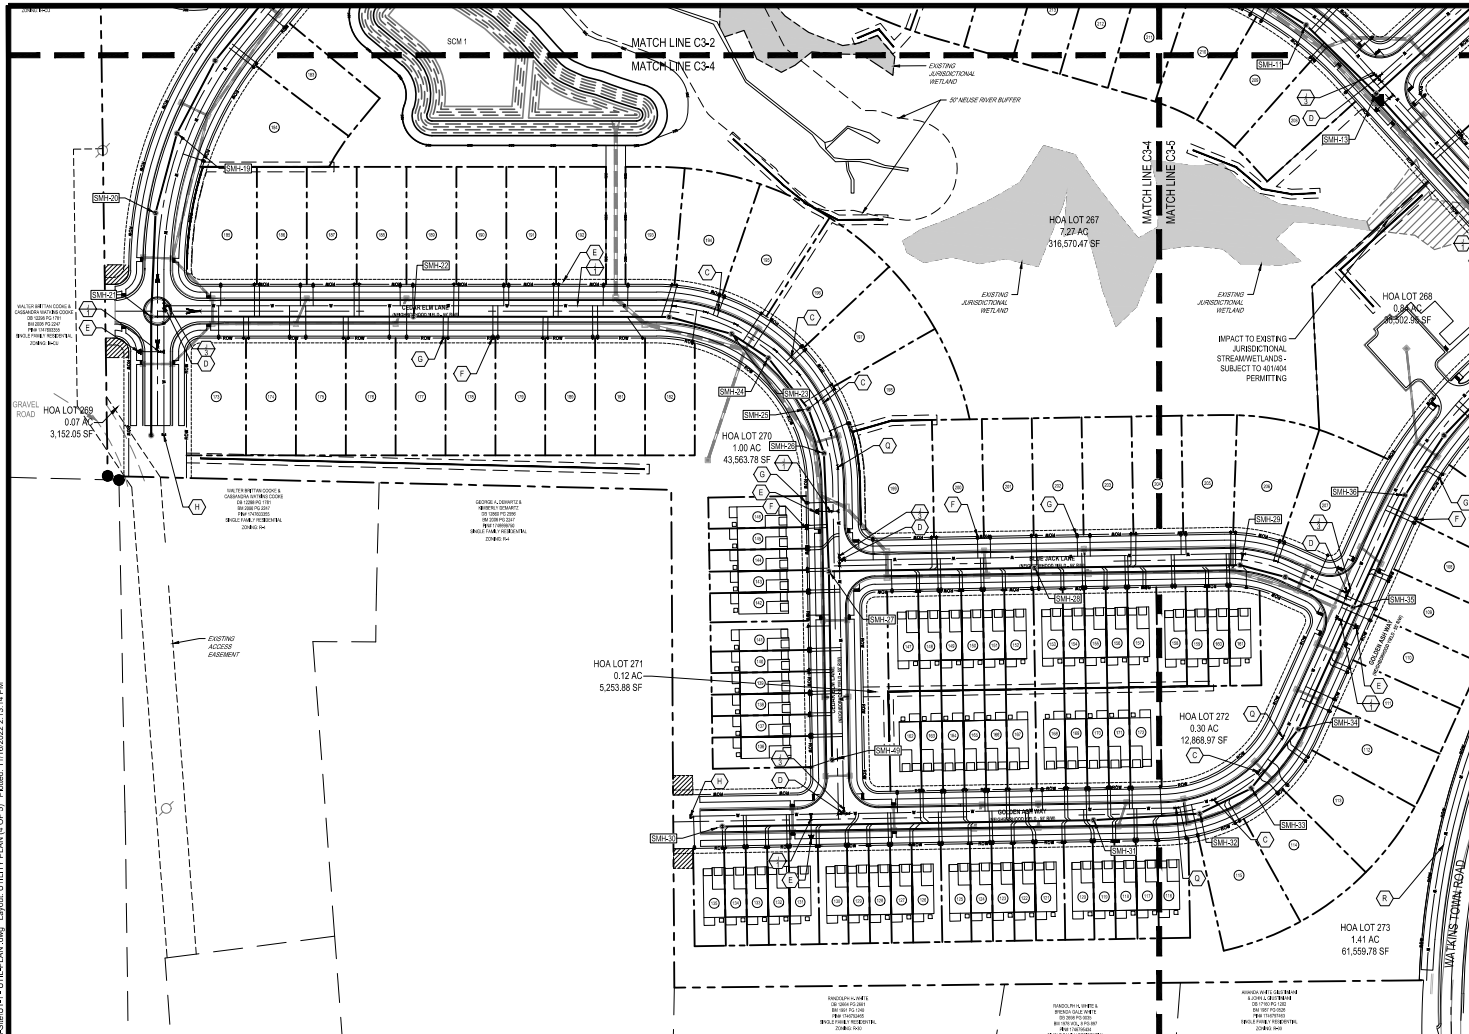

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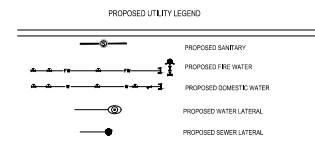
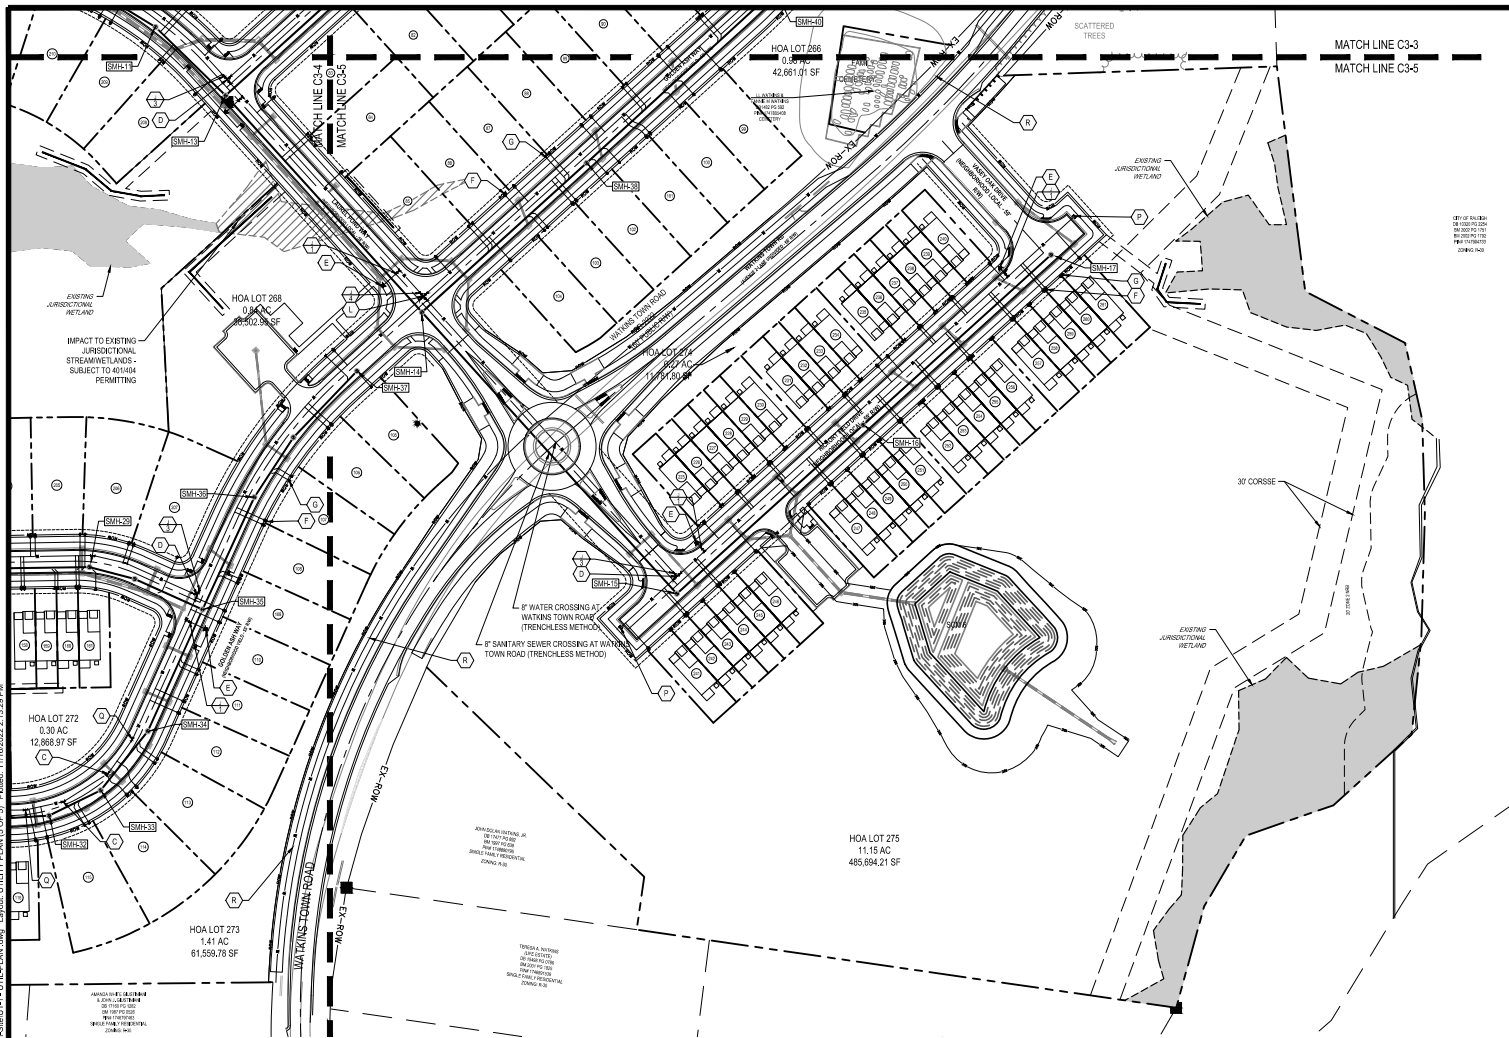
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<b>UTILITY PLAN (4 OF 5)</b>	<b>EVERLEE SUBDIVISION</b> PRELIMINARY SUBDIVISION PLAN	<b>LENNAR CORPORATION</b>	<b>BGE</b> 5440 WALTON PARK DRIVE SUITE 02 RALEIGH NC 27607 WWW.BGECOM.COM NC LICENSE #C-4397	DESIGNED BY: DRAWN BY: REVIEWED BY:	TW/AP CD/AP JDU	CITY OF RALEIGH COMMENTS - THIRD REVIEW: CITY OF RALEIGH COMMENTS - SECOND REVIEW: CITY OF RALEIGH COMMENTS - FIRST REVIEW:	10/4/2022 7/22/2022 3/1/2022	DATE	DESCRIPTION
FILE NUMBER: <b>8430-00</b>	DATE: 11/16/2022	<b>C8-4</b>							



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- UTILITY KEY NOTES
- A 8" SANITARY SEWER LINE
  - B 8" DP WATER LINE
  - C 8" 22.5° BEND IN CONC. BLOCKING
  - D 8" TEE W/ CONC. BLOCKING
  - E 8" FIRE HYDRANT ASSEMBLY WITH 8" VALVE (TYP)
  - F PROPOSED 30" DOMESTIC WATER SERVICE LATERAL (TYP)
  - G PROPOSED 4" SEWER SERVICE LATERAL
  - H 8" BLOW OFF ASSEMBLY
  - I 8" 45° BEND IN CONC. BLOCKING
  - J 8" VALVE
  - K WATER/SANITARY SEWER CROSSING
  - L 8" CROSS W/ CONC. BLOCKING
  - M 8" DP WATER LINE
  - N 8" 1/4" REDUCER
  - O 12" X 8" T&B
  - P 8" WATERLINE CAP
  - Q 8" 11/20° BEND IN CONC. BLOCKING
  - R 12" DP WATERLINE

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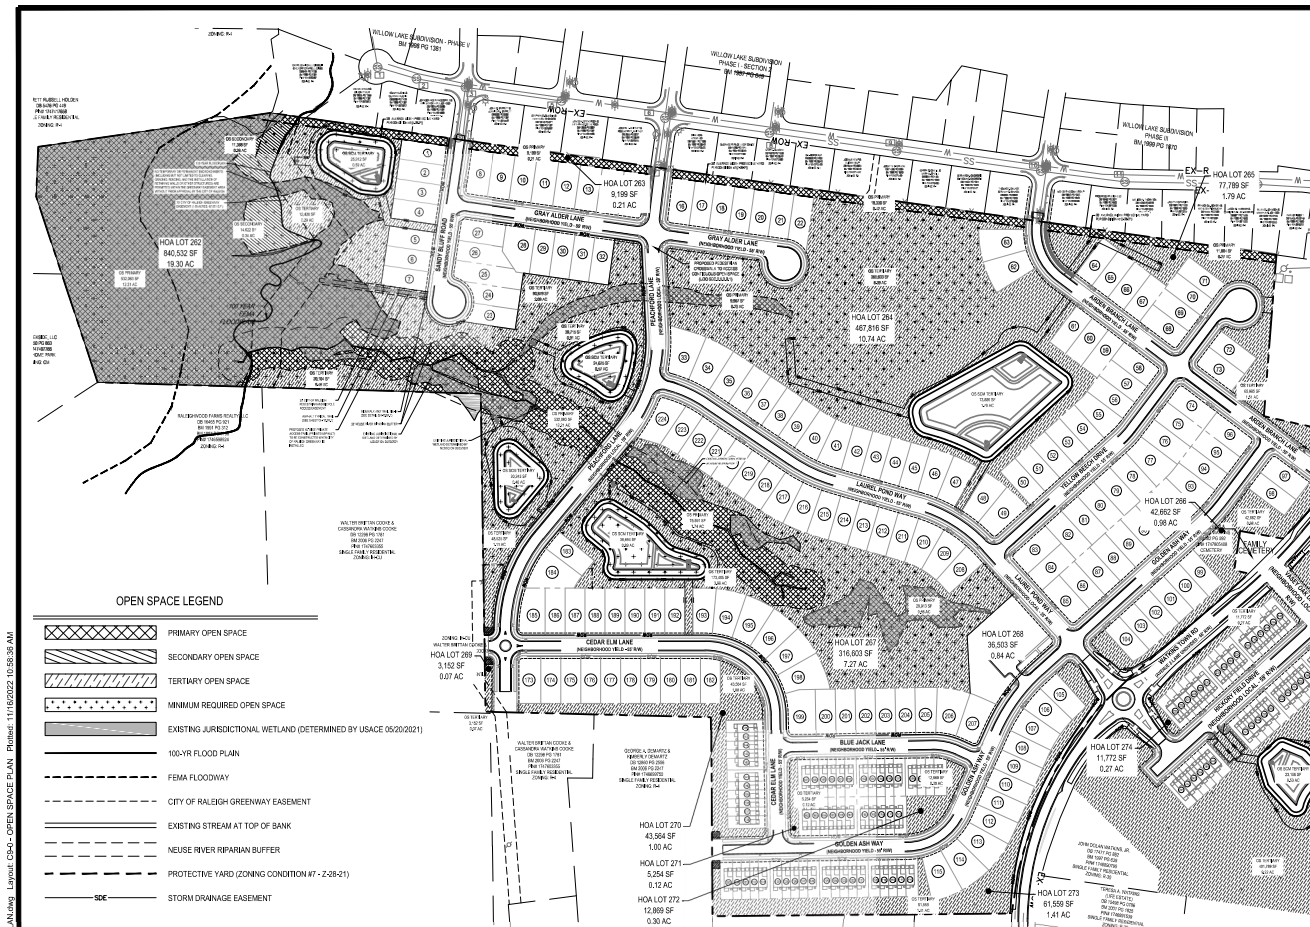


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DATE	REV	DESCRIPTION
11/16/2022	1	CITY OF RALEIGH COMMENTS - THIRD REVIEW
11/16/2022	2	CITY OF RALEIGH COMMENTS - SECOND REVIEW
11/16/2022	3	CITY OF RALEIGH COMMENTS - FIRST REVIEW
11/16/2022	4	CITY OF RALEIGH COMMENTS - FIRST REVIEW
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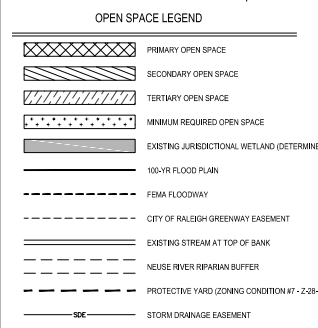
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DATE: 11/16/2022  
C8-5





HOA COMMON LOTS	PRIMARY OPEN SPACE AREA (SF)	PRIMARY OPEN SPACE AREA (ACRES)	SECONDARY OPEN SPACE AREA (SF)	SECONDARY OPEN SPACE AREA (ACRES)	TERTIARY OPEN SPACE AREA (SF)	TERTIARY OPEN SPACE AREA (ACRES)	SCM TERTIARY OPEN SPACE AREA (SF)	SCM TERTIARY OPEN SPACE AREA (ACRES)	TOTAL LOT AREA (SF)	TOTAL LOT AREA (ACRES)
LOT 262	532,063 SF	12.21 AC	25,990 SF	0.60 AC	211,849 SF	4.86 AC	70,830 SF	1.63 AC	840,532 SF	19.30 AC
LOT 263	9,199 SF	0.21 AC	N/A	N/A	N/A	N/A	N/A	N/A	9,199 SF	0.21 AC
LOT 264	28,267 SF	0.65 AC	N/A	N/A	365,633 SF	8.39 AC	73,886 SF	1.70 AC	467,816 SF	10.74 AC
LOT 265	11,854 SF	0.27 AC	N/A	N/A	65,965 SF	1.52 AC	N/A	N/A	77,789 SF	1.79 AC
LOT 266	N/A	N/A	N/A	N/A	42,862 SF	0.98 AC	N/A	N/A	42,862 SF	0.98 AC
LOT 267	134,504 SF	3.07 AC	N/A	N/A	173,405 SF	3.98 AC	38,694 SF	0.89 AC	316,003 SF	7.27 AC
LOT 268	N/A	N/A	N/A	N/A	N/A	N/A	N/A	N/A	36,503 SF	0.84 AC
LOT 269	N/A	N/A	N/A	N/A	3,152 SF	0.07 AC	N/A	N/A	3,152 SF	0.07 AC
LOT 270	N/A	N/A	N/A	N/A	43,594 SF	1.00 AC	N/A	N/A	43,594 SF	1.00 AC
LOT 271	N/A	N/A	N/A	N/A	5,254 SF	0.12 AC	N/A	N/A	5,254 SF	0.12 AC
LOT 272	N/A	N/A	N/A	N/A	12,869 SF	0.30 AC	N/A	N/A	12,869 SF	0.30 AC
LOT 273	N/A	N/A	N/A	N/A	61,559 SF	1.41 AC	N/A	N/A	61,559 SF	1.41 AC
LOT 274	N/A	N/A	N/A	N/A	11,772 SF	0.27 AC	N/A	N/A	11,772 SF	0.27 AC
LOT 275	60,762 SF	1.39 AC	N/A	N/A	401,789 SF	9.22 AC	23,156 SF	0.53 AC	485,707 SF	11.15 AC
OVERALL TOTAL	748,629 SF	17.13 AC	25,990 SF	0.60 AC	1,369,293 SF	32.12 AC	206,566 SF	4.75 AC	2,378,478 SF	54.80 AC

REQUIRED / PROVIDED OPEN SPACE PER 2-28-21:  
MIN % OF LOTS ABUTTING OPEN SPACE: 40% (0.4 X 267 LOTS) = 104 LOTS PER CONSERVATION STDS.  
MIN OPEN SPACE REQUIRED: 40% (0.4 X 86.86 ACRES) = 34.87 AC PER CONSERVATION STDS.  
PROVIDED LOTS ABUTTING OPEN SPACE: 72% (188 LOTS)  
OPEN SPACE PROVIDED: 2,378,444 SF (54.80 AC) 62.29%  
MIN. CONTIGUOUS AREA: 60% (0.6 X 34.87) = 20.92 AC PER CONSERVATION STDS.  
TOTAL CONTIGUOUS OPEN SPACE: HOA LOT 262 + HOA LOT 264 = 1,122,671 SF (25.77 AC) 74.33%



**PRIMARY OPEN SPACE**  
THE FOLLOWING ARE CONSIDERED PRIMARY OPEN SPACE AREAS AND MUST BE THE FIRST AREAS DESIGNATED AS REQUIRED OPEN SPACE:  
1. FLOODWAY AREAS  
2. NATURAL RESOURCE BUFFERS REQUIRED ALONG PRIMARY AND SECONDARY WATERCOURSES (SEE OPEN SPACE BONUS ALLOWANCE IN SEC. 9.2.3 A.1.D)  
3. SLOPES ABOVE 2% OF AT LEAST 5,000 SQUARE FEET CONTIGUOUS AREA  
4. JURISDICTIONAL WETLANDS UNDER FEDERAL LAW (EPA/ANR-AT-CT SECTION 404) THAT MEET THE DEFINITION APPLIED BY THE ARMY CORPS OF ENGINEERS, AND  
5. TRANSITIONAL PROTECTIVE YARDS.  
**SECONDARY OPEN SPACE**  
THE FOLLOWING ARE CONSIDERED SECONDARY OPEN SPACE AREAS AND MUST BE INCLUDED AS REQUIRED OPEN SPACE ONCE THE PRIMARY OPEN SPACE AREAS ARE EXHAUSTED:  
1. FLOODWAY FRINGS AND/OR FUTURE CONDITIONS FLOOD HAZARD AREAS.  
**TERTIARY OPEN SPACE**  
THE FOLLOWING ARE CONSIDERED TERTIARY OPEN SPACE AREAS AND MUST BE INCLUDED AS REQUIRED OPEN SPACE ONCE THE PRIMARY AND SECONDARY OPEN SPACE AREAS ARE EXHAUSTED:  
1. HISTORIC, ARCHEOLOGICAL, AND CULTURAL SITES, CEMETERIES AND BURIAL GROUNDS;  
2. SIGNIFICANT NATURAL FEATURES AND SCENIC VIEWSHEDS SUCH AS REDGUM LINES, FIELD BORDERS, MEADOWS, FIELDS, RIVER VIEWS, NATURAL WOODLANDS THAT CAN BE SEEN FROM ROADWAYS AND SERVE TO BLOCK THE VIEW OF THE PROJECT IN WHOLE OR IN PART;  
3. HABITAT FOR FEDERALLY LISTED ENDANGERED OR THREATENED SPECIES;  
4. INDIVIDUAL EXISTING HEALTHY TREES GREATER THAN 10 INCHES DBH AND THEIR CRITICAL ROOT ZONES;  
5. AREAS THAT CONNECT TO NEIGHBORING OPEN SPACE, TRAILS OR GREENWAYS;  
6. SLOES WITH SEVERE LIMITATIONS DUE TO DRAINAGE PROBLEMS; AND  
7. TREE CONSERVATION AREAS.

NO TEMPORARY OR PERMANENT ENCROACHMENTS (INCLUDING BUT NOT LIMITED TO CLEARING, GRADING, FENCING, AND THE INSTALLATION OF RETAINING WALLS OR OTHER STRUCTURES) ARE PERMITTED WITHIN THE GREENWAY EASEMENT AREA WITHOUT PRIOR APPROVAL BY THE CITY OF RALEIGH.

- SITE NOTES (ZONING CONDITIONS APPROVED UNDER 2-28-21)**
- A MINIMUM OF 40% OF THE NET SITE AREA SHALL BE DESIGNATED AS OPEN SPACE. OPEN SPACE MEETING THIS 40% REQUIREMENT SHALL HAVE A MINIMUM WIDTH OF 50 FEET, ANY OPEN SPACE IN EXCESS OF 40% OF THE NET SITE AREA SHALL NOT BE REQUIRED TO MEET THE 50 FEET WIDTH REQUIREMENT.
  - A MINIMUM OF 40% OF LOTS SHALL ABUT OPEN SPACE.
  - A MINIMUM OF 60% OF THE OPEN SPACE MEETING THE 40% NET SITE AREA REQUIREMENT SHALL BE CONTIGUOUS.

**NOTE:**  
CONTRACTOR SHALL INCLUDE IN BASE BID COSTS FOR ALL CITY REQUIRED BACKFILL, SOIL AMENDMENT REQUIREMENTS WITHIN LANDSCAPING AREAS INCLUDING PLANTING STRIPS.

**ATTENTION CONTRACTORS**

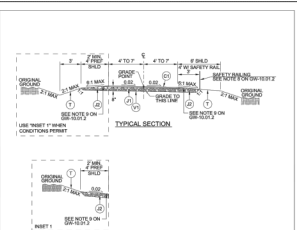
The Construction Contractor responsible for the extension of water, sewer, and/or roads, as approved in these plans, is responsible for contacting the **Public Works Department** at (919) 996-2400 and the **Public Utilities Department** at (919) 996-2340 at least twenty four hours prior to beginning any of these construction.

Failure to notify both City Departments in advance of beginning construction, will result in the issuance of monetary fines, and require consolidation of any water or sewer facilities not inspected as a result of this notification failure.


Failure to call for inspection, Initial a Downstream Plug, have Permitted Plans on the jobsite, or any other Violation of City of Raleigh Standards will result in a Fine and Possible Exclusion from future work in the City of Raleigh.



Know what's below.  
Call before you dig.



PAVEMENT SCHEDULE	
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2. ALL LANDSCAPE AREAS SHALL RECEIVE A MINIMUM OF 1" OF CLEAN FIBRIL FOSPHOR TOP SOILS, ROCKS, ROOTS, AND OTHER DELETERIOUS MATERIALS.
3. ALL PLANT MATERIAL SHALL BE HEALTHY, UNIFORM OF SPECIES AND FREE FROM PESTS AND DISEASE.
4. PLANT MATERIAL SHALL BE CONTAINER GROWN, FIELD GROWN, BALLED AND BURLAPED OR AS INDICATED ON THE PLANT LIST.
5. NEW TREES SHALL MEET REQUIREMENTS AS SPECIFIED. ALL NEW TREES MUST HAVE STRAIGHT TRUNKS WITH STRONG CENTRAL LEADERS INTACT TO THE TOP OF THE CROWN UNLESS MULTITRUNK TREES ARE SPECIFIED. ALL REQUIRED TREES SHALL BE TYPICAL OF THEIR SPECIES AND VARIETY, HAVE NORMAL GROWTH, VIGOR, HAVE WELL-DEVELOPED BRANCHES, BE FREE FROM DISEASE AND DEFECTS, AND BE FREE FROM DAMAGE WITH MAJOR GROUND ROOTS SHALL NOT BE DAMAGED. BRANCHES SHALL BE COORDINATE WITH COORDINATE BRANCHING WILL NOT BE ACCEPTED. TREES THAT HAVE BEEN SHEARED, TOPPED OR CUT BACK TO MATCH THE BRANCHING STRUCTURE WILL NOT BE ACCEPTED.
6. ALL MATERIALS ARE SUBJECT TO THE APPROVAL OF THE LANDSCAPE ARCHITECT BEFORE, DURING, AND AFTER INSTALLATION.
7. TREES SHALL BE CULVED OR STAKED AS SHOWN IN THE DETAILS OR OTHER LOCAL JURISDICTION.
8. AFTER BEING CULVED AT THE NURSERY, SLOPE, ALL TREES "IN LEAF" SHALL BE ACCUMULATED FOR TWO (2) WEEKS UNDER A MIST SYSTEM PRIOR TO INSTALLATION.
9. PLANT MATERIAL SHALL BE MEASURED AND SIZED ACCORDING THE LATEST EDITION OF THE AMERICAN STANDARDS FOR NURSERY STOCK (ANSI Z66.1) FOR A MINIMUM FOR QUALITY REQUIREMENTS.
10. WHERE SHOWN ON THE PLANS AND DETAILS, PLANTING BEDS ARE TO BE COMPLETELY COVERED WITH A MINIMUM OF FOUR INCHES (4") OF MULCH. MULCH SHALL BE ACQUIRED FROM A LOCAL SOURCE AND HARVESTED IN A SUSTAINABLE MANNER.
11. PLANT SPACING BE INDICATED ON PLANT SCHEDULE. UNLESS OTHERWISE NOTED, IT IS THE CONTRACTOR'S RESPONSIBILITY TO PROVIDE FULL PLANT COVERAGE IN ALL LANDSCAPE AREAS AS SPECIFIED IN THE PLANT SCHEDULE NOTES.
12. PLANT SPACING IS AS INDICATED ON PLANT SCHEDULE. UNLESS OTHERWISE NOTED, IT IS THE CONTRACTOR'S RESPONSIBILITY TO PROVIDE FULL PLANT COVERAGE IN ALL LANDSCAPE AREAS AS SPECIFIED IN THE PLANT SCHEDULE.
13. TREES OVERHANGING SIDEWALKS AND PARKING OR PEDESTRIAN AREAS SHALL HAVE A MINIMUM CLEAR TRUNK BRANCHING HEIGHT OF EIGHT FEET (8').
14. TREES OVERHANGING VISIBILITY EASEMENTS OR ROOSTER VANS SHALL HAVE A MINIMUM CLEAR TRUNK HEIGHT OF EIGHT FEET (8').
15. TREES OVERHANGING VISIBILITY EASEMENTS SHALL HAVE A MINIMUM CLEAR TRUNK HEIGHT OF EIGHT FEET (8').
16. TREES OVERHANGING PUBLIC STREET PAVEMENT SHALL HAVE A MINIMUM CLEAR TRUNK OF FOURTEEN FEET (14').
17. TREES NOT LOCATED IN A LANDSCAPE BED ARE TO RECEIVE A FOUR FOOT (4') DIAMETER MULCHING.
18. PLANT BEDS AND LAWN AREAS SHALL HAVE A 4" VERTICAL

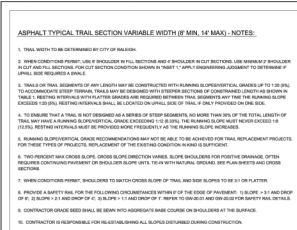1. EXISTING COMPOST PLANTING MEDIA MUST BE REMOVED AND REPLACED WITH 2" OF PLANTING MIX. EXISTING SOIL MAY BE UNCOMPACTED TO A DEPTH OF 2" AND AMENDED TO MEET PLANTING MIX REQUIREMENTS.
2. WHEN EXISTING OR NEW CROWN OR RENOVATED SITES, MUST MEET THE MINIMUM PLANTING MIX SPECIFICATIONS. SOIL AMENDMENTS OR FRESH PLANTING MIX ARE OFTEN NEEDED FOR PLANTING AREAS AT SITES WHERE THE ORIGINAL TOPSOILS, 6" OF POOR QUALITY, HAD BEEN COMPACTED OR WHERE TOPSOIL HAS BEEN COMPLETELY REMOVED DUE TO GRADING.
3. PLANTING MIX SHALL BE A WELL-BLENDED COMBINATION OF TOPSOIL, FINE ROOTS, STEDS, AND OTHER EXTENDED RELEASE FERTILIZERS. PLANTING MIX SHALL CONTAIN NOT AN NUTRIENT MATERIALS UNLESS OTHERWISE SPECIFIED.
4. ACCEPTABLE PLANTING MEDIA SHALL CONTAIN THE FOLLOWING SPECIFIED PERCENTAGES OF CONSTITUENTS:
  - CLAY - MINIMUM 10% MAXIMUM 42%, SAND - MINIMUM 20% MAXIMUM 28%, SILT - MINIMUM 20% MAXIMUM 55%.
  - ORGANIC MATTER - MINIMUM 5% MAXIMUM 10%.
  - ORGANIC MATTER DERIVED AS COMPOST/HUMUS SUCH AS SAWDUST OR LEAF LITTER THAT HAS COMPLETED THE DECOMPOSITION PROCESS.
  - ORGANIC MATTER SHALL BE DETERMINED BY A QUALIFIED LABORATORY.
5. PLANTING MIX SHALL HAVE NORMAL CONTENTS OF NITROGEN, PHOSPHORUS, POTASSIUM, CALCIUM, MAGNESIUM, SULFUR AND PROPER MICROELEMENT LEVELS. NUTRIENT LEVELS MUST SATISFY GROWING RATES AS RECOMMENDED BY LAB REPORT. OF THE EXISTING OR PLANNED PLANTING MIX.


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Know what's below.  
Call before you dig.



EVERLEE SUBDIVISION  
100 PERIMETER PARK DRIVE, SUITE 102  
RALEIGH, NC 27606  
2024.01.14

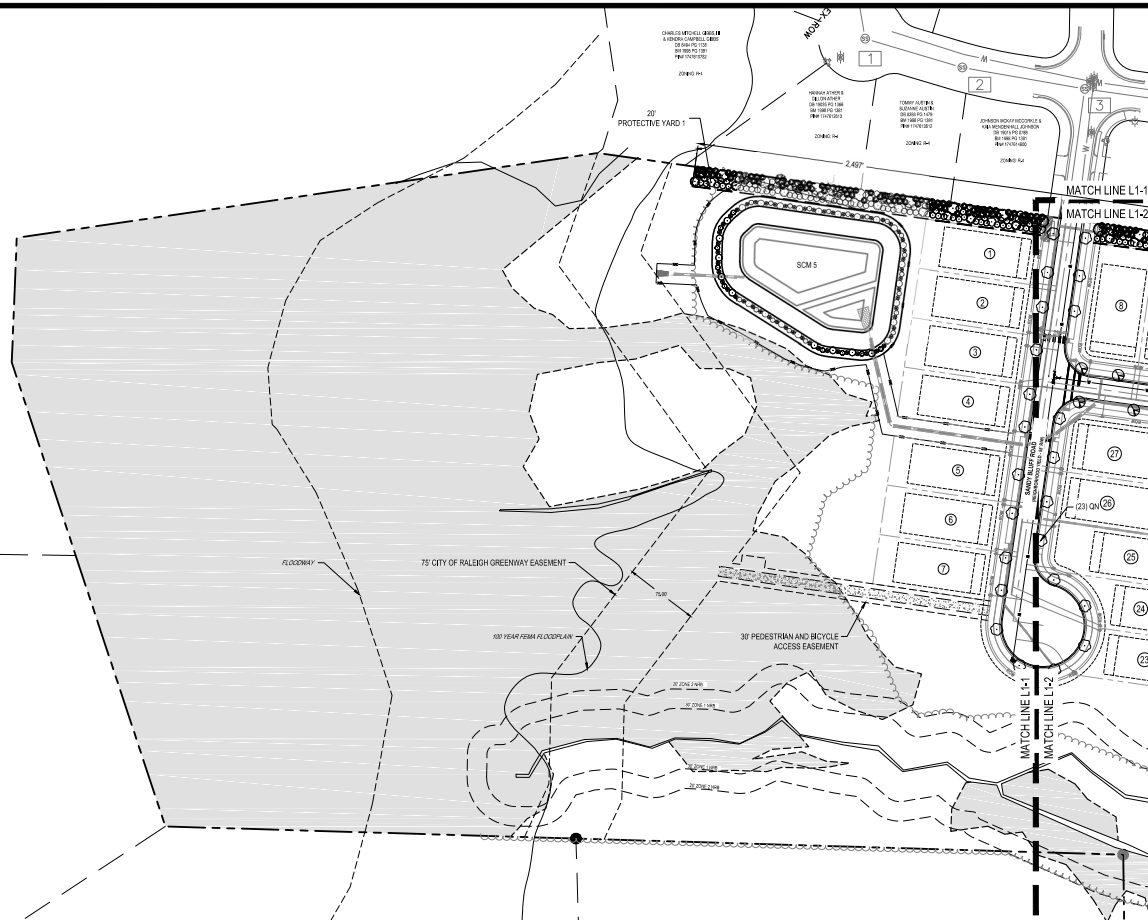ACQUINTELL, LLC  
100 PERIMETER PARK DRIVE, SUITE 102  
RALEIGH, NC 27606  
2024.01.14



### LANDSCAPE REQUIREMENTS

#### STREET TREE REQUIREMENTS

1 SHADE TREE EVERY 40' C/C  
STREET TREES SHALL BE INSTALLED AND MAINTAINED IN ACCORDANCE WITH THE REQUIREMENTS OF CHAPTER 2 OF THE CITY TREE MANUAL

LAUREL POND WAY  
REQUIRED: 2.84' LENGTH (BOTH SIDES) / 40' = 67 TREES  
PROVIDED: 74 TREES

GOLDEN ASH WAY  
REQUIRED: 3.80' LENGTH (BOTH SIDES) / 40' = 96 TREES  
PROVIDED: 96 TREES

YELLOW BEECH DRIVE  
REQUIRED: 1.77' LENGTH (BOTH SIDES) / 40' = 45 TREES  
PROVIDED: 45 TREES

CEDAR ELM LANE  
REQUIRED: 2.21' LENGTH (BOTH SIDES) / 40' = 56 TREES  
PROVIDED: 60 TREES

BLUE JACK LANE  
REQUIRED: 1.04' LENGTH (BOTH SIDES) / 40' = 27 TREES  
PROVIDED: 27 TREES

GRAY ALDER LANE  
REQUIRED: 1.71' LENGTH (BOTH SIDES) / 40' = 43 TREES  
PROVIDED: 43 TREES

HICKORY FIELD DRIVE  
REQUIRED: 1.23' LENGTH (BOTH SIDES) / 40' = 31 TREES  
PROVIDED: 31 TREES

VASEY OAK DRIVE  
REQUIRED: 2.74' LENGTH (BOTH SIDES) / 40' = 7 TREES  
PROVIDED: 7 TREES

PEACHFORD LANE  
REQUIRED: 3.01' LENGTH (BOTH SIDES) / 40' = 76 TREES  
PROVIDED: 76 TREES

SANDY BLUFF RD  
REQUIRED: 8.84' LENGTH (BOTH SIDES) / 40' = 23 TREES  
PROVIDED: 23 TREES

ARDEN BRANCH LANE  
REQUIRED: 2.12' LENGTH (BOTH SIDES) / 40' = 53 TREES  
PROVIDED: 53 TREES

PROTECTIVE YARDS  
TYPE B1 PROTECTIVE YARD (20' WIDTH)  
REQUIRED: 4 SHADE TREES PER 100' (2.49' LENGTH / 100') X 4 TREES = 100 SHADE TREES  
4 UNDERSTORY TREES PER 100' (2.49' LENGTH / 100') X 4 TREES = 100 UNDERSTORY TREES  
40 SHRUBS PER 100' (2.49' LENGTH / 100') X 40 SHRUBS = 999 SHRUBS (3' MIN. HEIGHT)

PROVIDED: 100 SHADE TREES  
100 UNDERSTORY TREES  
1000 SHRUBS

NOTE: ALL AREAS TO BE REPLANTED WITHIN THE DESIGNATED UNPLANTED AREAS ARE TO BE PLANTED PER COR UDD 6.1.5.A.6.

PLANT SCHEDULE						
LARGE SHADE TREES						
SYMBOL	CODE	QTY	COMMON NAME	BOTANICAL NAME	HEIGHT	CALIPER
	AF	73	SOUTHERN SUGAR MAPLE	ACER FLORIDANUM	10' MIN.	3" CAL. MIN.
	QN	68	NUTTALL OAK	QUERCUS NUTTALL	10' MIN.	3" CAL. MIN.
	UP	68	AMERICAN ELM	ULMUS AMERICANA	10' MIN.	3" CAL. MIN.
	LT	117	TULIP POPLAR	LIRIODENDRON TULIPIFERA	10' MIN.	3" CAL. MIN.
	QP	129	WILLOW OAK	QUERCUS PHELLOS	10' MIN.	3" CAL. MIN.
	QA	60	WHITE OAK	QUERCUS ALBA	10' MIN.	3" CAL. MIN.
	QF	91	SOUTHERN RED OAK	QUERCUS FALCATA	10' MIN.	3" CAL. MIN.
	GB	60	GINKGO	GINKGO BILOBA	10' MIN.	3" CAL. MIN.
MEDIUM SHADE TREES						
SYMBOL	CODE	QTY	COMMON NAME	BOTANICAL NAME	HEIGHT	CALIPER
	GB	69	EUROPEAN HORNBEAM	CARPANUS BETULUS	10' MIN.	3" CAL. MIN.
UNDERSTORY TREES						
SYMBOL	CODE	QTY	COMMON NAME	BOTANICAL NAME	HEIGHT	CALIPER
	PC	50	CAROLINA CHERRY LAUREL	PRUNUS CAROLINIANA	6' MIN.	1.5" CAL. MIN.
	AG	50	SERVICEBERRY	AMELANCHIER GRANDIFLORA	6' MIN.	1.5" CAL. MIN.
SHRUBS						
SYMBOL	CODE	QTY	COMMON NAME	BOTANICAL NAME	HEIGHT	CALIPER
	IC	1,406	DWARF BURFORD HOLLY	ILEX CORNUTA 'DWARF BURFORD'	10' MIN.	3 GAL.
	PL	431	ENGLISH LAUREL	PRUNUS LAUROCEARUS	10' MIN.	3 GAL.
PLANTING SYMBOLS						
	QUANTITY		NOTE TO CONTRACTOR: IF GRAPHIC REPRESENTATION OF PLANTINGS ON PLANS DOES NOT MATCH QUANTITIES IN PLANT LIST, GRAPHIC REPRESENTATION OF PLANTINGS ON PLANS WILL GOVERN.			



### ATTENTION CONTRACTORS

The Construction Contractor responsible for the extension of water, sewer, and/or gas, as approved in these plans, is responsible for contacting the **Public Works Department** at (919) 996-2409 and the **Public Utilities Department** at (919) 996-2340 at least twenty-four hours prior to beginning any of their construction.

Failure to notify both City Departments in advance of beginning construction, will result in the issuance of monetary fines, and require consultation of any water or sewer facilities not inspected as a result of this notification failure.

Failure to call for inspection, install a Downstream Plug, have Permitted Plans on the jobsite, or any other Violation of City of Raleigh Standards will result in a Fine and Possible Exclusion from future work in the City of Raleigh.

FILE NUMBER:  
8430-00  
DATE: 11/16/2022

L1-1

LENNAR  
CORPORATION  
1100 PERIMETER PARK DRIVE, SUITE 102  
RALEIGH, NC 27606  
NC LICENSE 6C-27860

EVERLEE  
SUBDIVISION  
100 PERIMETER PARK DRIVE, SUITE 102  
RALEIGH, NC 27606  
NC LICENSE 6C-27860

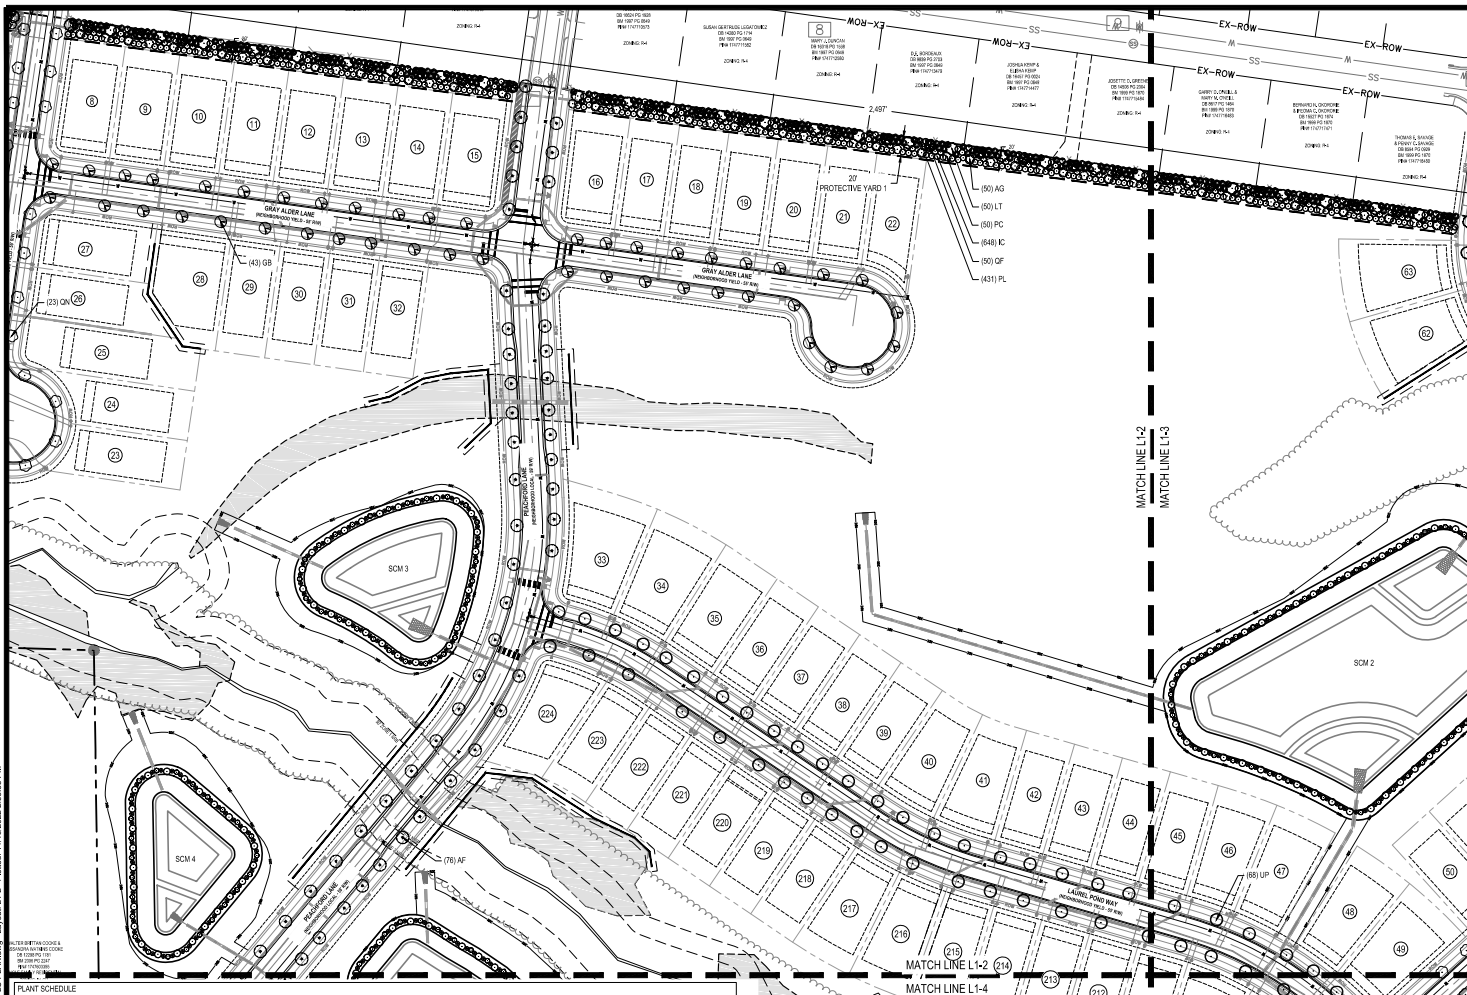
LANDSCAPE PLAN (1 OF 5)




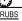


DATE	DESCRIPTION	REV
1/16/2022	CITY OF RALEIGH COMMENTS - THIRD REVIEW	1
7/22/2022	CITY OF RALEIGH COMMENTS - SECOND REVIEW	2
3/16/2022	CITY OF RALEIGH COMMENTS - FIRST REVIEW	3

DESIGNED BY: TWI/AP  
DRAWN BY: CD/AP  
REVIEWED BY: JDU  
© 2022



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PLANT SCHEDULE							
LARGE SHADE TREES							
	CODE	QTY	COMMON NAME	BOTANICAL NAME	HEIGHT	GAL/PER	NOTES
	AF	73	SOUTHERN SUGAR MAPLE	ACER FLORIDANUM	10' MIN.	3" CAL. MIN.	STREET TREE, WELL MATCHED SPECIMENS / FULL CROWN
	ON	68	NUTTALL OAK	QUERCUS NUTTALLI	10' MIN.	3" CAL. MIN.	STREET TREE, WELL MATCHED SPECIMENS / FULL CROWN
	UP	68	AMERICAN ELM	ULMUS AMERICANA	10' MIN.	3" CAL. MIN.	STREET TREE, WELL MATCHED SPECIMENS / FULL CROWN
	LT	117	TULIP POPLAR	LIRIODENDRON TULIPIFERA	10' MIN.	3" CAL. MIN.	STREET TREE, PROTECTIVE YARD TREE, WELL MATCHED SPECIMENS / FULL CROWN
	QP	139	WILLOW OAK	QUERCUS PHELLOS	10' MIN.	3" CAL. MIN.	STREET TREE, WELL MATCHED SPECIMENS / FULL CROWN
	QA	60	WHITE OAK	QUERCUS ALBA	10' MIN.	3" CAL. MIN.	STREET TREE, WELL MATCHED SPECIMENS / FULL CROWN
	QF	60	SOUTHERN RED OAK	QUERCUS FALCATA	10' MIN.	3" CAL. MIN.	PROTECTIVE YARD TREE, WELL MATCHED SPECIMENS / FULL CROWN
	GB	60	GINKO	GINKGO BILBOA	10' MIN.	3" CAL. MIN.	STREET TREE, WELL MATCHED SPECIMENS / FULL CROWN
MEDIUM SHADE TREES							
	CODE	QTY	COMMON NAME	BOTANICAL NAME	HEIGHT	GAL/PER	NOTES
	CB	89	EUROPEAN HORNBEEAN	CARPINUS BETULUS	10' MIN.	3" CAL. MIN.	STREET TREE, WELL MATCHED SPECIMENS / FULL CROWN
UNDERSTORY TREES							
	CODE	QTY	COMMON NAME	BOTANICAL NAME	HEIGHT	GAL/PER	NOTES
	PC	50	CAROLINA CHERRY LAUREL	PRUNUS CAROLINIANA	6' MIN.	1.5" CAL. MIN.	PROTECTIVE YARD TREE, WELL MATCHED SPECIMEN / FULL CROWN
	AG	50	SERVICEBERRY	AMELANCHIER GRANDIFLORA	6' MIN.	1.5" CAL. MIN.	PROTECTIVE YARD TREE, WELL MATCHED SPECIMENS / FULL CROWN
SHRUBS							
	CODE	QTY	COMMON NAME	BOTANICAL NAME	HEIGHT	CONTAINER	NOTES
	IZ	1,406	DWARF BURFORD HOLLY	ILEX CORNUTA DWARF BURFORD	18" MIN.	3 GAL.	PROTECTIVE YARD SHRUB, WELL MATCHED SPECIMENS / FULL CROWN
	PL	431	ENGLISH LAUREL	PRUNUS LAUROCEARUS	18" MIN.	3 GAL.	PROTECTIVE YARD SHRUB, WELL MATCHED SPECIMENS / FULL CROWN
PLANTING SYMBOLS							
	QTY	PLANT CODE	NOTE TO CONTRACTOR: IF GRAPHIC REPRESENTATION OF PLANTINGS ON PLANS DOES NOT MATCH QUANTITIES IN PLANT LIST, GRAPHIC REPRESENTATION OF PLANTINGS ON PLANS WILL GOVERN.				

## LANDSCAPE REQUIREMENTS

### STREET TREE REQUIREMENTS

1 SHADE TREE EVERY 40' O.C.  
STREET TREES SHALL BE INSTALLED AND MAINTAINED IN ACCORDANCE WITH THE REQUIREMENTS OF CHAPTER 2 OF THE CITY TREE MANUAL.

LAUREL POND WAY	REQUIRED: 2,847' LENGTH (BOTH SIDES) / 40' = 67 TREES PROVIDED: 74 TREES
GOLDEN ASH WAY	REQUIRED: 3,808' LENGTH (BOTH SIDES) / 40' = 96 TREES PROVIDED: 96 TREES
YELLOW BEECH DRIVE	REQUIRED: 1,772' LENGTH (BOTH SIDES) / 40' = 45 TREES PROVIDED: 45 TREES
CEDAR ELM LANE	REQUIRED: 2,210' LENGTH (BOTH SIDES) / 40' = 56 TREES PROVIDED: 60 TREES
BLUE JACK LANE	REQUIRED: 1,048' LENGTH (BOTH SIDES) / 40' = 27 TREES PROVIDED: 27 TREES
GRAY ALDER LANE	REQUIRED: 1,718' LENGTH (BOTH SIDES) / 40' = 43 TREES PROVIDED: 43 TREES
HICKORY FIELD DRIVE	REQUIRED: 1,234' LENGTH (BOTH SIDES) / 40' = 31 TREES PROVIDED: 31 TREES
VASEY OAK DRIVE	REQUIRED: 274' LENGTH (BOTH SIDES) / 40' = 7 TREES PROVIDED: 7 TREES
PEACHTREE LANE	REQUIRED: 3,010' LENGTH (BOTH SIDES) / 40' = 76 TREES PROVIDED: 76 TREES
SANDY BLUFF RD	REQUIRED: 884' LENGTH (BOTH SIDES) / 40' = 23 TREES PROVIDED: 23 TREES
ARDEN BRANCH LANE	REQUIRED: 2,102' LENGTH (BOTH SIDES) / 40' = 53 TREES PROVIDED: 53 TREES

### PROTECTIVE YARDS

PROTECTIVE YARD 1	REQUIRED: TYPE B1 PROTECTIVE YARD (20' WIDTH) 4 SHADE TREES PER 100' (2,497' LENGTH / 100') X 4 TREES = 100 SHADE TREES 4 UNDERSTORY TREES PER 100' (2,497' LENGTH / 100') X 4 TREES = 100 UNDERSTORY TREES 40 SHRUBS PER 100' (2,497' LENGTH / 100') X 40 SHRUBS = 999 SHRUBS (3' MIN. HEIGHT) PROVIDED: 100 SHADE TREES 100 UNDERSTORY TREES 1000 SHRUBS
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NOTE: ALL AREAS TO BE REPLANTED WITHIN THE DESIGNATED UNPLANTED AREAS ARE TO BE PLANTED PER COR UDD 9.1.3.A.6.

### ATTENTION CONTRACTORS

The Construction Contractor responsible for the extension of water, sewer, and/or gas, as approved in these plans, is responsible for contacting the **Public Works Department** at (919) 996-2400 and the **Public Utilities Department** at (919) 996-2340 at least twenty four hours prior to beginning any of their construction.

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Failure to call for inspection, install a Downstream Plug, have Permitted Plans on the jobsite, or any other Violation of City of Raleigh Standards will result in a Fine and Possible Exclusion from future work in the City of Raleigh.



Know what's below.  
Call before you dig.



FILE NUMBER:	8430-00
DATE:	11/16/2022
L-1-2	

DESIGNED BY: TW/AP

DRAWN BY: CD/AP

REVIEWED BY: JDU

10/4/2022 CITY OF RALEIGH COMMENTS - THIRD REVIEW

7/22/2022 CITY OF RALEIGH COMMENTS - SECOND REVIEW

3/16/2022 CITY OF RALEIGH COMMENTS - FIRST REVIEW

DESCRIPTION

DATE

REV

EVERLEE SUBDIVISION

PHASE 2 SUBDIVISION PLAN

1100 PERIMETER PARK DRIVE, SUITE 112

RALEIGH, NC 27607

MONROVILLE, NC 27606

NC LICENSE 6C-2897

LENNAR CORPORATION

5440 VALLEY PARK BLVD, SUITE 102

RALEIGH, NC 27607

MONROVILLE, NC 27606















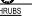



NC LICENSE 6C-2897

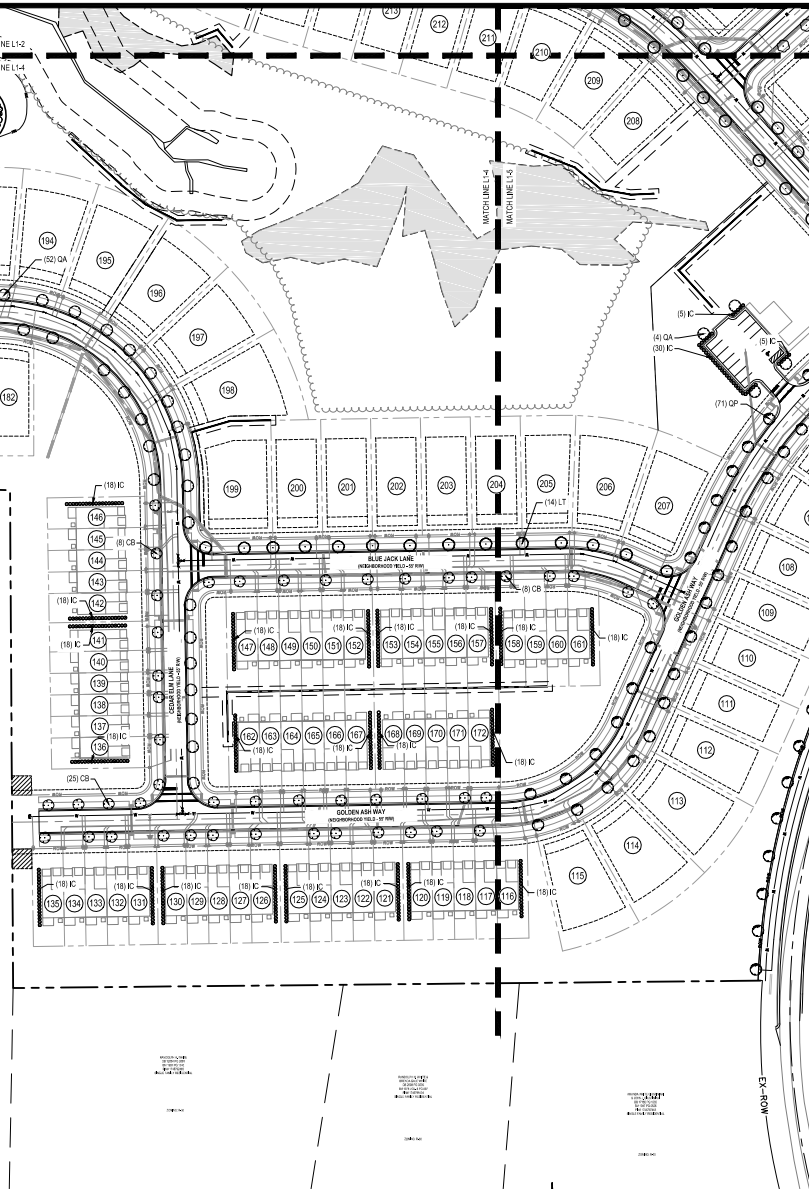
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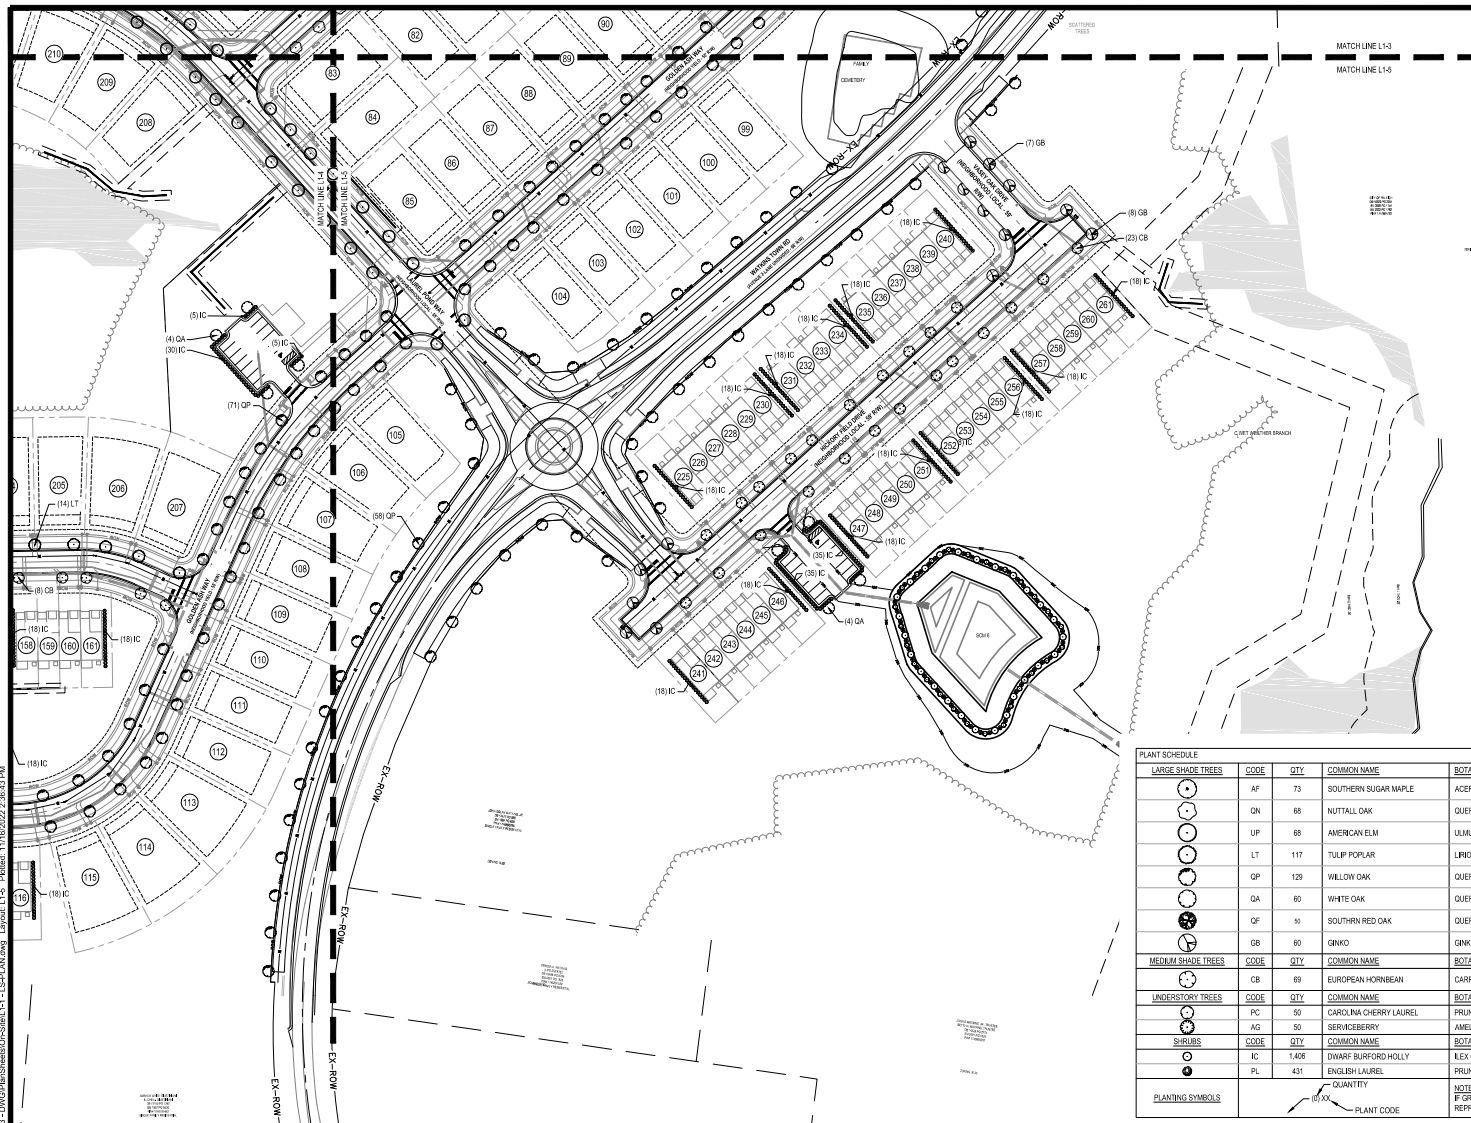

















PLANT SCHEDULE							
LARGE SHADE TREES							
	CODE	QTY	COMMON NAME	BOTANICAL NAME	HEIGHT	CALIPER	NOTES
	AF	73	SOUTHERN SUGAR MAPLE	ACER FLORIDANUM	10' MIN.	3" CAL. MIN.	STREET TREE, WELL MATCHED SPECIMENS / FULL CROWN
	ON	68	NUTTALL OAK	QUERCUS NUTTALLII	10' MIN.	3" CAL. MIN.	STREET TREE, WELL MATCHED SPECIMENS / FULL CROWN
	UP	68	AMERICAN ELM	ULMUS AMERICANA	10' MIN.	3" CAL. MIN.	STREET TREE, WELL MATCHED SPECIMENS / FULL CROWN
	LT	117	TULIP POPLAR	LIRIODENDRON TULIPIFERA	10' MIN.	3" CAL. MIN.	STREET TREE, PROTECTIVE YARD TREE, WELL MATCHED SPECIMENS / FULL CROWN
	OP	129	WILLOW OAK	QUERCUS PHELLOS	10' MIN.	3" CAL. MIN.	STREET TREE, WELL MATCHED SPECIMENS / FULL CROWN
	QA	60	WHITE OAK	QUERCUS ALBA	10' MIN.	3" CAL. MIN.	STREET TREE, WELL MATCHED SPECIMENS / FULL CROWN
	QF	50	SOUTHERN RED OAK	QUERCUS FALCATA	10' MIN.	3" CAL. MIN.	PROTECTIVE YARD TREE, WELL MATCHED SPECIMENS / FULL CROWN
	GR	60	GINKGO	GINKGO BILOBA	10' MIN.	3" CAL. MIN.	STREET TREE, MALE / FRUITLESS ONLY, WELL MATCHED SPECIMENS / FULL CROWN
MEDIUM SHADE TREES							
	CODE	QTY	COMMON NAME	BOTANICAL NAME	HEIGHT	CALIPER	NOTES
	CB	69	EUROPEAN HORNBEECH	CARPINUS BETULUS	10' MIN.	3" CAL. MIN.	STREET TREE, WELL MATCHED SPECIMENS / FULL CROWN
UNDERSTORY TREES							
	CODE	QTY	COMMON NAME	BOTANICAL NAME	HEIGHT	CALIPER	NOTES
	PC	50	CAROLINA CHERRY LAUREL	PRUNUS CAROLINIANA	8' MIN.	1.5" CAL. MIN.	PROTECTIVE YARD TREE, WELL MATCHED SPECIMENS / FULL CROWN
	AG	50	SERVICEBERRY	AMELANCHIER GRANDIFLORA	8' MIN.	1.5" CAL. MIN.	PROTECTIVE YARD TREE, WELL MATCHED SPECIMENS / FULL CROWN
SHRUBS							
	CODE	QTY	COMMON NAME	BOTANICAL NAME	HEIGHT	CONTAINER	NOTES
	IC	1,456	DWARF BURFORD HOLLY	ILEX CORNUTA 'DWARF BURFORD'	18" MIN.	3 GAL.	PROTECTIVE YARD SHRUB, WELL MATCHED SPECIMENS / FULL CROWN
	PL	431	ENGLISH LAUREL	PRUNUS LAUROCEARUS	18" MIN.	3 GAL.	PROTECTIVE YARD SHRUB, WELL MATCHED SPECIMENS / FULL CROWN
PLANTING SYMBOLS							
		NOTE TO CONTRACTOR: IF GRAPHIC REPRESENTATION OF PLANTINGS ON PLANS DOES NOT MATCH QUANTITIES IN PLANT LIST, GRAPHIC REPRESENTATION OF PLANTINGS ON PLANS WILL GOVERN.					








## LANDSCAPE REQUIREMENTS

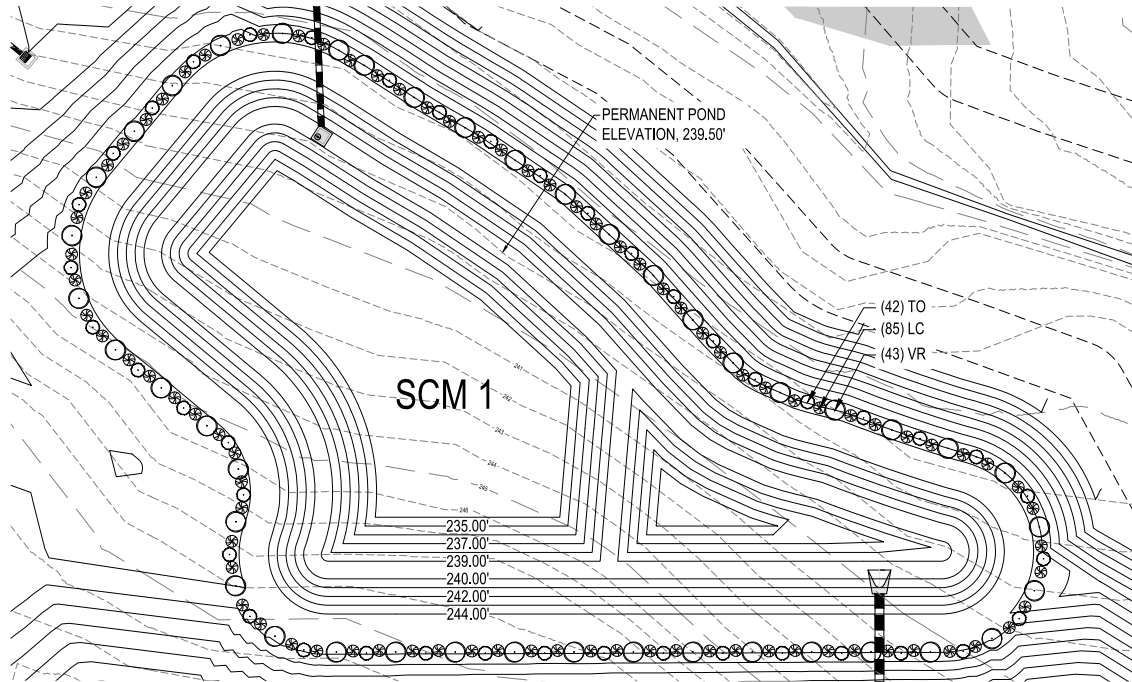PLANT SCHEDULE								
LARGE SHADE TREES		CODE	QTY	COMMON NAME	BOTANICAL NAME	HEIGHT	CALIPER	NOTES
	AF	73	SOUTHERN SUGAR MAPLE	ACER FLORIDANUM	10' MIN.	3" CAL. MIN.	STREET TREE, WELL MATCHED SPECIMENS / FULL CROWN	
	QN	68	NUTTALL OAK	QUERCUS NUTTALLI	10' MIN.	3" CAL. MIN.	STREET TREE, WELL MATCHED SPECIMENS / FULL CROWN	
	UP	68	AMERICAN ELM	ULMUS AMERICANA	10' MIN.	3" CAL. MIN.	STREET TREE, WELL MATCHED SPECIMENS / FULL CROWN	
	LT	117	TULIP POPLAR	LIRIODENDRON TULIPIFERA	10' MIN.	3" CAL. MIN.	STREET TREE, PROTECTIVE VARD TREE, WELL MATCHED SPECIES / FULL CROWN	
	QP	129	WILLOW OAK	QUERCUS PHellos	10' MIN.	3" CAL. MIN.	STREET TREE, WELL MATCHED SPECIMENS / FULL CROWN	
	QA	60	WHITE OAK	QUERCUS ALBA	10' MIN.	3" CAL. MIN.	STREET TREE, WELL MATCHED SPECIMENS / FULL CROWN	
	QF	50	SOUTHERN RED OAK	QUERCUS FALCATA	10' MIN.	3" CAL. MIN.	PROTECTIVE VARD TREE, WELL MATCHED SPECIMENS / FULL CROWN	
	GB	60	GINKO	GINKGO BILOBA	10' MIN.	3" CAL. MIN.	STREET TREE, MALE FRUITLESS ONLY, WELL MATCHED SPECIMENS / FULL CROWN	
MEDIUM SHADE TREES	CODE	QTY	COMMON NAME	BOTANICAL NAME	HEIGHT	CALIPER	NOTES	
	GB	60	EUROPEAN HORNBURN	CAYANUS BETULUS	10' MIN.	3" CAL. MIN.	STREET TREE, WELL MATCHED SPECIMENS / FULL CROWN	
UNDERSTORY TREES	CODE	QTY	COMMON NAME	BOTANICAL NAME	HEIGHT	CALIPER	NOTES	
	PC	40	CAROLINA CHERRY LAUREL	PRUNUS CAROLINIANA	8' MIN.	1.5" CAL. MIN.	PROTECTIVE VARD TREE, WELL MATCHED SPECIMENS / FULL CROWN	
	AG	50	SERVICEBERRY	AMELANCHIER GRANDIFLORA	8' MIN.	1.5" CAL. MIN.	PROTECTIVE VARD TREE, WELL MATCHED SPECIMENS / FULL CROWN	
SHRUBS	CODE	QTY	COMMON NAME	BOTANICAL NAME	HEIGHT	CONTAINER	NOTES	
	IC	1406	DWARF BURFORD HOLLY	ILEX CORNUTA DWARF BURFORD	10' MIN.	3 GAL	PROTECTIVE VARD SHRUB, WELL PLANE SHRUB, WELL MATCHED SPECIES / FULL CROWN	
	PL	431	ENGLISH LAUREL	PRUNUS LAURUSCERASUS	10' MIN.	3 GAL	PROTECTIVE VARD SHRUB, WELL MATCHED SPECIMENS / FULL CROWN	
NOTE TO CONTRACTOR: IF GRAPHIC REPRESENTATION OF PLANTINGS ON PLANS DOES NOT MATCH QUANTITIES IN PLANT LIST, GRAPHIC REPRESENTATION OF PLANTINGS ON PLANS WILL GOVERN.								
PLANTING SYMBOLS		QUANTITY		PLANT CODE				

### ATTENTION CONTRACTORS





SCM 1 PLANT SCHEDULE							
SMALL MATURING TREES	CODE	QTY	COMMON NAME	BOTANICAL NAME	HEIGHT	GALLIES	NOTES
○	TD	47	SHADY OAK	QUERCUS LAEVOGARRA	8' MIN.	12" GAL. MIN.	SPREADER/SHRUBBER UNDERSTORY TREE WITH MATCHED SPHERICAL FULL CROWN
SHRUBS	CODE	QTY	COMMON NAME	BOTANICAL NAME	HEIGHT	GALLIES	NOTES
●	LC	85	LEONURUS	LEONURUS CHINENSE	10' MIN.	3 GAL.	SPREADER/SHRUBBER UNDERSTORY TREE WITH MATCHED SPHERICAL FULL CROWN
○	VR	43	LEONURUS	LEONURUS CHINENSE	10' MIN.	3 GAL.	SPREADER/SHRUBBER UNDERSTORY TREE WITH MATCHED SPHERICAL FULL CROWN
PLANTING SYMBOL	QUANTITY		NOTE TO CONTRACTOR				
○	(10) XX		IF GRAPHIC REPRESENTATION OF PLANTINGS ON PLANS DOES NOT MATCH QUANTITIES IN PLANT LIST, GRAPHIC REPRESENTATION OF PLANTINGS ON PLANS WILL GOVERN.				



**ATTENTION CONTRACTORS**

The Construction Contractor responsible for the extension of water, sewer, and/or gas, as approved in these plans, is responsible for contacting the **Public Works Department** at (919) 996-2409 and the **Public Utilities Department** at (919) 996-2409 at least twenty-four hours prior to beginning any of their construction.

**Failure** to notify both City Departments in advance of beginning construction, will result in the issuance of monetary fines, and require resubmission of any water or sewer facilities not inspected as a result of this notification failure.

**Failure** to call for inspection, install a Downstream Plug, have Permitted Plans on the jobsite, or any other Violation of City of Raleigh Standards will result in a Fine and Possible Exclusion from future work in the City of Raleigh.

FILE NUMBER:	8430-00
DATE:	11/16/2022
L2-0	

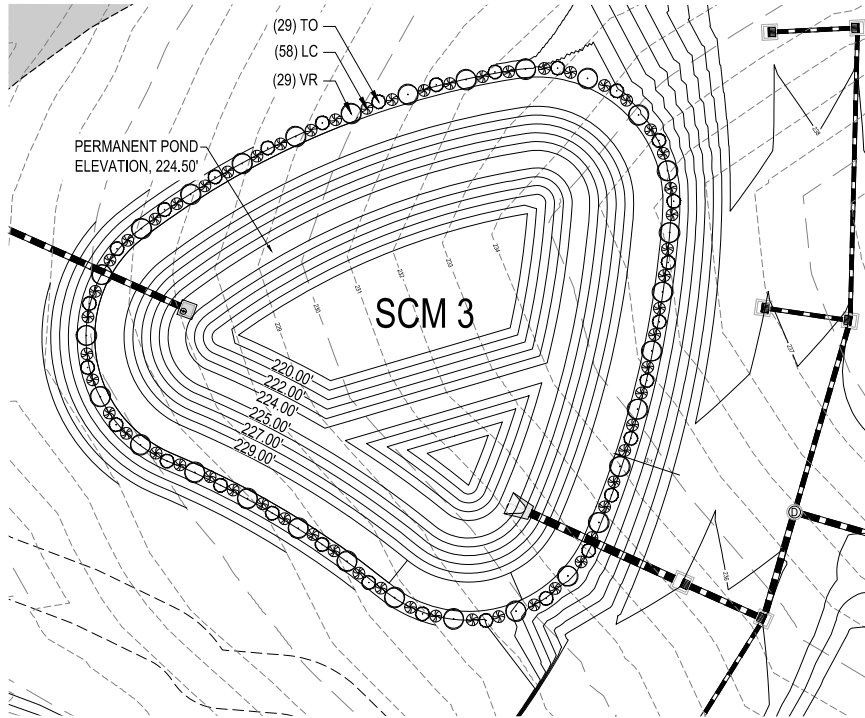
EVERLEE SUBDIVISION	LENNAR CORPORATION	EGE
PHASE 1 SUBDIVISION PLAN	1100 PERIMETER PARK DRIVE, SUITE 112	5440 VALLEY PARK BLVD, SUITE 102
WAKE COUNTY, NC 27616	MOOREVILLE, NC 27606	RALEIGH, NC 27607
NC LICENSE #C-27016	NC LICENSE #C-27060	NC LICENSE #C-2897

DESIGNED BY:	CD/AP
REVIEWED BY:	JDU
DATE:	11/16/2022
REV:	1
DESCRIPTION:	CITY OF RALEIGH COMMENTS - THIRD REVIEW
DATE:	11/16/2022
REV:	1
DESCRIPTION:	CITY OF RALEIGH COMMENTS - SECOND REVIEW
DATE:	11/16/2022
REV:	1
DESCRIPTION:	CITY OF RALEIGH COMMENTS - FIRST REVIEW












SCM 3 PLANT SCHEDULE						
SMALL MATURING TREES	CODE	QTY	COMMON NAME	BOTANICAL NAME	HEIGHT	GAUPEIS
	TO	29	CAROLINA CHERRYLAUREL	PRUNUS CAROLINIANA	12' MIN.	12' GAL. MIN.
SHRUBS	CODE	QTY	COMMON NAME	BOTANICAL NAME	HEIGHT	GAUPEIS
	LC	58	LOROPETALUM	LOROPETALUM CHINENSE	10' MIN.	3 GAL.
VINES	CODE	QTY	COMMON NAME	BOTANICAL NAME	HEIGHT	GAUPEIS
	VR	29	LEATHERLEAF MEUNIER	NEURUM RHYTIDOPHYLLUM	10' MIN.	3 GAL.
NOTE TO CONTRACTOR: IF GRAPHIC REPRESENTATION OF PLANTINGS ON PLANS DOES NOT MATCH QUANTITIES IN PLANT LIST, GRAPHIC REPRESENTATION OF PLANTINGS ON PLANS WILL GOVERN.						
PLANTING SYMBOL	QUANTITY (U) XX PLANT CODE					

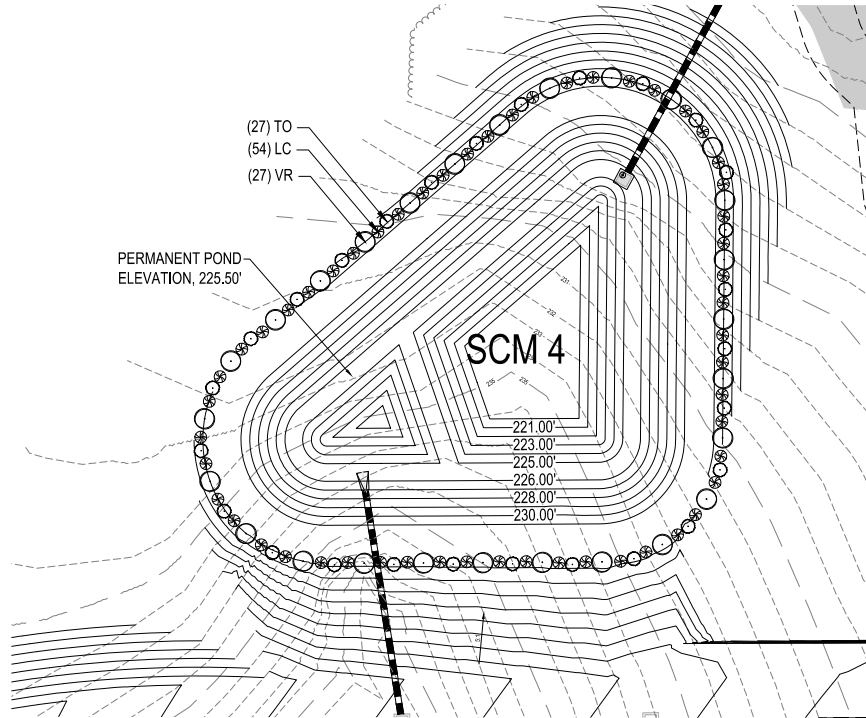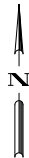

SCM 4 PLANT SCHEDULE						
SMALL MATURING TREES	CODE	QTY	COMMON NAME	BOTANICAL NAME	HEIGHT	GAUPEIS
	TO	27	CAROLINA CHERRYLAUREL	PRUNUS CAROLINIANA	12' MIN.	12' GAL. MIN.
SHRUBS	CODE	QTY	COMMON NAME	BOTANICAL NAME	HEIGHT	GAUPEIS
	LC	54	LOROPETALUM	LOROPETALUM CHINENSE	10' MIN.	3 GAL.
VINES	CODE	QTY	COMMON NAME	BOTANICAL NAME	HEIGHT	GAUPEIS
	VR	27	LEATHERLEAF MEUNIER	NEURUM RHYTIDOPHYLLUM	10' MIN.	3 GAL.
NOTE TO CONTRACTOR: IF GRAPHIC REPRESENTATION OF PLANTINGS ON PLANS DOES NOT MATCH QUANTITIES IN PLANT LIST, GRAPHIC REPRESENTATION OF PLANTINGS ON PLANS WILL GOVERN.						
PLANTING SYMBOL	QUANTITY (U) XX PLANT CODE					

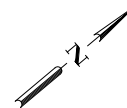

**ATTENTION CONTRACTORS**

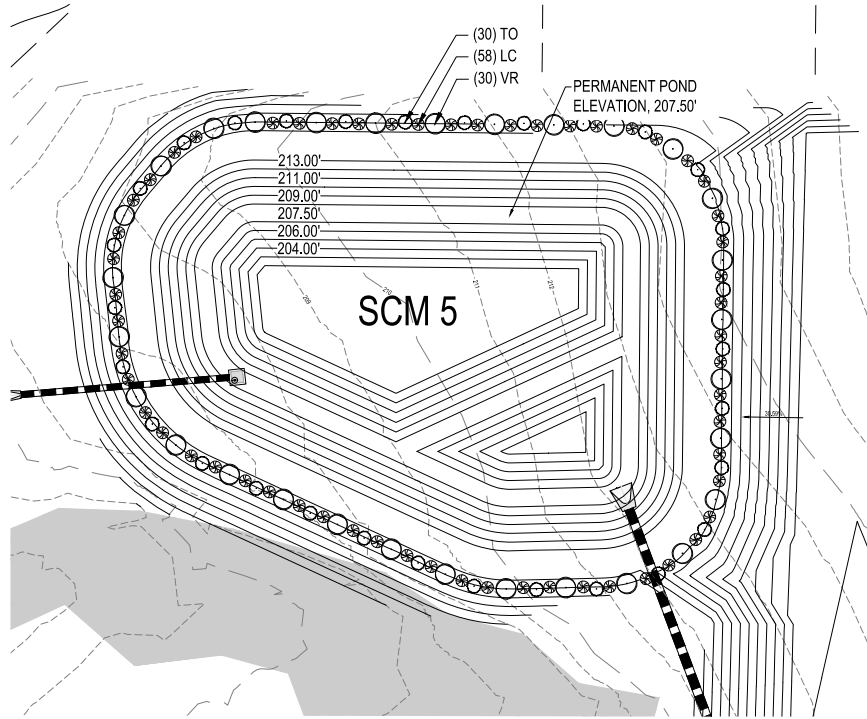
The Construction Contractor responsible for the extension of water, sewer, and/or gas, as approved in these plans, is responsible for contacting the **Public Works Department** at (919) 996-2409 and the **Public Utilities Department** at (919) 996-2340 at least twenty-four hours prior to beginning any of their construction.

Failure to notify both City Departments in advance of beginning construction, will result in the issuance of monetary fines, and require resubmission of any water or sewer facilities not inspected as a result of this notification failure.



Failure to call for inspection, install a Downstream Plug, have Permitted Plans on the jobsite, or any other Violation of City of Raleigh Standards will result in a Fine and Possible Exclusion from future work in the City of Raleigh.

FILE NUMBER: 8430-00	DATE: 11/16/2022	L2-2
SCM LANDSCAPE PLAN (3 OF 4)		
EVERLEE SUBDIVISION 1100 PERIMETER PARK DRIVE, SUITE 112 MORRISTOWN, NC 27560 NCEC LICENSE #C-27016		
LENNAR CORPORATION 1100 PERIMETER PARK DRIVE, SUITE 112 MORRISTOWN, NC 27560 NCEC LICENSE #C-27016		
EBC 5440 VALLEY PARK BLVD, SUITE 102 RALEIGH, NC 27607 NCEC LICENSE #C-4397		
DESIGNED BY: TW/AP	DRAWN BY: CD/AP	REVIEWED BY: JD/J
CITY OF RALEIGH COMMENTS - THIRD REVIEW 1/16/2022	CITY OF RALEIGH COMMENTS - SECOND REVIEW 1/16/2022	CITY OF RALEIGH COMMENTS - FIRST REVIEW 3/16/2022
REV	DATE	DESCRIPTION





SCM 5 PLANT SCHEDULE						
SMALL MATURING TREES						
CODE	QTY	COMMON NAME	BOTANICAL NAME	HEIGHT	CALIPER	NOTES
○	10	CAROLINA CHERRY LAUREL	PRUNUS CAROLINIANA	8' MIN.	1.5" CAL. MIN.	SPACING DETENTION SCREENING UNDERSTORY TREE. WELL MATCHED SPECIMENS, FULL CROWN.
SHRUBS						
CODE	QTY	COMMON NAME	BOTANICAL NAME	HEIGHT	CALIPER	NOTES
●	10	LOROPETALUM	LOROPETALUM CHINENSE	10' MIN.	3 GAL.	SPACING DETENTION SCREENING SHRUB. WELL MATCHED SPECIMENS, FULL BUSHY CONTAINER.
○	30	LEATHERLEAF YEW	WAXY YEW	10' MIN.	3 GAL.	SPACING DETENTION SCREENING SHRUB. WELL MATCHED SPECIMENS, FULL BUSHY CONTAINER.
PLANTING SYMBOL						
QUANTITY						
PLANT CODE						

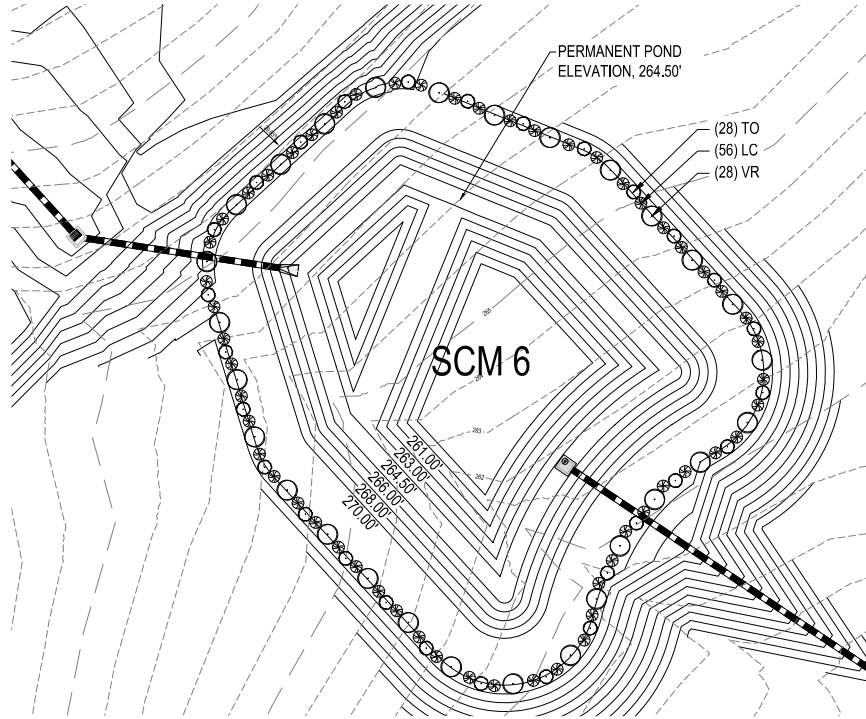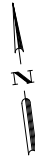

SCM 6 PLANT SCHEDULE						
SMALL MATURING TREES						
CODE	QTY	COMMON NAME	BOTANICAL NAME	HEIGHT	CALIPER	NOTES
○	10	CAROLINA CHERRY LAUREL	PRUNUS CAROLINIANA	8' MIN.	1.5" CAL. MIN.	SPACING DETENTION SCREENING UNDERSTORY TREE. WELL MATCHED SPECIMENS, FULL CROWN.
SHRUBS						
CODE	QTY	COMMON NAME	BOTANICAL NAME	HEIGHT	CALIPER	NOTES
●	10	LOROPETALUM	LOROPETALUM CHINENSE	10' MIN.	3 GAL.	SPACING DETENTION SCREENING SHRUB. WELL MATCHED SPECIMENS, FULL BUSHY CONTAINER.
○	30	LEATHERLEAF YEW	WAXY YEW	10' MIN.	3 GAL.	SPACING DETENTION SCREENING SHRUB. WELL MATCHED SPECIMENS, FULL BUSHY CONTAINER.
PLANTING SYMBOL						
QUANTITY						
PLANT CODE						



**ATTENTION CONTRACTORS**

The Construction Contractor responsible for the extension of water, sewer, and/or gas, as approved in these plans, is responsible for contacting the **Public Works Department** at (919) 996-2400 and the **Public Utilities Department** at (919) 996-2400 at least twenty-four hours prior to beginning any of their construction.

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FILE NUMBER:	8430-00
DATE:	11/16/2022
L2-3	

EVERLEE SUBDIVISION  
PHASE 2 SUBDIVISION  
RALEIGH, NC 27606

LENNAR CORPORATION  
1100 PERIMETER PARK DRIVE, SUITE 112  
MONROVIE, NC 27059

ECG  
5440 VALLEY PARK BLVD, SUITE 102  
RALEIGH, NC 27607  
NC LICENSE #C-4387

DESIGNED BY:	TD/AP
DRAWN BY:	CD/AP
REVIEWED BY:	JDU
DATE:	11/16/2022
REV:	
DESCRIPTION:	

11/16/2022

CITY OF RALEIGH COMMENTS - THIRD REVIEW

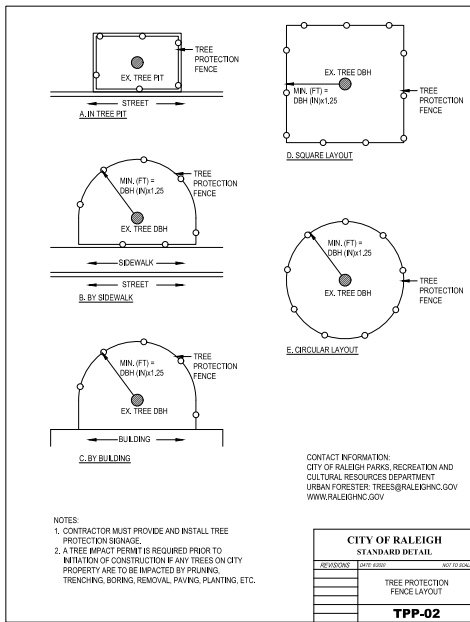
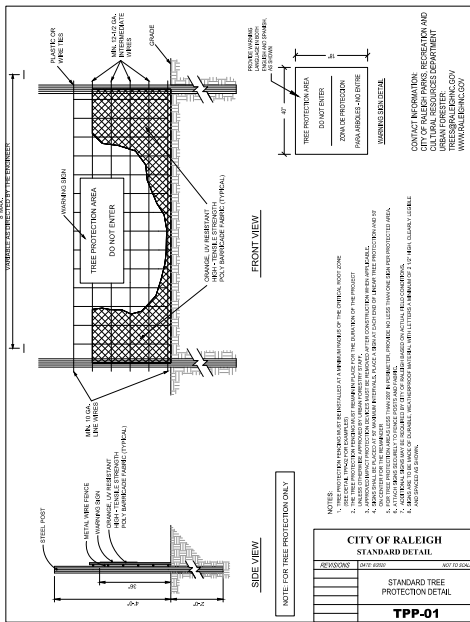
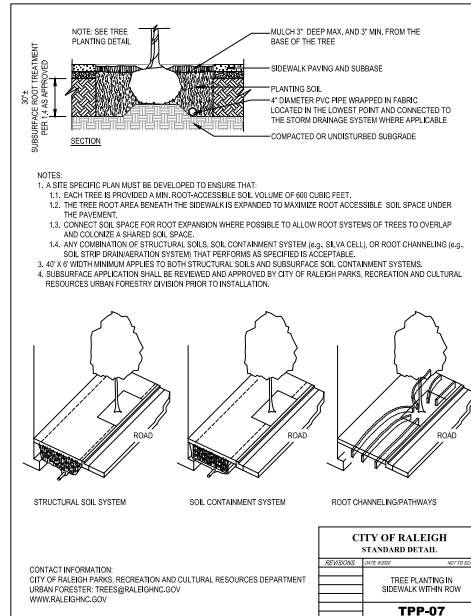
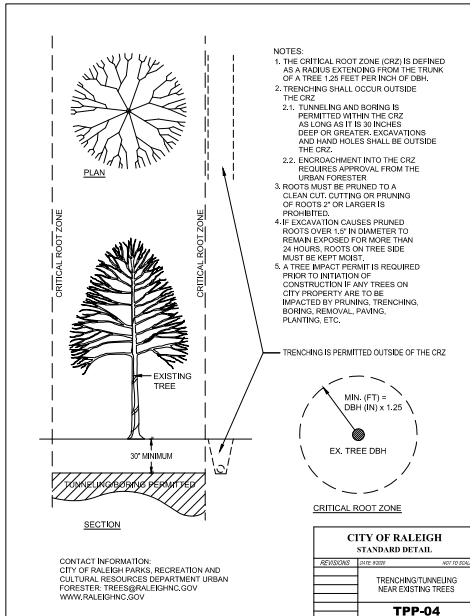
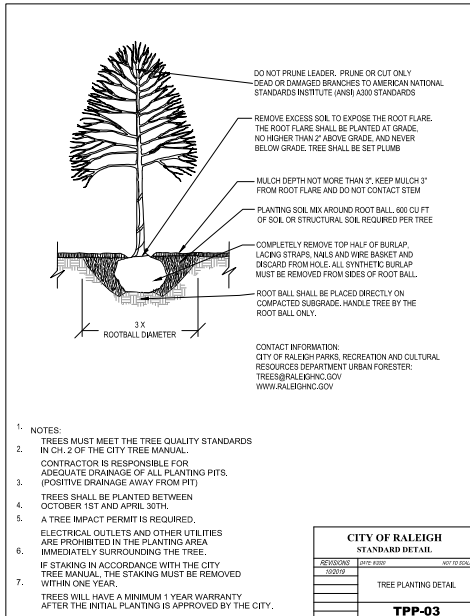
11/16/2022

CITY OF RALEIGH COMMENTS - SECOND REVIEW

11/16/2022

CITY OF RALEIGH COMMENTS - FIRST REVIEW





Know what's below.  
Call before you dig.

#### ATTENTION CONTRACTORS

The Construction Contractor responsible for the extension of water, sewer, and/or gas, as approved in these plans, is responsible for contacting the **Public Works Department** at (919) 996-3409 and the **Public Utilities Department** at (919) 996-2340 at least twenty four hours prior to beginning any of their construction.

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**Failure** to call for inspection, install a Downstream Plug, have Permitted Plans on the jobsite, or any other Violation of City of Raleigh Standards will result in a Fine and Possible Exclusion from future work in the City of Raleigh.

FILE NUMBER:  
8430-00  
DATE: 11/16/2022

L3-0

EVERLEE SUBDIVISION  
PRELIMINARY CONSTRUCTION PLAN  
1100 PERIMETER PARK DRIVE, SUITE 112  
MONROVILLE, NC 27060  
NC LICENSE 6C-2706

LENNAR CORPORATION  
5440 VALLEY PARK BLVD, SUITE 102  
RALEIGH, NC 27607  
NC LICENSE 6C-4897

DESIGNED BY: TWI/AP  
DRAWN BY: CDA/P  
REVIEWED BY: JDI

1/4/2022 CITY OF RALEIGH COMMENTS - THIRD REVIEW  
7/22/2022 CITY OF RALEIGH COMMENTS - SECOND REVIEW  
3/18/2022 CITY OF RALEIGH COMMENTS - FIRST REVIEW  
DATE DESCRIPTION



100.00'



—(23) IC

(17) PL

(2) LT

(2) PC

(2) QF

QUANTITY  
(0) XX  
PLANT CODE

**NOTE TO CONTRACTOR:**  
IF GRAPHIC REPRESENTATION OF PLANTINGS ON PLANS DOES NOT MATCH QUANTITIES IN PLANT LIST, GRAPHIC REPRESENTATION OF PLANTINGS ON PLANS WILL GOVERN.



0 5'

SCALE: 1" = 5'

L3-1

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LENNAR  
CORPORATION  
100 PERIMETER PARK DRIVE SUITE

EVERLEE  
SUBDIVISION  
PRELIMINARY SUBDIVISION PLAN

LANDSCAPE DETAILS

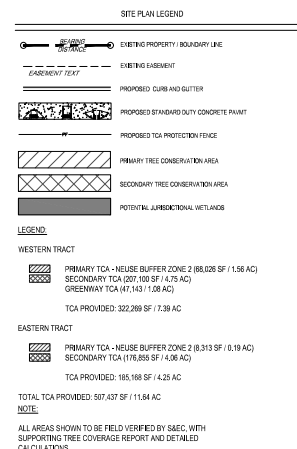
DESCRIPTION	CITY OF RALEIGH COMMENTS - FIRST REVIEW	CITY OF RALEIGH COMMENTS - SECOND REVIEW	CITY OF RALEIGH COMMENTS - THIRD REVIEW
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DESIGNED BY:	TW/AP
DRAWN BY:	CD/AP
REVIEWED BY:	JDJ

**BGE**  
5440 WADE PARK BLVD, SUITE 102  
RALEIGH NC 27607  
WWW.BGEINC.COM  
NC LICENSE #C-4397 ©2012

G:\NCA\Projects\Lennar\4430-00 - Lennar - Everlee - Raleigh\03 - DWG\PlanSheets\On-Site\1.3-0 - LS-OETL.dwg Layout: L3-1 Plotted: 11/16/2022 2:37:01 PM





NO TEMPORARY OR PERMANENT ENCROACHMENTS (INCLUDING BUT NOT LIMITED TO CLEARING, GRADING, FENCING, AND THE INSTALLATION OF RETAINING WALLS OR OTHER STRUCTURES) ARE PERMITTED WITHIN THE GREENWAY EASEMENT AREA WITHOUT PRIOR APPROVAL BY THE CITY OF RALEIGH.

<b>Two Comprehensive Plan Data Sheet</b> <b>Public Comments to The Executive Order</b> <b>Final Comprehensive Plan and the 2010 Comprehensive Plan Amendment</b>			
<b>Project Name:</b> <u>Veritas Life Sciences</u>			
<b>Owner:</b> <u>Veritas Life Sciences</u>	<b>Project Address:</b> <u>101-100</u>		
<b>Right-of-Way:</b> <u>on adjacent road to the south</u>	<b>Project Address:</b> <u>101-100</u>		
<b>Field ID:</b> <u>Veritas</u>	<b>Project Address:</b> <u>101-100</u>		
	<b>Section:</b> <u>Veritas</u>	<b>Project:</b> <u>Veritas</u>	
<b>USE 5.6.1: Primary Tree Determination Area</b>			
<u>1. Primary Tree Determination Area - PDA 1</u>			
<u>2. Primary Tree Determination Area - PDA 2</u>			
<u>3. Primary Tree Determination Area - PDA 3</u>			
<u>4. Primary Tree Determination Area - PDA 4</u>			
<u>5. Primary Tree Determination Area - PDA 5</u>			
<u>6. Primary Tree Determination Area - PDA 6</u>			
<u>7. Primary Tree Determination Area - PDA 7</u>			
<u>8. Primary Tree Determination Area - PDA 8</u>			
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<u>11. Primary Tree Determination Area - PDA 11</u>			
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<u>13. Primary Tree Determination Area - PDA 13</u>			
<u>14. Primary Tree Determination Area - PDA 14</u>			
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<u>98. Primary Tree Determination Area - PDA 98</u>			
<u>99. Primary Tree Determination Area - PDA 99</u>			
<u>100. Primary Tree Determination Area - PDA 100</u>			
<u>101. Primary Tree Determination Area</u>			

The *Construction Contractor* responsible for the extension of water, sewer, and/or reuse, as approved in these plans, is responsible for contacting the **Public Works Department** at (919) 996-2409, or the **Public Utilities Department** at (919) 996-4540 at least twenty-four hours prior to beginning any of their construction.

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Know what's below.  
Call before you dig.



**EVERLEE SUBDIVISION**

www.zameykeimg.com



11/9/2022  
Jagadee M. Indragan  
20506-Red-1.dgn

GENERAL NOTES:

2018 SPECIFICATIONS

EFFECTIVE: 01-16-2018  
REVISED:

GRADING:

THE GRADE LINES SHOWN DENOTE THE FINISHED ELEVATION OF THE PROPOSED OR FUTURE SURFACING AT GRADE POINTS SHOWN ON THE TYPICAL SECTIONS. GRADE LINES MAY BE ADJUSTED AT THEIR BEGINNING AND ENDING AND AT STRUCTURES AS DIRECTED BY THE ENGINEER IN ORDER TO SECURE A PROPER TIE-IN.

CLEARING:

CLEARING ON THIS PROJECT SHALL BE PERFORMED TO THE LIMITS ESTABLISHED METHOD II.

SUPERELEVATION:

ALL CURVES ON THIS PROJECT SHALL BE SUPERELEVATED IN ACCORDANCE WITH STD. NO. 225.05 USING THE RATE OF SUPERELEVATION AND RUNOFF SHOWN ON THE PLANS. SUPERELEVATION IS TO BE REVOLVED ABOUT THE GRADE POINTS SHOWN ON THE TYPICAL SECTIONS.

SHOULDER CONSTRUCTION:

ASPHALT, EARTH, AND CONCRETE SHOULDER CONSTRUCTION ON THE HIGH SIDE OF SUPERELEVATED CURVES SHALL BE IN ACCORDANCE WITH STD. NO. 560.02

SIDE ROADS:

THE CONTRACTOR WILL BE REQUIRED TO DO ALL NECESSARY WORK TO PROVIDE SUITABLE CONNECTIONS WITH ALL ROADS, STREETS, AND DRIVES ENTERING THIS PROJECT. THIS WORK WILL BE PAID FOR AT THE CONTRACT UNIT PRICE FOR THE PARTICULAR ITEMS INVOLVED.

DRIVEWAYS:

DRIVEWAYS SHALL BE CONSTRUCTED IN ACCORDANCE WITH STD. 848.03 AT LOCATIONS SHOWN ON PLANS OR AS DIRECTED BY THE ENGINEER.

SUBSURFACE PLANS:

NO SUBSURFACE PLANS ARE AVAILABLE ON THIS PROJECT. THE CONTRACTOR SHOULD MAKE HIS OWN INVESTIGATION AS TO THE SUBSURFACE CONDITIONS.

UTILITIES:

UTILITY OWNERS ON THIS PROJECT ARE DUKE ENERGY, AT&T, SPECTRUM, GOOGLE FIBER, DOMINION ENERGY. ANY RELOCATION OF EXISTING UTILITIES WILL BE ACCOMPLISHED BY OTHERS.

RIGHT-OF-WAY MARKERS:

ALL RIGHT-OF-WAY MARKERS ON THIS PROJECT SHALL BE PLACED BY OTHERS.

CURB RAMPS

CURB RAMPS ARE SHOWN ON THE PLANS AT APPROXIMATE LOCATIONS. CONSTRUCT ALL CURB RAMPS ACCORDANCE WITH STD 848.05/848.06 OR CURB RAMP DETAIL NOTED ON THE PLANS.

2018 ROADWAY ENGLISH STANDARD DRAWINGS

EFFECTIVE: 01-16-2018  
REVISED:

DIVISION 2 - EARTHWORK

200.02 METHOD OF CLEARING - METHOD II  
225.02 GUIDE FOR GRADING SUBGRADE - SECONDARY AND LOCAL  
225.04 METHOD OF OBTAINING SUPERELEVATION - TWO LANE PAVEMENT

DIVISION 3 - PIPE CULVERTS

300.01 METHOD OF PIPE INSTALLATION  
310.02 PARALLEL PIPE END SECTION - PRECAST CONCRETE SECTION FOR 15" TO 24" PIPE  
310.03 CROSS PIPE END SECTION - PRECAST CONCRETE SECTION FOR 18" TO 30" PIPE  
310.10 DRIVEWAY PIPE CONSTRUCTION

DIVISION 5 - SUBGRADE, BASES, AND SHOULDER

560.02 METHOD OF SHOULDER CONSTRUCTION - HIGH SIDE OF SUPERELEVATED CURVE - METHOD II

DIVISION 8 - INCIDENTALS

840.02 CONCRETE CATCH BASIN - 12" THRU 54" PIPE  
840.03 FRAME, GRATES, AND HOOD - FOR USE ON STANDARD CATCH BASIN  
840.19 CONCRETE GRATED DROP INLET TYPE 'D' - 12" THRU 36" PIPE  
840.29 FRAMES AND NARROW SLOT FLAT GRATES  
840.34 TRAFFIC BEARING JUNCTION BOX - FOR USE WITH PIPES 42" AND UNDER  
840.52 PRECAST MANHOLE - 4', 5', AND 6' DIAMETER  
840.54 MANHOLE FRAME AND COVER  
840.72 PIPE COLLAR  
848.04 STREET TURNOUT  
848.05 CURB RAMP - PROPOSED CURB & GUTTER  
852.01 CONCRETE ISLANDS  
852.02 CONCRETE MOUNTABLE MEDIAN - FOR USE WITH RIGID OR FLEXIBLE PAVEMENT  
852.06 METHOD OR PLACEMENT OF DROP INLETS IN CONCRETE ISLANDS  
862.01 GUARDRAIL PLACEMENT  
862.02 GUARDRAIL INSTALLATION  
862.03 STRUCTURE ANCHOR UNITS

CITY OF RALEIGH - PLANS AUTHORIZED FOR CONSTRUCTION

Plans for the proposed work have been reviewed for general compliance with applicable codes, standards, and specifications. The City of Raleigh does not warrant that the plans are correct or that the work will be completed in accordance with the plans. The City of Raleigh is not responsible for any errors or omissions in the plans or for any damage or injury resulting from the use of the plans. The City of Raleigh is not responsible for any damage or injury resulting from the use of the plans. The City of Raleigh is not responsible for any damage or injury resulting from the use of the plans.

City of Raleigh  
Development Approval

SHEET NO.  
1A

EVERLEE SUBDIVISION  
ROADWAY IMPROVEMENTS

RALEIGH, NORTH CAROLINA

GENERAL NOTES AND STANDARD DETAILS

REVISIONS

DOCUMENT NOT CONSIDERED FINAL UNLESS ALL  
SIGNATURES COMPLETED

SCALES

H=SCALE - NA

V=SCALE - NA

DATE: 11/09/2022

DESIGNED BY: MML

CHECKED BY: KMP

Infrastructure Consulting Services, Inc.

**RKA**

RAYE KEMP ASSOCIATES

2020 Independence Place

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Phone 919.967.7118

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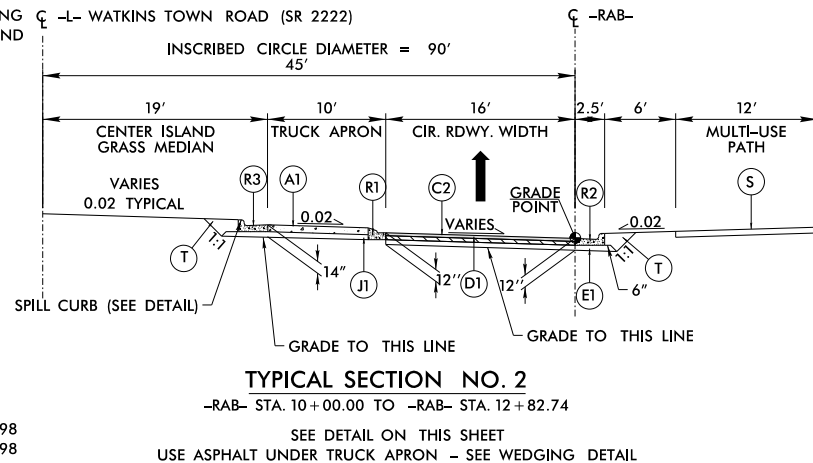
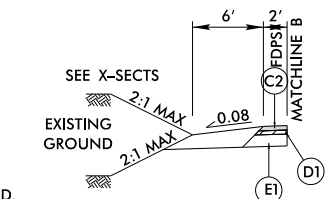
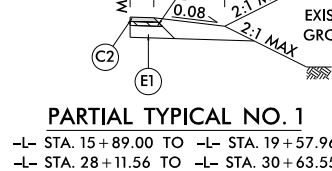
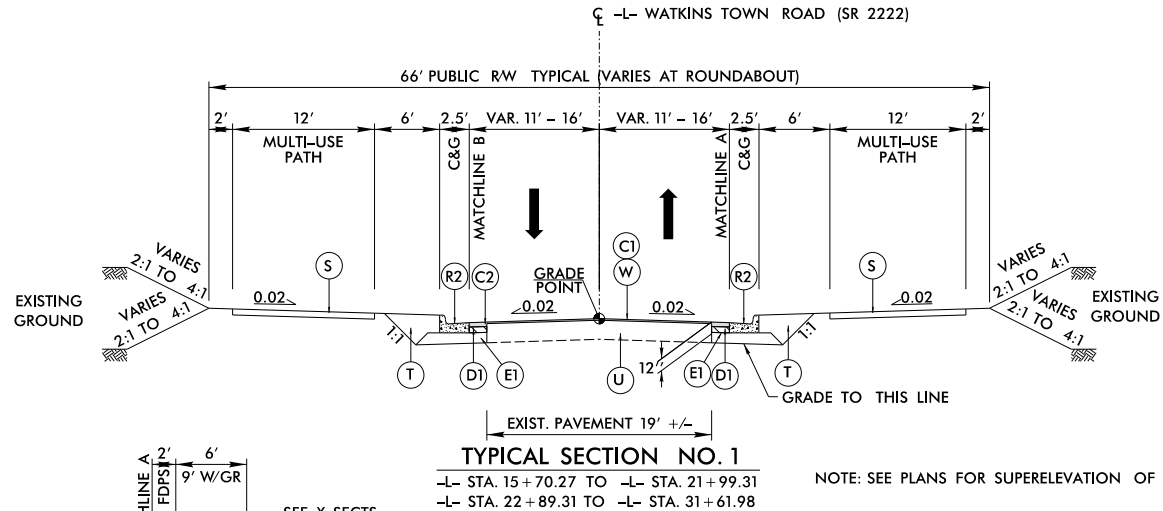
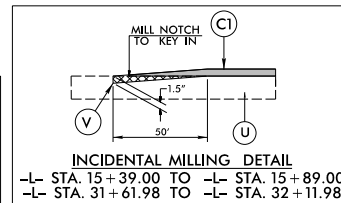
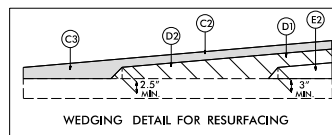
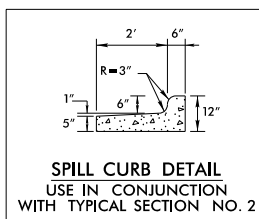
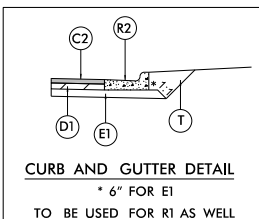
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20506-Rdy-18.dgn



PAVEMENT SCHEDULE	
A1	8" PORTLAND CEMENT CONCRETE WITHOUT WELDED WIRE FABRIC.
C1	PROP. APPROX. 1 1/2" ASPHALT CONCRETE SURFACE COURSE, TYPE S9.5C, AT AN AVERAGE RATE OF 168 LBS. PER SQ. YD.
C2	PROP. APPROX. 3" ASPHALT CONCRETE SURFACE COURSE, TYPE S9.5C, AT AN AVERAGE RATE OF 168 LBS. PER SQ. YD. IN EACH OF TWO LAYERS.
C3	PROP. VAR. DEPTH ASPHALT CONCRETE SURFACE COURSE, TYPE S9.5C, AT AN AVERAGE RATE OF 112 LBS. PER SQ. YD. PER 1" DEPTH, TO BE PLACED IN LAYERS NOT TO EXCEED 2" IN DEPTH.
D1	PROP. APPROX. 4" ASPHALT CONCRETE INTERMEDIATE COURSE, TYPE T19.0C AT AN AVERAGE RATE OF 456 LBS. PER SQ. YD.
D2	PROP. VAR. DEPTH ASPHALT CONCRETE INTERMEDIATE COURSE, TYPE T19.0C, AT AN AVERAGE RATE OF 114 LBS. PER SQ. YD. PER 1" DEPTH, TO BE PLACED IN LAYERS NOT LESS THAN 2 1/2" IN DEPTH OR GREATER THAN 4" IN DEPTH.
E1	PROP. APPROX. 5" ASPHALT CONCRETE BASE COURSE, TYPE B25.0C, AT AN AVERAGE RATE OF 570 LBS. PER SQ. YD.
E2	PROP. VAR. DEPTH ASPHALT CONCRETE BASE COURSE, TYPE B25.0C, AT AN AVERAGE RATE OF 114 LBS. PER SQ. YD. PER 1" DEPTH, TO BE PLACED IN LAYERS NOT LESS THAN 3" IN DEPTH OR GREATER THAN 5 1/2" IN DEPTH.
J1	PROP. 6" AGGREGATE BASE COURSE.
R1	1'-6" CONCRETE CURB AND GUTTER.
R2	2'-6" CONCRETE CURB AND GUTTER.
R3	SPILL CURB (SEE DETAIL ON THIS SHEET).
S	6" CONCRETE MULTI-USE PATH.
T	COMPACTED EARTH MATERIAL.
U	EXISTING PAVEMENT.
V	VARIABLE DEPTH MILLING.
W	VARIABLE DEPTH WEDGING.

#### NOTES:

- ALL PAVEMENT SLOPES ARE 1:1 UNLESS OTHERWISE SPECIFIED.
- SEE PLANS FOR LOCATIONS OF INTERSECTIONS, CONCRETE ISLANDS, TAPERS, AND MULTI-USE PATH.



**CITY OF RALEIGH PLANS AUTHORIZED FOR CONSTRUCTION**

Plans for the proposed use have been reviewed for general compliance with the City of Raleigh Comprehensive Zoning Ordinance and the City of Raleigh Comprehensive Land Use Ordinance. The City of Raleigh does not warrant the accuracy or completeness of the information provided herein, and the user assumes all responsibility for the use of the information provided herein. The City of Raleigh does not warrant the accuracy or completeness of the information provided herein, and the user assumes all responsibility for the use of the information provided herein.

City of Raleigh  
Development Approval

SHEET NO.  
2A-1

EVERLEE SUBDIVISION  
ROADWAY IMPROVEMENTS  
RALEIGH, NORTH CAROLINA  
TYPICAL SECTIONS



REVISIONS	DATE	BY	APP

SCALES  
H=SCALE = NA  
V=SCALE = NA  
DATE: 11/08/2022  
DESIGNED BY: MML  
CHECKED BY: KMP  
Infrastructure Consulting Services, Inc.  
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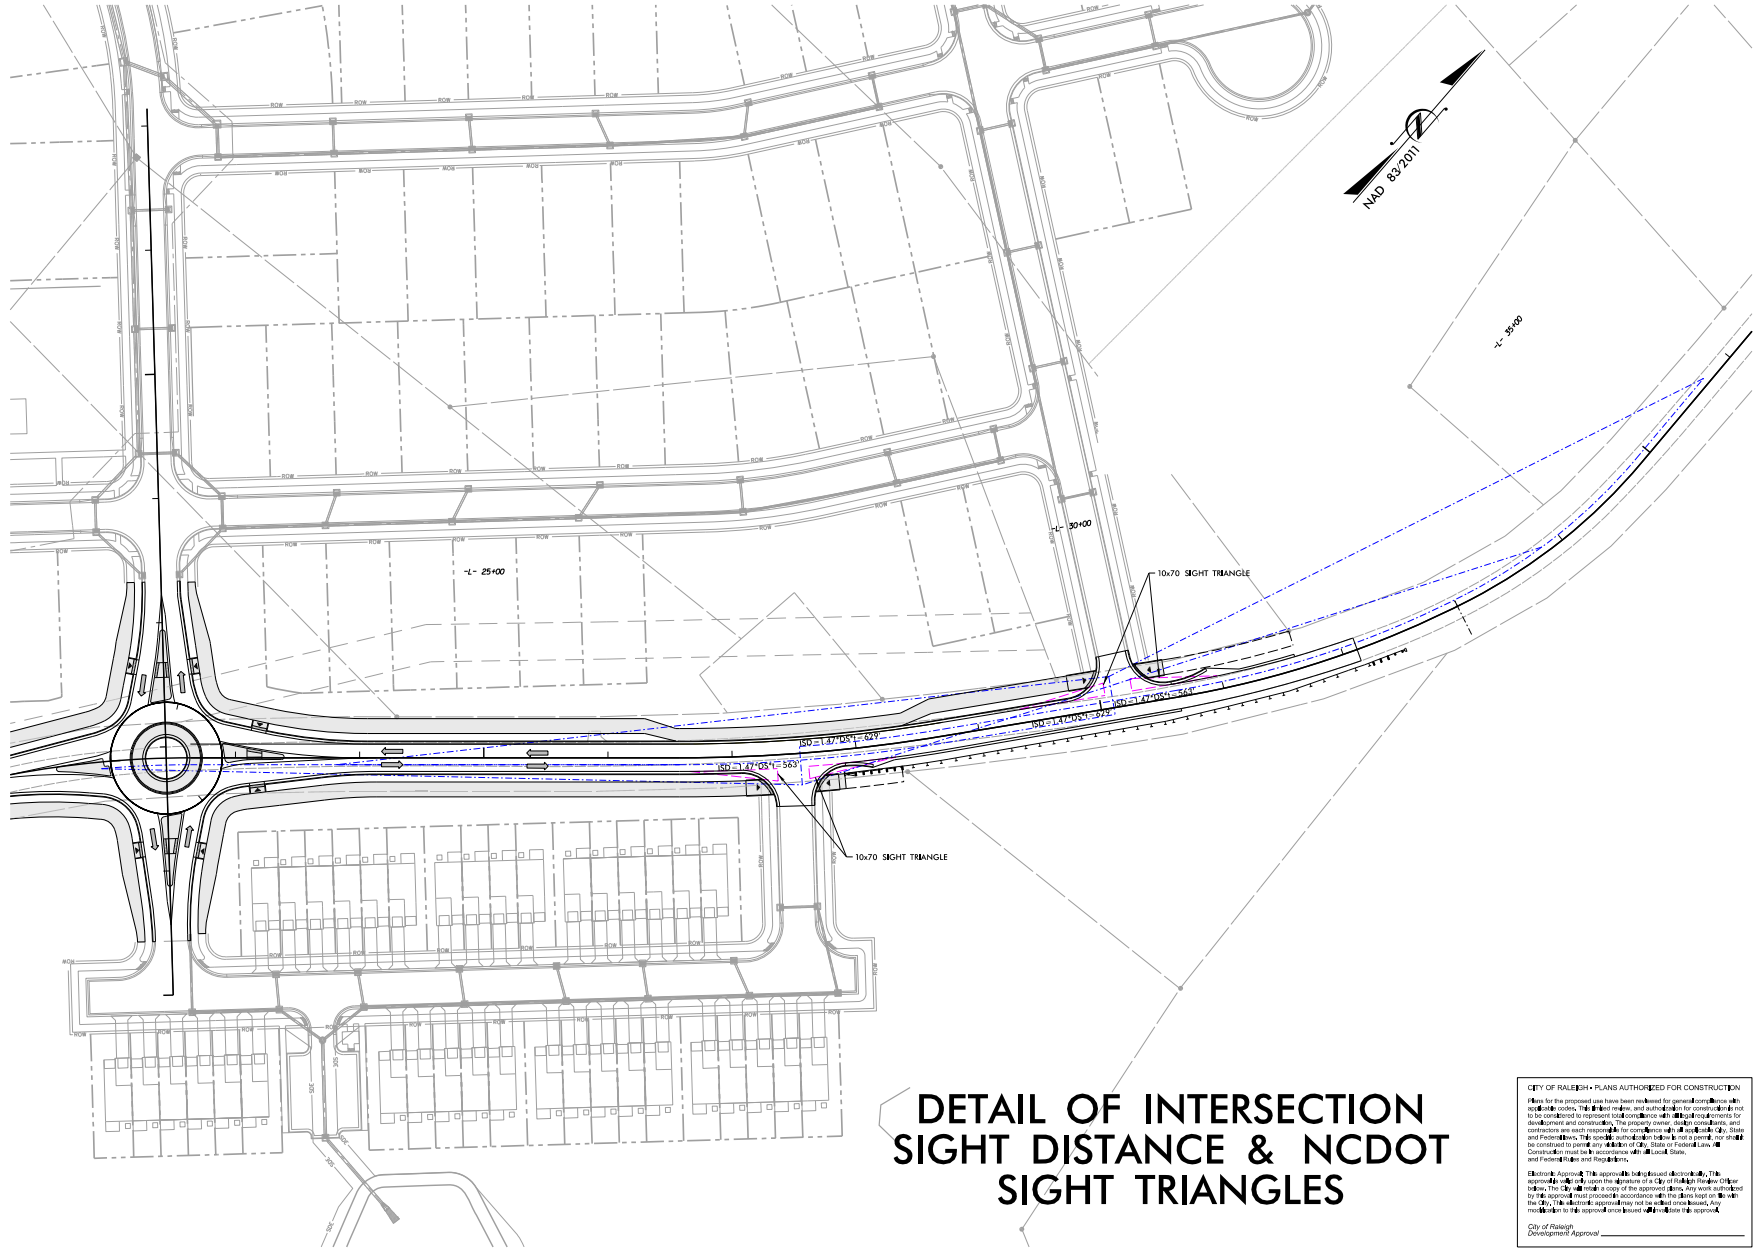
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## DETAIL OF INTERSECTION SIGHT DISTANCE & NCDOT SIGHT TRIANGLES

**CITY OF RALEIGH PLANS AUTHORIZED FOR CONSTRUCTION**

Plans for the proposed use have been reviewed for general compliance with applicable codes, regulations, and standards for construction and not to be construed as a guarantee of the accuracy of the information for development and construction. The planning, engineering, and construction are each responsible for compliance with all applicable City, State and Federal laws, rules, codes, standards, and regulations. Construction must be in accordance with all applicable laws, rules, codes, standards, and regulations.

**Electronic Approval:** This approval is not a physical stamp. This approval is valid only upon the signature of the City of Raleigh Engineer or other authorized official. The City will retain a copy of the approved plans. Any work performed by the contractor must be in accordance with the approved plans. The City will not be responsible for any work not in accordance with the approved plans. The City will not be responsible for any work not in accordance with the approved plans.

City of Raleigh  
Development Approval \_\_\_\_\_

SHEET NO.  
**2B-2**

EVERLEE SUBDIVISION  
ROADWAY IMPROVEMENTS  
RALEIGH, NORTH CAROLINA

SIGHT DISTANCE DETAIL SHEET

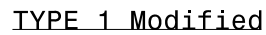
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NO.	DESCRIPTION	

SCALES  
H-SCALE = 1" = 50'  
V-SCALE = NA

DATE: 11/09/2022  
DESIGNED BY: MML  
CHECKED BY: KMP

Infrastructure Consulting Services, Inc.  
**RKA**  
RAMEY KEMP ASSOCIATES  
2008 Independence Place  
Raleigh, North Carolina 27605  
Phone: 919.961.1115  
Fax: 919.961.1116  
www.rameykemp.com





- 1 8.33% (12:1) MAX RAMP SLOPE
- 2 CROSS SLOPE: 2.00%
- 3 CURB RAMPS REQUIRE A (4'-0") MINIMUM LANDING WITH A MAXIMUM CROSS SLOPE AND LONGITUDINAL SLOPE OF 2.00% WHERE PEDESTRIANS PERFORM TURNING MANEUVERS. SLOPE TO DRAIN TO CURB.

SHEET NO. <div style="font-size: 24pt; font-weight: bold;">2C-1</div>		EVERLEE SUBDIVISION ROADWAY IMPROVEMENTS  RALEIGH, NORTH CAROLINA  CURB RAMP DETAILS
REVISIONS		DOCUMENT NOT CONSIDERED FINAL UNLESS ALL SIGNATURES COMPLETED
SCALES H=SCALE • NA V=SCALE • NA		
DATE: 11/08/2022		
DESIGNED BY: MML		
CHECKED BY: KMP		
Infrastructure Consulting Services, Inc. <div style="font-size: 36pt; font-weight: bold; margin: 5px 0;">RKA</div> RAMEY KEMP ASSOCIATES <div style="font-size: 8pt; margin-top: 5px;">             5505 Independence Place              Raleigh, North Carolina 27603              Phone: 919/4704115           </div> <div style="font-size: 8pt; margin-top: 5px;">             NC License No. 72-0489  <a href="http://www.rameykemp.com">www.rameykemp.com</a> </div>		



## SUMMARY OF EARTHWORK

<b>LINE</b>	<b>Station</b>	<b>Station</b>	<b>Uncl. Excav.</b>	<b>Embank.</b>	<b>Borrow</b>	<b>Waste</b>
-L-	15+50.00	32+50.00	309	10600	10591	0
-Y-	100+00.00	103+50.00	852	2020	1138	0
JRAB-	10+00.00	11-75.00	3	548	945	0
<b>TOTAL</b>			<b>1194</b>	<b>13868</b>	<b>12674</b>	<b>0</b>
<b>ADJUSTMENTS DUE TO</b>						
Est. Loss Due To Clearing And Grubbing			0			0
Rock Waste To Replace Borrow						
Adjust For Rock Spill That Replaces Borrow						
Eliminate Shrinkage For Mat'l That Is Now Rock						
Earth Waste To Replace Borrow					0	0
<b>PROJECT TOTAL</b>			<b>1194</b>	<b>13813</b>	<b>12719</b>	<b>0</b>
Est. 5% to Replace Topsoil in Borrow Pits					636	
<b>GRAND TOTAL</b>			<b>1194</b>		<b>13355</b>	
<b>SAY</b>			<b>1200</b>		<b>13400</b>	
Est. Shoulder Borrow		0 CY				
Est. Drainage Ditch Excav.		0 CY				
Select Granular Material		0 CY				
Geotextile For Soil Stab.		0 SY				
Estimate Undercut		0 CY				
Estimate Shallow Undercut		0 CY				
Class IV Subgrade Stab.		0 TONS				

Approximate quantities only. Unclassified excavation, shoulder borrow, fine grading, clearing and grubbing, breaking of existing pavement, and removal of existing pavement will be paid for at the lump sum price for "Grading".

### PARCEL INDEX

NOTE: ALL AREAS ARE IN SF

PARCEL NO.	PLAN SHEET NO.	PROPERTY OWNER NAME	R/W AREA TAKEN	TEMP CONST ESMT	PERM SLOPE ESMT	PERM DRAINAGE ESMT
1	5	DONALD LAWRENCE ZEIGLER, TRUSTEE; JAMES EDWARD MURRAY, TRUSTEE; KEITH EARL MURRAY, TRUSTEE;	-	2750	2052	341

## GUARDRAIL SUMMARY

"N" = DISTANCE FROM EDGE OF LANE TO FACE OF GUARDRAIL  
TOTAL SHOULDER WIDTH = DISTANCE FROM EDGE OF TRAVEL LANE TO SHOULDER BREAK POINT.  
FLARE LENGTH = DISTANCE FROM LAST SECTION OF PARALLEL GUARDRAIL TO END OF GUARDRAIL.  
W =  
TOTAL  
NG = NON-GATING IMPACT ATTENUATOR TYPE 350

[illegible]

**CITY OF RALEIGH PLANS AUTHORIZED FOR CONSTRUCTION**

Plans for the proposed case have been reviewed for general compliance with applicable codes, rules, and ordinances, and authorized for construction, provided that the applicant agrees to the following conditions. The applicant shall be considered to represent full compliance with all requirements for the proposed case. The applicant shall be responsible for ensuring that all applicable codes, rules, and ordinances are each responsible for compliance with all applicable City, State and Federal laws. This specific approval does not constitute a permit, nor shall it be used as evidence of any approval by the City, State or Federal Laws. The Construction must be in accordance with all Local, State, and Federal Laws and Regulations.

**Electronic Approval** The approval is being issued electronically. This approval is only valid at the address of the City of Raleigh (New Office) below. The City will retain a copy of the approved document. Any work authorized by this approval must proceed in accordance with the plans kept on file with the City. If the applicant is not satisfied with the approval, they may request a modification to the approval upon issuance of the approval.

*City of Raleigh  
Development Approval*

SHEET NO.  
3B

EVERLEE SUBDIVISION  
ROADWAY IMPROVEMENTS

RALEIGH, NORTH CAROLINA

## COMBINED SUMMARY

REVISIONS

DOCUMENT NOT CONSIDERED FINAL UNLESS ALL SIGNATURES COMPLETED

## SCALES

H-SCALE - NA

V-SCALE - NA

DATE: 11/08/20

DESIGNED BY: M

CHECKED BY: K

Infrastructure Consulting Services, Inc.

# RKA

**RAMEY KEMP ASSOCIATES**

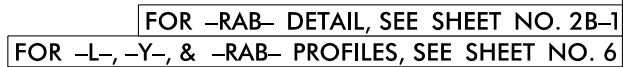
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Raleigh, North Carolina 27609

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1. ALL DIMENSIONS ARE TO EDGE OF TRAVEL UNLESS OTHERWISE SPECIFIED.
2. MAINTAIN ACCESS TO ALL MAILBOXES WITHIN THE PROJECT LIMITS. CONTRACTOR TO RELOCATE AS NECESSARY.
3. ALL DRIVEWAYS ARE 12' WIDE UNLESS OTHERWISE NOTED.



SHEET NO.  
4

EVERLEE SUBDIVISION  
ROADWAY IMPROVEMENTS

PLAN SHEET

**DOCUMENT NOT CONSIDERED FINAL UNLESS ALL**

REVISIONS

## SCALES

H. SCALE: 1" = 30'

DATE: 11/08/2022

DATE: 11/08/2022

DESIGNED BY: MN

CHECKED BY: KM

Infrastructure Consulting Services, Inc.

**514**

# SKA

**WVA**

RAMEY KEMP ASSOCIATES

5805 Farington Place  
Raleigh, North Carolina 27609

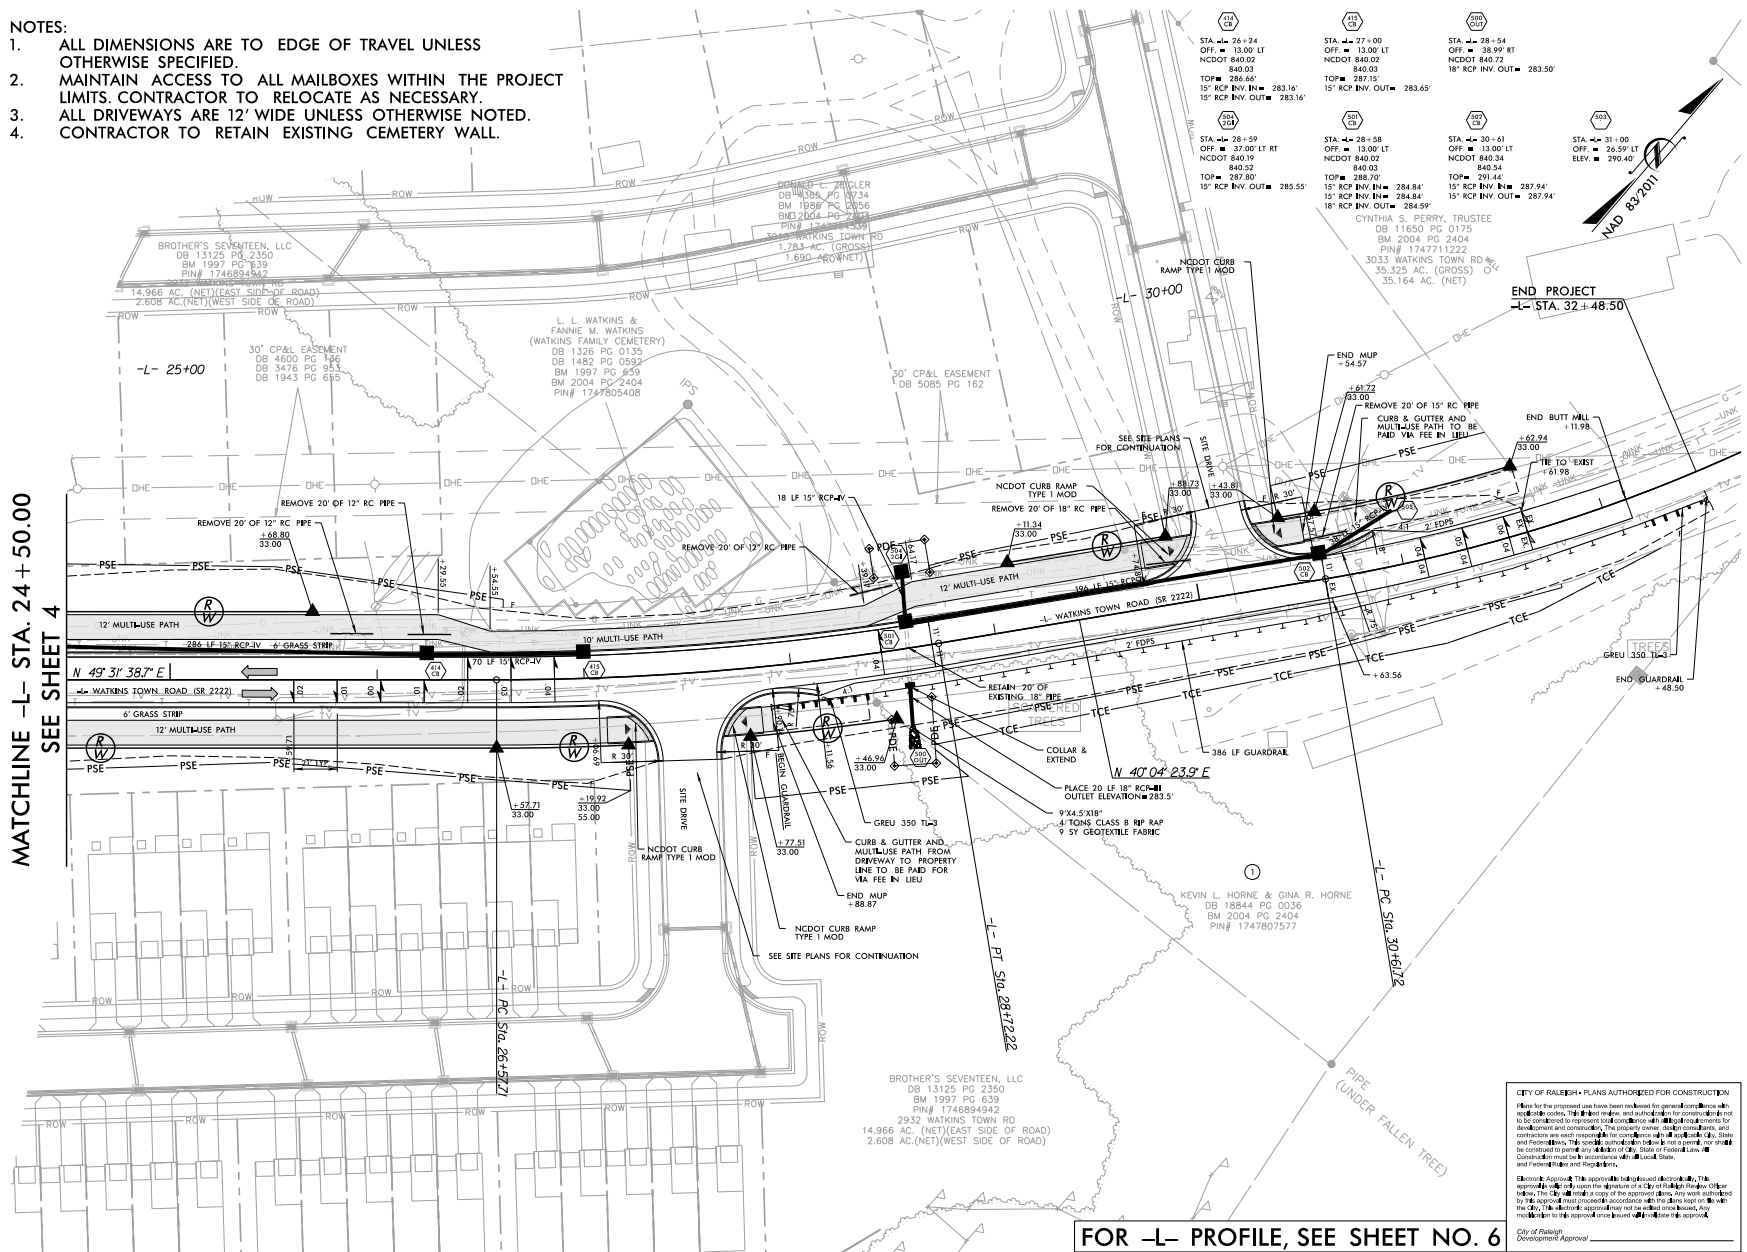
Phone: 919-872-5115

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MATCHLINE -L- STA. 24+50.00  
SEE SHEET 4

1. ALL DIMENSIONS ARE TO EDGE OF TRAVEL UNLESS OTHERWISE SPECIFIED.
2. MAINTAIN ACCESS TO ALL MAILBOXES WITHIN THE PROJECT LIMITS. CONTRACTOR TO RELOCATE AS NECESSARY.
3. ALL DRIVEWAYS ARE 12' WIDE UNLESS OTHERWISE NOTED.
4. CONTRACTOR TO RETAIN EXISTING CEMETERY WALL.



FOR -L- PROFILE, SEE SHEET NO. 6

**CITY OF RALEIGH • PLANS AUTHORIZED FOR CONSTRUCTION**

Plans for the proposed use have been reviewed for general compliance with applicable codes, Title 22 and ordinances, and authorization for construction is not intended to represent an endorsement or approval of the proposed use, design and construction. The property owner, design consultants, and contractors are each responsible for compliance with applicable City, State and Federal laws. The City of Raleigh hereby disclaims any warranty and shall be construed to permit any violation of City, State or Federal Law. All Construction must be in accordance with all Local, State, and Federal Rules and Regulations.

**Electronic Approval:** This approval is being issued electronically. This approval is only valid upon the signature of a City of Raleigh Planning Office Director or a duly authorized representative. This approval is not valid unless signed by this approval must proceed in accordance with the plans kept on file with the City. This electronic approval may not be added once issued. Any modification to this approval once issued will invalidate this approval.



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RALEIGH, NORTH CAROLINA  
PLAN SHEET

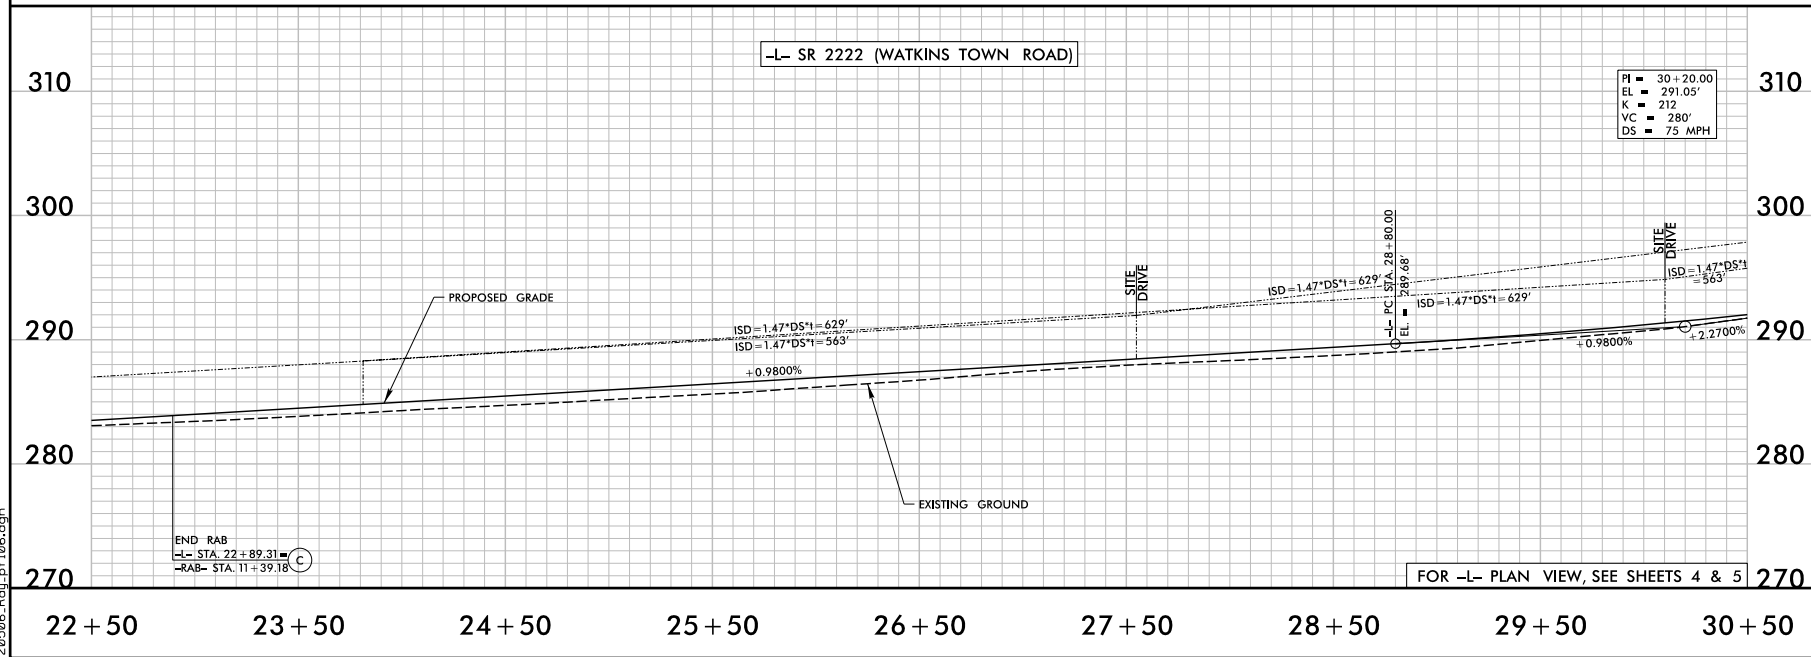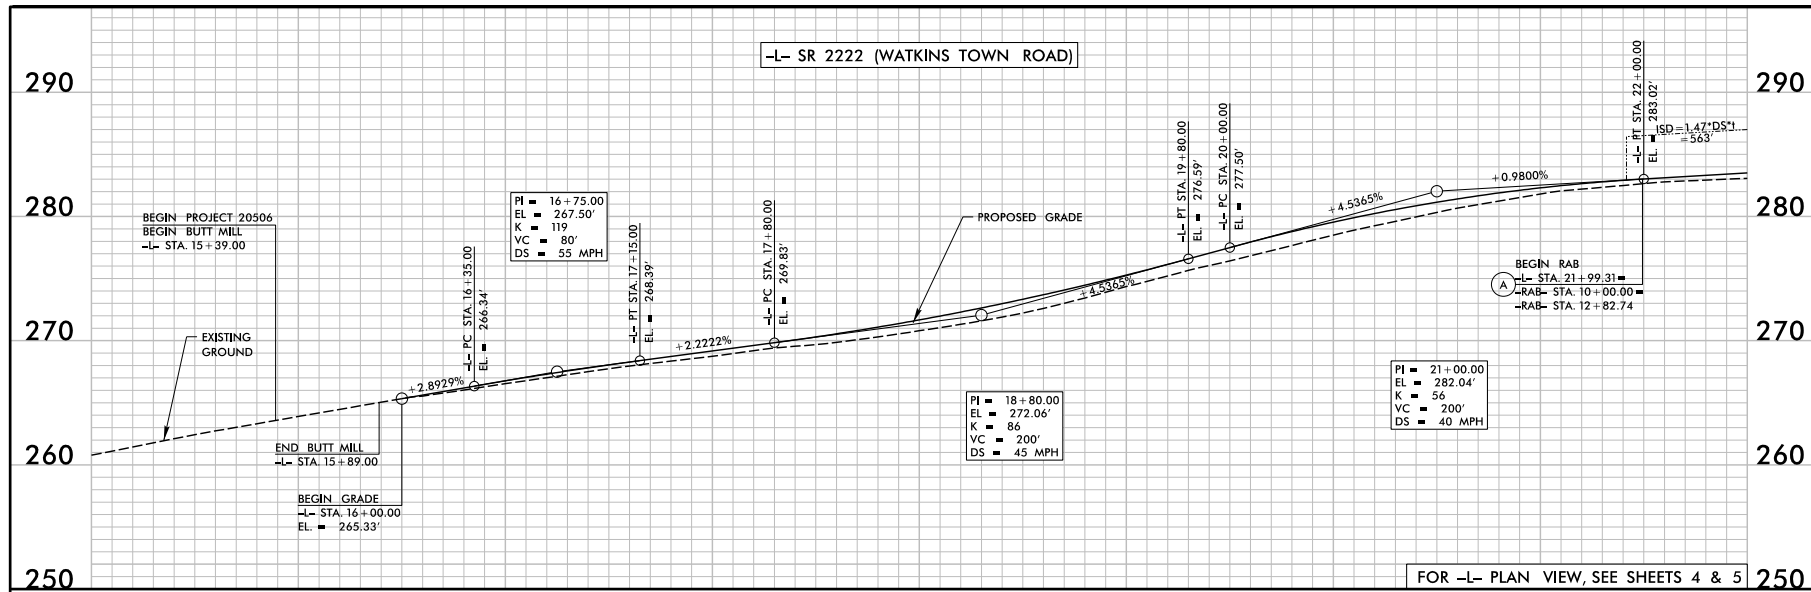
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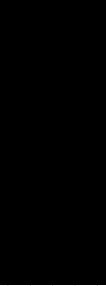
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SHEET NO.  
6



CITY OF RALEIGH  
ENGINEERING SERVICES DEPARTMENT  
EVERLEE SUBDIVISION  
PROFILE SHEET




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DATE: 11/08/2022  
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CHECKED BY: KMP  
Infrastructure Consulting Services, Inc.  
**RKA**  
RAYEY KEMP ASSOCIATES  
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11/9/2022  
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SHEET NO.  
7

CITY OF RALEIGH  
ENGINEERING SERVICES DEPARTMENT  
EVERLEE SUBDIVISION  
PROFILE SHEET

REVISIONS

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SCALES

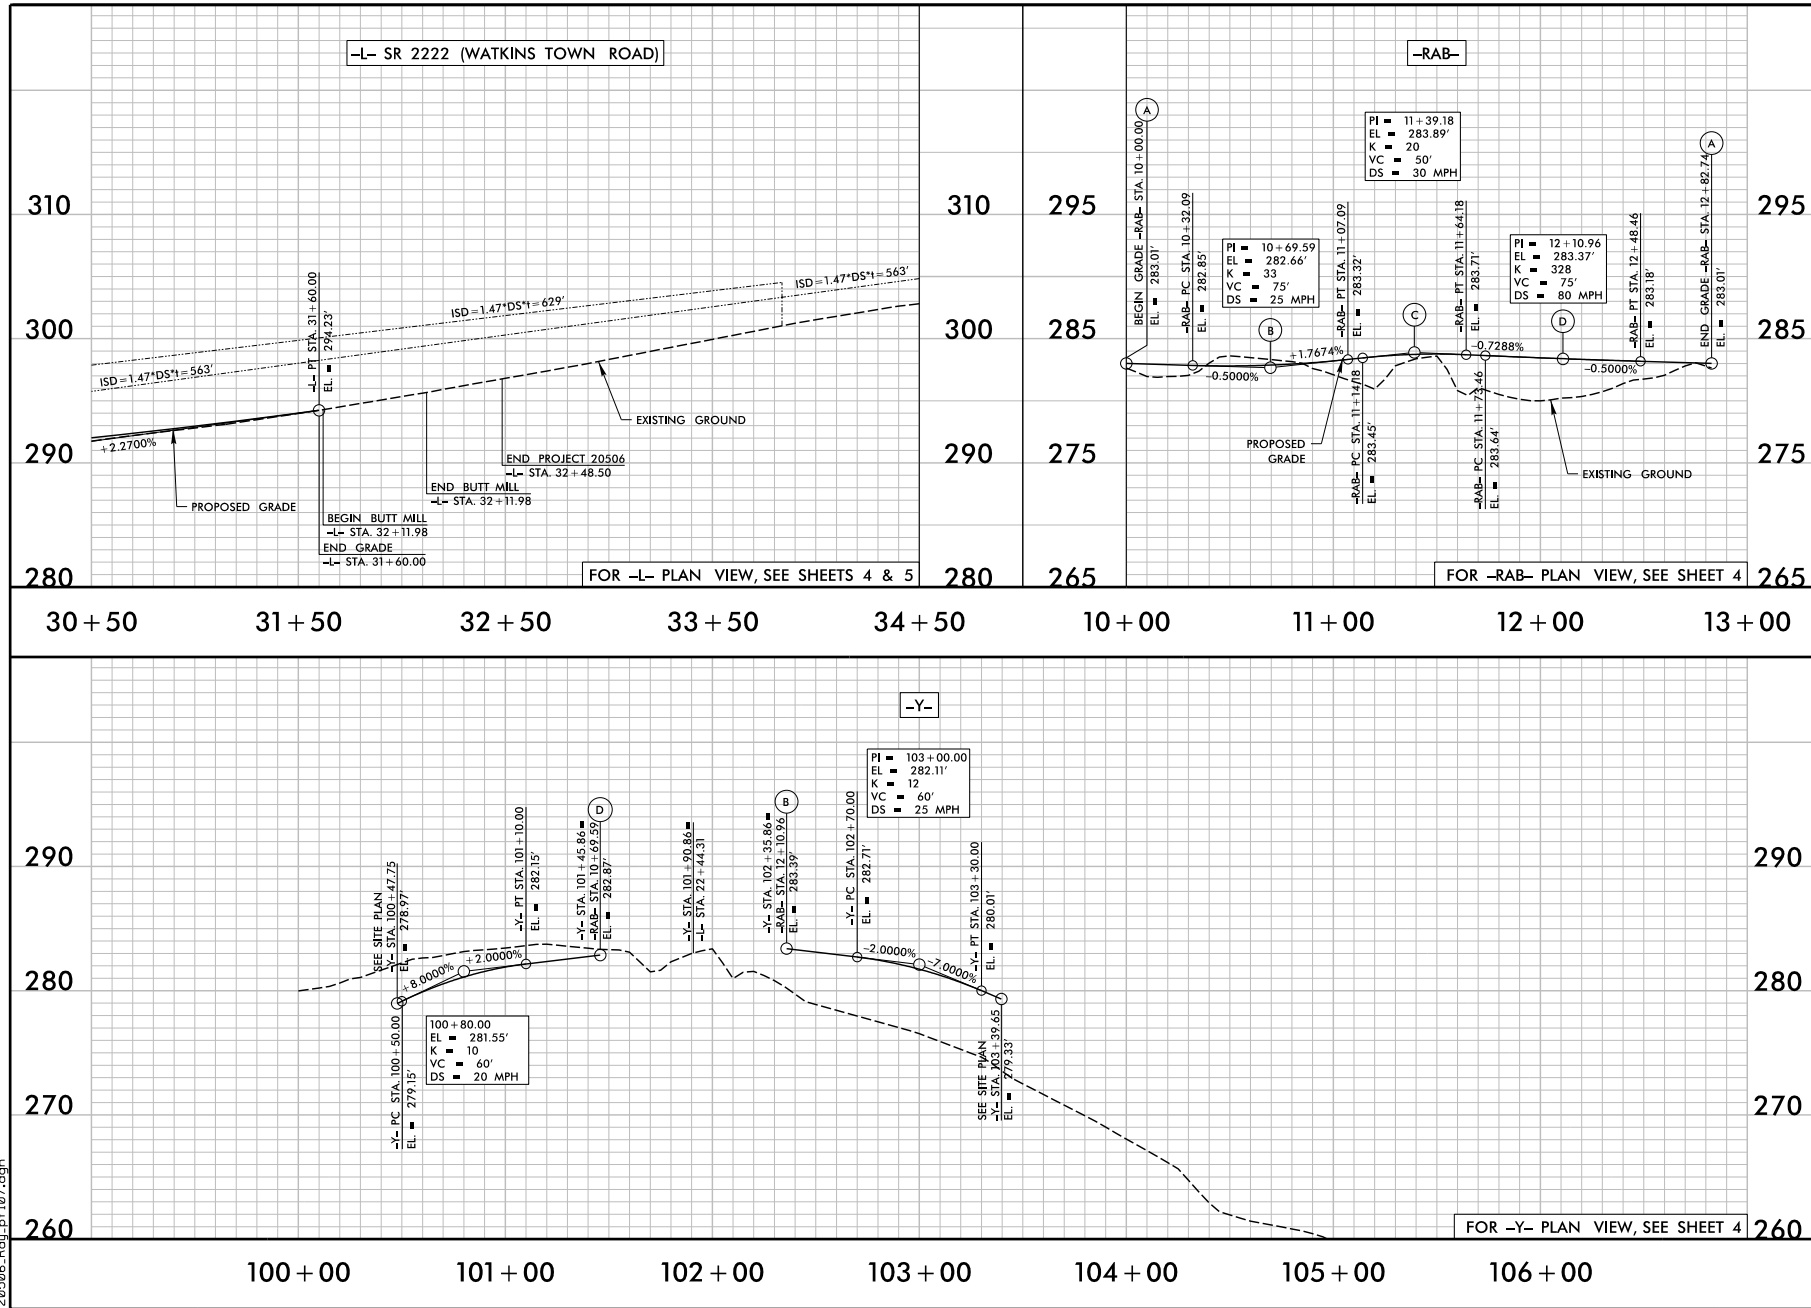H-SCALE = 1" = 30'  
V-SCALE = 1" = 5'

DATE: 11/08/2022  
DESIGNED BY: MML  
CHECKED BY: KMP

Infrastructure Consulting Services, Inc.  
  
RAYEY KEMP ASSOCIATES  
2022 Raleigh, NC  
Raleigh, North Carolina 27609  
Phone: 919.877.7115  
www.rkainc.com  
NC License No. F-4480



## GENERAL NOTES

CHANGES MAY BE REQUIRED WHEN PHYSICAL DIMENSIONS IN THE DETAIL DRAWINGS, STANDARD DETAILS, AND ROADWAY DETAILS ARE NOT ATTAINABLE TO MEET FIELD CONDITIONS OR RESULT IN DUPLICATE OR UNDESIRED OVERLAPPING OF DEVICES. MODIFICATION MAY INCLUDE: MOVING, SUPPLEMENTING, COVERING, OR REMOVAL OF DEVICES AS DIRECTED BY THE ENGINEER.

THE FOLLOWING GENERAL NOTES APPLY AT ALL TIMES FOR THE DURATION OF THE CONSTRUCTION PROJECT EXCEPT WHEN OTHERWISE NOTED IN THE PLAN OR DIRECTED BY THE ENGINEER.

## TIME RESTRICTIONS

A) DO NOT CLOSE OR NARROW TRAVEL LANES AS FOLLOWS:

<u>ROAD NAME</u>	<u>DAY AND TIME</u>	<u>RESTRICTIONS</u>
SR 2222 (WATKINS TOWN ROAD)	MONDAY-FRIDAY	6AM-9AM 4PM-7PM
PHASE I - STEP B MAY BE COMPLETED WITH NO DAY/TIME RESTRICTIONS UNDER ROAD CLOSURE AND DETOUR.		

B) DO NOT CLOSE OR NARROW TRAVEL LANES DURING HOLIDAYS AND SPECIAL EVENTS AS FOLLOWS:

## ROAD NAME

SR 2222 (WATKINS TOWN ROAD)

HOLIDAY

1. FOR ANY UNEXPECTED OCCURRENCE THAT CREATES UNUSUALLY HIGH TRAFFIC VOLUMES, AS DIRECTED BY THE ENGINEER.
2. FOR NEW YEAR'S, BETWEEN THE HOURS OF 6:00 A.M. DECEMBER 31st TO 7:00 P.M. JANUARY 2ND. IF NEW YEAR'S DAY IS ON A FRIDAY, SATURDAY, SUNDAY, OR MONDAY THEN UNTIL 7:00 P.M. THE FOLLOWING TUESDAY.
3. FOR EASTER, BETWEEN THE HOURS OF 6:00 A.M. THURSDAY AND 7:00 P.M. MONDAY.
4. FOR MEMORIAL DAY, BETWEEN THE HOURS OF 6:00 A.M. FRIDAY TO 7:00 P.M. TUESDAY.
5. FOR INDEPENDENCE DAY, BETWEEN THE HOURS OF 6:00 A.M. THE DAY BEFORE INDEPENDENCE DAY AND 7:00 P.M. THE DAY AFTER INDEPENDENCE DAY.  
  
IF INDEPENDENCE DAY IS ON A FRIDAY, SATURDAY, SUNDAY OR MONDAY THEN BETWEEN THE HOURS OF 6:00 A.M. THE THURSDAY BEFORE INDEPENDENCE DAY AND 7:00 P.M. THE TUESDAY AFTER INDEPENDENCE DAY.
6. FOR LABOR DAY, BETWEEN THE HOURS OF 6:00 A.M. FRIDAY AND 7:00 P.M. TUESDAY.
7. FOR THANKSGIVING DAY, BETWEEN THE HOURS OF 6:00 A.M. TUESDAY TO 7:00 P.M. MONDAY.
8. FOR CHRISTMAS, BETWEEN THE HOURS OF 6:00 A.M. THE FRIDAY BEFORE THE WEEK OF CHRISTMAS DAY AND 7:00 P.M. THE FOLLOWING TUESDAY AFTER THE WEEK OF CHRISTMAS.

C) DO NOT CONDUCT ANY HAULING OPERATIONS AGAINST THE FLOW OF TRAFFIC OF AN OPEN TRAVELWAY UNLESS THE HAULING OPERATION IS PROTECTED BY BARRIER OR GUARDRAIL OR AS DIRECTED BY THE ENGINEER.

## LANE AND SHOULDER CLOSURE REQUIREMENTS

- D) REMOVE LANE CLOSURE DEVICES FROM THE LANE WHEN WORK IS NOT BEING PERFORMED BEHIND THE LANE CLOSURE OR WHEN A LANE CLOSURE IS NO LONGER NEEDED OR AS DIRECTED BY THE ENGINEER.
  - E) WHEN PERSONNEL AND/OR EQUIPMENT ARE WORKING WITHIN 15 FT OF AN OPEN TRAVEL LANE, CLOSE THE NEAREST OPEN SHOULDER USING ROADWAY STANDARD DRAWING NO. 1101.04 UNLESS THE WORK AREA IS PROTECTED BY BARRIER OR GUARDRAIL OR A LANE CLOSURE IS INSTALLED.
  - F) WHEN PERSONNEL AND/OR EQUIPMENT ARE WORKING ON THE SHOULDER ADJACENT TO AN UNDIVIDED FACILITY AND WITHIN 5 FT OF AN OPEN TRAVEL LANE, CLOSE THE NEAREST OPEN TRAVEL LANE USING ROADWAY STANDARD DRAWING NO. 1101.02 UNLESS THE WORK AREA IS PROTECTED BY BARRIER OR GUARDRAIL.
- WHEN PERSONNEL AND/OR EQUIPMENT ARE WORKING WITHIN A LANE OF TRAVEL OF AN UNDIVIDED OR DIVIDED FACILITY, CLOSE THE LANE ACCORDING TO THE TRAFFIC CONTROL PLANS, ROADWAY STANDARD DRAWINGS, OR AS DIRECTED BY THE ENGINEER. CONDUCT THE WORK SO THAT ALL PERSONNEL AND/OR EQUIPMENT REMAIN WITHIN THE CLOSED TRAVEL LANE.
- G) DO NOT WORK SIMULTANEOUSLY WITHIN 15 FT ON BOTH SIDES OF AN OPEN TRAVELWAY, RAMP, OR LOOP WITHIN THE SAME LOCATION UNLESS PROTECTED WITH GUARDRAIL OR BARRIER.
  - H) DO NOT INSTALL MORE THAN ONE LANE CLOSURE IN ANY ONE DIRECTION ON SR 2222 (WATKINS TOWN ROAD).

## PAVEMENT EDGE DROP OFF REQUIREMENTS

- I) BACKFILL AT A 6:1 SLOPE UP TO THE EDGE AND ELEVATION OF EXISTING PAVEMENT IN AREAS ADJACENT TO AN OPENED TRAVEL LANE THAT HAS AN EDGE OF PAVEMENT DROP-OFF AS FOLLOWS:
- BACKFILL DROP-OFFS THAT EXCEED 2 INCHES ON ROADWAYS WITH POSTED SPEED LIMITS OF 45 MPH OR GREATER.
- BACKFILL DROP-OFFS THAT EXCEED 3 INCHES ON ROADWAYS WITH POSTED SPEED LIMITS LESS THAN 45 MPH.
- BACKFILL WITH SUITABLE COMPACTED MATERIAL, AS APPROVED BY THE ENGINEER, AT NO EXPENSE TO THE DEPARTMENT.
- J) DO NOT EXCEED A DIFFERENCE OF 2 INCHES IN ELEVATION BETWEEN OPEN LANES OF TRAFFIC FOR NOMINAL LIFTS OF 1.5 INCHES. INSTALL ADVANCE WARNING "UNEVEN LANES" SIGNS (WB-11) 350FT IN ADVANCE AND A MINIMUM OF EVERY HALF MILE THROUGHOUT THE UNEVEN AREA.

[illegible]

SHEET NO.  
TMP-1

## EVERLEE SUBDIVISION ROADWAY IMPROVEMENTS

RALEIGH, NORTH CAROLINA

## GENERAL NOTES

## REVISIONS

**DOCUMENT NOT CONSIDERED FINAL UNLESS ALL SIGNATURES COMPLETED**

## SCALES

H-SCALE • NA

DATE: 11/08/2022

SIGNED BY: MR:

CHECKED BY: WJH

Infrastructure Consulting Services, Inc.

**514**

JKL

**VIVA****RAMEY KEMP ASSOCIATES**

5103 Farington Place  
Raleigh, North Carolina 27626

Phone: 519-872-5115

NC License No. F-1489  
www.rameykemp.com



### **GENERAL NOTES (CONT.)**

## TRAFFIC PATTERN ALTERATIONS

- J) NOTIFY THE ENGINEER 30 DAYS PRIOR TO ANY TRAFFIC PATTERN ALTERATION.

## SIGNING

- K) INSTALL ADVANCE WORK ZONE WARNING SIGNS WHEN WORK IS WITHIN 40 FT FROM THE EDGE OF TRAVEL LANE AND NO MORE THAN THREE (3) DAYS PRIOR TO THE BEGINNING OF CONSTRUCTION.
- L) ENSURE ALL NECESSARY SIGNING IS IN PLACE PRIOR TO ALTERING ANY TRAFFIC PATTERN.
- M) INSTALL BLACK ON ORANGE "DIP" SIGNS (W8-2) AND/OR "BUMP" SIGNS (W8-1) 350FT IN ADVANCE OF THE UNEVEN AREA, OR AS DIRECTED BY THE ENGINEER.

## TRAFFIC CONTROL DEVICES

- N) WHEN LANE CLOSURES ARE NOT IN EFFECT SPACE CHANNELIZING DEVICES IN WORK AREAS NO GREATER IN FEET THAN TWICE THE POSTED SPEED LIMIT (MPH) EXCEPT, 10 FT ON-CENTER IN RADII, AND 3 FT OFF THE EDGE OF AN OPEN TRAVELWAY. REFER TO STANDARD SPECIFICATIONS FOR ROADS AND STRUCTURES SECTIONS 1130 (DRUMS), 1135 (CONES) AND 1180 (SKINNY DRUMS) FOR ADDITIONAL REQUIREMENTS.

## PAVEMENT MARKINGS AND MARKERS

- P) REMOVE/REPLACE ANY CONFLICTING/DAMAGED PAVEMENT MARKINGS AND MARKERS BY THE END OF EACH DAY'S OPERATION.

[illegible]

SHEET NO.  
TMP-2

EVERLEE SUBDIVISION  
ROADWAY IMPROVEMENTS

LEIGH, NORTH CAROLINA

## GENERAL NOTES

## REVISIONS

## SCALES

H-SCALE • NA

DATE: 11/08/2022

DESIGNED BY: MRS

CHECKED BY: WJH

Structure Consulting Servi

Infrastructure Consulting Services, Inc.

**RKA**

**RAMEY KEMP ASSOCIATES**5808 Farrington Place  
Raleigh, North Carolina 27609

Phone: 519-872-5115



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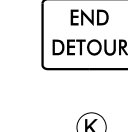
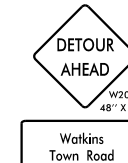
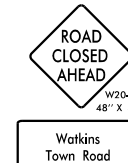
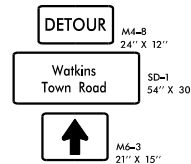
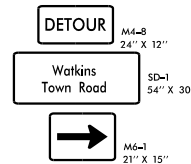
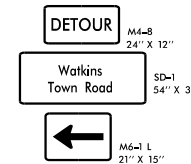
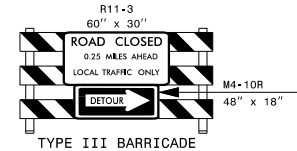
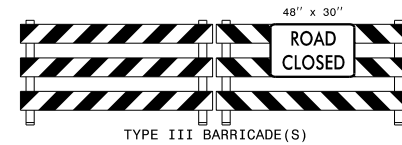
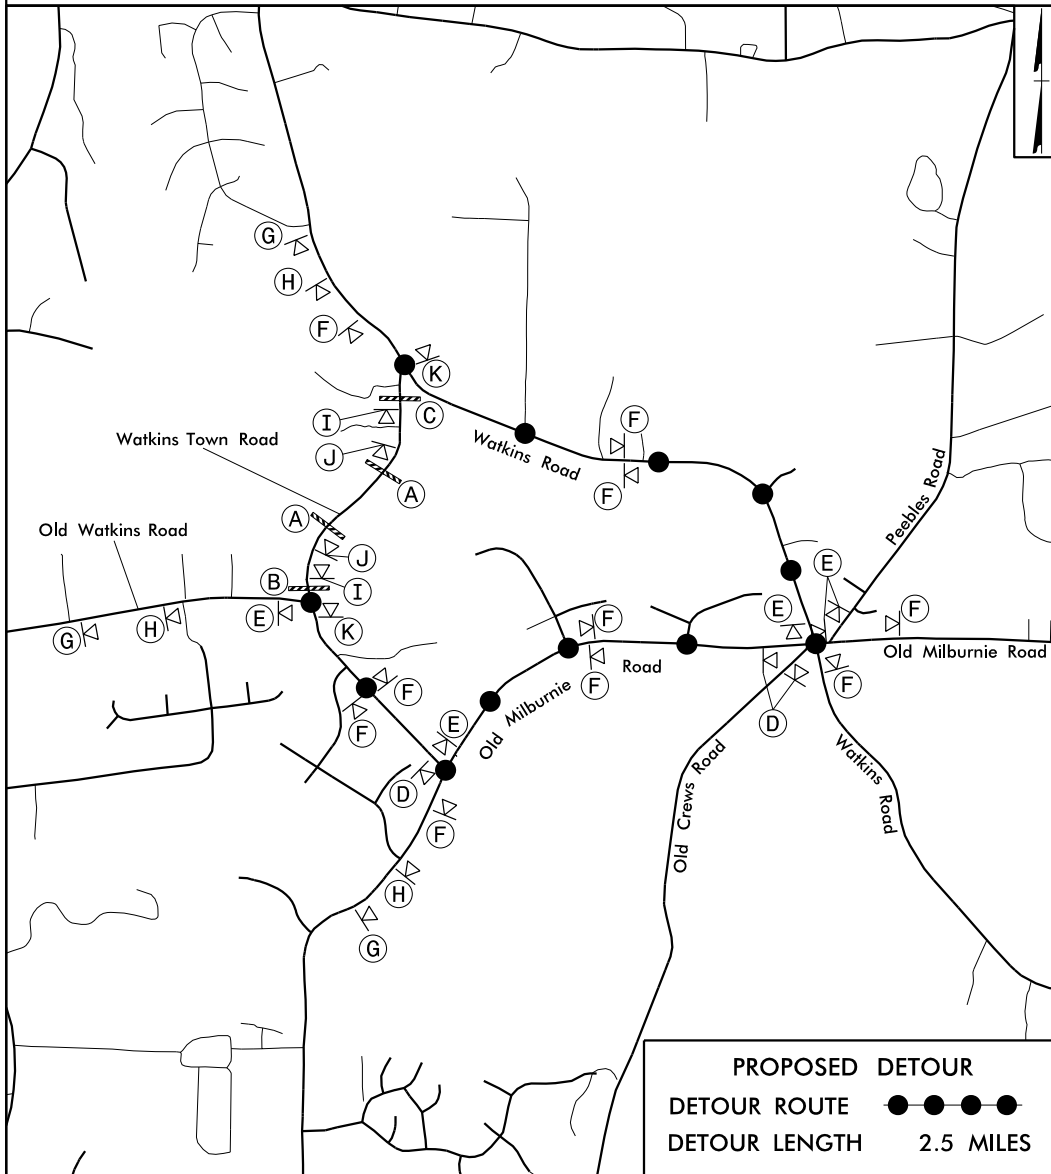






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# WATKINS TOWN ROAD DETOUR VIA OLD MILBURNIE ROAD AND WATKINS ROAD



**CITY OF RALEIGH - PLANS AUTHORIZED FOR CONSTRUCTION**

Plans for the proposed use have been reviewed for general compliance with the City of Raleigh's standards and specifications for construction and materials. The City of Raleigh and its authorized representatives do not warrant the accuracy or completeness of the information provided for the design and construction of the project. The design, engineering, and construction are each responsible for the accuracy and completeness of the design and construction. The City of Raleigh is not responsible for the design, engineering, and construction of the project. The City of Raleigh is not responsible for the design, engineering, and construction of the project. The City of Raleigh is not responsible for the design, engineering, and construction of the project.

City of Raleigh  
 Development Approval

SHEET NO.  
 TMP-5

EVERLEE SUBDIVISION  
 ROADWAY IMPROVEMENTS  
 RALEIGH, NORTH CAROLINA  
 DETOUR ROUTE

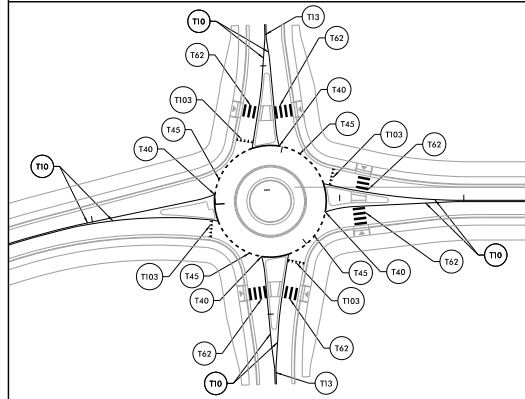


REVISIONS	SCALES
	H=SCALE: NA
	V=SCALE: NA
	DATE: 11/08/2022
	DESIGNED BY: MRS
	CHECKED BY: JWH
	Infrastructure Consulting Services, Inc.
	<b>RKA</b>
	RAHEE KEMP ASSOCIATES
	2000 Independence Place
	Raleigh, North Carolina 27605
	Phone 919/961-7418
	NC License No. 74189
	www.raheekemp.com

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 SIGNATURES COMPLETED




# EXHIBIT A: ROUNDABOUT PAVEMENT MARKING CALLOUTS



## PAVEMENT MARKING SCHEDULE

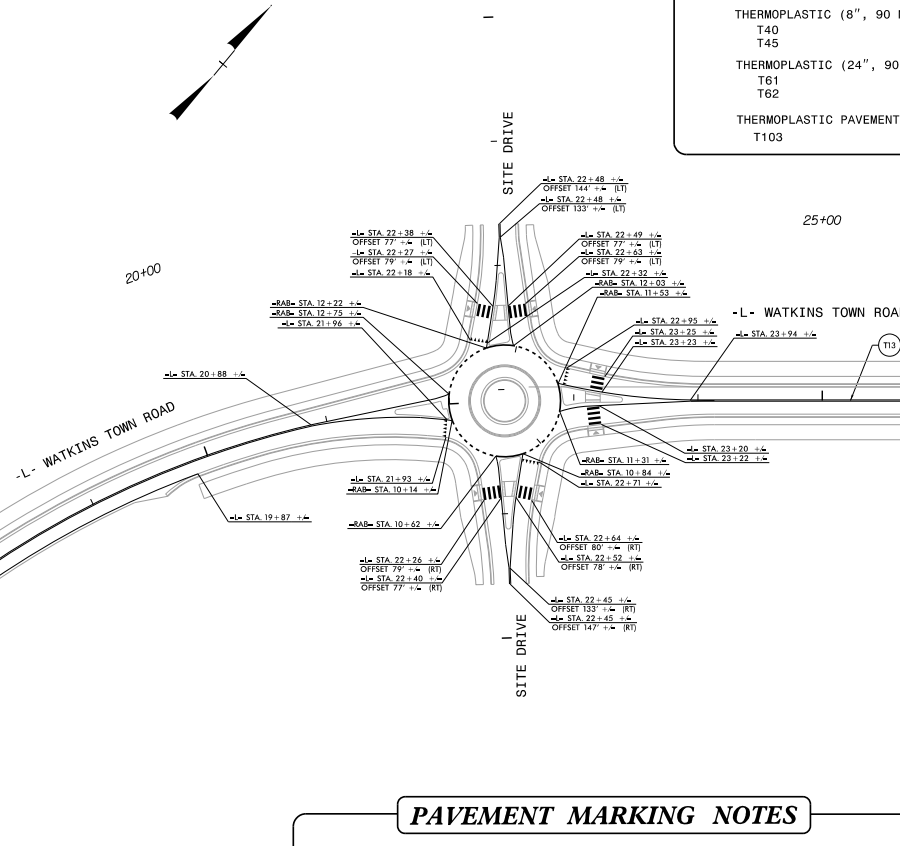SYMBOL	DESCRIPTION
THERMOPLASTIC (4", 90 MILS)	
T1	WHITE EDGELINE
T10	YELLOW EDGELINE
T13	YELLOW DOUBLE CENTER
THERMOPLASTIC (8", 90 MILS)	
T40	WHITE GORELINE
T45	3FT. -3FT./SP WHITE MINISKIP
THERMOPLASTIC (24", 90 MILS)	
T61	WHITE STOPBAR
T62	WHITE CROSSWALK LINE
THERMOPLASTIC PAVEMENT MARKING SYMBOLS (90 MILS)	
T103	24" YIELD LINE TRIANGLE



MATCHLINE -L- STA. 26 + 00  
SEE SHEET PMP-2

## ROADWAY STANDARD DRAWING

THE FOLLOWING ROADWAY STANDARDS AS APPEAR IN "ROADWAY STANDARD DRAWINGS" - PROJECT SERVICES UNIT - N.C. DEPARTMENT OF TRANSPORTATION - RALEIGH, N.C., DATED JANUARY 2018 ARE APPLICABLE TO THIS PROJECT AND BY REFERENCE HEREBY ARE CONSIDERED A PART OF THESE PLANS:

STD. NO.	TITLE
1205.01	PAVEMENT MARKINGS - LINE TYPES AND OFFSETS
1205.04	PAVEMENT MARKINGS - INTERSECTIONS
1205.07	PAVEMENT MARKINGS - PEDESTRIAN CROSSWALKS
1205.08	PAVEMENT MARKINGS - SYMBOLS AND WORD MESSAGES
1205.14	PAVEMENT MARKINGS - ROUNDABOUTS
1264.01	OBJECT MARKERS - TYPES
1264.02	OBJECT MARKERS - INSTALLATION

## PAVEMENT MARKING NOTES

THE FOLLOWING GENERAL NOTES APPLY AT ALL TIMES FOR THE DURATION OF THE CONSTRUCTION PROJECT, EXCEPT WHEN OTHERWISE NOTED IN THE PLAN, OR DIRECTED BY THE ENGINEER.

- INSTALL PAVEMENT MARKINGS AND PAVEMENT MARKERS ON THE FINAL SURFACE AS FOLLOWS:
 

ROAD NAME	MARKING	MARKER
ALL ROADS	THERMOPLASTIC	RAISED (IF EXISTING)
- TIE PROPOSED PAVEMENT MARKING LINES TO EXISTING PAVEMENT MARKING LINES.
- REMOVE/REPLACE ANY CONFLICTING/DAMAGED PAVEMENT MARKINGS AND MARKERS.
- STOP BAR LOCATION AT NON-SIGNALIZED INTERSECTIONS MAY BE ADJUSTED AS DIRECTED BY THE ENGINEER.

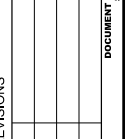
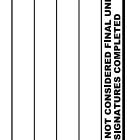
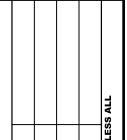
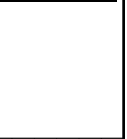
**CITY OF RALEIGH PLANS AUTHORIZED FOR CONSTRUCTION**

Plans for the proposed use have been reviewed for general compliance with applicable codes, laws, ordinances, and standards for construction and are to be considered for construction and construction of the project. The City of Raleigh, North Carolina, and its departments and divisions, including the Department of Transportation, and its contractors are each responsible for compliance with all applicable City, State and Federal laws, rules, regulations, codes, standards, and specifications. The City of Raleigh, North Carolina, and its departments and divisions, including the Department of Transportation, and its contractors are each responsible for compliance with all applicable City, State and Federal laws, rules, regulations, codes, standards, and specifications. The City of Raleigh, North Carolina, and its departments and divisions, including the Department of Transportation, and its contractors are each responsible for compliance with all applicable City, State and Federal laws, rules, regulations, codes, standards, and specifications.

City of Raleigh  
Development Approval

SHEET NO.  
PMP-1

EVERLEE SUBDIVISION  
ROADWAY IMPROVEMENTS  
RALEIGH, NORTH CAROLINA  
PAVEMENT MARKING DETAILS



REVISIONS	SCALES
	H-SCALE = 1"=50'
	V-SCALE = 1"=10'
	DATE: 11/08/2022
	DESIGNED BY: MRS
	CHECKED BY: JWH


Infrastructure Consulting Services, Inc.  
**RKA**  
RAYEY KEMP ASSOCIATES  
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Fax 919.701.1119  
www.rkainc.com



# PAVEMENT MARKING SCHEDULE

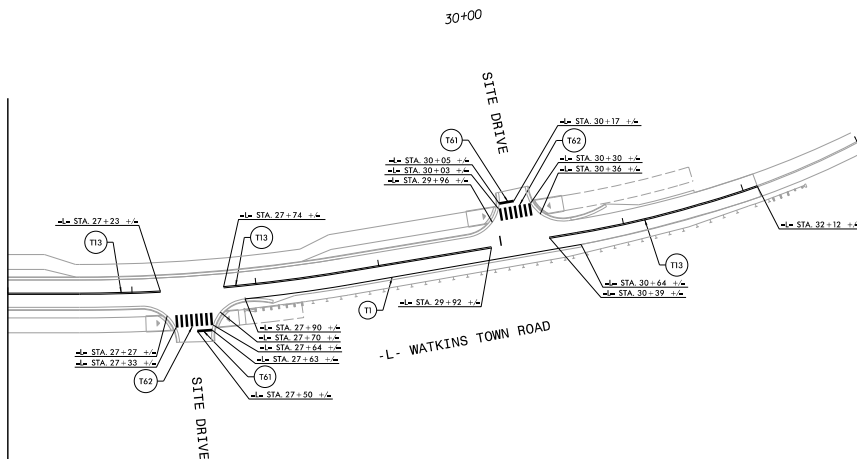SYMBOL	DESCRIPTION
THERMOPLASTIC (4", 90 MILS)	
T1	WHITE EDGELINE
T13	YELLOW DOUBLE CENTER
THERMOPLASTIC (24", 90 MILS)	
T61	WHITE STOPBAR
T62	WHITE CROSSWALK LINE

MATCHLINE -L- STA. 26+00  
SEE SHEET PMP-1



**CITY OF RALEIGH - PLANS AUTHORIZED FOR CONSTRUCTION**

Plans for the proposed use have been reviewed for general compliance with applicable codes, regulations, and standards for construction and to be consistent with applicable codes, regulations, and standards for development and construction. The proposed use, development, and construction are each responsible for compliance with all applicable City, State and Federal laws, regulations, and standards. The proposed use, development, and construction must be consistent with the City's Comprehensive Zoning Ordinance and the City's Comprehensive Land Use Ordinance. The proposed use, development, and construction must be consistent with the City's Comprehensive Land Use Ordinance and the City's Comprehensive Zoning Ordinance.

City of Raleigh  
Development Approval

SHEET NO.  
PMP-2

EVERLEE SUBDIVISION  
ROADWAY IMPROVEMENTS

RALEIGH, NORTH CAROLINA

PAVEMENT MARKING DETAILS

REVISIONS


SCALES

H-SCALE = 1"=50'

V-SCALE = 1"=10'

DATE: 11/08/2022

DESIGNED BY: MRS

CHECKED BY: WJH

DOCUMENT NOT CONSIDERED FINAL UNLESS ALL  
SIGNATURES COMPLETED

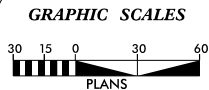
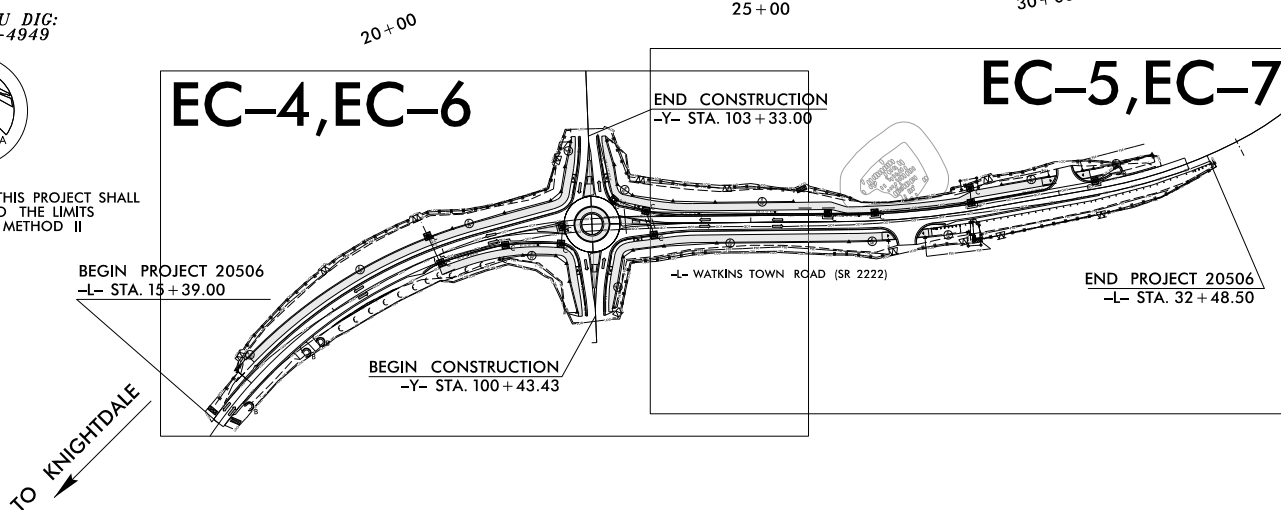
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Raleigh, North Carolina 27605  
Phone 919/967-1115  
NC License No. 54149  
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**PROJECT: EVERLEE SUBDIVISION**



CLEARING ON THIS PROJECT SHALL  
BE PERFORMED TO THE LIMITS  
ESTABLISHED BY METHOD II



ROADSIDE ENVIRONMENTAL UNIT  
DIVISION OF HIGHWAYS  
STATE OF NORTH CAROLINA

THESE EROSION AND SEDIMENT CONTROL PLANS COMPLY  
WITH THE REGULATIONS SET FORTH BY THE  
NCG-010000 GENERAL CONSTRUCTION PERMIT EFFECTIVE AUGUST 3, 2011  
ISSUED BY THE NORTH CAROLINA DEPARTMENT OF ENVIRONMENT AND  
NATURAL RESOURCES DIVISION OF WATER QUALITY.

Prepared in the Office of:

**RKA**  
RAMEY KEMP ASSOCIATES

Designed by:  
**SAMANTHA A. SHEFTE**  
Reviewed by:  
**MICHAEL D. BYWALETZ, P.E.**

LEVEL III [REDACTED]

**DOCUMENT NOT CONSIDERED FINAL  
UNLESS ALL SIGNATURES COMPLETED**

**CITY OF RALEIGH PLANS AUTHORIZED FOR CONSTRUCTION**

Plans for the proposed use have been submitted for general compliance with applicable codes, ordinances, rules and regulations for construction by the City of Raleigh. The City Engineer and authorizing officials for construction are to be considered to represent total compliance with the applicable codes, ordinances for development and construction. The property owner, under approval, is responsible for obtaining all applicable permits from the City of Raleigh, the State of North Carolina, and Federal laws. This specific authorization is not a permit, nor does it constitute a final decision by the City of Raleigh, State or Federal laws. The City Engineer must be in accordance with the Local, State, and Federal Plans and Regulations.

**Electronic Approval:** The approval is being issued electronically. This approval is subject to the terms and conditions of the City of Raleigh Ordinance below. The City Engineer is a copy of the approved documents. Any work authorized by the approval must proceed accordance with the terms set forth on the plan and the City Engineer must be in accordance with the City of Raleigh Ordinance below. The approval is not a permit, nor does it constitute a final decision by the City of Raleigh, State or Federal laws. The City Engineer must be in accordance with the Local, State, and Federal Plans and Regulations.

City of Raleigh  
Development Approval

[illegible]

SHEET NO.  
EC-1

EVERLEE SUBDIVISION  
ROADWAY IMPROVEMENTS

RALEIGH, NORTH CAROLINA

EROSION CONTROL PLANS

VISIONS	

**DOCUMENT NOT CONSIDERED FINAL UNLESS ALL SIGNATURES COMPLETED**

SCALES  
 H-SCALE = NA  
 V-SCALE = NA  
 DATE: 11/08/2022  
 DESIGNED BY: SAS  
 CHECKED BY: MDB  
 Infrastructure Consulting Services, Inc.  
  
**RAMEY KEMP ASSOCIATES**  
 5808 Farrington Place  
 Raleigh, North Carolina 27605  
 Phone: 919-270-1115  
 NC License No. F-1489  
[www.rameykemp.com](http://www.rameykemp.com)



Implementing the details and specifications on this plan sheet will result in the construction activity being considered compliant with the Ground Stabilization and Materials Handling sections of the NCG01 Construction General Permit (Sections E and F, respectively). The permittee shall comply with the Erosion and Sediment Control plan approved by the delegated authority having jurisdiction. All details and specifications shown on this sheet may not apply depending on site conditions and the delegated authority having jurisdiction.

Required Ground Stabilization Timeframes		
Site Area Description	Stabilize within this many calendar days after ceasing land disturbance	Timeframe variations
(a) Perimeter dikes, swales, ditches, and perimeter slopes	7	None
(b) High Quality Water (HQP) Zones	7	None
(c) Slopes steeper than 3:1	7	If slopes are 10' or less in length and are not steeper than 2:1, 14 days are allowed
(d) Slopes 3:1 to 4:1	14	-7 days for slopes greater than 50' in length and with slopes steeper than 4:1 -7 days for perimeter dikes, swales, ditches, perimeter slopes and HQP Zones -10 days for Falls Lake Watershed
(e) Areas with slopes flatter than 4:1	14	-7 days for perimeter dikes, swales, ditches, perimeter slopes and HQP Zones -10 days for Falls Lake Watershed unless there is zero slope

Temporary Stabilization	Permanent Stabilization
<ul style="list-style-type: none"> <li>Temporary grass seed covered with straw or other mulches and tackifiers</li> <li>Hydroseeding</li> <li> Rolled erosion control products with or without temporary grass seed</li> <li> Appropriately applied straw or other mulch</li> <li> Plastic sheeting</li> </ul>	<ul style="list-style-type: none"> <li>Permanent grass seed covered with straw or other mulches and tackifiers</li> <li> Geotextile fabrics such as permanent soil reinforcement matting</li> <li>Hydroseeding</li> <li> Shrubs or other permanent plantings covered with mulch</li> <li> Uniform and evenly distributed ground cover sufficient to restrain erosion</li> <li> Structural methods such as concrete, asphalt or retaining walls</li> <li> Rolled erosion control products with grass seed</li> </ul>

1. Temporary matting to be provided on all slopes 2:1 or steeper and on all ditch banks.

1. Maintain vehicles and equipment to prevent discharge of fluids.
2. Provide drip pans under any stored equipment.
3. Identify leaks and repair as soon as feasible, or remove leaking equipment from the project.
4. Collect all spent fluids, store in separate containers and properly dispose as hazardous waste (recycle when possible).
5. Remove leaking vehicles and construction equipment from service until the problem has been corrected.
6. Bring used fuels, lubricants, coolants, hydraulic fluids and other petroleum products to a recycling or disposal center that handles these materials.

1. Never bury or burn waste. Place litter and debris in approved waste containers.
2. Provide a sufficient number and size of waste containers (e.g. dumpster, trash receptacle) on site to contain construction and domestic wastes.
3. Locate waste containers at least 50 feet away from storm drain inlets and surface waters unless no other alternatives are reasonably available.
4. Locate waste containers on areas that do not receive substantial amounts of runoff from upland areas and does not drain directly to a storm drain, stream or wetland.
5. Cover waste containers at the end of each workday and before storm events or provide secondary containment. Repair or replace damaged waste containers.
6. Anchor all lightweight items in waste containers during times of high winds.
7. Empty waste containers as needed to prevent overflow. Clean up immediately if containers overflow.
8. Dispose waste off-site at an approved disposal facility.
9. On business days, clean up and dispose of waste in designated waste containers.

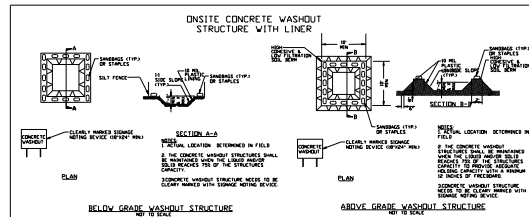
1. Do not dump paint and other liquid waste into storm drains, streams or wetlands.
2. Locate paint washouts at least 50 feet away from storm drain inlets and surface waters unless no other alternatives are reasonably available.
3. Contain liquid wastes in a controlled area.
4. Containment must be labeled, sized and placed appropriately for the needs of site.
5. Prevent the discharge of soaps, solvents, detergents and other liquid wastes from construction sites.

1. Install portable toilets on level ground, at least 50 feet away from storm drains, streams or wetlands unless there is no alternative reasonably available. If 50 foot offset is not attainable, provide relocation of portable toilet behind silt fence or place on a gravel pad and surround with sand bags.
2. Provide staking or anchoring of portable toilets during periods of high winds or in high foot traffic areas.
3. Monitor portable toilets for leaking and properly dispose of any leaked material. Utilize a licensed sanitary waste hauler to remove leaking portable toilets and replace with properly operating unit.

1. Show stockpile locations on plans. Locate earthen-material stockpile areas at least 50 feet away from storm drain inlets, sediment basins, perimeter sediment controls and surface waters unless it can be shown no other alternatives are reasonably available.
2. Protect stockpile with silt fence installed along toe of slope with a minimum offset of five feet from the toe of stockpile.
3. Provide stable stone access point when feasible.
4. Stabilize stockpile within the timeframes provided on this sheet and in accordance with the approved plan and any additional requirements. Soil stabilization is defined as vegetative, physical or chemical coverage techniques that will restrain accelerated erosion on disturbed soils for temporary or permanent control needs.

1. Create designated hazardous waste collection areas on-site.
2. Place hazardous waste containers under cover or in secondary containment.
3. Do not store hazardous chemicals, drums or bagged materials directly on the ground.

1. Store and apply herbicides, pesticides and rodenticides in accordance with label restrictions.
2. Store herbicides, pesticides and rodenticides in their original containers with the label, which lists directions for use, ingredients and first aid steps in case of accidental poisoning.
3. Do not store herbicides, pesticides and rodenticides in areas where flooding is possible or where they may spill or leak into wells, stormwater drains, ground water or surface water. If a spill occurs, clean area immediately.
4. Do not stockpile these materials onsite.



1. Do not discharge concrete or cement slurry from the site.
2. Dispose of, or recycle settled, hardened concrete residue in accordance with local and state solid waste regulations and at an approved facility.
3. Manage washout from mortar mixers in accordance with the above item and in addition place the mixer and associated materials on impervious barrier and within lot perimeter silt fence.
4. Install temporary concrete washouts per local requirements, where applicable. If an alternate method or product is to be used, contact your approval authority for review and approval. If local standard details are not available, use one of the two types of temporary concrete washouts provided on this detail.
5. Do not use concrete washouts for dewatering or storing defective curb or sidewalk sections. Stormwater accumulated within the washout may not be pumped into or discharged to the storm drain system or receiving surface waters. Liquid waste must be pumped out and removed from project.
6. Locate washouts at least 50 feet from storm drain inlets and surface waters unless it can be shown that no other alternatives are reasonably available. At a minimum, install protection of storm drain inlet(s) closest to the washout which could receive spills or overflow.
7. Locate washouts in an easily accessible area, on level ground and install a stone entrance pad in front of the washout. Additional controls may be required by the approving authority.
8. Install at least one sign directing concrete trucks to the washout within the project limits. Post signage on the washout itself to identify this location.
9. Remove the leavings from the washout when at approximately 75% capacity to limit overflow events. Replace the tarp, sand bags or other temporary structural components when no longer functional. When utilizing alternative or proprietary products, follow manufacturer's instructions.
10. At the completion of the concrete work, remove remaining leavings and dispose of in an approved disposal facility. Fill pit, if applicable, and stabilize any disturbance caused by removal of washout.

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EVERLEE SUBDIVISION  
ROADWAY IMPROVEMENTS  
RALEIGH, NORTH CAROLINA  
EROSION CONTROL SHEETS


**DOCUMENT NOT CONSIDERED FINAL UNLESS ALL SIGNATURES COMPLETED**

[www.rameykemp.com](http://www.rameykemp.com)

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**PART III  
SELF-INSPECTION, RECORDKEEPING AND REPORTING**

**SECTION A: SELF-INSPECTION**

Self-inspections are required during normal business hours in accordance with the table below. When adverse weather or site conditions would cause the safety of the inspection personnel to be in jeopardy, the inspection may be delayed until the next business day on which it is safe to perform the inspection. In addition, when a storm event of equal to or greater than 1.0 inch occurs outside of normal business hours, the self-inspection shall be performed upon the commencement of the next business day. Any time when inspections were delayed shall be noted in the Inspection Record.

Inspect	Frequency (during normal business hours)	Inspection records must include:
(1) Rain gauge maintained in good working order	Daily	Daily rainfall amounts. If no daily rain gauge observations are made during weekend or holiday periods, and no individual-day rainfall information is available, record the cumulative rain measurement for those unattended days (and this will determine if a site inspection is needed). Days on which no rainfall occurred shall be recorded as "zero." The permittee may use another rain-monitoring device approved by the Division.
(2) E&SC Measures	At least once per 7 calendar days and within 24 hours of a rain event ≥ 1.0 inch in 24 hours	1. Identification of the measures inspected, 2. Date and time of the inspection, 3. Name of the person performing the inspection, 4. Indication of whether the measures were operating properly, 5. Description of maintenance needs for the measures, 6. Description, evidence, and date of corrective actions taken.
(3) Stormwater discharge outlets (SDOs)	At least once per 7 calendar days and within 24 hours of a rain event ≥ 1.0 inch in 24 hours	1. Identification of the discharge outlets inspected, 2. Date and time of the inspection, 3. Name of the person performing the inspection, 4. Evidence of indicators of stormwater pollution such as oil sheen, floating or suspended solids or discoloration, 5. Indication of visible sediment leaving the site, 6. Description, evidence, and date of corrective actions taken.
(4) Perimeter of site	At least once per 7 calendar days and within 24 hours of a rain event ≥ 1.0 inch in 24 hours	(If visible sedimentation is found outside site limits, then a record of the following shall be made): 1. Actions taken to clean up or stabilize the sediment that has left the site limits, 2. Description, evidence, and date of corrective actions taken, and 3. An explanation as to the actions taken to control future releases.
(5) Streams or wetlands on-site or off-site (where accessible)	At least once per 7 calendar days and within 24 hours of a rain event ≥ 1.0 inch in 24 hours	(If the stream or wetland has increased visible sedimentation or a stream has visible increased turbidity from the construction activity then a record of the following shall be made): 1. Description, evidence and date of corrective actions taken, and 2. Records of the required reports to the appropriate Division Regional Office per Part III, Section C, Item 12(a) of this permit.
(6) Ground stabilization measures	After each phase of grading	1. The phase of grading (installation of perimeter E&SC measures, clearing and grubbing, installation of storm drainage facilities, completion of all land-disturbing activity, construction or redevelopment, permanent ground cover). 2. Documentation that the required ground stabilization measures have been provided within the required timeframe or an assurance that they will be provided as soon as possible.

NOTE: The rain inspection resets the required 7 calendar day inspection requirement.

**PART II, SECTION G, ITEM (4)  
DRAW DOWN OF SEDIMENT BASINS FOR MAINTENANCE OR CLOSE OUT**

Sediment basins and traps that receive runoff from drainage areas of one acre or more shall use outlet structures that withdraw water from the surface when these devices need to be drawn down for maintenance or close out unless this is infeasible. The circumstances in which it is not feasible to withdraw water from the surface shall be rare (for example, times with extended cold weather). Non-surface withdrawals from sediment basins shall be allowed only when all of the following criteria have been met:

- The E&SC plan authority has been provided with documentation of the non-surface withdrawal and the specific time periods or conditions in which it will occur. The non-surface withdrawal shall not commence until the E&SC plan authority has approved these items.
- The non-surface withdrawal has been reported as an anticipated bypass in accordance with Part II, Section C, Item 12(c) and (d) of this permit.
- Dewatering discharges are treated with controls to minimize discharges of pollutants from stormwater that is removed from the sediment basin. Examples of appropriate controls include properly sited, designed and maintained dewatering tanks, weir tanks, and filtration systems.
- Vegetated, upland areas of the sites or a properly designed stone pad is used to the extent feasible at the outlet of the dewatering treatment devices described in Item (c) above.
- Velocity dissipation devices such as check dams, sediment traps, and riprap are provided at the discharge points of all dewatering devices, and
- Sediment removed from the dewatering treatment devices described in Item (c) above is disposed of in a manner that does not cause deposition of sediment into waters of the United States.

**PART III  
SELF-INSPECTION, RECORDKEEPING AND REPORTING**

**SECTION B: RECORDKEEPING  
1. E&SC Plan Documentation**

The approved E&SC plan as well as any approved deviation shall be kept on the site. The approved E&SC plan must be kept up-to-date throughout the coverage under this permit. The following items pertaining to the E&SC plan shall be kept on site and available for inspection at all times during normal business hours.

Item to Document	Documentation Requirements
(a) Each E&SC measure has been installed and does not significantly deviate from the locations, dimensions and relative elevations shown on the approved E&SC plan.	Initial and date each E&SC measure on a copy of the approved E&SC plan or complete, date and sign an inspection report that lists each E&SC measure shown on the approved E&SC plan. This documentation is required upon the initial installation of the E&SC measures or if the E&SC measures are modified after initial installation.
(b) A phase of grading has been completed.	Initial and date a copy of the approved E&SC plan or complete, date and sign an inspection report to indicate completion of the construction phase.
(c) Ground cover is located and installed in accordance with the approved E&SC plan.	Initial and date a copy of the approved E&SC plan or complete, date and sign an inspection report to indicate compliance with approved ground cover specifications.
(d) The maintenance and repair requirements for all E&SC measures have been performed.	Complete, date and sign an inspection report.
(e) Corrective actions have been taken to E&SC measures.	Initial and date a copy of the approved E&SC plan or complete, date and sign an inspection report to indicate the completion of the corrective action.

**2. Additional Documentation to be Kept on Site**

In addition to the E&SC plan documents above, the following items shall be kept on the site and available for inspectors at all times during normal business hours, unless the Division provides a site-specific exemption based on unique site conditions that make this requirement not practical:

- This General Permit as well as the Certificate of Coverage, after it is received.
- Records of inspections made during the previous twelve months. The permittee shall record the required observations on the Inspection Record Form provided by the Division or a similar inspection form that includes all the required elements. Use of electronically-available records in lieu of the required paper copies will be allowed if shown to provide equal access and utility as the hard-copy records.

**3. Documentation to be Retained for Three Years**

All data used to complete the e-NOI and all inspection records shall be maintained for a period of three years after project completion and made available upon request. [40 CFR 122.41]

**PART III  
SELF-INSPECTION, RECORDKEEPING AND REPORTING**

**SECTION C: REPORTING**

**1. Occurrences that Must be Reported**

Permittees shall report the following occurrences:

- Visible sediment deposition in a stream or wetland.

- Oil spills if:
  - They are 25 gallons or more,
  - They are less than 25 gallons but cannot be cleaned up within 24 hours,
  - They cause sheen on surface waters (regardless of volume), or
  - They are within 100 feet of surface waters (regardless of volume).

(c) Releases of hazardous substances in excess of reportable quantities under Section 311 of the Clean Water Act (Ref: 40 CFR 110.3 and 40 CFR 117.3) or Section 102 of CERCLA (Ref: 40 CFR 302.4) or G.S. 143-215.85.

(d) Anticipated bypasses and unanticipated bypasses.

(e) Noncompliance with the conditions of this permit that may endanger health or the environment.

**2. Reporting Timeframes and Other Requirements**

After a permittee becomes aware of an occurrence that must be reported, he shall contact the appropriate Division regional office within the timeframes and in accordance with the other requirements listed below. Occurrences outside normal business hours may also be reported to the Department's Environmental Emergency Center personnel at (800) 858-0368.

Occurrence	Reporting Timeframes (After Discovery) and Other Requirements
(a) Visible sediment deposition in a stream or wetland	<ul style="list-style-type: none"><li><b>Within 24 hours</b>, an oral or electronic notification.</li><li><b>Within 7 calendar days</b>, a report that contains a description of the sediment and actions taken to address the cause of the deposition. Division staff may waive the requirement for a written report on a case-by-case basis.</li><li>If the stream is named on the <b>NC 303(d) list</b> as impaired for sediment related causes, the permittee may be required to perform additional monitoring, inspections or apply more stringent practices if staff determine that additional requirements are needed to assure compliance with the federal or state impaired-waters conditions.</li></ul>
(b) Oil spills and release of hazardous substances per Item 3(b)-(c) above	<ul style="list-style-type: none"><li><b>Within 24 hours</b>, an oral or electronic notification. The notification shall include information about the date, time, nature, volume and location of the spill or release.</li></ul>
(c) Anticipated bypasses [40 CFR 122.41(m)(3)]	<ul style="list-style-type: none"><li><b>A report at least ten days before the date of the bypass, if possible.</b> The report shall include an evaluation of the anticipated quality and effect of the bypass.</li></ul>
(d) Unanticipated bypasses [40 CFR 122.41(m)(3)]	<ul style="list-style-type: none"><li><b>Within 24 hours</b>, an oral or electronic notification.</li><li><b>Within 7 calendar days</b>, a report that includes an evaluation of the quality and effect of the bypass.</li></ul>
(e) Noncompliance with the conditions of this permit that may endanger health or the environment [40 CFR 122.41(i)(7)]	<ul style="list-style-type: none"><li><b>Within 24 hours</b>, an oral or electronic notification.</li><li><b>Within 7 calendar days</b>, a report that contains a description of the noncompliance, and its causes, the period of noncompliance, including exact dates and times, and if the noncompliance has not been corrected, the anticipated time noncompliance is expected to continue; and steps taken or planned to reduce, eliminate, and prevent recurrence of the noncompliance. [40 CFR 122.41(i)(6).</li><li>Division staff may waive the requirement for a written report on a case-by-case basis.</li></ul>

**CITY OF RALEIGH PLANS AUTHORIZED FOR CONSTRUCTION**

Plans for the proposed use have been reviewed for general compliance with applicable codes, laws, and regulations, and authorized for construction under the conditions and limitations set forth herein. The permittee shall be responsible for obtaining all necessary permits and approvals from the appropriate regulatory agencies. The permittee shall be responsible for obtaining all necessary permits and approvals from the appropriate regulatory agencies. The permittee shall be responsible for obtaining all necessary permits and approvals from the appropriate regulatory agencies.

City of Raleigh  
Development Approval

SHEET NO.  
EC-2B

EVERLEE SUBDIVISION  
ROADWAY IMPROVEMENTS  
RALEIGH, NORTH CAROLINA  
EROSION CONTROL PLANS

REVISIONS


SCALES  
H-SCALE = NA  
V-SCALE = NA  
DATE: 11/08/2022  
DESIGNED BY: SAS  
CHECKED BY: MDB

Infrastructure Consulting Services, Inc.

**RAKEY**  
RAKEY KEMP ASSOCIATES

1000 Independence Place  
Raleigh, North Carolina 27605  
(919) 876-1100  
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www.rakeykemp.com

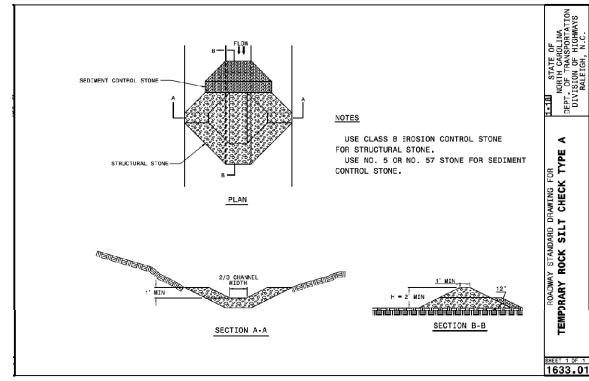
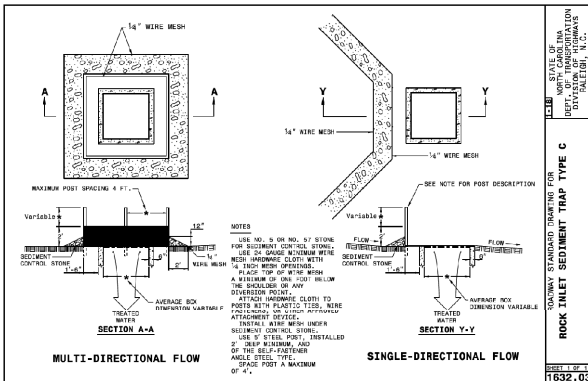
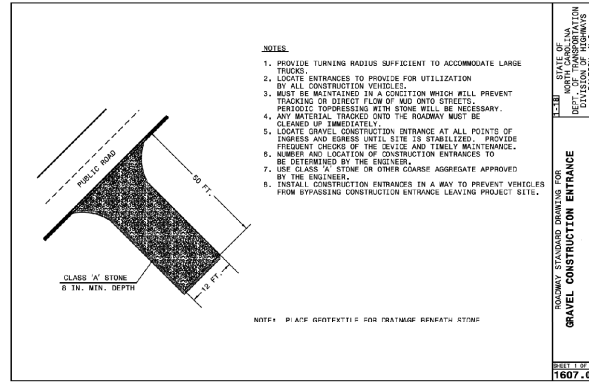
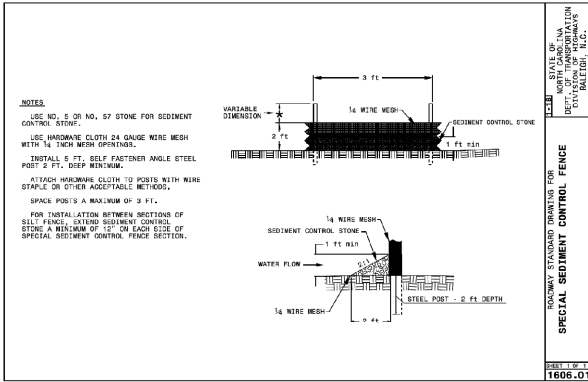
DOCUMENT NOT CONSIDERED FINAL UNLESS ALL  
SIGNATURES COMPLETED







11/9/2022  
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28566-EC-38289



## MAINTENANCE NOTES

### SPECIAL SEDIMENT CONTROL FENCE

INSPECT THE DEVICE PERIODICALLY AND AFTER EACH SIGNIFICANT RAINFALL EVENT FOR DAMAGE AND SEDIMENT ACCUMULATION TO CONFIRM THE DEVICE IS FUNCTIONING PROPERLY. AT A MINIMUM, REMOVE SEDIMENT FROM THE DEVICE WHEN ACCUMULATIONS REACH ONE-HALF THE HEIGHT OF THE SEDIMENT CONTROL STONE. REPLACE OR CLEAN THE SEDIMENT CONTROL STONE AS NEEDED TO ALLOW WATER TO DRAIN THROUGH THE DEVICE BETWEEN RAINFALL EVENTS. REBUILD AND/OR REPAIR THE DEVICE WHEN IT IS DAMAGED, REPAIR AREAS WHERE SSCP BECOMES UNDERMINED DUE TO CONCENTRATED FLOWS.

### CONSTRUCTION ENTRANCE

THE GRAVEL CONSTRUCTION ENTRANCE MUST BE MAINTAINED IN A CONDITION TO PREVENT TRACKING OR DIRECT FLOW OF MUD ONTO ADJACENT ROADWAYS. REPLACEMENT OF STONE MAY BE NECESSARY TO ENSURE THE GRAVEL ENTRANCE FUNCTIONS PROPERLY. REPLENISHMENT OF STONE MAY BE NECESSARY. FREQUENT CHECKS OF THE DEVICE AND TIMELY MAINTENANCE SHOULD BE COMPLETED. ANY MATERIAL TRACKED ONTO THE ROADWAY SHALL BE CLEANED UP IMMEDIATELY.

### ROCK INLET SEDIMENT TRAP TYPE C

INSPECT THE DEVICE AFTER EACH SIGNIFICANT RAINFALL EVENT FOR DAMAGE, SEDIMENT ACCUMULATION AND PROPER FUNCTION. REMOVE SEDIMENT FROM THE DEVICE WHEN ACCUMULATIONS REACH ONE-HALF THE HEIGHT OF THE SEDIMENT CONTROL STONE. REPLACE OR CLEAN THE SEDIMENT CONTROL STONE AS NEEDED TO ALLOW WATER TO DRAIN THROUGH THE DEVICE BETWEEN RAINFALL EVENTS. REBUILD AND/OR REPAIR THE DEVICE WHEN IT IS DAMAGED. IF THE DEVICE IS TO REMAIN AFTER PROJECT COMPLETION, IT SHOULD BE CLEAN AND IN PROPER SHAPE AT THE TIME OF FINAL INSPECTION. IF IT IS REMOVED, ALL ACCUMULATED SILT SHOULD BE REMOVED TO KEEP IT FROM ENTERING THE DRAINAGE SYSTEM.

### TEMPORARY ROCK SILT CHECK TYPE A

INSPECT ROCK CHECK AFTER EACH SIGNIFICANT RAINFALL. REMOVE SILT FROM DEVICE WHEN IT ACCUMULATES. REBUILD AND RESHAPE DEVICE AND WEIR WHEN DAMAGED OR AS NECESSARY. CLEANOUT WHEN CLOGGED BY STRAW, LIMBS OR OTHER DEBRIS.

MICHAEL D. BYWALETZ, P.E.  
LEVEL III NAME

3876  
LEVEL III CERTIFICATION

SHEET NO.  
EC-3B

EVERLEE SUBDIVISION  
ROADWAY IMPROVEMENTS  
RALEIGH, NORTH CAROLINA  
EROSION CONTROL PLANS

DOCUMENT NOT CONSIDERED FINAL UNLESS ALL  
SIGNATURES COMPLETED

REVISIONS

SCALES  
H-SCALE = NA  
V-SCALE = NA  
DATE: 11/08/2022  
DESIGNED BY: SAS  
CHECKED BY: MDB

Infrastructure Consulting Services, Inc.

**RKA**  
RAMEY KEMP ASSOCIATES

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Raleigh, North Carolina 27605  
Phone 919.941.2115  
Fax 919.941.2116  
www.rameykemp.com

**CITY OF RALEIGH PLANS AUTHORIZED FOR CONSTRUCTION**

Plans for the proposed use have been reviewed for general compliance with applicable codes, standards, and regulations for construction and are not to be construed as a guarantee of the accuracy or completeness of the information provided. The City of Raleigh is not responsible for the design, construction, or maintenance of the project. The City of Raleigh is not responsible for the design, construction, or maintenance of the project. The City of Raleigh is not responsible for the design, construction, or maintenance of the project.

City of Raleigh  
Development Approval





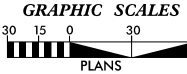


# CLEARING AND GRUBBING PHASE

- NOTES:
1. CONTRACTOR TO INSTALL EROSION CONTROL MEASURES BEFORE CONSTRUCTION BEGINS AND MAINTAIN THROUGHOUT CONSTRUCTION.
  2. CONTRACTOR IS TO KEEP ALL DEBRIS WITHIN THE WORK AREA AND OUTSIDE OF THE THROUGH LANES.
  3. CONTRACTOR TO COORDINATE WITH ENGINEER IF FIELD CONDITIONS VARY FROM PLANS OR CONFLICTING EROSION CONTROL MEASURES ARE INSTALLED WITH THE ADJACENT SITE CONSTRUCTION.

MICHAEL D. BYWALET  
LEVEL III NAME


3876  
LEVEL III CERTIFICATION NO.



SHEET NO.  
EC-4

EVERLEE SUBDIVISION  
ROADWAY IMPROVEMENTS  
RALEIGH, NORTH CAROLINA  
PLAN SHEET

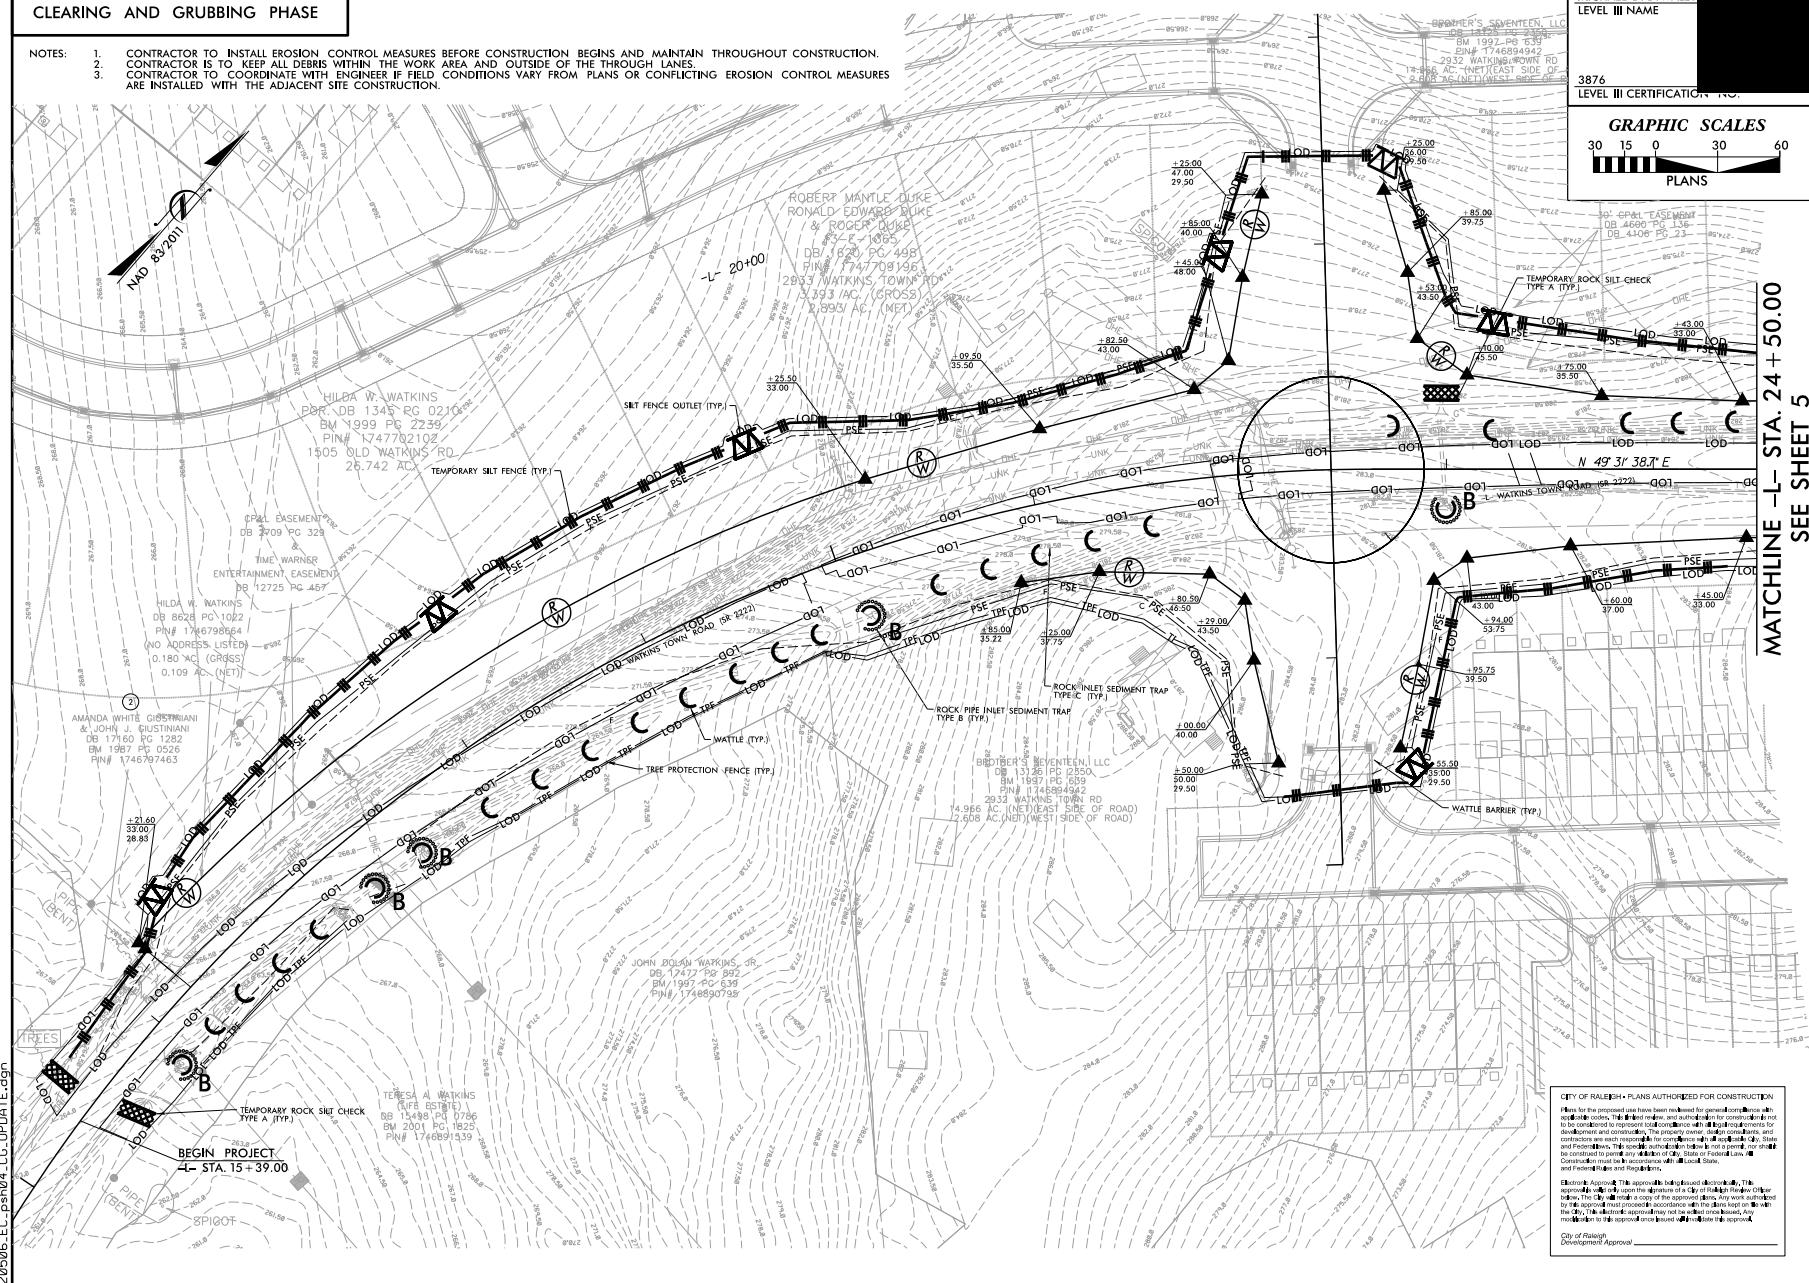MATCHLINE -L- STA. 24 + 50.00  
SEE SHEET 5



REVISIONS	DATE	BY	CHKD

REVISIONS	DATE	BY	CHKD

Infrastructure Consulting Services, Inc.  
**RKA**  
RAYEY KEMP ASSOCIATES  
2008 Independence Place  
Raleigh, North Carolina 27605  
Phone 919/791-1115  
NC License No. P-1489  
www.rayekemp.com




# CLEARING AND GRUBBING PHASE
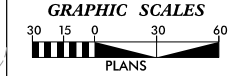
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MICHAEL D. BYWALETZ, P.E.  
LEVEL III NAME


3876  
LEVEL III CERTIFICATION



SHEET NO.  
EC-5

EVERLEE SUBDIVISION  
ROADWAY IMPROVEMENTS  
RALEIGH, NORTH CAROLINA  
EROSION CONTROL PLANS

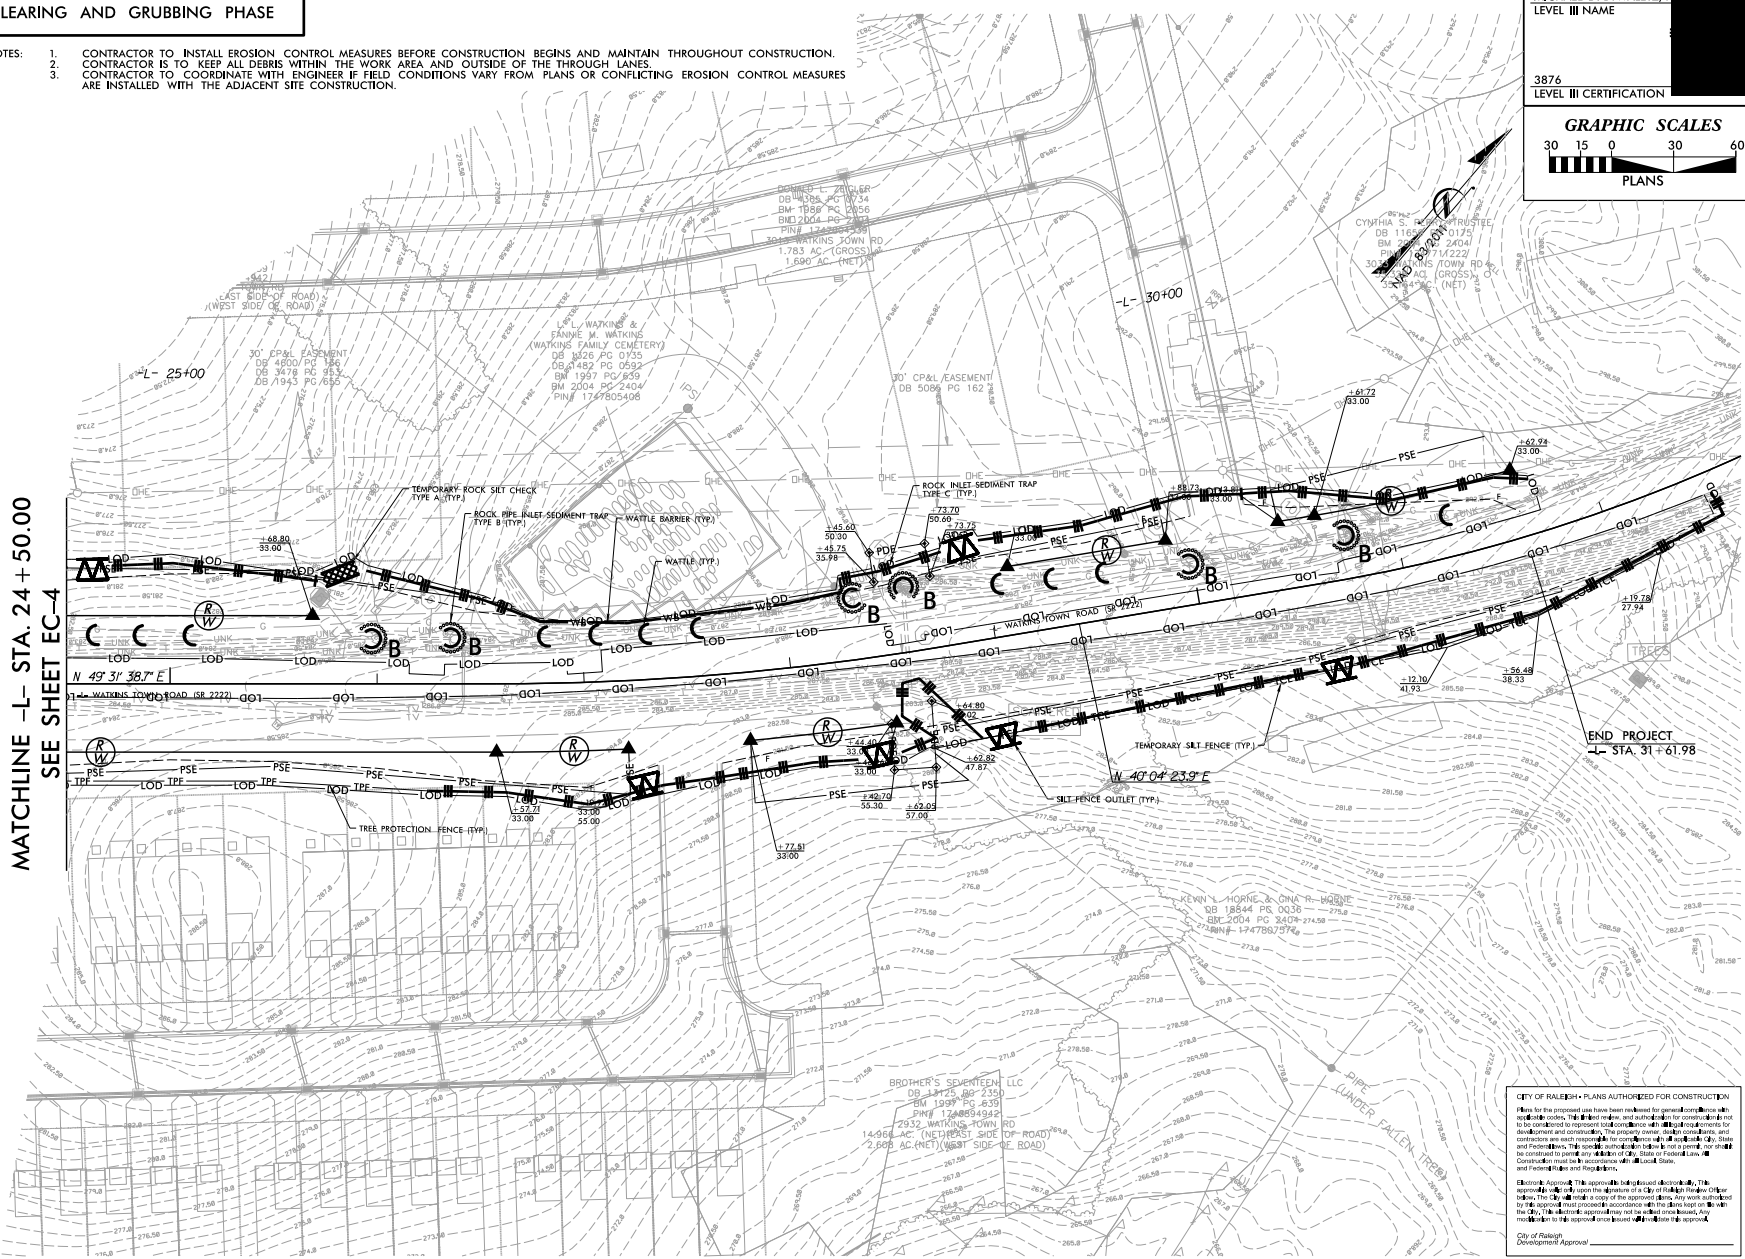MATCHLINE -L- STA. 24 + 50.00  
SEE SHEET EC-4



**CITY OF RALEIGH - PLANS AUTHORIZED FOR CONSTRUCTION**

Plans for the proposed use have been reviewed for general compliance with the City of Raleigh's Comprehensive Zoning Ordinance and the City of Raleigh's Comprehensive Land Use Ordinance. The City of Raleigh does not warrant the accuracy or completeness of the information provided herein. The City of Raleigh is not responsible for the accuracy or completeness of the information provided herein. The City of Raleigh is not responsible for the accuracy or completeness of the information provided herein. The City of Raleigh is not responsible for the accuracy or completeness of the information provided herein.

City of Raleigh  
Development Approval

REVISIONS

NO.	DESCRIPTION	DATE

SCALES

H-SCALE = 1" = 30'
V-SCALE = 1" = 10'
DATE: 11/08/2022
DESIGNED BY: SAS
CHECKED BY: MDB

Infrastructure Consulting Services, Inc.  
**RKA**  
RAYEY KEMP ASSOCIATES  
2025 Independence Place  
Raleigh, North Carolina 27605  
Phone 919-790-1118  
NC License No. 74149  
www.rkainc.com



## FINAL PHASE

NOTES: 1. CONTRACTOR TO SHERO EROSION CONTROL MEASURES DURING CONSTRUCTION TO MAINTAIN INLET PROTECTION AROUND THE EXISTING AND PROPOSED INLETS. WAFTES SHALL BE SHIFTED TO THE NEW DITCHLINE UNTIL EARTH IS STABILIZED.

2. CONTRACTOR IS TO KEEP ALL DEBRIS WITHIN THE WORK AREA AND OUTSIDE OF THE THROUGH LANES.

3. CONTRACTOR TO COORDINATE WITH ENGINEER IF FIELD CONDITIONS VARY FROM PLANS OR CONFLICTING EROSION CONTROL MEASURES ARE INSTALLED WITH THE ADJACENT SITE CONSTRUCTION.

MICHAEL D. BYWALETZ,  
LEVEL III NAME

3876  
LEVEL III CERTIFICATION NO.

## GRAPHIC SCALES



30' GP&L EASEMENT  
DB 4600 PG 136  
DB 4106 PG 23

SHEET NO.  
EC-6

EVERLEE SUBDIVISION  
ROADWAY IMPROVEMENTS

RALEIGH, NORTH CAROLINA

PLAN SHEET I

**MATCHLINE -L- STA. 24 + 50.00  
SEE SHEET 5**

REVISIONS

## SCALES

H-SCALE - 1" = 30'

DATE: 11/08/2022

DESIGNED BY: SLO

DESIGNED BY: SAS

Infrastructure Consulting Services, Inc.

**RKA**

**RAMEY KEMP ASSOCIATES**

5101 Faringdon Place  
Raleigh, North Carolina 27609  
Phone: 919-273-5115

NC License No. F-1489

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[www.rameykemp.com](http://www.rameykemp.com)

**CITY OF RALEIGH - PLANS AUTHORIZED FOR CONSTRUCTION**

Plans for the proposed use have been reviewed for general compliance with applicable codes, standards, and ordinances, and authorization for construction is not to be construed to represent total compliance with all regulatory requirements for the proposed use. The City of Raleigh does not warrant that all applicable codes, standards, ordinances, and regulations are listed, and the City of Raleigh does not warrant that the construction is in accordance with all applicable City, State and Federal laws. This specific authorization does not constitute a permit, nor should it be construed to permit any violation of City, State or Federal Laws. The City of Raleigh Construction must be in accordance with all Local, State and Federal Rules and Regulations.

**Electronic Approval:** This approval is being issued electronically. This approval is valid only upon the signature of a City of Raleigh Raleigh Official. The City of Raleigh Official's signature is required for the City of Raleigh to authorize by this approval must proceed in accordance with the plans that go on with the City. This electronic approval may not be relied upon in court. Any modification to this approval once issued will constitute this approval.

City of Raleigh  
Development Approval

10

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11/9/2022  
User: mbindsey  
20506-EC-psh04\_FINAL-UPDATE.dgn



## FINAL PHASE

NOTES: 1. CONTRACTOR TO SHIFT EROSION CONTROL MEASURES DURING CONSTRUCTION TO MAINTAIN INLET PROTECTION AROUND THE EXISTING AND PROPOSED INLETS. WATTLERS SHALL BE SHIFTED TO THE NEW DITCHLINE UNTIL EARTH IS STABILIZED.

2. CONTRACTOR IS TO KEEP ALL DEBRIS WITHIN THE WORK AREA AND OUTSIDE OF THE THROUGH LANES.

3. CONTRACTOR TO COORDINATE WITH ENGINEER IF FIELD CONDITIONS VARY FROM PLANS OR CONFLICTING EROSION CONTROL MEASURES ARE INSTALLED WITH THE ADJACENT SITE CONSTRUCTION.

MICHAEL D. BYWALE  
LEVEL III NAME

3876  
LEVEL III CERTIFICAT

**GRAPHIC SCALES**

The graphic scales are located at the bottom of the page. The 'PLANS' scale is a horizontal line with vertical tick marks at 30, 15, 0, 30, and 60. The 'SECTION' scale is a horizontal line with vertical tick marks at 0, 15, 30, 45, and 60. The 'PLANS' scale has a shaded area between 0 and 30, and the 'SECTION' scale has a shaded area between 0 and 15.

SHEET NO.  
EC-7

EVERLEE SUBDIVISION  
ROADWAY IMPROVEMENTS

RALEIGH, NORTH CAROLINA

## EROSION CONTROL PLANS

REVISIONS

## SCALES

H-SCALE: 1° ■ 30°

1/00ALE NA

V-SCALE - NA

DATE: 11/08/2022

DESIGNED BY: SAS

CHECKED BY: MDB

Infrastructure Consulting Services, Inc.

**RKA**

**RAMEY KEMP ASSOCIATES**

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MATCHLINE -L- STA. 24+50.00  
SEE SHEET EC-6

11/9/2022  
User:mlundsey  
20506-EC\_psh05\_final.dgn

**CITY OF RALEIGH • PLANS AUTHORIZED FOR CONSTRUCTION**

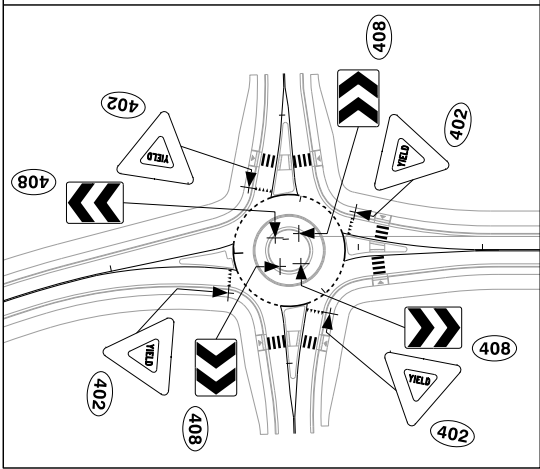
Plans for the proposed work have been reviewed for general compliance with applicable codes, the City of Raleigh regulations, and authorized for construction, provided that the contractor is required to represent and warrant compliance with all requirements for development and construction. The property owner, design consultants, and contractors each represent and warrant that the proposed work complies with City, State and Federal laws and regulations. The City of Raleigh is not a party to this agreement and shall not be held responsible for any violations of City, State or Federal Laws. Construction must be in accordance with all Local, State, and Federal Laws.

**Electronic Approval:** The approved digitalized electronic document, this agreement, shall be the property of the City of Raleigh and may be shared with other City employees. The City will retain a copy of the approved plans. Any work authorized by this approval must proceed in accordance with the plans kept on file with the City. The City and the approved agency may not be held liable on basis of, any modification to this approval once issued without written approval.

*City of Raleigh  
Development Approval*



# EXHIBIT A: ROUNDABOUT PROPOSED SIGNS




## ROADWAY STANDARD DRAWING

THE FOLLOWING ROADWAY STANDARDS AS APPEAR IN "ROADWAY STANDARD DRAWINGS" - PROJECT SERVICES UNIT - N.C. DEPARTMENT OF TRANSPORTATION - RALEIGH, N.C., DATED JANUARY 2018 ARE APPLICABLE TO THIS PROJECT AND BY REFERENCE HEREBY ARE CONSIDERED A PART OF THESE PLANS:

STD. NO.	TITLE
904.10	ORIENTATION OF GROUND MOUNTED SIGNS
904.50	MOUNTING OF TYPE 'D', 'E' AND 'F' SIGNS ON 'U' CHANNEL POSTS
910.40	SINGLE LANE ROUNDABOUT SIGNING, WITH PEDESTRIANS

## PROJECT NOTE

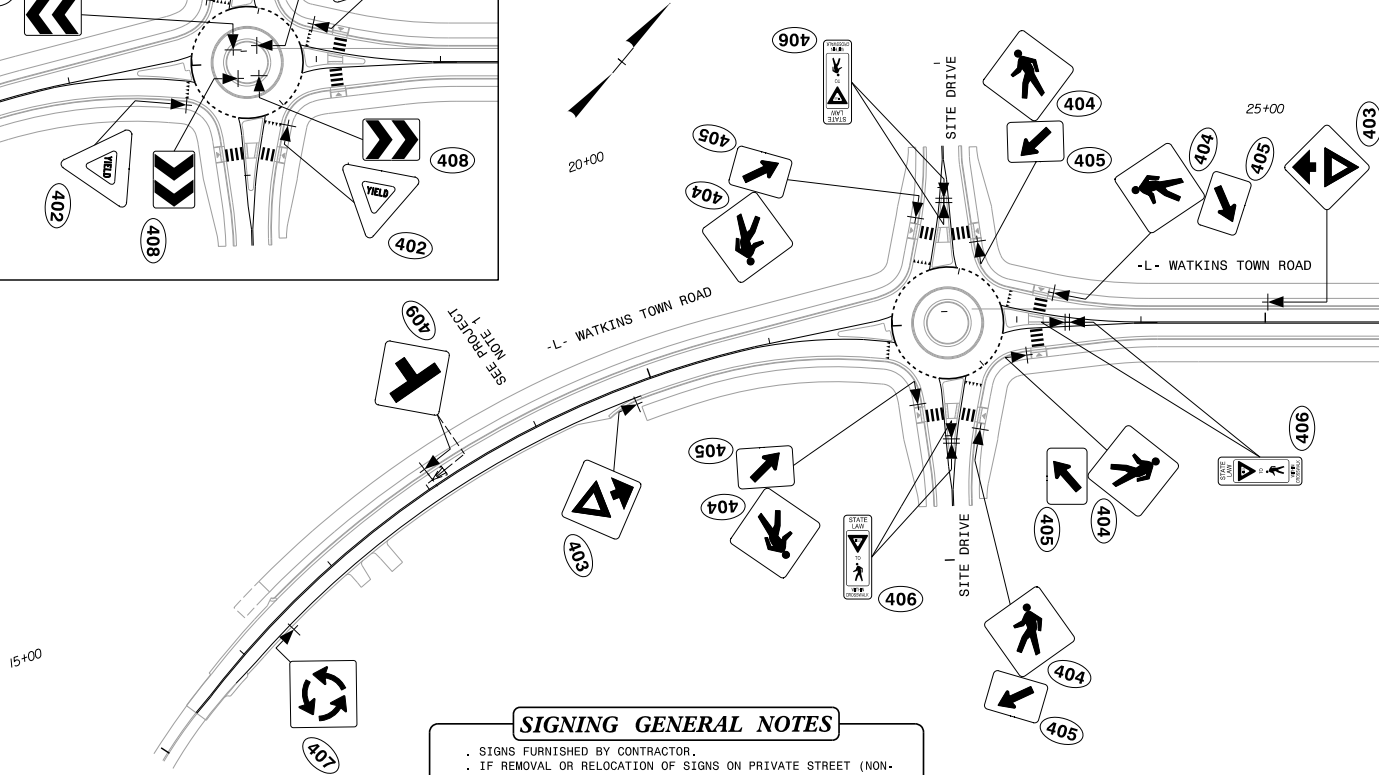1 RELOCATE EXISTING SIGN ASSEMBLY



## SIGNING GENERAL NOTES

- SIGNS FURNISHED BY CONTRACTOR.
- IF REMOVAL OR RELOCATION OF SIGNS ON PRIVATE STREET (NON-STATE MAINTAINED) IS REQUIRED DUE TO CONSTRUCTION, THE CONTRACTOR SHALL INFORM THE ENGINEER. THE WORK WILL BE COMPLETED BY OTHERS.
- WHEN NOT STATIONED OR DIMENSIONED ON PLANS, ALL 'E' AND 'F' SIGNS SHALL BE FIELD LOCATED BY THE ENGINEER.
- ALL EXISTING SIGNS ON "U" CHANNEL POST WITHIN THE PROJECT LIMITS SHALL BE REMOVED AND DISPOSED OF UNLESS OTHERWISE NOTED ON PLANS.
- WHEN EXISTING SIGNS ARE REMOVED AND INSTALLED ON NEW SUPPORTS, THE RE-ERECTION SHALL IMMEDIATELY FOLLOW THE REMOVAL.
- THE BACKGROUND FOR TYPE E & F SIGNS SHALL BE TYPE C REFLECTIVE SHEETING.
- ALL SIGNS WITHIN THE CLEAR ZONE SHALL BE ON BREAKAWAY SUPPORTS THAT COMPLY WITH THE LATEST EDITION OF AASHTO MANUAL FOR ASSESSING SAFETY HARDWARE (MASH) AND NCHRP REPORT 350.

MATCHLINE -L- STA. 26 + 00  
SEE SHEET SIGN-4

CITY OF RALEIGH - PLANS AUTHORIZED FOR CONSTRUCTION

Plans for the proposed use have been reviewed for general compliance with applicable codes, standards, and regulations. The City of Raleigh is not responsible for the accuracy or completeness of the information provided by the applicant. The applicant is responsible for the accuracy and completeness of the information provided. The City of Raleigh is not responsible for the accuracy or completeness of the information provided by the applicant. The applicant is responsible for the accuracy and completeness of the information provided.

City of Raleigh  
Development Approval

SHEET NO.  
SIGN-1

EVERLEE SUBDIVISION  
ROADWAY IMPROVEMENTS  
RALEIGH, NORTH CAROLINA  
PROPOSED SIGNING DETAILS



REVISIONS	DATE	BY	DESCRIPTION

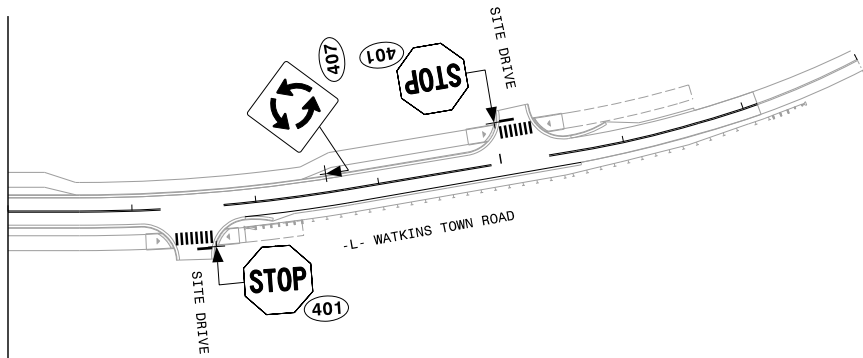
SCALES  
H-SCALE = 1"=50'  
V-SCALE = 1"=10'

DATE: 11/09/2022  
DESIGNED BY: MRS  
CHECKED BY: WJH

Infrastructure Consulting Services, Inc.  
**RKA**  
RAMEY KEMP ASSOCIATES  
2000 Independence Place  
Raleigh, North Carolina 27605  
Phone 919-790-1918  
NC License No. 54489  
www.rameykemp.com



**MATCHLINE -L- STA. 26+00  
SEE SHEET SIGN-3**



**CITY OF RALEIGH - PLANS AUTHORIZED FOR CONSTRUCTION**

None of the proposed laws have been released for general construction with applicable codes, technical review, and authorization for construction. It is not to be construed to represent total compliance with all legal requirements for construction. The City of Raleigh does not warrant that the proposed laws and contracts are each responsive for compliance with applicable codes. City or State contracts may be subject to review by the City or State and may not be permitted to be construed for any violation of City, State or Federal Laws. Construction must be in accordance with all Local, State, and Federal Laws.

**Electronic Approval:** This approval is based on electronic data. This approval only may only use the signature of a City of Raleigh official authorized to sign. The City will retain a copy of the approved plans. Any work authorized by this approval is not to be construed as a representation of the City or State. This electronic approval may not be used on a basis, any modification to this approval cannot exceed the scope of the approval.

*City of Raleigh  
Development Approval*

SHEET NO.  
SIGN-2

EVERLEE SUBDIVISION  
ROADWAY IMPROVEMENTS

RALEIGH, NORTH CAROLINA

## PROPOSED SIGNING DETAILS

REVISIONS

## SCALES

H. SCALE - 1"=50'

DATE: 11/08/2022

DESIGNED BY: MRS



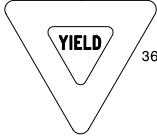

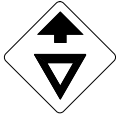




CHECKED BY: WJH

Infrastructure Consulting Services, Inc.

**RKA**

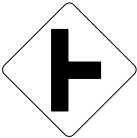**RAMEY KEMP ASSOCIATES**  
5306 Farningdon Place  
Raleigh, North Carolina 27609  
Phone: 919-872-6115  
NC License No. F-1489  
[www.rameykemp.com](http://www.rameykemp.com)



SHEET NO.									
SIGN-3									
EVERLEE SUBDIVISION ROADWAY IMPROVEMENTS RALEIGH, NORTH CAROLINA TYPE 'E' SIGNS									
<p>401 QUANTITY REQ'D <u>2</u></p>  <p>36" X 36" R1-1</p> <p>ONE "U" POST PER SIGN</p>	<p>406 QUANTITY REQ'D <u>6</u></p>  <p>12" X 36" R1-6</p> <p>ONE "U" POST PER SIGN</p>								
<p>402 QUANTITY REQ'D <u>8</u></p>  <p>36" X 36" X 36" R1-2</p> <p>ONE "U" POST PER SIGN</p>	<p>407 QUANTITY REQ'D <u>2</u></p>  <p>30" X 30" W2-6</p> <p>ONE "U" POST PER SIGN</p>								
<p>403 QUANTITY REQ'D <u>2</u></p>  <p>30" X 30" W3-2</p> <p>ONE "U" POST PER SIGN</p>	<p>408 QUANTITY REQ'D <u>4</u></p>  <p>30" X 24" R6-4</p> <p>ONE "U" POST PER SIGN</p>								
<p>404 QUANTITY REQ'D <u>6</u></p>  <p>36" X 36" W11-2</p> <p>ONE "U" POST PER SIGN</p>	<p>409 QUANTITY REQ'D <u>1</u></p>  <p>36" X 36" W2-2R</p> <p>ONE "U" POST PER SIGN</p>								
<p>405 QUANTITY REQ'D <u>6</u></p>  <p>24" X 12" W16-7PL</p> <p>ONE "U" POST PER SIGN</p>									<p>405 QUANTITY REQ'D <u>6</u></p> <p>ONE "U" POST PER SIGN</p>

REVISIONS

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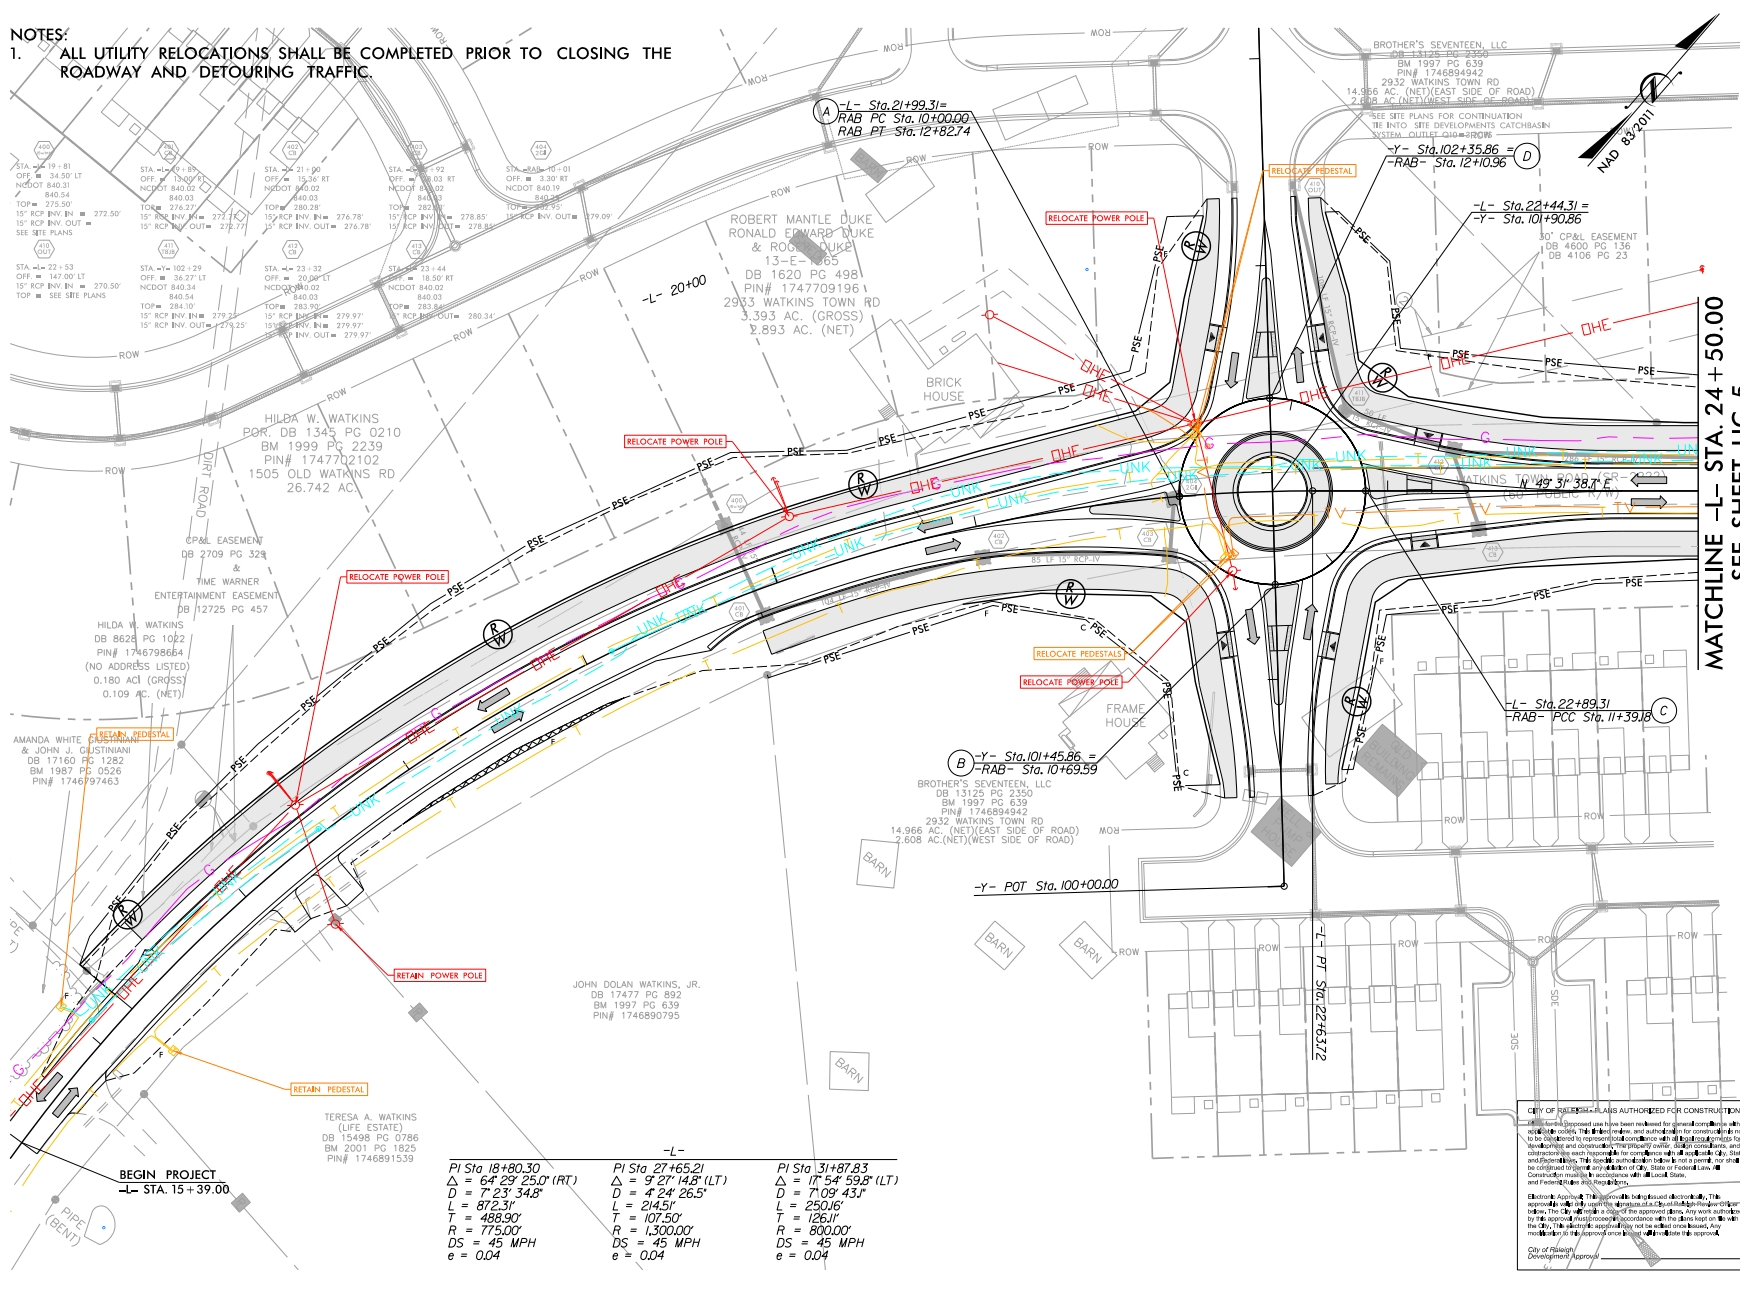
SCALES  
H=SCALE • NA  
V=SCALE • NA  
DATE: 11/08/2022  
DESIGNED BY: MRS  
CHECKED BY: WJH

Infrastructure Consulting Services, Inc.  
**RKA**  
RAYEY KEMP ASSOCIATES  
2025 Federation Place  
Raleigh, North Carolina 27605  
Phone: 919.451.5115  
NC License No. F41488  
www.rkainc.com

1/9/2022  
User: mlyndsey  
20506\_SIGN\_02.dgn



1. ALL UTILITY RELOCATIONS SHALL BE COMPLETED PRIOR TO CLOSING THE ROADWAY AND DETOURING TRAFFIC.



EVERLEE SUBDIVISION  
ROADWAY IMPROVEMENTS

RALEIGH, NORTH CAROLINA

UTILITY COORDINATION PLANS

DOCUMENT NOT CONSIDERED FINAL UNLESS ALL

## REVISIONS

SCALES

H. SCALE: 1"=3'

V-SCALE - NA

DATE: 11/08/2002

DESIGNED BY: M.

QUESTIONS 13-18

CHECKED BY: RW

Infrastructure Consulting Services, Inc.

**514**

# SKA



**RAMEY KEMP ASSOCIATES**

5805 Farlington Place  
Raleigh, North Carolina 27609

Phone: 919-872-5115

NC License No. F-1489  
www.rameykemp.com

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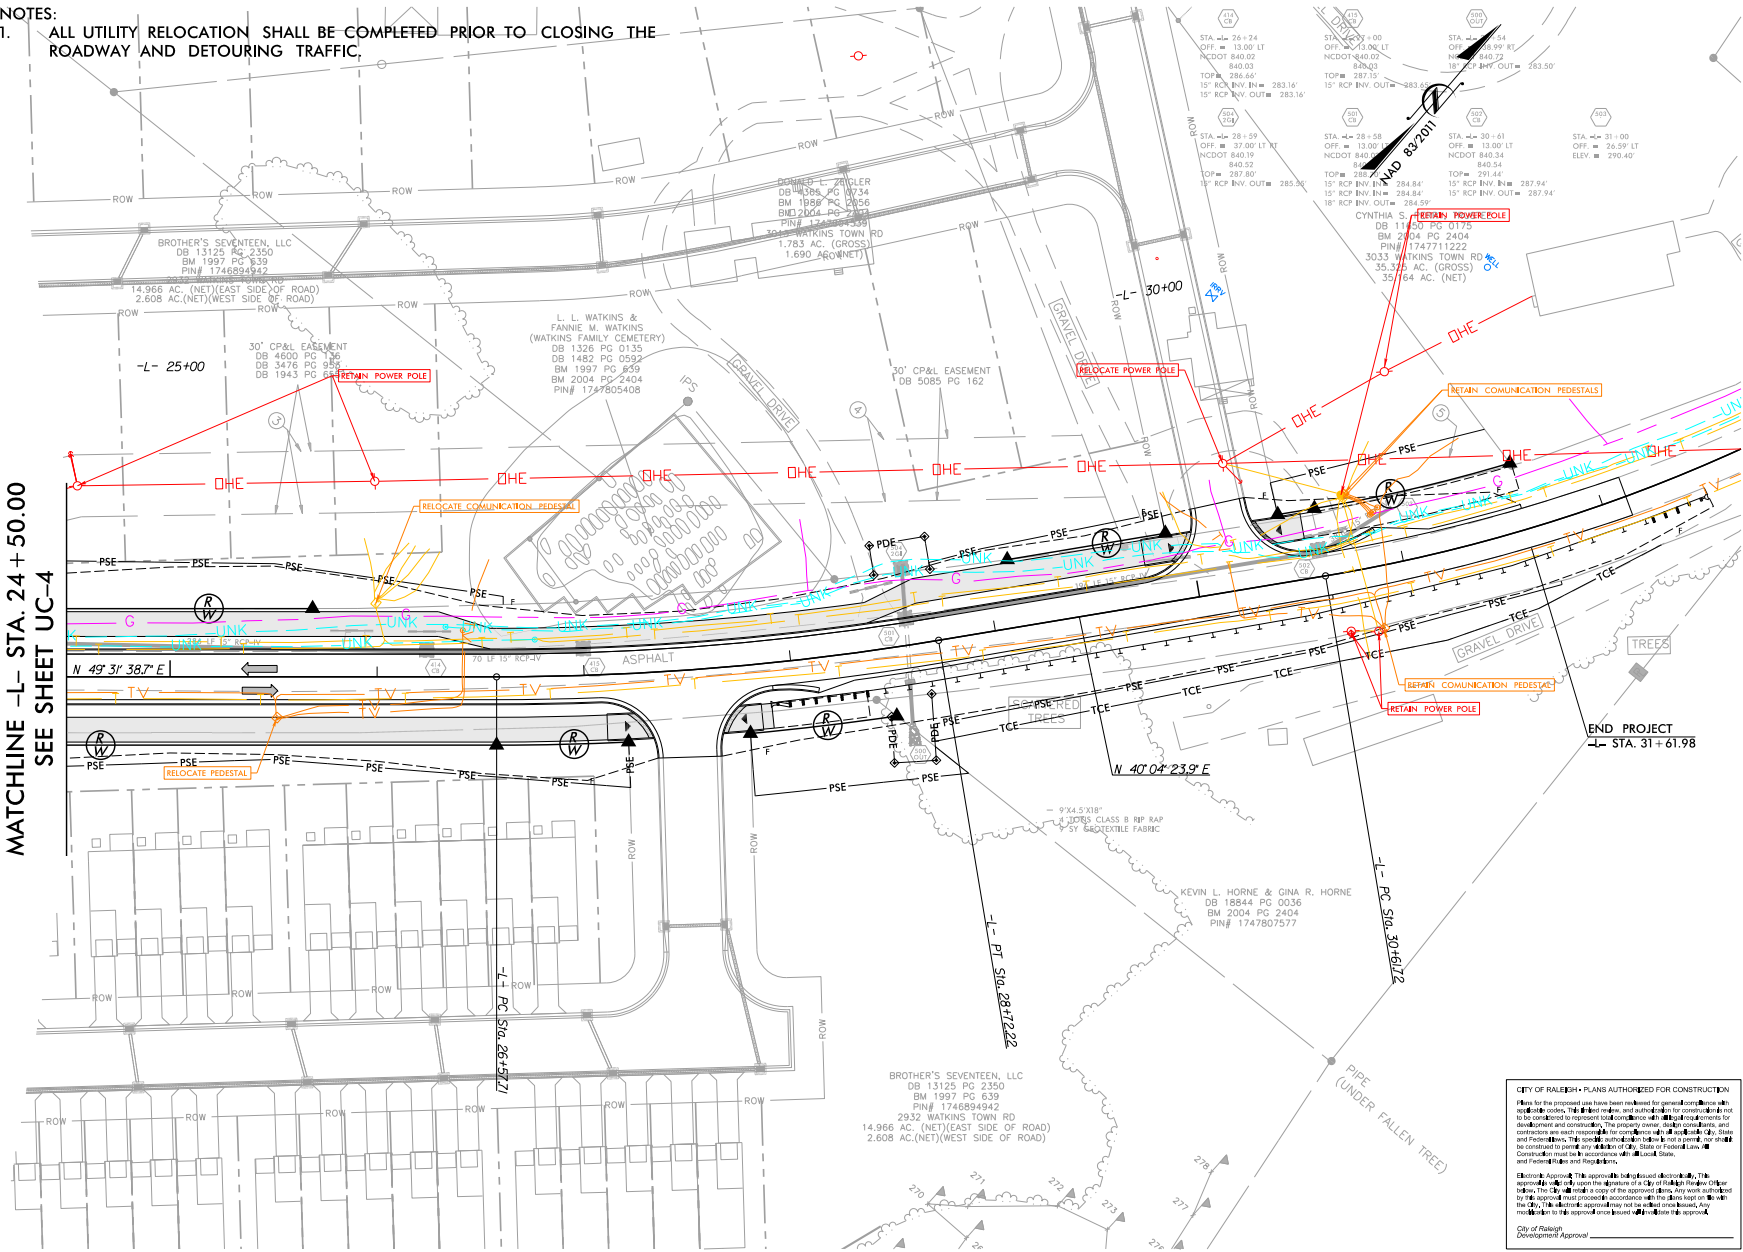


11/9/2022  
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28863-ut-ps05.dgn

# NOTES:

1. ALL UTILITY RELOCATION SHALL BE COMPLETED PRIOR TO CLOSING THE ROADWAY AND DETOURING TRAFFIC.

MATCHLINE -L- STA. 24 + 50.00  
SEE SHEET UC-4



SHEET NO.  
UC-5

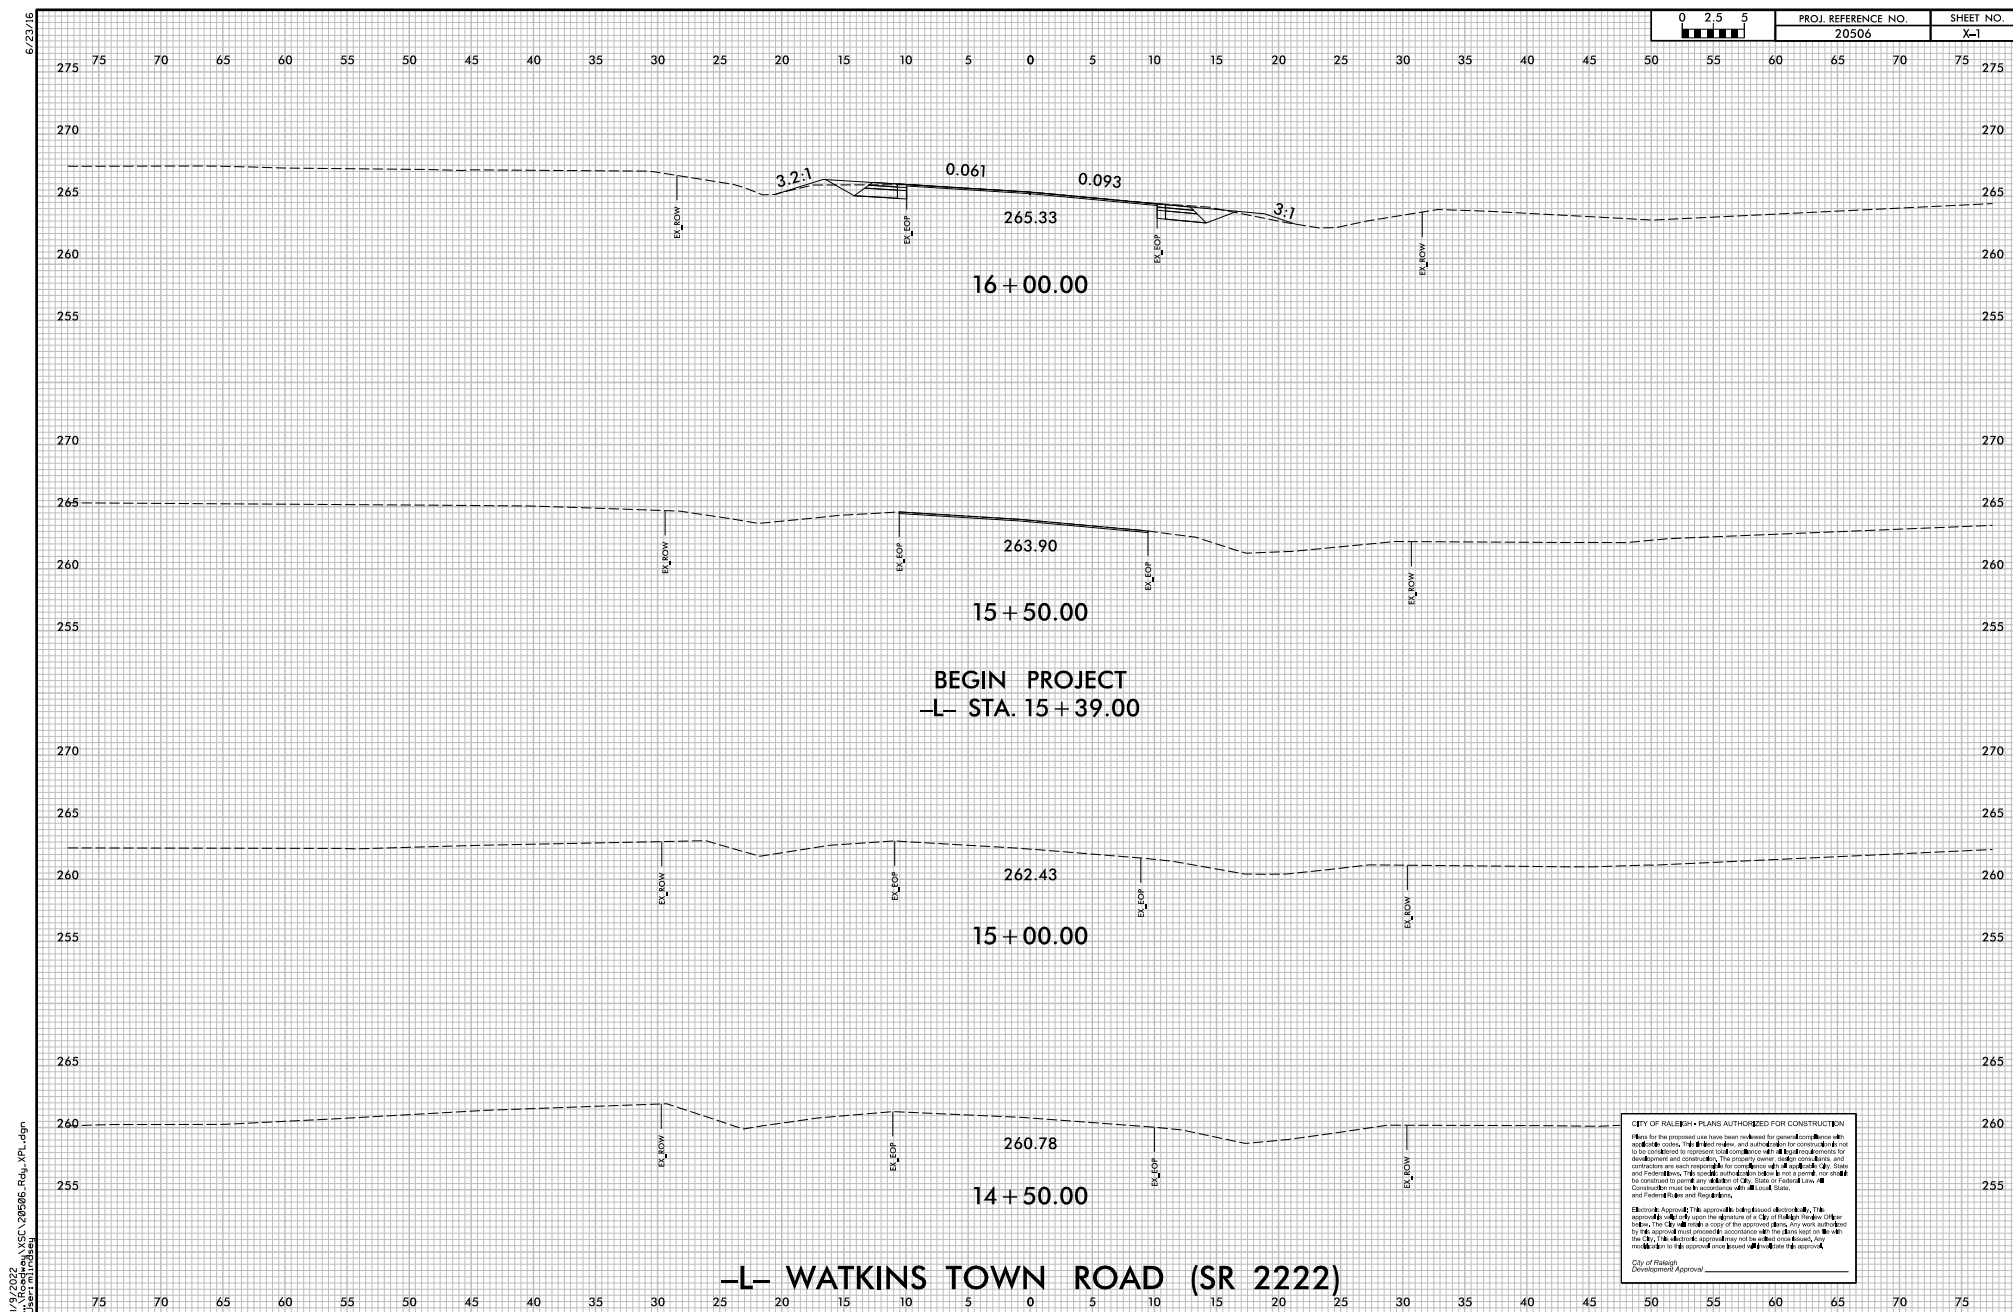
EVERLEE SUBDIVISION  
ROADWAY IMPROVEMENTS  
RALEIGH, NORTH CAROLINA  
UTILITY COORDINATION PLANS

REVISIONS

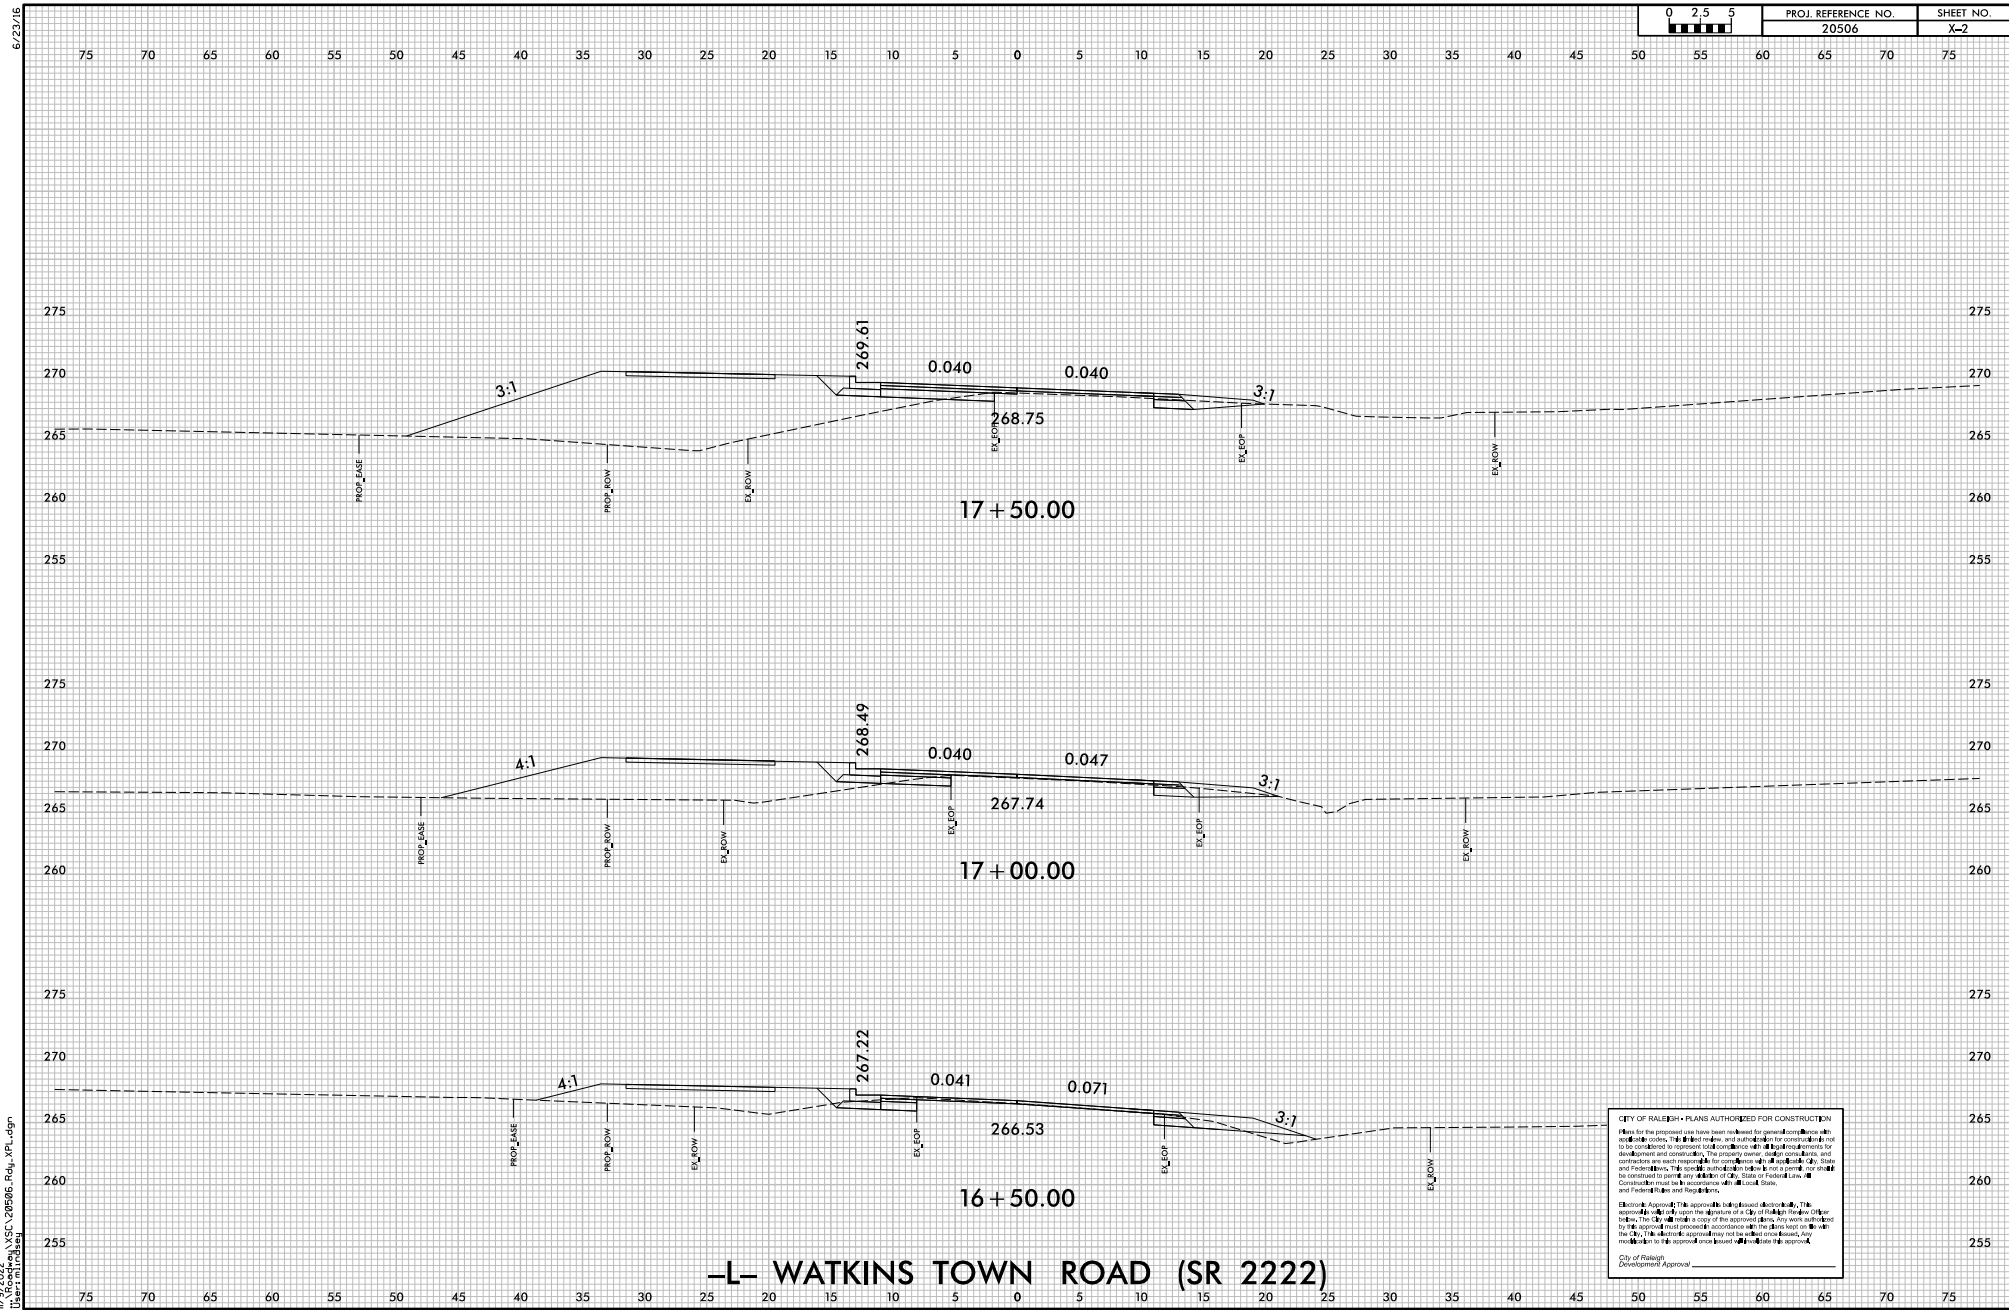
NO.	DESCRIPTION	DATE

SCALES  
H-SCALE = 1"=30'  
V-SCALE = 1"=10'  
DATE: 11/08/2022  
DESIGNED BY: MML  
CHECKED BY: KMP  
Infrastructure Consulting Services, Inc.  
**RKA**  
RAMEY KEMP ASSOCIATES  
2020 Independence Place  
Raleigh, North Carolina 27605  
Phone 919.961.7400  
NC License No. P-1489  
www.rameykemp.com












6/23/16

11/9/2022  
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User: m1000am

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PROJ. REFERENCE NO.		SHEET NO.
20506		X-3

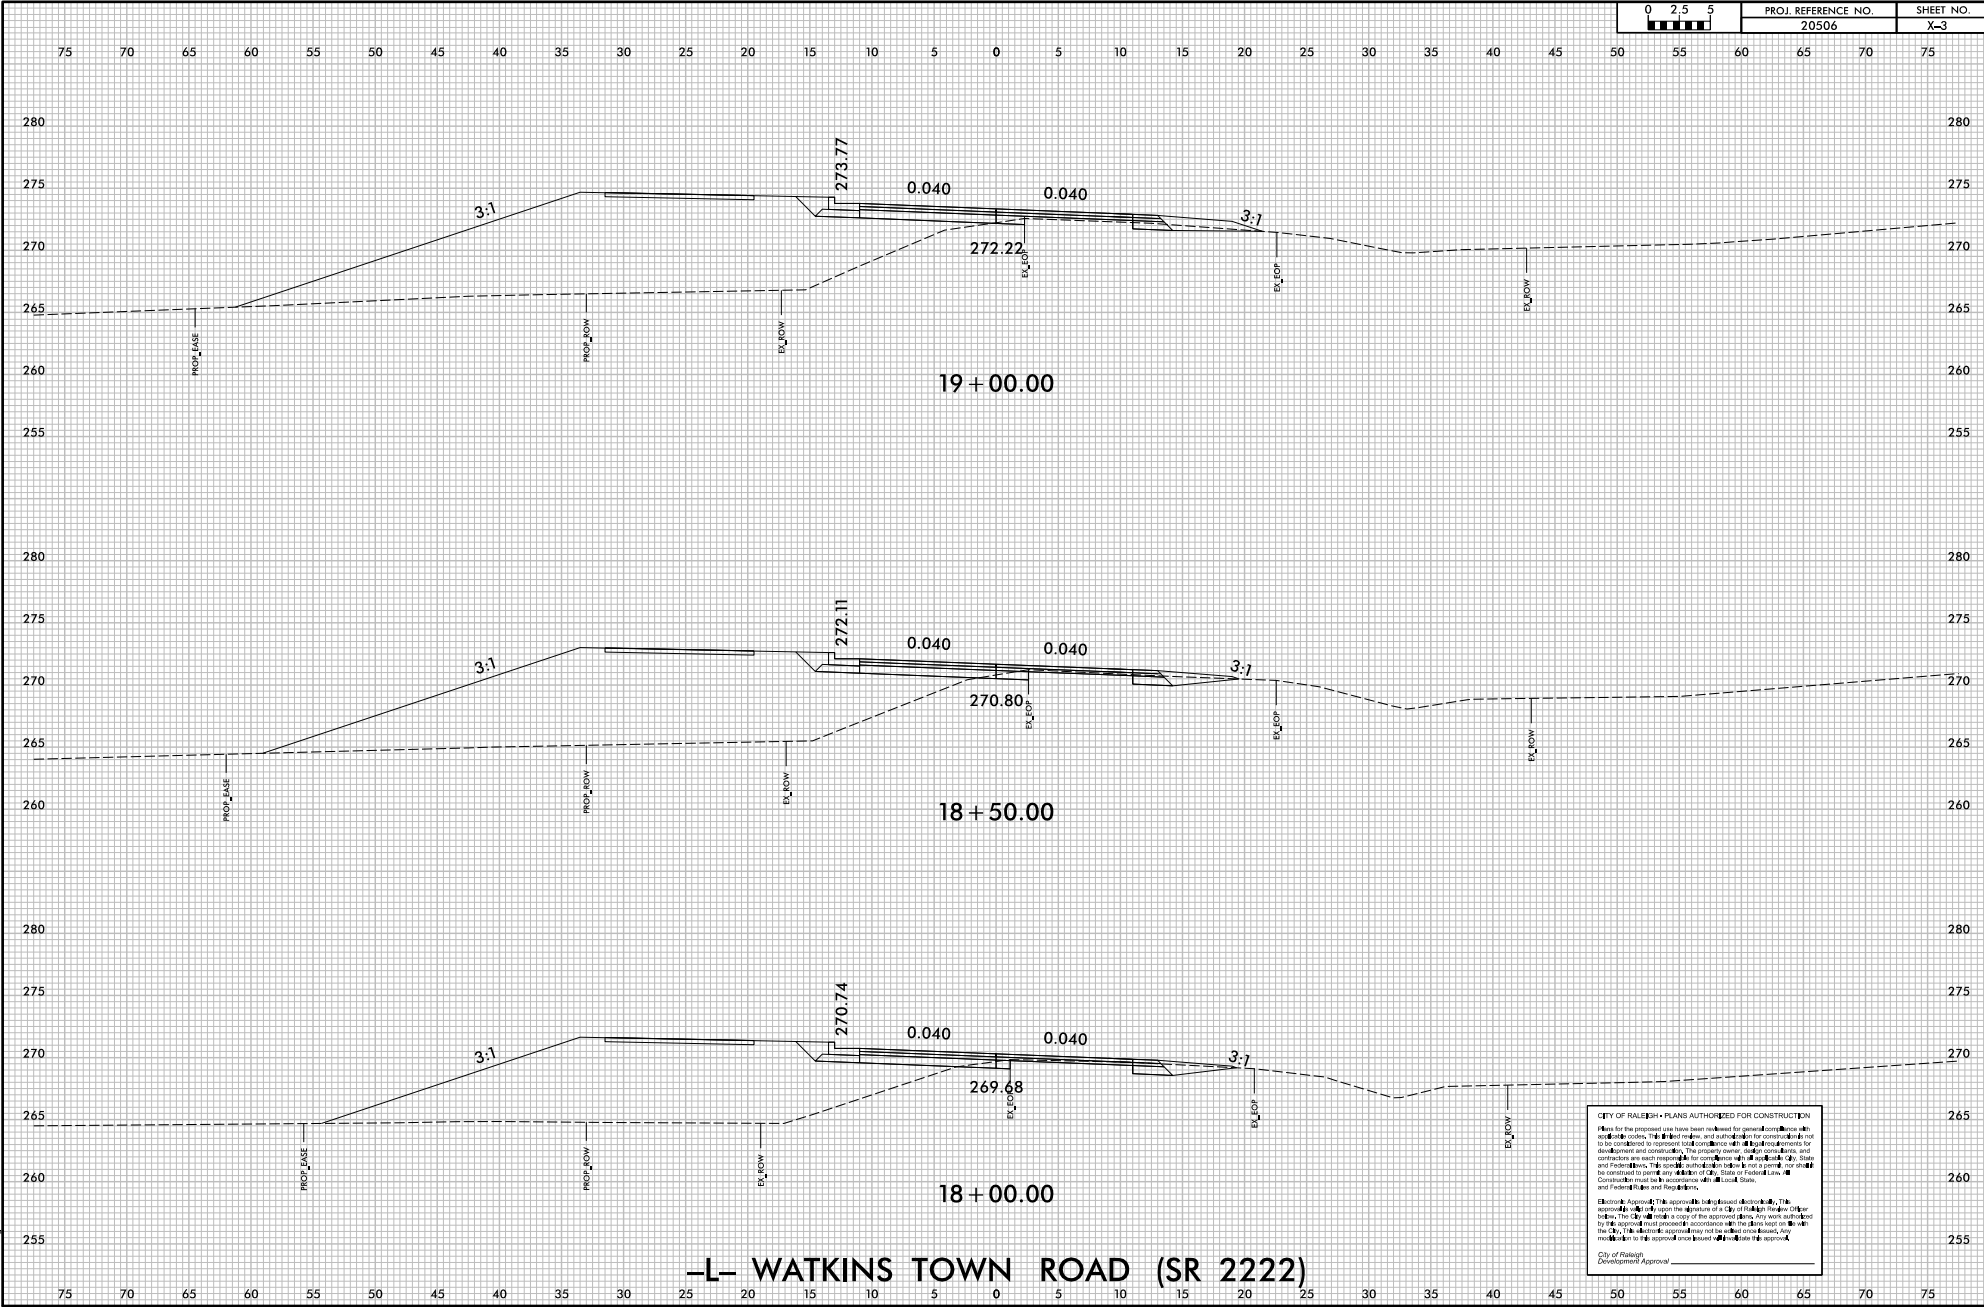

**CITY OF RALEIGH PLANS AUTHORIZED FOR CONSTRUCTION**

Plans for the proposed use have been reviewed for general compliance with applicable codes, ordinances, and regulations. The City Engineer's approval is not a guarantee of construction quality or performance. The City Engineer's approval is not a guarantee of construction quality or performance. The City Engineer's approval is not a guarantee of construction quality or performance.

City of Raleigh  
Development Approval

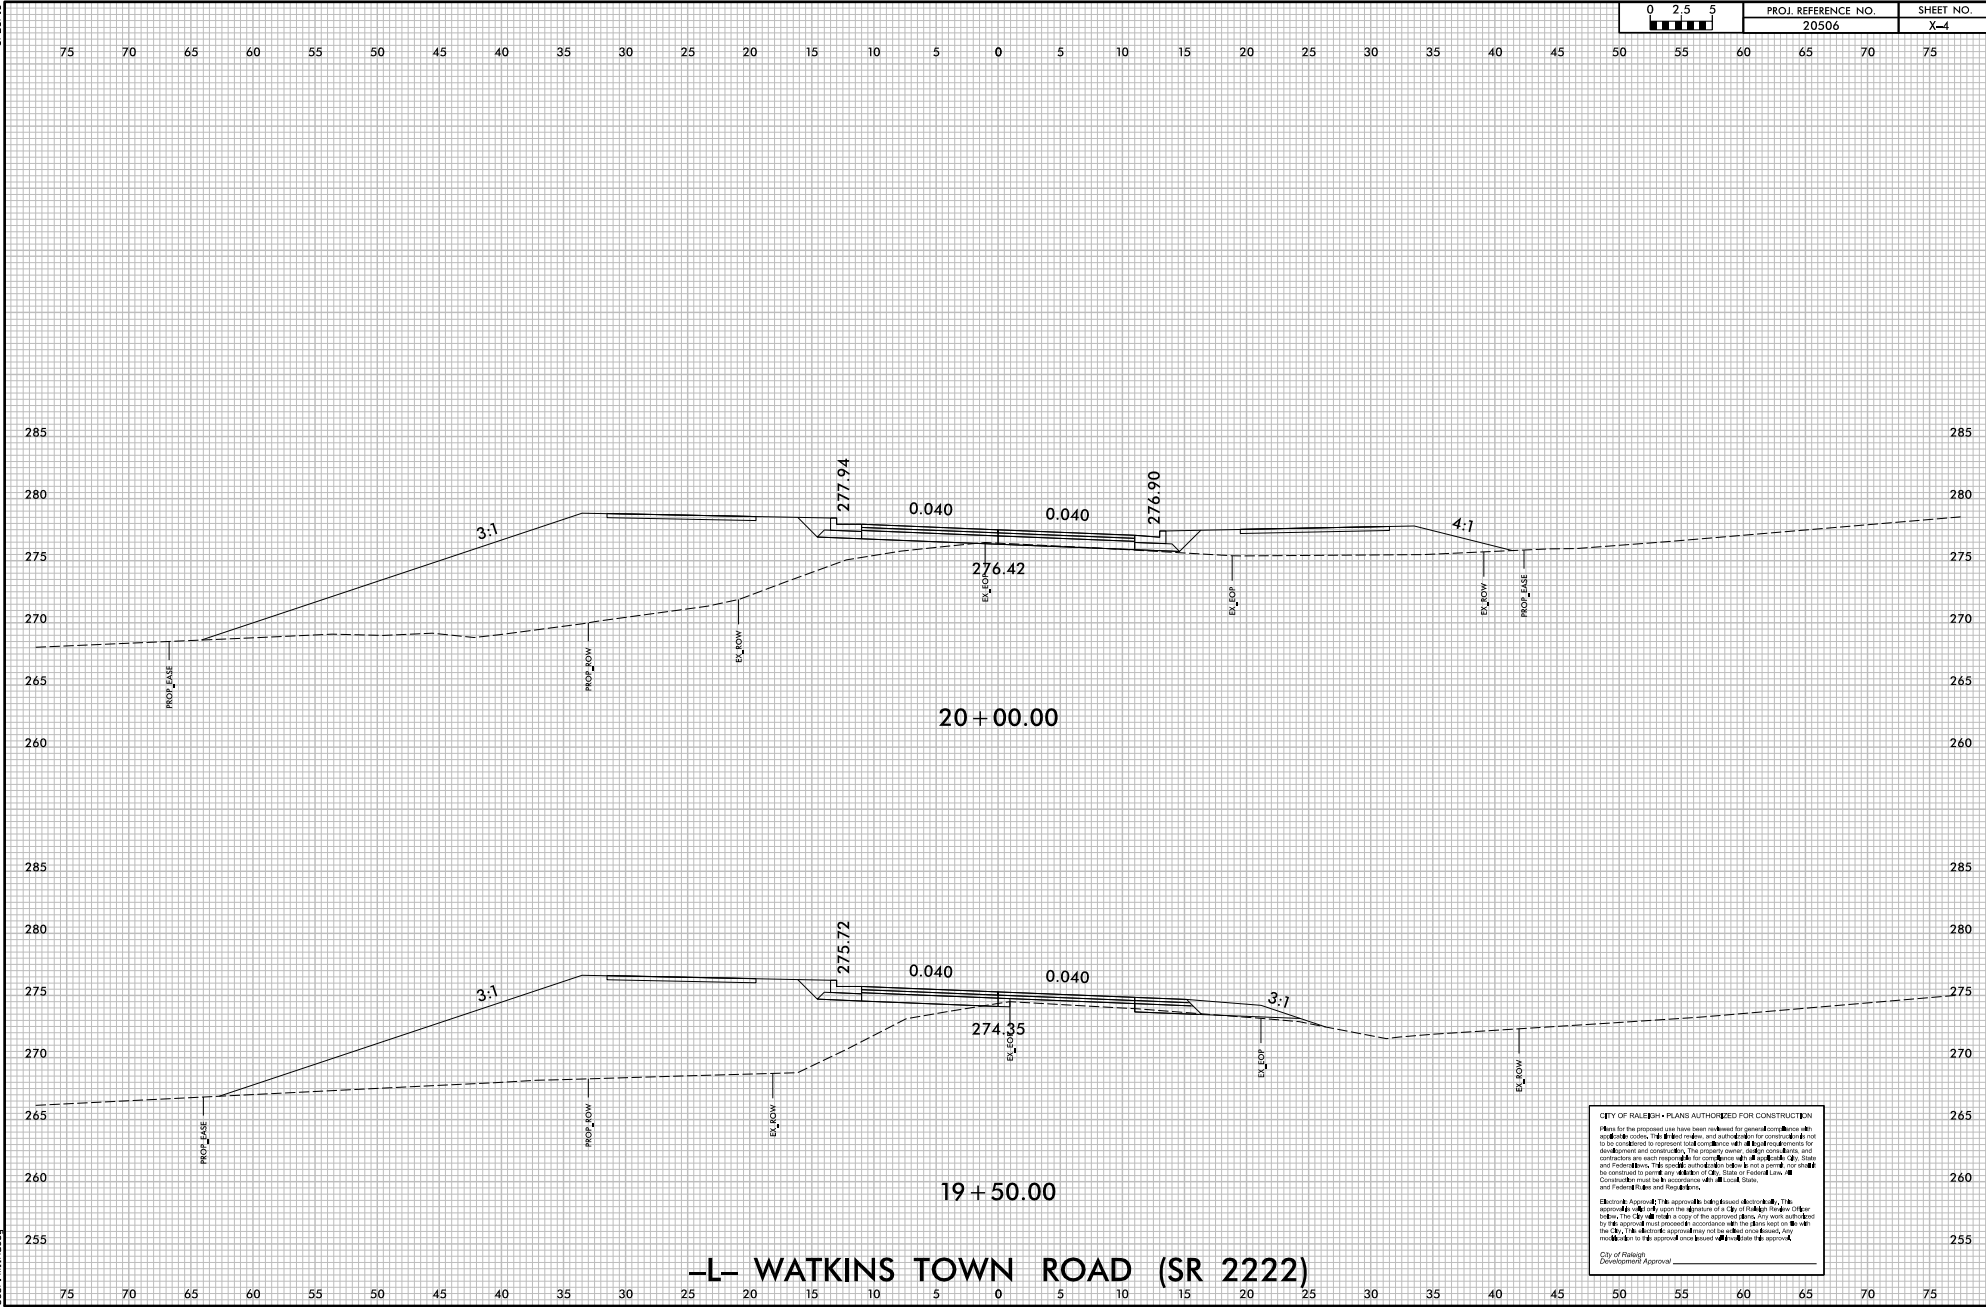
**-L- WATKINS TOWN ROAD (SR 2222)**



6/23/16

11/9/2022  
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User: m1024m

0 2.5 5	PROJ. REFERENCE NO.	SHEET NO.
	20506	X-4




**CITY OF RALEIGH • PLANS AUTHORIZED FOR CONSTRUCTION**

Plans for the proposed use have been reviewed for general compliance with applicable codes. The City Engineer and Inspector of Construction are not responsible for the accuracy of the information provided by the contractor. The contractor is responsible for obtaining all necessary permits and approvals from the City, State, and Federal Agencies. The contractor shall be responsible for obtaining all necessary permits and approvals from the City, State, and Federal Agencies. The contractor shall be responsible for obtaining all necessary permits and approvals from the City, State, and Federal Agencies.


**Electronic Approval:** This approval is not a physical stamp. The contractor shall submit a copy of this approval to the City Engineer and Inspector of Construction. Any work not in accordance with the approved plans shall be done at the contractor's expense. The contractor shall be responsible for obtaining all necessary permits and approvals from the City, State, and Federal Agencies.

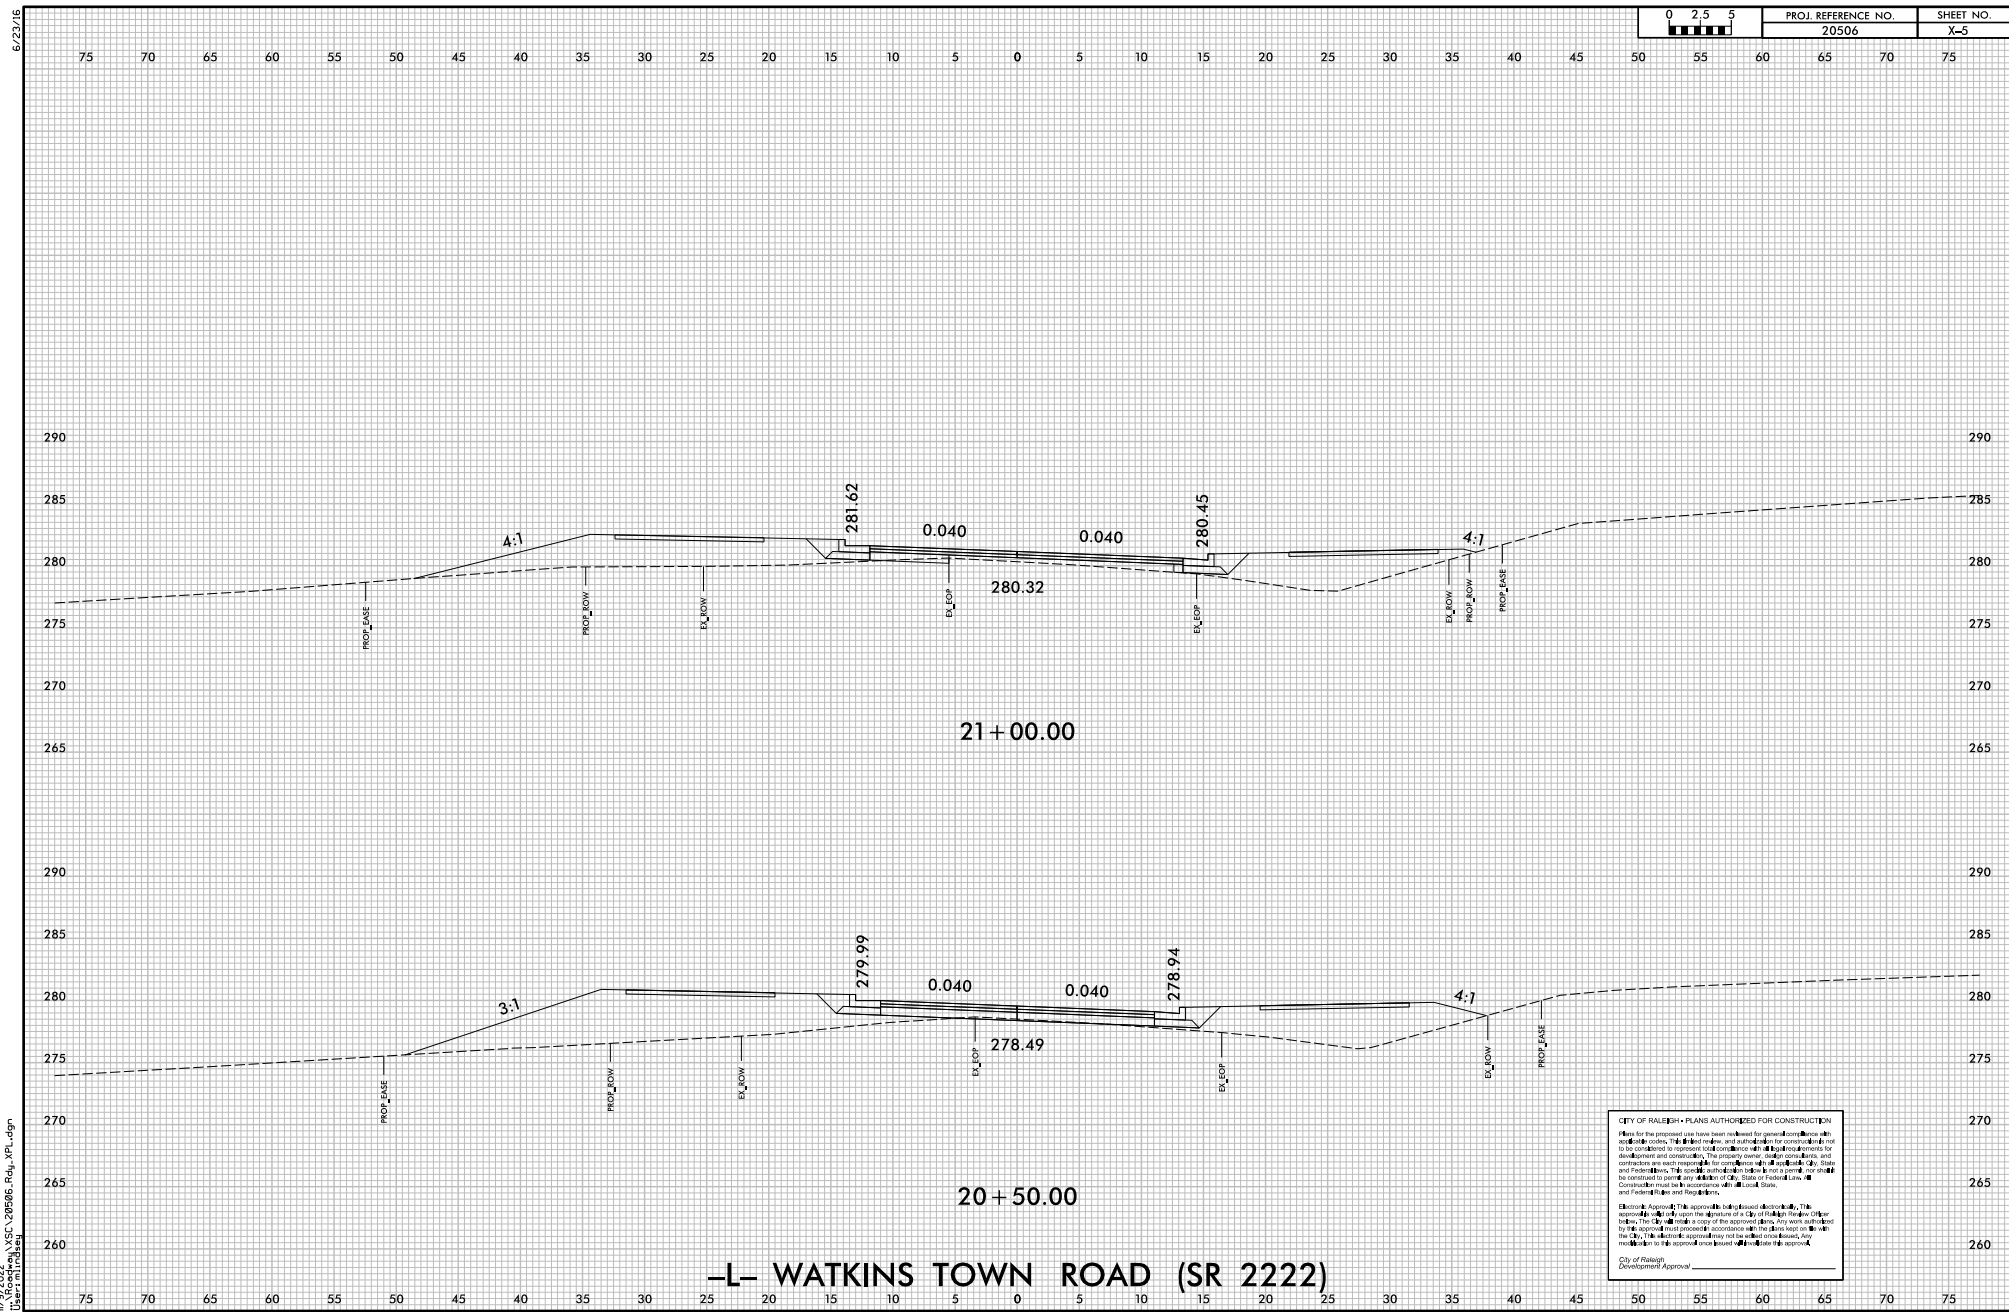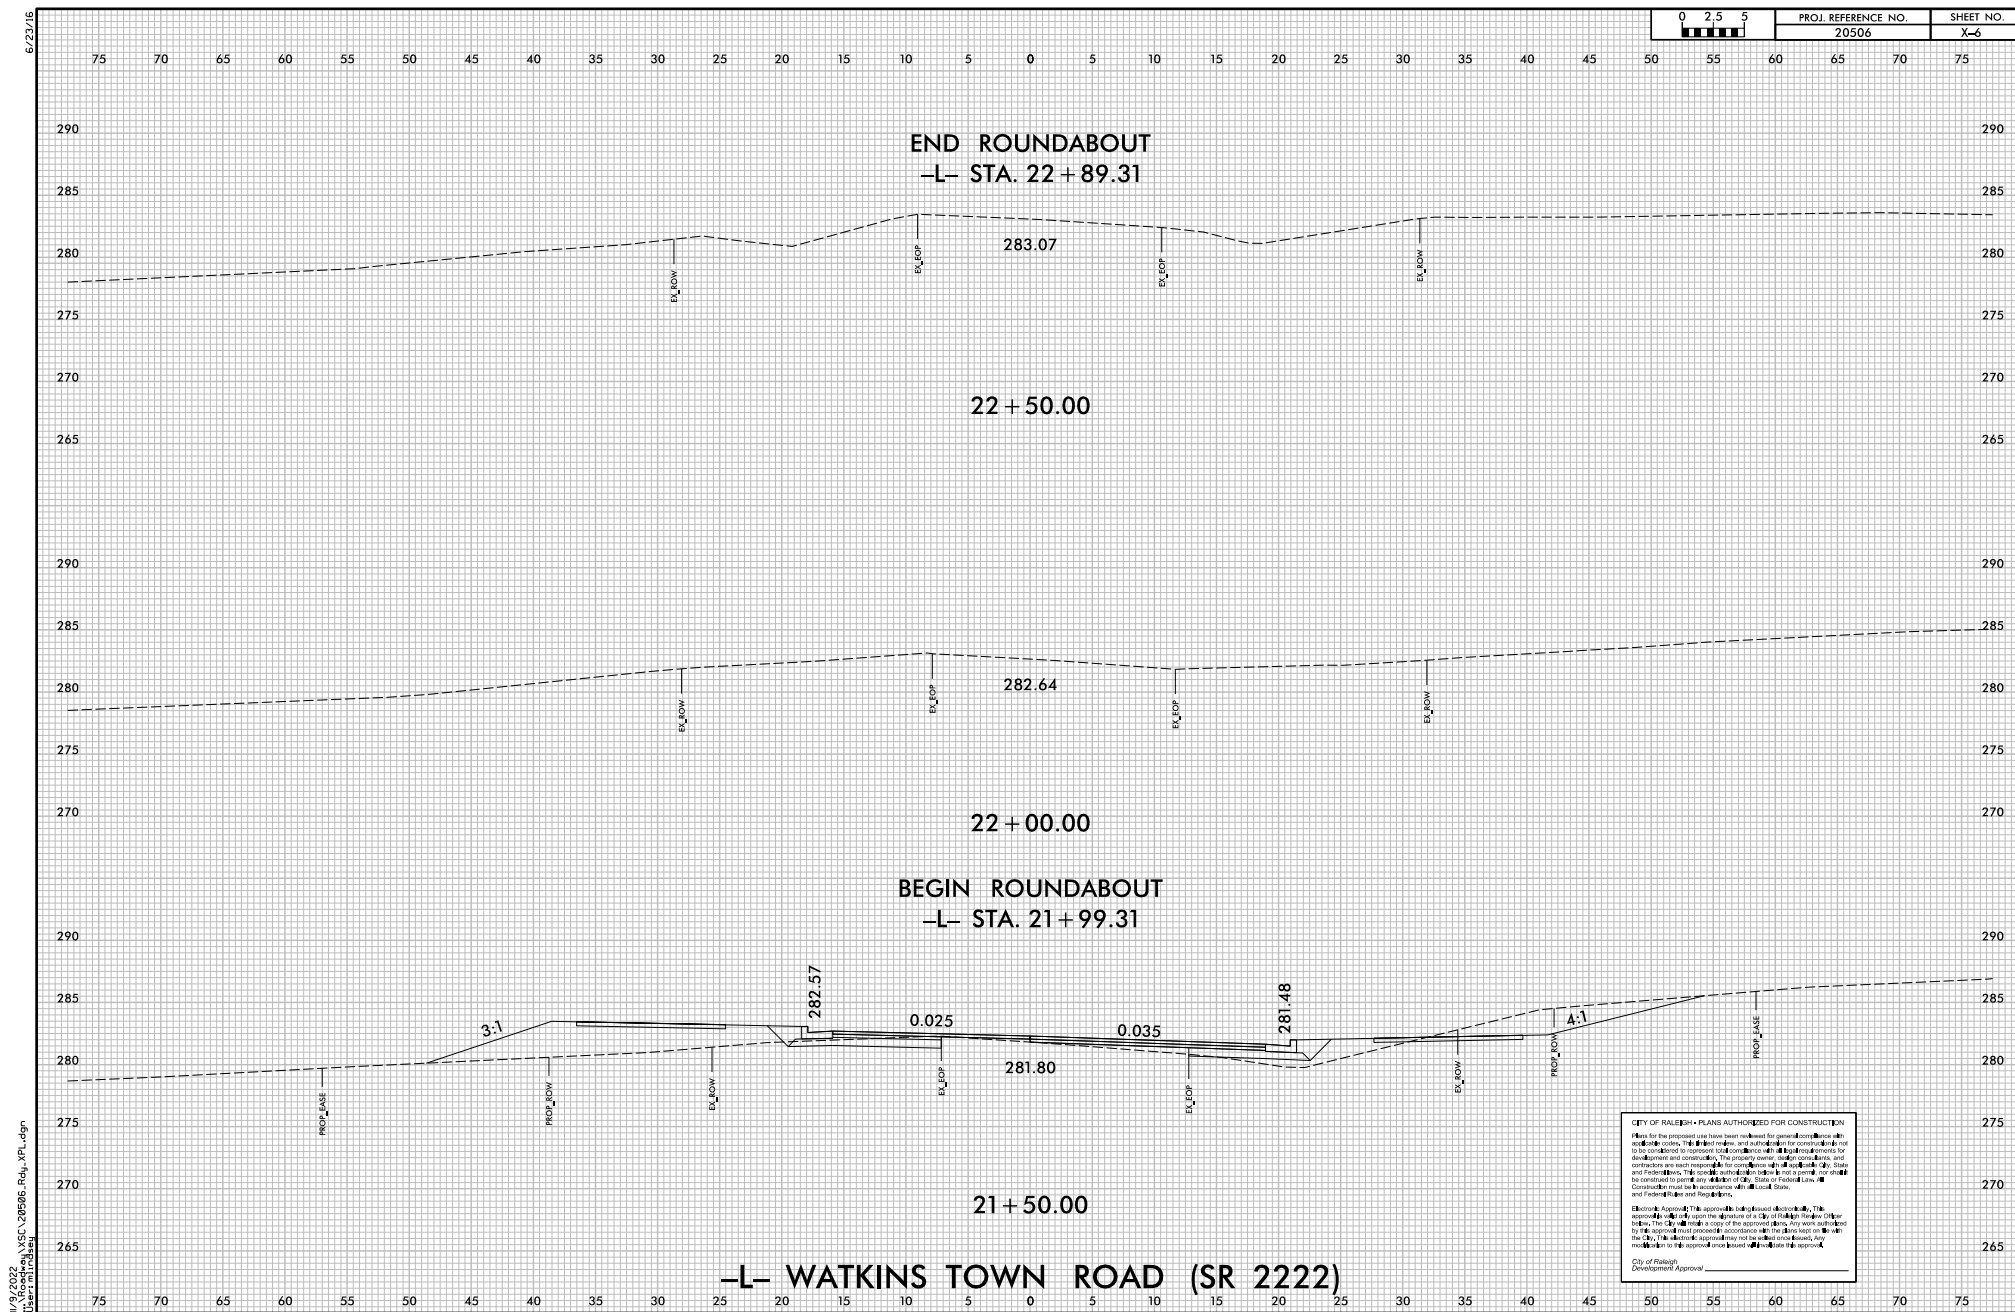City of Raleigh Development Approval \_\_\_\_\_

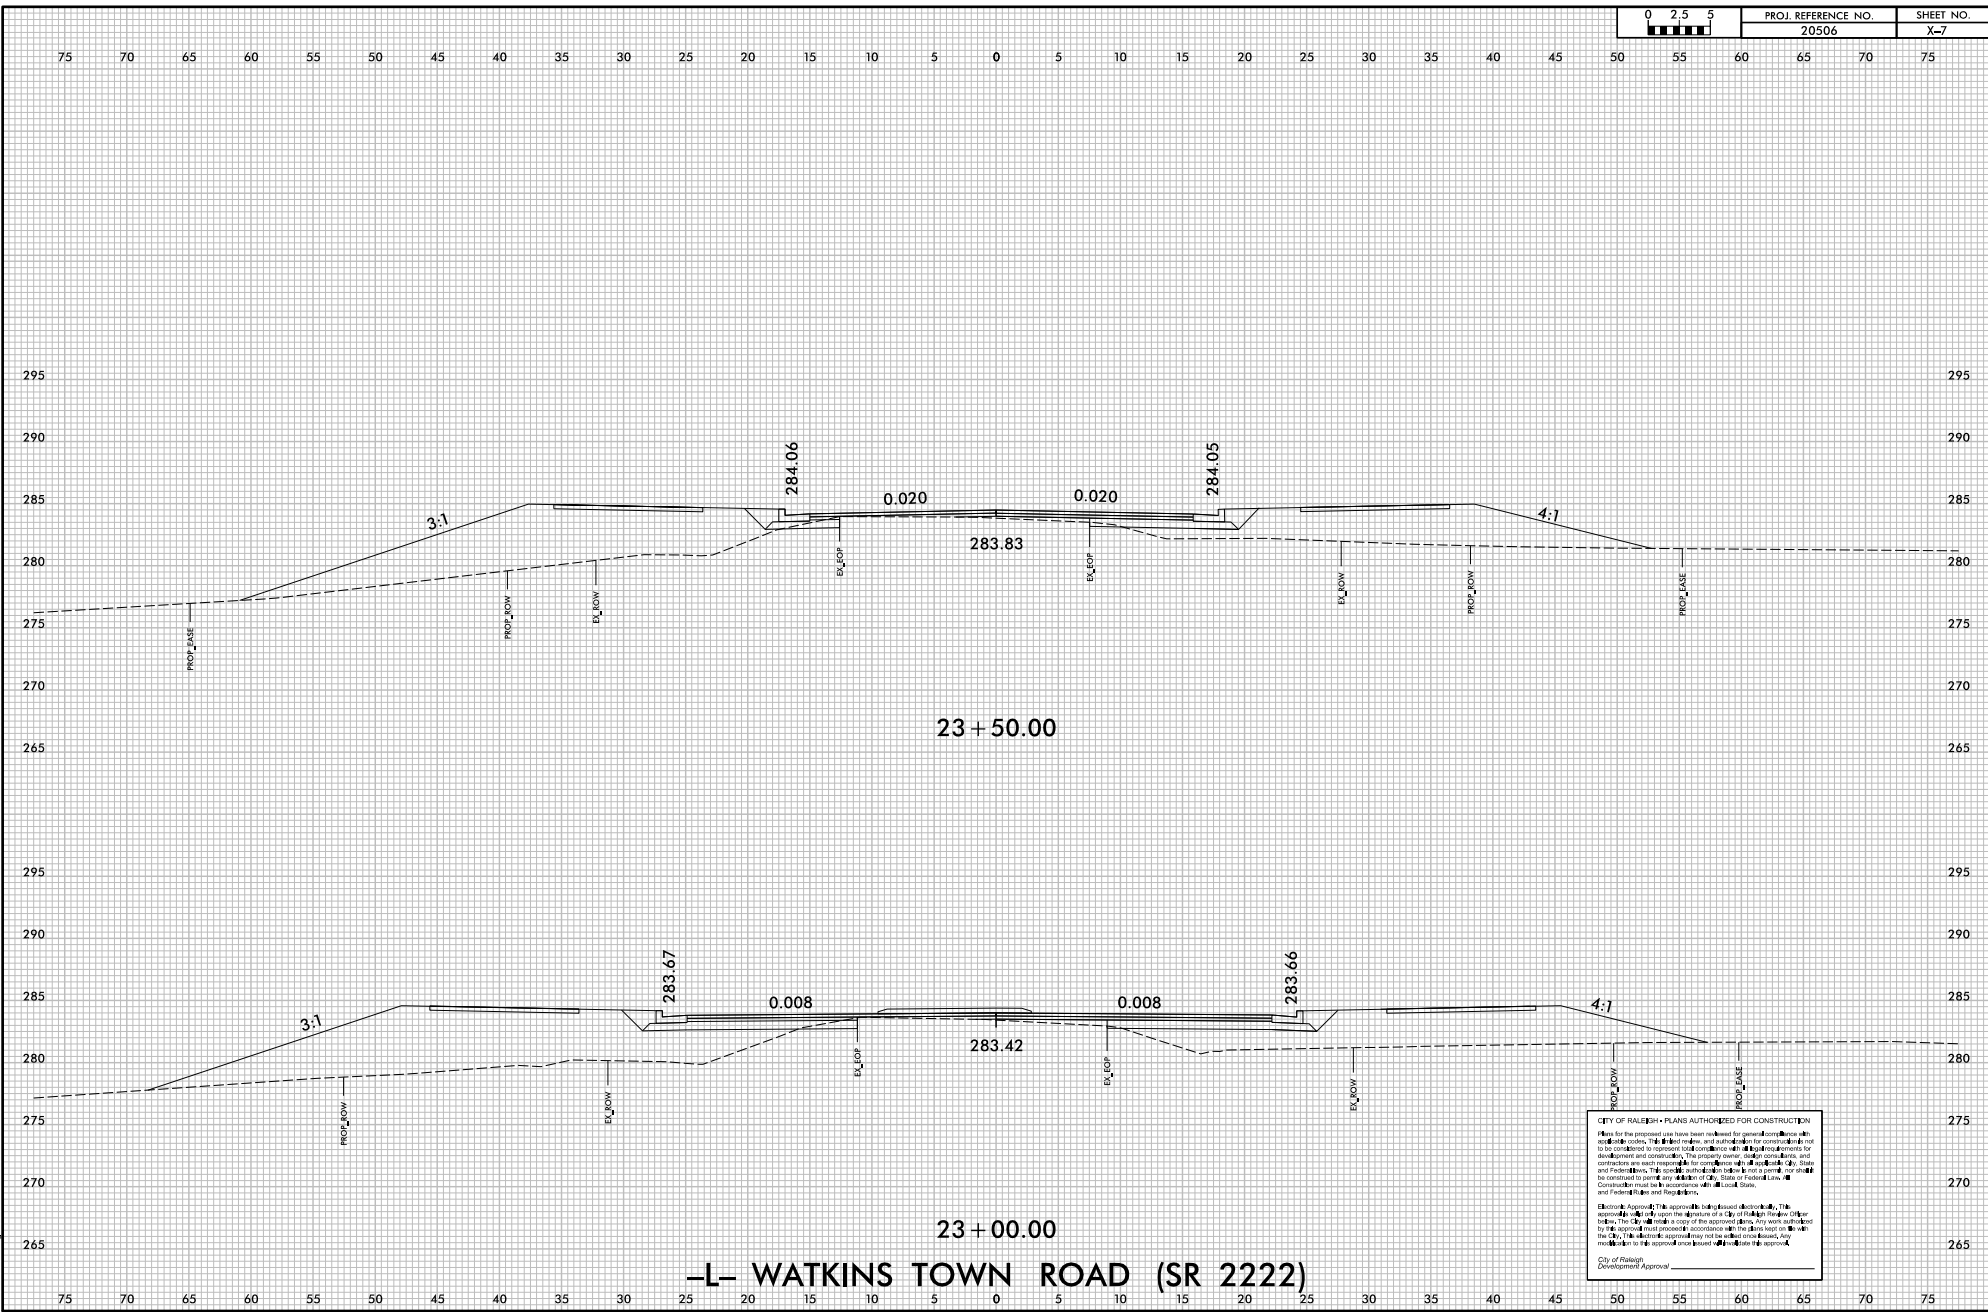




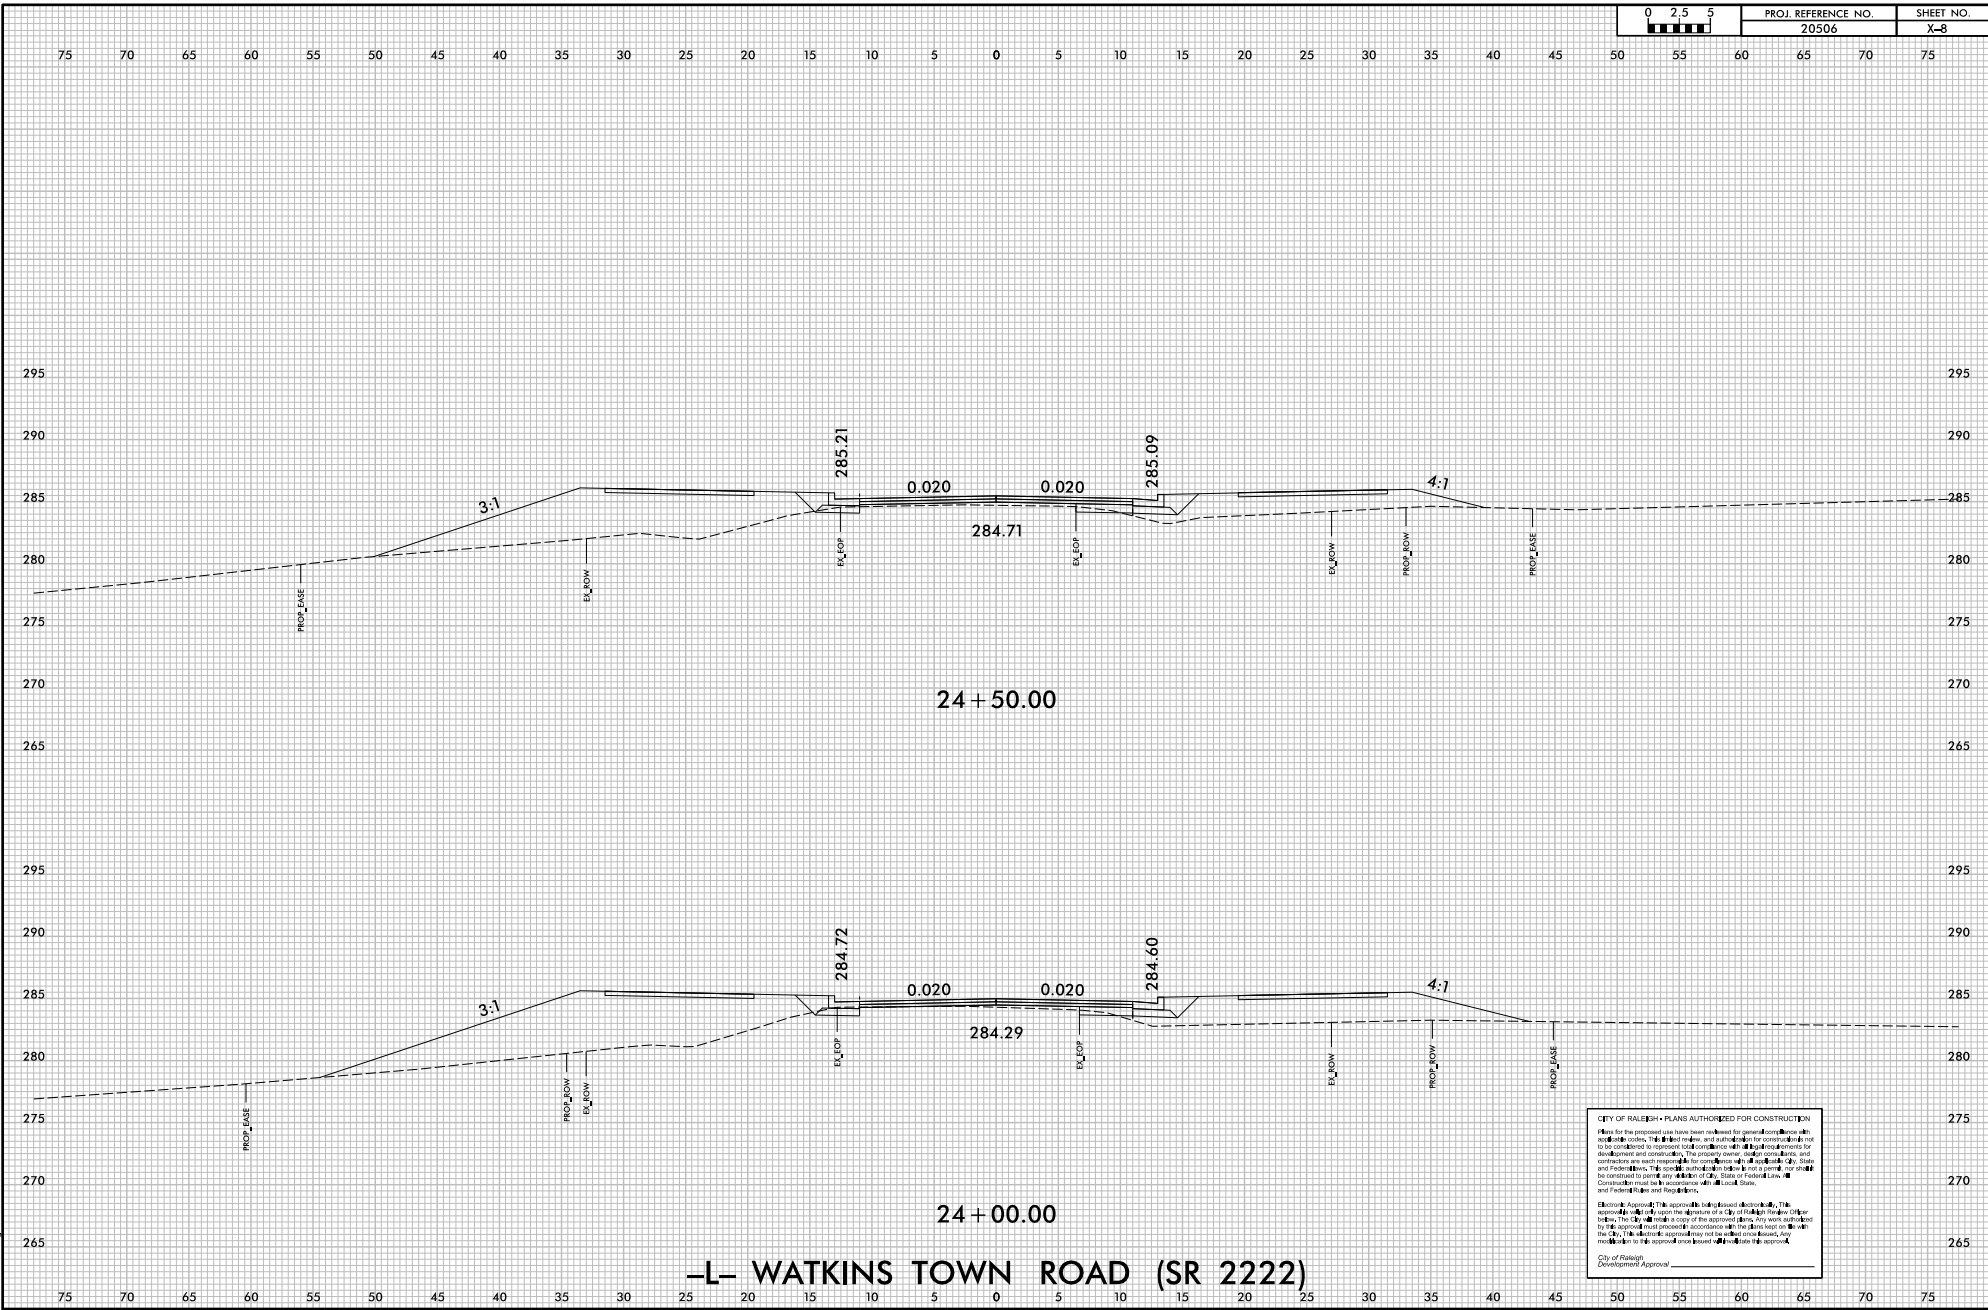















6/23/16

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User: m111111

0 2.5 5	PROJ. REFERENCE NO.	SHEET NO.
	20506	X-9

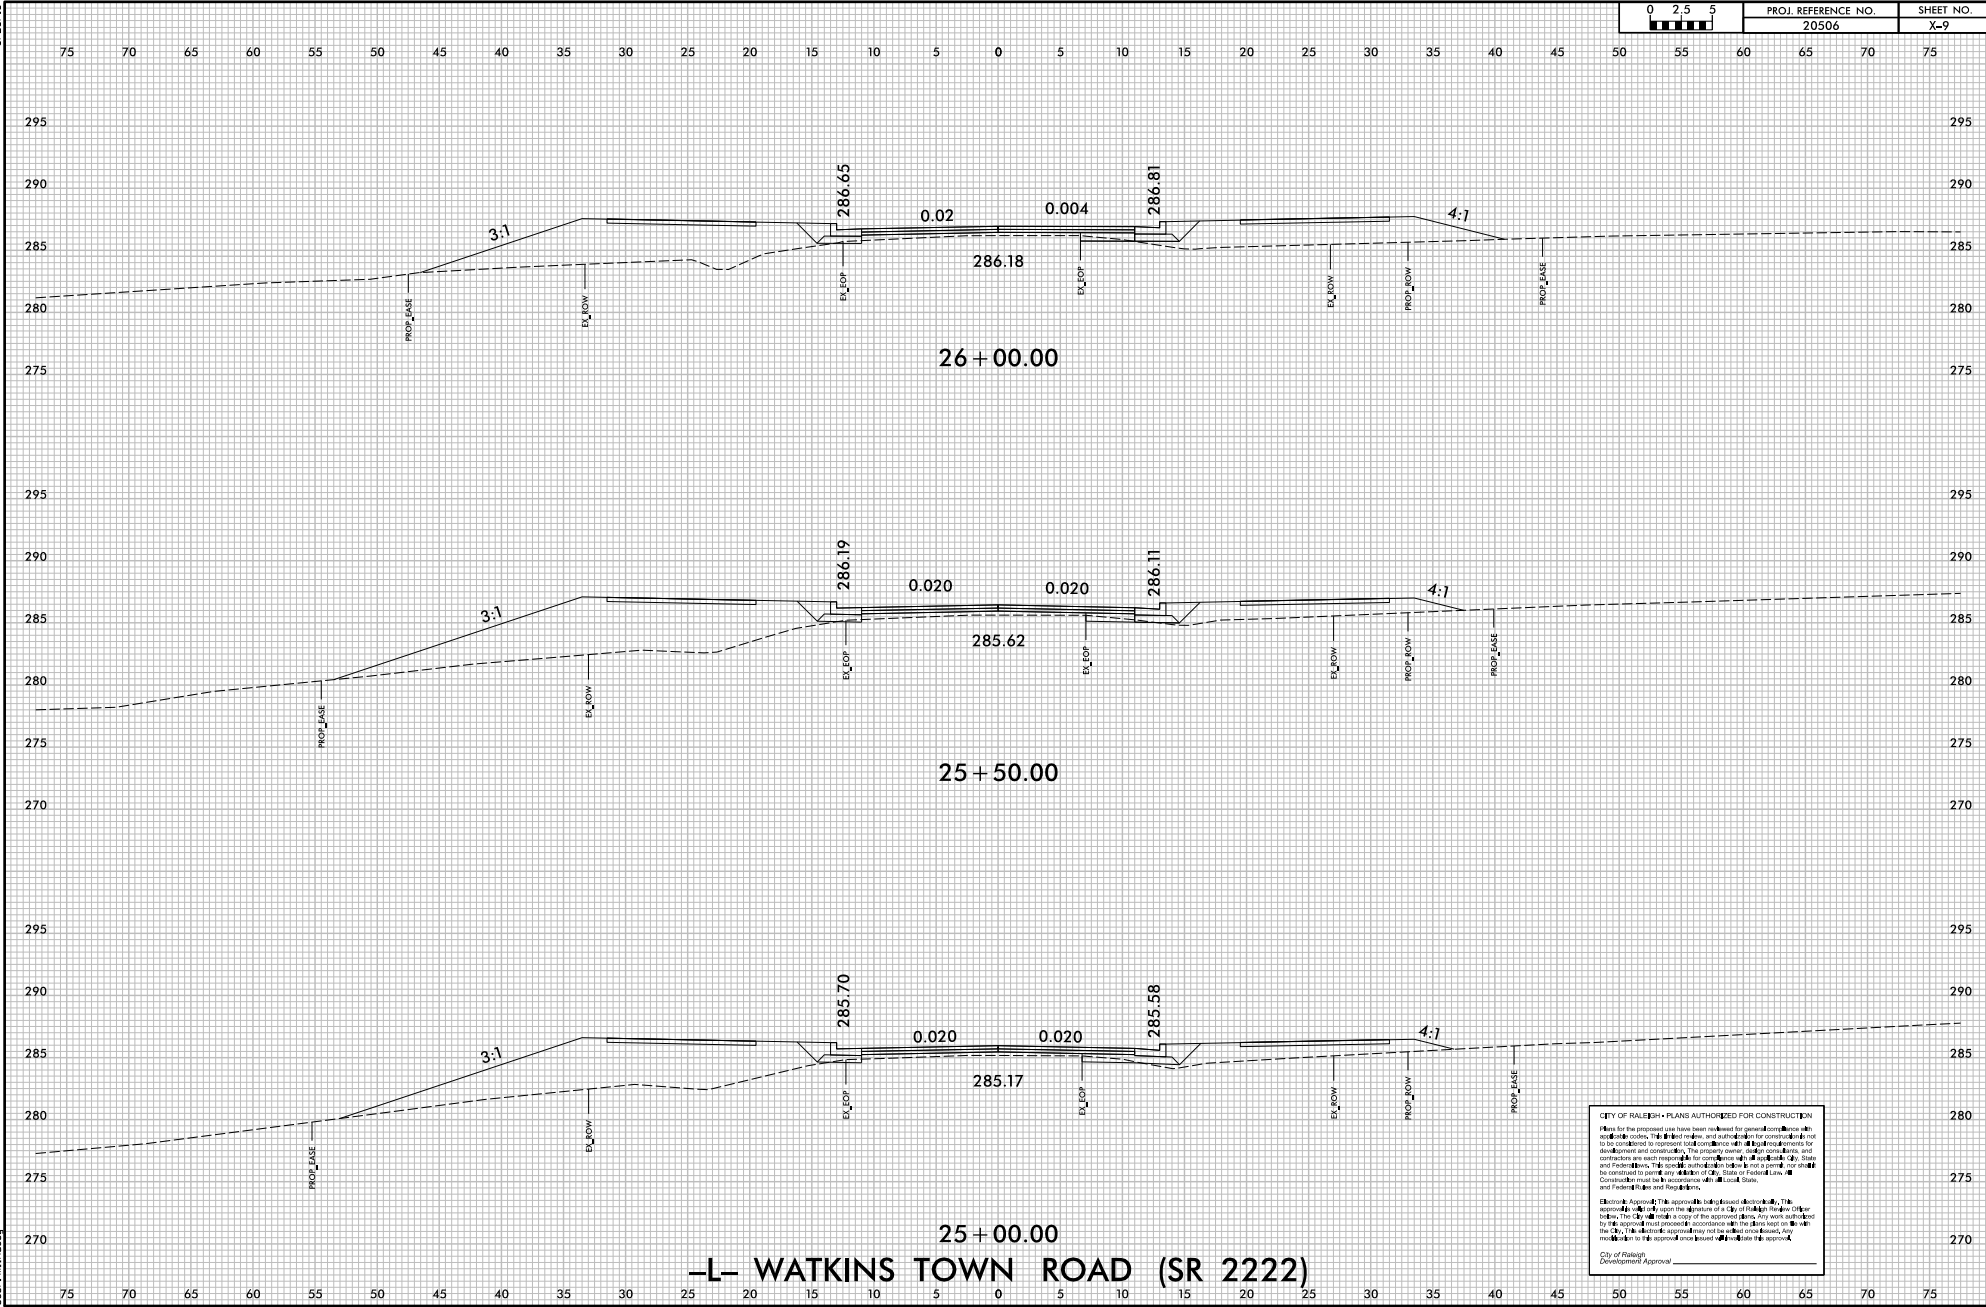

**-L- WATKINS TOWN ROAD (SR 2222)**

**CITY OF RALEIGH • PLANS AUTHORIZED FOR CONSTRUCTION**

Plans for the proposed use have been reviewed for general compliance with applicable codes, ordinances, and regulations of the City of Raleigh. The City of Raleigh does not warrant or guarantee the accuracy or completeness of the information provided herein. The user of these plans is responsible for obtaining all necessary permits and approvals from the appropriate authorities. The user of these plans is responsible for obtaining all necessary permits and approvals from the appropriate authorities. The user of these plans is responsible for obtaining all necessary permits and approvals from the appropriate authorities.

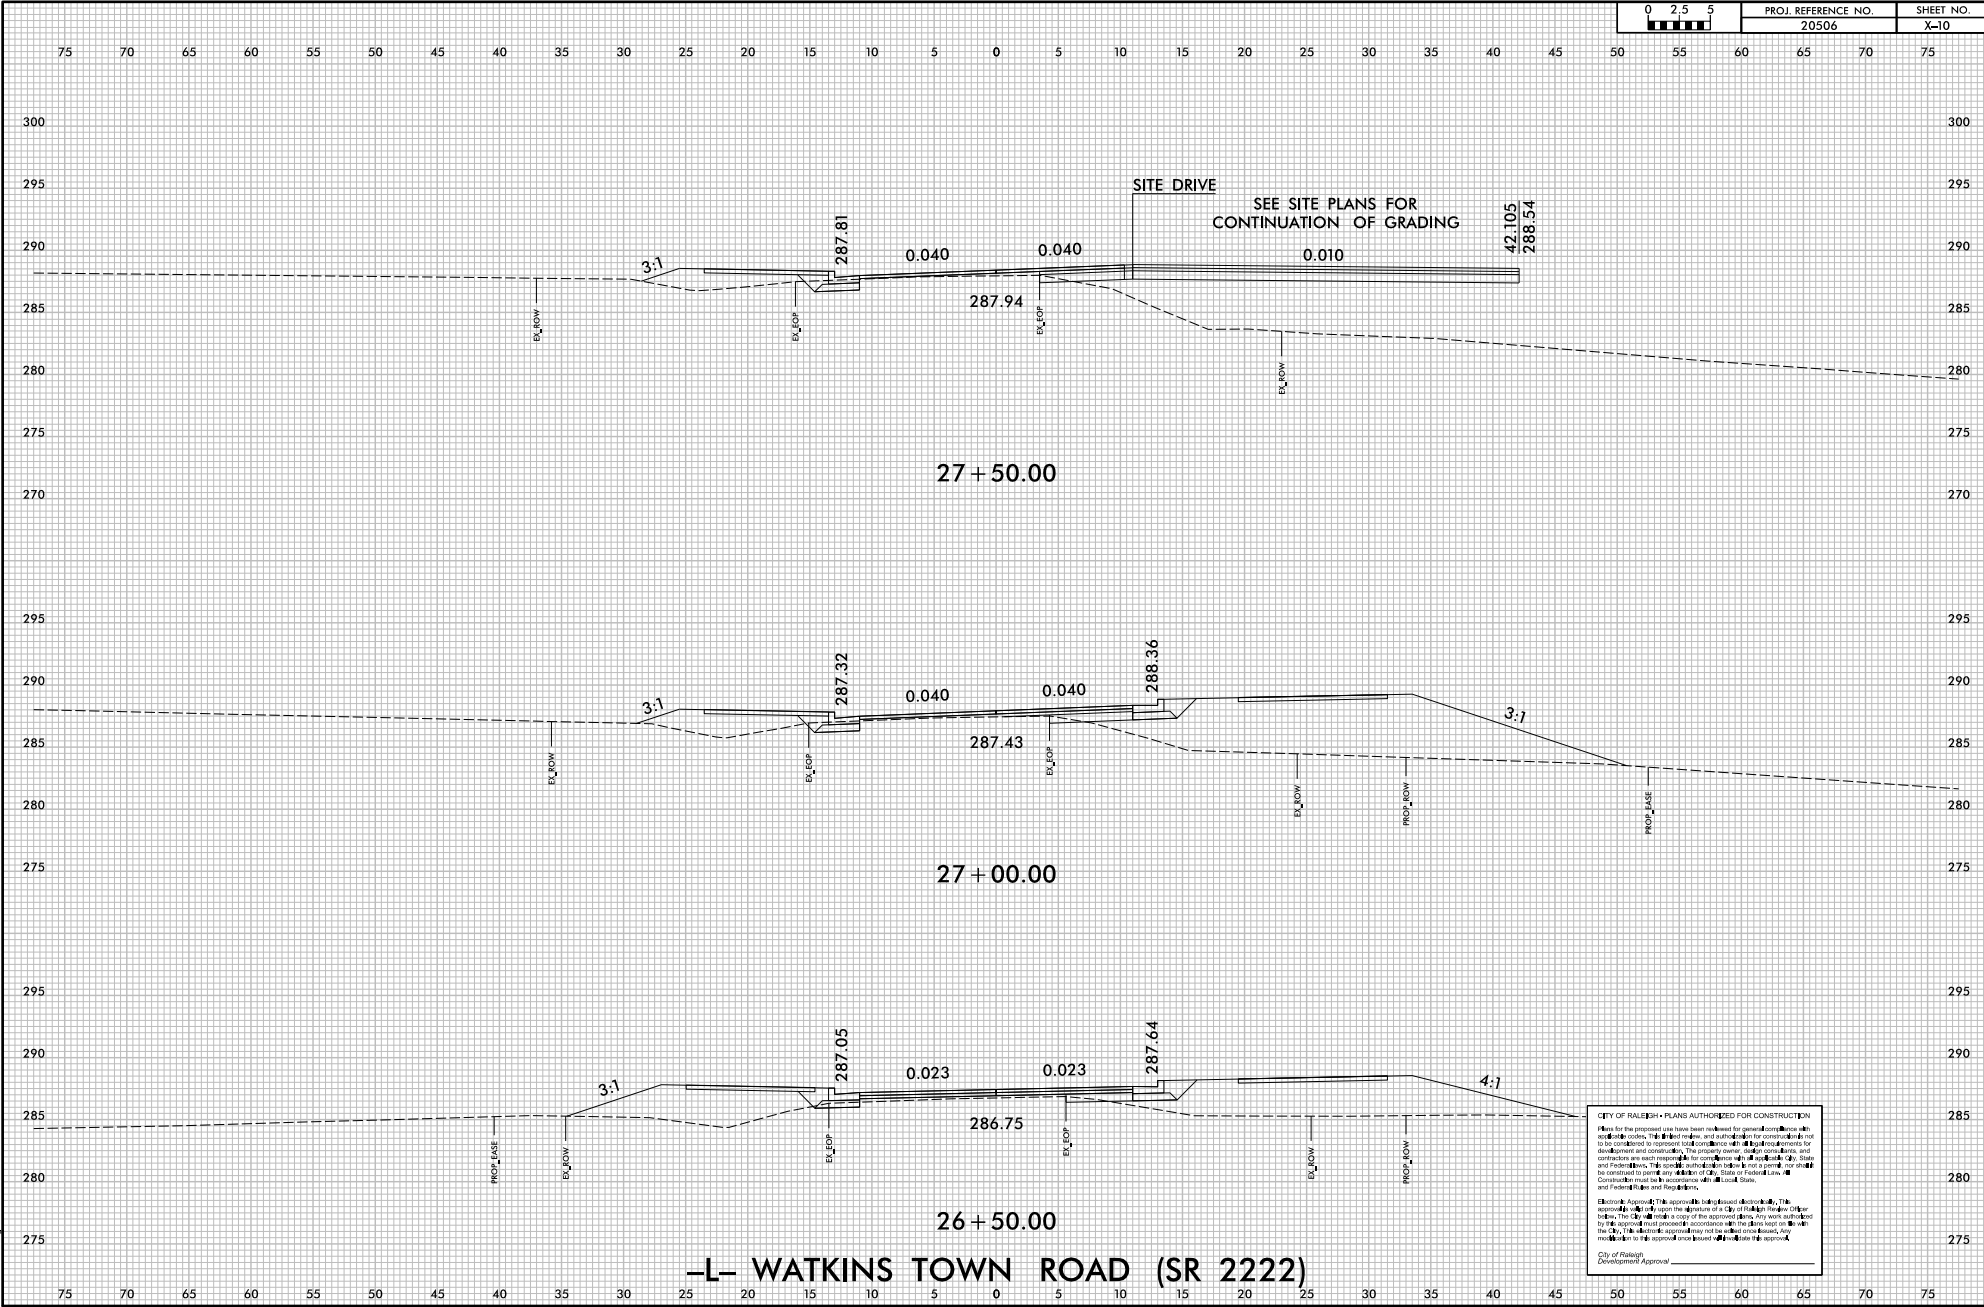
City of Raleigh  
Development Approval



6/23/16

11/9/2022  
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User: m16dram

0 2.5 5	PROJ. REFERENCE NO.	SHEET NO.
	20506	X-10




**-L- WATKINS TOWN ROAD (SR 2222)**

**CITY OF RALEIGH PLANS AUTHORIZED FOR CONSTRUCTION**


Plans for the proposed use have been reviewed for general compliance with applicable codes, ordinances, and regulations. The City of Raleigh is not responsible for the accuracy or completeness of the information provided by the applicant. The applicant is responsible for obtaining all necessary permits and approvals from the appropriate agencies. The City of Raleigh is not responsible for the accuracy or completeness of the information provided by the applicant. The applicant is responsible for obtaining all necessary permits and approvals from the appropriate agencies. The City of Raleigh is not responsible for the accuracy or completeness of the information provided by the applicant. The applicant is responsible for obtaining all necessary permits and approvals from the appropriate agencies.

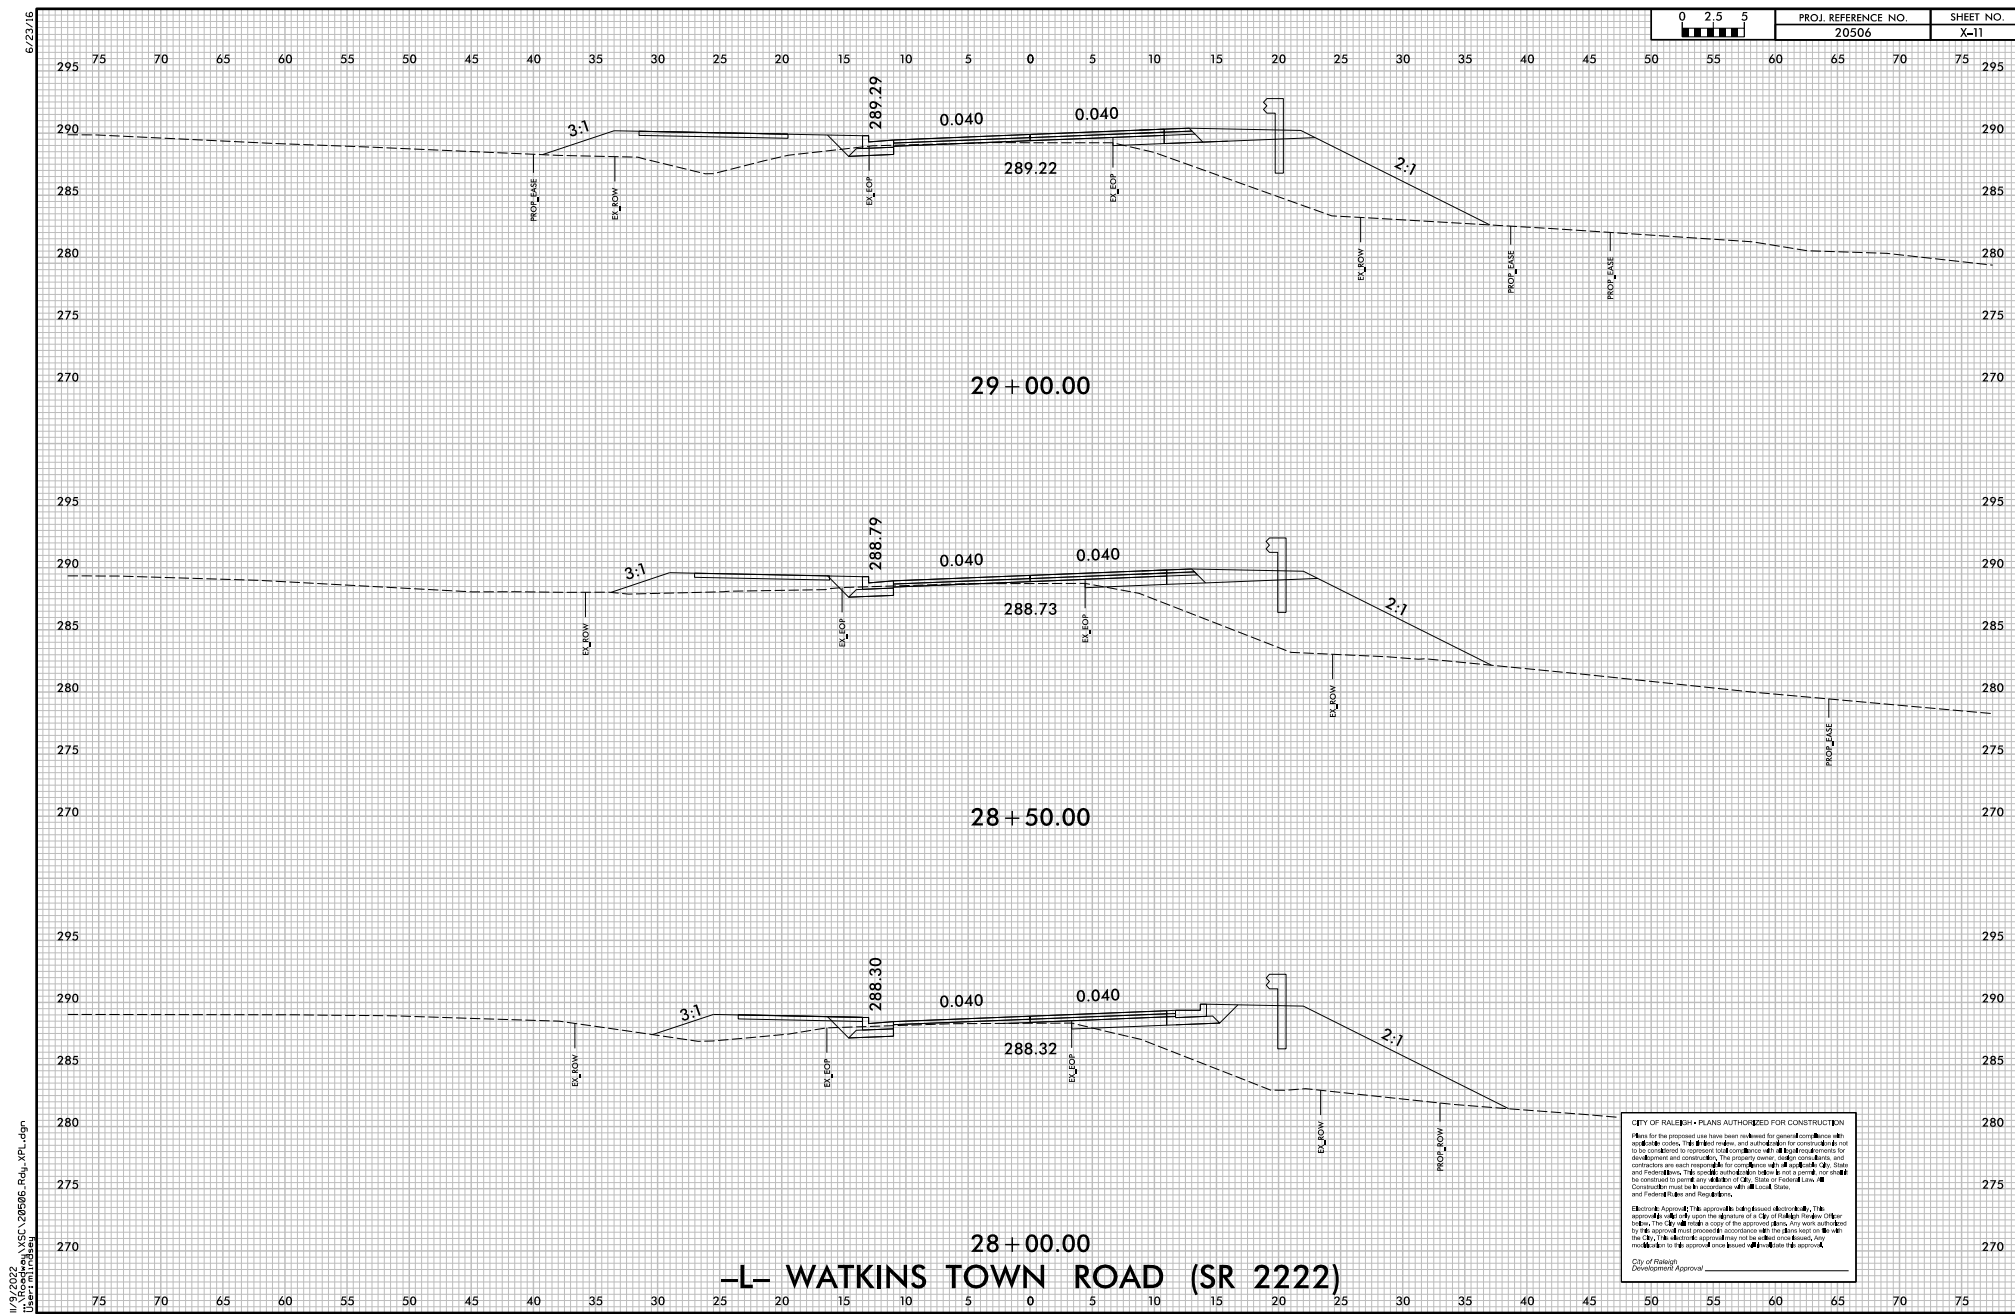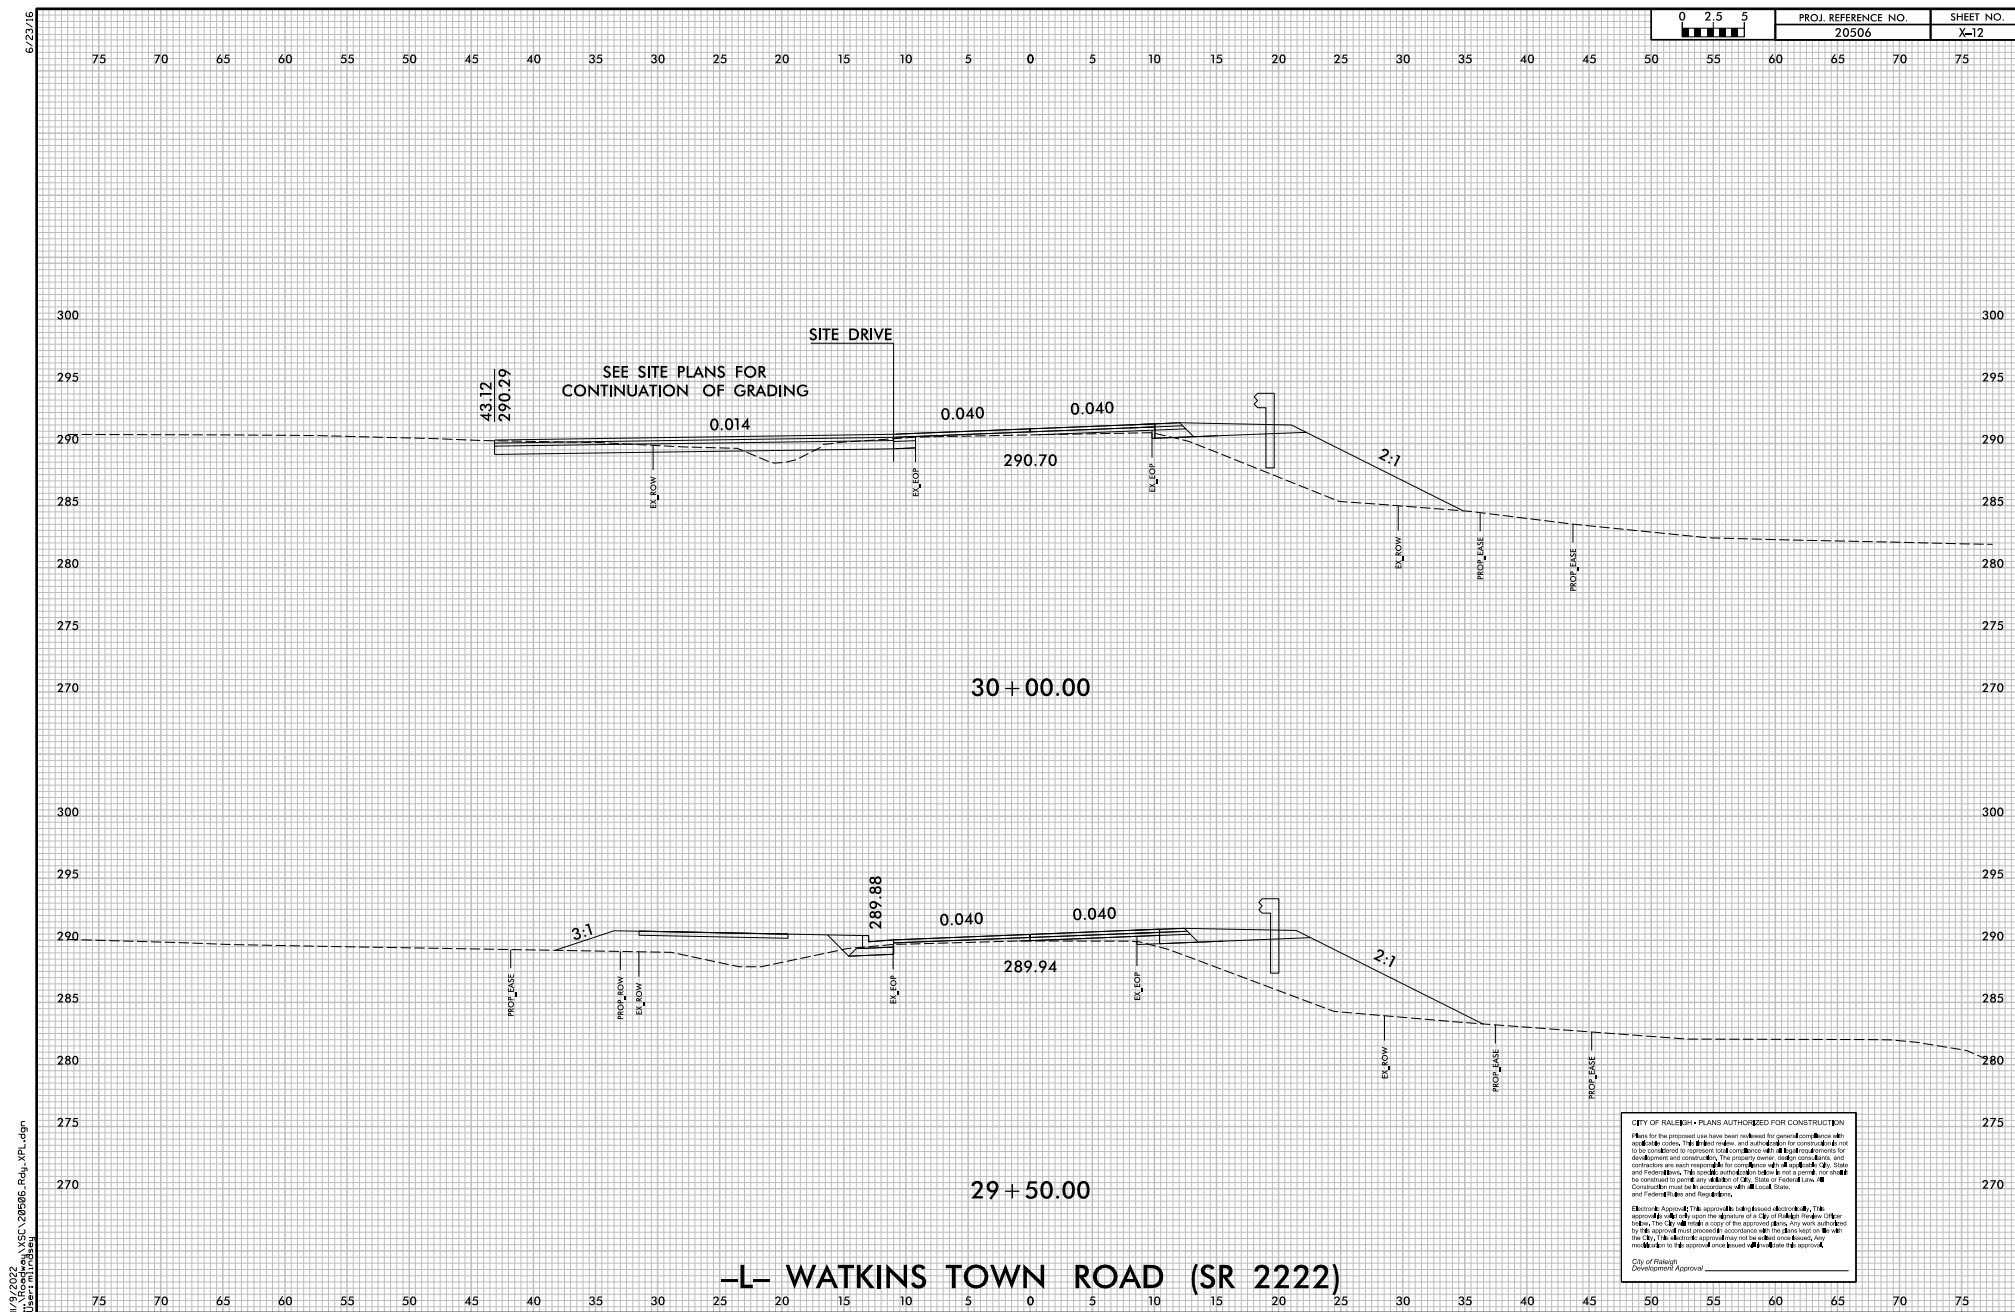City of Raleigh  
Development Approval













6/23/16

11/9/2022  
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User: m1024m

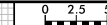

PROJ. REFERENCE NO.	SHEET NO.
20506	X-13

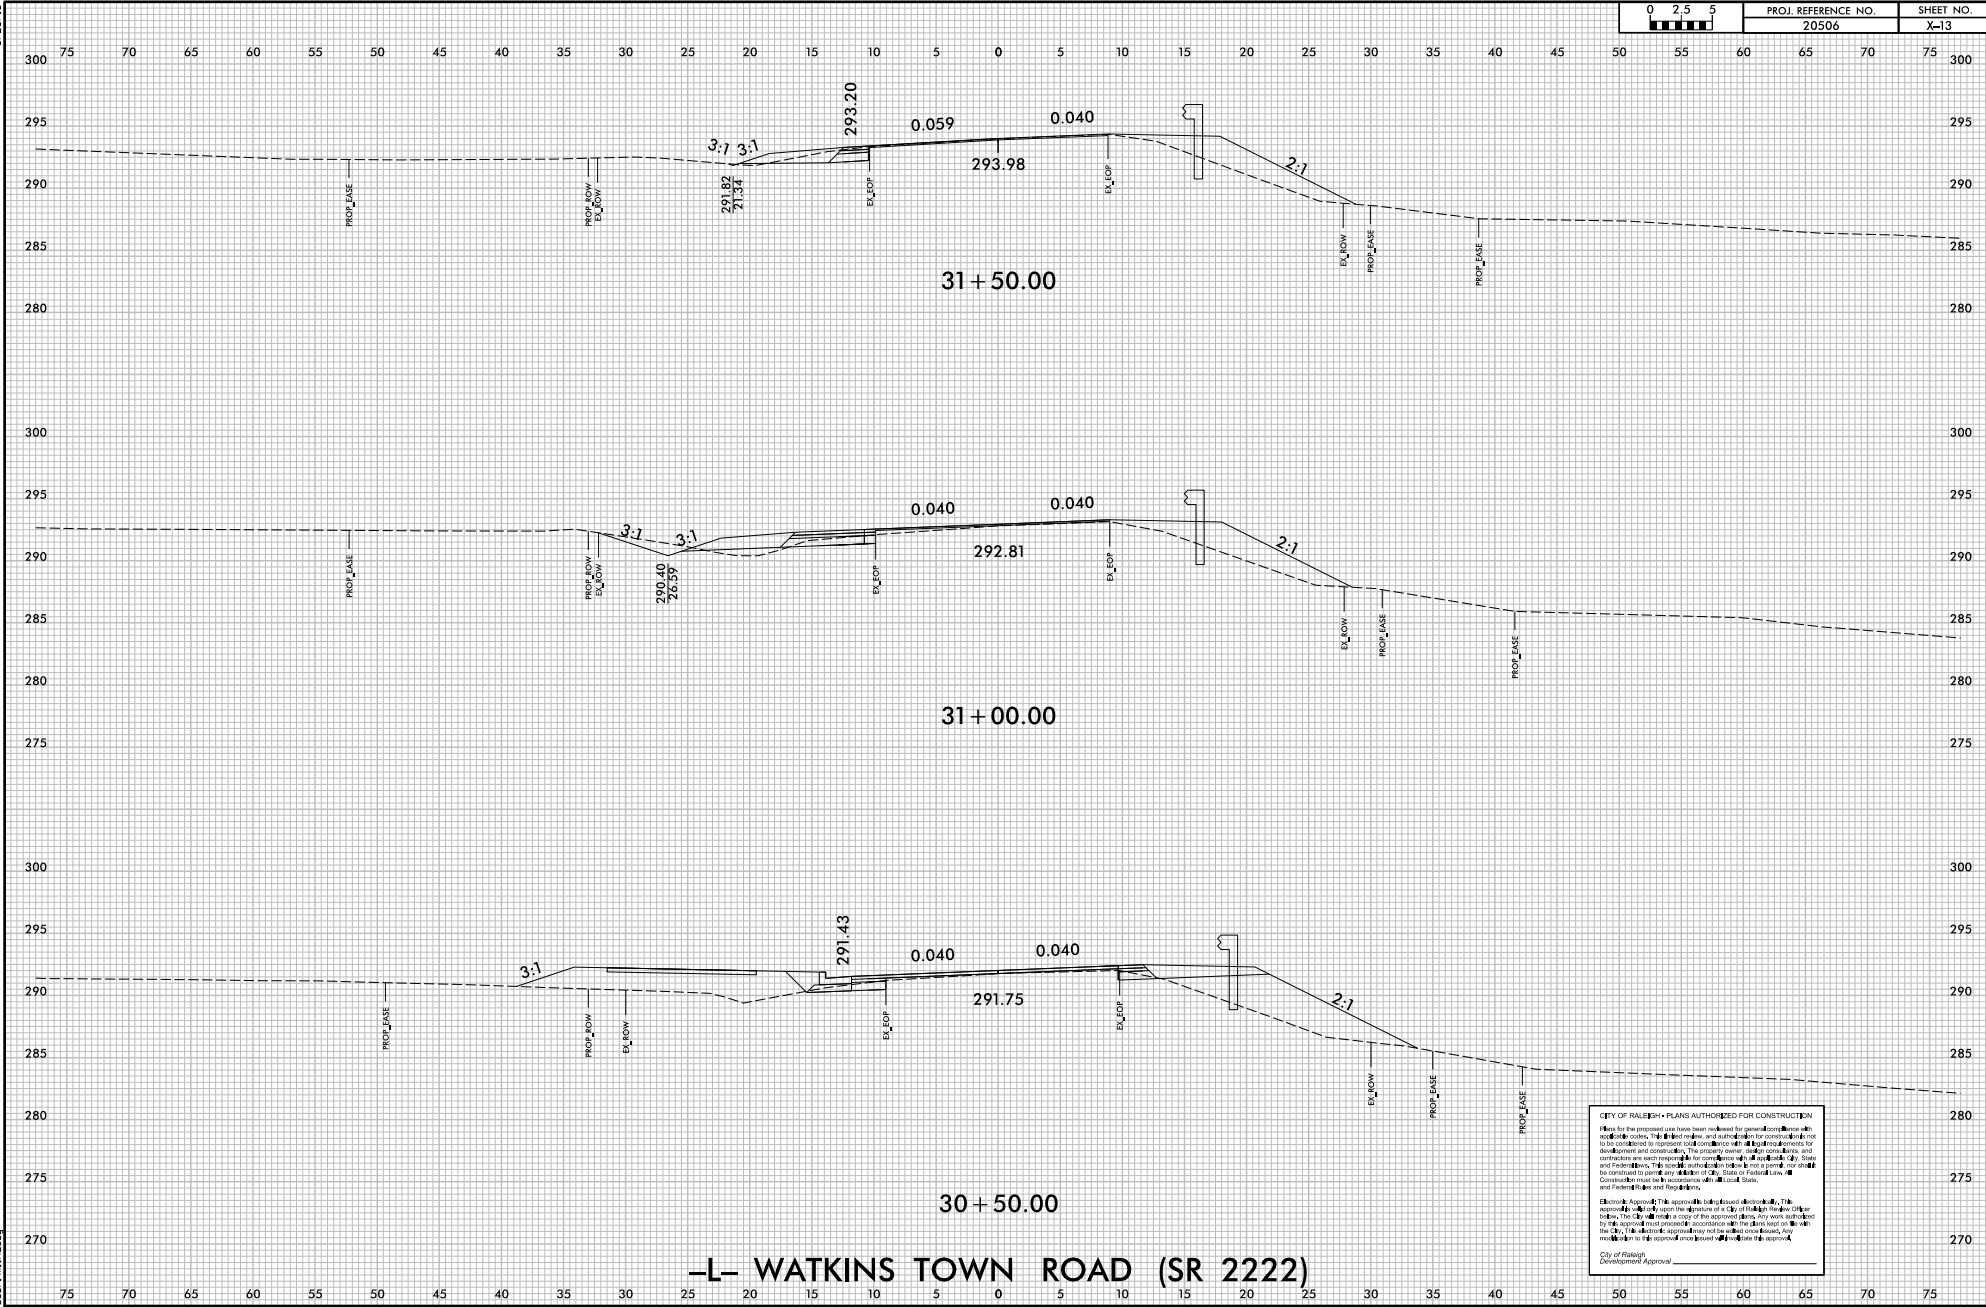

**CITY OF RALEIGH - PLANS AUTHORIZED FOR CONSTRUCTION**

Plans for the proposed work have been reviewed for general compliance with the City of Raleigh's standards and specifications. The City of Raleigh does not warrant the accuracy or completeness of the information provided on these plans. The contractor is responsible for obtaining all necessary permits and approvals from the appropriate authorities. The contractor is also responsible for obtaining all necessary easements and rights-of-way from the appropriate authorities. The contractor is also responsible for obtaining all necessary approvals from the appropriate authorities. The contractor is also responsible for obtaining all necessary approvals from the appropriate authorities.

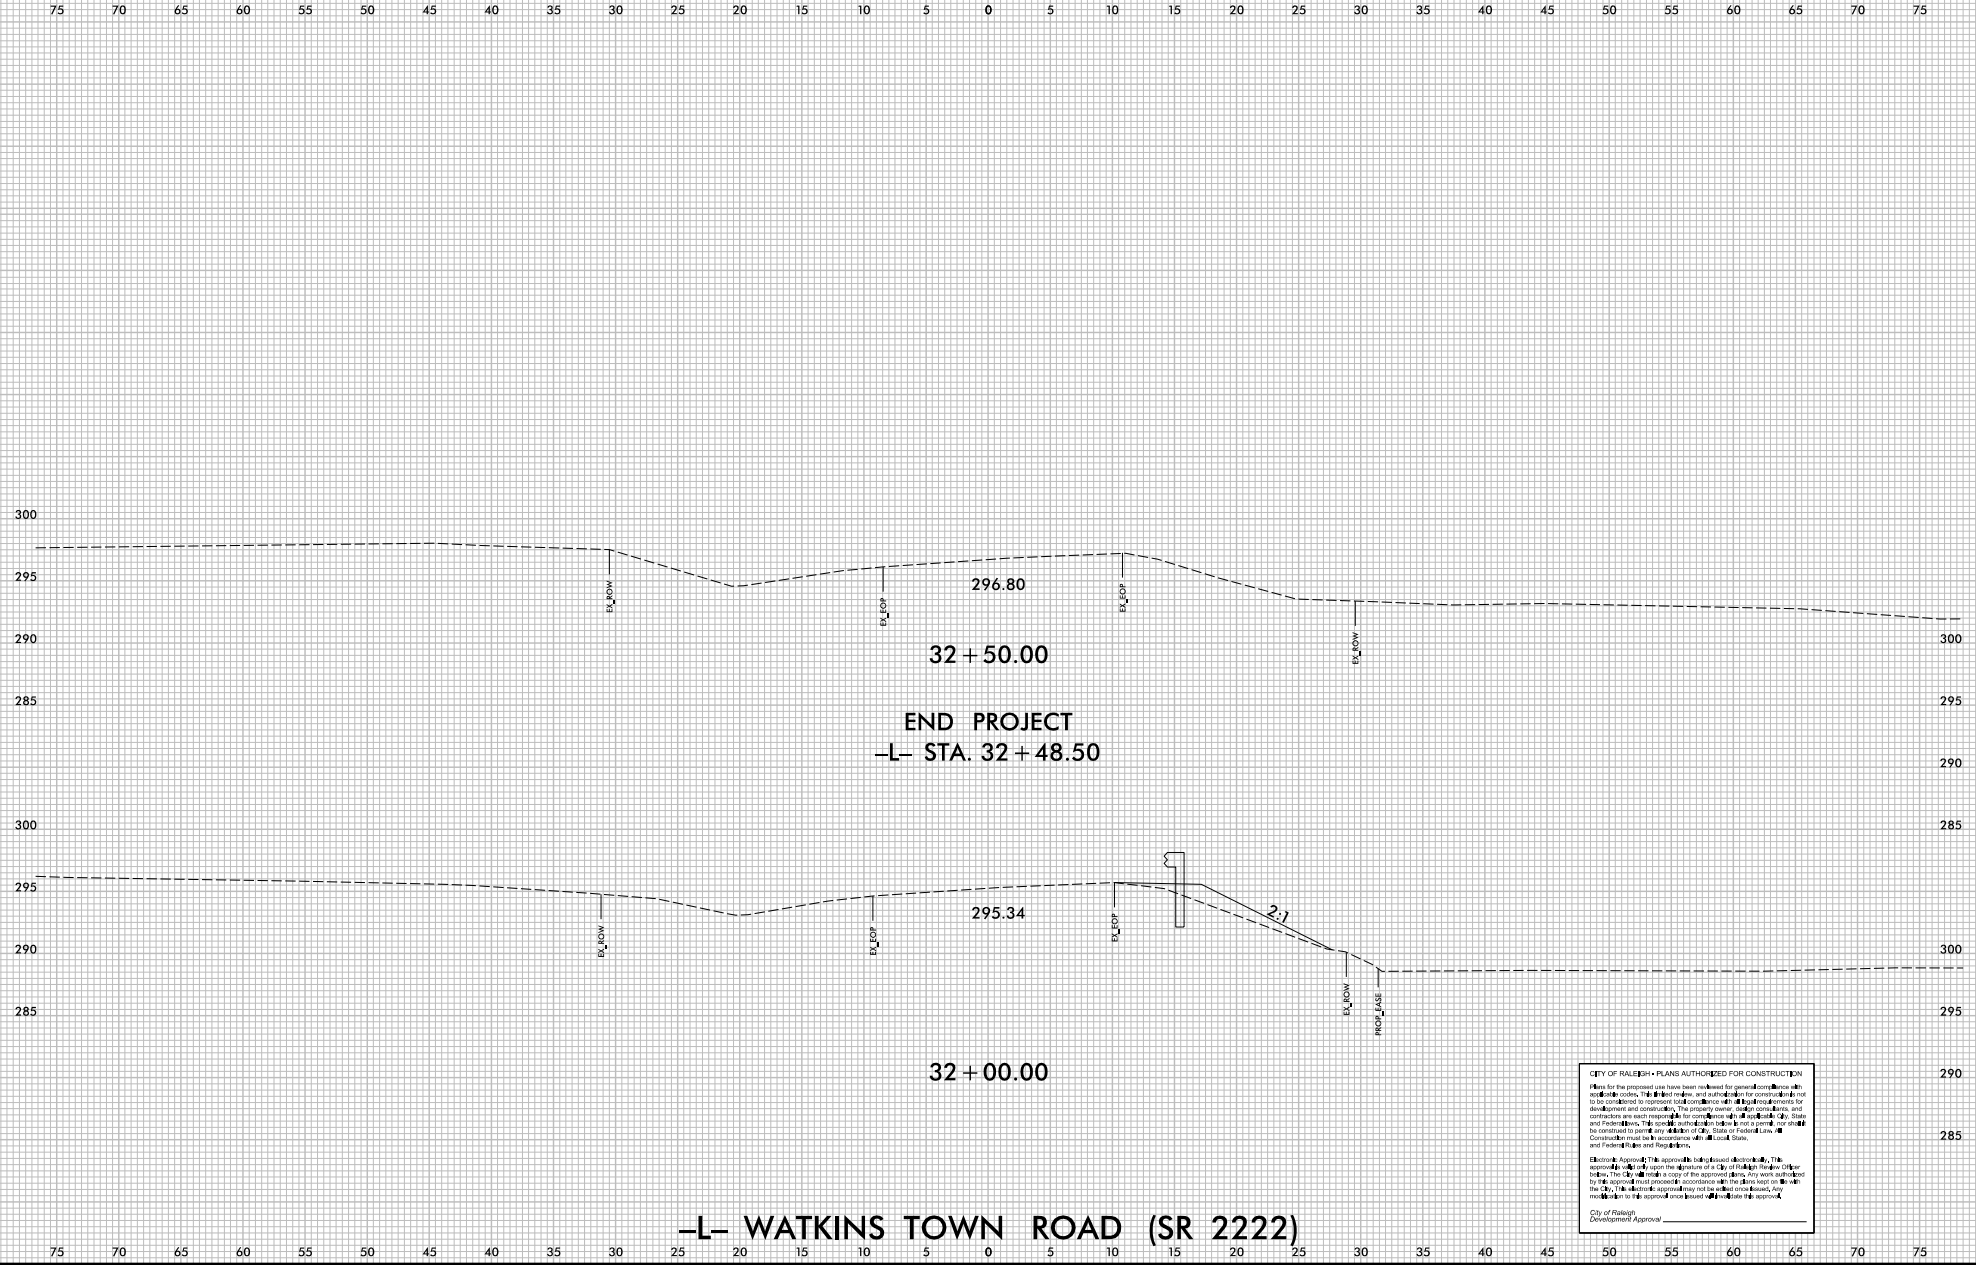
City of Raleigh  
Development Approval



6/23/16

11/9/2022  
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User: m16dram


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	20506	X-14





6/23/16


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User: m.fordham

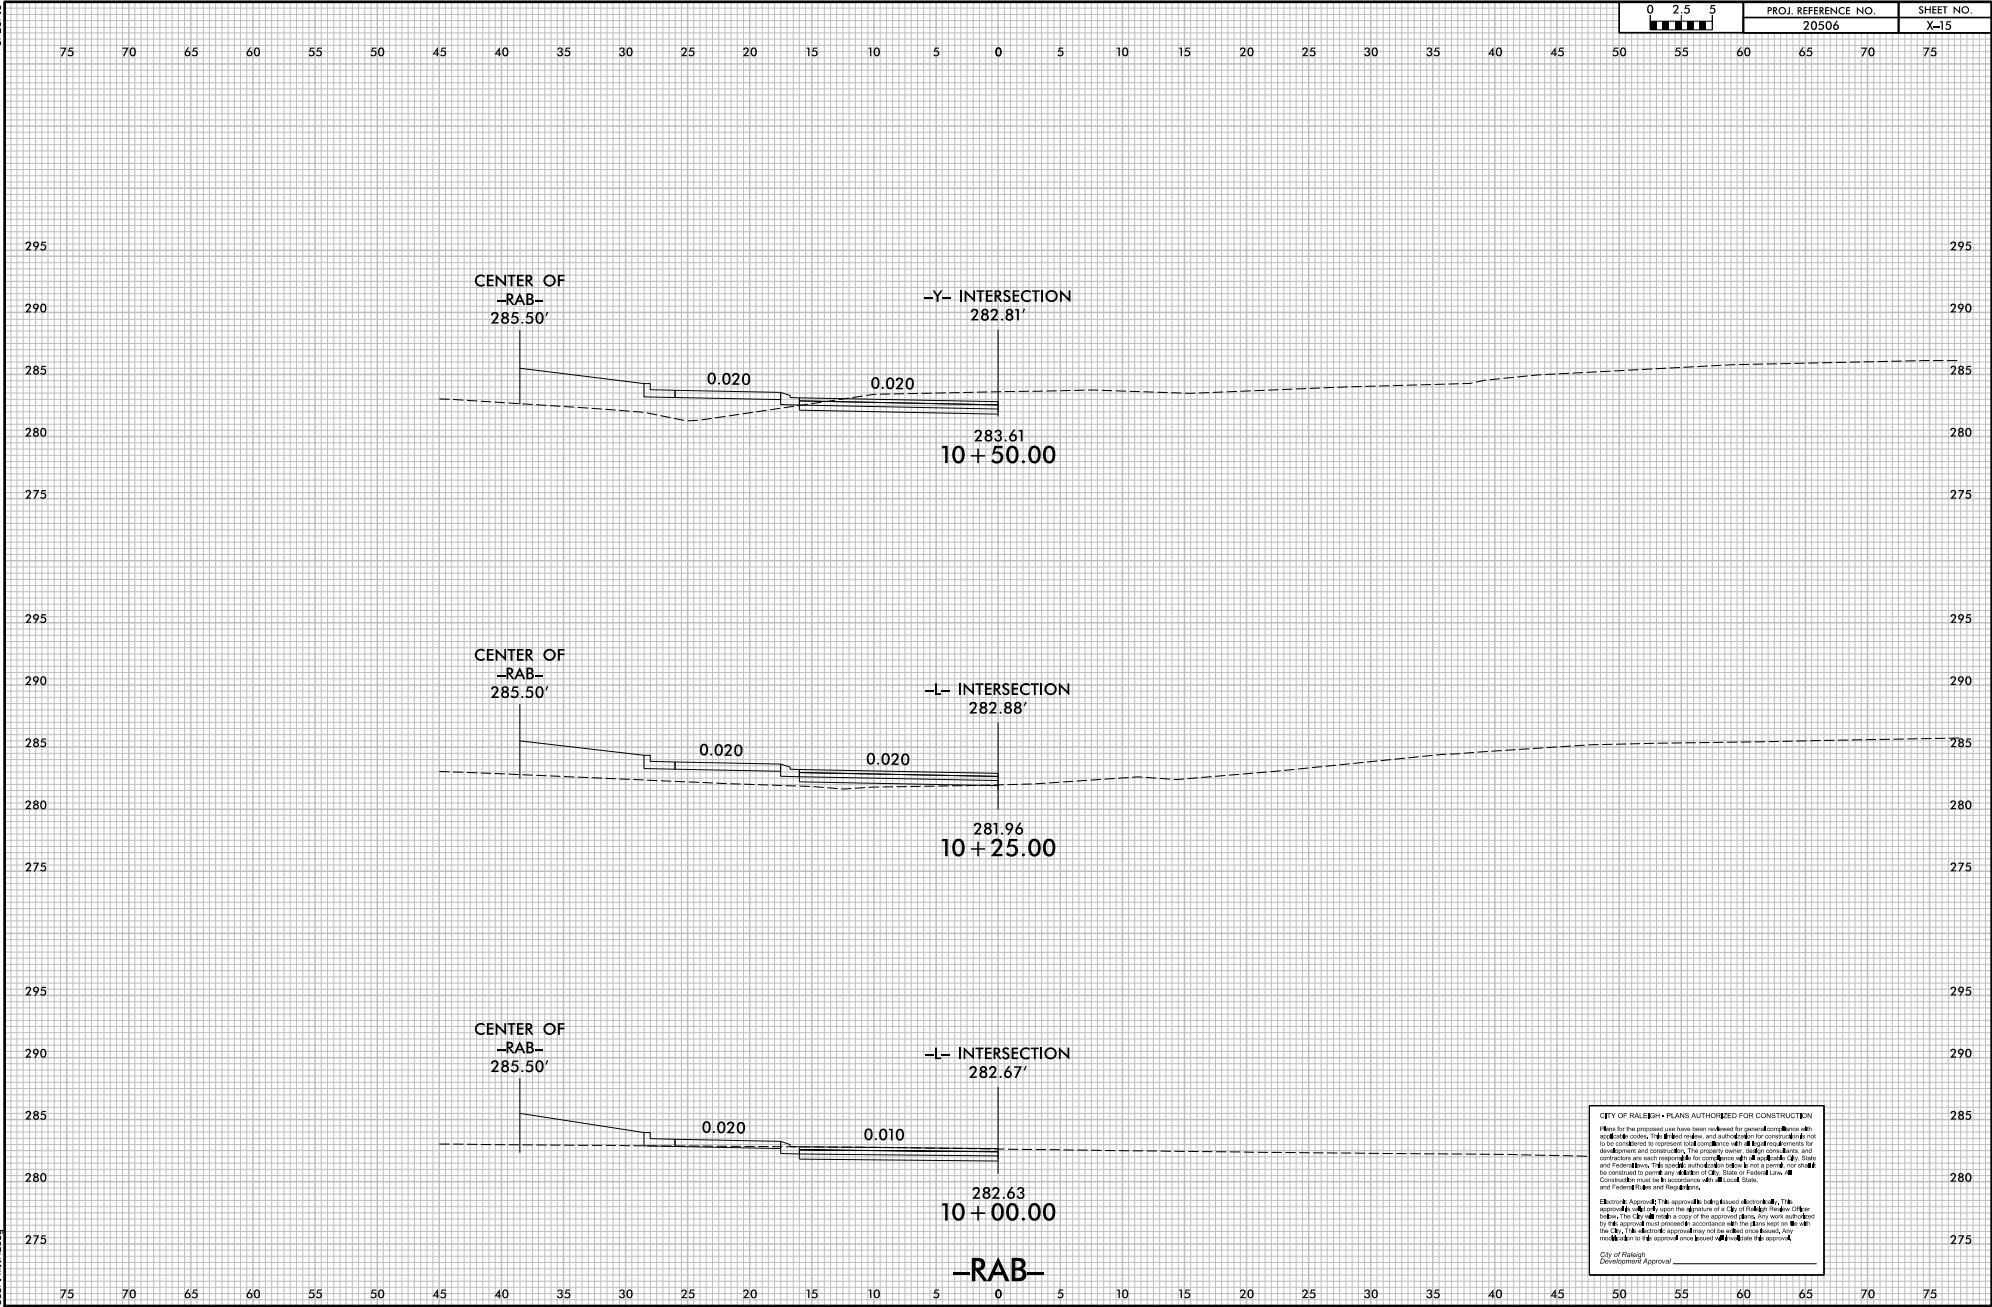



6/23/16

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User: m.fordham

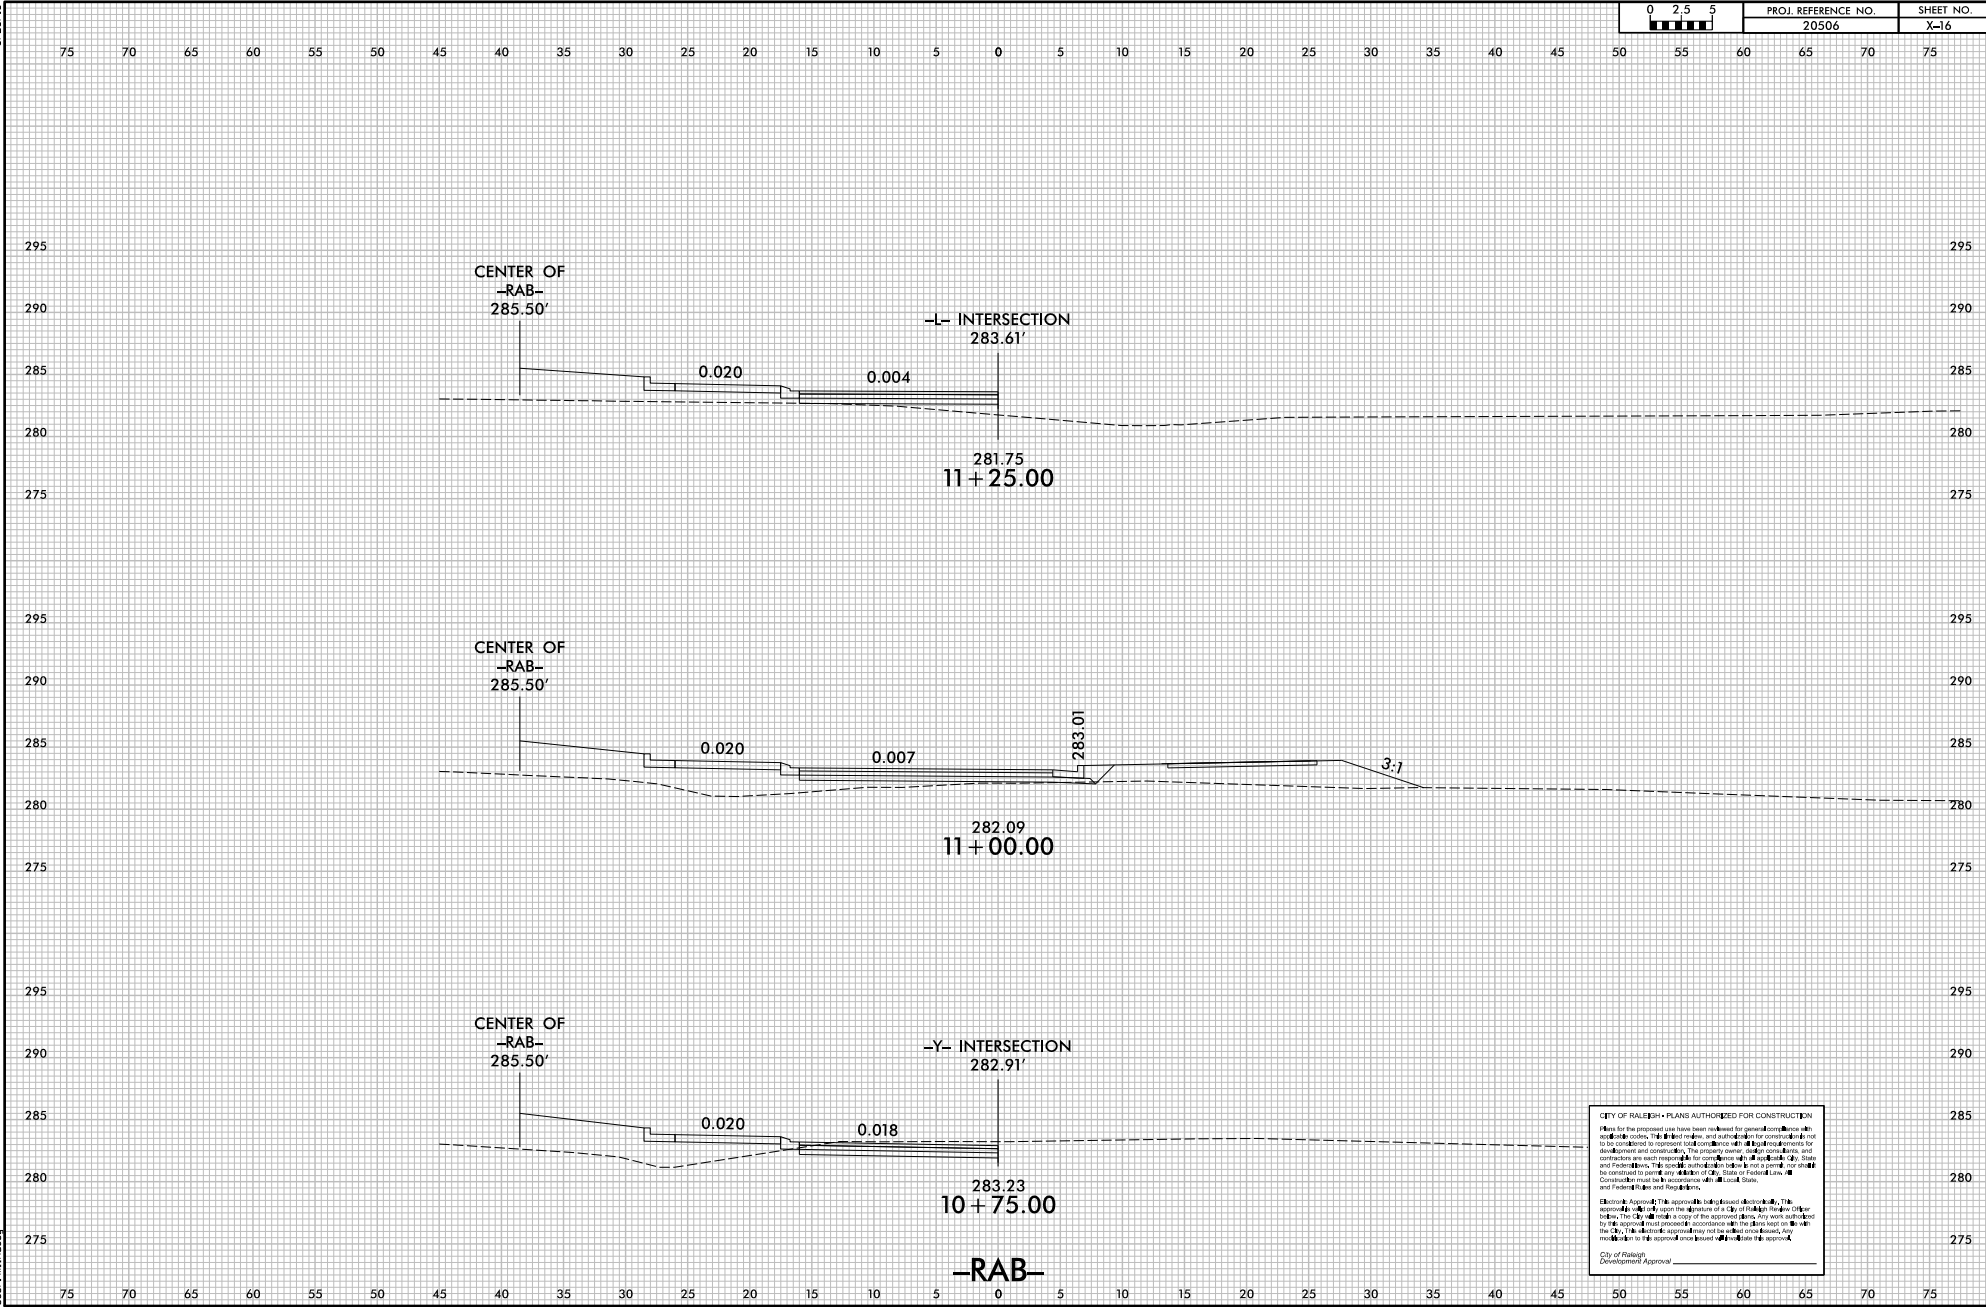

**CITY OF RALEIGH • PLANS AUTHORIZED FOR CONSTRUCTION**

Plans for the proposed use have been reviewed for general compliance with applicable codes, regulations, and standards of the City of Raleigh. The City of Raleigh does not warrant the accuracy or completeness of the information provided herein, nor does it warrant the accuracy or completeness of the information provided by others. The City of Raleigh is not responsible for any errors or omissions in the plans, and the user of the plans is responsible for verifying the accuracy and completeness of the information provided by others. The City of Raleigh is not responsible for any errors or omissions in the plans, and the user of the plans is responsible for verifying the accuracy and completeness of the information provided by others.

Electronic Approval: This approval is not a seal or stamp. It is a digital signature of the City of Raleigh. The City of Raleigh is not responsible for any errors or omissions in the plans, and the user of the plans is responsible for verifying the accuracy and completeness of the information provided by others.

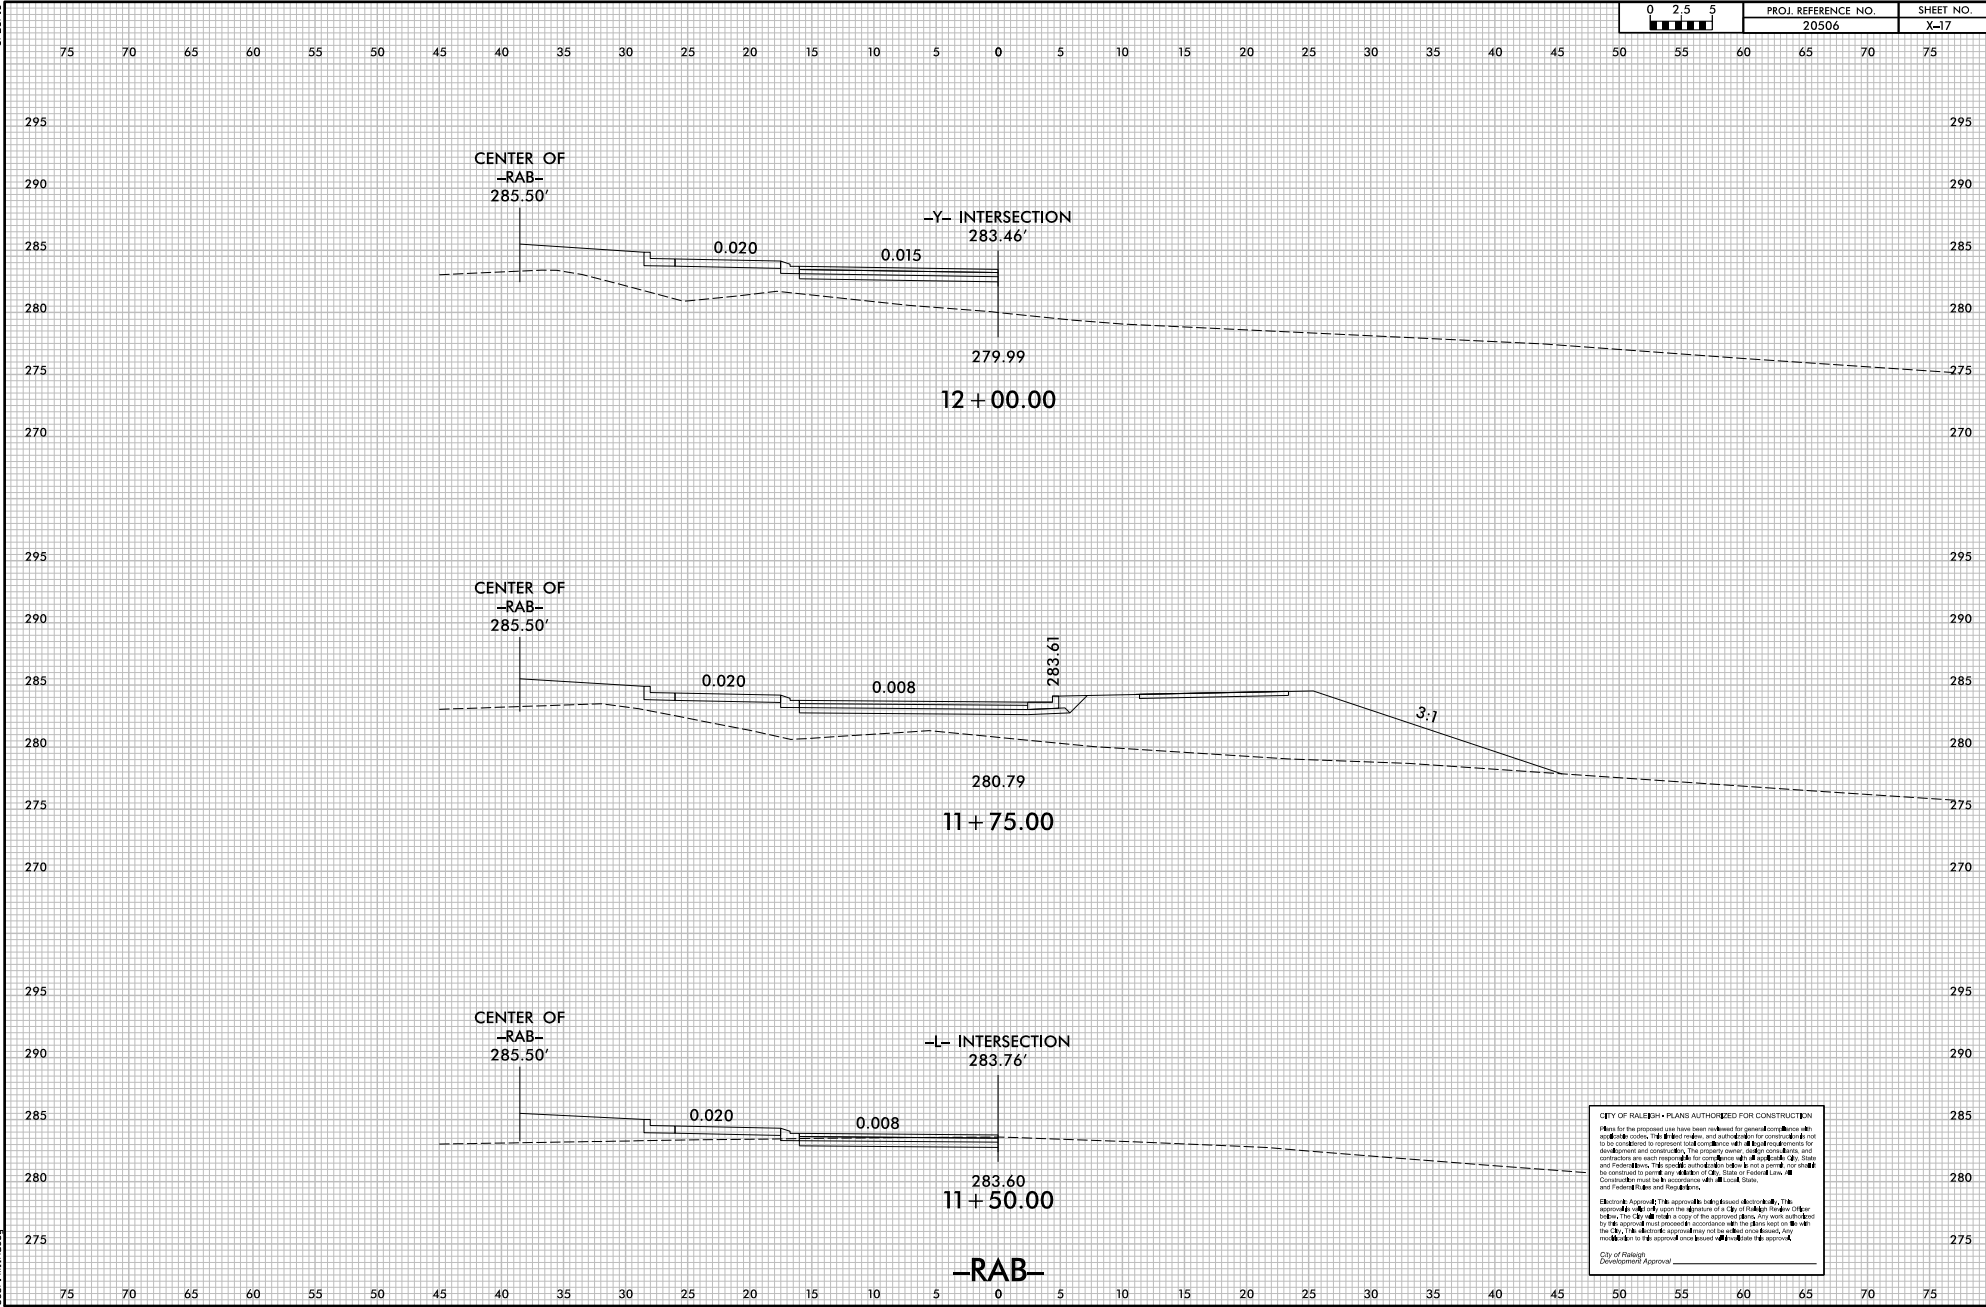
City of Raleigh  
Development Approval



6/23/16

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User: m16d16

0 2.5 5	PROJ. REFERENCE NO.	SHEET NO.
	20506	X-17



**CITY OF RALEIGH • PLANS AUTHORIZED FOR CONSTRUCTION**

Plans for the proposed use have been reviewed for general compliance with applicable codes, ordinances, and regulations. The City of Raleigh is not responsible for the accuracy or completeness of the information provided by the applicant. The applicant is responsible for obtaining all necessary permits and approvals from the appropriate agencies. The City of Raleigh is not responsible for the accuracy or completeness of the information provided by the applicant. The applicant is responsible for obtaining all necessary permits and approvals from the appropriate agencies.

Electronic Approval: This approval is not a physical stamp. The applicant must provide a copy of this approval to the City of Raleigh. The City of Raleigh is not responsible for the accuracy or completeness of the information provided by the applicant. The applicant is responsible for obtaining all necessary permits and approvals from the appropriate agencies.

City of Raleigh  
Development Approval



