#### **Preliminary Subdivision Application**



**Site Review** 

Planning and Development Customer Service Center • One Exchange Plaza, Suite 400 | Raleigh, NC 27601 | 919-996-2500

**INSTRUCTIONS:** This form is used when submitting a Preliminary Subdivision (UDO Section 10.2.5). Please check the appropriate review type and include the plan checklist document. Please email all documents and your preliminary subdivision plans to SiteReview@raleighnc.gov.

		DEVELO	PME	NT OPTIONS	(UDO	Chap	oter 2)		
Convention	al S	Subdivision	Cor	npact Develop	ment		Conse	rvatior	n Development
Cottage	Cou	ırt		Flag lot			Frequent T	ransit [	Development Option
NOTE: Subdivisions m	ay	require City Counci	l appro	oval if located	in a Hi	storic	: Overlay Distric	t.	
			GENE	RAL INFORM	/IATIO	N			
Scoping/sketch plan ca	ase	number(s):							
Development name (s	ubje	ect to approval):							
Property Address(es):									
Recorded Deed PIN(s	):								
Building type(s):		Detached House		Attached Ho	use		Townhouse		Apartment
General Building		Mixed Use Buildin	g	Civic Building	3		Open Lot		Tiny House
			'					•	
CI	JRF	RENT PROPERTY (	OWNE	ER/APPLICAN	NT/DEV	VELC	PER INFORMA	NOITA	
Current Property Own	er(	s) Names:							
Company:				Title:					
Address:									
Phone #:		E	Email:						
Applicant Name (If dif	fere	ent from owner. Se	e "wh	o can apply"	in ins	truct	ions):		
Relationship to owner:		Lessee or contrac	t purch	naser Ow	ner's a	autho	rized agent	Easer	ment holder
Company:		,	Addres	SS:					
Phone #:		E	Email:						
NOTE: please attach p	our	chase agreement o	r con	tract, lease o	r ease	ment	t when submitt	ing th	is form.
Developer Contact Na	me	s:							
Company:				Title:					
Address:									
Phone #:		E	Email:						

DEVEL OD		NT TYPE + CITE DA	TE TABL	C 7	ON.	UNC INFORMATION
	VI E	NT TYPE + SITE DA	IE IABL	E – Z	UN	ING INFORMATION
Gross site acreage:						
Zoning districts (if more than on	e, p	provide acreage of ea	ch):			
Overlay district(s):		Inside City Limits?	Yes	$\square$ N	lo	Historic District/Landmark: N/A
Conditional Use District (CUD) Case # Z-		Board of Adjustment BOA-	Case#			Design Alternate Case # DA-
		STORMWATE	R INFORI	MATIO	NC	
Imperious Area on Parcel(s): Existing (sf)Propose	ed t	otal (sf)	-			for Compliance (includes right-of-way): Proposed total (sf)
		NUMBER OF LC	TS AND	DENS	SIT	Υ
# of Detached House Lots:		# of Attached Hou	use Lots:			# of Townhouse Lots:
# of Tiny House Lots:	#	of Open Lots:				ots (Apartment, General, Civic):
Total # of Lots:	Т	otal # Dwelling Units:				
# of bedroom units (if known): 11	or_	2br	3br		- '	4br
Proposed density for each zoning	ıg c	listrict (UDO 1.5.2.F):				
		APPLICANT SIG	SNATUR	E BLO	OC	К
by the landowner, a lessee or	pe ase	rson holding an option ment holder may also	n or cont	ract to	рι	development approvals may be made urchase or lease land, or an authorized pment approval for such development
	ıd/c	r permit application.	Written pe	ermis	sior	perty owner for the purposes of making on from the property owner to act as an equest.
or one of the persons authorize the application. The undersignapplication are correct and the	zed ned e u	by state law (N.C.G. I also acknowledges t ndersigned understar	S. 160D-4 that the ir nds that d	403(a iforma evelo	)) to atio	s that they are either the property owner to make this application, as specified in and statements made in the ment approvals are subject to revocation pment approval, pursuant to N.C. Gen.
described in this application v	vill	be maintained in all re	espects ir	acco	orda	pplication and that the proposed project ance with the plans and specifications ons of the City of Raleigh Unified
application is placed on hold a the applicant fails to respond of six consecutive months or	at t to o mo	he request of the app comments or provide re, then the application	licant for additiona on review	a peri I infor is dis	iod ma cor	c.G.S. 143-755(b1), if this permit of six consecutive months or more, or if ation requested by the City for a period ntinued, and a new application is ne permit processing is resumed shall
Signature:						Date:
Printed Name: Signature:						Date:
Printed Name:						Date.

# OLDE TOWNE 8-LOT ADDITION

LOT 10 & LOTS 4/5


# OPEN SPACE LOT 924 (OLDE TOWNE LOTS 4 AND 5, BM2022-PG01247 OPEN SPACE LOT 909 (OLDE TOWNE LOT 10, BM2022-PG01497

PROJECT NUMBER: HLE24001

DATE: MAY 22, 2024

<b>Preliminary</b>	Subdivisi	on A	Applicatio	n					DEVELOPI	MENT T
Site Review							[. Doloish		Gross site acreage: 2.04 acres	
Planning and Development Cu	ustomer Service Center	• One Exc	hange Plaza, Suite 400   F	Raleigh, I	NC 27601   919-9	96-2500	Raleigh		Zoning districts (if more than on	e, provid
INSTRUCTIONS: This fo	arm is used when a	ubmittin	a a Droliminary Sub	divinio	n (LIDO Socti	on 10 2	) 5) Places shock th		R-10-CU	
appropriate review type								ie	Overlay district(s): N/A	Insi
subdivision plans to Site	Review@raleighnc	.gov.							Conditional Use District (CUD) Case # Z-	Boa
	DEVE	LOPME	ENT OPTIONS (UDO	) Chap	oter 2)				Cust II Z	100
✓ Conventional	al Subdivision	Co	ompact Development	t	Con	servatio	on Development		Imperious Area on Parcel(s):	
Cottage C	Court		Flag lot		Frequent	Transit	t Development Opti	on	Existing (sf)Propose	ed total (
NOTE: Subdivisions ma	ay require City Coul	ncil app	roval if located in a F	listoric	Overlay Dist	rict.	0.000 6/4		and the second s	,
		GEN	ERAL INFORMATION	NC					# of Detached House Lots: 0	#
Scoping/sketch plan ca	se number(s): N/A								# of Tiny House Lots:	# of Op
Development name (su					ON				O Total # of Later a	0
Property Address(es): 2	2425 Tonoloway	Drive,	5024 Anamosa St	treet					Total # of Lots: 8 # of bedroom units (if known): 1b	Total #
								_	Proposed density for each zonin	
Recorded Deed PIN(s):	1732122141, 17	32054	441							• • • • • • • • • • • • • • • • • • •
Building type(s):	Detached Hous	е	Attached House	V	Townhouse		Apartment			
General Building	Mixed Use Build	ding	Civic Building		Open Lot	=	Tiny House		Pursuant to state law (N.C. G by the landowner, a lessee or	
									agent of the landowner. An ea	asement
CU	RRENT PROPERT	YOWN	IER/APPLICANT/DE	EVELO	PER INFOR	IOITAN	N		as is authorized by the easen	
Current Property Owner	er(s) Names: Eric	Rifkin							Acting as an authorized agen this development approval an	
Company: Olde Towne	WEH LP		Title: Assis	stant \	VP				authorized agent must be ma	
Address: 56 Hunter St	reet, Suite 110, A	pex, N	lorth Carolina 275	502					By submitting this application,	
Phone #: 919.387.188	1870	1	: erifkin@hallecor		es.com			· ·	or one of the persons authorize the application. The undersign	
Applicant Name (If diffe	······			8				-	application are correct and the for false statements or misrep	
Relationship to owner:	22		chaser 🗸 Owner's			TESS	ement holder	-	Stat. § 160D-403(f).	
A CONTRACTOR SECULT AND CONTRACTOR OF THE CONTRA		1				I CARCAGO	t van materia i energia pervenya a	_	The undersigned indicates the	
Company: McAdams C		-	ess: 2905 Meridian		4.55%)	m, NC	27713		described in this application was submitted herewith, and in ac	
Phone #: 919.361.500	0	Emai	: williamson@mca	adams	sco.com				Development Ordinance.	
NOTE: please attach p	urchase agreemer	t or co	ntract, lease or eas	ement	t when subm	itting t	his form.		The undersigned hereby ackr	
Developer Contact Nar	nes: Eric Rifkin								application is placed on hold a the applicant fails to respond	
Company: Olde Towne	WEH LP		Title: Assis	stant \	Vice Preside	ent			of six consecutive months or	more, th
Address: 56 Hunter St	reet, Suite 110. A	pex, N	lorth Carolina 275	02				$\neg$	required to proceed and the dapply to the new application.	ievelopa
Phone #: 919.387.188		1 2	: erifkin@hallecon		es com			_	Signature:	10
				. puili			Revision 03.01.		Printed Name: Nicolas Williamson	n
							raleighnc.		Signature: Printed Name:	

DEVELOR	PME	NT TYPE + SITE DA	TE TABL	E -	ZON	ING	INFORMATION	
Gross site acreage: 2.04 acre	es							
Zoning districts (if more than or	ne, p	rovide acreage of ea	ach):					
R-10-CU								
Overlay district(s): N/A		Inside City Limits?	✓ Yes	П	No	His	toric District/Landmark:	N/A
Conditional Use District (CUD)		Board of Adjustmen		_			sign Alternate Case #	
Case # Z-		BOA-				DA-		
		STORMWATE	R INFOR	MAT	ION			
Imperious Area on Parcel(s):			Impervi	ous	Area	for C	Compliance (includes ri	ght-of-way)
Existing (sf)Propos	sed to	otal (sf)	Existing	j (sf <u>)</u>			Proposed total (sf) _	
		NUMBER OF LO	OTS AND	DE	NSIT	Y		
# of Detached House Lots: ()		# of Attached Ho			NO11		# of Townhouse Lots:	3
# of Tiny House Lots:	# 0	of Open Lots:	1 000	<u> </u>	nor I -		# or rownhouse cols.c	,
0	0				Jse, (			
Total # of Lots: 8	-	tal # Dwelling Units:	72-7				3	
# of bedroom units (if known): 1		2br	3br 8			4br	-	
Proposed density for each zoni		- 07/07/03	1 2 3 3 5 5				,,,,,,,,,,,,,,,,,,,,,,,,,,,,,,,,,,,,,,	
processors • 20000000 season consistentical (2 € 0.0 ±2) 2 ± ± ± ± ± ± ± ± ± ± ± ± ± ± ± ± ±	J	J.	-					
		APPLICANT SIG	GNATUR	FR	OCI	K		
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by the landowner, a lessee of agent of the landowner. An eas is authorized by the easer this development approval a authorized agent must be made a submitting this application or one of the persons author the application. The undersignapplication are correct and the forfalse statements or misre Stat. § 160D-403(f).  The undersigned indicates the described in this application submitted herewith, and in a Development Ordinance.	or pereserved to the control of the	rson holding an option ment holder may also the control of the con	on or conto apply for apply for apply for whitten p of Raleight ant acknows. S. 160D-that the inds that of ecuring the pis aware espects is sions and at to state	tract or de or the ermin n upo owle 4030 nforr deve e de of the n acc	to puvelop proppssion on red dges (a)) to natio lopm evelop mis ap corda ulatio (N.C	perty of from that of the that	owner for the purpose in the property owner to the property owner to the property owner to the this application, as distatements made in approvals are subject to the property owner to the this application, as distatements made in the approval of the City of Raleigh Unit 143-755(b1), if this point approval, if this point the city of Raleigh Unit 143-755(b1), if this point approval to the City of Raleigh Unit 143-755(b1), if this point approval to the City of Raleigh Unit 143-755(b1), if this point approval to the City of Raleigh Unit 143-755(b1), if this point approval to the City of Raleigh Unit 143-755(b1), if this point approval to the City of Raleigh Unit 143-755(b1), if this point approval to the City of Raleigh Unit 143-755(b1), if this point 143-755(b1), if thi	authorized velopment s of making o act as an operty owne specified in the o revocation o N.C. Gen. osed project edifications nified
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**VICINITY MAP** 

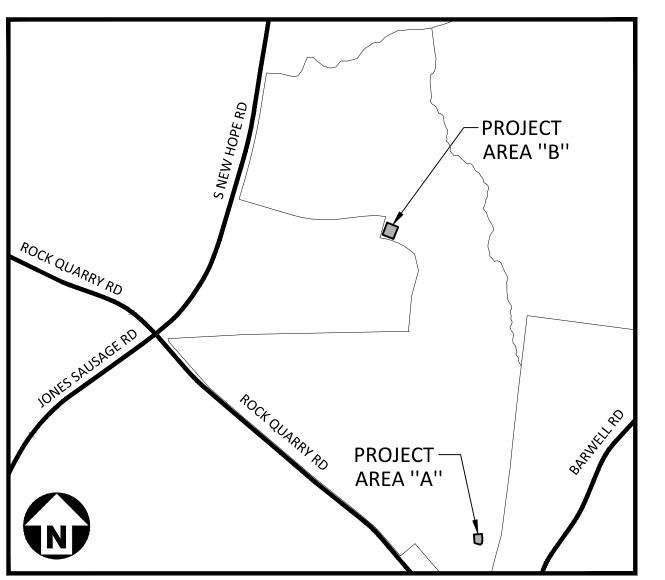1" = 1000'

DWELLING UNITS:	MAXIMUM ALLOWABLE DWELLING UNITS: TOTAL PROPOSED UNITS:	1,700 UNITS
	ASR-0095-2019 (APARTMENTS):	1,700 UNITS 360 UNITS
	SUB-0007-2020 (LOT 2 TOWNHOUSE):	226 UNITS
	SUB-0070-2020 (LOT 4 & 5 TOWNHOUSE):	305 UNITS
	SUB-0071-2020 (LOT 10 TOWNHOUSE):	209 UNITS
	SUB-0045-2021 (PHASE 2 SINGLE-FAMILY):	592 UNITS
	SUB-XXXX-2024 (8-LOT ADDITION TOWNHOUSE):	8 UNITS
OPEN SPACE:	GROSS SITE AREA PER SUBDIVISION CASE #S-21-19:	229.70 AC (LOTS 1-12)
	LESS RIGHT OF WAY DEDICATION:	0.00 AC
	NET SITE AREA:	229.70 AC
	TOTAL REQUIRED OPEN SPACE:	57.46 ACRES (25% NET SITE AREA)
	TOTAL OPEN SPACE PROPOSED:	70.46 AC
	LOT 1 OPEN SPACE:	33.98 AC (100% OF LOT SITE AREA)
	LOT 6,7,8,9,12 OPEN SPACE:	17.50 AC (39% OF PROJECT SITE AREA)
	LOT 4,5 OPEN SPACE:	7.74 AC (16% OF PROJECT SITE AREA)



CONTRACTOR SHALL NOTIFY "NC811" (811) OR (1-800-632-4949) AT LEAST 3 FULL BUSINESS DAYS PRIOR TO BEGINNING CONSTRUCTION OR EXCAVATION TO HAVE EXISTING UTILITIES LOCATED. CONTRACTOR SHALL CONTACT ANY LOCAL UTILITIES THAT PROVIDE THEIR OWN LOCATOR SERVICES INDEPENDENT OF "NC811". REPORT ANY DISCREPANCIES TO THE ENGINEER IMMEDIATELY.

### C4.01

C1.01

C2.00

C2.01

**SHEET INDEX** 

GRADING AND STORM DRAINAGE PLAN UTILITY PLAN **EROSION CONTROL DETAILS** C6.20 NCGO1 DETAILS

**EXISTING CONDITIONS** 

**PROJECT NOTES** 

SITE PLAN

**DEMOLITION PLAN** 

OVERALL SITE PLAN

SITE DETAILS SITE DETAILS **UTILITY DETAILS** LANDSCAPE PLAN

LANDSCAPE NOTES AND DETAILS LIGHTING PERFORMANCE PLAN

SITE DATA	
SITE ADDRESS:	5024 ANAMOSA STREET AND 2426 TONOLOWAY DRIVE, RALEIGH NORTH CAROLINA, 27610
PARCEL PIN NUMBER:	1732054441, 1732122141
LOTS WITHIN OLDE TOWNE SUBDIVISION	LOTS 4 AND 5, LOT 10
EXISTING ZONING:	R-10-CU (RESIDENTIAL - 10 - CONDITIONAL USE)
OVERLAY DISTRICT:	NONE APPLICABLE
BLOCK PERIMETER:	N/A; NO ROADS PROPOSED WITH THIS SITE PLAN, ONLY ADDITION OF LOTS
WATERSHED:	WALNUT CREEK
FLOODPLAIN/FIRM PANEL:	NONE APPLICABLE
SITE AREA:	LOTS 4 AND 5 AREA: 1.381 ACRES LOT 10 AREA: 0.66 ACRES GROSS SITE AREA: 2.04 ACRES
EXISTING USE:	VACANT
PROPOSED USE:	TOWNHOUSE
PROPOSED DWELLING UNITS:	8 UNITS

### ZONING CONDITIONS

SPECIAL CONDITIONS OF SUBDIVISION APPROVA

TCZ-4-2019-ROCK QUARRY ROAD AND SOUTH NEW HOPE ROAD, ON SOUTH NEW HOPE ROAD AT THE NORTHEAST CORNER OF ITS INTERSECTION WITH ROCK QUARRY ROAD, EIGHTEEN (18) PROPERTIES TOTALING APPROXIMATELY 532 ACRES REZONED TO RESIDENTIAL-10-CONDITIONAL USE (R-10-CU). CONDITIONS DATED: SEPTEMBER 9, 2019

. TOTAL NUMBER OF DWELLING UNITS SHALL NOT EXCEED 1,700 UNITS ON THE SUBJECT PROPERTY. THE APARTMENT BUILDING TYPE SHALL NOT BE PERMITTED ON THE SUBJECT PROPERTY EXCEPT THAT UP TO THREE HUNDRED SIXTY (360) DWELLING UNITS LOCATED WITHIN THE APARTMENT BUILDING TYPE SHALL BE PERMITTED WHERE THE APARTMENT BUILDING TYPE IS LOCATED WITHIN TWO THOUSAND FIVE HUNDRED FEET (2500') OF THE RIGHT-OF-WAY FOR ROCK QUARRY ROAD. A MINIMUM OF ONE HUNDRED (100) RESIDENTIAL UNITS. OF ANY UNIT TYPE PERMISSIBLE UNDER THE UNIFIED DEVELOPMENT ORDINANCE, SHALL BE RESTRICTED TO THOSE AGE FIFTY FIVE (55) AND OLDER, IN AT THE TIME OF ISSUANCE OF THE FIRST CERTIFICATE OF OCCUPANCY FOR A DWELLING UNIT, THE PROPERTY OWNER SHALL CREATE AN AREA CONTAINING AT LEAST TWENTY-FIVE (25) ACRES OF LAND IDENTIFIED BY THE PROPERTY OWNER AND LOCATED ON THE SUBJECT PROPERTY

PROPERTY OWNER SHALL ENSURE THE PARK LAND HAS ACCESS FROM A STREET INTERNAL TO THE PROJECT. . THE PROPERTY OWNER SHALL INSTALL GREENWAY TRAILS ON THE SUBJECT PROPERTY GENERALLY AS SHOWN ON THE ATTACHED EXHIBIT B MEETING CITY OF RALEIGH GREEN WAY TRAIL SPECIFICATIONS, TO BE COMPLETED AS FOLLOWS: (A) THE "RED ROUTE" FROM "NODE 1" AT SOUTH NEW HOPE ROAD HEADING EASTWARD ACROSS THE SUBJECT PROPERTY FOR AT LEAST 1500 LINEAR FEET PRIOR TO THE CERTIFICATE OF OCCUPANCY FOR THE CLUBHOUSE FACILITY; (B) THE "GREEN ROUTE" FROM THE TERMINUS OF THE "RED ROUTE" TO "NODE 2" AT BARWELL ROAD WHEN A ROADWAY CONNECTION IS (C) THE "ORANGE ROUTE" FROM "NODE 2" TO "NODE 3" NEAR WALNUT CREEK PRIOR TO THE 1500<sup>TH</sup> CERTIFICATE OF OCCUPANCY.
4. A MINIMUM OF TWENTY-FIVE PERCENT (25%) OF THE NET SITE AREA (SITE AREA EXCLUDING STREET RIGHT-OF-WAY) SHALL BE USED FOR

NEAR THE INTERSECTION OF THE NEW HOPE ROAD AND WALNUT CREEK (THE "PARK LAND") FOR USE AS A PUBLIC OR PRIVATE PARK. THE

PASSIVE AND ACTIVE OPEN SPACE, INCLUDING PUBLIC PARKS, PRIVATE PARKS, PUBLIC GREENWAYS, ENVIRONMENTALLY SENSITIVE AREAS, TREE CONSERVATION AREA, STORMWATER DEVICES AND OTHER OPEN SPACE. 5. FOR PROPERTY DELINEATED BY WAKE COUNTY PIN 1722937105 AND IDENTIFIED AS LOT 5007 ON BOOK OF MAPS 2008, PAGE 280, WAKE COUNTY REGISTRY (THE "PROPERTY"). UNLESS A MORE RESTRICTIVE PROVISION OF THE CITY OF RALEIGH UNIFIED DEVELOPMENT ORDINANCE APPLIES, ONE OR MORE BUILDINGS SHALL BE LOCATED WITHIN ONE HUNDRED FEET (100') OF ROCK QUARRY ROAD OR AT LEAST FIFTY PERCENT (50%) OF THE LENGTH OF THE PROPERTY ALONG ROCK QUARRY ROAD, EXCLUDING PUBLIC STREET RIGHT-OF-WAY FROM LENGTH OF THE

#### ZONING CONDITION RESPONSES

. UNITS WITHIN THIS SUBDIVISION WILL STILL KEEP UNDER 1700 UNITS MAXIMUM (SEE . DEDICATION WILL OCCUR PRIOR TO THE 1ST CO, LOT 1 OF S-21-19 DEED OF TRANSFER IS WITH THE CITY ATTORNEY'S OFFICE . GREENWAY TRAILS SHOWN ON PROPERTY PER THIS REQUIREMENT WITHIN S-21-19, THIS SITE IS NOT SUBJECT TO GREENWAY STANDARDS 5. THIS REQUIREMENT DOES NOT APPLY TO THIS SITE, HAS BEEN MET PER ASR-0095-2019.

#### SOLID WASTE COMPLIANCE STATEMENT:

- THE DEVELOPER ACKNOWLEDGES THAT THEY HAVE REVIEWED AND ARE IN COMPLIANCE WITH THE REQUIREMENTS SET FORTH IN THE SOLID WASTE DESIGN MANUAL.
- THE SOLID WASTE REMOVAL FOR THIS PROJECT WILL BE HANDLED BY THE CITY OF RALEIGH.
- 3. INDIVIDUAL ROLLOUT CARTS WILL BE PROVIDED.

SEE SHEET CO.00 FOR ALL PROJECT, SITE, GRADING, STORM DRAINAGE AND UTILITY NOTES

ALL CONSTRUCTION SHALL BE IN ACCORDANCE WITH THE CURRENT CITY OF RALEIGH AND NCDOT (WHERE APPLICABLE) ENGINEERING DESIGN AND CONSTRUCTION STANDARDS

NO TEMPORARY OR PERMANENT ENCROACHMENTS (INCLUDING BUT NOT LIMITED TO CLEARING, GRADING) FENCING, AND THE INSTALLATION OF RETAINING WALLS OR OTHER STRUCTURES) ARE PERMITTED WITHIN THE GREENWAY EASEMENT AREA WITHOUT PRIOR APPROVAL BY THE CITY OF RALEIGH.

#### ATTENTION CONTRACTORS

The Construction Contractor responsible for the extension of water, sewer, and/or reuse, as approved in these plans, is responsible for contacting the Public Works Department at (919) 996-2409, and the Public Utilities Department at (919) 996-4540 at least twenty four hours prior to beginning any of their construction.

Failure to notify both City Departments in advance of beginning construction, will result in the issuance of monetary fines, and require reinstallation of any water or sewer facilities not inspected as a result of this notification failure.

Failure to call for Inspection, Install a Downstream Plug, have Permitted Plans on the Jobsite, or any other Violation of City of Raleigh Standards will result in a Fine and Possible Exclusion from future work in the City of Raleigh.

PRELIMINARY DRAWING - NOT RELEASED FOR CONSTRUCTION



621 Hillsborough Street

Raleigh, NC 27603

phone 919. 361. 5000 fax 919. 361. 2269 license number: C-0293, C-187

www.mcadamsco.com

#### **CONTACT**

**NICK WILLIAMSON** williamson@mcadamsco.com PHONE: 919. 948. 8064


#### CLIENT

HALLE BUILDING GROUP 56 HUNTER STREET, STE. 110 APEX, NC 27502 ERIC RIFKIN PHONE: 919, 387, 1885



#### PROJECT DIRECTORY

DEVELOPER HALLE BUILDING GROUP 56 HUNTER STREET, SUITE 110 APEX, NORTH CAROLINA, 27502 PHONE: 919. 387. 1885

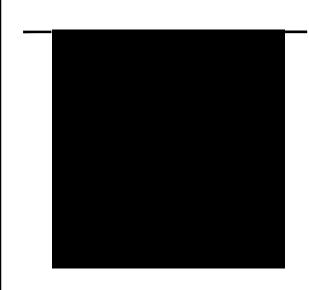

#### **REVISIONS**

**PRELIMINARY SUBDIVISION PLAN FOR:** 

**OLDE TOWNE 8-LOT ADDITION** LOT 10 & LOT 4/5 PROJECT NUMBER: HLE24001

#### SITE PLAN NOTES

- 1. NON-ALLEY LOADED DRIVEWAYS MAY INTERSECT A STREET NO CLOSER THAN 20 FEET FROM THE INTERSECTION OF TWO STREET RIGHT-OF-WAYS. THE MINIMUM CORNER CLEARANCE FROM CURB LINE OR EDGE OF PAVEMENT OF INTERSECTING STREETS SHALL BE AT LEAST 20 FEET FROM THE POINT OF TANGENCY OF THE RADIUS OF CURVATURE, OR 20 FEET FROM THE INTERSECTION OF RIGHT-OF-WAY LINES, WHICH EVER IS GREATER. THE RADIUS OF THE DRIVEWAY SHALL NOT ENCROACH ON THE MINIMUM CORNER CLEARANCE. REFER TO SECTION 6.5 OF THE LATEST VERSION OF THE RALEIGH STREET DESIGN MANUAL FOR ADDITIONAL
- RIGHT-OF-WAY SHALL BE CLEARED AND GRUBBED WITHIN 50' OF ALL MINOR RESIDENTIAL, RESIDENTIAL, AND RESIDENTIAL
  COLLECTOR INTERSECTIONS. THE FULL LENGTH OF THE RIGHT-OF-WAY SHALL BE CLEARED AND GRADED ALONG ALL MAJOR,
  MINOR. & SENSITIVE AREA THOROUGHFARES.
- 3. WITHIN THE AREA DEFINED SIGHT TRIANGLES SHOWN ON THESE PLANS, THERE SHALL BE NO SIGHT OBSTRUCTING OR PARTLY OBSTRUCTING WALL, FENCE, SIGN, FOLIAGE BERMS, OR PARKED VEHICLES BETWEEN THE HEIGHTS OF 24 INCHES AND 8 FEET ABOVE THE CURB LINE ELEVATION OR THE NEAREST TRAVEL WAY IF NO CURB LINE EXISTS. REFER TO SECTION 6.12 OF THE LATEST VERSION OF THE RAI FIGH STREET DESIGN MANUAL FOR ADDITIONAL DETAILS
- MULTIWAY STOP CONTROL WILL NOT BE USED AT ANY PUBLIC STREET INTERSECTION WITHOUT AN ENGINEERING STUDY TO PROVIDE DATA TO CITY OF RALEIGH TRANSPORTATION DIVISION THAT THE MULTIWAY STOP INSTALLATION WARRANTS CAN BE MET AND ORDINANCED BY CITY COUNCIL APPROVAL.
- 5. ALL CONSTRUCTION SHALL CONFORM TO THE LATEST CITY OF RALEIGH AND/OR NCDOT STANDARDS AND SPECIFICATIONS AS
- 6. ALL DIMENSIONS SHOWN ON SITE PLAN ARE MEASURED TO BACK OF CURB UNLESS OTHERWISE NOTED.
- 7. CONTRACTOR SHALL MAINTAIN AN "AS-BUILT" SET OF DRAWINGS TO RECORD THE EXACT LOCATION OF ALL PIPING PRIOR TO CONCEALMENT. DRAWINGS SHALL BE GIVEN TO THE ENGINEER UPON COMPLETION OF THE PROJECT WITH A COPY OF THE TRANSMITTAL LETTER TO THE OWNER.
- 8. EXISTING IMPROVEMENTS DAMAGED DURING CONSTRUCTION SHALL BE REPLACED/RESTORED TO THEIR ORIGINAL CONDITION AND TO THE SATISFACTION OF THE OWNER, BY THE CONTRACTOR RESPONSIBLE FOR THE DAMAGE.
- 9. THE CONTRACTOR SHALL NOTE THAT THE DRAWINGS MAY NOT SHOW EVERY OFFSET, TRANSITION, FITTING, ETC. THAT MAY BE REQUIRED. THE CONTRACTOR SHALL INSTALL SUCH STANDARD APPURTENANCES AS REQUIRED TO CLOSELY FOLLOW THE GRADES AND ALIGNMENTS DEPICTED ON THE PLANS.
- 10. CONTRACTOR SHALL NOTIFY "NC811" (811) OR (1-800-632-4949) AT LEAST 3 FULL BUSINESS DAYS PRIOR TO BEGINNING CONSTRUCTION OR EXCAVATION TO HAVE EXISTING UTILITIES LOCATED. CONTRACTOR SHALL CONTACT ANY LOCAL UTILITIES THAT PROVIDE THEIR OWN LOCATOR SERVICES INDEPENDENT OF "NC811". REPORT ANY DISCREPANCIES TO THE ENGINEER
- 11. CONTRACTOR IS RESPONSIBLE FOR COORDINATING CONSTRUCTION ACTIVITIES WITH THE APPROPRIATE UTILITY COMPANIES FOR ANY REQUIRED RELOCATIONS (I.E. POWER POLES, TELEPHONE PEDESTALS, WATER METERS, ETC.).
- 12. ALL DIMENSIONS AND GRADES SHOWN ON THE PLANS SHALL BE FIELD VERIFIED BY THE CONTRACTOR PRIOR TO CONSTRUCTION. CONTRACTOR SHALL NOTIFY THE ENGINEER IF ANY DISCREPANCIES EXIST PRIOR TO PROCEEDING WITH CONSTRUCTION, FOR NECESSARY PLAN OR GRADE CHANGES. NO EXTRA COMPENSATION SHALL BE PAID TO CONTRACTOR FOR ANY WORK DONE DUE TO DIMENSIONS OR GRADES SHOWN INCORRECTLY ON THESE PLANS IF SUCH NOTIFICATION HAS NOT BEEN GIVEN.
- 13. ACCESSIBLE RAMPS SHALL BE CONSTRUCTED IN ACCORDANCE WITH THE CITY OF RALEIGH UNIFIED DEVELOPMENT ORDINANCE (UDO) DETAILS.
- 14. ALL SIDEWALKS THAT CONNECT TO THE PUBLIC RIGHT-OF-WAY MUST BE ACCESSIBLE TO PERSONS WHO ARE BLIND, HAVE LOW VISION AND PEOPLE WITH MOBILITY DISABILITIES. PEDESTRIAN EXISTING ROUTES AND ALTERNATE PEDESTRIAN ROUTES DURING CONSTRUCTION WILL BE REQUIRED TO BE COMPLIANT WITH THE PUBLIC RIGHTS OF WAY ACCESSIBILITY GUIDELINES (PROWAG), 2010 ADA STANDARDS FOR ACCESSIBLE DESIGN AND THE MANUAL ON UNIFORM TRAFFIC CONTROL DEVICES (MUTCD).
- 15. TYPICAL PAVEMENT SECTION DETAILS ARE SHOWN WITHIN THIS SET AND INTENDED TO BE A MINIMUM PAVEMENT SECTION REQUIREMENT. THE CURRENT GEOTECHNICAL REPORT SHALL OVER-RIDE ALL TYPICAL PAVEMENT SECTIONS SHOWN, IF THE GEOTECHNICAL ENGINEER DEEMS A HEAVIER SECTION IS REQUIRED.
- 16. EQUIPMENT AND PRODUCTS OTHER THAN THOSE SPECIFIED MAY BE USED PROVIDED APPROVAL HAS BEEN OBTAINED FROM THE OWNER IN WRITING PRIOR TO ORDERING OR INSTALLATION. THE CONTRACTOR SHALL WAIVE ANY CLAIM FOR ADDITIONAL COST RELATED TO SUBSTITUTION OF ALTERNATE EQUIPMENT.
- 17. IF UNFORESEEN CONDITIONS DEVELOP DURING CONSTRUCTION, REFER TO THE LATEST VERSION OF THE RALEIGH STREET DESIGN MANUAL AND CONTACT PUBLIC WORKS STAFF FOR FURTHER GUIDANCE.
- 18. ALL SIGNAGE ASSOCIATED WITH THE PUBLIC STREET SYSTEM SHALL ADHERE TO MUTCD STANDARDS AND SPECIFICATIONS.
- 19. ANY TRANSIT STOP LOCATIONS SHOWN ARE PRELIMINARY ONLY. FINAL LOCATION SHALL BE DETERMINED ONCE THE CITY OF RALEIGH TRANSIT ROUTE HAS BEEN FINALIZED. ALL TRANSIT STOPS SHALL HAVE A 10'x20'x6" (3000 PSI) CONCRETE PAD.

#### STORM DRAINAGE NOTES

- 1. ALL STORM DRAINAGE PIPES SHOWN SHALL BE REINFORCED CONCRETE (RCP) (MINIMUM CLASS III) UNLESS NOTED OTHERWISE. CONTRACTOR TO COORDINATE WITH THE GEOTECH TO VERIFY TYPE OF BEDDING REQUIRED BASED ON SOIL CONDITIONS. CONTRACTOR TO SELECT REQUIRED CLASS OF PIPE BASED ON DEPTH OF PIPE AND BEDDING PROVIDED PER THE AMERICAN CONCRETE PIPE ASSOCIATION GUIDELINES.
- 2. ALL STORM DRAINAGE CONSTRUCTION SHALL BE IN ACCORDANCE WITH THE CITY OF RALEIGH STANDARDS.
- 3. ALL CONCRETE SHALL MEET A MINIMUM 3000 PSI COMPRESSIVE STRENGTH.
- 4 ALL PIPE IN STORM DRAIN STRUCTURES SHALL BE STRUCK EVEN WITH INSIDE WALL.
- 5. ALL PIPE JOINTS SHALL BE MADE WITH PREFORMED JOINT SEALER, WHICH CONFORMS TO AASHTO SPECIFICATION M-198 FOR TYPE B FLEXIBLE PLASTIC GASKETS UNLESS OTHERWISE NOTED.
- 6. THE INTERIOR SURFACES OF ALL STORM DRAINAGE STRUCTURES SHALL BE POINTED UP AND SMOOTHED TO AN ACCEPTABLE STANDARD. USING MORTAR MIXED TO MANUFACTURER'S SPECIFICATIONS.
- 7. ALL BACKFILL SHALL BE NON-PLASTIC IN NATURE, FREE FROM ROOTS, VEGETATION MATTER, WASTE CONSTRUCTION MATERIAL OR OTHER OBJECTIONABLE MATERIAL. SAID MATERIAL SHALL BE CAPABLE OF BEING COMPACTED BY MECHANICAL MEANS AND SHALL HAVE NO TENDENCY TO FLOW OR BEHAVE IN A PLASTIC MANNER UNDER THE TAMPING BLOWS OR PROOF ROLLING.
- 8. MATERIALS DEEMED BY THE OWNER'S REPRESENTATIVE OR GEOTECH AS UNSUITABLE FOR BACKFILL PURPOSES SHALL BE REMOVED AND REPLACED WITH SUITABLE MATERIAL.
- 9. BACKFILLING OF TRENCHES SHALL BE ACCOMPLISHED IMMEDIATELY AFTER PIPE IS LAID. THE FILL AROUND THE PIPE SHALL BE THOROUGHLY COMPACTED TO 95 % OF THE MAXIMUM DRY DENSITY OBTAINABLE WITH THE STANDARD PROCTOR TEST. THE TOP EIGHT (8) INCHES SHALL BE COMPACTED TO 100 PERCENT STANDARD PROCTOR.
- 10. UNDER NO CIRCUMSTANCES SHALL WATER BE ALLOWED TO RISE IN UNBACKFILLED TRENCHES AFTER PIPE HAS BEEN PLACED.
- 11. ALL CONCRETE PIPE AND PRECAST STORM STRUCTURES SHALL MEET NCDOT STANDARDS BY MANUFACTURER.
- 12. CONTRACTOR SHALL BE RESPONSIBLE FOR CHECKING ALL PIPE AND STRUCTURES FOR CRACKS OR BREAKS, PRIOR TO INSTALLATION.
  ANY DAMAGED ITEMS SHALL NOT BE INSTALLED.
- 13. "KNOCK-OUT" BOXES OR HDPE PIPE SHALL NOT BE ALLOWED WITHIN PUBLIC RIGHT-OF-WAYS UNLESS APPROVED IN WRITING BY CITY OF RALEIGH STORMWATER DEPARTMENT.

#### CITY OF RALEIGH PUBLIC UTILITIES

DIP MATERIAL IS SPECIFIED FOR SANITARY SEWER.

#### STANDARD UTILITY NOTES (AS APPLICABLE)

- 1. ALL MATERIALS & CONSTRUCTION METHODS SHALL BE IN ACCORDANCE WITH CITY OF RALEIGH DESIGN STANDARDS, DETAILS & SPECIFICATIONS (REFERENCE: CORPUD HANDBOOK, CURRENT EDITION).
- 2. UTILITY SEPARATION REQUIREMENTS:
- a) A DISTANCE OF 100' SHALL BE MAINTAINED BETWEEN SANITARY SEWER & ANY PRIVATE OR PUBLIC WATER SUPPLY SOURCE SUCH AS AN IMPOUNDED RESERVOIR USED AS A SOURCE OF DRINKING WATER. IF ADEQUATE LATERAL SEPARATION CANNOT BE ACHIEVED, FERROUS SANITARY SEWER PIPE SHALL BE SPECIFIED & INSTALLED TO WATERLINE SPECIFICATIONS. HOWEVER, THE MINIMUM SEPARATION SHALL NOT BE LESS THAN 25' FROM A PRIVATE WELL OR 50' FROM A PUBLIC WELL.
- b) WHEN INSTALLING WATER &/OR SEWER MAINS, THE HORIZONTAL SEPARATION BETWEEN UTILITIES SHALL BE 10'. IF THIS SEPARATION CANNOT BE MAINTAINED DUE TO EXISTING CONDITIONS, THE VARIATION ALLOWED IS THE WATER MAIN IN A SEPARATE TRENCH WITH THE ELEVATION OF THE WATER MAIN AT LEAST 18" ABOVE THE TOP OF THE SEWER & MUST BE APPROVED BY THE PUBLIC UTILITIES DIRECTOR. ALL DISTANCES ARE MEASURED FROM OUTSIDE DIAMETER
- c) WHERE IT IS IMPOSSIBLE TO OBTAIN PROPER SEPARATION, OR ANYTIME A SANITARY SEWER PASSES OVER A WATERMAIN, DIP MATERIALS OR STEEL ENCASEMENT EXTENDED 10' ON EACH SIDE OF CROSSING MUST BE SPECIFIED & INSTALLED TO WATERLINE SPECIFICATIONS.
- d) 5.0' MINIMUM HORIZONTAL SEPARATION IS REQUIRED BETWEEN ALL SANITARY SEWER & STORM SEWER FACILITIES, UNLESS
- e) MAINTAIN 18" MIN. VERTICAL SEPARATION AT ALL WATERMAIN & RCP STORM DRAIN CROSSINGS; MAINTAIN 24" MIN. VERTICAL SEPARATION AT ALL SANITARY SEWER & RCP STORM DRAIN CROSSINGS. WHERE ADEQUATE SEPARATIONS CANNOT BE ACHIEVED, SPECIFY DIP MATERIALS & A CONCRETE CRADLE HAVING 6" MIN. CLEARANCE (PER CORPUD DETAILS W. 41.8.5.40)
- f) ALL OTHER UNDERGROUND UTILITIES SHALL CROSS WATER & SEWER FACILITIES WITH 18" MIN. VERTICAL SEPARATION REQUIRED.
- 3. ANY NECESSARY FIELD REVISIONS ARE SUBJECT TO REVIEW & APPROVAL OF AN AMENDED PLAN &/OR PROFILE BY THE CITY OF RALEIGH PUBLIC UTILITIES DEPARTMENT PRIOR TO CONSTRUCTION.
- 4. CONTRACTOR SHALL MAINTAIN CONTINUOUS WATER & SEWER SERVICE TO EXISTING RESIDENCES & BUSINESSES THROUGHOUT CONSTRUCTION OF PROJECT. ANY NECESSARY SERVICE INTERRUPTIONS SHALL BE PRECEDED BY A 24 HOUR ADVANCE NOTICE TO THE CITY OF RALEIGH PUBLIC UTILITIES DEPARTMENT.
- 5. 3.0' MINIMUM COVER IS REQUIRED ON ALL WATER MAINS & SEWER FORCEMAINS. 4.0' MINIMUM COVER IS REQUIRED ON ALL REUSE MAINS.
- 6. IT IS THE DEVELOPER'S RESPONSIBILITY TO ABANDON OR REMOVE EXISTING WATER & SEWER SERVICES NOT BEING USED IN REDEVELOPMENT OF A SITE UNLESS OTHERWISE DIRECTED BY THE CITY OF RALEIGH PUBLIC UTILITIES DEPARTMENT. THIS INCLUDES ABANDONING TAP AT MAIN & REMOVAL OF SERVICE FROM ROW OR EASEMENT PER CORPUD HANDBOOK PROCEDURE.
- 7. INSTALL 3/4" COPPER WATER SERVICES WITH METERS LOCATED AT ROW OR WITHIN A 2'X2' WATERLINE EASEMENT IMMEDIATELY ADJACENT. NOTE: IT IS THE APPLICANT'S RESPONSIBILITY TO PROPERLY SIZE THE WATER SERVICE FOR EACH CONNECTION TO PROVIDE ADEQUATE FLOW & PRESSURE.
- INSTALL 4" SEWER SERVICES @ 1.0% MINIMUM GRADE WITH CLEANOUTS LOCATED AT ROW OR EASEMENT LINE & SPACED EVERY 75 LINEAR FEET MAXIMUM.
- 24. PRESSURE REDUCING VALVES ARE REQUIRED ON ALL WATER SERVICES EXCEEDING 80 PSI. WHERE SANITARY SERVICES ARE SERVING A BUILDING INSTALLED ON A FLOOR WITH A FINISHED FLOOR ELEVATION BELOW THE ELEVATION OF THE MANHOLE COVER OF THE NEXT UPSTREAM MANHOLE IN THE PUBLIC SEWER, SUCH FIXTURES SHALL BE PROTECTED BY A BACKWATER VALVE INSTALLED IN THE SERVICE LINE. SANITARY SERVICES SERVING A BUILDING WITH A FINISHED FLOOR ELEVATION ABOVE THE ELEVATION OF THE MANHOLE COVER OF THE NEXT UPSTREAM MANHOLE IN THE PUBLIC SEWER SHALL NOT DISCHARGE THROUGH A BACKWATER VALVE.
- 25. ALL ENVIRONMENTAL PERMITS APPLICABLE TO THE PROJECT MUST BE OBTAINED FROM NCDWQ, USACE &/OR FEMA FOR ANY RIPARIAN BUFFER, WETLAND &/OR FLOODPLAIN IMPACTS (RESPECTIVELY) PRIOR TO CONSTRUCTION.
- 26. NCDOT / RAILROAD ENCROACHMENT AGREEMENTS ARE REQUIRED FOR ANY UTILITY WORK (INCLUDING MAIN EXTENSIONS & SERVICE TAPS) WITHIN STATE OR RAILROAD ROW PRIOR TO CONSTRUCTION.
- 27. GREASE INTERCEPTOR / OIL WATER SEPARATOR SIZING CALCULATIONS & INSTALLATION SPECIFICATIONS SHALL BE APPROVED BY THE CORPUD FOG PROGRAM COORDINATOR PRIOR TO ISSUANCE OF A BUILDING PERMIT. CONTACT STEPHEN CALVERLEY AT (919) 296-2334 OR STEPHEN.CALVERLEY@RALEIGHNC.GOV FOR MORE INFORMATION.
- 28. CROSS-CONNECTION CONTROL PROTECTION DEVICES ARE REQUIRED BASED ON DEGREE OF HEALTH HAZARD INVOLVED AS LISTED IN APPENDIX-B OF THE RULES GOVERNING PUBLIC WATER SYSTEMS IN NORTH CAROLINA. THESE GUIDELINES ARE THE MINIMUM REQUIREMENTS. THE DEVICES SHALL MEET AMERICAN SOCIETY OF SANITARY ENGINEERING (ASSE) STANDARDS OR BE ON THE UNIVERSITY OF SOUTHERN CALIFORNIA APPROVAL LIST. THE DEVICES SHALL BE INSTALLED AND TESTED (BOTH INITIAL AND PERIODIC TESTING THEREAFTER) IN ACCORDANCE WITH THE MANUFACTURER'S RECOMMENDATIONS OR THE LOCAL CROSS-CONNECTION CONTROL PROGRAM, WHICHEVER IS MORE STRINGENT. CONTACT JOANIE HARTLEY AT (919) 996-5923 OR JOANIE.HARTLEY@RALEIGHNC.GOV FOR MORE INFORMATION.

#### **GRADING NOTES**

- 1. ALL DIMENSIONS AND GRADES SHOWN ON THE PLANS SHALL BE FIELD VERIFIED BY THE CONTRACTOR PRIOR TO CONSTRUCTION. CONTRACTOR SHALL NOTIFY THE ENGINEER IF ANY DISCREPANCIES EXIST PRIOR TO PROCEEDING WITH CONSTRUCTION, FOR NECESSARY PLAN OR GRADE CHANGES. NO EXTRA COMPENSATION SHALL BE PAID TO THE CONTRACTOR FOR ANY WORK DONE DUE TO DIMENSIONS OR GRADES SHOWN INCORRECTLY ON THESE PLANS IF SUCH NOTIFICATION HAS NOT BEEN GIVEN.
- OCCUPATIONAL SAFETY AND HEALTH ADMINISTRATION (OSHA) STANDARDS FOR EXCAVATIONS; FINAL RULE 29CFR PART 1926, SUBPART "P" APPLIES TO ALL EXCAVATIONS EXCEEDING FIVE (5) FEET IN DEPTH. EXCAVATION EXCEEDING TWENTY (20) FEET IN DEPTH REQUIRES THE DESIGN OF A TRENCH SAFETY SYSTEM BY A REGISTERED PROFESSIONAL ENGINEER, PROVIDED BY CONTRACTOR RESPONSIBLE FOR EXCAVATION.
- 3. ALL CONSTRUCTION SHALL BE IN ACCORDANCE WITH THE CITY OF RALEIGH AND/OR NCDOT STANDARDS AND SPECIFICATIONS AS APPLICABLE.
- 4. CONTRACTOR SHALL NOTIFY "NC811" (811) OR (1-800-632-4949) AT LEAST 3 FULL BUSINESS DAYS PRIOR TO BEGINNING CONSTRUCTION OR EXCAVATION TO HAVE EXISTING UTILITIES LOCATED. CONTRACTOR SHALL CONTACT ANY LOCAL UTILITIES THAT PROVIDE THEIR OWN LOCATOR SERVICES INDEPENDENT OF "NC811". REPORT ANY DISCREPANCIES TO THE ENGINEER IMMEDIATELY.
- 5. CONSTRUCTION, MAINTENANCE AND REMOVAL OF ALL EROSION CONTROL DEVICES ARE THE RESPONSIBILITY OF THE GENERAL CONTRACTOR. TIMING OF REMOVAL SHALL BE COORDINATED WITH THE EROSION CONTROL INSPECTOR.
- 6. EXISTING UTILITIES AND STRUCTURES SHOWN, BOTH UNDERGROUND AND ABOVE GROUND, ARE BASED ON A FIELD SURVEY AND THE BEST AVAILABLE RECORD DRAWINGS. THE CONTRACTOR SHALL VERIFY FIELD CONDITIONS PRIOR TO BEGINNING RELATED CONSTRUCTION. ANY DISCREPANCIES SHALL BE REPORTED TO THE ENGINEER IMMEDIATELY.
- 7. SOIL UNDER BUILDINGS, PAVED AREAS AND WITHIN SLOPES GREATER THAN 3:1 (H:V) SHALL BE APPROVED, PLACED AND COMPACTED AS RECOMMENDED BY THE GEOTECHNICAL ENGINEER.

#### **RETAINING WALL NOTES**

- 1. THE RETAINING WALL ALIGNMENT SHOWN ON THESE PLANS DEPICTS THE LOCATION OF THE FRONT FACE OF THE RETAINING WALL AT THE TOP OF THE WALL. THE CONTRACTOR IS RESPONSIBLE FOR ENSURING RETAINING WALLS ARE NOT LOCATED IN ANY STREAM BUFFERS, AND THEIR CONSTRUCTION DOES NOT ENCROACH INTO ANY ADJACENT PROPERTIES DUE TO ANY BATTER INCORPORATED IN THE DESIGN OF THE WALLS.
- RETAINING WALLS ARE TO BE DESIGN-BUILD PROJECTS BY THE CONTRACTOR. IT SHALL BE THE CONTRACTOR'S RESPONSIBILITY TO
  OBTAIN FINAL CONSTRUCTION DRAWINGS FROM A REGISTERED ENGINEER AND GAIN ALL REQUIRED PERMITS NECESSARY FOR
  THE CONSTRUCTION OF THE RETAINING WALLS.
- 3. RETAINING WALLS SHALL BE ASSUMED TO BE BACKFILLED WITH OFF-SITE BORROW MATERIAL OR PROCESSED FILL, UNLESS THE CONTRACTOR CAN PROVIDE TO THE OWNER WITH CONFIRMATION FROM THE GEOTECHNICAL ENGINEER AND THE RETAINING WALL DESIGNER, THAT READILY AVAILABLE ON-SITE SOILS CAN BE USED.
- 4. THE TOP AND BOTTOM OF WALL ELEVATIONS SHOWN ON THESE PLANS IDENTIFY FINISHED GRADE ELEVATIONS ONLY. THE EXTENT THAT THE RETAINING WALL WILL BE EXTENDED BELOW GRADE TO THE FOOTING OR ABOVE GRADE TO THE TOP OF THE CAP BLOCK COURSE SHALL BE IDENTIFIED ON THE RETAINING WALL CONSTRUCTION DRAWINGS.
- 5. ALL RETAINING WALLS OVER 30" HIGH SHALL HAVE A SAFETY FENCE (DESIGN BY OTHERS).
- 6. ANY PART OF ANY RETAINING WALL THAT EXTENDS INTO THE RIGHT-OF-WAY WILL REQUIRE AN ENCROACHMENT AGREEMENT. ENCROACHMENT AGREEMENTS FOR RETAINING WALLS SHALL BE APPROVED PRIOR TO CONSTRUCTION DRAWING APPROVAL.
- 7. ANY TIEBACK SYSTEMS FOR THE RETAINING WALLS SHALL NOT BE ALLOWED WITHIN PUBLIC RIGHT-OF-WAY.
- 8. STORMWATER RUN-OFF SHALL BE DIRECTED AWAY FROM RETAINING WALLS. ANY RUN-OFF FLOWING TO AND OVER A RETAINING WALL SHALL BE KEPT TO AN ABSOLUTE MINIMUM AND BROUGHT TO THE ATTENTION OF THE WALL DESIGNER PRIOR TO THEIR DESIGN.

#### TRAFFIC CONTROL NOTES

- 1. THE CONTRACTOR SHALL CONDUCT ALL WORK IN A SAFE MANNER AND WITH A MINIMUM AMOUNT OF INCONVENIENCE TO
- 2. THE CONTRACTOR SHALL BE RESPONSIBLE FOR ALL TRAFFIC CONTROL AND SHALL ADHERE TO THE PROVISIONS OF THE MUTCD (MOST CURRENT EDITION).
- 3. NO WORK ON, OR BLOCKAGE OF, EXISTING THROUGH TRAFFIC LANES SHALL OCCUR DURING THE PEAK TRAFFIC HOURS OF 7AM-9AM AND 4PM-6PM, MONDAY THROUGH FRIDAY. THE CONTRACTOR MUST OBTAIN A LANE CLOSURE PERMIT FOR ANY WORK WHICH REQUIRES THE CLOSURE OF A TRAVEL LANE. PLEASE CONTACT THE CITY PUBLIC WORKS DEPARTMENT TRANSPORTATION OPERATIONS DIVISION AT (919)-996-3030 FOR LANE CLOSURES AT LEAST 48 HOURS IN ADVANCE AND FOR STREET CLOSURES, AT LEAST 2 WEEKS IN ADVANCE. PROVIDE EXACT LOCATION, CROSS STREET, DATES FOR LANE CLOSURE,
- 4. THE CONTRACTOR SHALL BE RESPONSIBLE FOR CONTACTING THE INSPECTIONS DEPARTMENT TO OBTAIN A STREET CUT PERMIT. THE PERMIT FORM IS ON-LINE (RALEIGH.GOV) AND SHALL BE COMPLETED AND FAXED TO (919)-516-2685. THE PERMIT LASTS FOR 30 DAYS AND CAN BE EXTENDED AT NO COST IF REQUEST IS MADE PRIOR TO PERMITS EXPIRATION DATE. INQUIRIES SHALL BE MADE AT (919)-996-2430.
- 5. PRIOR TO CONSTRUCTION BEGINNING, ALL SIGNAGE AND TRAFFIC CONTROL SHALL BE IN PLACE.
- 6. THE CONTRACTOR SHALL HAVE A COMPLETE SET OF CONTRACT DOCUMENTS AS WELL AS ALL PERMITS, APPROVALS AND EASEMENTS ON THE JOB SITE AT ALL TIMES.
- 7. THE CONTRACTOR SHALL REPAIR ALL DAMAGED DRIVEWAYS, DRIVEWAY PIPES, CURB AND GUTTER, SIDEWALKS AND STREETS TO EXISTING CONDITION OR BETTER.
- 8. ALL SIDEWALKS MUST BE ACCESSIBLE TO PERSONS WHO ARE BLIND, HAVE LOW VISION AND PEOPLE WITH MOBILITY DISABILITIES. EXISTING PEDESTRIAN ROUTES AND ALTERNATE PEDESTRIAN ROUTES DURING CONSTRUCTION WILL BE REQUIRED TO BE COMPLIANT WITH THE PUBLIC RIGHTS OF WAY ACCESSIBILITY GUIDELINES (PROWAG), 2010 ADA STANDARDS FOR ACCESSIBLE DESIGN AND THE MANUAL ON UNIFORM TRAFFIC CONTROL DEVICES (MUTCD).



### McAdams

The John R. McAdams Company, In 621 Hillsborough Street Suite 500 Raleigh, NC 27603

phone 919. 361. 5000 fax 919. 361. 2269 license number: C-0293, C-187

www.mcadamsco.com

#### CLIENT

HALLE BUILDING GROUP 56 HUNTER STREET, STE. 110 APEX, NC 27502 PHONE: 919. 387. 1885



# NA NA

RELIMINARY SUBDIVISION PI LOT 10 AND LOTS 4/5 RALEIGH, NORTH CAROLINA, 27610



#### REVISIONS

NO. DATE

#### PLAN INFORMATION

PROJECT NO. HLE24001

FILENAME HLE24001-N1

CHECKED BY JCM

DRAWN BY CHB

SCALE 1"=30'

DATE 05. 22. 2024

PRELIMINARY DRAWING - NOT RELEASED FOR CONSTRUCTION


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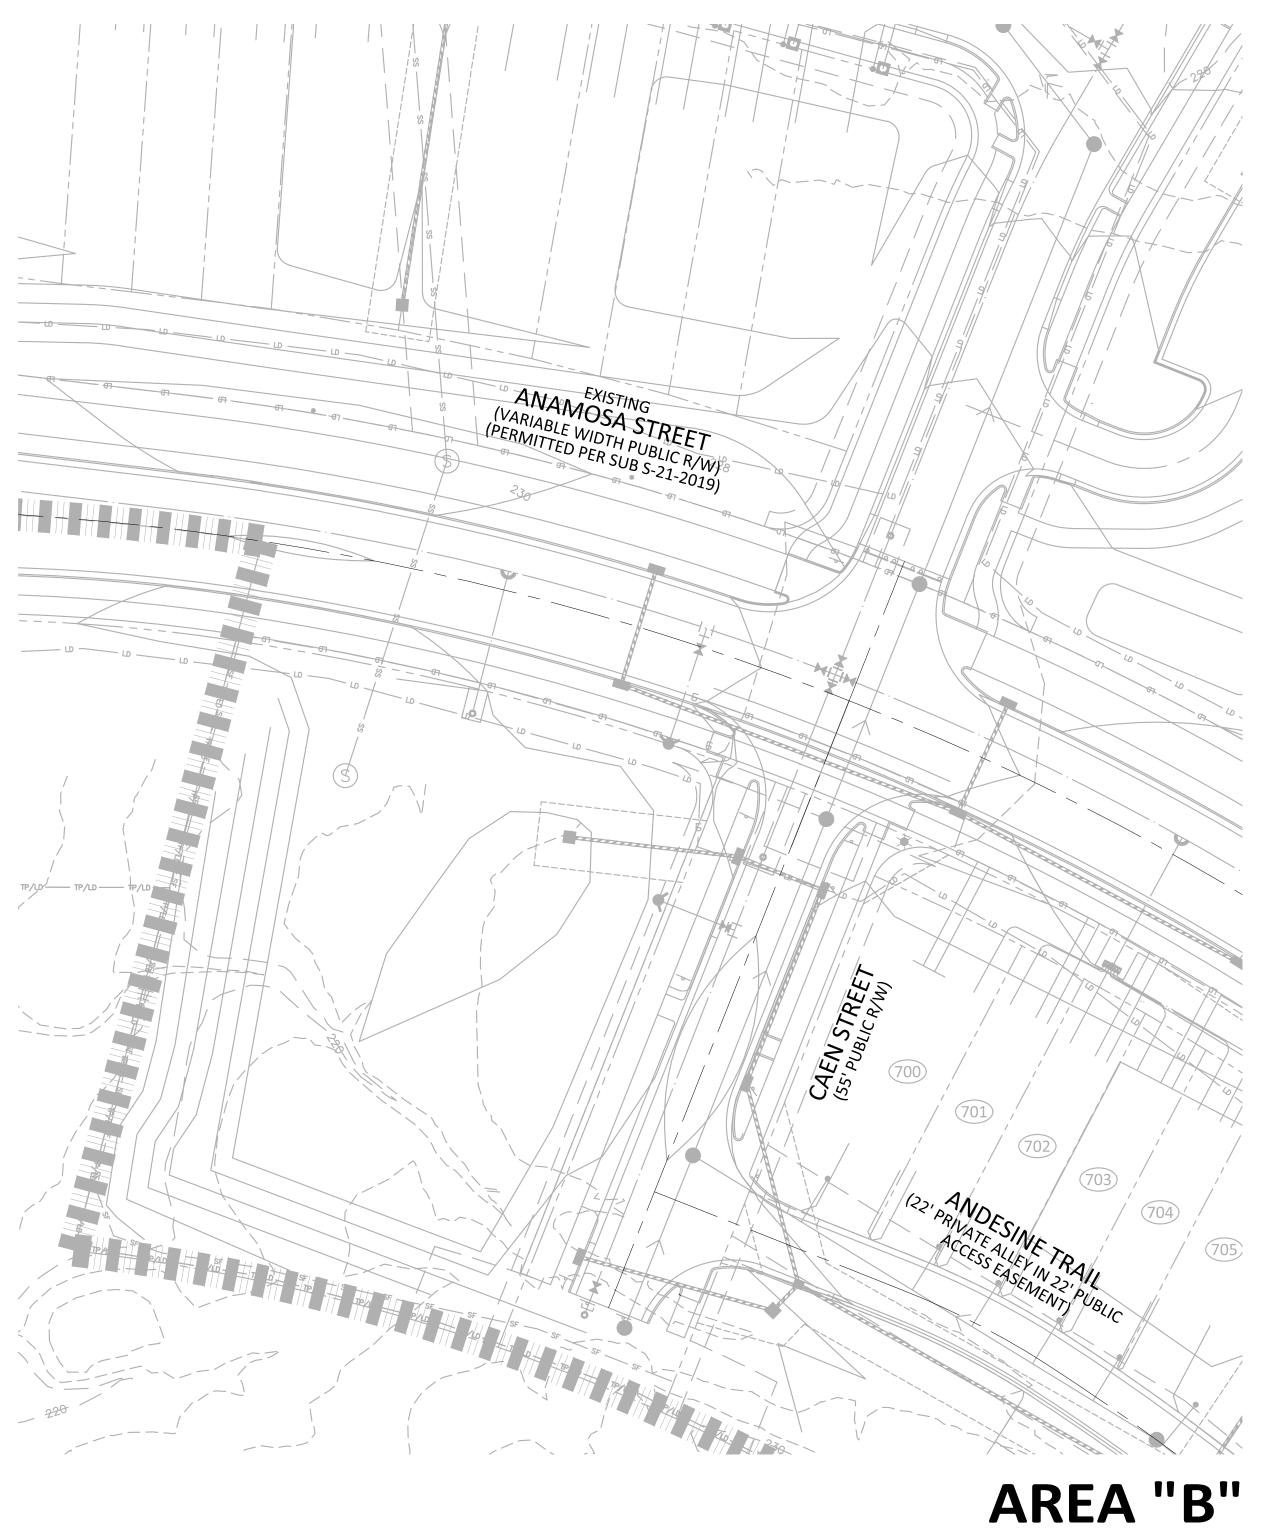
PROJECT NOTES

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CONTRACTOR SHALL NOTIFY "NC811" (811) OR (1-800-632-4949) AT LEAST 3 FULL BUSINESS DAYS PRIOR TO BEGINNING CONSTRUCTION OR EXCAVATION TO HAVE EXISTING UTILITIES LOCATED. CONTRACTOR SHALL CONTACT ANY LOCAL UTILITIES THAT PROVIDE THEIR OWN LOCATOR SERVICES INDEPENDENT OF "NC811". REPORT ANY DISCREPANCIES TO THE ENGINEER IMMEDIATELY.





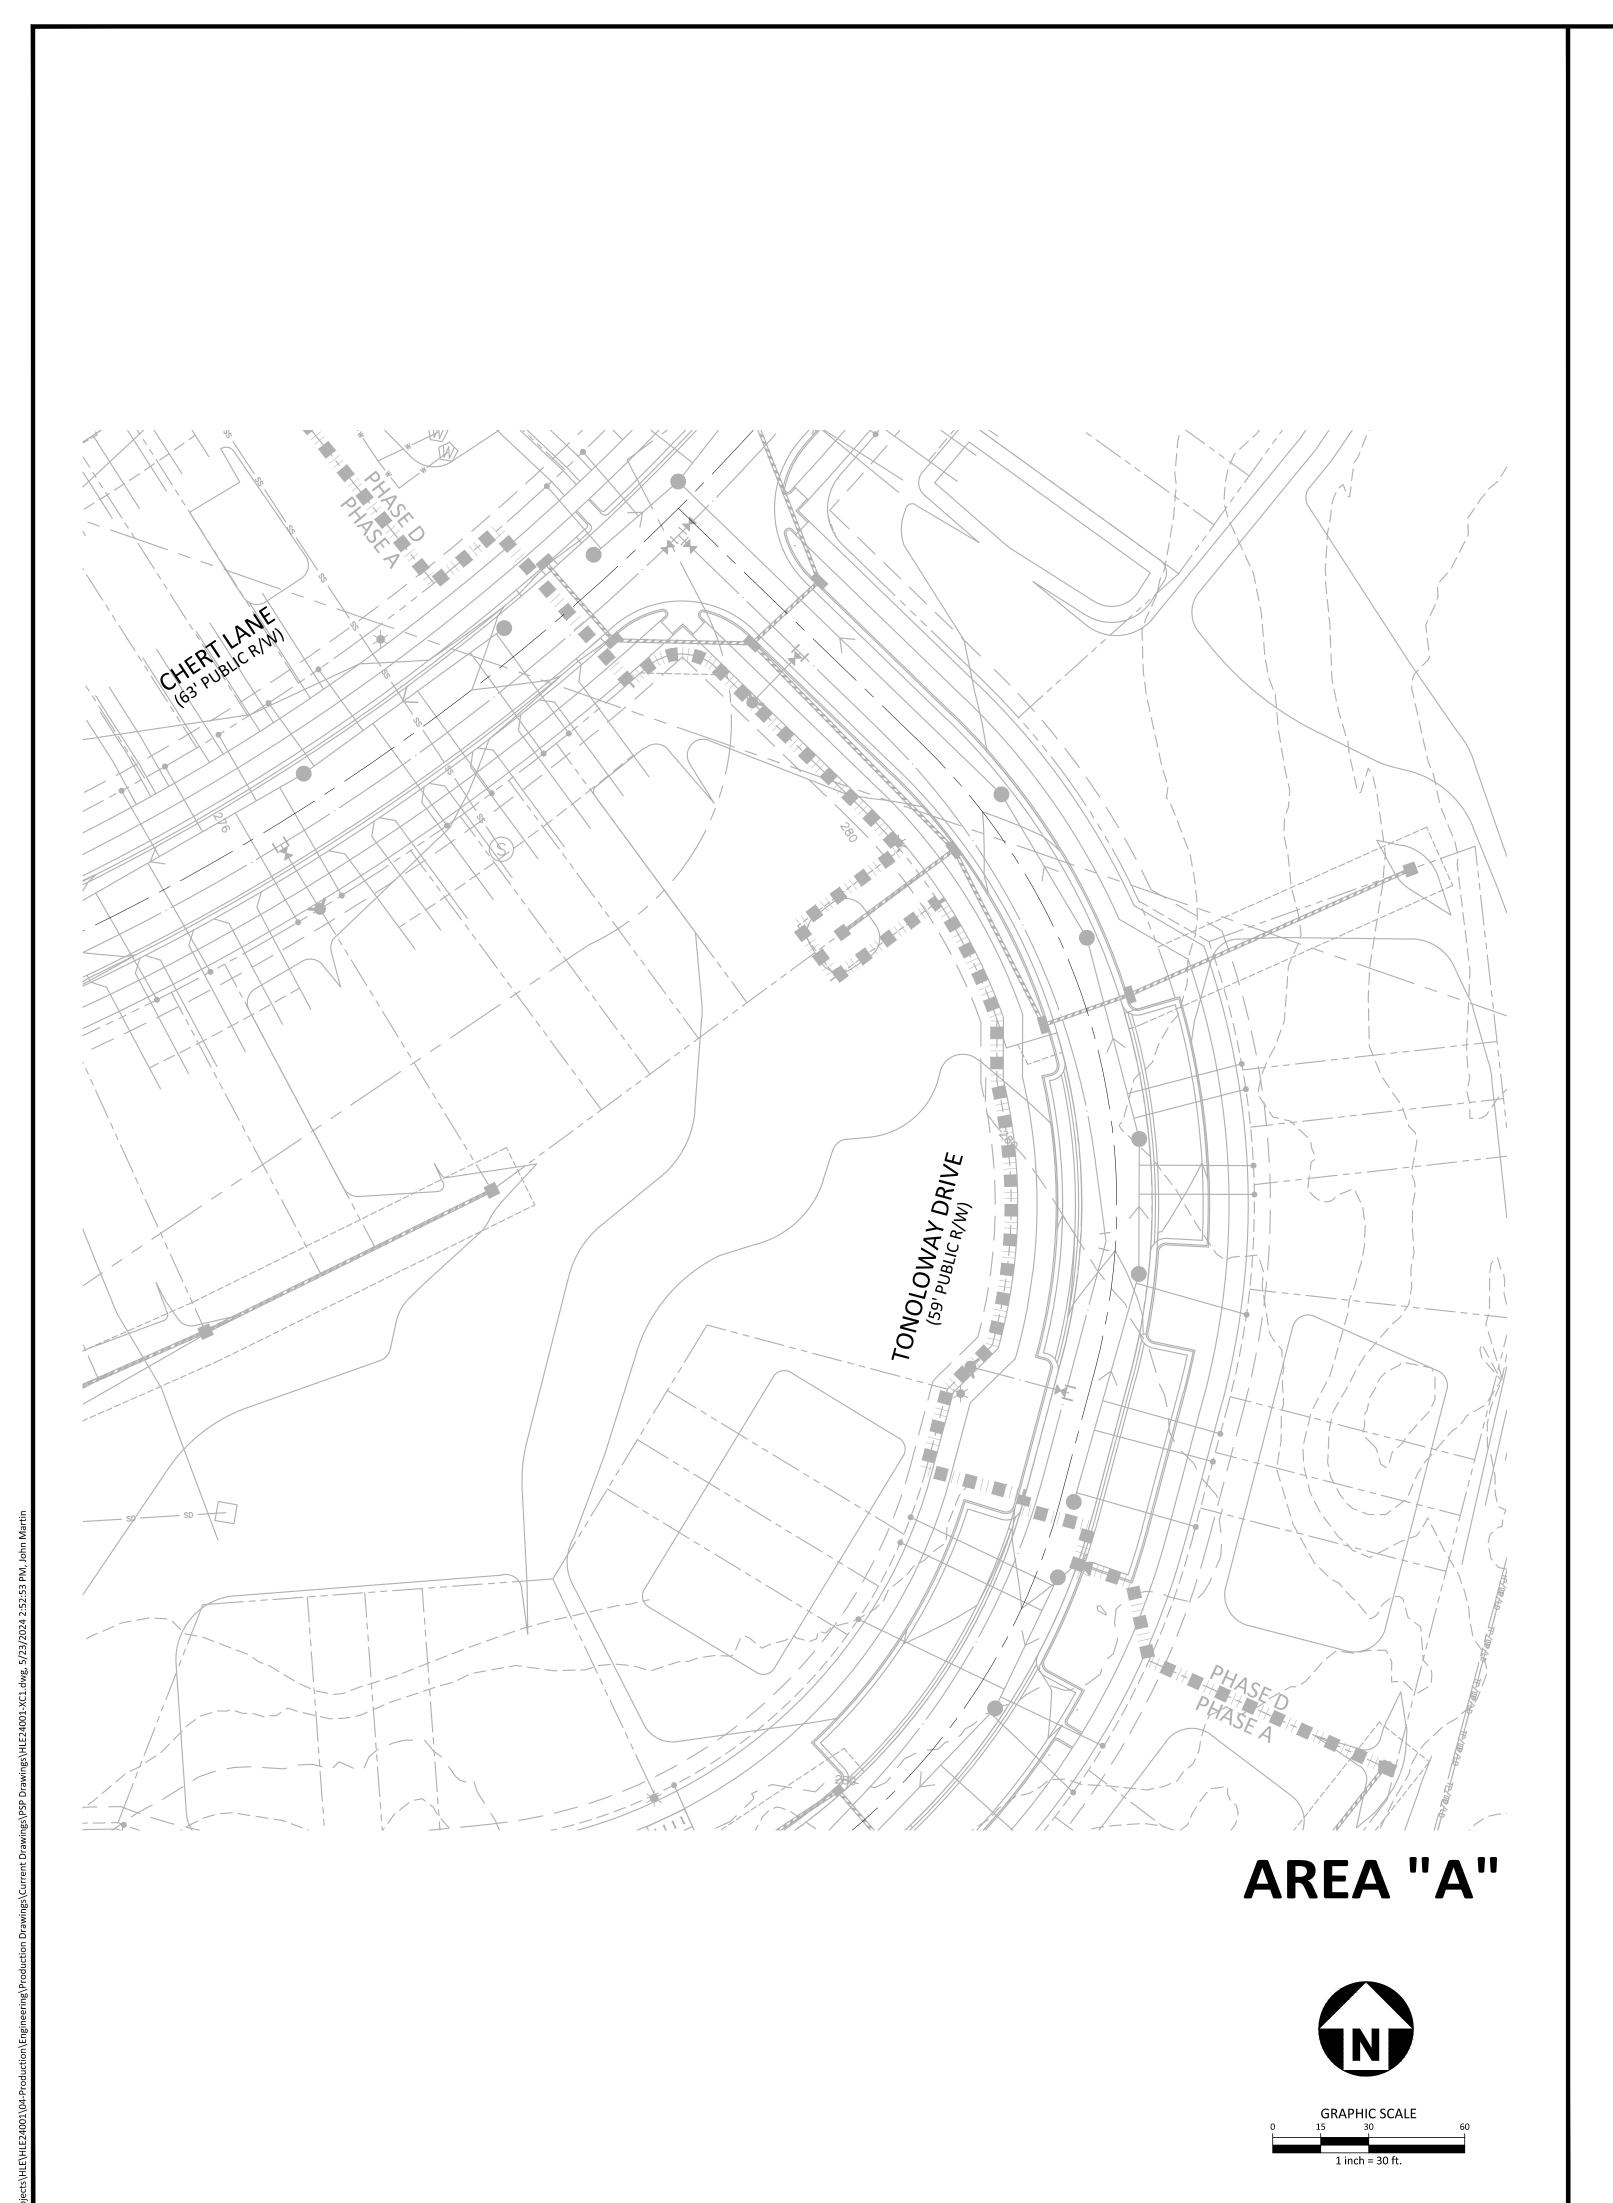

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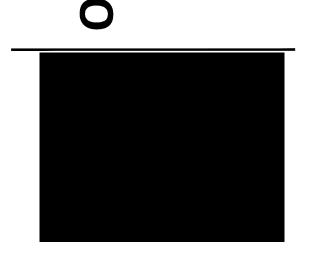
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#### CLIENT

HALLE BUILDING GROUP 56 HUNTER STREET, STE. 110 APEX, NC 27502 PHONE: 919. 387. 1885

# DITION PLAN

OLDE TOWNE 8-LOT ADDI
PRELIMINARY SUBDIVISION PLA
LOT 10 AND LOTS 4/5
RALEIGH, NORTH CAROLINA, 27610



#### REVISIONS

NO. DATE

#### PLAN INFORMATION

PROJECT NO. HLE24001

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CHECKED BY JCM

DRAWN BY CHB


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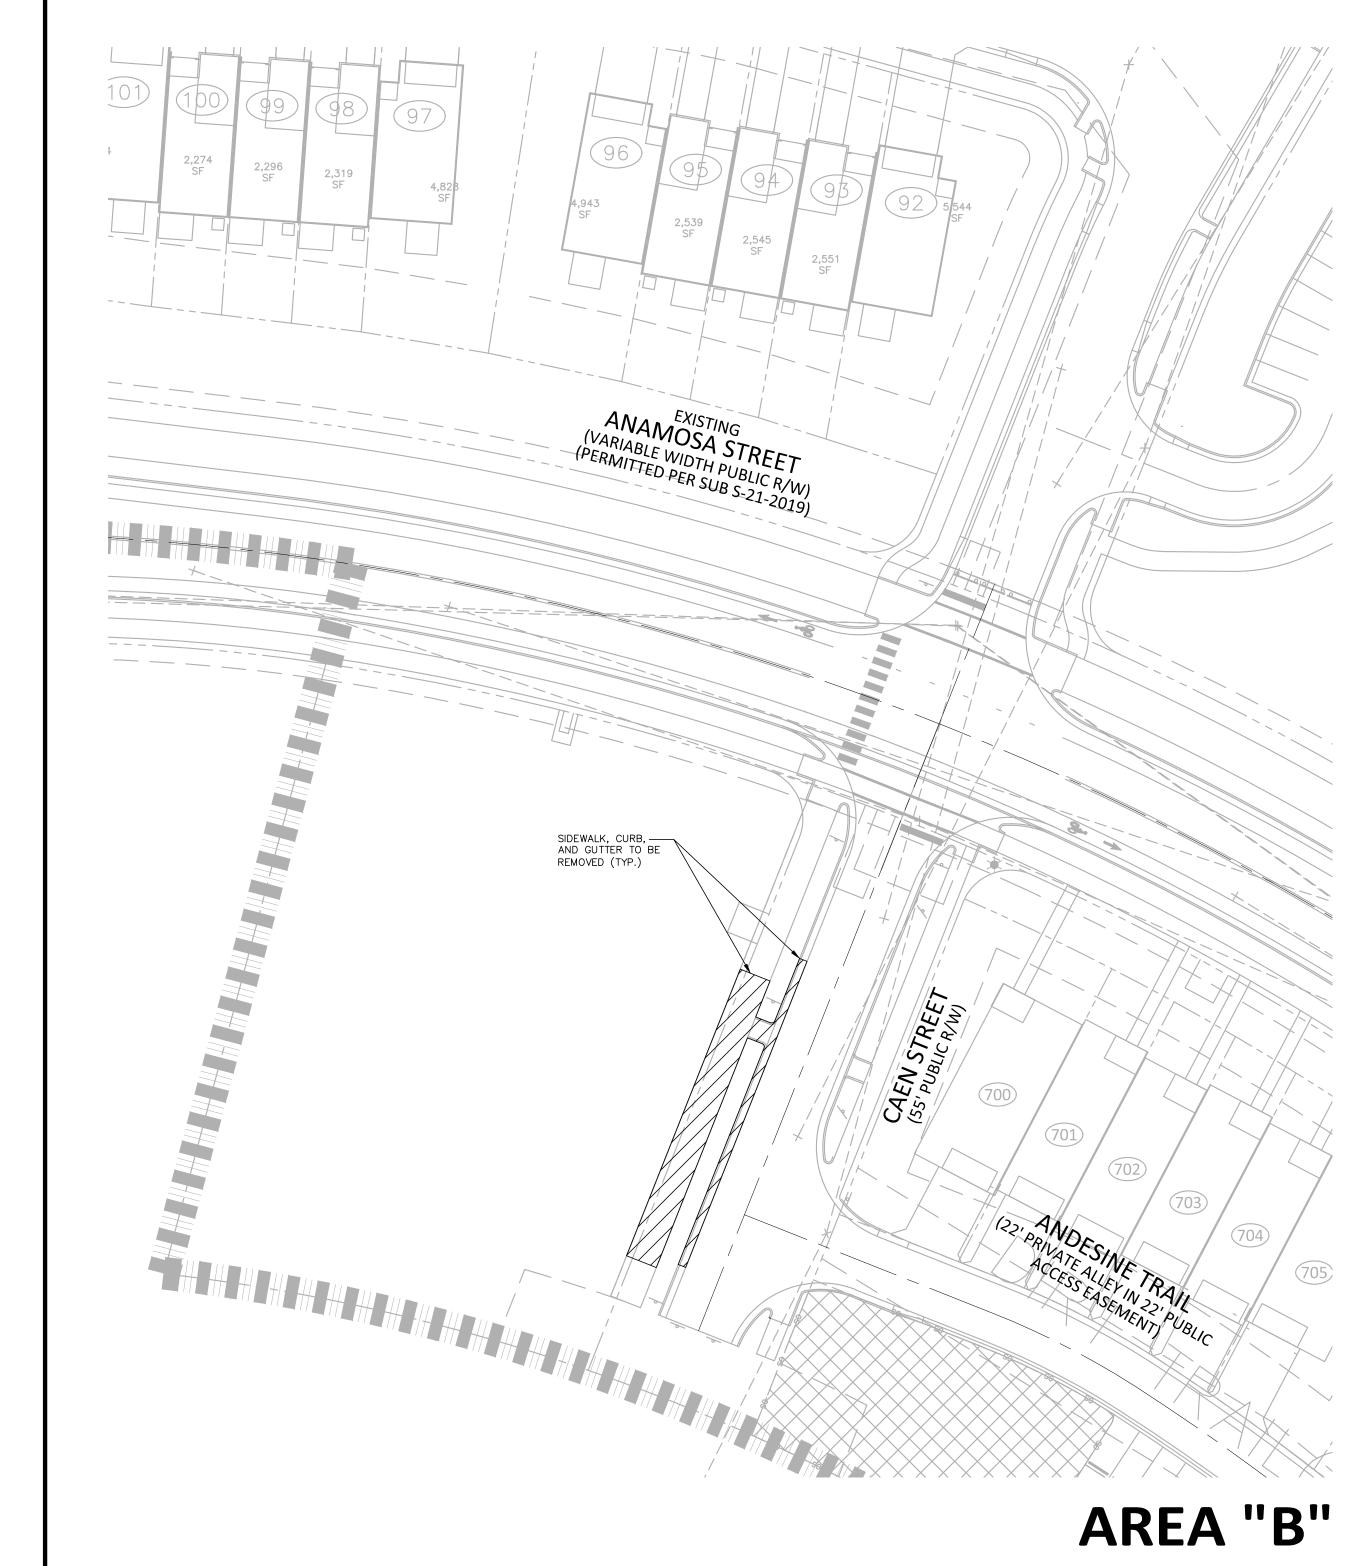
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PRELIMINARY DRAWING - NOT RELEASED FOR CONSTRUCTION

**EXISTING CONDITIONS** 

C1.00





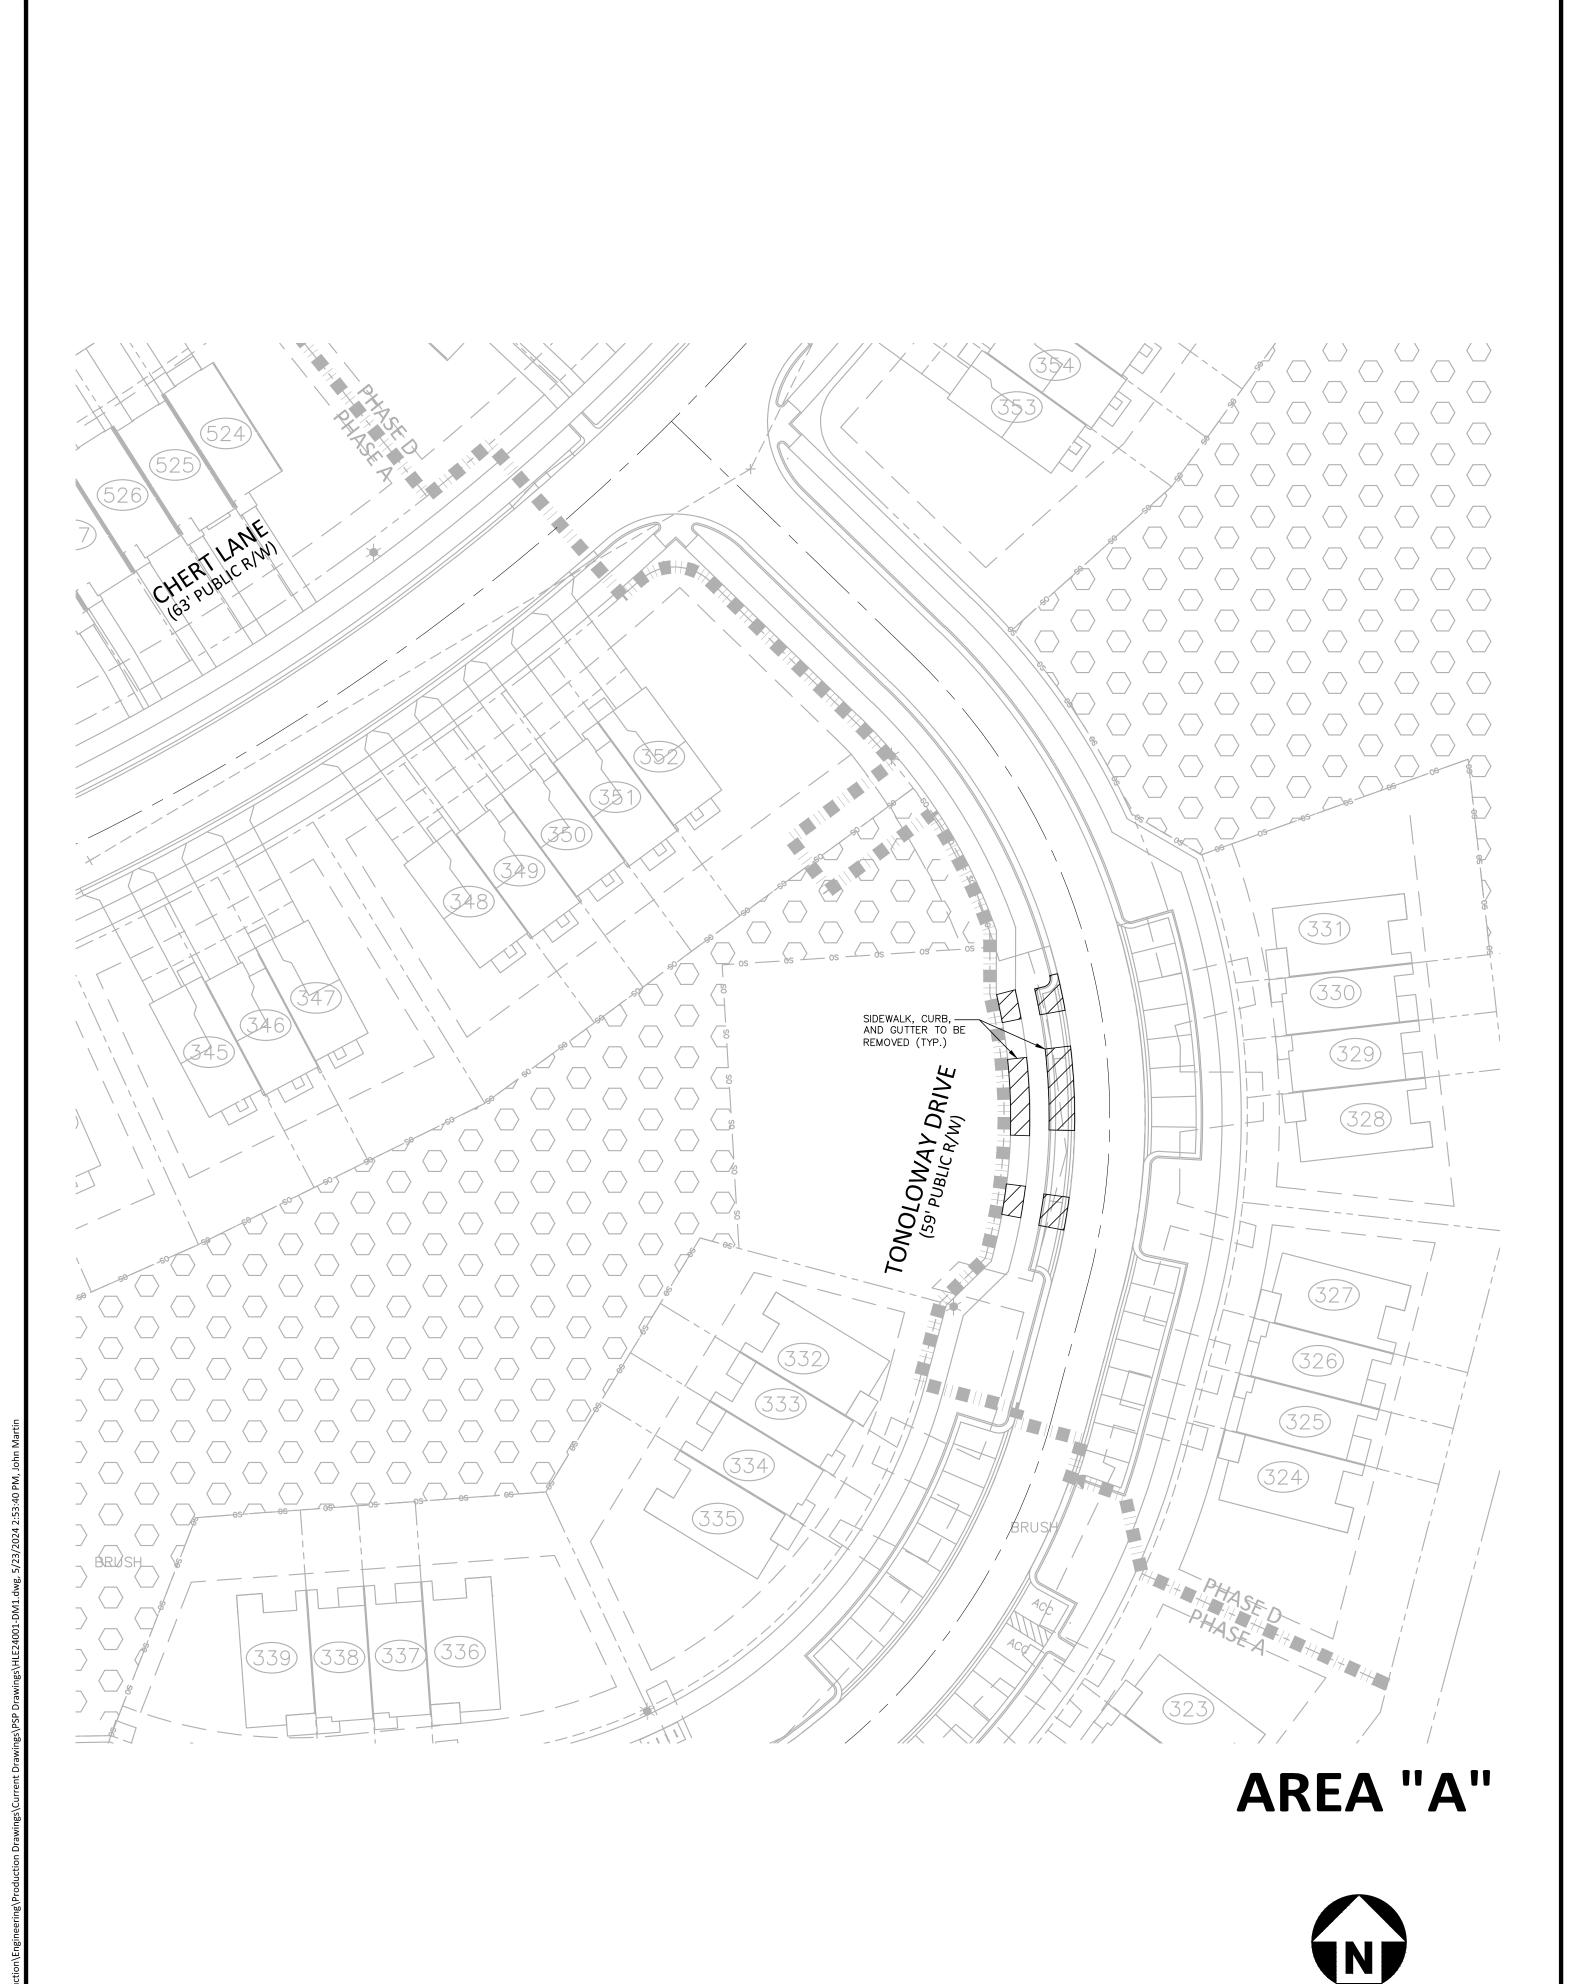

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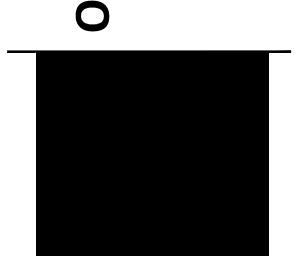
#### CLIENT

HALLE BUILDING GROUP 56 HUNTER STREET, STE. 110 APEX, NC 27502 PHONE: 919. 387. 1885



# BUILDING GRO

OLDE TOWNE 8-LOT ADDI PRELIMINARY SUBDIVISION PLA LOT 10 AND LOTS 4/5



#### **REVISIONS**

NO. DATE

#### PLAN INFORMATION

PROJECT NO. HLE24001

FILENAME HLE24001-DM:
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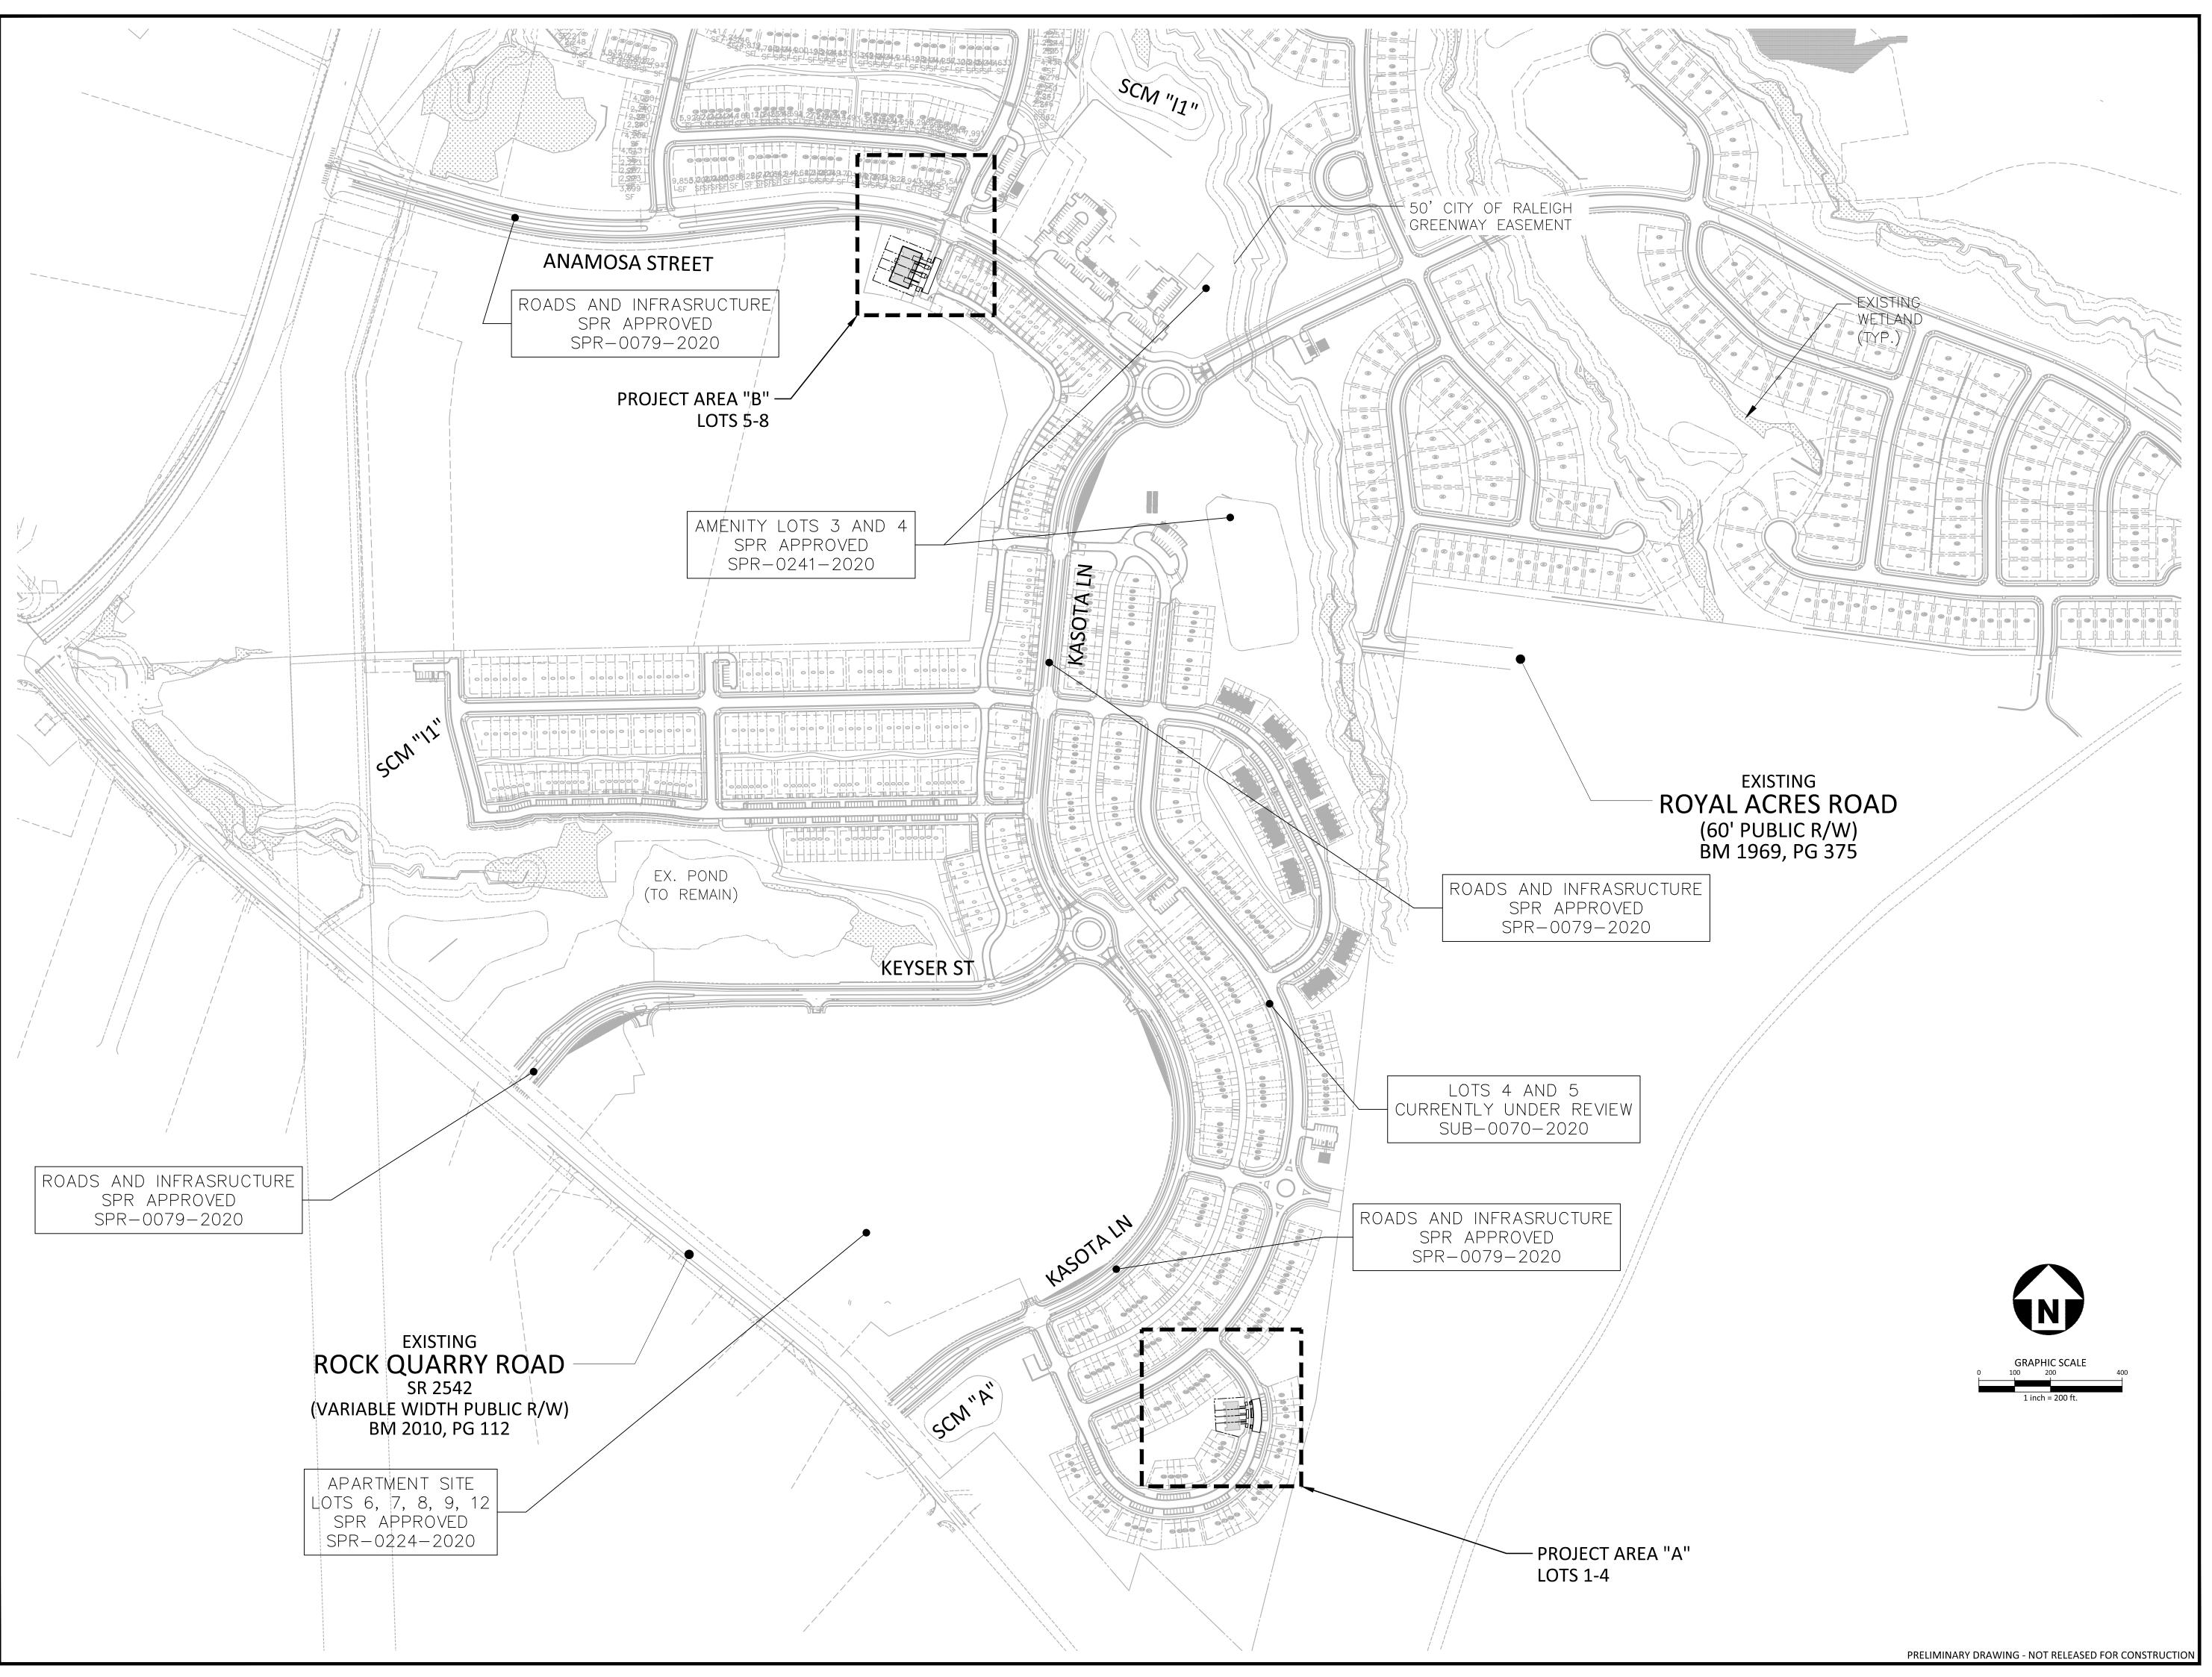
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DATE SHEET

**DEMOLITION PLAN** 

C1.01

PRELIMINARY DRAWING - NOT RELEASED FOR CONSTRUCTION





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phone 919. 361. 5000 fax 919. 361. 2269

license number: C-0293, C-187


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#### CLIENT

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# 8-LOT ADDITION UBDIVISION PLAN ND LOTS 4/5 H CAROLINA, 27610



#### **REVISIONS**

NO. DATE
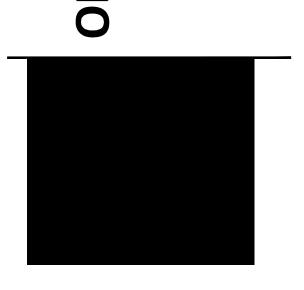
#### PLAN INFORMATION

PROJECT NO. HLE24001

FILENAME HLE24001-S1

CHECKED BY JCM

DRAWN BY CHB


SCALE 1"=200'

DATE 05. 22. 2024

SHEET

**OVERALL SITE PLAN** 

C2.00

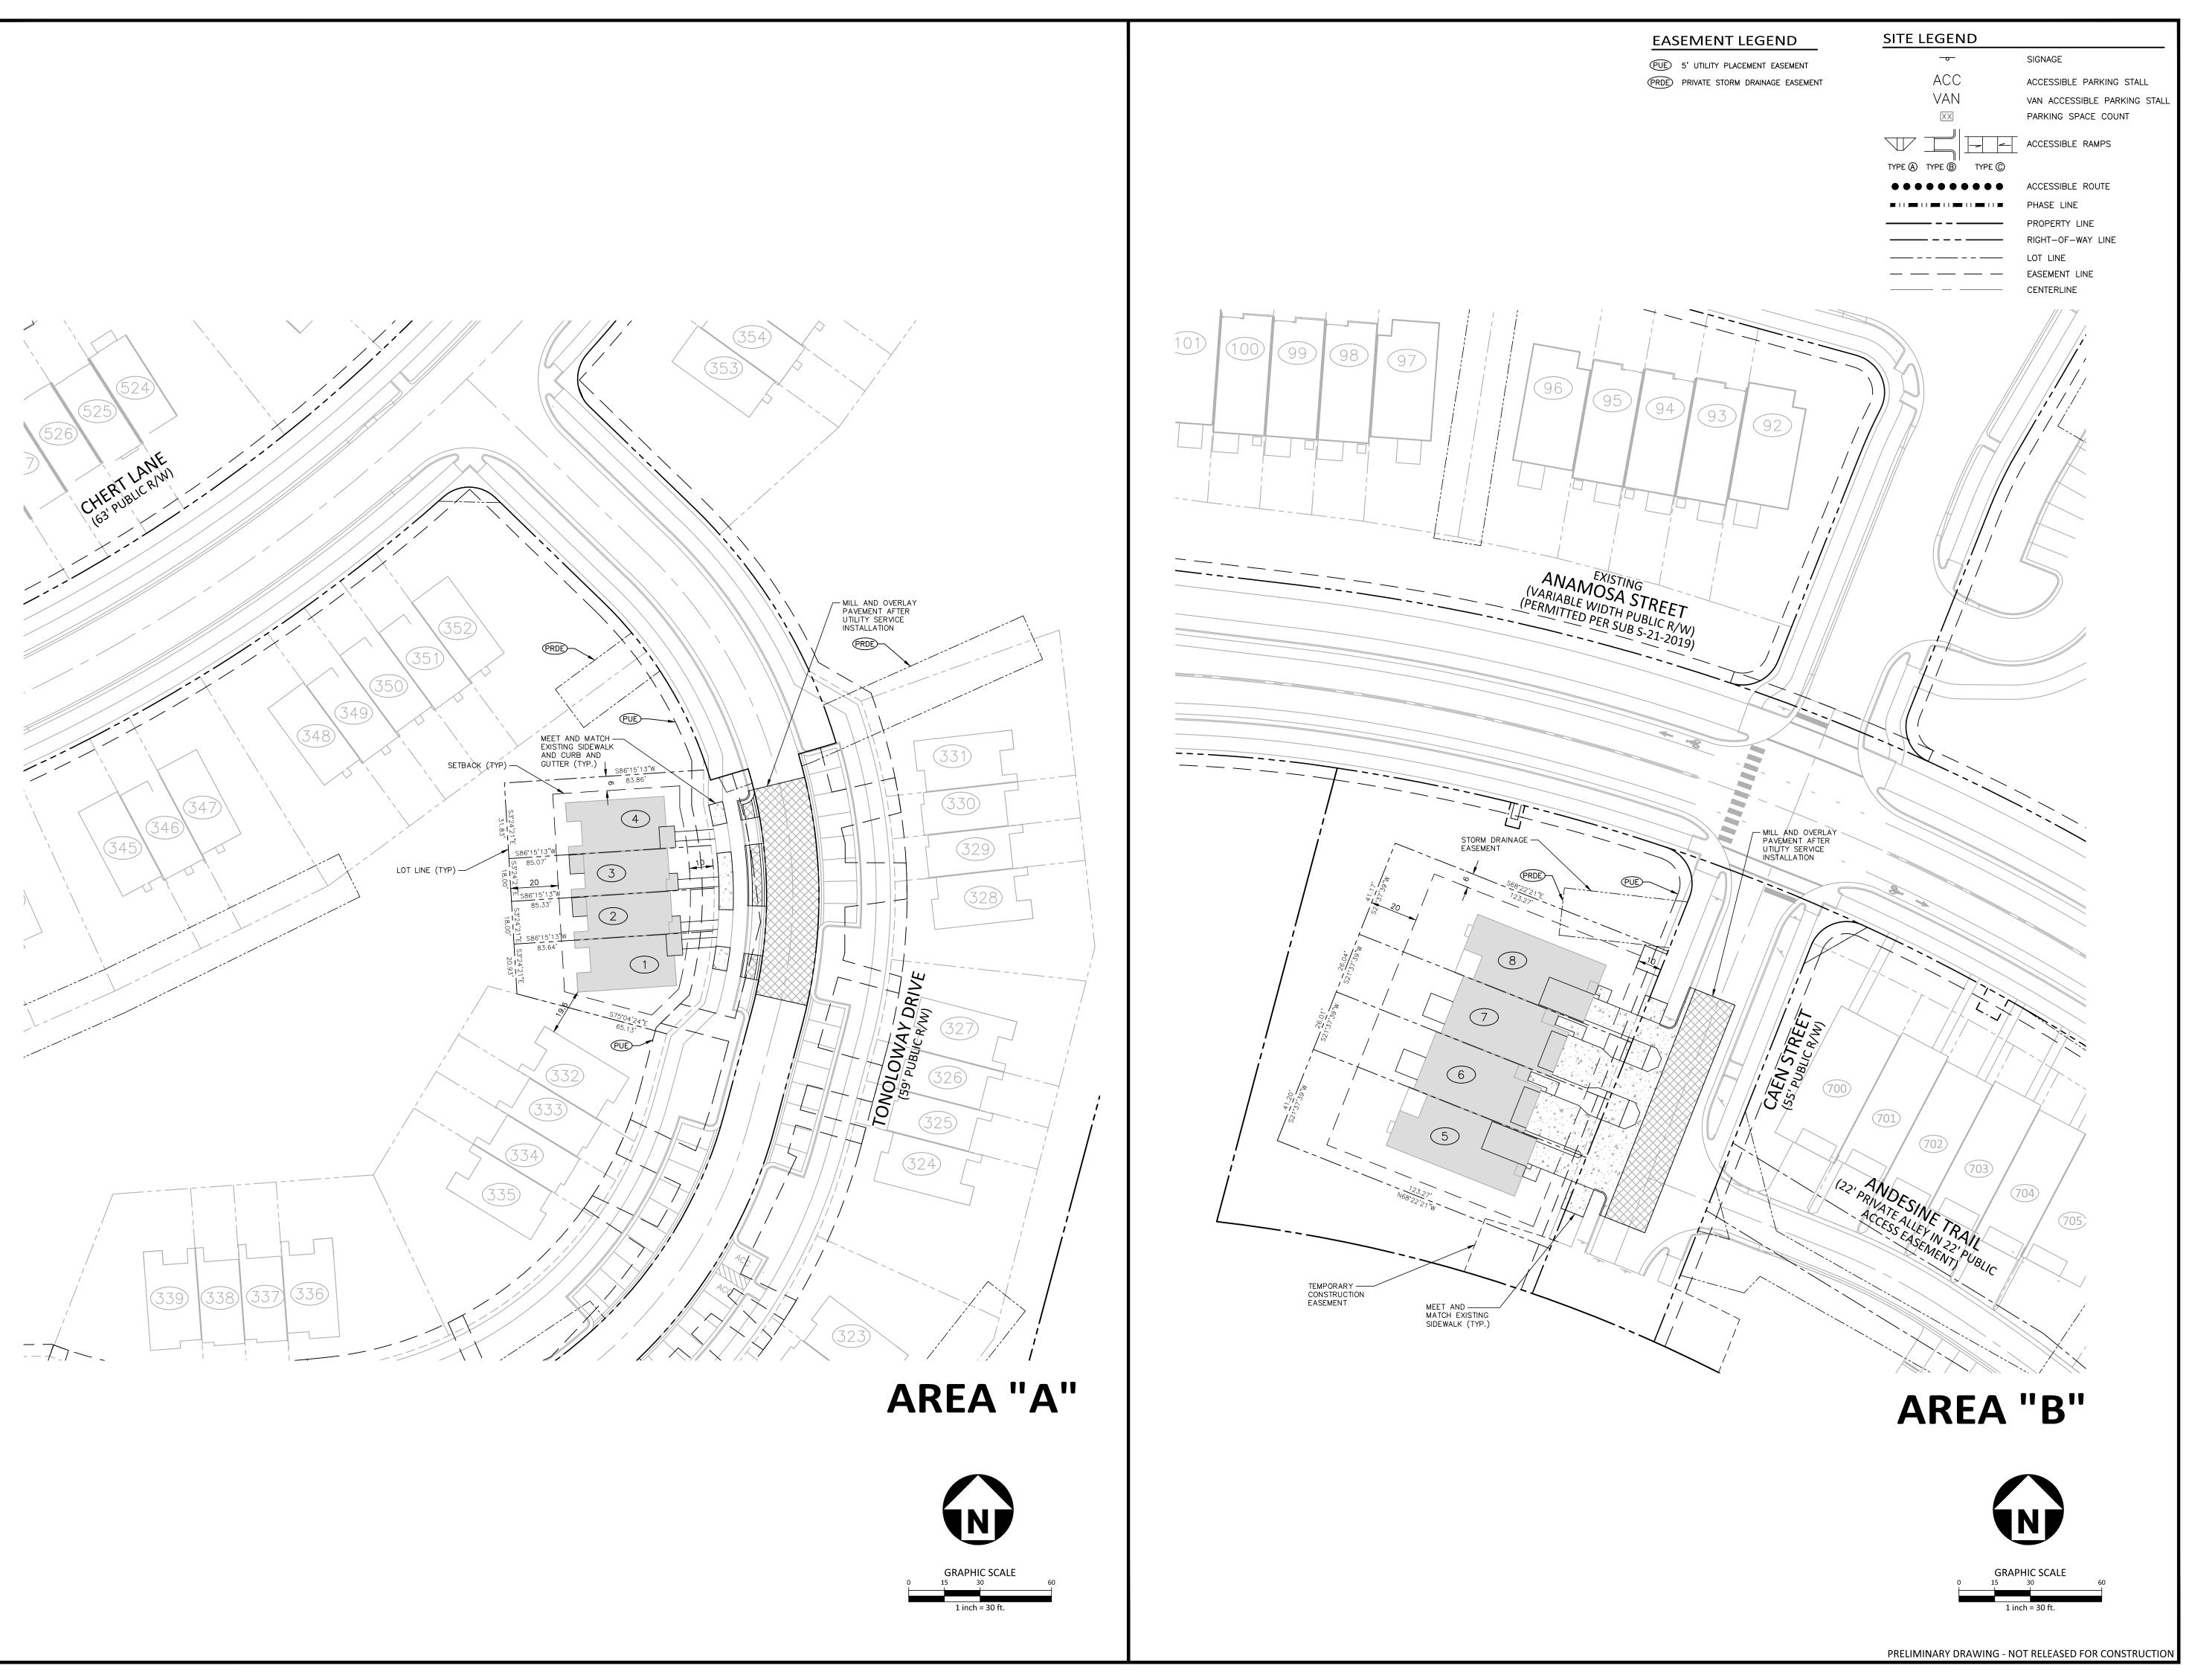



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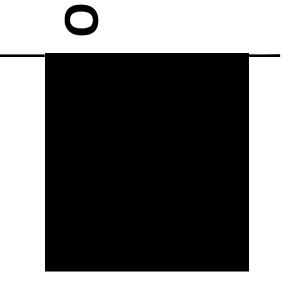
#### CLIENT

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# BUILDING GROUP

PRELIMINARY SUBDIVISION PLAND LOT 10 AND LOTS 4/5



#### REVISIONS

NO. DATE

SHEET

#### PLAN INFORMATION


PROJECT NO. HLE24001
FILENAME HLE24001-S1
CHECKED BY JCM
DRAWN BY CHB
SCALE 1"=30'
DATE 05. 22. 2024

SITE PLAN

C2.01

#### EASEMENT LEGEND

PUE 5' UTILITY PLACEMENT EASEMENT PRDE PRIVATE STORM DRAINAGE EASEMENT

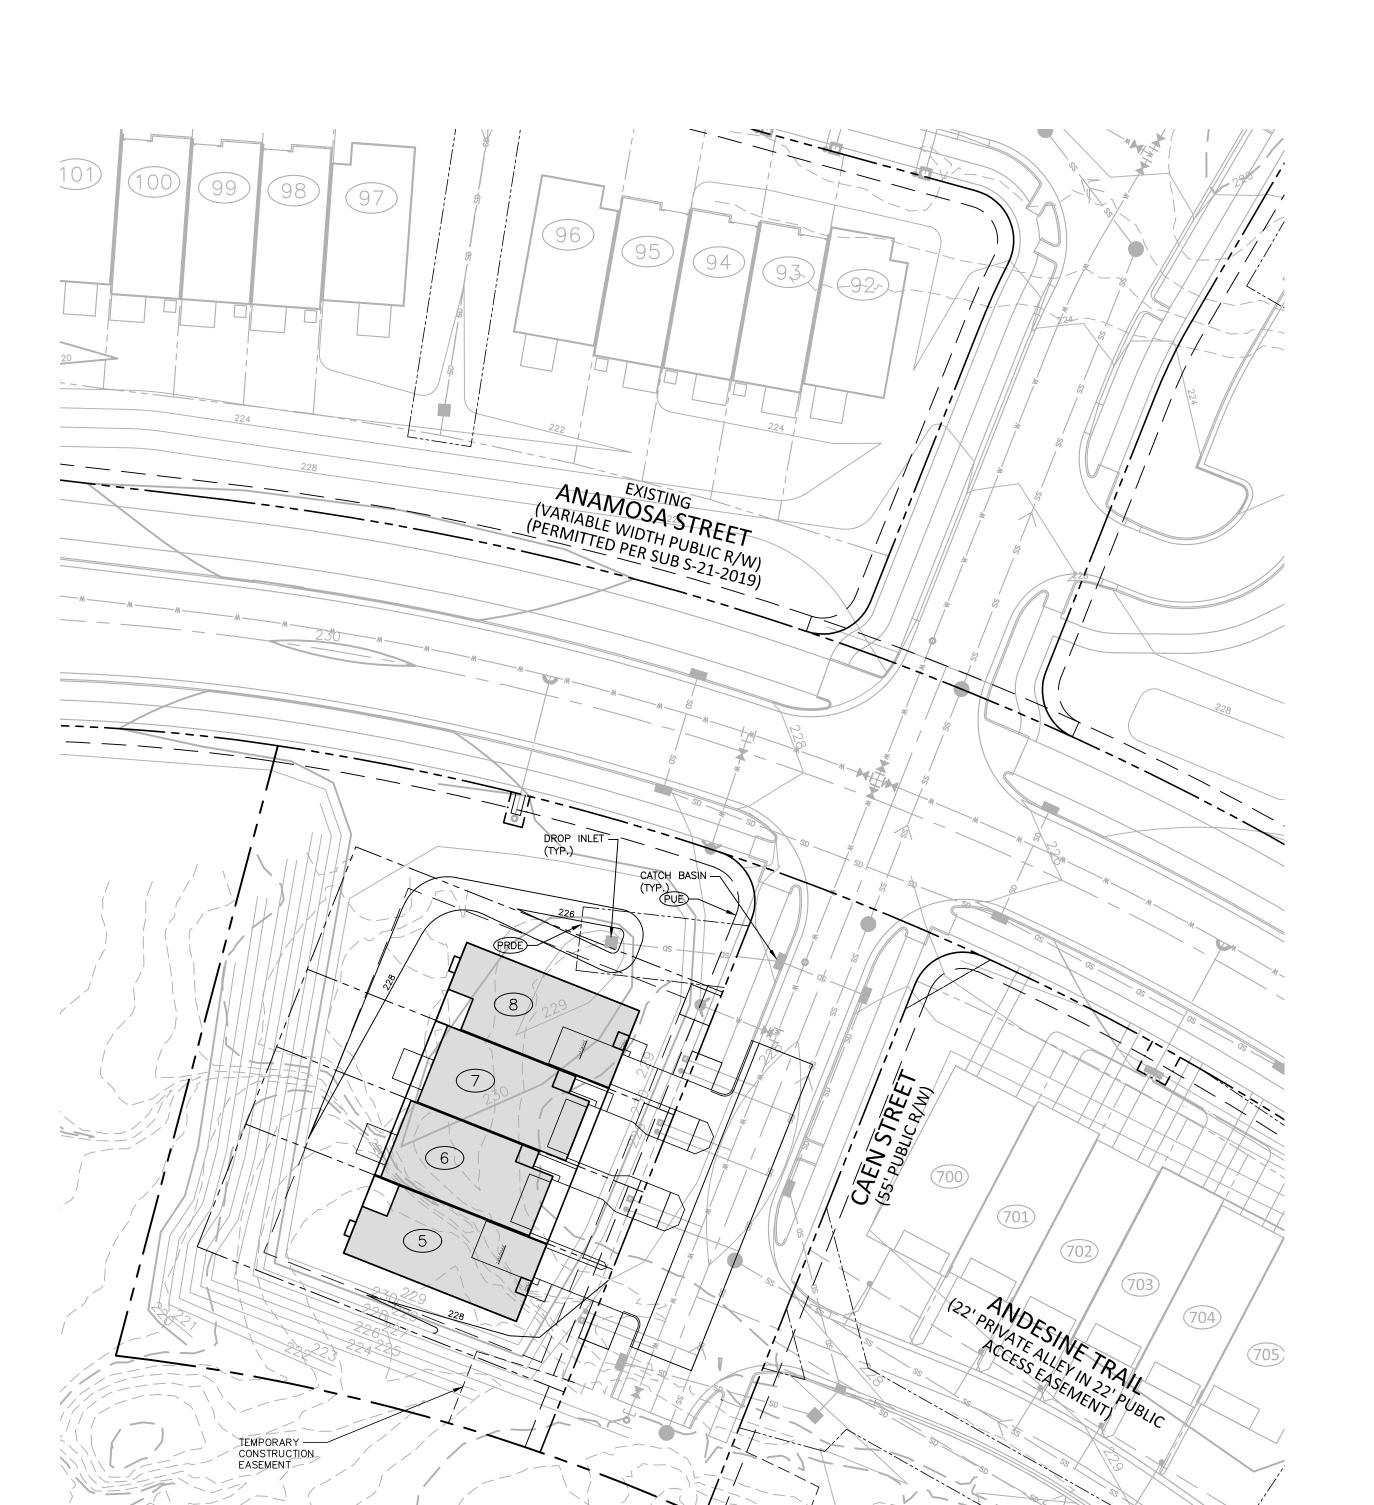



FLARED END SECTION ENDWALL SECTION CATCH BASIN

DROP INLET STORM SERVICE INLET

STORM SERVICE ROOF-DRAIN JUNCTION BOX DRAINAGE FLOW ARROW LINE BREAK SYMBOL

TOP & BOTTOM CURB ELEVATIONS TOP OF WALL ELEVATION
BOTTOM OF WALL ELEVATION
(NOTE: BOTTOM OF WALL IS GROUND
ELEVATION NOT WALL FOUNDATION)

SPOT ELEVATION + 250.60 STORM DRAINAGE — TP — TP — TREE PROTECTION FENCE -----LD ------ LIMITS OF DISTURBANCE

WOODED AREA \_\_\_\_ MINOR CONTOUR EXISTING MAJOR CONTOUR

EXISTING MINOR CONTOUR — — EASEMENT LINE ACCESSIBLE PARKING AREA (2% MAX. SLOPE IN ALL DIRECTIONS) AREA "B"



PRELIMINARY DRAWING - NOT RELEASED FOR CONSTRUCTION



**McAdams** The John R. McAdams Company, Inc.

621 Hillsborough Street Suite 500 Raleigh, NC 27603 phone 919. 361. 5000


license number: C-0293, C-187 www.mcadamsco.com

fax 919. 361. 2269

#### CLIENT

HALLE BUILDING GROUP 56 HUNTER STREET, STE. 110 APEX, NC 27502 PHONE: 919. 387. 1885



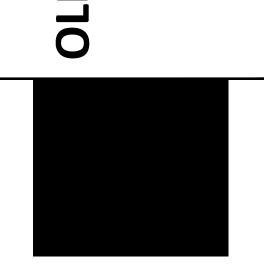

#### **REVISIONS**


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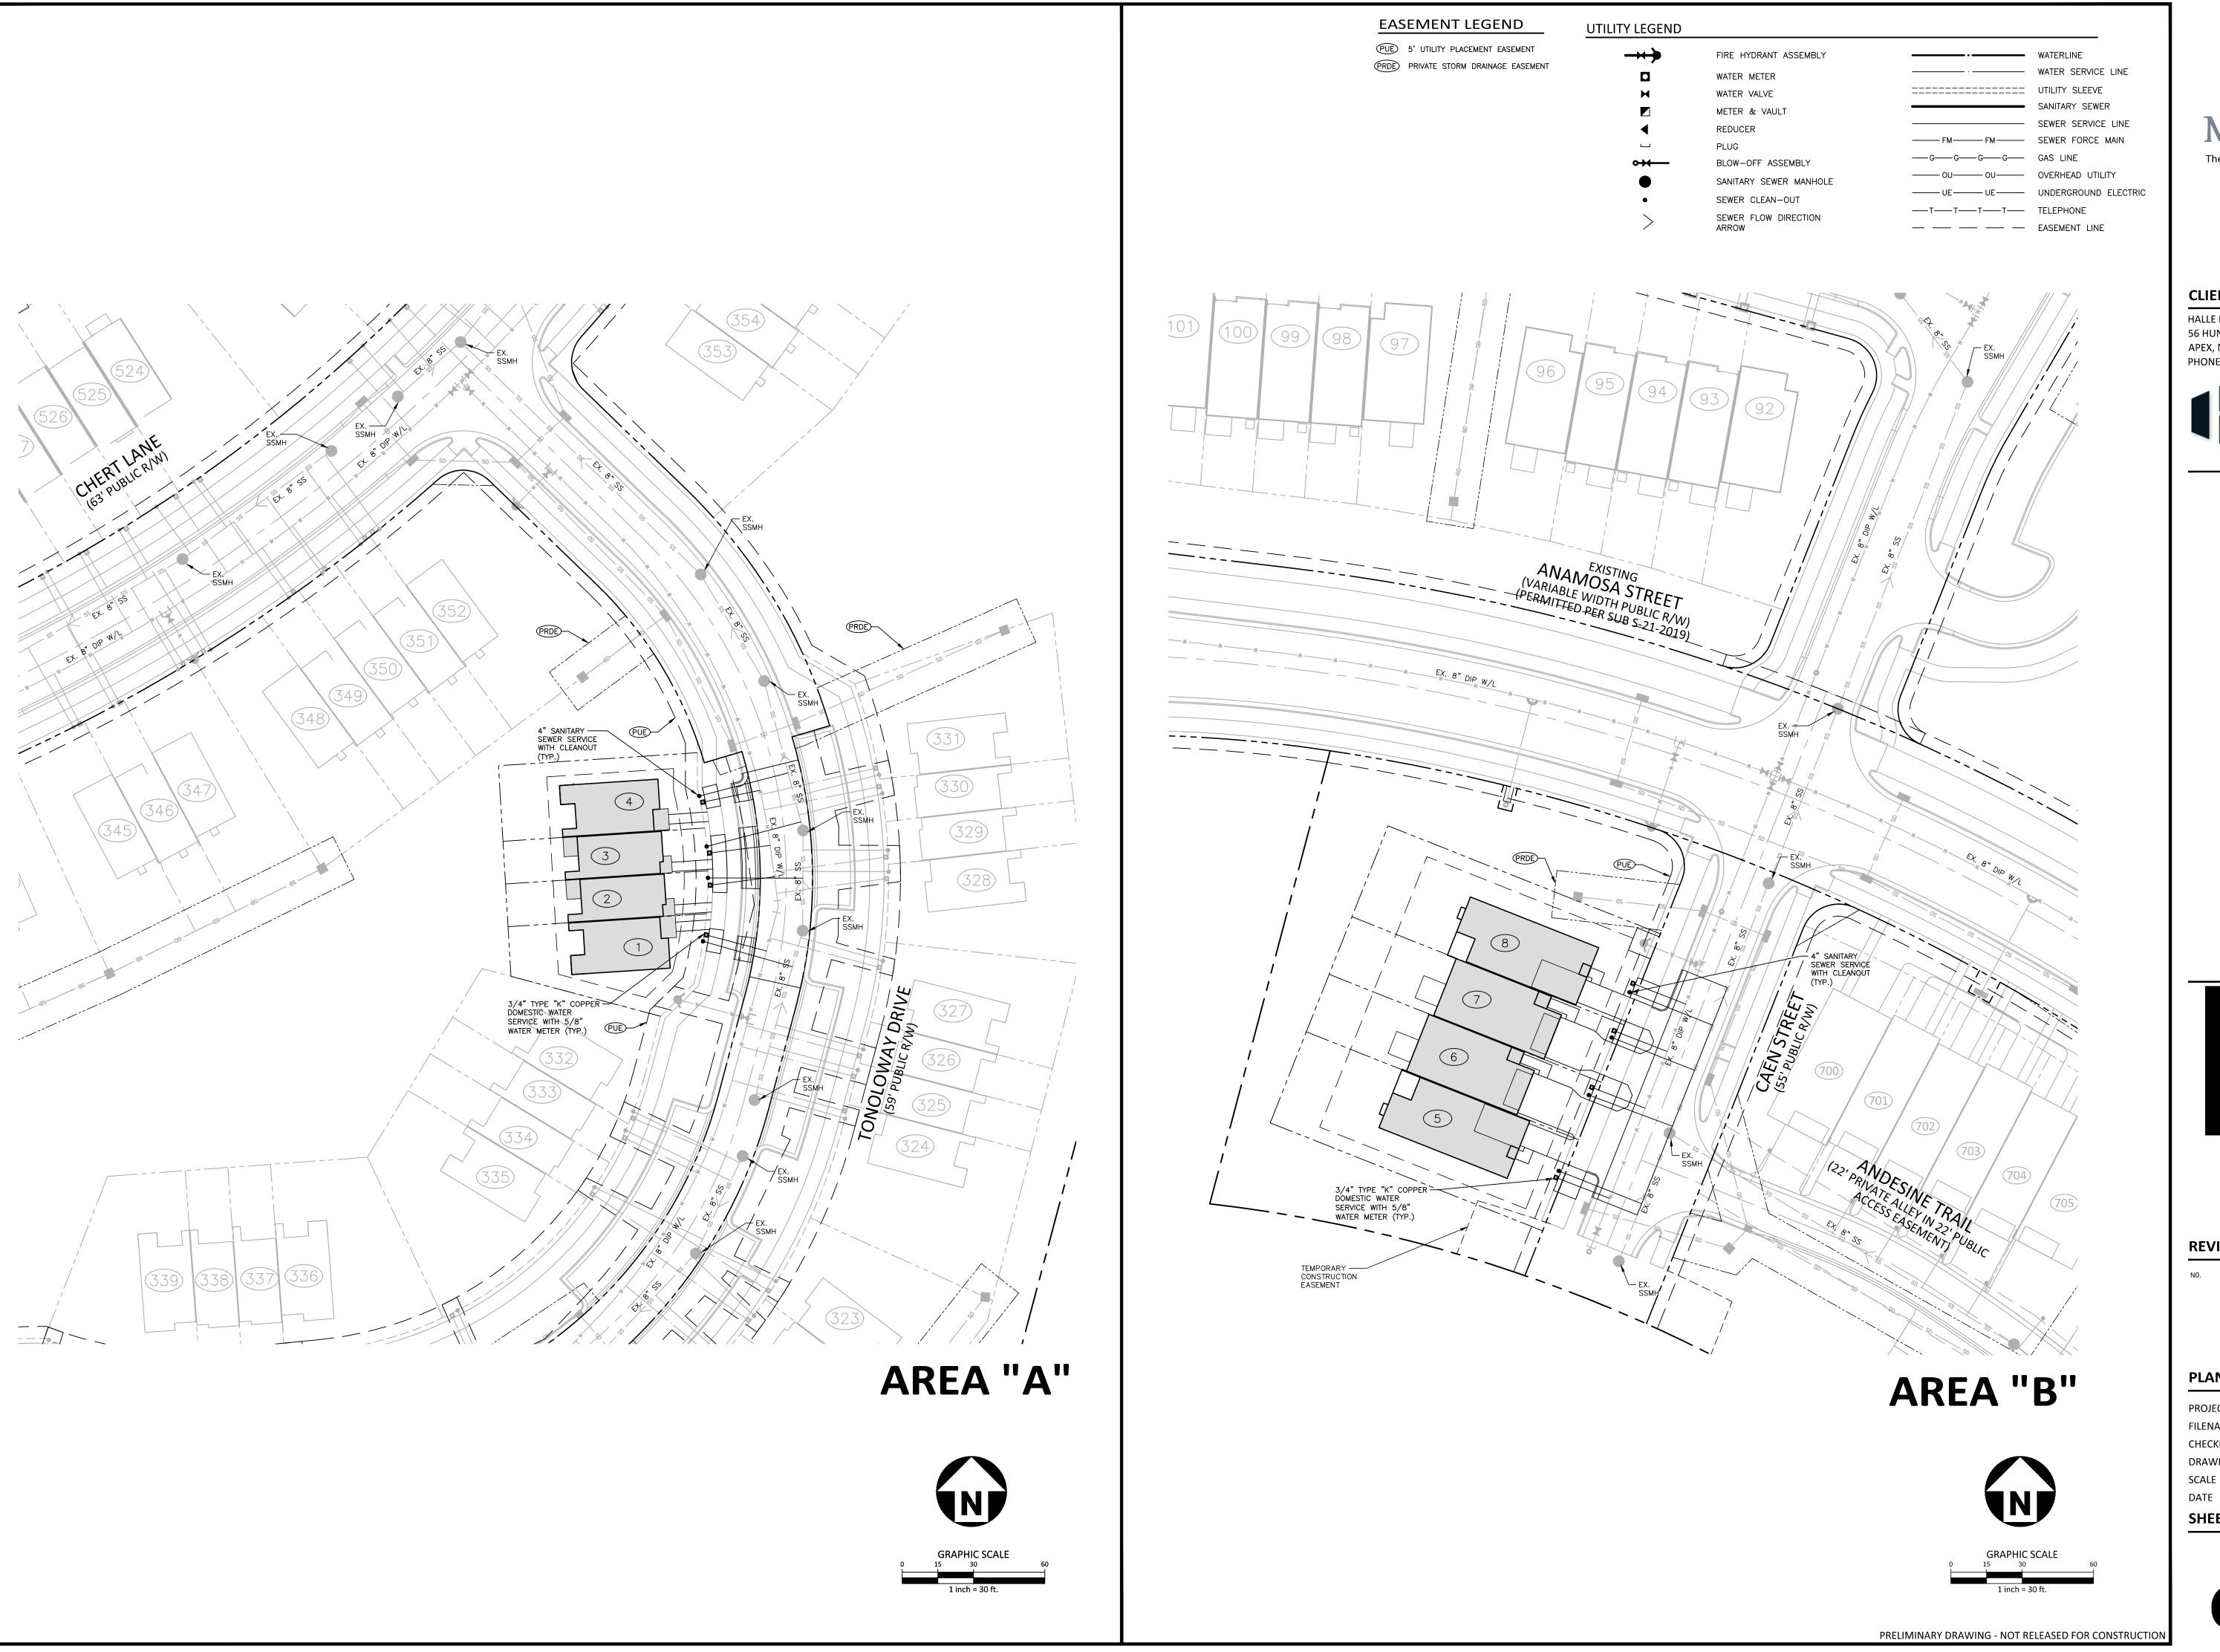
#### PLAN INFORMATION

PROJECT NO. HLE24001 HLE24001-G1 FILENAME CHECKED BY DRAWN BY SCALE 1"=30'

05. 22. 2024 DATE

SHEET GRADING AND STORM DRAINAGE PLAN



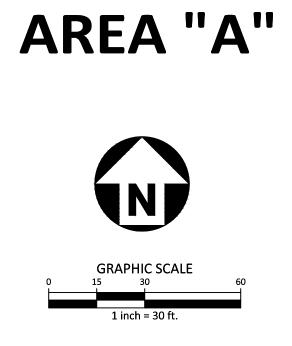



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fax 919. 361. 2269 license number: C-0293, C-187


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OLDE TOW PRELIMIN



**REVISIONS** 


**PLAN INFORMATION** 

FILENAME CHECKED BY DRAWN BY SCALE

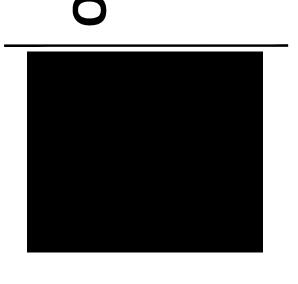SHEET

**UTILITY PLAN** 

C4.01

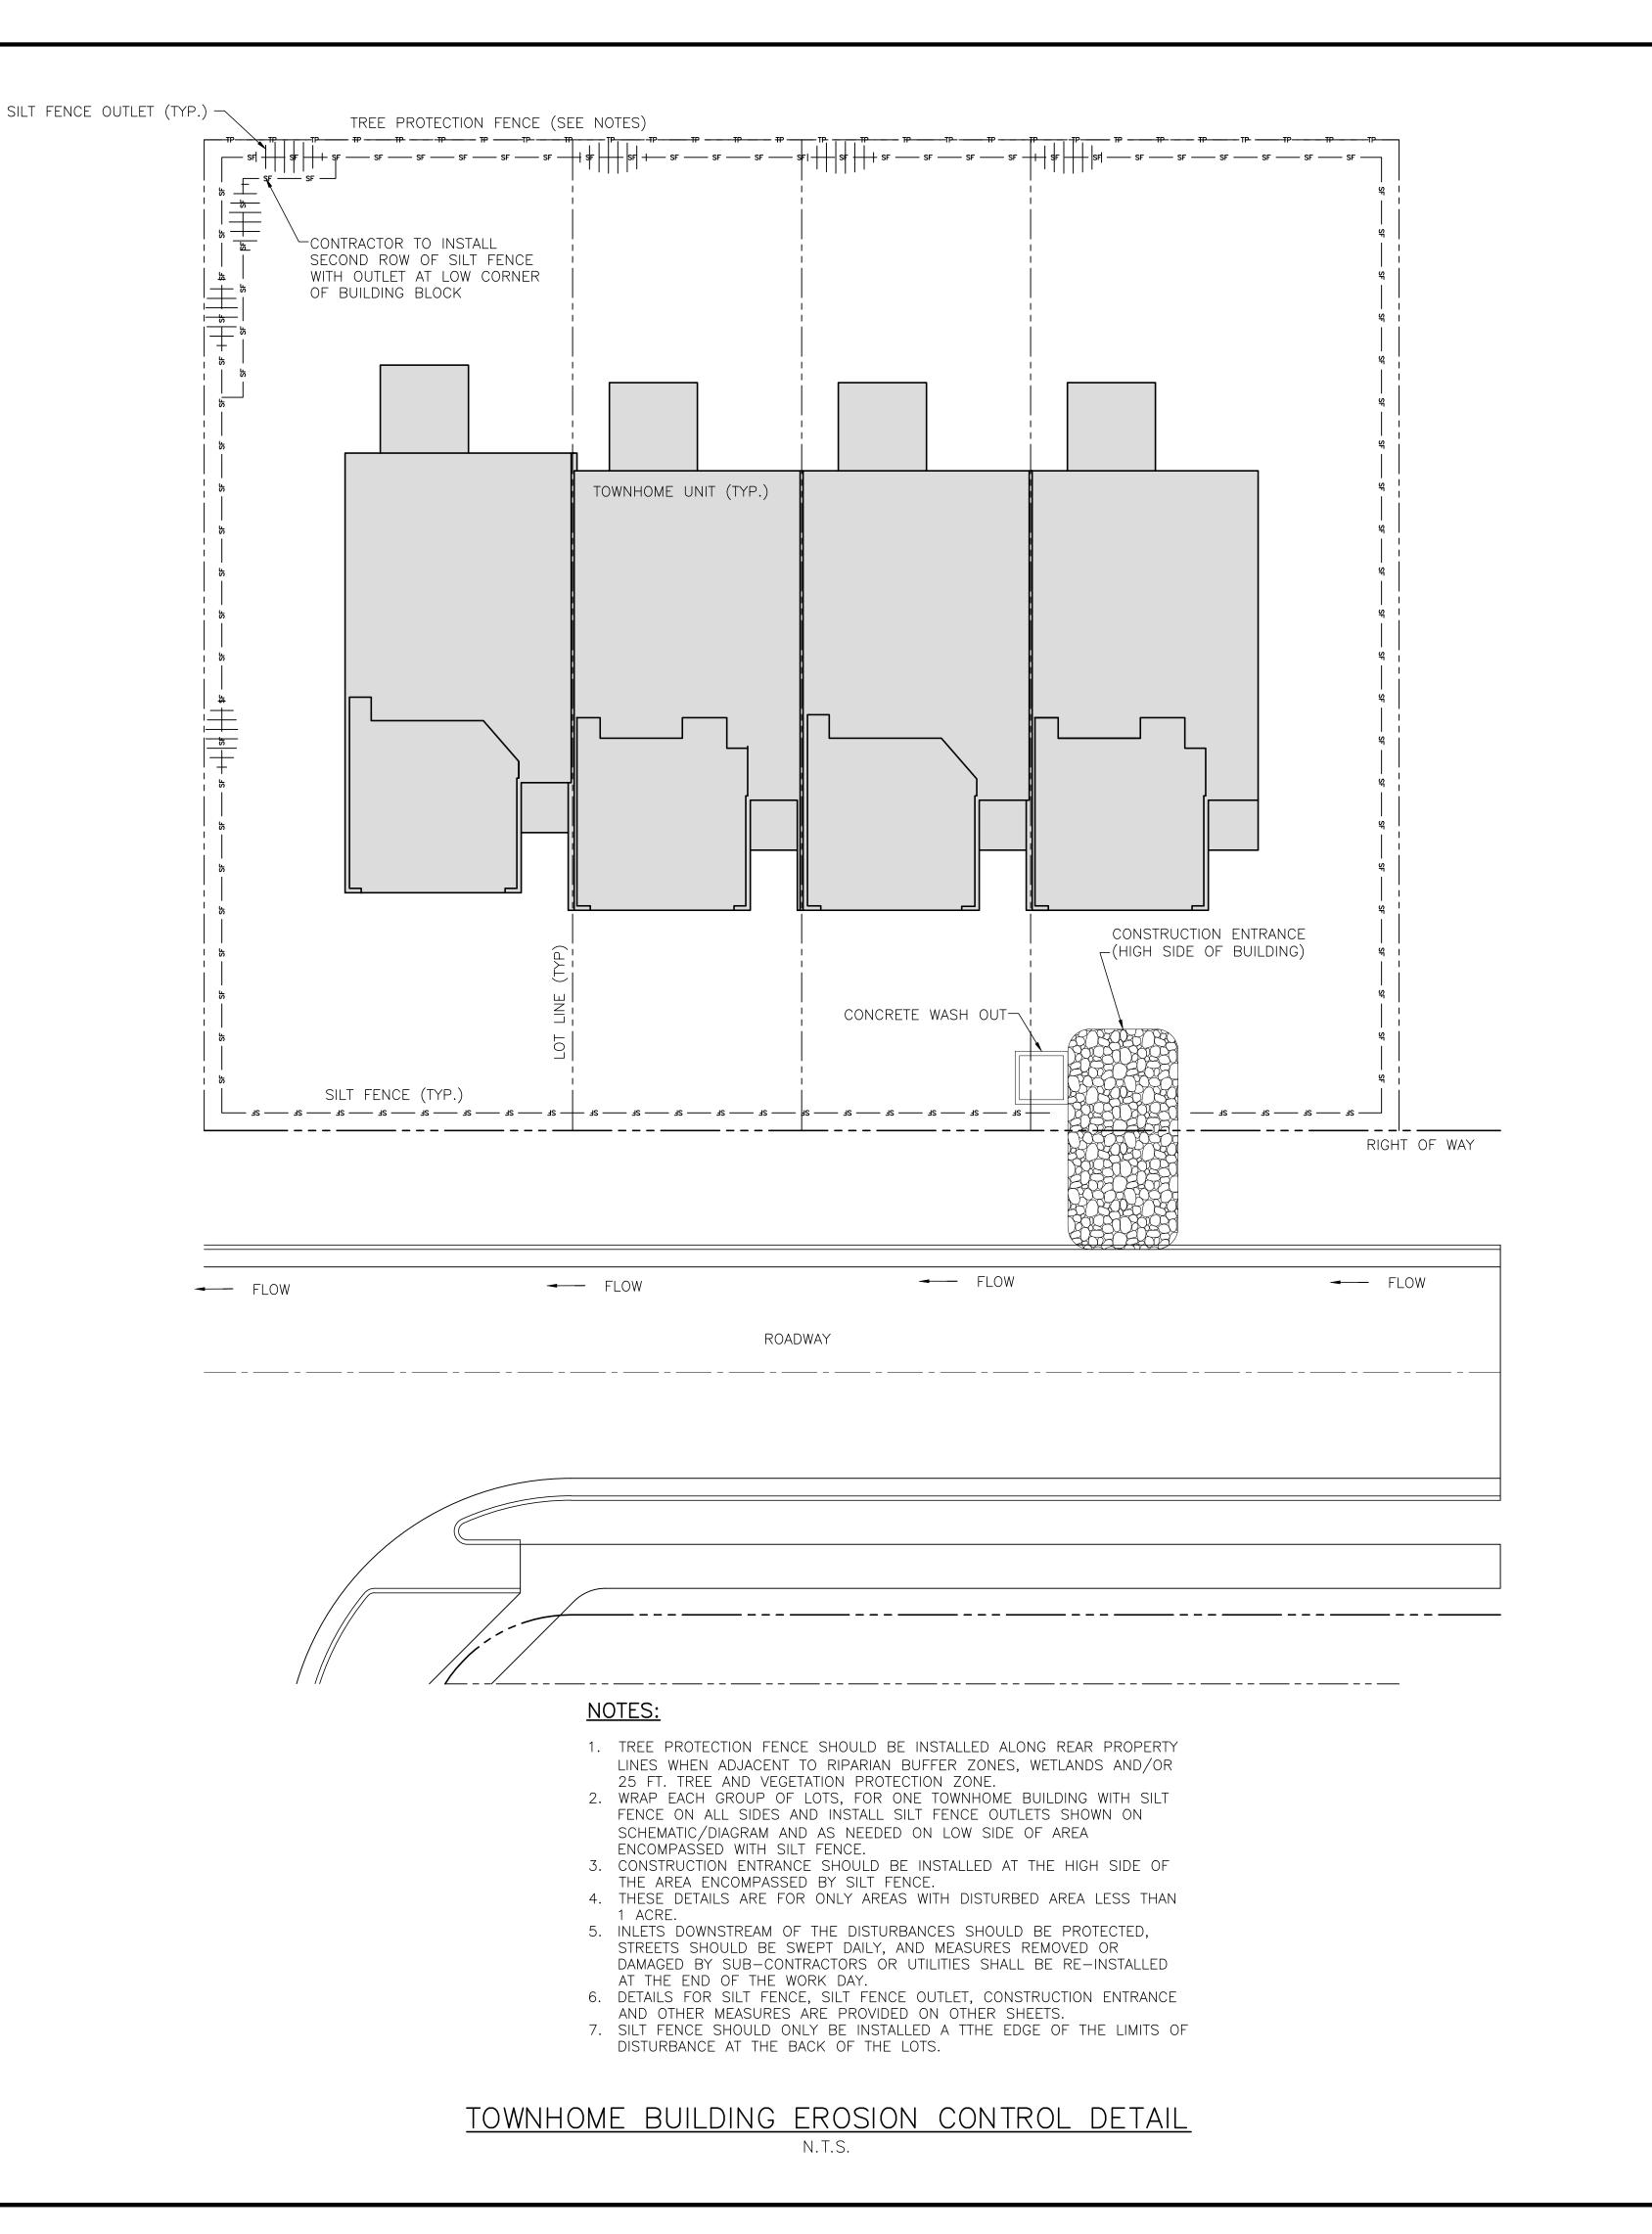

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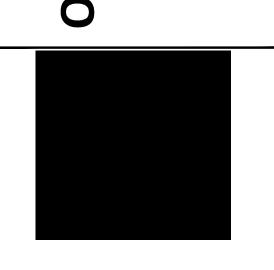
#### CLIENT

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# DDITION N PLAN '5

PRELIMINARY SUBDIVISION PL/LOT 10 AND LOTS 4/5
RALEIGH, NORTH CAROLINA, 27610



#### **REVISIONS**

NO. DATE

#### PLAN INFORMATION

PROJECT NO. HLE24001

FILENAME HLE24001-EC1

CHECKED BY JCM

DRAWN BY CHB

SCALE 1"=30'

DATE 05. 22. 2024

SHEET

EROSION CONTROL DETAILS

C6.10

#### GROUND STABILIZATION AND MATERIALS HANDLING PRACTICES FOR COMPLIANCE WITH THE NCG01 CONSTRUCTION GENERAL PERMIT

mplementing the details and specifications on this plan sheet will result in the construction activity being considered compliant with the Ground Stabilization and Materials Handling sections of the NCG01 Construction General Permit (Sections E and F, respectively). The permittee shall comply with the Erosion and Sediment Control plan approved by the delegated authority having jurisdiction. All details and specifications shown on this sheet may not apply depending on site conditions and the delegated authority having jurisdiction.

	Re	equired Ground Stabil	ization Timeframes
Si	te Area Description	Stabilize within this many calendar days after ceasing land disturbance	Timeframe variations
(a)	Perimeter dikes, swales, ditches, and perimeter slopes	7	None
(b)	High Quality Water (HQW) Zones	7	None
(c)	Slopes steeper than 3:1	7	If slopes are 10' or less in length and are not steeper than 2:1, 14 days are allowed
(d)	Slopes 3:1 to 4:1	14	-7 days for slopes greater than 50' in length and with slopes steeper than 4:1 -7 days for perimeter dikes, swales, ditches, perimeter slopes and HQW Zones -10 days for Falls Lake Watershed
(e)	Areas with slopes flatter than 4:1	14	<ul> <li>-7 days for perimeter dikes, swales, ditches, perimeter slopes and HQW Zone</li> <li>-10 days for Falls Lake Watershed unless there is zero slope</li> </ul>

practicable but in no case longer than 90 calendar days after the last land disturbing activity. Temporary ground stabilization shall be maintained in a manner to render the surface stable against accelerated erosion until permanent ground stabilization is achieved.

#### GROUND STABILIZATION SPECIFICATION

Stabilize the ground sufficiently so that rain will not dislodge the soil. Use one of the techniques in the table below:

Temporary Stabilization
Temporary grass seed covered with s
other mulches and tackifiers

- straw or Permanent grass seed covered with straw or other mulches and tackifiers • Geotextile fabrics such as permanent soil Hydroseeding
- reinforcement matting Rolled erosion control products with or without temporary grass seed Hydroseeding Appropriately applied straw or other mulch
   Shrubs or other permanent plantings covered Plastic sheeting Uniform and evenly distributed ground cover sufficient to restrain erosion
  - Structural methods such as concrete, asphalt or retaining walls Rolled erosion control products with grass seed

#### POLYACRYLAMIDES (PAMS) AND FLOCCULANTS

- . Select flocculants that are appropriate for the soils being exposed during construction, selecting from the NC DWR List of Approved PAMS/Flocculants.
- Apply flocculants at or before the inlets to Erosion and Sediment Control Measures. 3. Apply flocculants at the concentrations specified in the *NC DWR List of Approved*
- PAMS/Flocculants and in accordance with the manufacturer's instructions. 4. Provide ponding area for containment of treated Stormwater before discharging
- Store flocculants in leak-proof containers that are kept under storm-resistant cover or surrounded by secondary containment structures.

#### Maintain vehicles and equipment to prevent discharge of fluids.

to a recycling or disposal center that handles these materials.

**EQUIPMENT AND VEHICLE MAINTENANCE** 

- 2. Provide drip pans under any stored equipment. 3. Identify leaks and repair as soon as feasible, or remove leaking equipment from the
- 4. Collect all spent fluids, store in separate containers and properly dispose as
- hazardous waste (recycle when possible).
- Remove leaking vehicles and construction equipment from service until the problem
- 6. Bring used fuels, lubricants, coolants, hydraulic fluids and other petroleum products

#### ITTER, BUILDING MATERIAL AND LAND CLEARING WASTE

- Never bury or burn waste. Place litter and debris in approved waste containers. Provide a sufficient number and size of waste containers (e.g dumpster, trash receptacle) on site to contain construction and domestic wastes.
- Locate waste containers at least 50 feet away from storm drain inlets and surface waters unless no other alternatives are reasonably available. Locate waste containers on areas that do not receive substantial amounts of runoff
- from upland areas and does not drain directly to a storm drain, stream or wetland. Cover waste containers at the end of each workday and before storm events or provide secondary containment. Repair or replace damaged waste containers.
- Anchor all lightweight items in waste containers during times of high winds. Empty waste containers as needed to prevent overflow. Clean up immediately if
- containers overflow. 8. Dispose waste off-site at an approved disposal facility.

#### **PAINT AND OTHER LIQUID WASTE**

Do not dump paint and other liquid waste into storm drains, streams or wetlands. Locate paint washouts at least 50 feet away from storm drain inlets and surface

9. On business days, clean up and dispose of waste in designated waste containers.

- waters unless no other alternatives are reasonably available. Contain liquid wastes in a controlled area.
- . Containment must be labeled, sized and placed appropriately for the needs of site. . Prevent the discharge of soaps, solvents, detergents and other liquid wastes from construction sites.

#### **PORTABLE TOILETS**

- Install portable toilets on level ground, at least 50 feet away from storm drains, streams or wetlands unless there is no alternative reasonably available. If 50 foot offset is not attainable, provide relocation of portable toilet behind silt fence or place
- on a gravel pad and surround with sand bags. Provide staking or anchoring of portable toilets during periods of high winds or in high
- Monitor portable toilets for leaking and properly dispose of any leaked material. Utilize a licensed sanitary waste hauler to remove leaking portable toilets and replace with properly operating unit.

#### **EARTHEN STOCKPILE MANAGEMENT**

- Show stockpile locations on plans. Locate earthen-material stockpile areas at least 50 feet away from storm drain inlets, sediment basins, perimeter sediment controls and surface waters unless it can be shown no other alternatives are reasonably
- Protect stockpile with silt fence installed along toe of slope with a minimum offset of five feet from the toe of stockpile.

as vegetative, physical or chemical coverage techniques that will restrain accelerated

- . Provide stable stone access point when feasible.
- . Stabilize stockpile within the timeframes provided on this sheet and in accordance with the approved plan and any additional requirements. Soil stabilization is defined

erosion on disturbed soils for temporary or permanent control needs.

#### 1. Do not discharge concrete or cement slurry from the site.

**CONCRETE WASHOUTS** 

- Dispose of, or recycle settled, hardened concrete residue in accordance with local and state solid waste regulations and at an approved facility.
- Manage washout from mortar mixers in accordance with the above item and in addition place the mixer and associated materials on impervious barrier and within
- Install temporary concrete washouts per local requirements, where applicable. If an alternate method or product is to be used, contact your approval authority for review and approval. If local standard details are not available, use one of the two types of temporary concrete washouts provided on this detail.
- Do not use concrete washouts for dewatering or storing defective curb or sidewalk sections. Stormwater accumulated within the washout may not be pumped into or discharged to the storm drain system or receiving surface waters. Liquid waste must be pumped out and removed from project.
- Locate washouts at least 50 feet from storm drain inlets and surface waters unless it can be shown that no other alternatives are reasonably available. At a minimum, install protection of storm drain inlet(s) closest to the washout which could receive
- Locate washouts in an easily accessible area, on level ground and install a stone entrance pad in front of the washout. Additional controls may be required by the approving authority. Install at least one sign directing concrete trucks to the washout within the project
- limits. Post signage on the washout itself to identify this location. Remove leavings from the washout when at approximately 75% capacity to limit overflow events. Replace the tarp, sand bags or other temporary structural
- products, follow manufacturer's instructions. 10. At the completion of the concrete work, remove remaining leavings and dispose of in an approved disposal facility. Fill pit, if applicable, and stabilize any disturbance caused by removal of washout.

components when no longer functional. When utilizing alternative or proprietary

#### HERBICIDES, PESTICIDES AND RODENTICIDES

- Store and apply herbicides, pesticides and rodenticides in accordance with label
- Store herbicides, pesticides and rodenticides in their original containers with the label, which lists directions for use, ingredients and first aid steps in case of accidental poisoning
- Do not store herbicides, pesticides and rodenticides in areas where flooding is possible or where they may spill or leak into wells, stormwater drains, ground water or surface water. If a spill occurs, clean area immediately.
- Do not stockpile these materials onsite.

- Create designated hazardous waste collection areas on-site.
- Place hazardous waste containers under cover or in secondary containment.

#### HAZARDOUS AND TOXIC WASTE

#### 3. Do not store hazardous chemicals, drums or bagged materials directly on the ground.

#### NCG01 GROUND STABILIZATION AND MATERIALS HANDLING

EFFECTIVE: 04/01/19

#### SELF-INSPECTION, RECORDKEEPING AND REPORTING

SECTION A: SELF-INSPECTION Self-inspections are required during normal business hours in accordance with the table below. When adverse weather or site conditions would cause the safety of the inspection personnel to be in jeopardy, the inspection may be delayed until the next business day on which it is safe to perform the inspection. In addition, when a storm event of equal to or greater than 1.0 inch occurs outside of normal business hours, the self-inspection shall be performed upon the commencement of the next business day. Any time when inspections were delayed shall be noted in the Inspection Record.

Inspect	Frequency (during normal business hours)	Inspection records must include:
(1) Rain gauge maintained in good working order	Daily	Daily rainfall amounts.  If no daily rain gauge observations are made during weekend o holiday periods, and no individual-day rainfall information i available, record the cumulative rain measurement for those un attended days (and this will determine if a site inspection i needed). Days on which no rainfall occurred shall be recorded a "zero." The permittee may use another rain-monitoring device approved by the Division.
(2) E&SC Measures	At least once per 7 calendar days and within 24 hours of a rain event ≥ 1.0 inch in 24 hours	<ol> <li>Identification of the measures inspected,</li> <li>Date and time of the inspection,</li> <li>Name of the person performing the inspection,</li> <li>Indication of whether the measures were operating properly,</li> <li>Description of maintenance needs for the measure,</li> <li>Description, evidence, and date of corrective actions taken.</li> </ol>
(3) Stormwater discharge outfalls (SDOs)	At least once per 7 calendar days and within 24 hours of a rain event ≥ 1.0 inch in 24 hours	1. Identification of the discharge outfalls inspected, 2. Date and time of the inspection, 3. Name of the person performing the inspection, 4. Evidence of indicators of stormwater pollution such as oil sheen, floating or suspended solids or discoloration, 5. Indication of visible sediment leaving the site, 6. Description, evidence, and date of corrective actions taken.
(4) Perimeter of site	At least once per 7 calendar days and within 24 hours of a rain event ≥ 1.0 inch in 24 hours	If visible sedimentation is found outside site limits, then a record of the following shall be made:  Actions taken to clean up or stabilize the sediment that has left the site limits,  Description, evidence, and date of corrective actions taken, and an explanation as to the actions taken to control future releases.
(5) Streams or wetlands onsite or offsite (where accessible)	At least once per 7 calendar days and within 24 hours of a rain event ≥ 1.0 inch in 24 hours	If the stream or wetland has increased visible sedimentation or a stream has visible increased turbidity from the construction activity, then a record of the following shall be made:  1. Description, evidence and date of corrective actions taken, and  2. Records of the required reports to the appropriate Division Regional Office per Part III, Section C, Item (2)(a) of this permit.
(6) Ground stabilization measures	After each phase of grading	1. The phase of grading (installation of perimeter E&SC measures, clearing and grubbing, installation of storm drainage facilities, completion of all land-disturbing activity, construction or redevelopment, permanent ground cover).  2. Documentation that the required ground stabilization measures have been provided within the required timeframe or an assurance that they will be provided as soon as possible.

NOTE: The rain inspection resets the required 7 calendar day inspection requirement.

#### SELF-INSPECTION, RECORDKEEPING AND REPORTING

**SECTION B: RECORDKEEPING** 

#### 1. E&SC Plan Documentation

The approved E&SC plan as well as any approved deviation shall be kept on the site. The approved E&SC plan must be kept up-to-date throughout the coverage under this permit. The following items pertaining to the E&SC plan shall be kept on site and available for inspection at all times during normal business hours.

**Documentation Requirements** 

report to indicate the completion of the

(a) Each E&SC measure has been installed and does not significantly deviate from the locations, dimensions and relative elevations shown on the approved E&SC plan.	Initial and date each E&SC measure on a copy of the approved E&SC plan or complete, date and sign an inspection report that lists each E&SC measure shown on the approved E&SC plan. This documentation is required upon the initial installation of the E&SC measures or if the E&SC measures are modified after initial installation.
(b) A phase of grading has been completed.	Initial and date a copy of the approved E&SC plan or complete, date and sign an inspection report to indicate completion of the construction phase.
(c) Ground cover is located and installed in accordance with the approved E&SC plan.	Initial and date a copy of the approved E&SC plan or complete, date and sign an inspection report to indicate compliance with approved ground cover specifications.
(d) The maintenance and repair requirements for all E&SC measures have been performed.	Complete, date and sign an inspection report.
(e) Corrective actions have been taken to E&SC measures.	Initial and date a copy of the approved E&SC plan or complete, date and sign an inspection

2. Additional Documentation to be Kept on Site In addition to the E&SC plan documents above, the following items shall be kept on the site and available for inspectors at all times during normal business hours, unless the Division provides a site-specific exemption based on unique site conditions that make this requirement not practical:

(a) This General Permit as well as the Certificate of Coverage, after it is received.

(b) Records of inspections made during the previous twelve months. The permittee shall record the required observations on the Inspection Record Form provided by the Division or a similar inspection form that includes all the required elements. Use of electronically-available records in lieu of the required paper copies will be allowed if shown to provide equal access and utility as the hard-copy records.

3. Documentation to be Retained for Three Years All data used to complete the e-NOI and all inspection records shall be maintained for a period of three years after project completion and made available upon request. [40 CFR 122.41]

#### PART II, SECTION G, ITEM (4) DRAW DOWN OF SEDIMENT BASINS FOR MAINTENANCE OR CLOSE OUT

Sediment basins and traps that receive runoff from drainage areas of one acre or more shall use outlet structures that withdraw water from the surface when these devices need to be drawn down for maintenance or close out unless this is infeasible. The circumstances in which it is not feasible to withdraw water from the surface shall be rare (for example, times with extended cold weather). Non-surface withdrawals from sediment basins shall be allowed only when all of the following criteria have been met:

- (a) The E&SC plan authority has been provided with documentation of the non-surface withdrawal and the specific time periods or conditions in which it will occur. The non-surface withdrawal shall not commence until the E&SC plan authority has approved these items,
- (b) The non-surface withdrawal has been reported as an anticipated bypass in accordance with Part III, Section C, Item (2)(c) and (d) of this permit, (c) Dewatering discharges are treated with controls to minimize discharges of pollutants from stormwater that is removed from the sediment basin. Examples of appropriate controls include properly sited, designed and maintained dewatering tanks, weir tanks, and filtration systems,
- (d) Vegetated, upland areas of the sites or a properly designed stone pad is used to the extent feasible at the outlet of the dewatering treatment devices described in Item (c) above, (e) Velocity dissipation devices such as check dams, sediment traps, and riprap are provided at the discharge points of all dewatering devices, and
- (f) Sediment removed from the dewatering treatment devices described in Item (c) above is disposed of in a manner that does not cause deposition of sediment into waters of the United States.

#### SELF-INSPECTION, RECORDKEEPING AND REPORTING

#### **SECTION C: REPORTING** 1. Occurrences that Must be Reported

Permittees shall report the following occurrences: (a) Visible sediment deposition in a stream or wetland.

#### (b) Oil spills if:

- They are 25 gallons or more,
- They are less than 25 gallons but cannot be cleaned up within 24 hours,
- They cause sheen on surface waters (regardless of volume), or • They are within 100 feet of surface waters (regardless of volume).
- (c) Releases of hazardous substances in excess of reportable quantities under Section 311 of the Clean Water Act (Ref: 40 CFR 110.3 and 40 CFR 117.3) or Section 102 of CERCLA

#### (d) Anticipated bypasses and unanticipated bypasses.

(Ref: 40 CFR 302.4) or G.S. 143-215.85.


(e) Noncompliance with the conditions of this permit that may endanger health or the

#### 2. Reporting Timeframes and Other Requirements

After a permittee becomes aware of an occurrence that must be reported, he shall contact the appropriate Division regional office within the timeframes and in accordance with the other requirements listed below. Occurrences outside normal business hours may also be reported to the Department's Environmental Emergency Center personnel at (800) 858-0368.

Occurrence	Reporting Timeframes (After Discovery) and Other Requirements
(a) Visible sediment	Within 24 hours, an oral or electronic notification.
deposition in a	Within 7 calendar days, a report that contains a description of the
stream or wetland	sediment and actions taken to address the cause of the deposition.
	Division staff may waive the requirement for a written report on a
	case-by-case basis.
	If the stream is named on the NC 303(d) list as impaired for sediment-
	related causes, the permittee may be required to perform additional
	monitoring, inspections or apply more stringent practices if staff
	determine that additional requirements are needed to assure compliance
	with the federal or state impaired-waters conditions.
(b) Oil spills and	Within 24 hours, an oral or electronic notification. The notification
release of	shall include information about the date, time, nature, volume and
hazardous	location of the spill or release.
substances per Item	
1(b)-(c) above	
(c) Anticipated	A report at least ten days before the date of the bypass, if possible.
bypasses [40 CFR	The report shall include an evaluation of the anticipated quality and
122.41(m)(3)]	effect of the bypass.
(d) Unanticipated	Within 24 hours, an oral or electronic notification.
bypasses [40 CFR	Within 7 calendar days, a report that includes an evaluation of the
122.41(m)(3)]	quality and effect of the bypass.
(e) Noncompliance	Within 24 hours, an oral or electronic notification.
with the conditions	Within 7 calendar days, a report that contains a description of the
of this permit that	noncompliance, and its causes; the period of noncompliance,
may endanger	including exact dates and times, and if the noncompliance has not
health or the	been corrected, the anticipated time noncompliance is expected to
environment[40	continue; and steps taken or planned to reduce, eliminate, and
CFR 122.41(I)(7)]	prevent reoccurrence of the noncompliance. [40 CFR 122.41(I)(6).
	Division staff may waive the requirement for a written report on a

case-by-case basis.

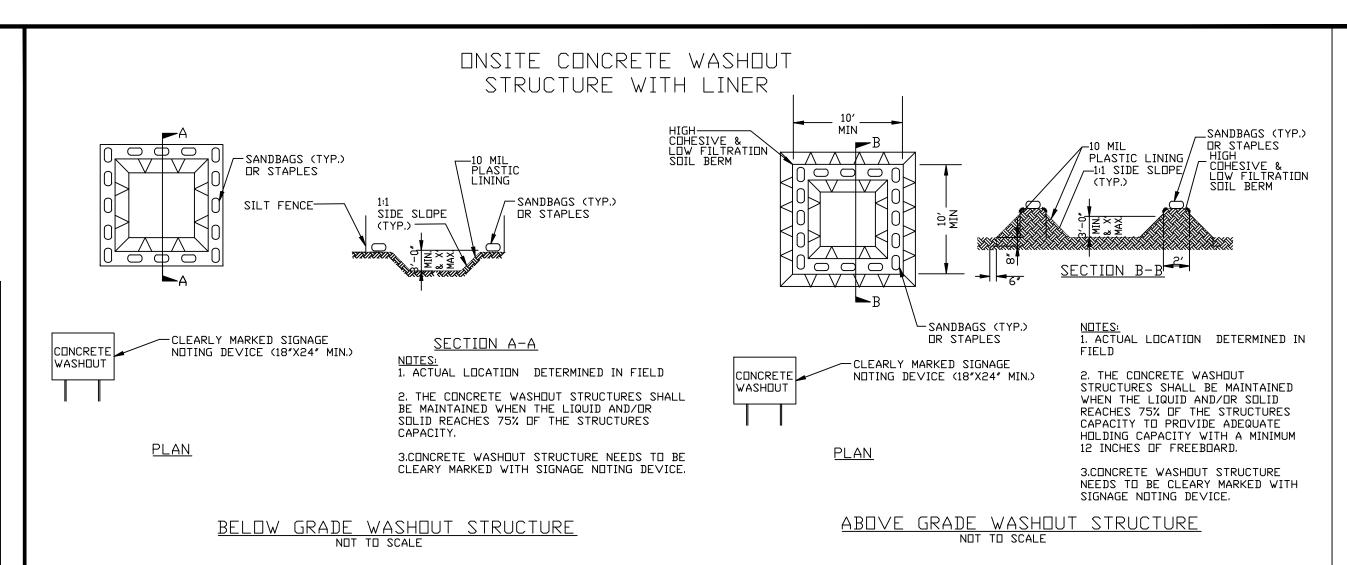

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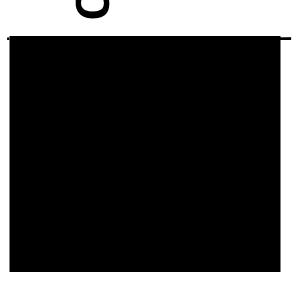
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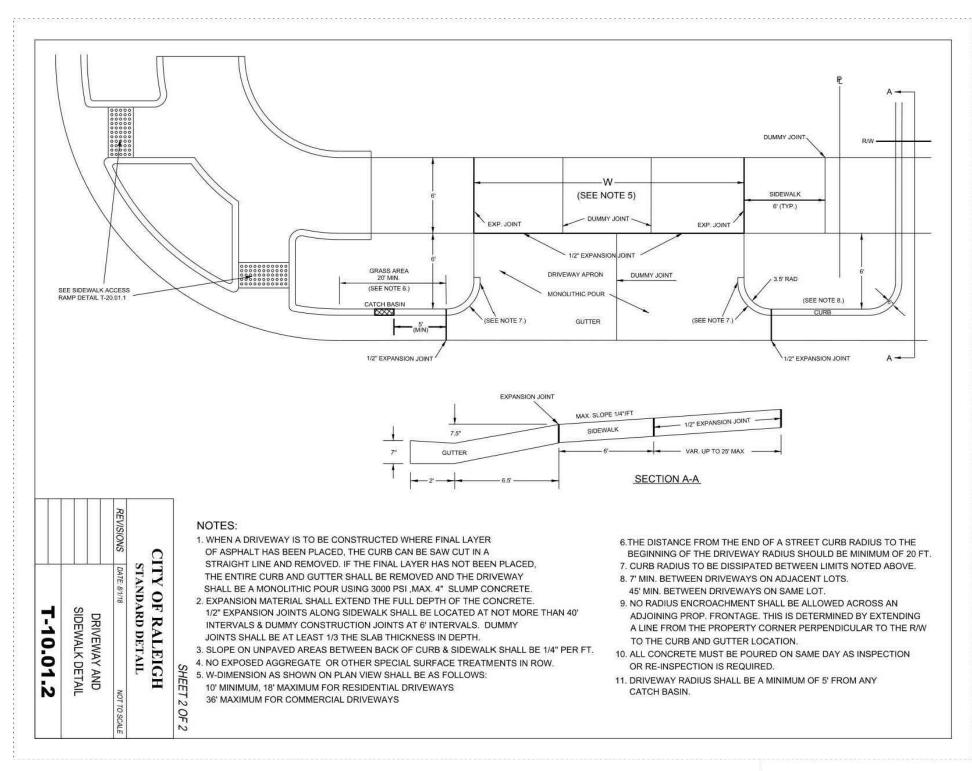
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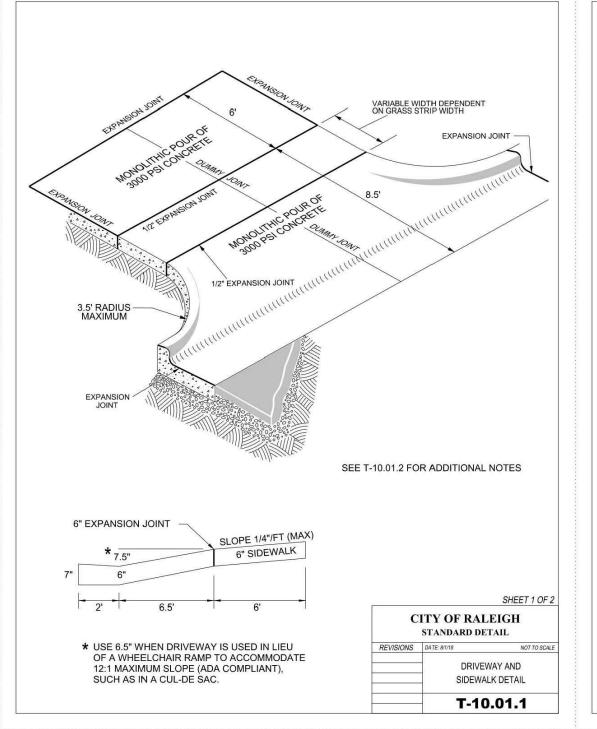
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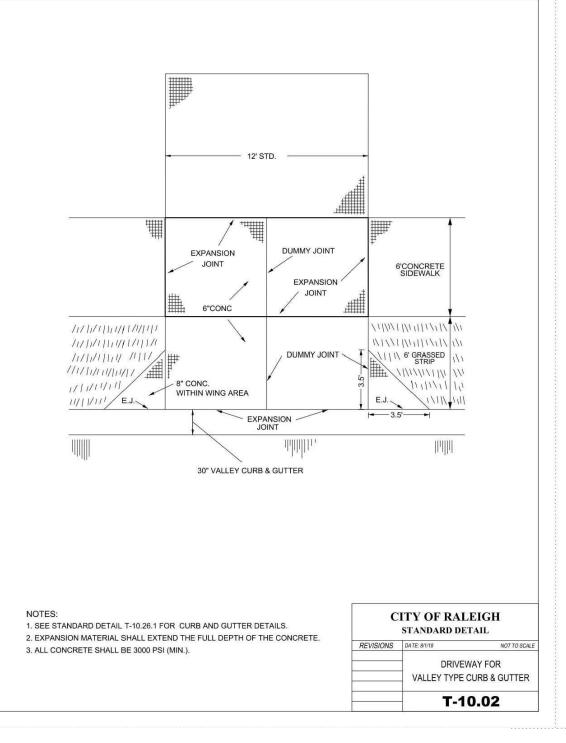
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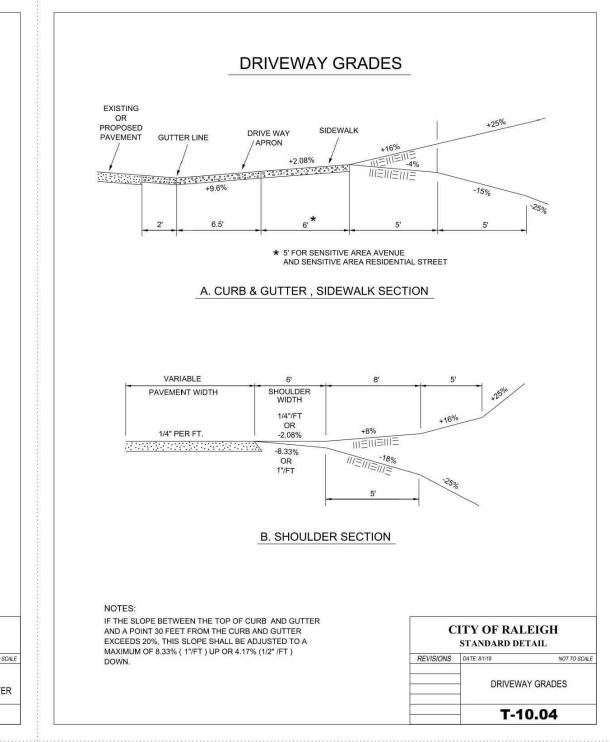
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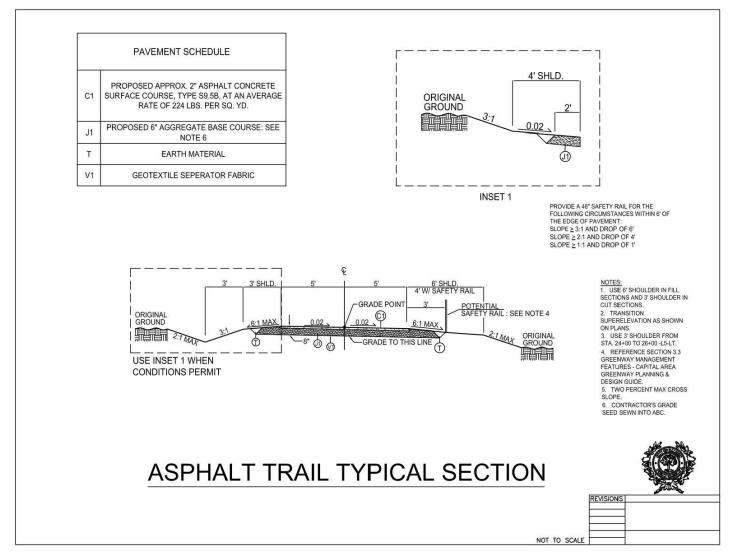
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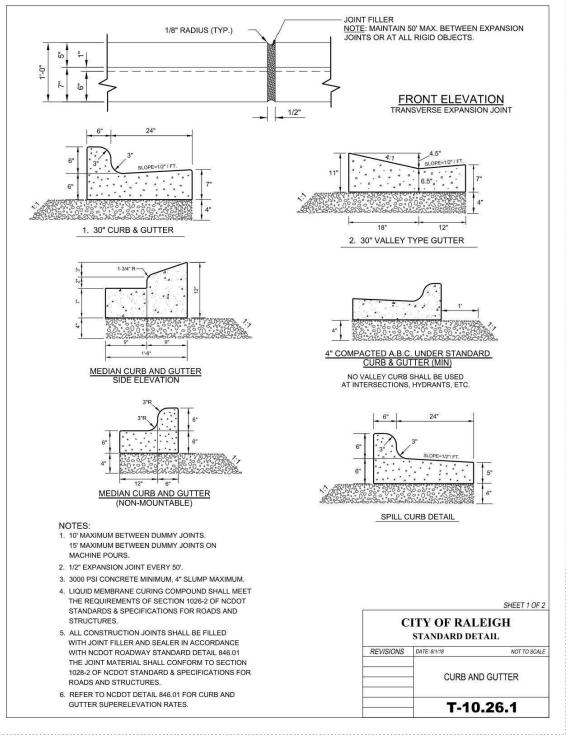













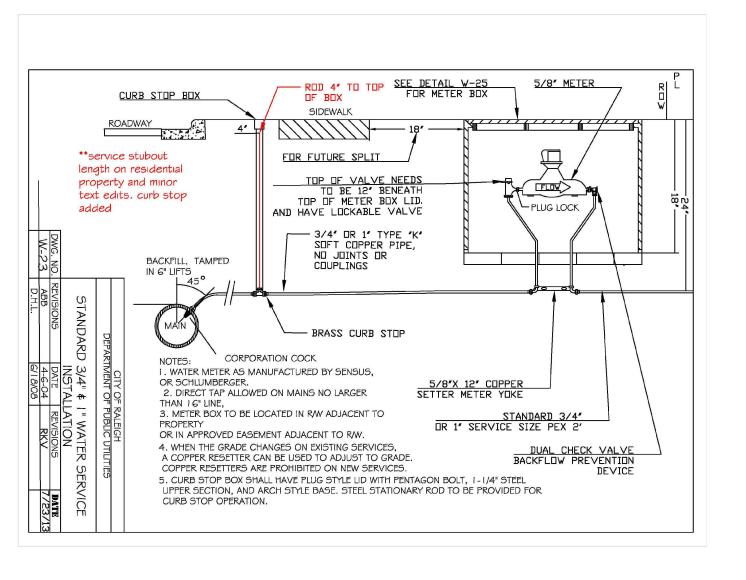



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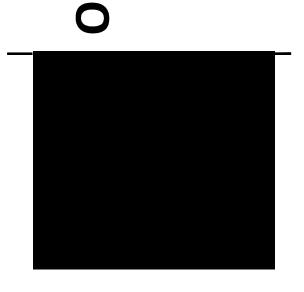
CLIENT

HALLE BUILDING GROUP 56 HUNTER STREET, STE. 110 APEX, NC 27502 PHONE: 919. 387. 1885



# BUILDING GF

DE TOWNE 8-LOT ADDITI PRELIMINARY SUBDIVISION PLAN LOT 10 AND LOTS 4/5



**REVISIONS** 

NO. DATE

PLAN INFORMATION

PROJECT NO. HLE24001

FILENAME HLE24001-D1

CHECKED BY JCM


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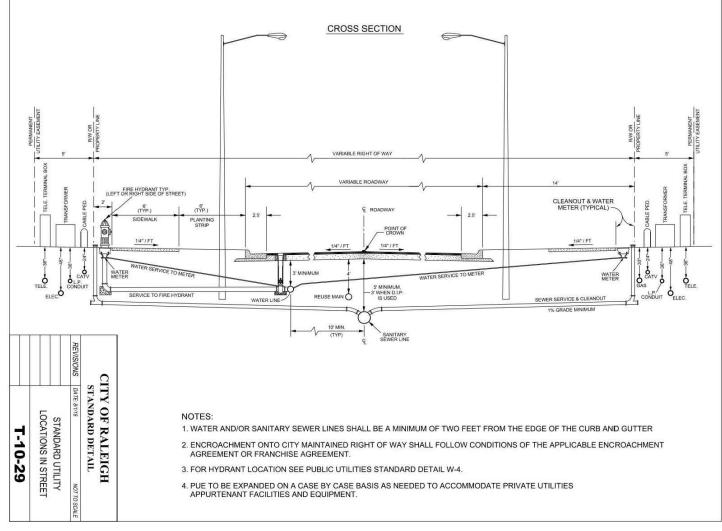
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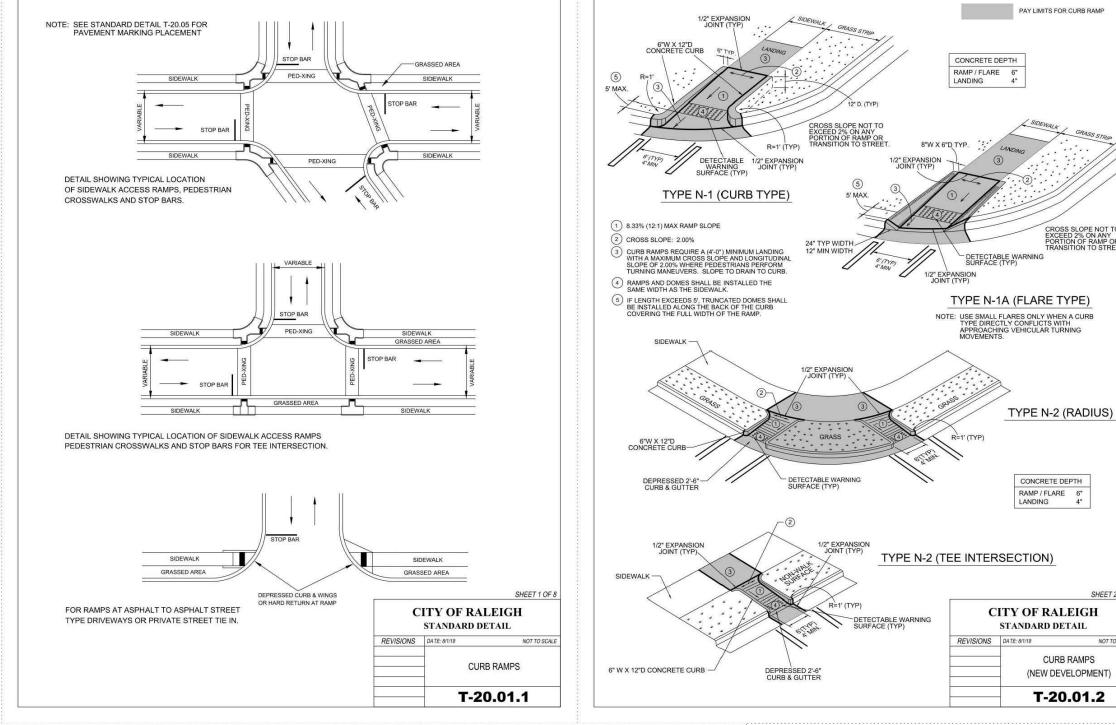
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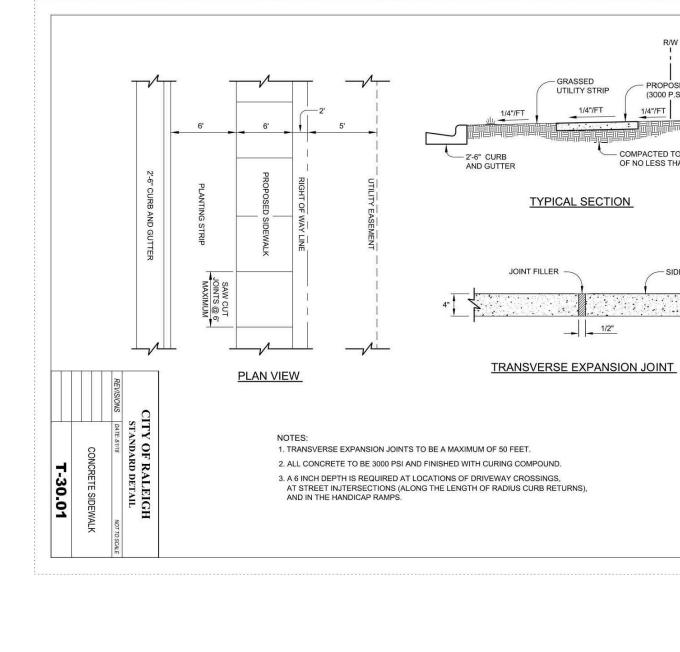
SITE DETAILS


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- CITY OF RALEIGH STANDARD CURB RAMPS HAVE BEEN DEVELOPED IN ACCORDANCE WITH THE AMERICANS WITH DISABILITIES ACT (ADA) AND PUBLIC RIGHT OF WAY ACCESS GUIDELINES (PROWAG).
- 2. CURB RAMPS SHALL BE PROVIDED AT LOCATIONS AS SHOWN ON THE PLANS OR AS DIRECTED BY THE ENGINEER. SIDEWALK ACCESS RAMPS SHALL BE LOCATED AS INDICATED IN THE DETAIL, HOWEVER, THE LOCATION MAY BE ADJUSTED IN COORDINATION WITH THE CITY OF RALEIGH WHERE EXISTING LIGHT POLES, FIRE HYDRANTS, DROP INLETS, ETC. AFFECT PLACEMENT
- 3. DOUBLE WHEELCHAIR RAMPS ARE TO BE INSTALLED AT ALL PUBLIC STREET INTERSECTIONS WHERE SIDEWALK IS REQUIRED.
- THE WALKING SURFACE SHALL BE SLIP RESISTANT. THE COLOR FOR THE DETECTABLE WARNING AREA SHALL BE YELLOW FOR CONTRAST.
- NO SLOPE ON THE SIDEWALK ACCESS RAMP SHALL EXCEED 1"/FT (12:1) IN RELATIONSHIP TO THE GRADE OF THE STREET.
- 6. IN NO CASE SHALL THE WIDTH OF THE SIDEWALK ACCESS RAMP BE LESS THAN 48" ALL RAMPS SHALL BE INSTALLED THE SAME WIDTH AS THE SIDEWALK.
- USE CLASS A (3000 PSI) CONCRETE WITH A SIDEWALK FINISH IN ORDER TO OBTAIN A ROUGH NONSKID SURFACE.
- 8. A 1/2" EXPANSION JOINT INSTALLED FULL DEPTH WILL BE REQUIRED WHERE THE CONCRETE SIDEWALK ACCESS RAMP JOINS THE CURB AND ALSO WHERE NEW CONCRETE ABUTS
- EXISTING CONCRETE.

9. CURB RAMPS SHOULD BE PLACED PARALLEL TO THE DIRECTION OF TRAVEL.

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NOT TO SC	DATE: 8/1/18	REVISIONS
AMP NOTES	CURB RA	

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phone 919. 361. 5000 fax 919. 361. 2269

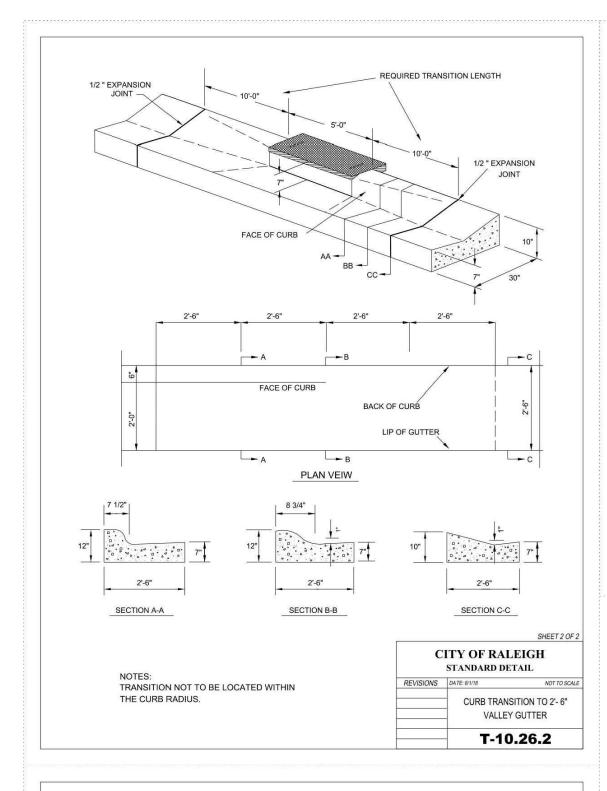www.mcadamsco.com

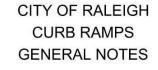license number: C-0293, C-187


#### CLIENT

HALLE BUILDING GROUP 56 HUNTER STREET, STE. 110 APEX, NC 27502 PHONE: 919. 387. 1885



# DITION PLAN

PRELIMINARY SUBDIVISION PL LOT 10 AND LOTS 4/5 RALEIGH, NORTH CAROLINA, 27610

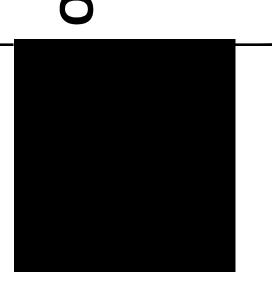

#### **REVISIONS**

NO. DATE

SHEET

#### PLAN INFORMATION

PROJECT NO. HLE24001

FILENAME HLE24001-D1

CHECKED BY JCM


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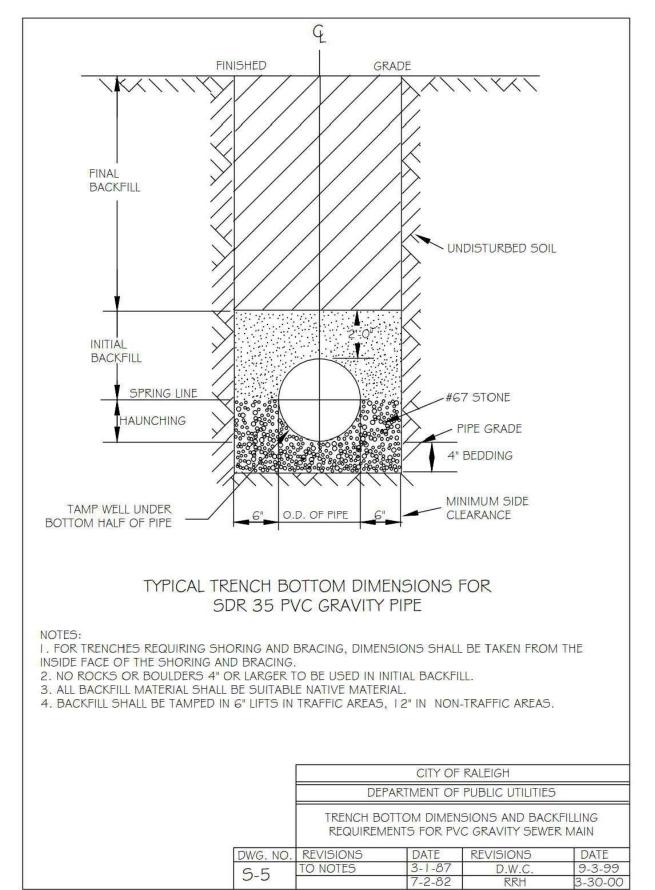
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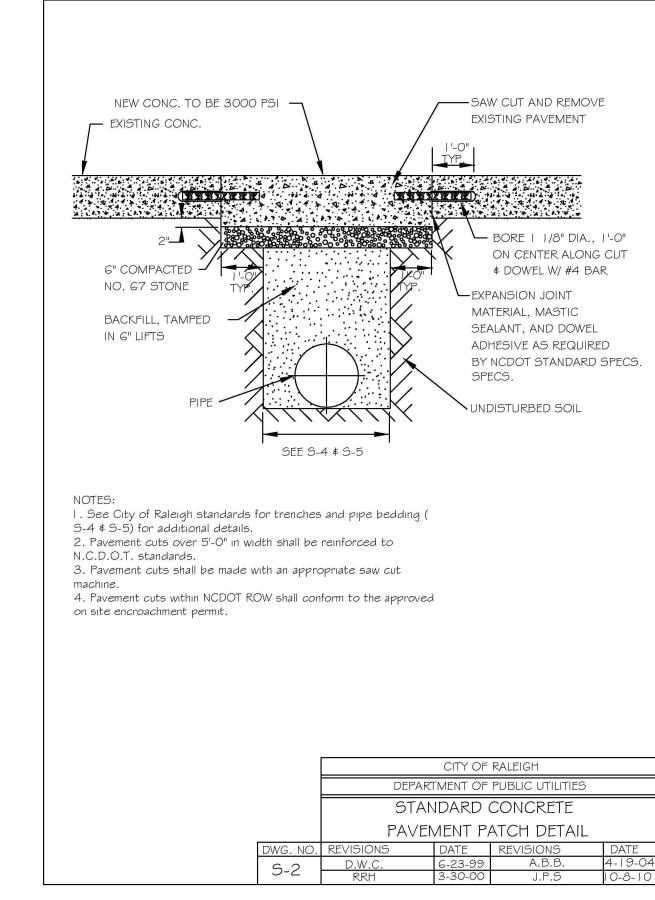
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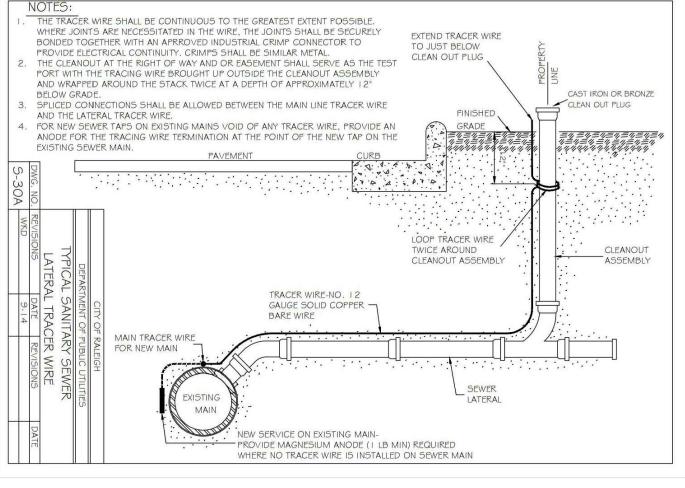
SITE DETAILS


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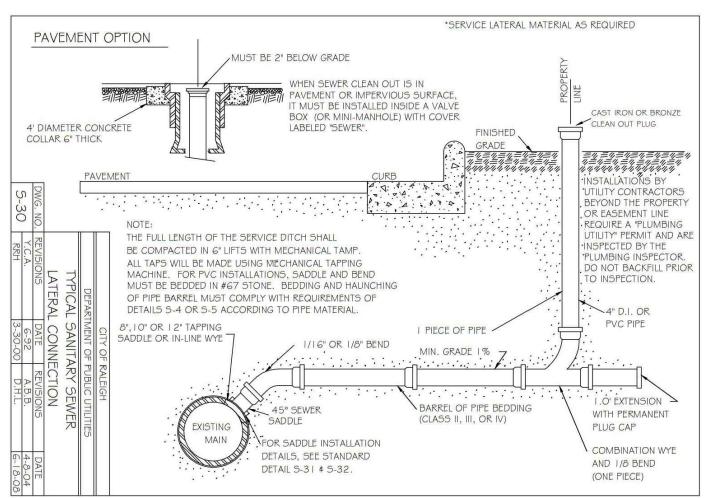








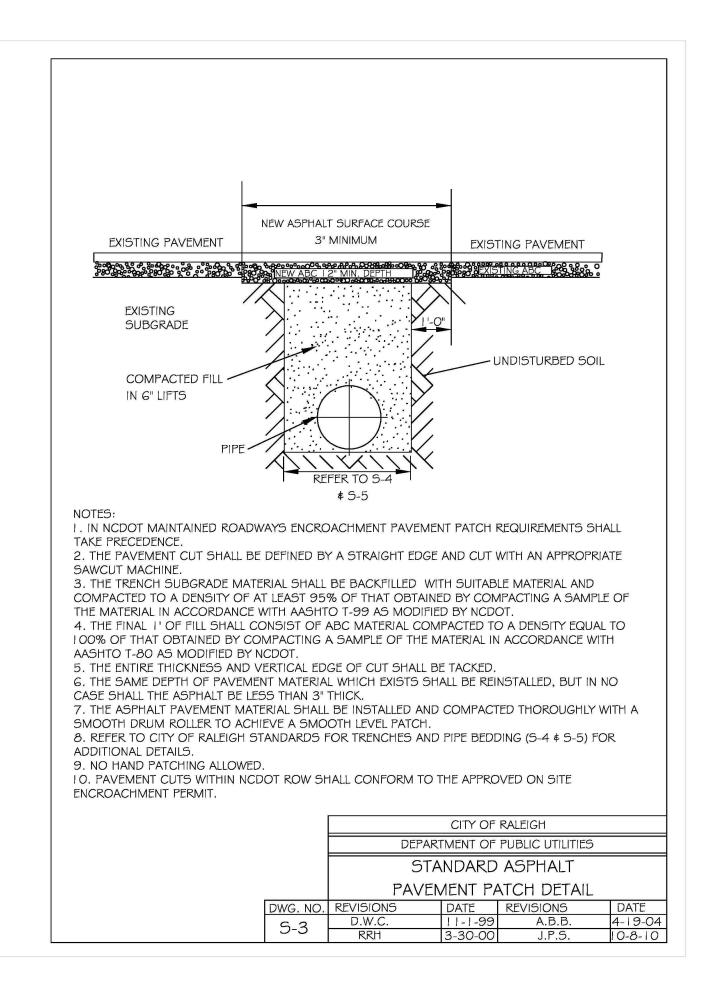

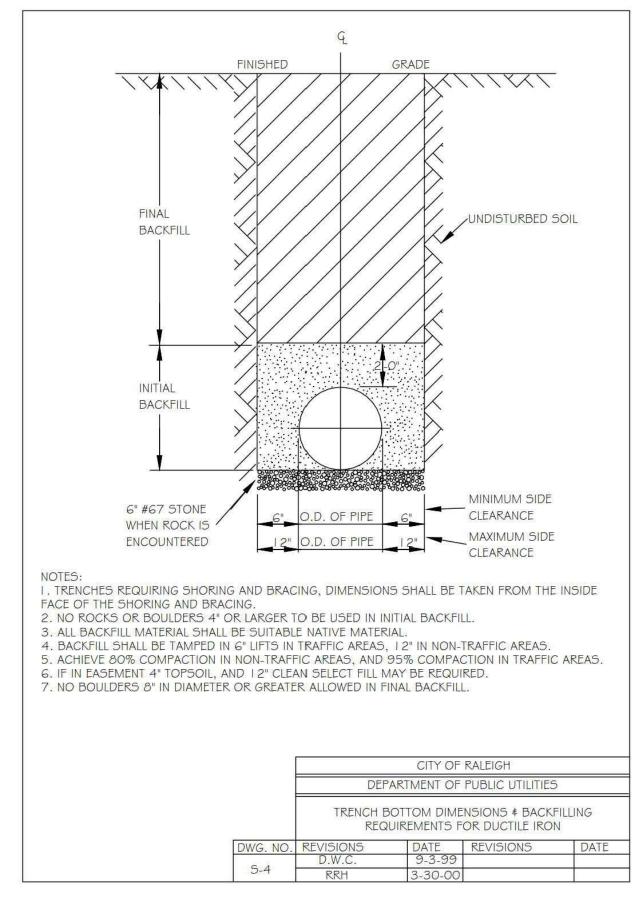



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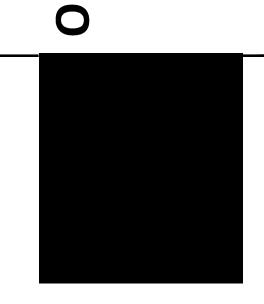
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#### **REVISIONS**


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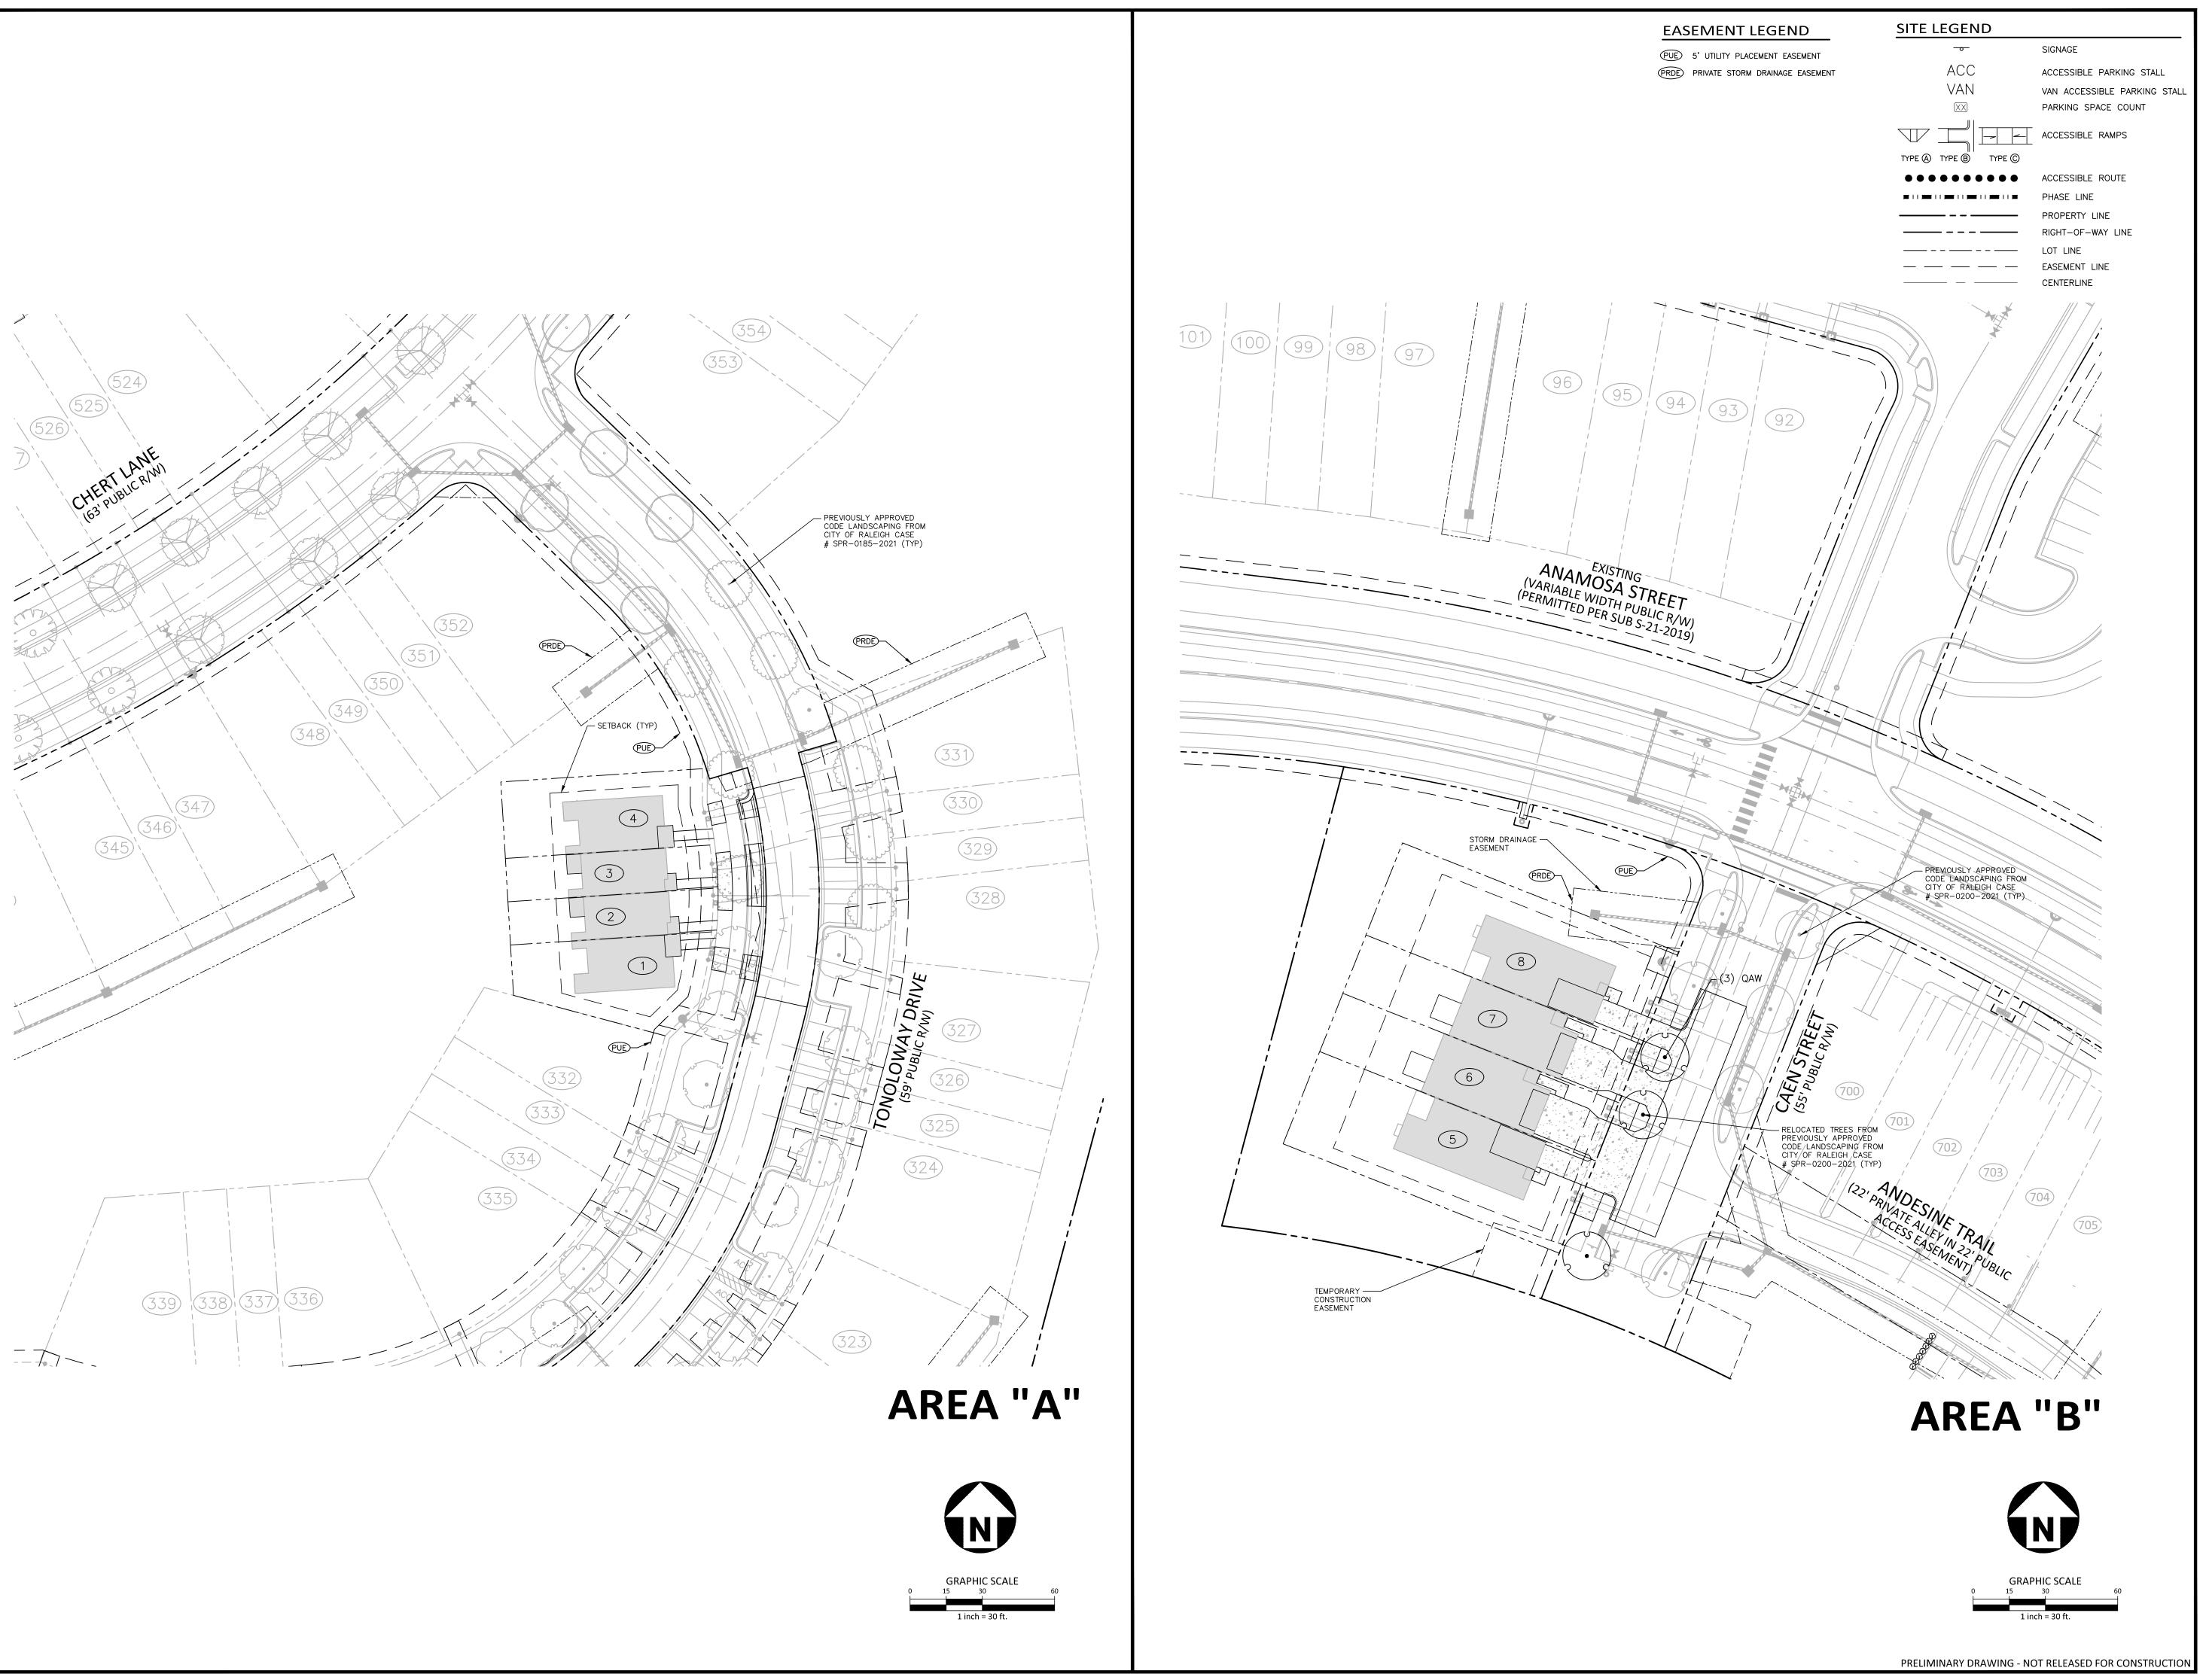
SHEET

#### PLAN INFORMATION

PROJECT NO. HLE24001 FILENAME HLE24001-D1 CHECKED BY DRAWN BY SCALE 1"=30' DATE 05. 22. 2024

UTILITY DETAILS



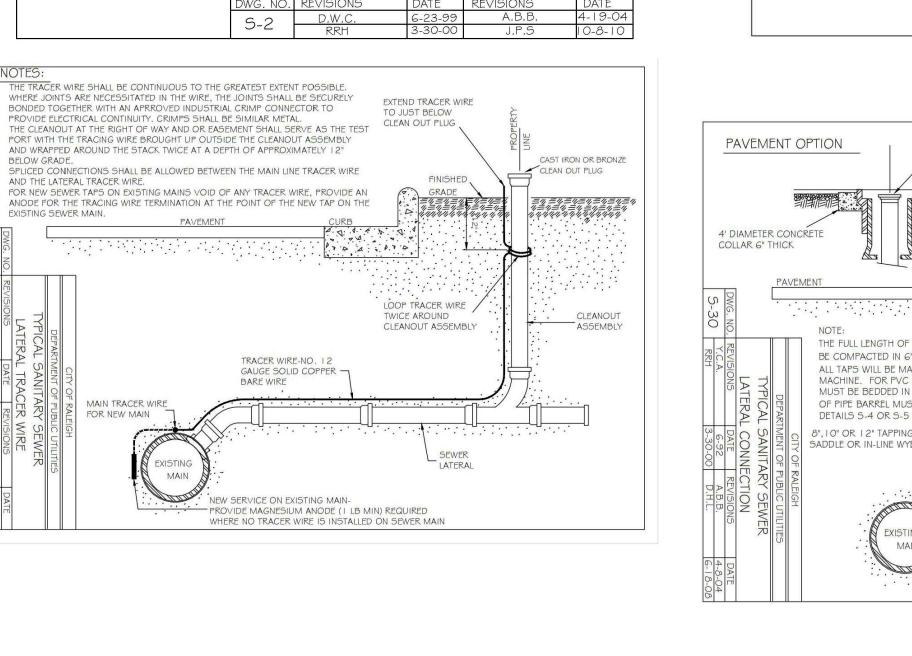



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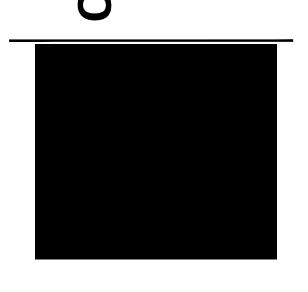
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OLDE TOW PRELIMIN



#### **REVISIONS**

NO. DATE

#### **PLAN INFORMATION**

FILENAME CHECKED BY DRAWN BY SCALE 1"=30' 05. 22. 2024 DATE

SHEET LANDSCAPE PLAN

#### PLANT SCHEDULE - RELOCATED TREES

CODE QTY COMMON NAME BOTANICAL NAME CAL



White Oak


Quercus alba


#### LANDSCAPE NOTES

- 1. ALL MATERIALS AND METHODS OF CONSTRUCTION SHALL BE IN ACCORDANCE WITH THE CITY OF RALEIGH AND THE STATE OF NORTH CAROLINA STANDARDS AND SPECIFICATIONS. 2. CONTRACTOR IS RESPONSIBLE FOR THE SITE INSPECTION BEFORE LANDSCAPE CONSTRUCTION AND INSTALLATION IN ORDER TO BECOME FAMILIAR WITH THE EXISTING CONDITIONS.
- 3. LANDSCAPE CONTRACTOR IS RESPONSIBLE FOR LOCATING ALL UNDERGROUND UTILITIES BEFORE BEGINNING DEMOLITION OR INSTALLATION.
- 4. CONTRACTOR SHALL NOTIFY LANDSCAPE ARCHITECT OF ANY DISCREPANCIES BETWEEN THE NOTES, SPECIFICATIONS, DRAWINGS OR SITE CONDITIONS FOR RESOLUTION PRIOR TO
- 5. ANY DAMAGE TO UTILITIES SHALL BE REPAIRED AT THE CONTRACTOR'S EXPENSE.
- 6. THIS PLAN IS FOR PLANTING PURPOSES ONLY. FOR INFORMATION REGARDING BUILDINGS, GRADING, WALLS, ETC., REFER TO ARCHITECTURE, SITE AND GRADING PLANS.
- 7. VERIFICATION OF TOTAL PLANT QUANTITIES AS SHOWN IN THE PLANT SCHEDULE SHALL BE THE RESPONSIBILITY OF THE LANDSCAPE CONTRACTOR. ANY DISCREPANCIES SHALL BE BROUGHT TO
- 8. CONTRACTOR TO ENSURE PROPER STABILIZATION AND SEEDING OF THE SITE IN ACCORDANCE WITH APPLICABLE REGULATIONS.
- 9. LANDSCAPE MATERIAL SHALL BE WELL FORMED, VIGOROUS, GROWING SPECIMENS WITH GROWTH TYPICAL OF VARIETIES SPECIFIED AND SHALL BE FREE FROM DAMAGE, INSECTS AND DISEASES. MATERIAL SHALL EQUAL OR SURPASS #1 QUALITY AS DEFINED IN THE CURRENT ISSUE OF "AMERICAN STANDARD FOR NURSERY STOCK" AS PUBLISHED BY THE AMERICAN NURSERY & LANDSCAPE ASSOCIATION.
- 10. ALL PLANT MATERIAL IS TO BE CAREFULLY HANDLED BY THE ROOT BALL, NOT THE TRUNK, BRANCHES AND/OR FOLIAGE OF THE PLANT. MISHANDLED PLANT MATERIAL MAY BE REJECTED BY THE LANDSCAPE ARCHITECT
- 11. ALL PLANT MATERIAL IS TO BE WELL ROOTED, NOT ROOT BOUND, SUCH THAT THE ROOT BALL REMAINS INTACT THROUGHOUT THE PLANTING PROCESS. DEFICIENT PLANT MATERIAL MAY BE REJECTED BY THE LANDSCAPE ARCHITECT OR OWNER.
- 12. ALL PLANTS TO BE A MINIMUM OF WHAT IS SPECIFIED IN THE PLANT SCHEDULE. ANY CHANGES OR SUBSTITUTIONS SHALL BE APPROVED BY THE LANDSCAPE ARCHITECT AND GOVERNING JURISDICTION PRIOR TO ANY HOLE BEING DUG.
- 13. CONTRACTOR TO COORDINATE WITH OWNER'S REPRESENTATIVE AND LANDSCAPE ARCHITECT TO ESTABLISH THE EXTENTS OF MULCH/SEED/SOD IF NOT SPECIFICALLY SHOWN ON PLANS.
- 14. CONTRACTOR SHALL PROVIDE POSITIVE DRAINAGE IN ALL PLANTING AREAS.
- 15. PROPOSED TREES TO BE PLANTED A MINIMUM 10 FEET FROM ANY LIGHT POLE AS MEASURED FROM TRUNK OF THE TREE TO THE POLE.
- 16. PROPOSED TREES TO BE PLANTED A MINIMUM 5 FEET FROM ANY FIRE HYDRANT AS MEASURED FROM TRUNK OF THE TREE TO THE HYDRANT.
- 17. CONTRACTOR SHALL COMPLETE SOIL TEST IN ALL PLANTING AREAS TO DETERMINE SOIL AMENDMENT REQUIREMENTS UNLESS WAIVED BY OWNER'S REPRESENTATIVE. CONTRACTOR SHALL ADJUST PH AND FERTILITY BASED UPON THE SOIL TEST RESULTS.
- 18. TOPSOIL SHALL BE FREE OF MATERIAL LARGER THAN 1.0 INCH IN DIAMETER OR LENGTH AND SHALL NOT CONTAIN SLAG, CINDERS, STONES, LUMPS OF SOIL, STICKS, ROOTS, TRASH, OR OTHER
- 19. LOOSEN SUBGRADE / SURFACE SOIL TO A MINIMUM DEPTH OF 6 INCHES. APPLY SOIL AMENDMENTS AND FERTILIZERS AS REQUIRED BY THE SOIL TEST RESULTS TO ACHIEVE A HEALTHY GROWING MEDIA AND MIX THOROUGHLY INTO TOP 4 INCHES OF SOIL. SPREAD PLANTING SOIL MIX TO A DEPTH OF 6 INCHES BUT NOT LESS THAN REQUIRED TO MEET FINISH GRADES AFTER NATURAL SETTLEMENT. DO NOT SPREAD IF PLANTING SOIL OR SUBGRADE IS FROZEN, MUDDY, OR EXCESSIVELY WET.
- 20. IF IMPORTED TOPSOIL IS REQUIRED, THE SUBGRADE SHALL BE SCARIFIED OR TILLED TO A DEPTH OF AT LEAST 6 INCHES PRIOR TO INSTALLATION OF IMPORTED TOPSOIL. FOLLOWING INSTALLATION OF IMPORTED TOPSOIL, THE TOPSOIL SHALL BE TILLED TO INTEGRATE THE SOIL PROFILES.
- 21. PLANT MATERIALS ARE TO BE GUARANTEED FOR A PERIOD OF 12 MONTHS. PLANT MATERIALS WHICH REMAIN UNHEALTHY WILL BE REPLACED BY THE LANDSCAPE CONTRACTOR BEFORE THE EXPIRATION OF THE GUARANTEE PERIOD OR IMMEDIATELY IF SO DIRECTED BY THE OWNER'S REPRESENTATIVE OR LANDSCAPE ARCHITECT.
- 22. ALL TREE PLANTINGS SHALL BE MULCHED TO A DEPTH OF 3 INCHES, AND WITH A MINIMUM 3 FOOT RADIUS FROM BASE OF TREE OR TO DRIPLINE. MULCH SHALL BE FREE OF TRASH AND MAINTAINED WEED FREE. MULCH SHALL NOT COVER THE ROOT FLARE. CONFIRM MULCH SPECIFICATIONS WITH OWNER'S REPRESENTATIVE OR LANDSCAPE ARCHITECT.
- 23. DO NOT PRUNE TREES AND SHRUBS BEFORE DELIVERY. PROTECT BARK, BRANCHES, AND ROOT SYSTEMS FROM SUN SCALD, DRYING, SWEATING, WHIPPING, AND OTHER HANDLING AND TYING DAMAGE. DO NOT BEND OR BIND-TIE TREES OR SHRUBS IN SUCH A MANNER AS TO DESTROY THEIR NATURAL SHAPE. PROVIDE PROTECTIVE COVERING OF EXTERIOR PLANTS DURING DELIVERY. DO NOT DROP EXTERIOR PLANTS DURING DELIVERY AND HANDLING.
- 24. DELIVER EXTERIOR PLANTS AFTER PREPARATIONS FOR PLANTING HAVE BEEN COMPLETED AND INSTALL IMMEDIATELY. IMMEDIATELY AFTER UNLOADING, STAND THE TREES UP TO REDUCE THE RISK OF SUN SCALD. PROPERLY STAGED TREES ARE STANDING, UNTIED AND SPACED. UNLESS IMMEDIATELY INSTALLED, SET EXTERIOR PLANTS AND TREES IN SHADE, PROTECT FROM WEATHER AND MECHANICAL DAMAGE, AND KEEP ROOTS MOIST.
- 25. SEE LANDSCAPE DETAILS FOR TREE STAKING REQUIREMENTS.
- 26. CONTRACTOR SHALL REMOVE DEBRIS AND FINE GRADE ALL PLANTING AREAS PRIOR TO INSTALLATION.
- 27. REMOVE GUY WIRES AND STAKES AT END OF WARRANTY PERIOD OR ESTABLISHMENT
- 28. FINISH GRADING: GRADE PLANTING AREAS TO A SMOOTH, UNIFORM SURFACE PLANE WITH LOOSE, UNIFORMLY FINE TEXTURE. GRADE TO WITHIN PLUS OR MINUS 1/2 INCH OF FINISH ELEVATION. ROLL AND RAKE, REMOVE RIDGES, AND FILL DEPRESSIONS TO MEET FINISH GRADES. LIMIT FINISHED GRADING TO AREAS THAT CAN BE PLANTED IN THE IMMEDIATE FUTURE.
- 29. ALL TREES LOCATED WITHIN SIGHT DISTANCE TRIANGLES SHALL BE LIMBED UP TO A HEIGHT OF 8 FEET. HIGHER CALIPER AT INSTALLATION MAY BE NECESSARY.

#### NOTES

- 1. MEDIUM, DECIDUOUS SHADE TREES ARE SHOWN IN FRONT OF TOWNHOME LOTS DUE TO LIMITED PLANTING SPACE, UTILITY CONFLICT MINIMIZATION, AND PROXIMITY TO DRIVEWAYS. LARGE, MATURING DECIDUOUS STREET TREES ARE SHOWN IN AREAS WHERE LIMITATIONS DO NOT EXIST.
- STREET TREES SHALL BE INSTALLED AND MAINTAINED IN ACCORDANCE WITH THE REQUIREMENTS OF CHAPTER 2 OF THE CITY TREE MANUAL. STREET TREES BETWEEN DRIVEWAYS IN FRONT OF TOWNHOMES SHALL HAVE A MINIMUM OF 600 CUBIC FEET OF SOIL VOLUME AS DESCRIBED IN CHAPTER 2 OF THE CITY TREE MANUAL. SEE CITY OF RALEIGH DETAIL TPP-07, THIS SHEET FOR THE REQUIRED UNDERGROUND ROOT CHANNELS. COORDINATE WITH
- UTILITY INSTALLATION AND CITY OF RALEIGH URBAN FORESTRY INSPECTIONS. 4. ALL MECHANICAL EQUIPMENT SHALL BE SCREENED. SEE LANDSCAPE DETAILS ON SHEET L5.03 FOR TYPICAL SCREENING REQUIREMENTS. ADDITIONAL PLANT MATERIAL WILL BE REQUIRED THAT IS NOT SHOWN ON THE PLANT SCHEDULE. 5. STREET TREES SHALL BE LOCATED NO CLOSER THAN 30' FROM STOP SIGNS, 10' ON EITHER SIDE OF UTILITY PIPES, 10' FROM DRIVEWAY, 10' FROM A FIRE HYDRANT AND 20' FROM ANY LIGHT POLES. SEE RALEIGH CITY TREE MANUAL FOR ADDITIONAL MINIMUM SEPARATIONS FROM SITE ELEMENTS TO STREET
- 6. CONTRACTOR SHALL REPLACE ANY EXISTING STREET TREE WHICH IS DAMAGED OR DESTROYED DURING CONSTRUCTION WITH AN EQUAL SPECIES AND SIZE
- TO BE APPROVED BY LANDSCAPE ARCHITECT AND/OR GOVERNING AGENCY. 7. ALL EXISTING STREET TREES AND THEIR CRITICAL ROOT ZONES SHALL BE PROTECTED TO THE MAXIMUM EXTENT POSSIBLE THROUGHOUT CONSTRUCTION.
- 8. ALL TREES LOCATED WITHIN SIGHT DISTANCE TRIANGLES SHALL BE LIMBED UP TO A MINIMUM 8' ABOVE FINISHED GRADE. 9. A TREE IMPACT PERMIT IS REQUIRED FOR TREES INSTALLED WITHIN THE PUBLIC RIGHTS-OF-WAY AND WILL BE ISSUED WITH BUILDING PERMITS.

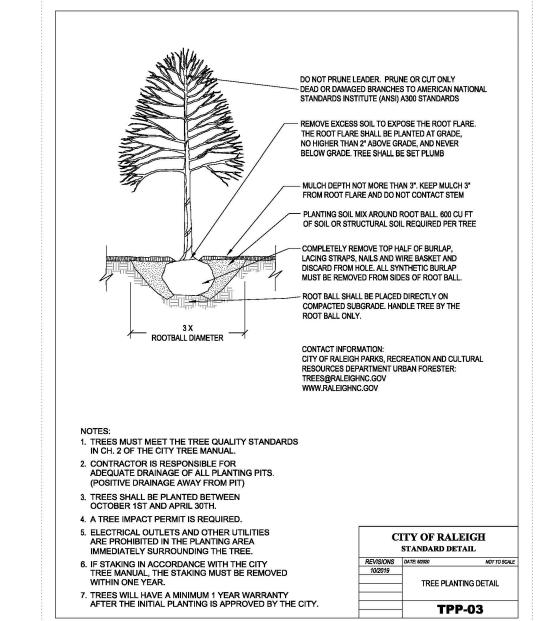

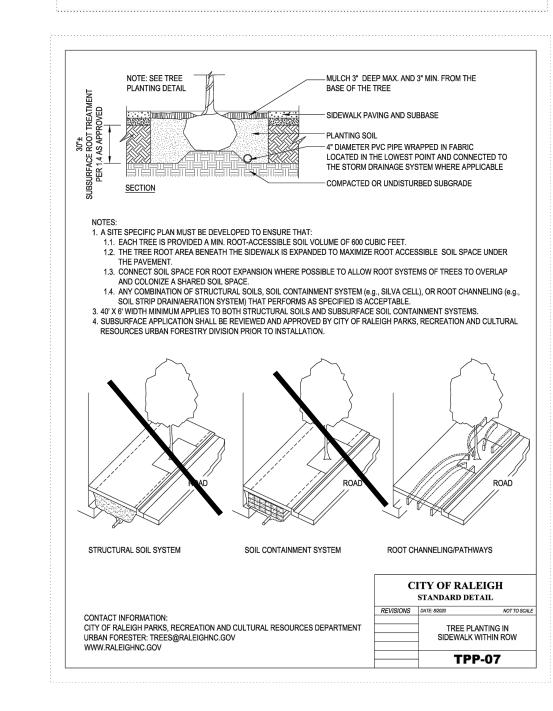



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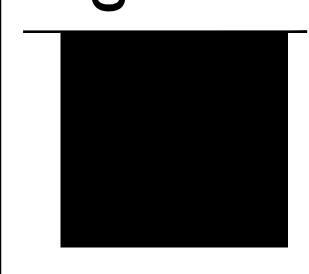
Raleigh, NC 27603

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#### **REVISIONS**


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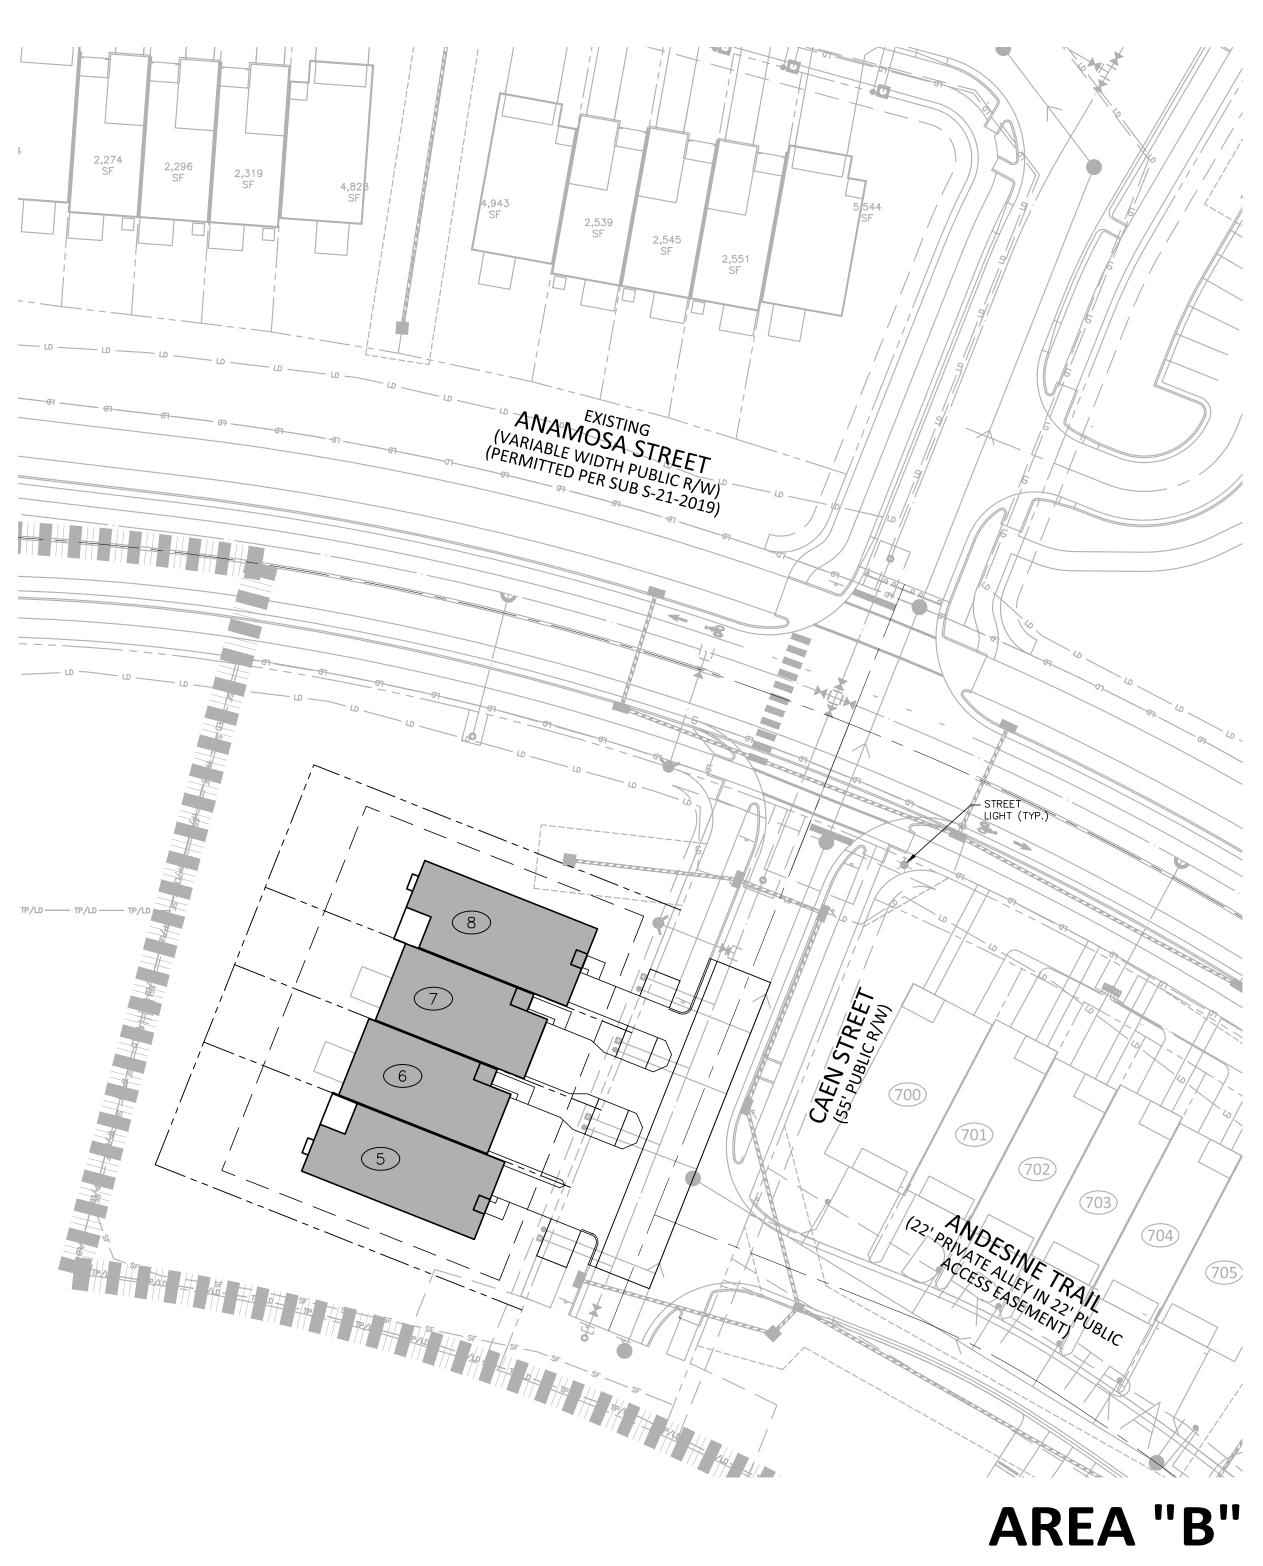
#### PLAN INFORMATION

PROJECT NO. HLE24001 FILENAME HLE24001-LS1 CHECKED BY DRAWN BY 1"=30' SCALE DATE 05. 22. 2024

SHEET

**LANDSCAPE NOTES AND DETAILS** 



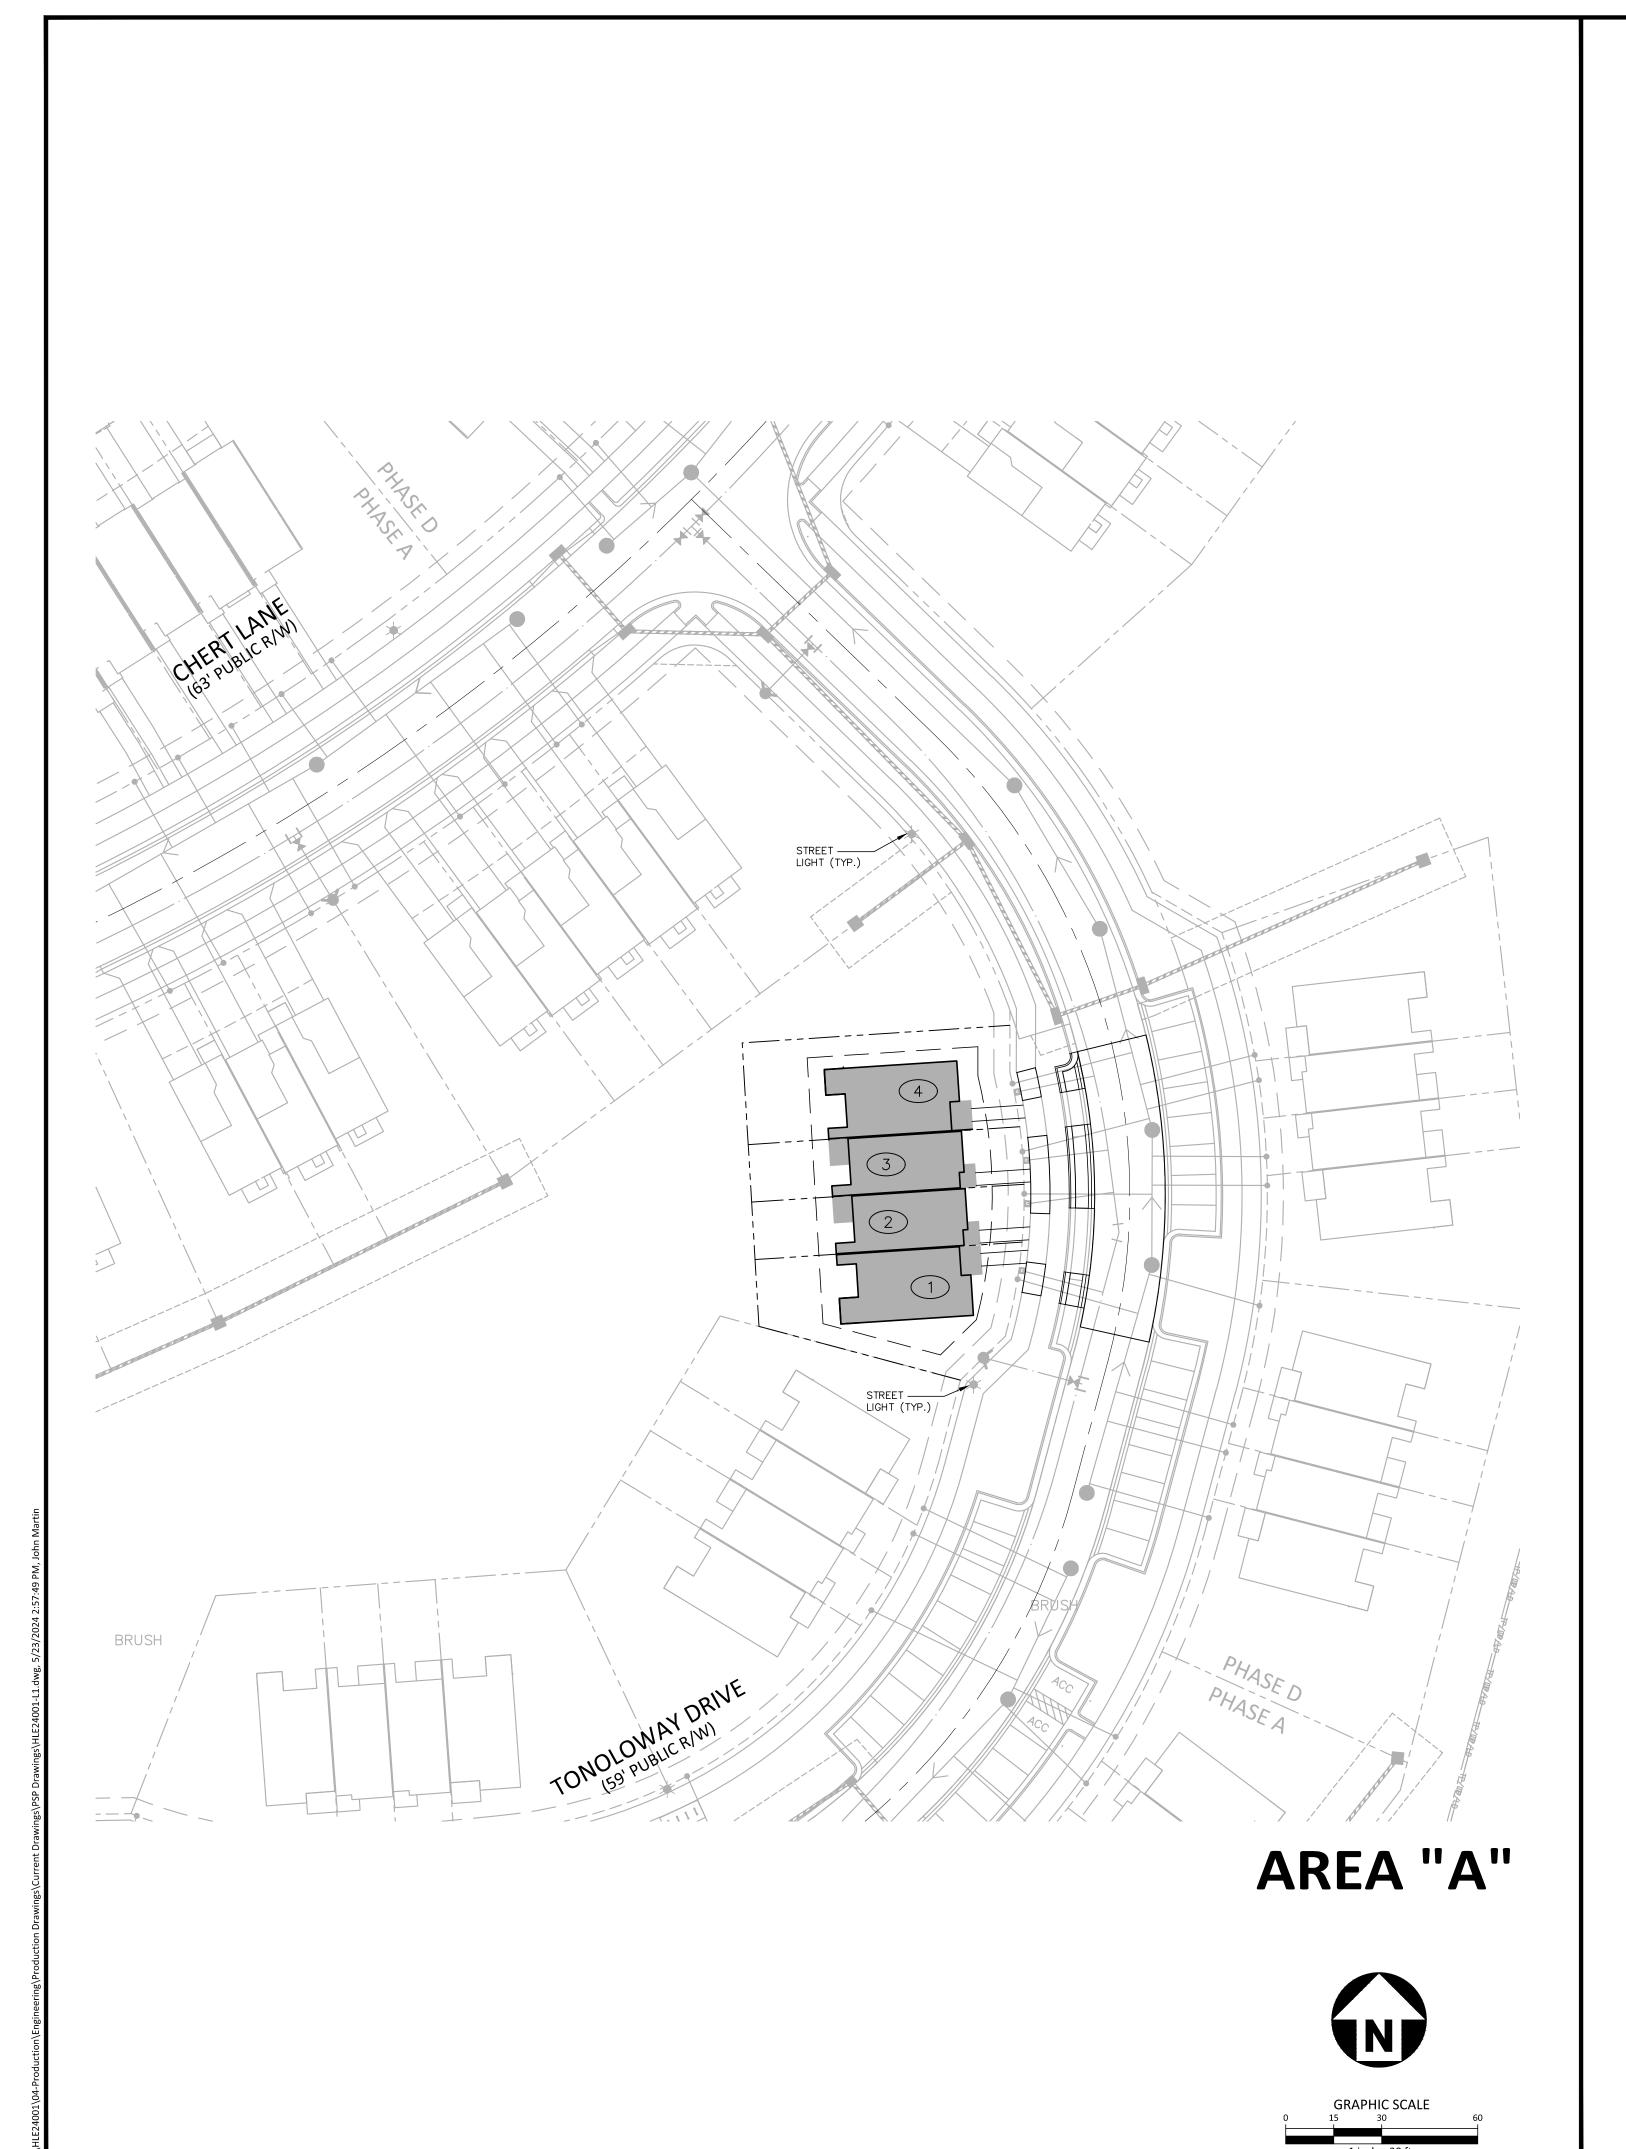



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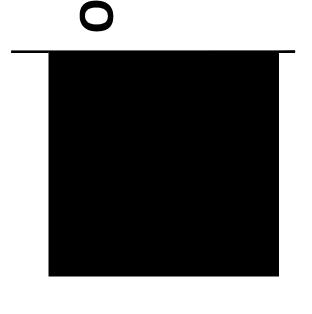
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OLDE TOW
PRELIMINA



#### **REVISIONS**

#### **PLAN INFORMATION**

FILENAME CHECKED BY 1"=30' SCALE

05. 22. 2024 DATE SHEET

LIGHTING PERFORMANCE PLAN

L6.00

PRELIMINARY DRAWING - NOT RELEASED FOR CONSTRUCTION