



# Administrative Approval Action

Case File / Name: SUB-0034-2023  
DSLC - Yardly Buffaloe Village

City of Raleigh  
Development Services Department  
One Exchange Plaza  
Raleigh, NC 27602  
(919) 996-2492  
currentplanning@raleighnc.gov  
www.raleighnc.gov

**LOCATION:** The project is located on the southeast corner of Buffaloe Road and Forestville Road and is approximately 37.1 acres in size (22.74 ac zoned CX-3-CU and 14.36 ac zoned RX-3-CU). Single-family dwellings, zoned R-6, border the southern boundary line. This site is outside the city limits.

**REQUEST:** The project is requesting approval of a subdivision to create seven Open Lots which will eventually be developed with a total of 222 dwelling units as well as a public and private street system.

**DESIGN  
ADJUSTMENT(S)/  
ALTERNATES, ETC:** ASR-0059-2023: DSLC - Administrative Site Review [ASR]/Administrative Site Review  
ASR-0060-2023: DSLC - Administrative Site Review [ASR]/Administrative Site Review  
ASR-0061-2023: DSLC - Administrative Site Review [ASR]/Administrative Site Review  
ASR-0067-2023: DSLC - Administrative Site Review [ASR]/Administrative Site Review

**FINDINGS:** City Administration finds that this request, with the below conditions of approval being met, conforms to the Unified Development Ordinance. This approval is based on a preliminary plan dated February 6, 2024 by TM BTR of Carolinas LLC.

## **CONDITIONS OF APPROVAL and NEXT STEPS:**

*This document must be applied to the second sheet of all future submittals except for final plats. This is a preliminary plan and as such no permits have been issued with this approval. To obtain permits and/or completion of the project, the following steps are required:*

☒ **SITE PERMITTING REVIEW** - For land disturbance of 12,000 square feet or greater, public or private infrastructure, shared stormwater devices, etc. Site Permitting Review may be submitted upon receipt of this signed approval document.

***The following items are required prior to approval of Site Permitting Review plans:***

### **General**

1. A segment of Primary Tree Conservation Area - Neuse Buffer Zone 2 (0.24 acres) narrows to a width less than 20' which is impermissible per UDO 9.1.4.D.1. Prior to SPR, remove the portion of Primary Tree Conservation Area - Neuse Buffer Zone 2 (0.24 acres) that is less than 20' wide, adjust the acreage provided in the standardized label, and update the Tree Conservation Plan Data Sheet.

### **Engineering**

2. Required NCDOT encroachment and/or driveway permits must be approved and copies provided to the City of Raleigh Transportation Department – Mobility Strategy and Infrastructure Division prior to Site Permit review approval.

### **Public Utilities**



# Administrative Approval Action

Case File / Name: SUB-0034-2023  
DSLC - Yardly Buffaloe Village

City of Raleigh  
Development Services Department  
One Exchange Plaza  
Raleigh, NC 27602  
(919) 996-2492  
currentplanning@raleighnc.gov  
www.raleighnc.gov

3. A Downstream Sewer Capacity Study in compliance with the City of Raleigh Public Utilities Department Handbook shall be submitted by the Project Engineer for review and approval.
4. Review and adjust SPR plans according to recommendations.

## Stormwater

5. A surety equal to of the cost of clearing, grubbing and reseeding a site, shall be paid to the City (UDO 9.4.4).
6. A nitrogen offset payment must be made to a qualifying mitigation bank (UDO 9.2.2.B).
7. A stormwater control plan with a stormwater operations and maintenance manual and budget shall be approved (UDO 9.2).

## Urban Forestry

8. Submit a final tree conservation plan that includes metes and bounds descriptions of all tree conservation areas and tree protection fencing as required (UDO 9.1.5).
9. Tree protection fence must be inspected by Urban Forestry staff prior to the issuance of a grading permit.

☒ **LEGAL DOCUMENTS** - Email to [legaldocumentreview@raleighnc.gov](mailto:legaldocumentreview@raleighnc.gov). Legal documents must be approved, executed, and recorded prior to or in conjunction with the recorded plat on which the associated easements are shown. Copies of recorded documents must be returned to the City within one business day of recording to avoid withholding of further permit issuance.

<input checked="" type="checkbox"/>	Stormwater Maintenance Covenant Required
<input checked="" type="checkbox"/>	Sidewalk Deed of Easement Required

<input checked="" type="checkbox"/>	Right of Way Deed of Easement Required
-------------------------------------	--

☒ **RECORDED MAP(S)** - Submit plat to record new property lines, easements, tree conservation areas, etc.). Plats may be submitted for review when the Site Permitting Review plans, if required, have been deemed ready for mylar signature.

***The following items must be approved prior to recording the plat:***

## General

1. A demolition permit shall be issued and this building permit number shown on all maps for recording.
2. Street names for this development shall be approved by the Raleigh GIS Division and by Wake County.
3. A recombination map shall be recorded prior to or in conjunction with the recording of lots.





# **Administrative Approval Action**

**Case File / Name: SUB-0034-2023**  
**DSLC - Yardly Buffaloe Village**

**City of Raleigh**  
**Development Services Department**  
One Exchange Plaza  
Raleigh, NC 27602  
(919) 996-2492  
currentplanning@raleighnc.gov  
www.raleighnc.gov

## **Engineering**

4. A sidewalk deed of easement, in addition to a plat showing the location of the easement, shall be submitted to the Planning and Development Services Department for review, and if acceptable, approved for recordation. Approved plats must be recorded at the Wake County Register of Deeds Office on or before the 14th day following approval by the City. The 14-day expiration date shall be clearly indicated on the plat. By the end of the next business day following recordation of the plat, all required legal instruments (including deeds of easement) shall be recorded, and recorded copies of the plat and all legal instruments required by the City in association with development approval shall be provided to the City. (Reference: UDO 8.1.7.A; 10.2.5.F.4.d)
5. A public street right-of-way deed of easement, in addition to a plat showing the location of the easement, shall be submitted to the Planning and Development Services Department for review, and if acceptable, approved for recordation. Approved plats must be recorded at the Wake County Register of Deeds Office on or before the 14th day following approval by the City. The 14-day expiration date shall be clearly indicated on the plat. By the end of the next business day following recordation of the plat, all required legal instruments (including deeds of easement) shall be recorded, and recorded copies of the plat and all legal instruments required by the City in association with development approval shall be provided to the City. (Reference: UDO 8.1.7.A; 10.2.5.F.4.d)
6. A public infrastructure surety shall be provided to City of Raleigh Transportation – Development Engineering Division (UDO 8.1.3) in the amount of 100% of the improvement cost for the NCDOT portion and 125% of the improvement cost for the City of Raleigh infrastructure.

## **Public Utilities**

7. A Petition for Annexation into the City limits shall be submitted in accordance with City Council policy for extension of utility service to properties currently outside of the City limits. This voluntary annexation in no way obligates the City to extend utility services to the property.
8. A Water and/or Sewer Assessment fee shall be paid to the Assessment Specialist in the City of Raleigh Engineering Services Department.
9. SPR (Construction Drawings) must be approved by the City of Raleigh Public Utilities Department for all public water, public sewer and/or private sewer extensions.
10. Wake County approval for any required Well or Septic Permits shall be shown on the map for recordation. Or note on SPR "To be abandoned according to Wake County Standards"

## **Stormwater**

11. The riparian buffers, in accordance with the preliminary plan and the State of North Carolina regulations, shall be shown on plats for recording along with required buffer statement (Recorded Map Checklist).
12. If demolition causes a land disturbance of more than 12,000 sf, a mass grading permit will be required. (UDO 9.4.6)



# Administrative Approval Action

Case File / Name: SUB-0034-2023  
DSLC - Yardly Buffaloe Village

City of Raleigh  
Development Services Department  
One Exchange Plaza  
Raleigh, NC 27602  
(919) 996-2492  
currentplanning@raleighnc.gov  
www.raleighnc.gov

13. The maximum allocated impervious area for all applicable lots in the subdivision should be identified on all maps for recording.
14. A surety equal to 125% of the cost of the construction of a stormwater device shall be paid to the Engineering Services Department (UDO 9.2.2.D.1.d).
15. All stormwater control measures and means of transporting stormwater runoff to and from any nitrogen and stormwater runoff control measures shall be shown on all plats for recording as private drainage easements (UDO 9.2).
16. The flood prone areas, as approved by the City Stormwater Engineer and shown on the preliminary plan, shall be shown on the recorded map (UDO 9.3.3.G).
17. The City form document entitled Declaration of Maintenance Covenant and Grant of Protection Easement for Stormwater Control Facilities shall be approved by the City and recorded with the county register of deeds office (UDO 9.2.2.G).

## Urban Forestry

18. A public infrastructure surety for 65 street trees shall be provided to City of Raleigh Transportation – Development Engineering Division (UDO 8.1.3) in the amount of 100% of the improvement cost for the NCDOT portion. A public infrastructure surety for 89 street trees shall be provided to City of Raleigh Transportation – Development Engineering Division (UDO 8.1.3) in the amount of 125% of the improvement cost for the City of Raleigh infrastructure.
19. A tree conservation plat shall be recorded with metes and bounds showing the designated tree conservation areas (UDO 9.1). This development proposes 3.05 acres of tree conservation area.

☒ **BUILDING PERMITS** - For buildings and structures shown on the approved plans. Commercial building permit plans must include the signed, approved Site Permitting Review plans attached, if applicable. Permit sets may be reviewed prior to the recordation of required plats, but cannot be approved.

***The following items must be approved prior to the issuance of building permits:***

## General

1. Comply with all conditions of Z-27-22 and TCZ-28-22.
2. A demolition permit shall be obtained.

## Engineering

3. A Traffic Control and Pedestrian (TCPED) Plan must be approved and a right-of-way occupancy permit must be obtained from Right-of-way Services for any construction activities within the right-of-way.

## Public Utilities



# Administrative Approval Action

Case File / Name: SUB-0034-2023  
DSLCL - Yardly Buffalo Village

City of Raleigh  
Development Services Department  
One Exchange Plaza  
Raleigh, NC 27602  
(919) 996-2492  
currentplanning@raleighnc.gov  
www.raleighnc.gov

4. A plat must be recorded at the Wake County Register of Deeds office for all utility easement dedications.

## Urban Forestry

5. A tree impact permit must be obtained for the approved streetscape tree installation in the right of way. This development proposes 16 street trees along Buffalo Rd, 49 street trees along Forestville Rd, and 89 street trees along Yardly Village Ln.

***The following are required prior to issuance of building occupancy permit:***

## General

1. All Water, Sanitary Sewer and Reuse facilities shall be installed, inspected, tested and accepted by the City of Raleigh Public Utilities Department for operations and maintenance.

## Stormwater

2. As-built drawings and associated forms for all Stormwater devices are accepted by the Engineering Services Department (UDO 9.2.2.D.3).

**EXPIRATION DATES:** If significant construction has not taken place on a project after preliminary subdivision approval, that approval may "sunset" and be declared void, requiring re-approval before permits may be issued. To avoid allowing this preliminary approval to "sunset", the following must take place by the following dates:

**3-Year Sunset Date: March 20, 2027**  
**Record at least ½ of the land area approved.**

**5-Year Sunset Date: March 20, 2029**  
**Record entire subdivision.**

I hereby certify this administrative decision.

Signed: \_\_\_\_\_ Date: 03/20/2024  
Development Services Dir/Designee  
Staff Coordinator: Jermon Purifoy


PRELIMINARY SUBDIVISION PLANS FOR  
**YARDLY BUFFALOE VILLAGE**  
 BUFFALOE ROAD  
 LEIGH, WAKE COUNTY, NORTH CAROLINA  
 # SUB-0034-2023

[illegible][illegible]

Sheet List Table	
Sheet Number	Sheet Title
C001	COVER SHEET
C002	ZONING CONDITIONS
C100	EXISTING CONDITIONS
C101	OVERALL DEMOLITION PLAN
C200	OVERALL PRELIMINARY SUBSIDION PLAN
C201	PRELIMINARY SUBSIDION PLAN
C202	PRELIMINARY SUBSIDION PLAN
C203	PRELIMINARY SUBSIDION PLAN
C204	PRELIMINARY SUBSIDION PLAN
C205	OFFSITE ROADWAY IMPROVEMENTS
C206	PRELIMINARY SUBSIDION PLAN
C300	OVERALL PRELIMINARY GRADING AND DRAINAGE PLAN
C301	PRELIMINARY GRADING AND DRAINAGE PLAN
C302	PRELIMINARY GRADING AND DRAINAGE PLAN
C303	PRELIMINARY GRADING AND DRAINAGE PLAN
C304	PRELIMINARY GRADING AND DRAINAGE PLAN
C400	OVERALL PRELIMINARY UTILITY PLAN
C401	PRELIMINARY UTILITY PLAN
C402	PRELIMINARY UTILITY PLAN
C403	PRELIMINARY UTILITY PLAN
C404	PRELIMINARY UTILITY PLAN
C500	SCM DETAILS - WET POND 1
C501	SCM DETAILS - WET POND 2
L000	OVERALL TREE CONSERVATION PLAN
L001	TREE CONSERVATION PLAN
L002	TREE CONSERVATION PLAN
L003	TREE CONSERVATION PLAN
L004	TREE CONSERVATION PLAN
L100	OVERALL LANDSCAPE PLAN
L101	LANDSCAPE PLANS
L102	LANDSCAPE PLANS
L103	LANDSCAPE PLANS
L104	LANDSCAPE PLANS
L105	LANDSCAPE DETAILS

## SITE DATA TABLE

PROPERTY INFORMATION	
ESTIMATED ZONING:	CG-30
EXISTING USE:	IND-50
PROPOSED USE:	VACANT OPEN SPACE
TOTAL SITE AREA:	37.10 AC (1,616,032 SQ. FT.)
OPEN LOT BACKS:	
	PRIMARY STREET: LOT = 10'0"
	BACK STREET: LOT = 10'0"
	REARMSIDE LOT: LOT = 10'0"
OPEN LOT DIMENSIONS:	
	MINIMUM LOT WIDTH = 80'0"
PROPOSED NUMBER OF PARKING SPACES:	
	LOT 1: 84 SPACES
	LOT 2: 16 SPACES
	LOT 3: 8 SPACES
PROJECT DATA	
	1766-12-1
	1768-1-1
	1768-1-4
	1768-1-7
	1768-1-10
	1768-1-11
	1768-1-12
	1768-1-99
	1768-2-1
	1768-2-2
	1768-2-3
	1768-2-76
	1

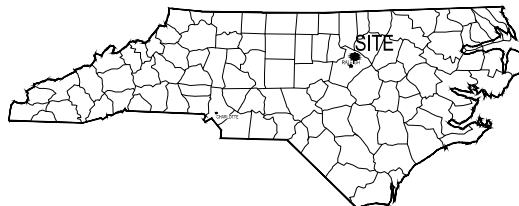[illegible][illegible]



PROJECT OWNER AND CONSULTANT INFORMATION				
<b>DEVELOPER:</b> TAYLOR MORRISON 1145 N. COMMERCE STREET CHARLOTTE, NC 28227 PHONE: (704) 251-6142	<b>ENGINEER:</b> KIMLEY-HORN AND ASSOCIATES, INC. 250 SOUTH MAIN STREET SUITE 218 MORRISVILLE, NC 27667 PHONE: (919) 678-1070 FAX: (919) 677-1252	<b>SURVEYOR:</b> ESP ASSOCIATES, INC. 2300 GARDEN STREET SUITE 216 MORRISVILLE, NC 27667 PHONE: (919) 678-1070 FAX: (919) 677-1252	<b>PROJECT OWNER:</b> TAYLOR MORRISON 1145 N. COMMERCE STREET CHARLOTTE, NC 28227	
<b>CONTACT:</b> MEGAN LEDBETTER	<b>CONTACT:</b> EVAN CONDER	<b>CONTACT:</b> KATIE WITT, P.E.		

Digitally signed by  
jeff.caines@raleighnc.gov  
DN:  
E=jeff.caines@raleighnc.gov,  
CN=jeff.caines@raleighnc.gov  
Reason: I am approving this  
document  
Date: 2024,03,20  
14:24:21-04'00'

**NOT FOR  
CONSTRUCTION**



Know what's below.  
Call before you dig.

SHEET NUMBER <b>C001</b>	<b>YARDLY BUFFALO E VILLAGE</b>  PREPARED FOR <b>YARDLY BY TAYLOR MORRISON BTR / VSI/RALEIGH, LLC</b> RALEIGH NC	KIM PROJECT 01/20/19 DATE 02/08/24 SCALE AS SHOWN DESIGNED BY MTH DRAWN BY MTH CHECKED BY ALW		 <p>           9 2024 KIMLEY-HORN AND ASSOCIATES, INC.            300 SOUTH MAIN ST. SUITE 201 HOLLY SPRING, NC 27440            WWW.KIMLEY-HORN.COM            NC LICENSE #0192         </p>	CITY COMMENTS 10/20/2023 CITY COMMENTS 10/20/2023 CITY COMMENTS 07/26/2025	DATE 10/20/24 10/20/23 10/20/23 07/26/2025	BY ALW ALW ALW JAC
					CITY COMMENTS 10/20/2023 CITY COMMENTS 10/20/2023 CITY COMMENTS 07/26/2025	DATE 10/20/24 10/20/23 10/20/23 07/26/2025	BY ALW ALW ALW JAC

AMENDED CONDITIONS DATED: APRIL 13, 2022

- MEANS OF COMPLIANCE: A 50 FEET PRINCIPAL BUILDING SETBACK HAS BEEN PROVIDED ADJACENT TO THESE PROPERTIES.

- MEANS OF COMPLIANCE: N/A - NO BUILDINGS PROPOSED.

- MEANS OF COMPLIANCE: N/A - NO BUILDINGS PROPOSED WITH THIS SUBDIVISION.

- MEANS OF COMPLIANCE: N/A - NO BUILDINGS PROPOSED WITH THIS SUBDIVISION.

- MEANS OF COMPLIANCE: N/A - NO BUILDINGS PROPOSED WITH THIS SUBDIVISION.

- MEANS OF COMPLIANCE: N/A - NO BUILDINGS PROPOSED WITH THIS SUBDIVISION.

- MEANS OF COMPLIANCE: N/A - NO BUILDINGS PROPOSED WITH THIS SUBDIVISION.

- MEANS OF COMPLIANCE: N/A - NO BUILDINGS PROPOSED WITH THIS SUBDIVISION.

- MEANS OF COMPLIANCE: PROPOSED LIGHTING IS LESS THAN 35 FEET IN HEIGHT. NO LIGHTING PROPOSED IN BUFFER AREAS OR PROTECTIVE YARDS.

- MEANS OF COMPLIANCE: N/A - NO LOTS ARE BEING RECORDED OR BUILDINGS PROPOSED WITH THIS SUBDIVISION.

- MEANS OF COMPLIANCE: N/A - NO BUILDINGS PROPOSED.

MEANS OF COMPLIANCE: PARKING IS NOT PROPOSED ALONG THE FRONTAGE OF BUFFALOE ROAD WITH THIS SUBDIVISION PLAN.

- MEANS OF COMPLIANCE: N/A - NO PARKING PROPOSED WITH THIS SUBDIVISION WITHIN 25 FEET OF RIGHT-OF-WAY OF BUFFALO ROAD OR FORESTVILLE ROAD.

- MEANS OF COMPLIANCE: SIDEWALKS PROPOSED ALONG PUBLIC AND PRIVATE INTERNAL STREET NETWORK.

- MEANS OF COMPLIANCE: N/A - NO BUILDINGS PROPOSED WITH THIS SUBDIVISION.

- MEANS OF COMPLIANCE: SIDEWALKS ALONG PUBLIC AND PRIVATE ROADWAY NETWORK ARE A MINIMUM OF 6 FEET WIDE.

- MEANS OF COMPLIANCE: N/A - NO BUILDINGS PROPOSED.


CONDITIONS DATED: OCTOBER 10, 2022

- MEANS OF COMPLIANCE: N/A - NO BUILDINGS PROPOSED.



- MEANS OF COMPLIANCE: N/A - NO BUILDINGS PROPOSED.

- (II) SCHOOL, PUBLIC OR PRIVATE (K-12);
- (III) DAY CARE CENTER; (IV) HEALTH CLUB;
- (V) MEDICAL OFFICE;
- (VI) OUTDOOR SPORTS OR ENTERTAINMENT FACILITY (250 SEATS);
- (VII) BED AND BREAKFAST;
- (X) HOSPITALITY HOUSE;
- (X) PARKING FACILITY;
- (XI) COPY CENTER;
- (XII) OPTOMETRIST;
- (XIII) EATING ESTABLISHMENT;
- (XIV) RETAIL SALES.


- MEANS OF COMPLIANCE: N/A - NO BUILDINGS PROPOSED.

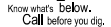[illegible]



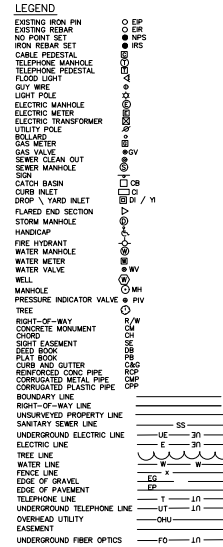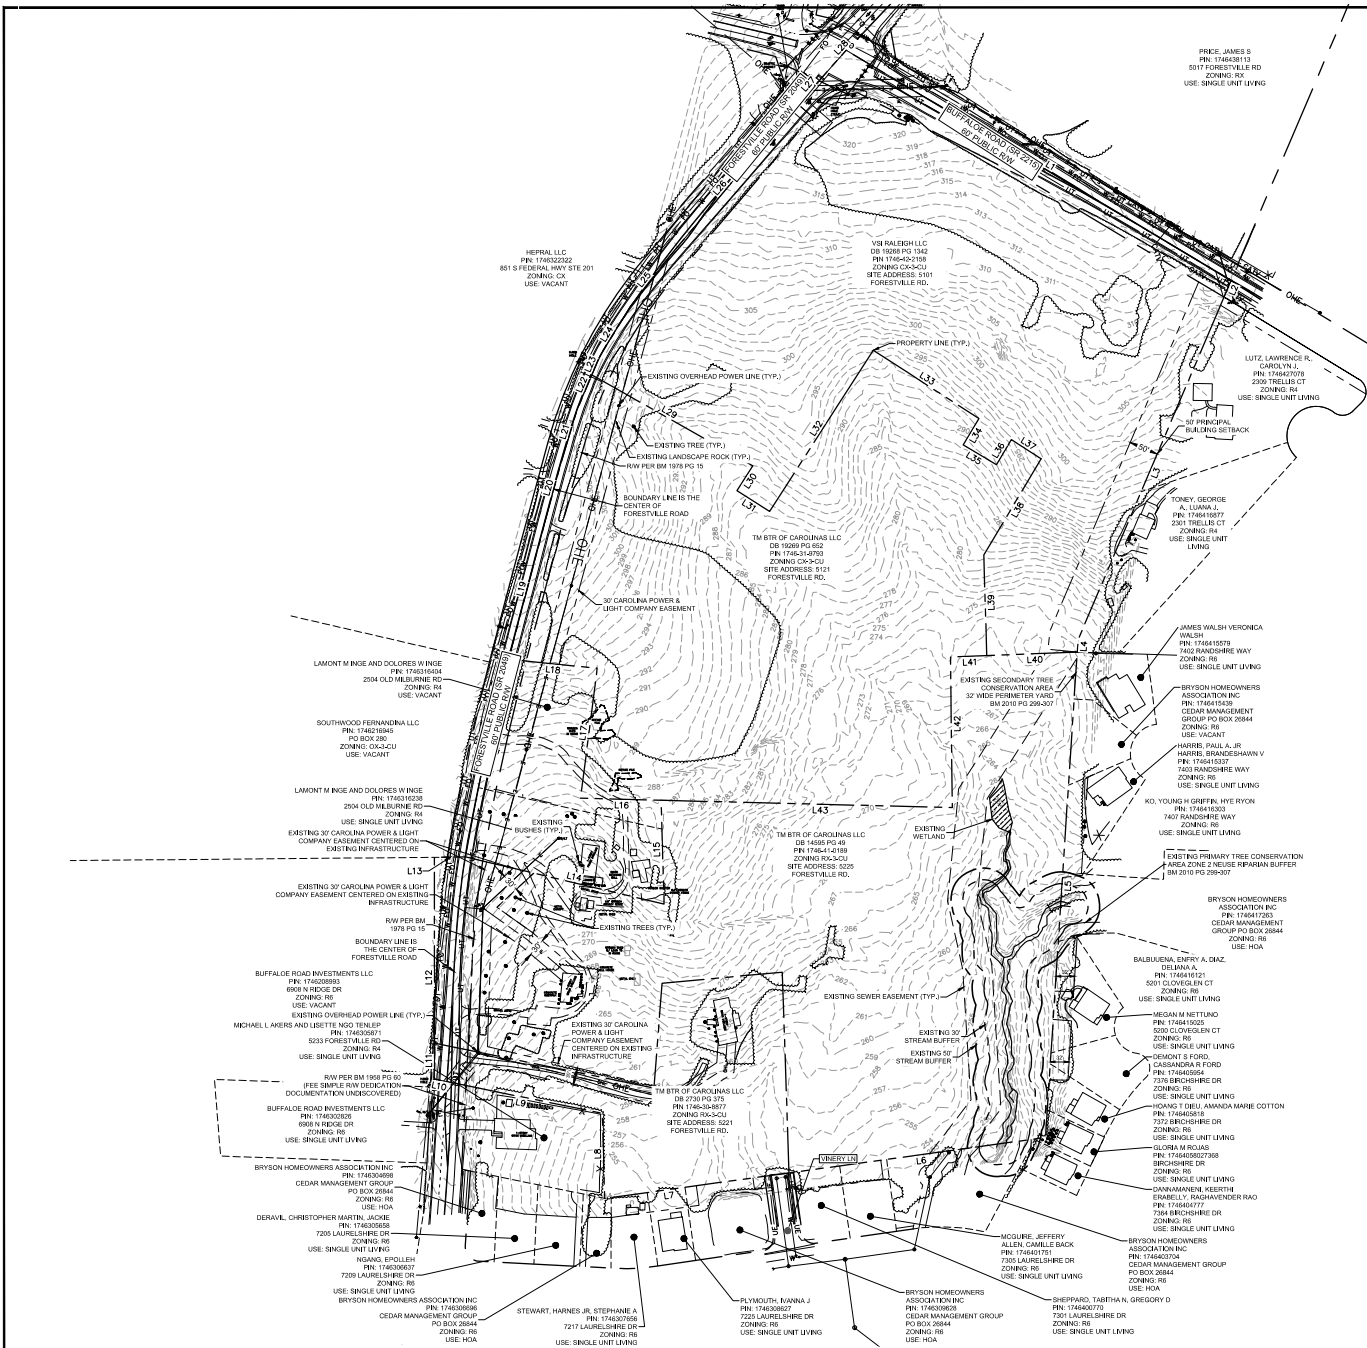

LINE TABLE			LINE TABLE		
LINE	LENGTH	BEARING	LINE	LENGTH	BEARING
L1	764.47	S59°07'26.29"E	L23	100.00	N22°56'33.71"E
L2	30.74	S23°04'05.37"W	L24	100.00	N31°35'33.71"E
L3	633.07	S23°04'05.37"W	L25	100.00	N37°54'33.71"E
L4	22.92	S5°35'15.40"W	L26	314.09	N40°02'33.71"E
L5	829.16	S3°44'26.30"W	L27	148.75	N41°36'33.71"E
L6	441.17	S82°07'45.05"W	L28	7.50	N42°21'03.71"E
L7	317.26	S82°07'45.05"W	L29	315.05	S60°29'33.00"E
L8	145.02	N1°30'57.28"W	L30	50.00	S32°43'57.00"W
L9	267.29	N78°28'48.79"W	L31	66.00	S57°16'03.00"E
L10	24.61	N78°28'48.79"W	L32	326.73	N32°43'57.00"E
L11	61.24	N0°06'44.21"W	L33	214.52	S57°09'15.00"E
L12	316.88	N0°03'25.12"W	L34	52.29	S30°51'36.00"W
L13	53.29	N89°11'38.92"E	L35	66.00	S59°08'24.00"E
L14	347.80	S76°36'46.72"E	L36	50.00	N30°51'36.00"E
L15	177.16	N1°40'30.84"W	L37	60.37	S57°09'15.00"E
L16	137.39	N88°33'19.34"W	L38	190.71	S30°51'36.00"W
L17	223.42	N7°20'34.02"E	L39	171.81	S1°40'31.00"E
L18	151.91	N84°13'36.96"W	L40	216.19	S87°47'15.59"W
L19	240.47	N14°49'18.12"E	L41	216.19	S87°47'15.59"W
L20	100.00	N15°07'33.71"E	L42	256.75	S0°42'03.96"E
L21	100.00	N16°52'33.71"E	L43	496.49	N88°33'19.34"W
L22	100.00	N22°56'33.71"E			

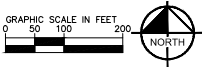

**Kimley»Horn**

© 2024 KIMLEY-HORN AND ASSOCIATES, INC.  
300 SOUTH MAIN ST. SUITE 212, DULLES, VA 22024  
WWW.KIMLEY-HORN.COM  
NVC LICENSE #4-102

**PRELIMINARY**  
NOT FOR CONSTRUCTION

**EXISTING CONDITIONS**

**YARDLY BUFFALOEE VILLAGE**  
PREPARED FOR  
YARDLY BY TAYLOR MORRISON  
BTR / VSR RALEIGH, LLC  
RALEIGH

**811**  
Know what's below.  
Call before you dig.

**REVISIONS**

NO.	DATE	BY
1	02/06/24	BAK
2	02/06/24	BAK
3	02/06/24	BAK
100	02/06/24	BAK

**SHEET NUMBER**  
**C100**



1. ALL SEPTIC TANKS/WELLS TO BE ABANDONED ACCORDING TO WAKE COUNTY STANDARDS.

T	COMMON NAME
T1	RED MAPLE
T2	SILVER MAPLE
T3	AMERICAN HORSEBANE
T4	PIGNUT HICKORY
T5	PECAN
T6	MOCKERNUT HICKORY
T7	FLORIDIAN DOGWOOD
T8	AMERICAN HOLLY
T9	EASTERN RED CEDAR
T10	FRONT GUM
T11	TULIP POPULAR
T12	RED MULBERRY
T13	BLACK GUM
T14	SOURWOOD
T15	SHORTLEAF PINE
T16	LOBLOLLY PINE
T17	AMERICAN SYCAMORE
T18	BLACK CHERRY
T19	WHITE OAK
T20	SOUTHERN RED OAK
T21	BLACKOAK OAK
T22	WHITE OAK
T23	YELLOW OAK
T24	NORTHERN RED OAK
T25	POST OAK
T26	WINGED ELM
T27	AMERICAN ELM

**PRELIMINARY**  
NOT FOR CONSTRUCTION

	A	CITY COMMENTS	02/08/2024	SNAI
	A	CITY COMMENTS	01/09/2024	SNAI
	A	CITY COMMENTS	10/20/2023	SNAL
	A	CITY COMMENTS	07/26/2023	JMC




Know what's below.  
Call before you dig.



Drawn by: [Name], Checked by: [Name], Date: [Date], Scale: [Scale], Project: [Project Name], Sheet: [Sheet Number] of [Total Sheets]

This document, together with the concepts and designs presented herein, as an instrument of service, is intended only for the specific project and client for which it was prepared. Reuse of and/or reproduction of this document without written authorization and adaptation by [Firm Name] and Associates, Inc. will be without liability to [Firm Name] and Associates, Inc.

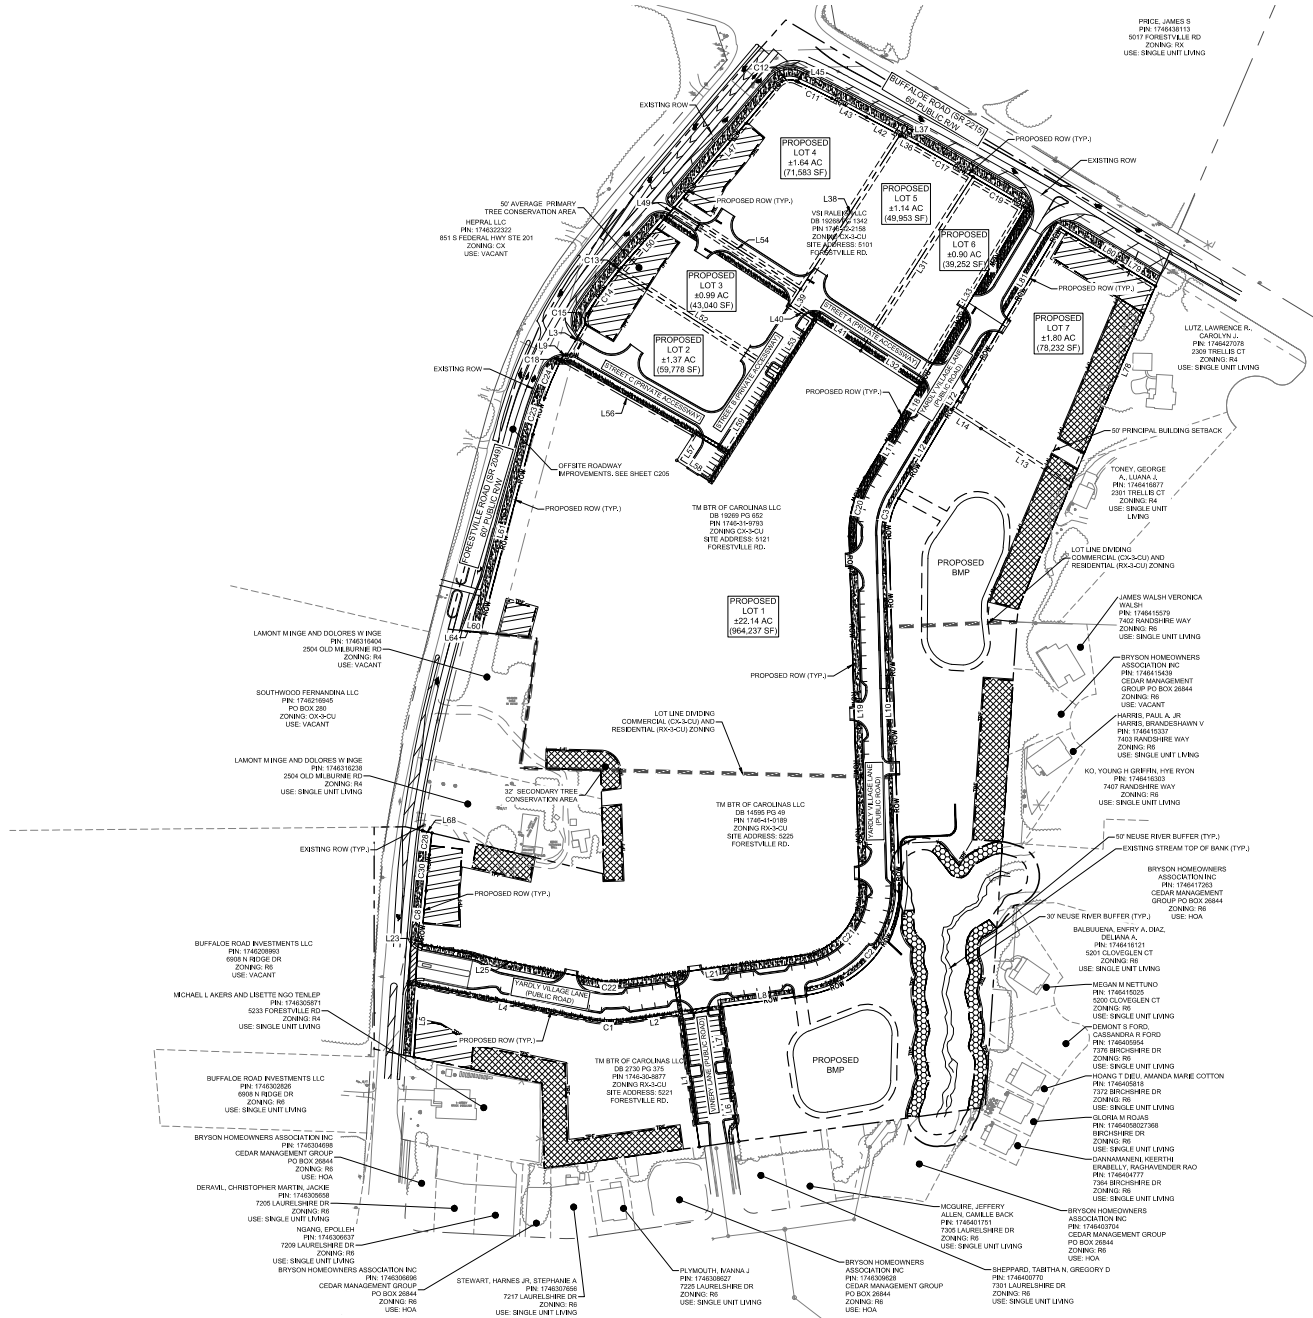


**PROPOSED IMPROVEMENTS LEGEND**

--- DRAINAGE PROPERTY	--- PROPOSED RIGHT-OF-WAY
--- BOUNDARY	--- TOP OF BANK
--- PROPOSED PROPERTY	--- 30' NEUSE RIVER BUFFER
--- BOUNDARY	--- 30' NEUSE RIVER BUFFER
--- 30' NEUSE RIVER BUFFER	--- 30' NEUSE RIVER BUFFER
--- BUILDING SETBACK	--- 30' NEUSE RIVER BUFFER
--- CURB AND GUTTER	--- 30' NEUSE RIVER BUFFER
--- TRAFFIC LIGHTS	--- 30' NEUSE RIVER BUFFER
--- STOP SIGN / STOP MARKING A SIGN	--- 30' NEUSE RIVER BUFFER
--- SIGN - SINGLE / DOUBLE	--- 30' NEUSE RIVER BUFFER
--- SIGN - MONUMENT / PILON	--- 30' NEUSE RIVER BUFFER
--- SITE LIGHTING	--- 30' NEUSE RIVER BUFFER
--- RETAINING WALL	--- 30' NEUSE RIVER BUFFER
--- PARKING COUNT	--- 30' NEUSE RIVER BUFFER

**SITE DATA TABLE**

PROPERTY INFORMATION	
EXISTING ZONING:	CK-3-CU
PROPOSED ZONING:	CK-3-CU
EXISTING USE:	VACANT OPEN LOT
PROPOSED USE:	VACANT OPEN LOT
TOTAL SITE AREA:	37.10 AC (1,616,032 SF)
OPEN LOT SETBACK:	37.10 AC (1,616,032 SF)
PRIMARY STREET = 10 FEET	
SIDE STREET = 10 FEET	
REAR/SIDE LOT LINE = 10 FEET	
MINIMUM LOT WIDTH = 50 FEET	
PROPOSED NUMBER OF PARKING SPACES:	
LOT 1: 54 SPACES	
LOT 2: 15 SPACES	
LOT 3: 8 SPACES	
PROJECT DATA	
PN #:	1746-02-758
PN #:	1746-02-758
PN #:	1746-02-758
PN #:	1746-02-758
PROPOSED # OF LOTS:	7
GROSS SITE AREA:	37.10 AC (1,616,032 SF)
RAW OBSERVATION:	7.12 AC (308,664 SF)
NET SITE AREA:	29.98 AC (1,307,368 SF)
PROPOSED LOT AREAS:	
LOT 1 (VACANT):	22.14 AC (964,237 SF)
LOT 2 (VACANT):	1.37 AC (59,778 SF)
LOT 3 (VACANT):	0.90 AC (39,440 SF)
LOT 4 (VACANT):	1.84 AC (81,583 SF)
LOT 5 (VACANT):	1.14 AC (49,883 SF)
LOT 6 (VACANT):	0.90 AC (39,440 SF)
LOT 7 (VACANT):	1.80 AC (78,232 SF)
LOT 8 (VACANT):	1.80 AC (78,232 SF)

KEY MAP (SCALE 1" = 300')

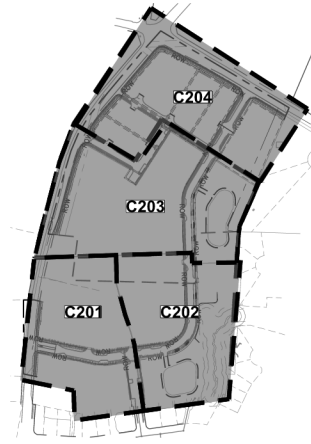

**Kimley»Horn**

300 SOUTH MAIN ST. SUITE 212, HOLLY SPRINGS, NC 27540  
WWW.KIMLEY-HORN.COM  
NC LICENSE # 5102

PROJECT NO.	1746-02-758
DATE	02/06/24
SCALE	AS SHOWN
DESIGNED BY	NTB
DRAWN BY	NTB
CHECKED BY	NTB


**OVERALL PRELIMINARY SUBDIVISION PLAN**

**YARDLY BUFFALO VILLAGE**


PREPARED FOR  
**YARDLY BY TAYLOR MORRISON BTR / VSI RALEIGH, LLC**

**SHEET NUMBER C200**

DATE BY

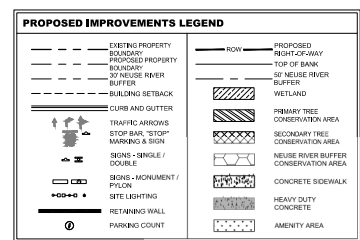


SITE DATA TABLE	
<b>PROPERTY INFORMATION</b>	
EXISTING ZONING:	CX-3X-50
EXISTING USE:	RESIDENTIAL
PROPOSED USE:	VACANT
TOTAL SITE AREA:	37.10 AC (1,618,000 S.F.)
OPEN LOT SUBDIVISION:	
OPEN LOT SUBDIVISIONS:	
PRIMARY STREET - 10 FEET	
SIDE STREET - 10 FEET	
REAR/SIDE LOT - 10 FEET	
MINIMUM LOT WIDTH - 50 FEET	
PROPOSED NUMBER OF PARKING SPACES	
TOTAL PARKING SPACES	
LOT 1: 16 PARKING SPACES	
LOT 2: 16 PARKING SPACES	
LOT 3: 16 PARKING SPACES	
<b>PROJECT DATA</b>	
FIN#:	1748-02-158
	1748-01-070
	1748-01-109
	1748-01-109
	1748-03-887
PROPOSED # OF LOTS:	
GROSS SITE AREA: 37.10 AC (1,618,000 S.F.)	
NET DEVELOPMENT: 37.10 AC (1,620,000 S.F.)	
NET SITE AREA: 29.98 AC (1,306,078 S.F.)	
PROPOSED LOT AREAS:	
LOT 1 (VACANT): 2.91 AC (126,984 SQ. FT.)	
LOT 2 (VACANT): 1.37 AC (60,159.78 SQ. FT.)	
LOT 3 (VACANT): 5.90 AC (256,434.90 SQ. FT.)	
LOT 4 (VACANT): 1.60 AC (71,583.50 SQ. FT.)	
LOT 5 (VACANT): 1.41 AC (62,853.50 SQ. FT.)	
LOT 6 (VACANT): 5.90 AC (256,252.50 SQ. FT.)	
LOT 7 (VACANT): 1.40 AC (62,732.50 SQ. FT.)	

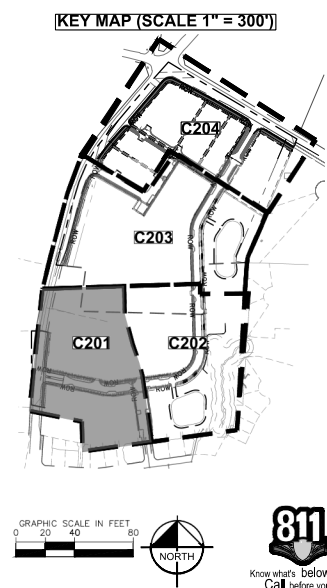[illegible]



PROPOSED IMPROVEMENTS LEGEND			
	EXISTING PROPERTY BOUNDARY		PROPOSED RIGHT-OF-WAY
	PROPOSED PROPERTY BOUNDARY		TOP OF BANK
	50' HOUSE RIVER BUFFER		50' HOUSE RIVER BUFFER
	BUILDING SETBACK		WETLAND
	CURB AND GUTTER		PRIMARY TREE CONSERVATION AREA
	TRAFFIC ARROWS		SECONDARY TREE CONSERVATION AREA
	STOP BAR, 'STOP' MARKING & SIGN		HOUSE RIVER BUFFER CONSERVATION AREA
	SIGN: SINGLE / DOUBLE		CONCRETE SIDEWALK
	SIGN: MONUMENT / Pylon		HEAVY DUTY CONCRETE
	SITE LIGHTING		AMENITY AREA
	RETAINING WALL		
	PARKING COUNT		

KEY MAP (SCALE 1" = 300')

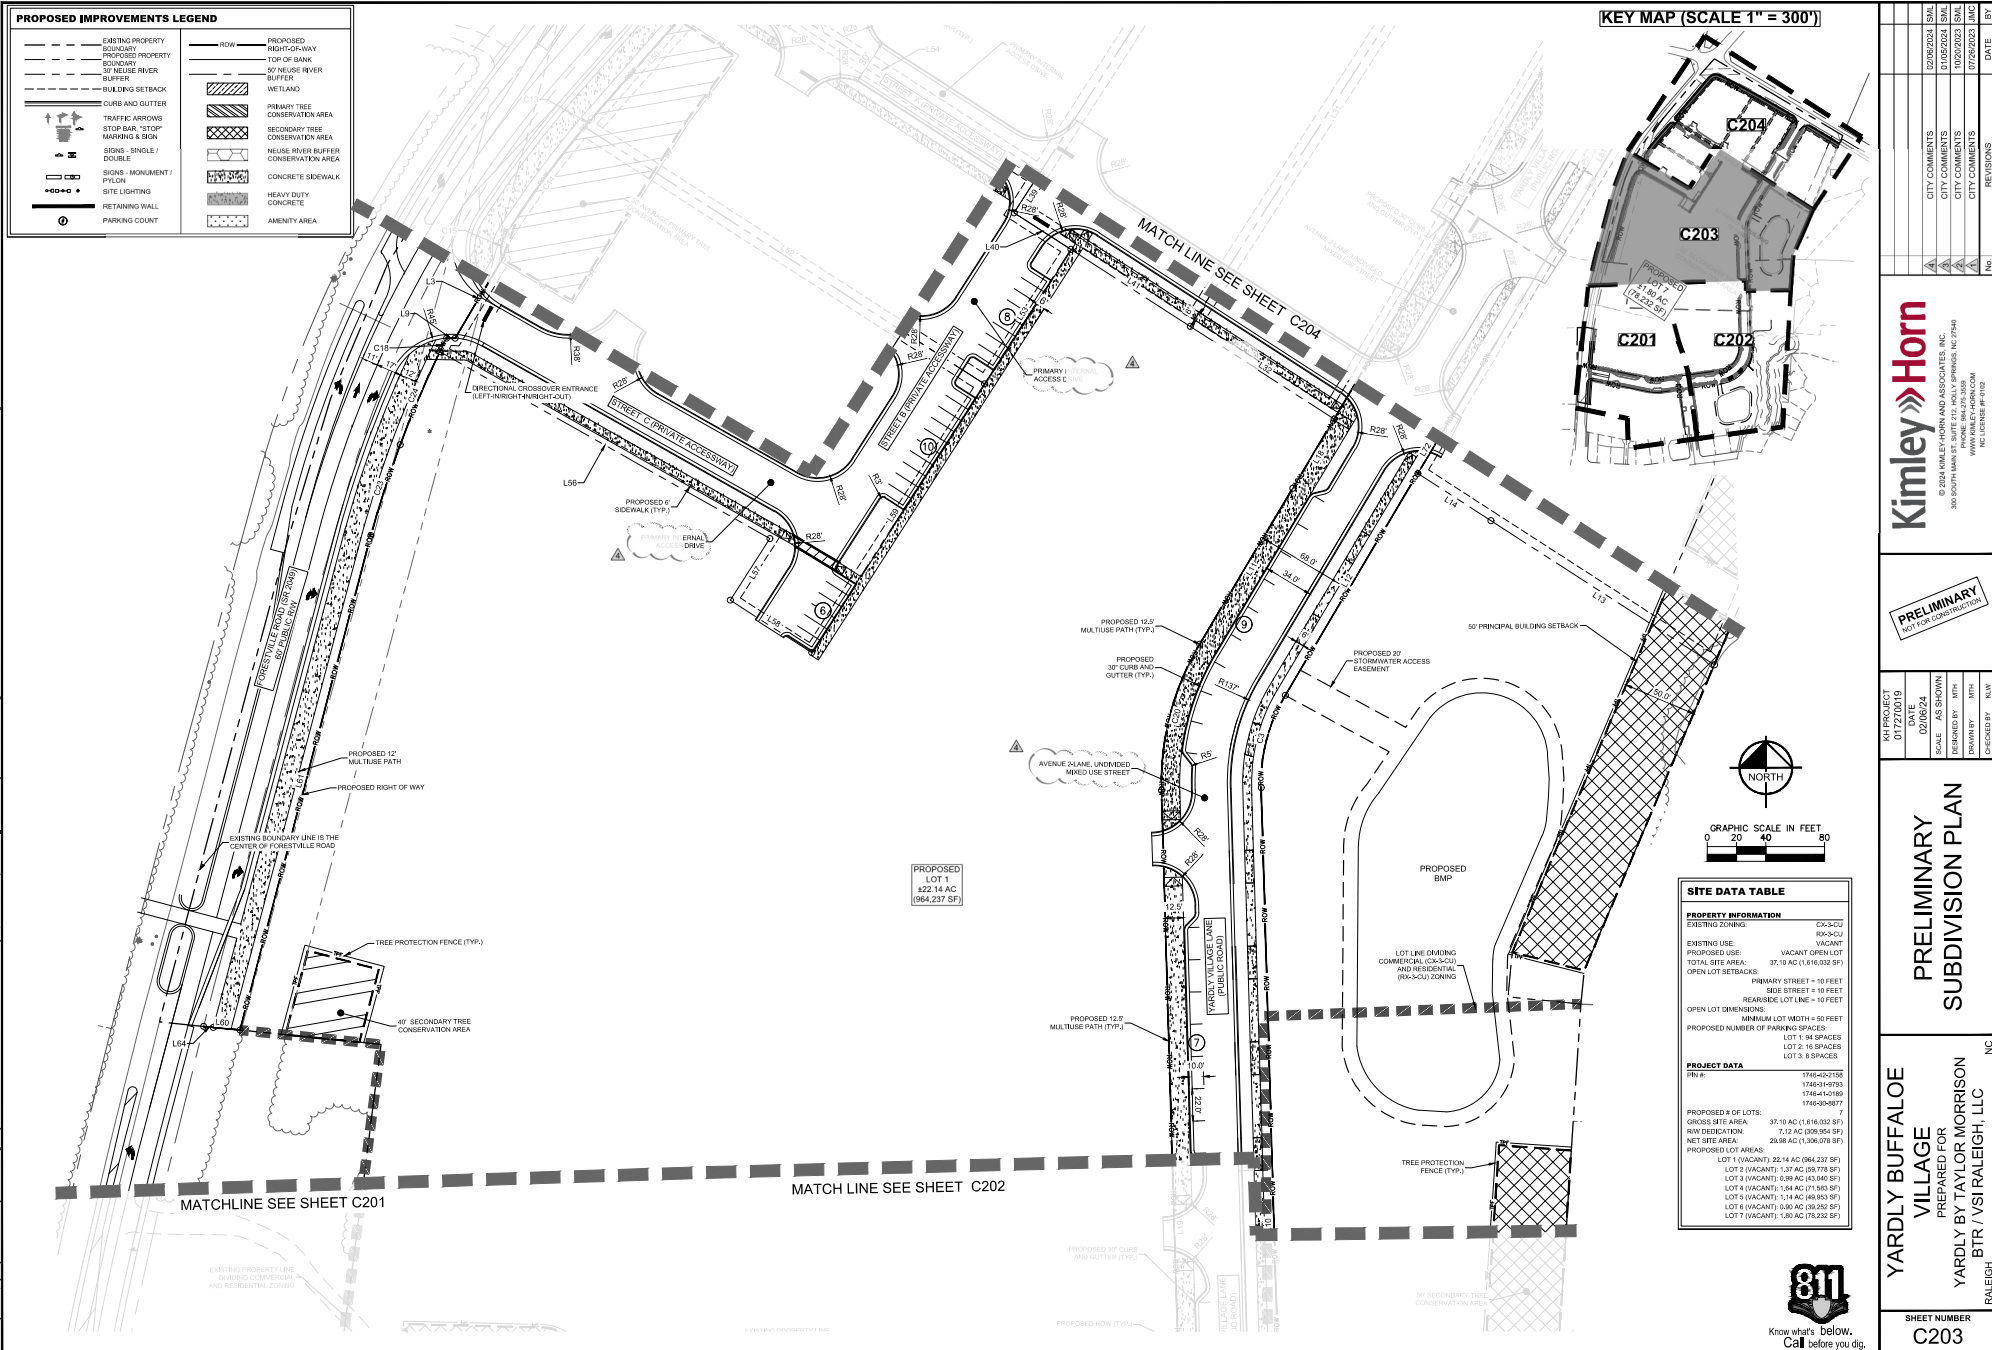

SITE DATA TABLE	
<b>PROPERTY INFORMATION</b>	
EXISTING ZONING:	CK-32U
EXISTING USE:	VACANT
PROPOSED USE:	VACANT OPEN LOT
TOTAL SITE AREA:	37.19 AC (1,616,032 SF)
OPEN LOT SETBACKS:	10 FEET
OPEN LOT DIMENSIONS:	MINIMUM LOT WIDTH = 50 FEET
PROPOSED NUMBER OF PARKING SPACES:	LOT 1: 94 SPACES LOT 2: 16 SPACES LOT 3: 8 SPACES
<b>PROJECT DATA</b>	
PROPOSED # OF LOTS:	7
GROSS SITE AREA:	37.19 AC (1,616,032 SF)
RAW DEDICATION:	7.12 AC (308,354 SF)
NET SITE AREA:	30.07 AC (1,307,678 SF)
PROPOSED LOT AREAS:	LOT 1 (VACANT): 22.14 AC (964,237 SF) LOT 2 (VACANT): 1.14 AC (49,778 SF) LOT 3 (VACANT): 0.99 AC (43,840 SF) LOT 4 (VACANT): 1.14 AC (49,778 SF) LOT 5 (VACANT): 1.14 AC (49,778 SF) LOT 6 (VACANT): 0.80 AC (34,852 SF) LOT 7 (VACANT): 1.80 AC (78,232 SF)

© 2024 KIMLEY-HORN AND ASSOCIATES, INC.  
300 SOUTH MAIN ST. SUITE 212, HOLLY SPRING, NC 27540  
WWW.KIMLEY-HORN.COM  
NC LICENSE #F-552

**PRELIMINARY**  
NOT FOR CONSTRUCTION

PROJECT NO.	2206024
DATE	02/06/24
SCALE	AS SHOWN
DESIGNED BY	WITH
DRAWN BY	WITH
CHECKED BY	RAW


**PRELIMINARY**  
SUBDIVISION PLAN

**YARDLY BUFFALOEE VILLAGE**  
PREPARED FOR  
YARDLY BY TAYLOR MORRISON  
BTR / VSI RALEIGH, LLC

**811**  
Know what's below.  
Call before you dig.


SHEET NUMBER  
**C203**



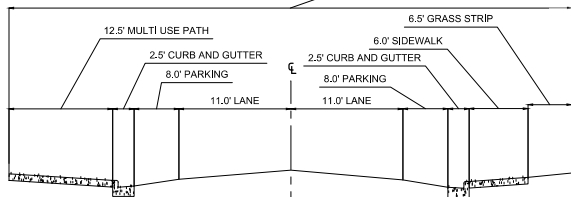


## SITE DATA TABLE

PROPERTY INFORMATION	
EXISTING ZONING:	CK-3-C R3-C
EXISTING USE:	VACANT
PROPOSED USE:	RETAIL
TOTAL SITE AREA:	37.40 AC (1,615,032 SF)
OPEN LOT STREET:	PRIMARY STREET = 10 FEET SIDE STREET = 10 FEET
OPEN LOT DIMENSIONS:	REAR/END LOT LINE = 10 FEET MINIMUM LOT WIDTH = 50 FEET
PROPOSED NUMBER OF PARKING SPACES:	20 SPACES 10 L1 SPACES 10 L2 SPACES 2 L3 SPACES
PROJECT DATA	
FILE #:	17654-0157 17654-0163 17654-0180 17654-0187
PROPOSED # OF LOTS:	7
GROSS SITE AREA:	37.40 AC (1,615,032 SF)
RUR DEDICATION:	72.12 AC (3,100,954 SF)
NET SITE AREA:	29.28 AC (1,278,089 SF)
PROPOSED LOT AREAS:	
LOT 1 (VACANT):	22.14 AC (964,273 SF)
LOT 2 (VACANT):	1.23 AC (53,978 SF)
LOT 3 (VACANT):	0.99 AC (43,040 SF)
LOT 4 (VACANT):	1.64 AC (71,383 SF)
LOT 5 (VACANT):	1.14 AC (49,853 SF)
LOT 6 (VACANT):	0.99 AC (43,282 SF)
LOT 7 (VACANT):	1.80 AC (78,202 SF)

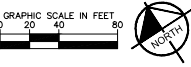


Know what's below.  
Call before you dig.

[illegible]

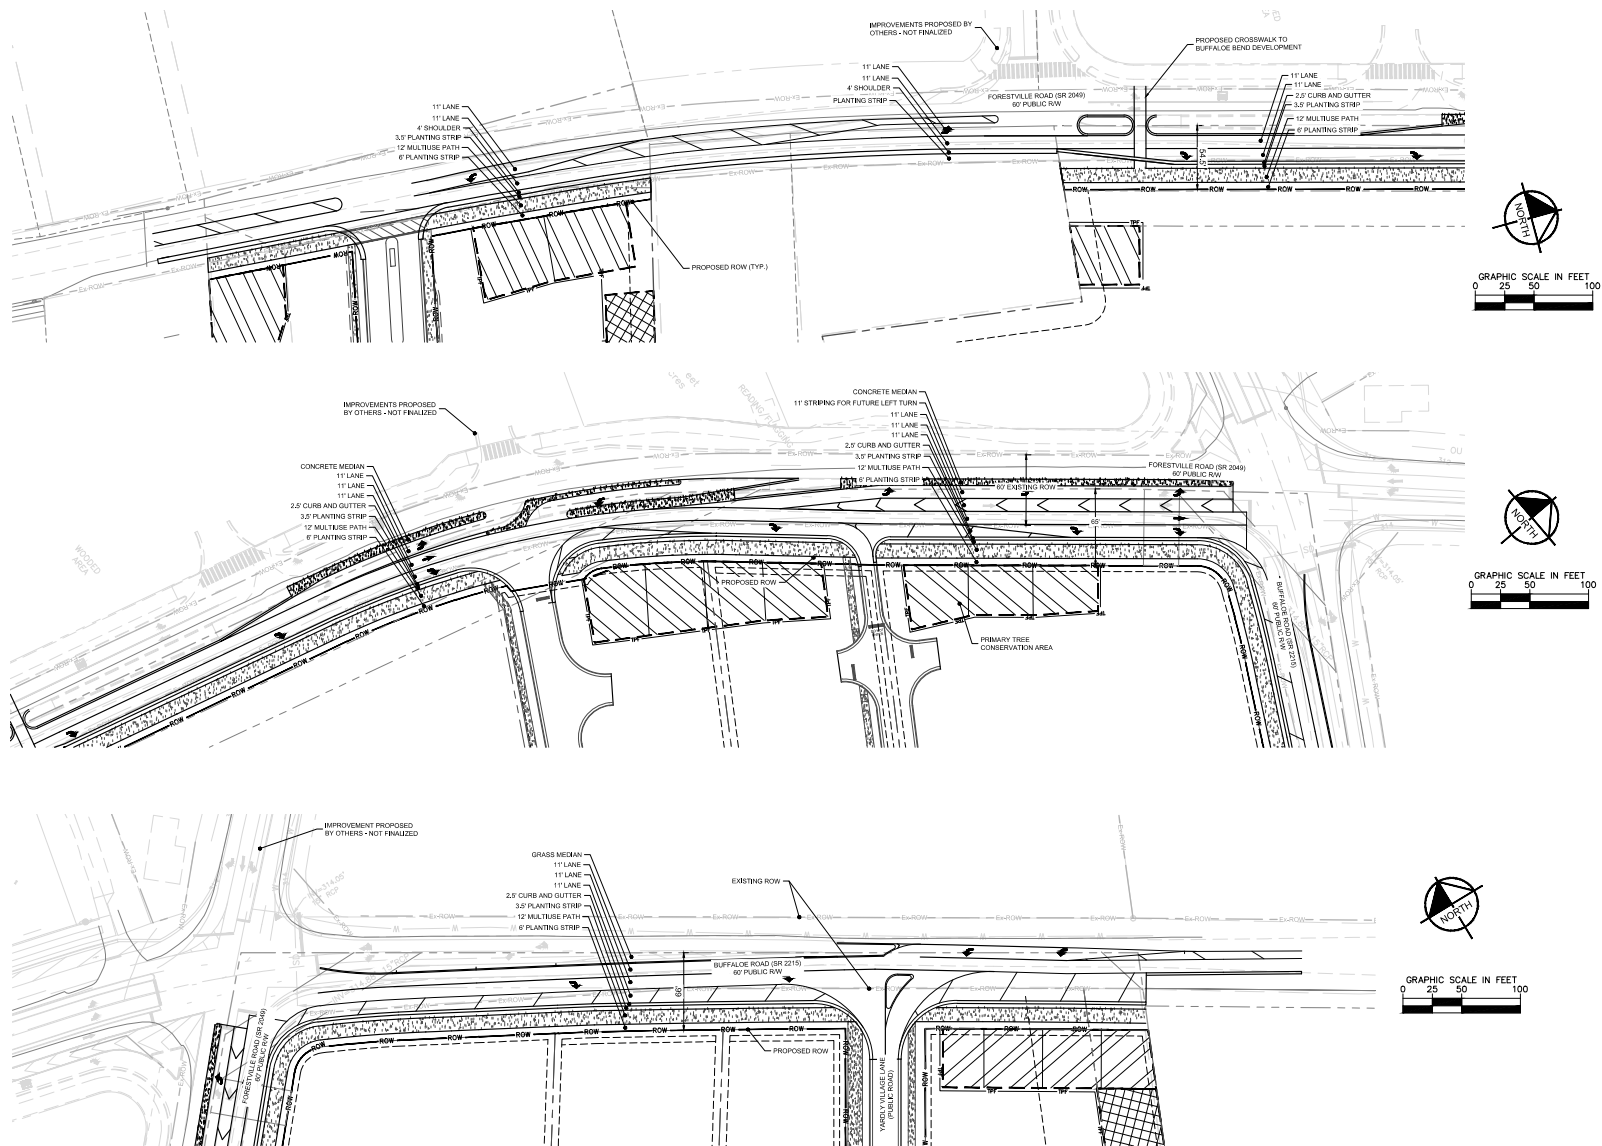

CURVE TABLE						
CURVE	RADIUS	LENGTH	CHORD BEARING	CHORD	DELTA	TANGENT
C1	184.00'	62.43'	N88°11'59"W	62.13'	19°29'21"	31.52'
C2	184.00'	268.97'	N40°12'10"E	245.68'	83°49'21"	164.97'
C3	116.00'	65.87'	N14°35'33"E	64.99'	32°32'07"	33.85'
C8	2452.50'	83.75'	N4°52'57"E	83.75'	1°57'24"	41.89'
C11	935.60'	63.39'	N63°55'12"W	63.37'	3°52'54"	31.70'
C12	26.00'	33.40'	S77°07'06"W	31.15'	73°36'20"	19.45'
C13	452.41'	7.20'	S40°08'51"W	7.20'	0°54'41"	3.60'
C14	740.08'	90.51'	S38°21'57"W	90.46'	7°00'27"	45.31'
C15	21.00'	17.98'	S81°19'54"W	17.44'	49°03'45"	9.58'
C17	11192.35'	109.55'	N60°32'54"W	109.55'	0°33'39"	54.78'
C18	318.79'	10.27'	S28°24'22"W	10.27'	1°50'44"	5.13'
C19	11022.00'	104.34'	N58°36'48"W	104.34'	0°32'33"	52.17'
C20	184.00'	104.48'	S14°35'33"W	103.09'	32°32'07"	53.69'
C21	116.00'	169.57'	S40°12'10"W	154.87'	83°49'21"	104.00'
C22	116.00'	39.36'	N88°11'59"W	39.17'	19°29'21"	19.87'
C23	765.76'	65.11'	N17°56'40"E	65.09'	4°52'17"	32.57'
C24	743.24'	68.99'	N23°04'20"E	68.92'	5°18'54"	34.50'
C28	2453.84'	37.45'	N6°34'13"E	37.45'	0°52'28"	18.73'
C30	2458.58'	61.64'	N5°24'50"E	61.64'	1°26'11"	30.82'


LINE TABLE		
LINE	LENGTH	BEARING
L1	230.98'	N7°59'09.57"W
L2	93.86'	S82°04'50.43"W
L3	63.93'	S31°02'02.80"W
L4	297.52'	N78°28'48.79"W
L5	124.48'	S3°54'15.50"W
L6	115.49'	N7°59'09.57"W
L7	115.49'	N7°59'09.57"W
L8	147.96'	N82°04'50.43"E
L9	5.59'	S89°19'33.59"W
L10	598.38'	N1°40'30.84"W
L11	123.82'	S30°51'36.10"W
L12	177.68'	N30°51'36.10"E
L13	161.30'	N57°09'08.79"W
L14	59.37'	N57°07'14.08"W
L16	54.98'	S30°51'36.10"W
L19	596.38'	S1°40'30.84"E
L21	308.62'	S82°04'50.43"W
L23	7.17'	N3°54'15.50"E
L25	306.61'	N78°28'48.79"W
L31	353.11'	S32°50'45.40"W
L32	116.64'	S57°12'39.51"E
L33	357.69'	N30°51'36.10"E
L36	30.56'	N61°28'42.50"W
L37	3.06'	N61°37'21.21"W
L38	312.14'	S32°50'45.40"W
L39	33.04'	S32°50'45.40"W
L40	46.06'	S57°12'41.15"E
L41	96.88'	S57°12'40.61"E
L42	64.80'	N61°37'21.21"W
L43	67.64'	N61°39'05.52"W
L45	4.01'	N68°57'35.96"W
L47	273.72'	S40°18'41.79"W
L49	17.84'	S41°38'44.82"W
L50	119.13'	S41°23'58.85"W
L52	323.97'	S57°16'02.81"E
L53	108.94'	N32°43'57.00"E
L54	256.33'	S57°09'14.61"E
L56	258.59'	S60°29'32.89"E
L57	49.99'	S32°44'33.00"W
L58	66.00'	S57°16'03.00"E
L59	217.79'	N32°43'57.00"E
L60	24.87'	S84°19'09.00"E
L61	348.72'	N14°49'18.12"E
L64	24.87'	S84°19'09.00"E
L68	16.56'	N78°36'46.72"W
L72	34.16'	N30°51'36.10"E
L78	370.62'	S23°04'05.37"W
L79	65.92'	S58°30'37.53"E
L80	124.37'	S58°47'09.15"E
L81	326.15'	N30°51'36.10"E

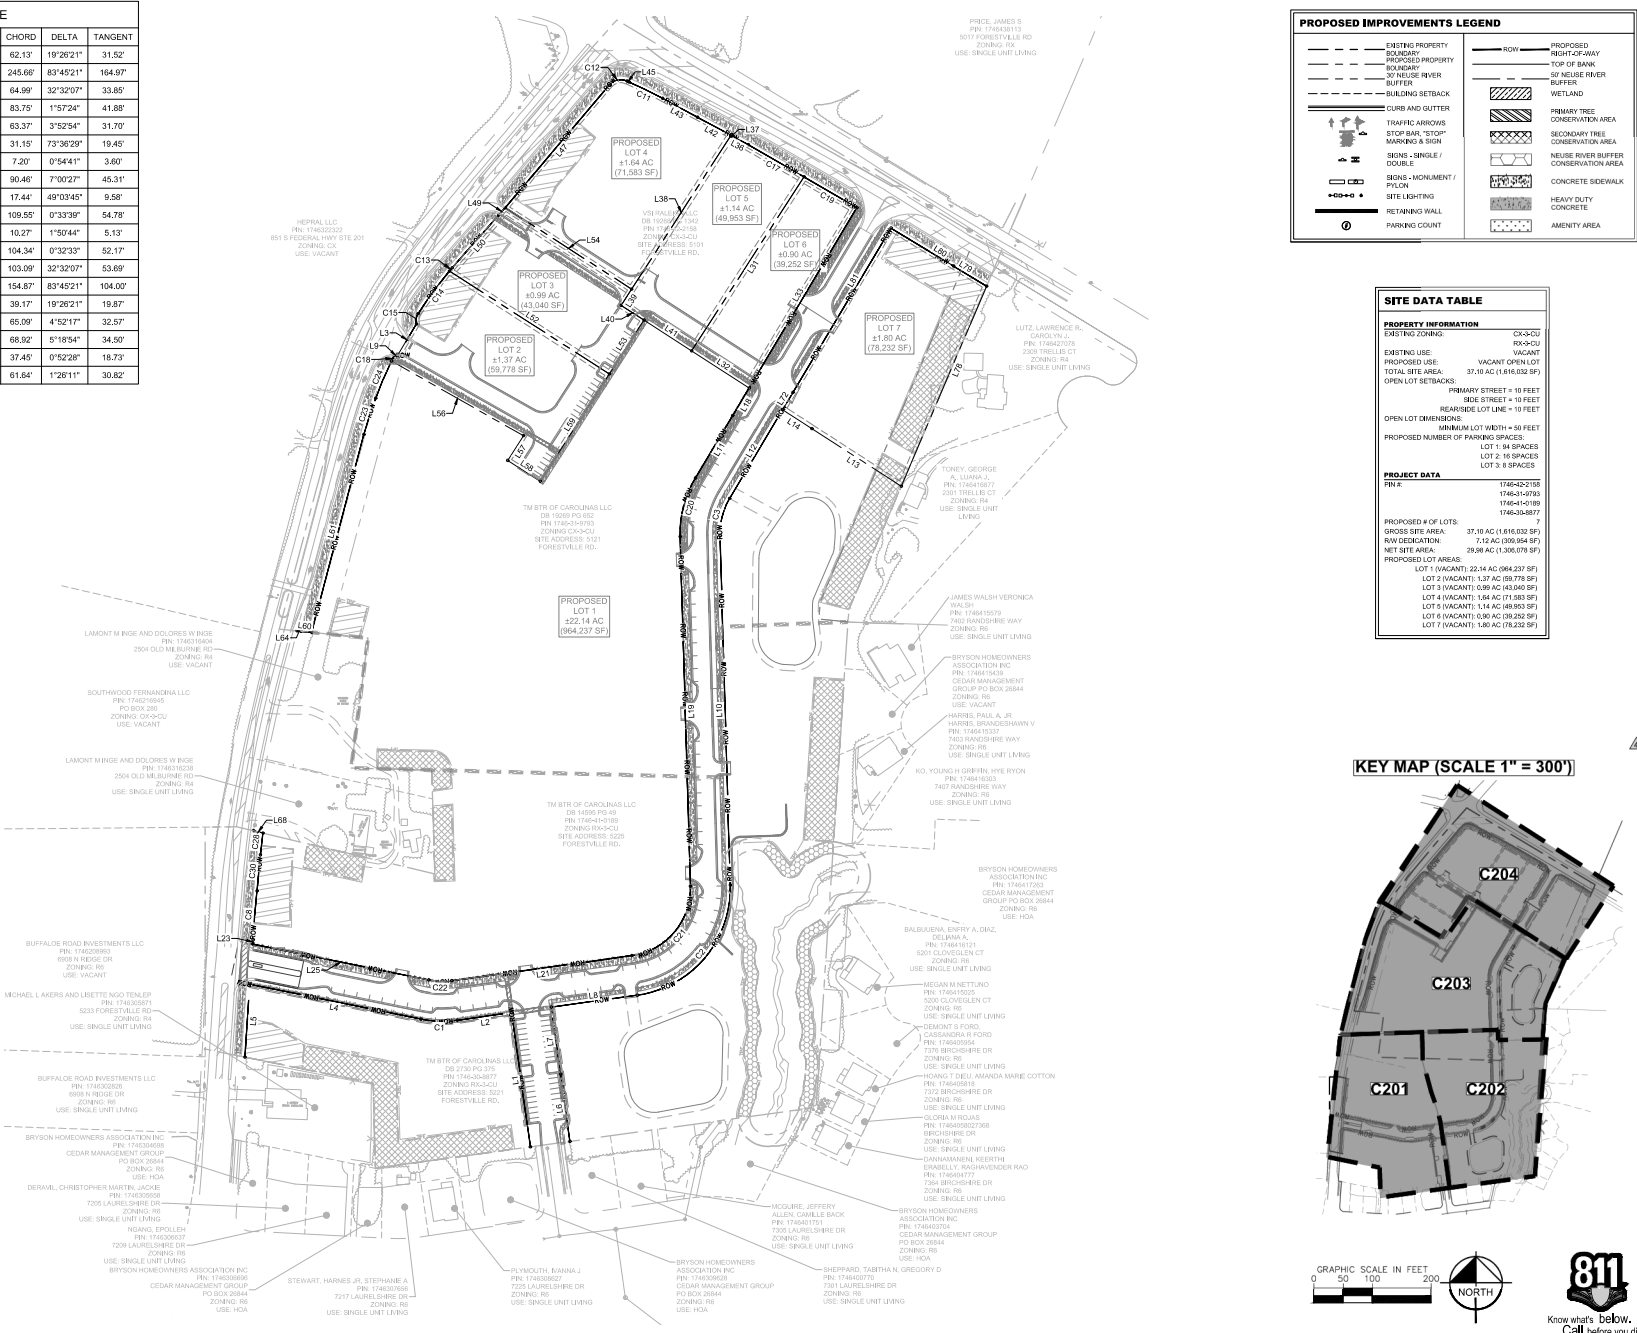

PROPOSED IMPROVEMENTS LEGEND			
	EXISTING PROPERTY BOUNDARY		ROW
	PROPOSED PROPERTY BOUNDARY		RIGHT-OF-WAY
	50' NEUSE RIVER BUFFER		TOP OF BANK
	BUILDING SETBACK		50' NEUSE RIVER BUFFER
	CURB AND GUTTER		WETLAND
	TRAFFIC ARROWS		PRIMARY TREE CONSERVATION AREA
	STOP BANK		SECONDARY TREE CONSERVATION AREA
	MARKING A SIGN		NEUSE RIVER BUFFER
	STONE - BRIDGE		CONCRETE SIDEWALK
	STONE - MONUMENT		HEAVY DUTY CONCRETE
	SITE LIGHTING		AMENITY AREA
	RETAINING WALL		
	PARKING COUNT		

SITE DATA TABLE	
PROPERTY INFORMATION	
EXISTING ZONING:	CK-KC-02
PROPOSED USE:	VACANT
PROPOSED LOT:	37.10 AC (1,616,032 SF)
TOTAL SITE AREA:	37.10 AC (1,616,032 SF)
OPEN LOT SETBACKS:	PRIMARY STREET = 10 FEET SIDE STREET = 10 FEET NEARBY LOT LINE = 10 FEET
OPEN LOT DIMENSIONS:	MINIMUM LOT WIDTH = 50 FEET
PROPOSED NUMBER OF PARKING SPACES:	LOT 1: 84 SPACES LOT 2: 10 SPACES LOT 3: 8 SPACES
PROJECT DATA	
PROPOSED # OF LOTS:	176-42-2158 176-43-4793 176-44-0189 176-45-8877
GROSS SITE AREA:	37.10 AC (1,616,032 SF)
R/W DEDICATION:	7.12 AC (309,364 SF)
NET SITE AREA:	30.98 AC (1,306,678 SF)
PROPOSED LOT AREAS:	LOT 1 VACANT: 22.14 AC (964,237 SF) LOT 2 VACANT: 1.37 AC (59,778 SF) LOT 3 VACANT: 0.89 AC (43,040 SF) LOT 4 VACANT: 1.84 AC (77,580 SF) LOT 5 VACANT: 1.14 AC (49,953 SF) LOT 6 VACANT: 0.86 AC (39,282 SF) LOT 7 VACANT: 1.86 AC (78,232 SF)

KEY MAP (SCALE 1" = 300')

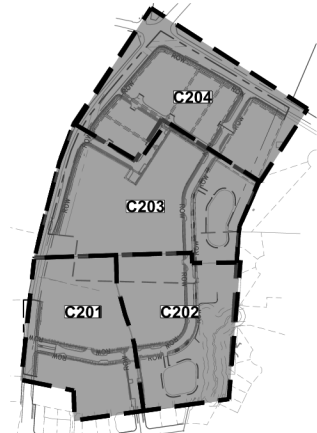

© 2024 KIMLEY-HORN AND ASSOCIATES, INC.  
300 SOUTH MAIN ST. SUITE 212 HOLLY SPRINGS, NC 27540  
WWW.KIMLEY-HORN.COM  
NC LICENSE # 5102

**PRELIMINARY**  
NOT FOR CONSTRUCTION

YARDLY BUFFALO VILLAGE  
PREPARED FOR  
YARDLY BY TAYLOR MORRISON  
BTR / VSI RALEIGH, LLC

811  
Know what's below.  
Call before you dig.


SHEET NUMBER  
**C206**

NO.	DATE	BY
1	02/06/24	BAK
2	02/06/24	BAK
3	02/06/24	BAK
100	02/06/24	BAK





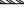
This document, together with the concepts and designs presented herein, as an instrument of service, is intended only for the specific purpose and client for which it was prepared. Reuse of and improper reliance on this document without written authorization and adaptation by Kimley-Horn and Associates, Inc. will be without liability to Kimley-Horn and Associates, Inc.

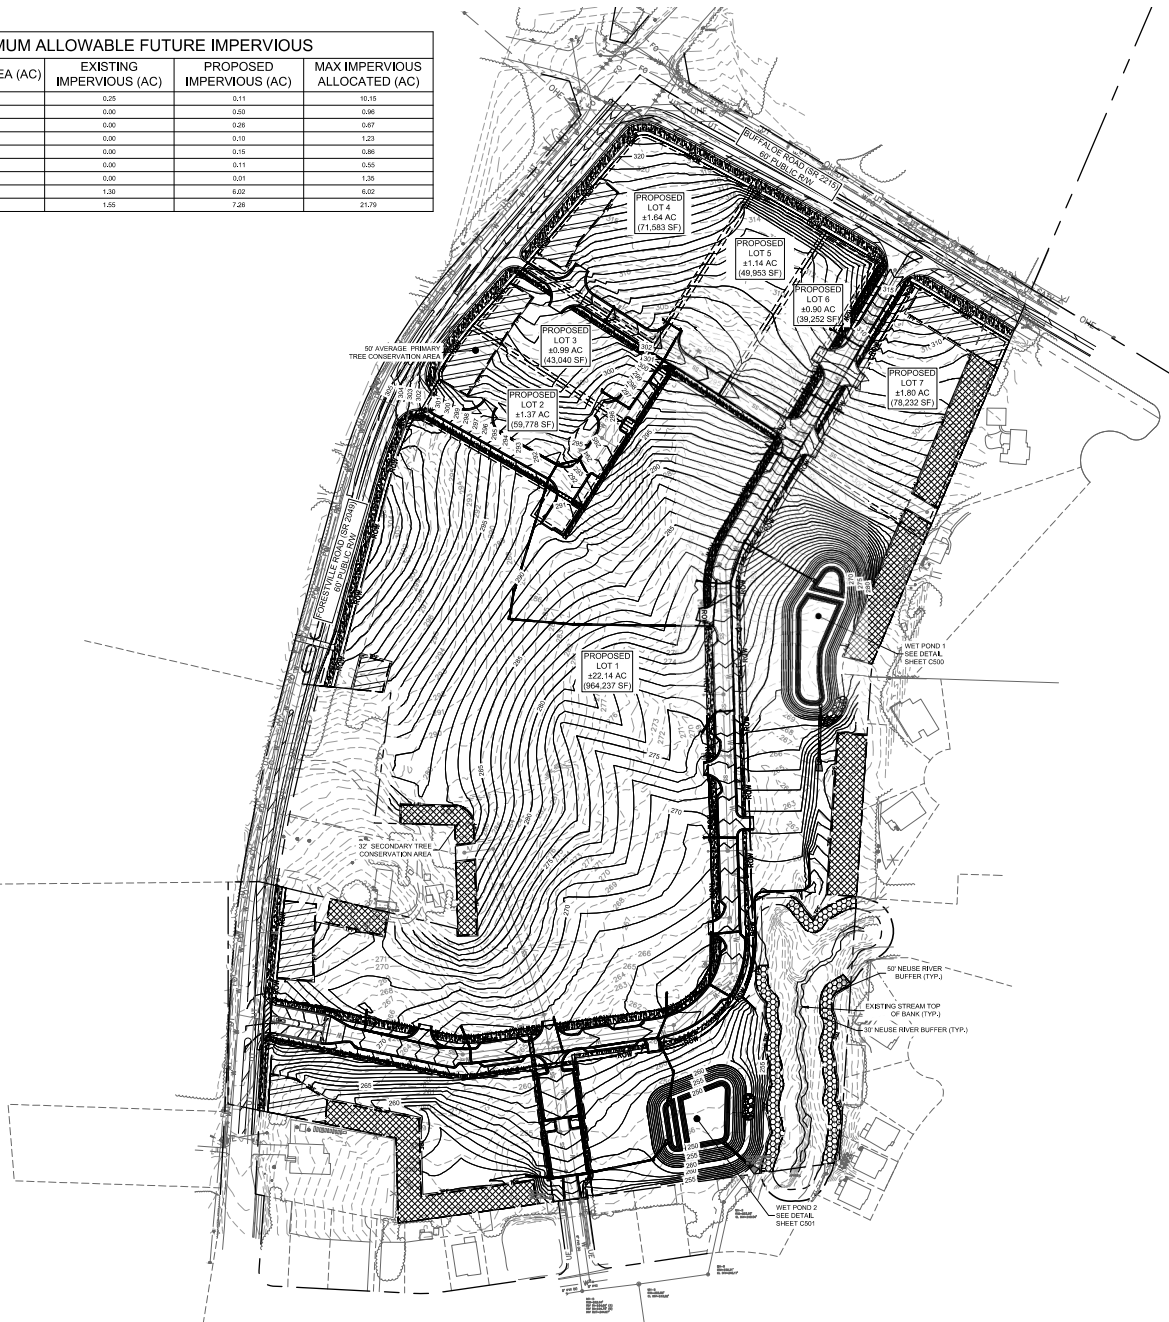


MAXIMUM ALLOWABLE FUTURE IMPERVIOUS				
LOT	TOTAL AREA (AC)	EXISTING IMPERVIOUS (AC)	PROPOSED IMPERVIOUS (AC)	MAX IMPERVIOUS ALLOCATED (AC)
LOT 1	22.14	0.25	0.11	16.15
LOT 2	1.27	0.00	0.60	0.66
LOT 3	0.99	0.00	0.26	0.67
LOT 4	0.64	0.00	0.19	1.23
LOT 5	1.14	0.00	0.15	0.86
LOT 6	0.80	0.00	0.11	0.55
LOT 7	1.80	0.00	0.01	1.79
PUBLIC ROW	7.12	1.50	0.60	4.02
TOTAL	35.10	1.58	7.28	21.79

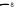

### GRADING AND DRAINAGE LEGEND

---	PROPERTY BOUNDARY	ROW	RIGHT-OF-WAY
---	CURB AND GUTTER	---	STORM DRAIN
450	PROPOSED MAJOR CONTOUR	600	EXISTING MAJOR CONTOUR
451	PROPOSED MINOR CONTOUR	451	EXISTING MINOR CONTOUR
500	SPOT ELEVATION	1.00	LIMITS OF DISTURBANCE
	CATCH BASIN (CB)		PRIMARY TREE CONSERVATION AREA
	MANHOLE (SMH)		SECONDARY TREE CONSERVATION AREA
---	RETAINING WALL		AMENITY AREA

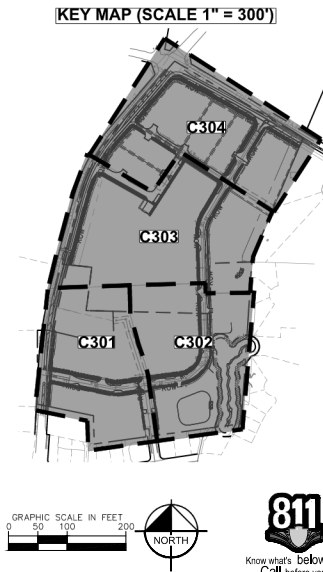

**Kimley»Horn**  
© 2024 KIMLEY-HORN AND ASSOCIATES, INC.  
300 SOUTH MAIN ST. SUITE 212, HOLLY SPRINGS, NC 27540  
PHONE: 919-273-3559  
WWW.KIMLEY-HORN.COM  
NC LICENSE #F-0102

**PRELIMINARY**  
NOT FOR CONSTRUCTION

KH PROJECT	DATE	SCALE	AS SHOWN
017270019	02/06/24	DESIGNED BY	MTH
		DRAWN BY	MTH


OVERALL  
PRELIMINARY  
GRADING AND  
DRAINAGE PLAN

**YARDLY BUFFALO  
VILLAGE**  
PREPARED FOR  
YARDLY BY TAYLOR MORRISON  
BTR / VSI RALEIGH, LLC


SHEET NUMBER  
C300



Prepared by: Kimley-Horn, Incorporated, 10000 North Carolina Highway 100, Raleigh, NC 27601. Project No. 2020-001. Date: 02/06/2024. This drawing is the property of Kimley-Horn, Incorporated and is not to be reproduced, stored in a retrieval system, or transmitted in any form or by any means, electronic, mechanical, photocopying, recording, or by any information storage and retrieval system, without the prior written permission of Kimley-Horn, Incorporated.

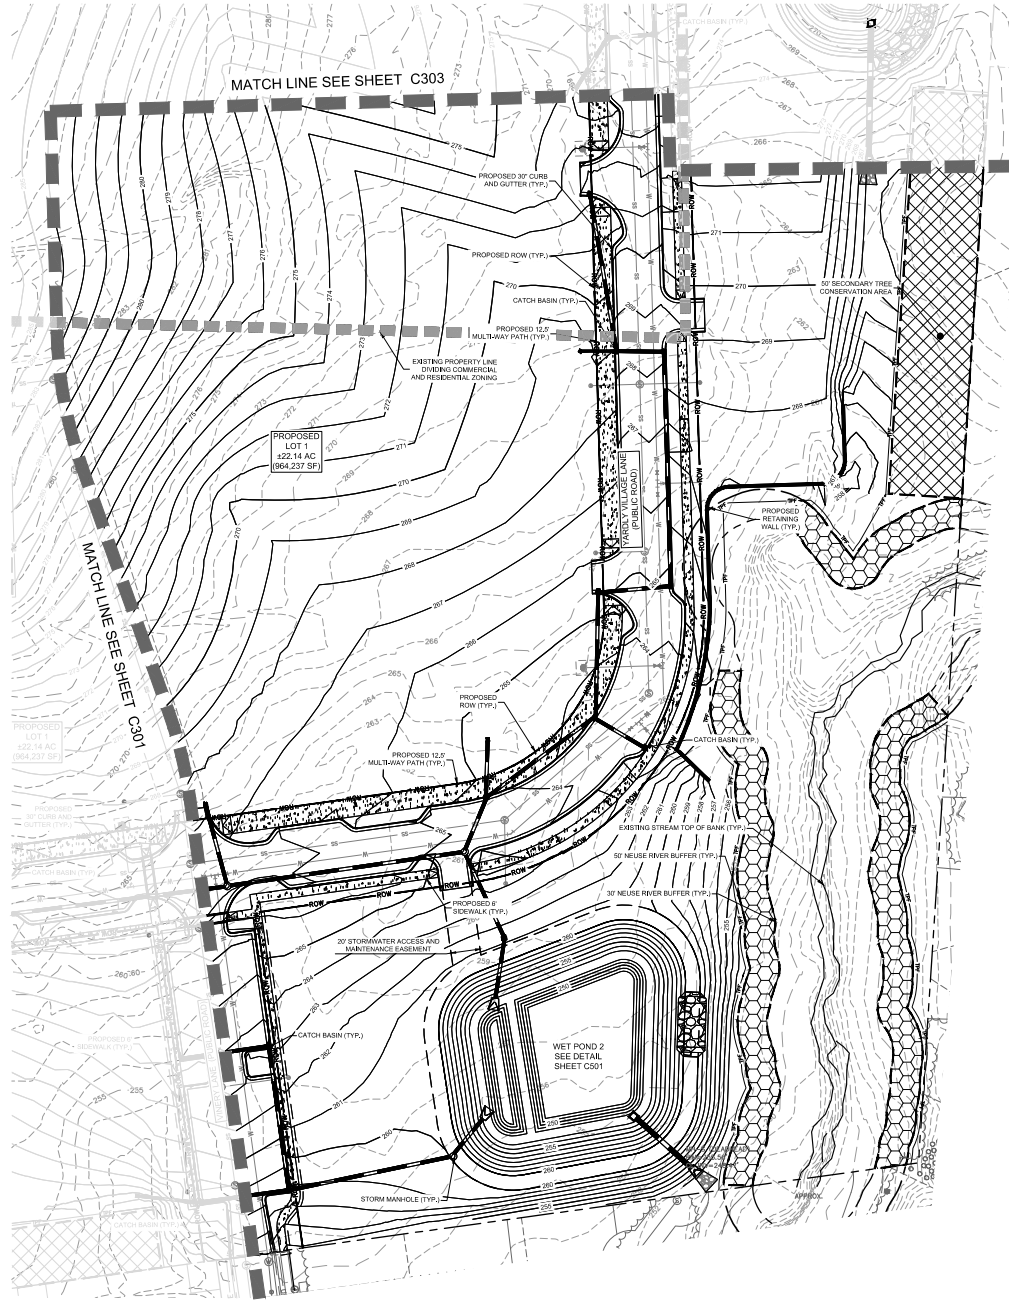

GRADING AND DRAINAGE LEGEND			
--- PROPERTY BOUNDARY	--- ROW	--- RIGHT-OF-WAY	
--- CURB AND GUTTER	--- STORM DRAIN		
--- PROPOSED MAJOR CONTOUR	--- EXISTING MAJOR CONTOUR		
--- PROPOSED MINOR CONTOUR	--- EXISTING MINOR CONTOUR		
--- SPOT ELEVATION	--- LIMITS OF DISTURBANCE		
--- CATCH BASIN (CB)	--- PRIMARY TREE CONSERVATION AREA		
--- MANHOLE (SDMH)	--- SECONDARY TREE CONSERVATION AREA		
--- RETAINING WALL	--- AMENITY AREA		

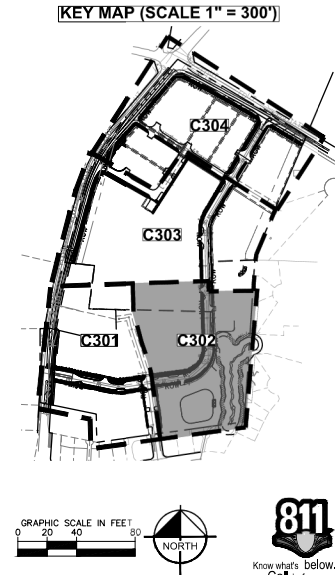

YARDLY BUFFALOEE VILLAGE

PREPARED FOR TAYLOR MORRISON BTR / VSI RALEIGH, LLC

RALEIGH NC

PRELIMINARY GRADING AND DRAINAGE PLAN

DATE: 02/06/2024

DESIGNED BY: NTH

DRAWN BY: NTH

CHECKED BY: NTH

811

Know what's below. Call before you dig.

Kimley-Horn

© 2024 KIMLEY-HORN AND ASSOCIATES, INC.

300 SOUTH MAIN STREET, SUITE 212, HOLLY SPRING, NC 27540

WWW.KIMLEY-HORN.COM

NC LICENSE # 5102

PROJECT NO. 2020-001

DATE: 02/06/2024

DESIGNED BY: NTH

DRAWN BY: NTH

CHECKED BY: NTH



REVISIONS


DATE

BY

This document, together with the concepts and designs presented herein, is an instrument of service, is intended only for the specific purpose and client for which it was prepared, and its use for any other purpose without the written authorization and adaptation by Kimley-Horn and Associates, Inc. shall be without liability to Kimley-Horn and Associates, Inc.



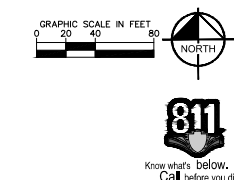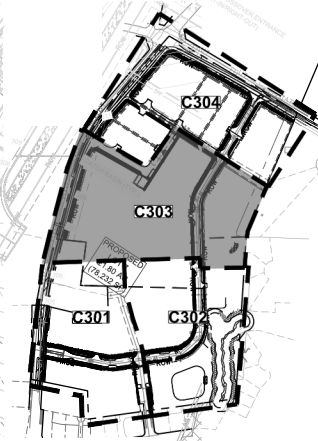


SHEET NUMBER		C303																					
YARDLY BUFFALO E VILLAGE PREPARED FOR		YARDLY BY TAYLOR MORRISON RALEIGH BTR / VSI RALEIGH, LLC NC																					
PRELIMINARY GRADING AND DRAINAGE PLAN		<div>PRELIMINARY NOT FOR CONSTRUCTION</div>																					
KH PROJECT 017770019		<div><p><b>Kimley-Horn</b> 300 SOUTH MAIN ST., SUITE 200 • RALEIGH, NC 27601 WWW.KIMLEY-HORN.COM NC LICENSE # 9152</p></div>																					
SHEET NUMBER 0206074		<table><tr><th>NO.</th><th>REVISIONS</th><th>DATE</th><th>BY</th></tr><tr><td>1</td><td>CITY COMMENTS</td><td>10/26/2024</td><td>JNAL</td></tr><tr><td>2</td><td>CITY COMMENTS</td><td>10/26/2024</td><td>JNAL</td></tr><tr><td>3</td><td>CITY COMMENTS</td><td>10/26/2024</td><td>JNAL</td></tr><tr><td>4</td><td>CITY COMMENTS</td><td>07/26/2025</td><td>JNAL</td></tr></table>		NO.	REVISIONS	DATE	BY	1	CITY COMMENTS	10/26/2024	JNAL	2	CITY COMMENTS	10/26/2024	JNAL	3	CITY COMMENTS	10/26/2024	JNAL	4	CITY COMMENTS	07/26/2025	JNAL
NO.	REVISIONS	DATE	BY																				
1	CITY COMMENTS	10/26/2024	JNAL																				
2	CITY COMMENTS	10/26/2024	JNAL																				
3	CITY COMMENTS	10/26/2024	JNAL																				
4	CITY COMMENTS	07/26/2025	JNAL																				
SCALE AS SHOWN																							
DESIGNED BY MTH																							
DRAWN BY MTH																							
CHECKED BY NAW																							






STANDARD UTILITY NOTES (AS APPLICABLE):

1. ALL MATERIALS & CONSTRUCTION METHODS SHALL BE IN ACCORDANCE WITH CITY OF RALEIGH DESIGN STANDARDS, DETAILS & SPECIFICATIONS (REFERENCE: CORPUS HANDBOOK, CURRENT EDITION).
2. UTILITY SEPARATION REQUIREMENTS:
  - A) A DISTANCE OF 10' SHALL BE MAINTAINED BETWEEN SANITARY SEWER & ANY PRIVATE OR PUBLIC WATER SUPPLY SOURCE SUCH AS AN UNBARRICADED RESERVOIR USED AS A SOURCE OF DRINKING WATER. IF ADEQUATE LATERAL SEPARATION CANNOT BE ACHIEVED, FERROUS SANITARY SEWER PIPES SHALL BE SPECIFIED & INSTALLED TO WATERLINE SPECIFICATIONS. HOWEVER, THE MINIMUM SEPARATION SHALL NOT BE LESS THAN 25' FROM A PRIVATE WELL OR 50' FROM A PUBLIC WELL.
  - B) WHEN INSTALLING WATER & RCP SEWER MAINS, THE HORIZONTAL SEPARATION BETWEEN UTILITIES SHALL BE 12". IF THIS SEPARATION CANNOT BE MAINTAINED DUE TO EXISTING CONDITIONS, THE VARIATION ALLOWED IN THE WATER MAIN IN A SEPARATE TRENCH WITH THE ELEVATION OF THE WATER MAIN AT LEAST 18" ABOVE THE TOP OF THE SEWER & MUST BE APPROVED BY THE PUBLIC UTILITIES DIRECTOR. ALL DISTANCES ARE MEASURED FROM OUTSIDE DIAMETER TO OUTSIDE DIAMETER.
  - C) WHERE IT IS IMPOSSIBLE TO OBTAIN PROPER SEPARATION, OR ANYTIME A SANITARY SEWER PASSES OVER A WATERMAIN, RCP MATERIALS OR STEEL ENCASEMENT EXTENDING 18" ON EACH SIDE OF CROSSING MUST BE SPECIFIED & INSTALLED TO WATERLINE SPECIFICATIONS.
  - D) 12" MINIMUM HORIZONTAL SEPARATION IS REQUIRED BETWEEN ALL SANITARY SEWER & STORM SEWER FACILITIES, UNLESS DOW MATERIAL IS SPECIFIED FOR SANITARY SEWER.
  - E) MAINTAIN 18" MIN. VERTICAL SEPARATION AT ALL WATERMAIN & RCP STORM DRAIN CROSSINGS. MAINTAIN 24" MIN. VERTICAL SEPARATION AT ALL SANITARY SEWER & RCP STORM DRAIN CROSSINGS. WHERE ADEQUATE SEPARATIONS CANNOT BE ACHIEVED, SPECIFY RCP MATERIALS & A CONCRETE CRADLE HAVING 8" MIN. CLEARANCE (PER CORPUS DETAILS W-41 & S-49). F) ALL OTHER UNDERGROUND UTILITIES SHALL CROSS WATER & SEWER FACILITIES WITH 18" MIN. VERTICAL SEPARATION REQUIRED.
3. ANY NECESSARY FIELD REVISIONS ARE SUBJECT TO REVIEW & APPROVAL OF AN AMENDED PLAN &/OR PROFILE BY THE CITY OF RALEIGH PUBLIC UTILITIES DEPARTMENT PRIOR TO CONSTRUCTION.
4. CONTRACTOR SHALL MAINTAIN CONTINUOUS WATER & SEWER SERVICE TO EXISTING RESIDENCES & BUSINESSES THROUGHOUT CONSTRUCTION OF PROJECT. ANY NECESSARY SERVICE INTERRUPTIONS SHALL BE PRECEDED BY A 24 HOUR AHEAD NOTICE TO THE CITY OF RALEIGH PUBLIC UTILITIES DEPARTMENT.
5. 3/2" MINIMUM COVER IS REQUIRED ON ALL WATER MAINS & SEWER FORCE MAINS. 4/2" MINIMUM COVER IS REQUIRED ON ALL REUSE MAINS.
6. IT IS THE DEVELOPER'S RESPONSIBILITY TO ABANDON OR REMOVE EXISTING WATER & SEWER SERVICES NOT BEING USED IN REDEVELOPMENT OF A SITE UNLESS OTHERWISE DIRECTED BY THE CITY OF RALEIGH PUBLIC UTILITIES DEPARTMENT. THIS INCLUDES ABANDONING TWP AT MAIN & REMOVAL OF SERVICE FROM ROW OR EASEMENT PER CORPUS HANDBOOK PROCEDURE.
7. INSTALL 8" PVC SEWER SERVICES @ 1.5% MINIMUM GRADE WITH CLEANOUTS LOCATED AT ROW OR EASEMENT LINE & SPACED EVERY 50' LINEAR FEET MAXIMUM.
8. PRESSURE REDUCING VALVES ARE REQUIRED ON ALL WATER SERVICES EXCEEDING 18" BACKEATER VALVES ARE REQUIRED ON ALL SANITARY SEWER SERVICES HAVING BUILDING DRAINS LOWER THAN 1/2' ABOVE THE NEXT UPSTREAM MANHOLE.
9. ALL ENVIRONMENTAL PERMITS APPLICABLE TO THE PROJECT MUST BE OBTAINED FROM NCOW. USACE AOR FEMA FOR ANY RIPARIAN BUFFER, WETLAND & BOD FLOODPLAIN IMPACTS (RESPECTIVELY) PRIOR TO CONSTRUCTION.
10. NCDOT ROADWAY ENCROACHMENT AGREEMENTS ARE REQUIRED FOR ANY UTILITY WORK (INCLUDING MAIN EXTENSIONS & SERVICE TAPS) WITHIN STATE OR RAILROAD ROW PRIOR TO CONSTRUCTION.
11. GREASE INTERCEPTOR / OIL WATER SEPARATOR SIZING CALCULATIONS & INSTALLATION SPECIFICATIONS SHALL BE APPROVED BY THE CORPUS FCM PROGRAM COORDINATOR PRIOR TO SUBMITTAL OF A BUILDING PERMIT. CONTACT TMI BEASLEY AT (919) 996-2334 OR TMI@BEASLEY@RALEIGHNC.GOV FOR MORE INFORMATION.
12. CROSS-CONNECTION CONTROL PROTECTION DEVICES ARE REQUIRED BASED ON DEGREE OF HEALTH HAZARD INVOLVED AS LISTED IN APPENDIX A OF THE RULES GOVERNING PUBLIC WATER SYSTEMS IN NORTH CAROLINA. THESE DEVICES ARE THE MINIMUM REQUIREMENTS. THE DEVICES SHALL MEET AMERICAN SOCIETY OF SANITARY ENGINEERING (ASSE) STANDARDS OR BE ON THE UNIVERSITY OF SOUTHERN CALIFORNIA APPROVAL LIST. THE DEVICES SHALL BE INSTALLED AND TESTED (BOTH INITIAL AND PERIODIC TESTING THEREAFTER IN ACCORDANCE WITH THE MANUFACTURER'S RECOMMENDATIONS OR THE LOCAL CROSS-CONNECTION CONTROL PROGRAM, WHICHEVER IS MORE STRINGENT. CONTACT JOANNE HARTLEY AT (919) 996-5932 OR JOANNE.HARTLEY@RALEIGHNC.GOV FOR MORE INFORMATION.
13. FIRE DEPARTMENT VEHICLE ACCESS LANE MUST BE CAPABLE OF SUPPORTING THE LOAD OF FIRE APPARATUS WEIGHING AT LEAST 30,000 LB. AND SHALL BE SURFACED TO PROVIDE ALL WEATHER DRIVING CAPABILITIES (POFC 360.3.2).
14. MAXIMUM ANTICIPATED AVERAGE DAILY FLOW (SEWER) FOR THE PROJECT IS 67,500 GPD.

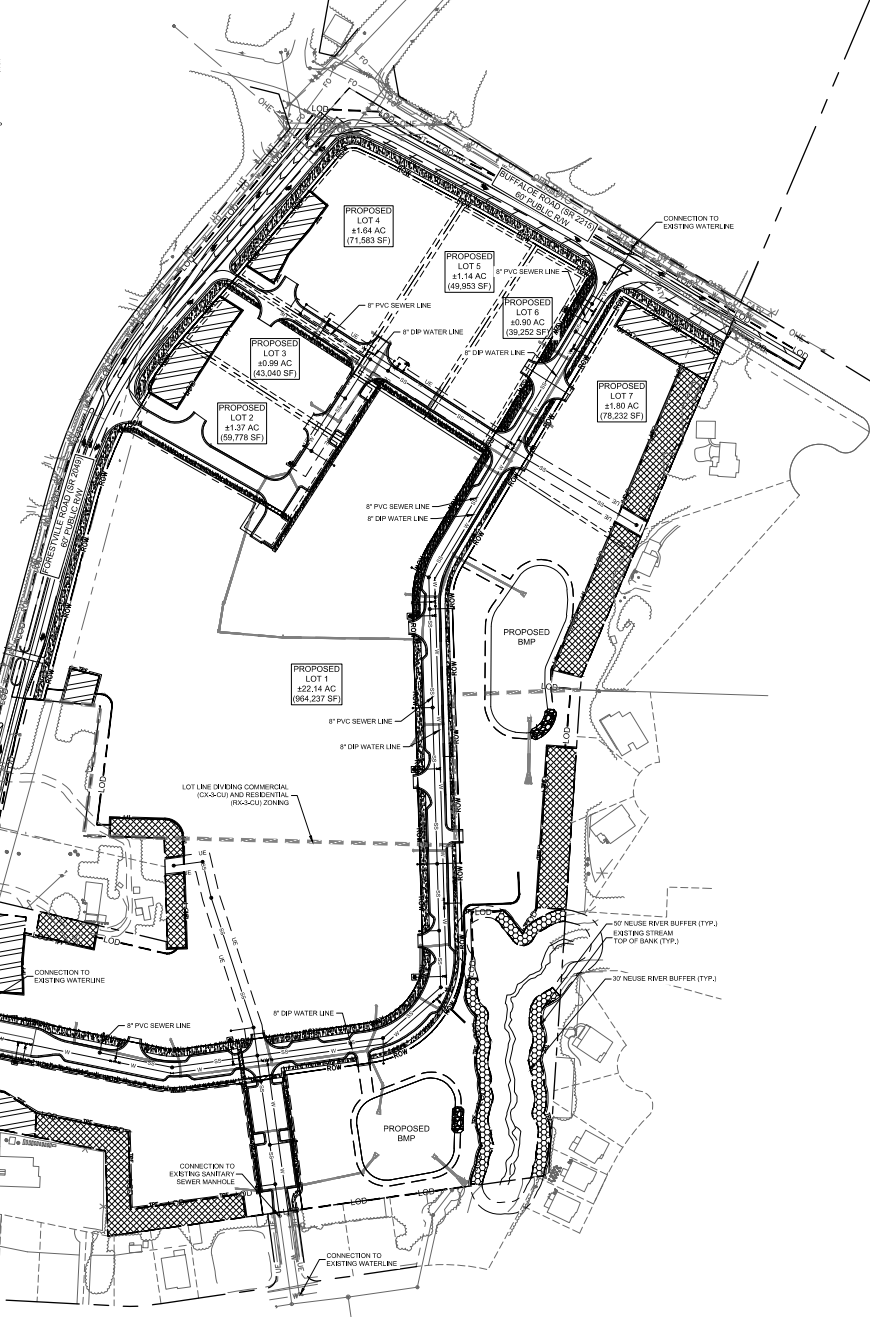

UTILITY LEGEND	
---	PROPERTY BOUNDARY
---	WATER LINE
---	ROOF DRAIN
---	WATER METER
---	POINT OF CONNECTION
---	PIPE TRENCH
---	FIRE HYDRANT (FH)
---	FIRE DEPARTMENT CONNECTION (FDC)
---	ROW
---	RIGHT-OF-WAY
---	SANITARY SEWER LINE
---	UTILITY EASEMENT
---	GATE VALVE
---	BACKFLOW PREVENTOR
---	SANITARY SEWER CLEANOUT (SSCO)
---	SANITARY SEWER CLEANOUT TRAFFIC RATED
---	SANITARY SEWER MANHOLE (SMH)

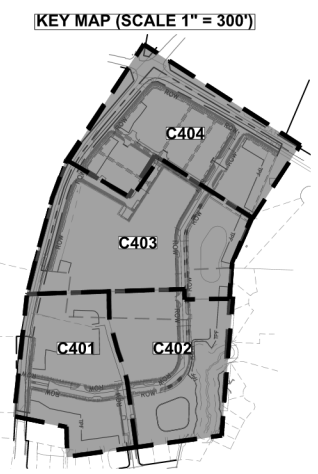

811

Know what's below.  
Call before you dig.

YARDLY BUFFALOEE VILLAGE  
PREPARED FOR  
YARDLY BY TAYLOR MORRISON  
BTR / VSI RALEIGH, LLC  
RALEIGH NC

OVERALL  
PRELIMINARY  
UTILITY PLAN

PRELIMINARY  
NOT FOR CONSTRUCTION

PROJECT NO. 2024-001  
DATE 02/06/24  
SCALE AS SHOWN  
DESIGNED BY NTH  
DRAWN BY NTH  
CHECKED BY NTH

PROJECT NO. 2024-001  
DATE 02/06/24  
SCALE AS SHOWN  
DESIGNED BY NTH  
DRAWN BY NTH  
CHECKED BY NTH

Kimley-Horn  
© 2024 KIMLEY-HORN AND ASSOCIATES, INC.  
300 SOUTH MAIN STREET, SUITE 212, HOLLY SPRING, NC 27540  
WWW.KIMLEY-HORN.COM  
NC LICENSE # 002

CITY COMMENTS  
CITY COMMENTS  
CITY COMMENTS  
CITY COMMENTS  
CITY COMMENTS

DATE  
DATE  
DATE  
DATE  
DATE

This document, together with the concepts and design presented herein, as an instrument of service, is intended only for the specific purpose and client for which it was prepared. Reuse of and/or reproduction of this document without written authorization and adaptation by Kimley-Horn and Associates, Inc. is strictly prohibited.










811

Know what's below.  
Call before you dig.

SHEET NUMBER  
C403







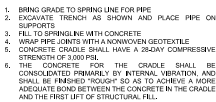

## EARTHEN DAM SPECIFICATIONS

- EMERGENCY SPILLWAY ELEV: 272.50 -


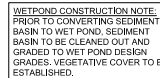
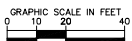


**PRINCIPAL SPILLWAY PIPE NOTE**  
THE PRINCIPAL SPILLWAY PIPE SHALL BE REINFORCED CONCRETE AND CONFORM TO ASTM C-76, CLASS III STANDARDS. RUBBER GASKETED JOINT PIPE SHALL BE INSTALLED.


100-YR STORM ELEV = 272.99  
10-YR STORM ELEV = 272.54  
2-YR STORM ELEV = 271.47  
TEMPORARY POOL ELEV = 270.30  
PERMANENT POOL ELEV = 268.00



1. RISER STRUCTURES  
CONSTRUCTED WITH MULTIPLE  
BARREL SECTIONS SHALL HAVE  
WATERTIGHT JOINTS, AND EACH  
SECTION SHALL BE BOLTED TO  
ADJACENT SECTIONS WITH  
STAINLESS STEEL STRAPS AND  
HARDWARE.

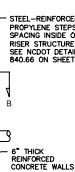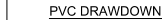
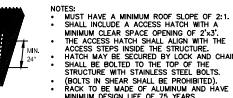


Plotted by: [redacted] Date: [redacted] Sheet: [redacted] of [redacted] Project: [redacted] Title: [redacted] Scale: [redacted] Notes: [redacted]

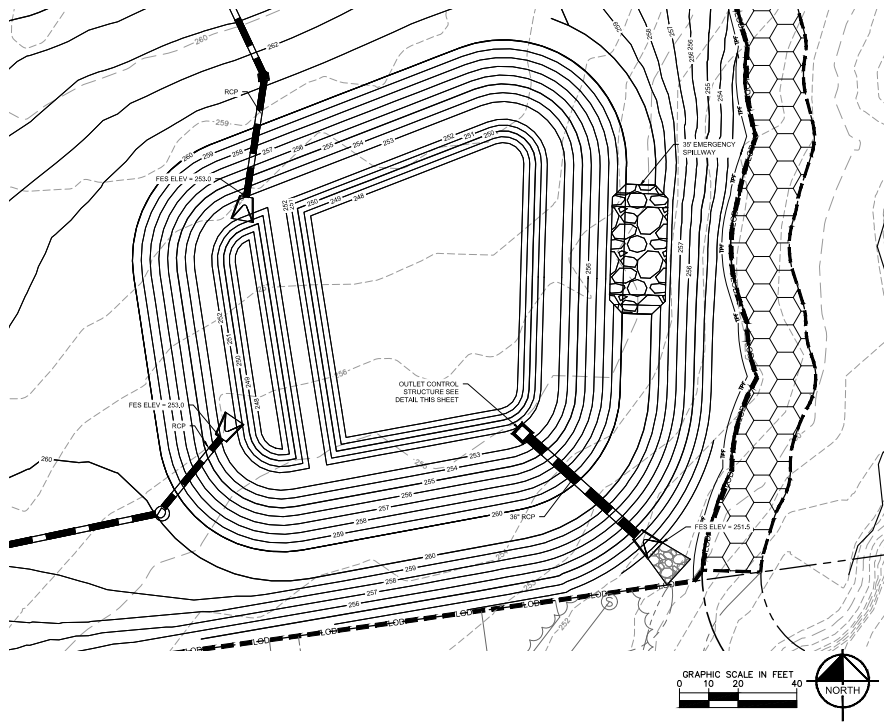

### EARTHEN DAM SPECIFICATIONS

- A MAXIMUM SLOPE OF 3H:1V SHALL BE USED ON THE EMBANKMENTS TO ALLOW MAINTENANCE EQUIPMENT AND TO MAINTAIN GROUND COVER.
- TREATMENT OF SEEPAGE AREAS, SUBGRADE PREPARATION, FOUNDATION DRAINAGE, AND ROCK FOUNDATION PREPARATION (E.G. TREATMENT WITH SLUSH GROUTING, DENTAL CONCRETE, ETC.) MAY BE REQUIRED AT THE DISCRETION OF THE GEOTECHNICAL ENGINEER. ALL SUCH ACTIVITIES SHALL BE CLOSELY MONITORED AND DOCUMENTED BY THE GEOTECHNICAL ENGINEER.
- TO RE-ESTABLISH VEGETATION AFTER CONSTRUCTION, A 2- TO 3-INCH LAYER OF TOPSOIL SHALL BE PLACED ON THE DISTURBED EMBANKMENT SURFACE AND THE AREA SEEDED AND MULCHED OR HYDROSEEDING.
- A GRASS SURFACE IS REQUIRED TO PREVENT EROSION AND RUTTING. IF VEGETATION IS USED TO STABILIZE THE EMBANKMENT, PROPER MAINTENANCE, INCLUDING MOWING, FERTILIZING, AND RESEEDING BARE SPOTS, IS REQUIRED TO PREVENT EROSION.
- WHERE FILL IS REQUIRED TO RAISE THE EXISTING GRADES OF THE SITE TO THE NEW SUBGRADE ELEVATIONS INDICATED, SUCH FILL SHALL BE OF EARTH, PLACED COMPACTED AS SPECIFIED. ON-SITE OR OFF-SITE BORROW MATERIAL SHALL BE APPROVED BY THE INDEPENDENT TESTING LABORATORY'S GEOTECHNICAL ENGINEER PRIOR TO BEING PLACED ON PROPOSED FILL AREA.
- ALL SUBGRADE TO RECEIVE FILL SHALL BE EVALUATED BY THE GEOTECHNICAL ENGINEER PRIOR TO PLACING NEW FILL. METHODS FOR EVALUATION SHALL INCLUDE PROOF ROLLING USING TANDEN AXLE DUMP TRUCK OR SIMILAR PNEUMATIC TYRED EQUIPMENT, OR OTHER METHODS AS SPECIFIED BY THE ON-SITE GEOTECHNICAL ENGINEER. ALL SOIL THAT RUTS, PUMPS OR EXTRACTS EXCESSIVELY AS DETERMINED BY THE GEOTECHNICAL ENGINEER SHALL BE CORRECTED AS SPECIFIED BY THE ON-SITE GEOTECHNICAL ENGINEER.
- METHODS OF CORRECTION MAY INCLUDE DRYING AND COMPACTION, PLACEMENT OF 18 TO 24 INCH BROAD LIFT OF BORROW MATERIAL APPROVED BY THE GEOTECHNICAL ENGINEER, STABILIZATION WITH FABRIC AND STONE, AND/OR UNDERCUTTING.
- ALL VISIBLE ORGANIC DEBRIS SUCH AS ROOTS AND LIMBS SHALL BE REMOVED FROM THE FILL MATERIAL PRIOR TO COMPACTION TO THE REQUIRED DENSITY. SOILS WITH ORGANIC WATER CONTENT EXCEEDING 5% BY WEIGHT SHALL NOT BE USED. STONES GREATER THAN 3-INCH (IN ANY DIRECTION) SHALL BE REMOVED FROM THE FILL PRIOR TO COMPACTION.
- THE SURFACE OF THE GROUND AND MOISTURE CONTENT OF THE LOOSERED MATERIAL SHALL BE SUCH THAT IT WILL READILY BOND WITH THE FIRST LAYER OF FILL MATERIAL.
- CONTROLLED FILL, AS SPECIFIED BY THE GEOTECHNICAL ENGINEER, IN THE DAM EMBANKMENT SHALL BE PLACED IN 6-INCH LOOSE LAYERS (3-INCH LOOSE LAYERS WITHIN 3- FEET OF EITHER SIDE OF THE PRINCIPAL SPILLWAY PIPE TO A DEPTH OF 2- FEET OVER THE FIRST) AND SHALL BE COMPACTED TO A DENSITY OF NO LESS THAN 95% OF THE STANDARD PROCTOR MAXIMUM DENSITY AT A MOISTURE CONTENT OF 4% OR 2% PERCENTAGE POINTS OF THE OPTIMUM MOISTURE CONTENT IN ACCORDANCE WITH ASTM D698.
- ANY FILL LAYER THAT IS SMOOTH DRUM ROLLED TO REDUCE MOISTURE PENETRATION DURING A STORM EVENT SHALL BE PROPERLY SCARRIFIED PRIOR TO THE PLACEMENT OF THE NEXT SOIL LIFT.
- FILL ADJACENT TO THE RISER AND PRINCIPAL SPILLWAY PIPE SHALL BE PLACED SO THAT LIFTS ARE AT THE SAME LEVEL ON BOTH SIDES OF THE STRUCTURES.
- EARTHWORK COMPACTION WITHIN 3- FEET OF ANY STRUCTURES SHALL BE ACCOMPLISHED BY MEANS OF HAND TAMPORS, MANUALLY DIRECTED POWER TAMPORS OR PLATE COMPACTORS OR MINATURE SELF- PROPELLED ROLLERS.
- SURFACE WATER AND STREAM FLOW SHALL BE CONTINUOUSLY CONTROLLED THROUGHOUT CONSTRUCTION AND THE PLACEMENT OF CONTROLLED FILL.
- AT THE END OF EACH DAYS ACTIVITIES, CONTRACTOR SHALL SEAL SURFACE OF NEW FILL BY USE OF A SMOOTH WHEEL ROLLER AND PROVIDE POSITIVE DRAINAGE OFF OF NEW FILL SURFACE.
- THE GEOTECHNICAL ENGINEER MUST INSPECT AND APPROVE ALL SUBGRADES AND FILL LAYERS BEFORE FURTHER CONSTRUCTION WORK IS PERFORMED THEREON.
- FILL MATERIAL PLACED AT DENSITIES LOWER THAN SPECIFIED MINIMUM DENSITIES OR AT MOISTURE CONTENTS OUTSIDE THE SPECIFIED RANGES OR OTHERWISE NOT CONFORMING TO SPECIFIED REQUIREMENTS SHALL BE REMOVED AND REPLACED WITH ACCEPTABLE MATERIALS.
- THE CONTRACTOR SHALL BE RESPONSIBLE FOR DRYING SOILS TOO WET TO ACHIEVE COMPACTION OR STABILITY. SOILS SHALL NOT BE CONSIDERED UNSUITABLE SOLELY DUE TO MOISTURE CONTENT.
- FOUNDATION AREAS MAY REQUIRE UNDERCUTTING OF COMPRESSIBLE AND/OR UNSUITABLE SOILS IN ADDITION TO THAT INDICATED ON THE PLANS. ALL SUCH UNDERCUTTING SHALL BE PERFORMED AT THE DISCRETION OF THE GEOTECHNICAL ENGINEER AND SHALL BE MONITORED AND DOCUMENTED. IN NO CASE SHALL THERE BE AN ATTEMPT TO STABILIZE ANY PORTIONS OF THE FOUNDATION SOILS WITH CRUSHED STONE.
- COMPACTION BY MEANS OF DROP WEIGHTS FROM A CRANE OR HOIST SHALL NOT BE PERMITTED.
- HEAVY EQUIPMENT SHALL NOT BE ALLOWED TO PASS OVER CAST-IN- PLACE STRUCTURES UNTIL ADEQUATE CURING TIME HAS ELAPSED.
- TESTS OF THE DEGREE (%) OF COMPACTION OF THE PLACED FILL IN THE DAM SHALL BE PERFORMED AS A PART OF THE CONTRACTOR'S NORMAL QUALITY CONTROL PROGRAM FOR THE CONSTRUCTION OF THE DAM. TESTS SHALL BE CONDUCTED CONCURRENT WITH THE INSTALLATION OF THE COMPACTED FILL, AND THE CONTRACTOR SHALL COORDINATE THE CONSTRUCTION OF THE DAM SO THAT THE TESTING CAN BE COMPLETED. SHOULD THE RESULTS OF THE TESTS INDICATE THAT THE SPECIFIED DEGREE OF COMPACTION HAS NOT BEEN OBTAINED, THE PORTIONS OF THE DAM REPRESENTED BY SUCH TESTS SHALL BE REMOVED OR REBUILT. ALL PORTIONS OF THE DAM SHALL ACHIEVE THE SPECIFIED MINIMUM DEGREE OF COMPACTION.
- ALL EARTHEN FILLS SHALL BE CLEARED, GRUBBED AND STRIPPED OF ALL VEGETATIVE MATERIAL, TOPSOIL AND ORGANIC MATERIAL PRIOR TO CONSTRUCTION. FULL CONSTRUCTION SPECIFICATIONS ARE REQUIRED IN ACCORDANCE WITH CHAPTER 21 OF CITY OF DURHAM OCTOBER 1, 2013 ADDENDA.

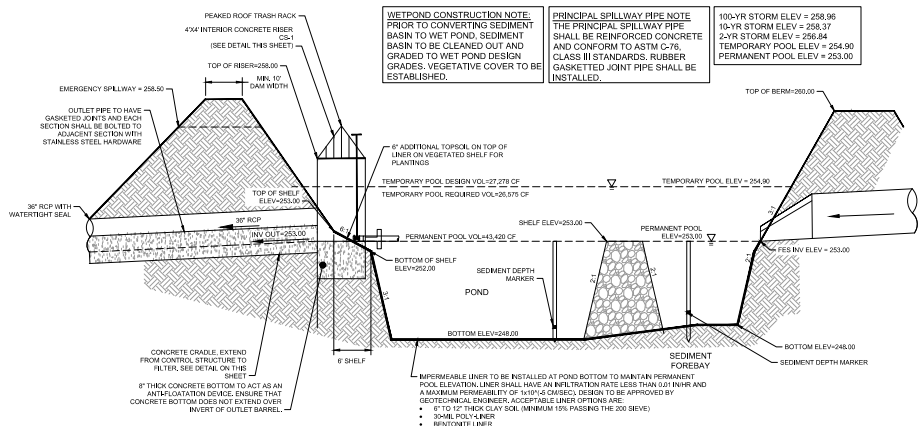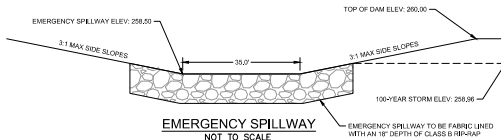


### WET DETENTION POND

NOT TO SCALE

### NOTES:


1. RISER STRUCTURES CONSTRUCTED WITH MULTIPLE BARREL SECTIONS SHALL HAVE WATERWAY JOINTS, AND EACH SECTION SHALL BE BOLTED TO ADJACENT SECTIONS WITH STAINLESS STEEL STRAPS AND HARDWARE.

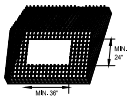

- NOTES:
- MUST HAVE A MINIMUM ROOF SLOPE OF 2:1.
  - SHALL INCLUDE A ACCESS HATCH WITH A MINIMUM CLEAR SPACE OPENING OF 2'-6".
  - THE ACCESS HATCH SHALL ALIGN WITH THE HATCH MAY BE SECURED BY LOCK AND SHALL BE BOLTED TO THE TOP OF THE STRUCTURE (BOLTS IN SHEAR SHALL BE PROHIBITED).
  - RACK TO BE MADE OF ALUMINUM AND HAVE A MINIMUM DESIGN LIFE OF 75 YEARS.

### ROOF RACK DETAIL


NOT TO SCALE

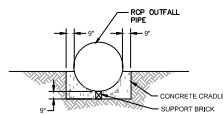

1. BRING GRADE TO SPRING LINE FOR PIPE
2. EXCAVATE TRENCH AS SHOWN AND PLACE PIPE ON SUPPORTS
3. FILL TO SPRINGLINE WITH CONCRETE
4. WRAP PIPE JOINTS WITH A NONWOVEN GEOTEXTILE
5. CONCRETE CRADLE SHALL HAVE A 24-HOUR COMPRESSIVE STRENGTH OF 3,000 PSI.
6. THE CONCRETE CRADLE SHALL BE CONSOLIDATED PRIMARILY BY INTERNAL VIBRATION, AND SHALL BE FINISHED ROUGH SO AS TO ACHIEVE A MORE ADEQUATE BOND BETWEEN THE CONCRETE IN THE CRADLE AND THE FIRST LIFT OF STRUCTURAL FILL.


### CONCRETE CRADLE DETAIL

NOT TO SCALE

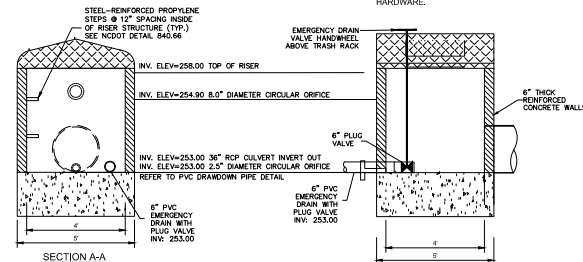


### CS-2 CONCRETE RISER CONTROL STRUCTURE

NOT TO SCALE

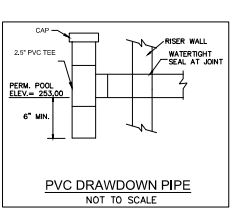

### PVC DRAWDOWN PIPE

NOT TO SCALE

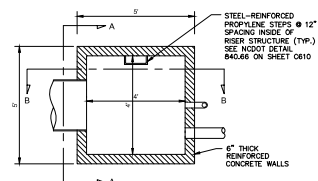

This document, together with the concepts and design presented herein, is an instrument of service, is intended only for the specific purpose and client for which it was prepared, and is not to be used for any other purpose without the written consent of Kimley-Horn and Associates, Inc. and its affiliates.

© 2024 KIMLEY-HORN AND ASSOCIATES, INC.  
300 SOUTH MAIN STREET, SUITE 210, JOLLY SPRINGS, NC 27460  
WWW.KIMLEY-HORN.COM  
NC LICENSE # 4102

NO.	DATE	BY	REVISIONS
1	02/06/24	SKM	CITY COMMENTS
2	02/06/24	SKM	CITY COMMENTS
3	02/06/24	SKM	CITY COMMENTS
4	02/06/24	SKM	CITY COMMENTS


**PRELIMINARY**  
NOT FOR CONSTRUCTION

NO.	DATE	BY	REVISIONS
1	02/06/24	SKM	CITY COMMENTS
2	02/06/24	SKM	CITY COMMENTS
3	02/06/24	SKM	CITY COMMENTS
4	02/06/24	SKM	CITY COMMENTS

**YARDLY BUFFALO VILLAGE**  
PREPARED FOR  
YARDLY BY TAYLOR MORRISON  
BTR / VSI RALEIGH, LLC  
RALEIGH

**SCM DETAILS - WET POND 2**

SHEET NUMBER  
**C501**

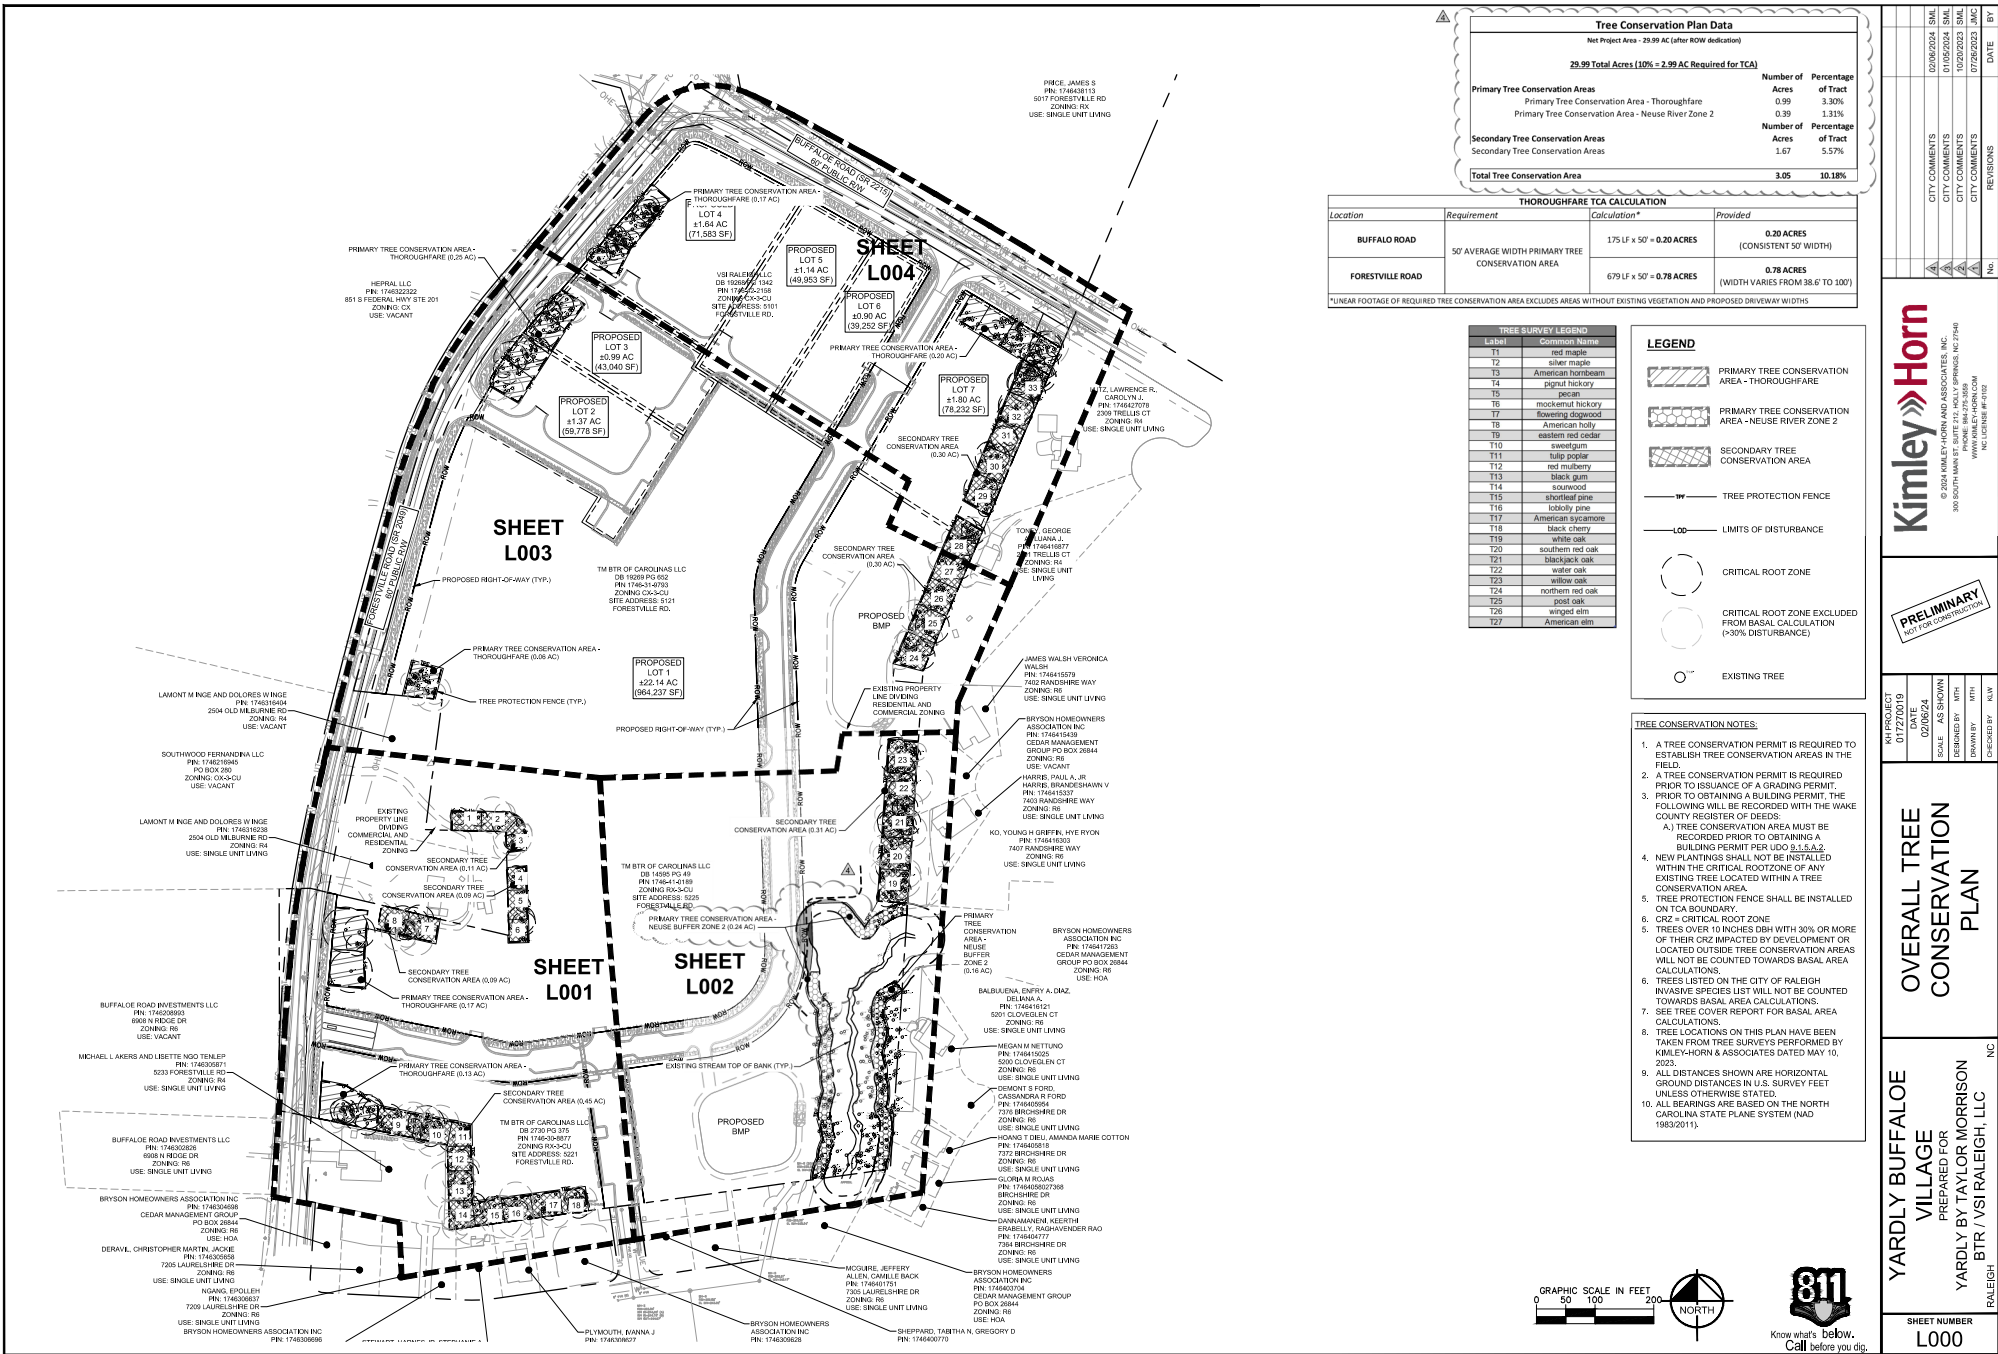


This document, together with the concepts and designs presented herein, is an instrument of service, is intended only for the specific purpose and client for which it was prepared, and its use for any other purpose without the written authorization and adaptation by Kimley-Horn and Associates, Inc. will be without liability to Kimley-Horn and Associates, Inc.







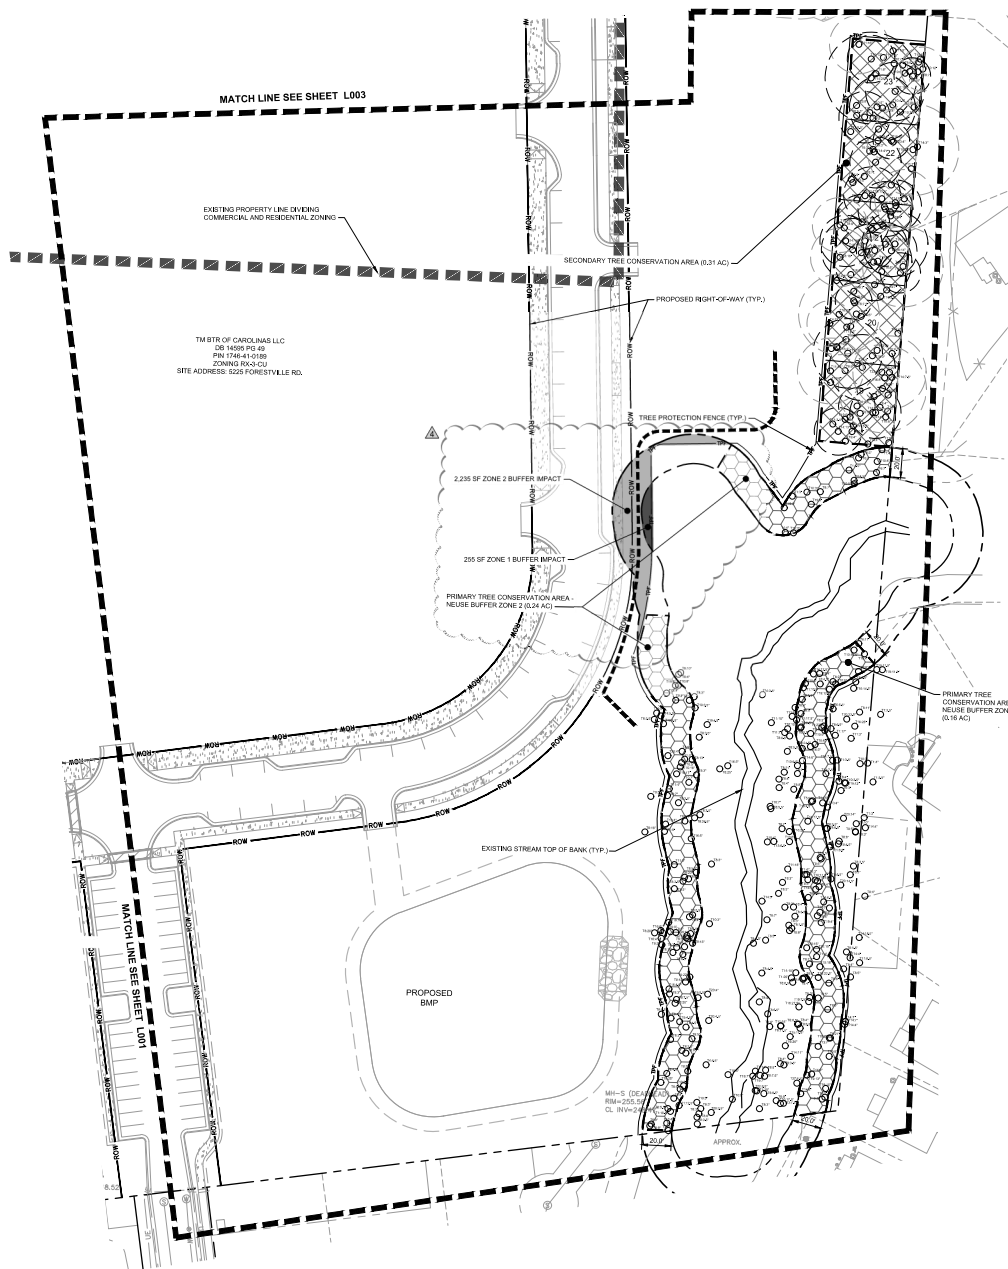

Label	Common Name
T1	red maple
T2	silver maple
T3	American hornbeam
T4	pinnut hickory
T5	pinnut
T6	mockernut hickory
T7	flowering dogwood
T8	American holly
T9	eastern red cedar
T10	sweetgum
T11	halepuglar
T12	red mulberry
T13	black gum
T14	boxwood
T15	shortleaf pine
T16	loblolly pine
T17	American sycamore
T18	black cherry
T19	white oak
T20	southern red oak
T21	blackjack oak
T22	water oak
T23	yellow oak
T24	northern red oak
T25	post oak
T26	winged elm
T27	American elm

**LEGEND**

PRIMARY TREE CONSERVATION AREA - THOROUGHFARE

PRIMARY TREE CONSERVATION AREA - NEUSE RIVER ZONE 2

SECONDARY TREE CONSERVATION AREA

TREE PROTECTION FENCE

LIMITS OF DISTURBANCE

CRITICAL ROOT ZONE


CRITICAL ROOT ZONE EXCLUDED FROM BASAL CALCULATION (>30% DISTURBANCE)

EXISTING TREE




		<b>PRELIMINARY</b> NOT FOR CONSTRUCTION		IN PROJECT DATE 02/06/24 SCALE AS SHOWN DESIGNED BY NTH DRAWN BY NTH CHECKED BY NTH		<b>TREE CONSERVATION PLAN</b>		<b>YARDLY BUFFALO VILLAGE</b> PREPARED FOR YARDLY BY TAYLOR MORRISON BTR / VSI RALEIGH, LLC NC		SHEET NUMBER <b>L002</b>	
CITY COMMENTS 02/06/2024 SNA		CITY COMMENTS 02/06/2024 SNA		CITY COMMENTS 02/06/2024 SNA		CITY COMMENTS 02/06/2024 SNA		REVISIONS DATE BY		DATE BY	



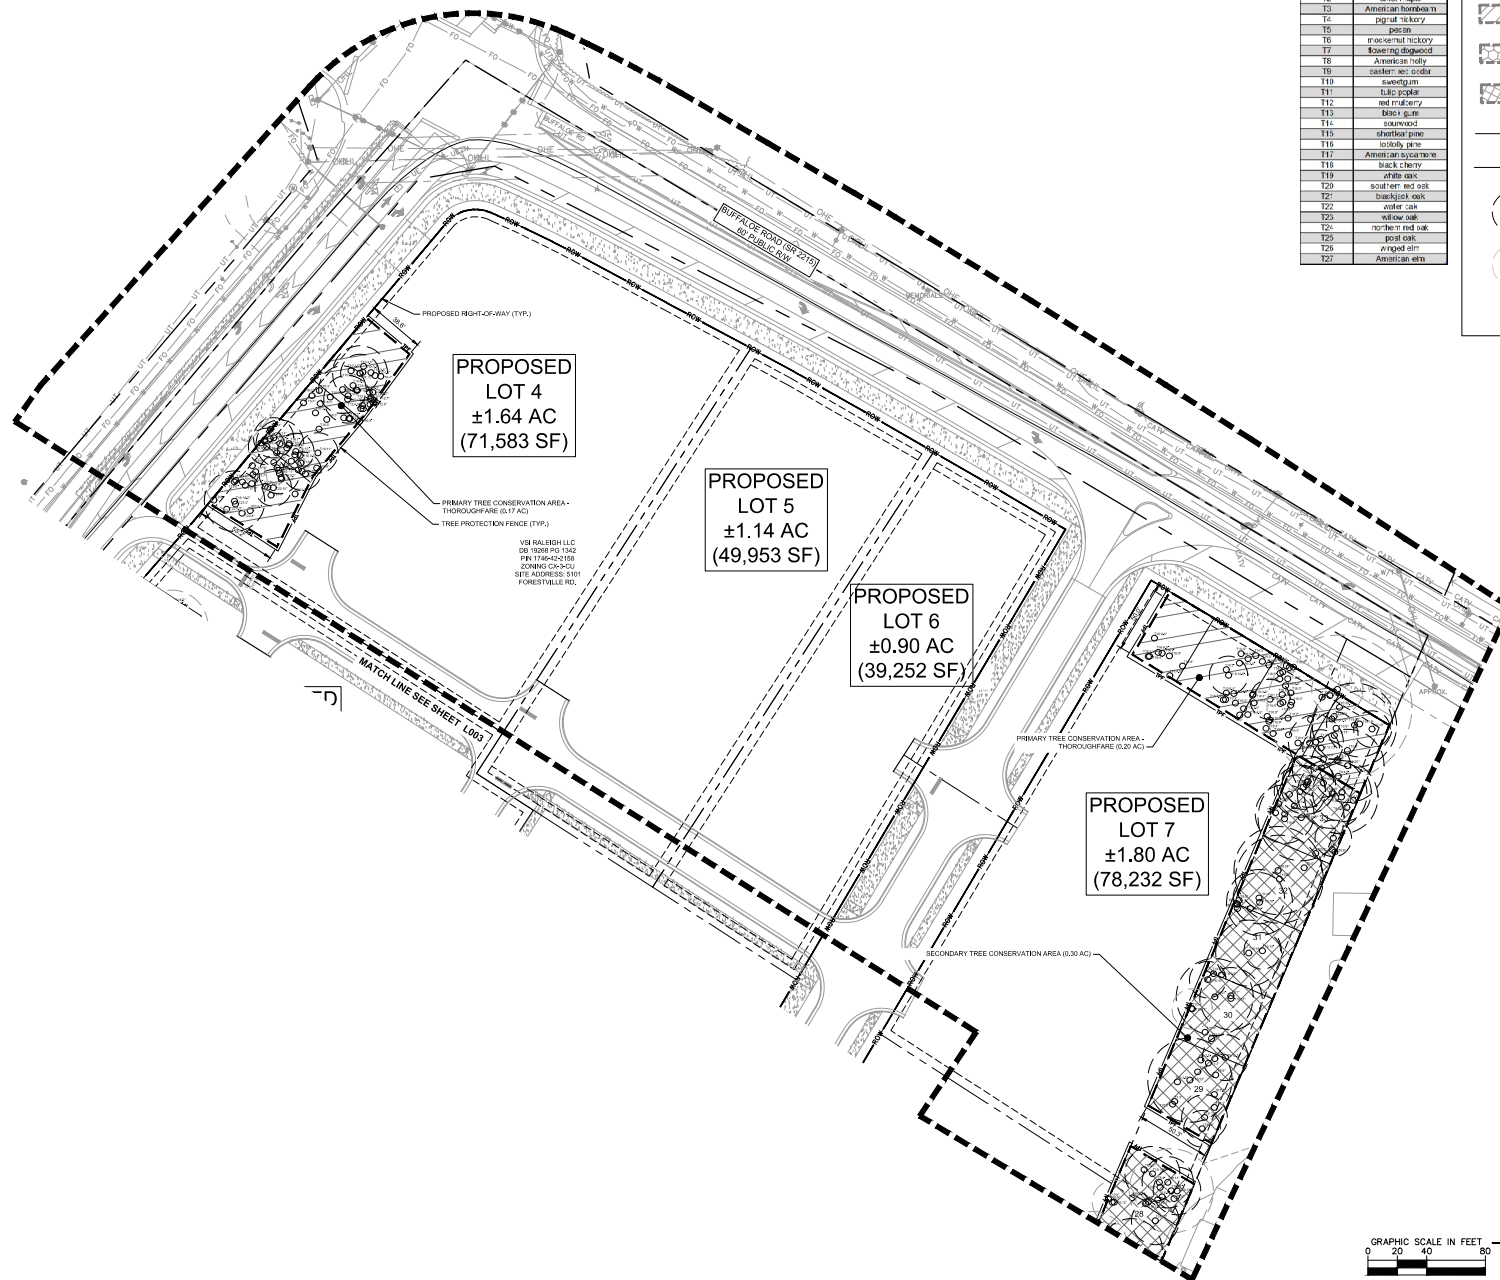




TREESURVEY LEGEND	
Label	Common Name
T1	red maple
T2	silver maple
T3	American hornbeam
T4	pinus strobus
T5	pecan
T6	macrocarpa
T7	flowering dogwood
T8	American holly
T9	banker red cedar
T10	oak
T11	tulip poplar
T12	red mulberry
T13	black gum
T14	sourwood
T15	shortleaf pine
T16	loblooly pine
T17	American sycamore
T18	black cherry
T19	white oak
T20	southern red oak
T21	blackjack oak
T22	oak
T23	yellow oak
T24	northern red oak
T25	post oak
T26	angel
T27	American elm


**LEGEND**


 PRIMARY TREE CONSERVATION AREA - THOROUGHFARE


 PRIMARY TREE CONSERVATION AREA - NEUSE RIVER ZONE 2


 SECONDARY TREE CONSERVATION AREA

 TREE PROTECTION FENCE

 LIMITS OF DISTURBANCE

 CRITICAL ROOT ZONE

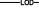 CRITICAL ROOT ZONE EXCLUDED FROM BASAL CALCULATION (>30% DISTURBANCE)

 EXISTING TREE

SHEET NUMBER L004		YARDLY BUFFALO VILLAGE PREPARED FOR YARDLY BY TAYLOR MORRISON RALEIGH BTR / VSI RALEIGH, LLC NC		TREE CONSERVATION PLAN		DATE 02/06/24 SCALE AS SHOWN DESIGNED BY MTH DRAWN BY NAW CHECKED BY NAW		<div>PRELIMINARY NOT FOR CONSTRUCTION</div> <div>Kimley»Horn © 2024 KIMLEY-HORN AND ASSOCIATES, INC. 300 SOUTH MAIN ST. SUITE 402, WEST SPRINGFIELD, IL 62789 WWW.KIMLEY-HORN.COM LIC #0036747-01-00000000</div>		<table><thead><tr><th>NO.</th><th>REVISIONS</th><th>DATE</th><th>BY</th></tr></thead><tbody><tr><td>1</td><td>CITY COMMENTS</td><td>10/06/2024</td><td>SWA</td></tr><tr><td>2</td><td>CITY COMMENTS</td><td>01/08/2024</td><td>SWA</td></tr><tr><td>3</td><td>CITY COMMENTS</td><td>10/20/2023</td><td>SWA</td></tr><tr><td>4</td><td>CITY COMMENTS</td><td>07/26/2022</td><td>JMC</td></tr></tbody></table>		NO.	REVISIONS	DATE	BY	1	CITY COMMENTS	10/06/2024	SWA	2	CITY COMMENTS	01/08/2024	SWA	3	CITY COMMENTS	10/20/2023	SWA	4	CITY COMMENTS	07/26/2022	JMC
NO.	REVISIONS	DATE	BY																												
1	CITY COMMENTS	10/06/2024	SWA																												
2	CITY COMMENTS	01/08/2024	SWA																												
3	CITY COMMENTS	10/20/2023	SWA																												
4	CITY COMMENTS	07/26/2022	JMC																												





20 W



SHEET NUMBER  
L100





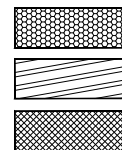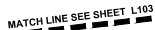




PLANT SCHEDULE L102			
TREES	QTY	BOTANICAL NAME	COMMON NAME
	29	ZELKOVA SERRATA 'GREEN VASE'	GREEN VASE JAPANESE ZELKOVA
SHRUBS	QTY	BOTANICAL NAME	COMMON NAME
	69	ILEX GLABRA	INKBERRY HOLLY

GENERAL NOTES:

1. PLEASE SEE SHEET L105 LANDSCAPE DETAILS FOR FULL PLANT SCHEDULE, INSTALLATION DETAILS, NOTES, AND CALCULATIONS.

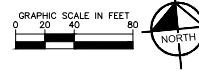

Know what's below.  
Call before you dig.

[illegible]

**Kimley»Horn**  
© 2024 KIMLEY-HORN AND ASSOCIATES, INC.  
300 SOUTH MAIN ST, SUITE 212 HOLLY SPRINGS, NC 27540  
PHONE: 664-275-5559  
[WWW.KIMLEY-HORN.COM](http://WWW.KIMLEY-HORN.COM)

**PRELIMINARY**  
NOT FOR CONSTRUCTION



LANDSCAPE PLANS

**YARDLY BUFFALO  
VILLAGE**  
PREPARED FOR  
YARDLY BY TAYLOR MORRISON  
BTR / VSI RALEIGH, LLC  
EIGH

SHEET NUMBER  
**L102**





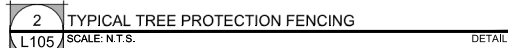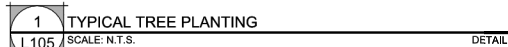

Know what's below  
Call before you dig