

Case File / Name: SUB-0037-2023 DSLC - MAGNOLIA FOREST City of Raleigh
Development Services Department
One Exchange Plaza
Raleigh, NC 27602
(919) 996-2492
currentplanning@raleighnc.gov
www.raleighnc.gov

LOCATION: This 66.17 acre site is a combination of multiple tracts zoned R-4, R-6 CU, and

CM, and is located on the east side of Forestville Road at the intersection of

Forestville Road and Brinley Manor Drive. The site is outside the city limits.

REQUEST: This is a subdivision utilizing the conservation development option with 154

detached home lots and 13 HOA, community, and open space lots for a total of

167 proposed lots. There are three phases for development in this plan.

DESIGN

ADJUSTMENT(S)/

ALTERNATES, ETC: N/A

FINDINGS: City Administration finds that this request, with the below conditions of

approval being met, conforms to the Unified Development Ordinance. This approval is based on a preliminary plan dated June 18, 2024 by Timmons

Group.

CONDITIONS OF APPROVAL and NEXT STEPS:

This document must be applied to the second sheet of all future submittals except for final plats. This is a preliminary plan and as such no permits have been issued with this approval. To obtain permits and/or completion of the project, the following steps are required:

☑ <u>SITE PERMITTING REVIEW</u> - For land disturbance of 12,000 square feet or greater, public or private infrastructure, shared stormwater devices, etc. Site Permitting Review may be submitted upon receipt of this signed approval document.

The following items are required prior to approval of Site Permitting Review plans:

General

 Regarding the Conservation subdivision perimeter buffer yards (fence and landscaping) - the fence/wall should run along the edge of the site with the required landscaping between the fence/wall and the proposed residential lots. - Please revise the location of the buffer yard fence/wall around the perimeter showing the fence/wall along the site border with required landscaping between the wall and the proposed residential lots.

Engineering

- 2. Required NCDOT encroachment and/or driveway permits must be approved and copies provided to the City of Raleigh Transportation Department Mobility Strategy and Infrastructure Division prior to Site Permit review approval.
- 3. A public infrastructure surety (SUR-0481-2023) shall be provided to City of Raleigh Transportation Development Engineering Division (UDO 8.1.3) in the amount of 100% of the improvement cost for the NCDOT portion and 125% of the improvement cost for the City of Raleigh infrastructure.

Public Utilities

4. A Downstream Sewer Capacity Study in compliance with the City of Raleigh Public Utilities Department Handbook shall be submitted by the Project Engineer for review and approval.



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Stormwater

- 5. The State of North Carolina shall approve any proposed disturbance within the riparian buffer prior to the issuance of any grading or site permit (UDO 9.2.3.E).
- If required, a nitrogen offset payment must be made to a qualifying mitigation bank (UDO 9.2.2.B).
- 7. A surety equal to of the cost of clearing, grubbing and reseeding a site, shall be paid to the City (UDO 9.4.4).
- 8. A stormwater control plan with a stormwater operations and maintenance manual and budget shall be approved (UDO 9.2).
- 9. A 100-year floodplain analysis shall be submitted and approved by the Engineering Services Department prior to the issuance of any grading or site permit (UDO 9.3).

Transportation

10. 401/404 Permits Required at SPR Review

Urban Forestry

- 11. Submit a final tree conservation plan that includes metes and bounds descriptions of all tree conservation areas and tree protection fencing as required (UDO 9.1.5).
- 12. Tree protection fence must be inspected by Urban Forestry staff prior to the issuance of a grading permit.

☑ **LEGAL DOCUMENTS** - Email to legaldocumentreview@raleighnc.gov. Legal documents must be approved, executed, and recorded prior to or in conjunction with the recorded plat on which the associated easements are shown. Copies of recorded documents must be returned to the City within one business day of recording to avoid withholding of further permit issuance.

V	Right of Way Deed of Easement Required
V	Slope Easement Deed of Easement Required

V	Utility Placement Deed of Easement Required
Ø	Stormwater Maintenance Covenant Required

☑ **RECORDED MAP(S)** - Submit plat to record new property lines, easements, tree conservation areas, etc.). Plats may be submitted for review when the Site Permitting Review plans, if required, have been deemed ready for mylar signature.

The following items must be approved prior to recording the plat:

General

1. Provide documentation indicating a Property Owner's Association has been established for the subject development.



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- 2. Comply with conditions of Z-14-14, specifically Z-14-14, #3.
- 3. The greenway easement as shown on the preliminary plan shall be dedicated prior to, or in conjunction with the recording of a map in any phase affected by the greenway.
- A demolition permit shall be issued for the structures on site and this building permit number shown on all maps for recording.

Engineering

- 5. A fee-in-lieu for any streets or sidewalks that cannot be fully constructed to the project boundaries as determined at SPR review is paid to the City of Raleigh (UDO 8.1.10).
- 6. A 5' utility placement easement deed of easement, in addition to a plat showing the location of the easement, shall be submitted to the Planning and Development Services Department for review, and if acceptable, approved for recordation. Approved plats must be recorded at the Wake County Register of Deeds Office on or before the 14th day following approval by the City. The 14-day expiration date shall be clearly indicated on the plat. By the end of the next business day following recordation of the plat, all required legal instruments (including deeds of easement) shall be recorded, and recorded copies of the plat and all legal instruments required by the City in association with development approval shall be provided to the City. (Reference: UDO 8.1.7.A; 10.2.5.F.4.d)
- 7. A slope easement deed of easement, in addition to a plat showing the location of the easement, shall be submitted to the Planning and Development Services Department for review, and if acceptable, approved for recordation. Approved plats must be recorded at the Wake County Register of Deeds Office on or before the 14th day following approval by the City. The 14-day expiration date shall be clearly indicated on the plat. By the end of the next business day following recordation of the plat, all required legal instruments (including deeds of easement) shall be recorded, and recorded copies of the plat and all legal instruments required by the City in association with development approval shall be provided to the City. (Reference: UDO 8.1.7.A; 10.2.5.F.4.d)
- 8. A sight distance easement shall be approved by the Transportation Department for recording in the Wake County Registry and shown on a plat approved for recordation.
- 9. A public street right-of-way deed of easement, in addition to a plat showing the location of the easement, shall be submitted to the Planning and Development Services Department for review, and if acceptable, approved for recordation. Approved plats must be recorded at the Wake County Register of Deeds Office on or before the 14th day following approval by the City. The 14-day expiration date shall be clearly indicated on the plat. By the end of the next business day following recordation of the plat, all required legal instruments (including deeds of easement) shall be recorded, and recorded copies of the plat and all legal instruments required by the City in association with development approval shall be provided to the City. (Reference: UDO 8.1.7.A; 10.2.5.F.4.d)
- 10. A fee-in-lieu for curb and gutter not installed with the alternate cross section is paid to the City of Raleigh (UDO 8.1.10).



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Public Utilities

- 11. A fee-in-lieu of construction shall be paid to the City of Raleigh Public Utilities Department for the construction of a water and/or sewer main.
- 12. Infrastructure Construction Plans (concurrent submittal) must be approved by the City of Raleigh Public Utilities Department for all public water, public sewer and/or private sewer extensions.
- 13. A Petition for Annexation into the City limits shall be submitted in accordance with City Council policy for extension of utility service to properties currently outside of the City limits. This voluntary annexation in no way obligates the City to extend utility services to the property.

Stormwater

- 14. The riparian buffers, in accordance with the preliminary plan and the State of North Carolina regulations, shall be shown on plats for recording along with required buffer statement (Recorded Map Checklist).
- 15. A surety equal to 125% of the cost of the construction of a stormwater device shall be paid to the Engineering Services Department (UDO 9.2.2.D.1.d).
- 16. The flood prone areas, as approved by the City Stormwater Engineer and shown on the preliminary plan, shall be shown on the recorded map (UDO 9.3.3.G).
- 17. If demolition causes a land disturbance of more than 12,000 sf, a mass grading permit will be required. (UDO 9.4.6)
- 18. The maximum allocated impervious area for all applicable lots in the subdivision should be identified on all maps for recording.
- 19. All stormwater control measures and means of transporting stormwater runoff to and from any nitrogen and stormwater runoff control measures shall be shown on all plats for recording as private drainage easements (UDO 9.2).
- 20. The City form document entitled Declaration of Maintenance Covenant and Grant of Protection Easement for Stormwater Control Facilities shall be approved by the City and recorded with the county register of deeds office (UDO 9.2.2.G).

Urban Forestry

- 21. A public infrastructure surety for 93 street trees shall be provided to City of Raleigh Transportation Development Engineering Division (UDO 8.1.3) in the amount of 100% of the improvement cost for the NCDOT portion. A public infrastructure surety for 321 street trees shall be provided to City of Raleigh Transportation Development Engineering Division (UDO 8.1.3) in the amount of 125% of the improvement cost for the City of Raleigh infrastructure.
- 22. A tree conservation plat shall be recorded with metes and bounds showing the designated tree conservation areas (UDO 9.1). This development proposes 12.20 acres of tree conservation area.



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☑ <u>BUILDING PERMITS</u> - For buildings and structures shown on the approved plans. Commercial building permit plans must include the signed, approved Site Permitting Review plans attached, if applicable. Permit sets may be reviewed prior to the recordation of required plats, but cannot be approved.

The following items must be approved prior to the issuance of building permits:

Public Utilities

1. A plat must be recorded at the Wake County Register of Deeds office for all utility easement dedications.

Stormwater

- 2. All stormwater control measures and means of transporting stormwater runoff to and from any nitrogen and stormwater runoff control measures shall be shown on all plats for recording as private drainage easements (UDO 9.2).
- 3. If total land disturbance will be over 12,000 sq. ft. for multiple houses, a separate site plan submittal & approval will be required. Site plans require an erosion control plan. (UDO 9.4.6.)
- 4. Impervious restrictions for each lot must be recorded on a plat prior to building permit issuance.

Urban Forestry

5. A tree impact permit must be obtained for the approved streetscape tree installation in the right of way. This development proposes 51 street trees along Thornrose Hill Dr, 21 street trees along Ripon Dr, 46 street trees along Turlock Trail, 49 street trees along McHenry Dr, 46 street trees along Newman Dr, 30 street trees along Maplemoor Way, 30 street trees along Countystone Way, 8 street trees along Brinley Manor Dr, 30 street trees along Endicot Way, 93 street trees along Forestville Rd, and 10 street trees along Countryvale Lane.

The following are required prior to issuance of building occupancy permit:

General

- All Water, Sanitary Sewer and Reuse facilities shall be installed, inspected, tested and accepted by the City of Raleigh Public Utilities Department for operations and maintenance.
- 2. Final inspection of all tree conservation areas and right of way street trees by Urban Forestry Staff

Stormwater

- 3. As-built impervious survey is accepted by the Engineering Services Department (UDO 9.2).
- 4. As-built drawings and associated forms for all Stormwater devices are accepted by the Engineering Services Department (UDO 9.2.2.D.3).



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EXPIRATION DATES: If significant construction has not taken place on a project after preliminary subdivision approval, that approval may "sunset" and be declared void, requiring re-approval before permits may be issued. To avoid allowing this preliminary approval to "sunset", the following must take place by the following dates:

3-Year Sunset Date: August 6, 2027

Record at least ½ of the land area approved.

5-Year Sunset Date: August 6, 2029

Record entire subdivision.

I hereby c	ertify this administrative decision.		
Signed: .	puto lato	Date:	08/06/2024
	Development Se vices Dir/Designee	_	

Staff Coordinator: Michael Walters

B Imperious Area on Parcel(s): Imperious Area for Compliance (includes right-of-way): Existing (sf) 24,644 Proposed total (sf) 546,443 Existing (sf) 0 Proposed total (sf) 963,429 # of Detached House Lots: 154 # of Affached House Lots: # of Townhouse Lots: # of Timy House Lots: # of Timy House Lots: # of Object Lots: # of Object Lots (Apartment, General, Mixed Use, Civic): NUMBER OF LOTS AND DENSITY Total # of Lots: 167 Total # Dwelling Units: 154 Proposed density for each zoning district (UDO 1.5.2.F): R-4: 1.43 DU/A & R-6-CU: 3.14 DU/A

SIGNATURE BLOCK

Pursuant to state law (N.C. Gen. Stat. § 1600-403(e)), applications for development approvals may be made by the landowner, a lessee or person holding an option or contract to purchase or lesse land, or an authorized agent of the landowner. An easement holder may also apply for development approval for such development as is authorized by the substitution of the landowner. An easement holder may also apply for development approval for such development as is authorized by the substitution of the landowner. An easement holder may be apply for development approval for such development as is authorized by the landowner.


regulations in effect at the time permit processing is resumed shall appl	ly to the new application.
Signature: 4. July	Date: 07/12/2023
Printed Name: R. Scott Johnson, Sr. Director of Development	t - kb Home
Signature:	Date:
Part and a second	

Page 2 of 2

MAJOR SUBDIVISION PRELIMINARY PLAN

MAGNOLIA FOREST SUBDIVISION

RALEIGH, WAKE COUNTY, NORTH CAROLINA PIN(S): 1745-39-6863, 1745-39-6763, 1745-38-8601 1745-49-5347, 1745-48-3769

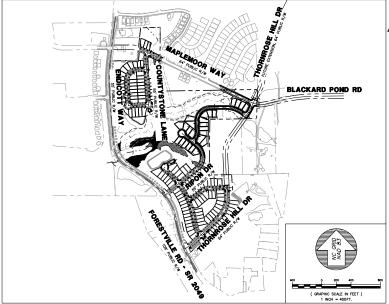

SKETCH PLAN CASE, SCOPE-0155-2021 SUBMITTAL DATE: SEPTEMBER 19, 2023 CASE NUMBER: SUB-0037-2023

SITE DATA TABLE

PROJECT NAME:	MAGNOLIA FOREST SUBDIVISION		
PROPERTY ADDRESS(ES):	5317 FORESTVILLE ROAD, RALEIGH, NC 27604 5323 FORESTVILLE ROAD, RALEIGH, NC 27604 5401 FORESTVILLE ROAD, RALEIGH, NC 27604 5417 FORESTVILLE ROAD, RALEIGH, NC 27604 5425 FORESTVILLE ROAD, RALEIGH, NC 27604		
PROPERTY PIN NUMBERS:	1745-39-6863, 1745-39-6763, 1745-38-8601, 1745-49-5347, 1745-48-3769		
PROPOSED ZONING:	R-4, R-6-CU, CM		
TOWNSHIP	ST. MATTHEW'S		
PROPOSED USE:	RESIDENTIAL		
TOTAL TRACT AREA:	66.17 ACRES		

LANDSCAPE ARCHITECTURE:



SITE PLANNING / CIVIL ENGINEERING

■ Ballentine Associates, PA

L-11



DRAWING LIST

		DRAWING LIST		17:
	SHEET	DRAWING TITLE	LATEST ISSUE I	
١. ١	(G0001	COVER SHEET	18 JUN	24
A,	G0002	ZONING CONDITIONS AND GENERAL NOTES	18 JUN	24
	C0100	EXISTING CONDITIONS & DEMOLITION PLAN OVERVIEW	18 JUN	24
	C0101	EXISTING CONDITIONS & DEMOLITION PLAN ENLARGEMENT =1	18 JUN	24
	C0102	EXISTING CONDITIONS & DEMOLITION PLAN ENLARGEMENT *2	18 JUN	24
	C0103	EXISTING CONDITIONS & DEMOLITION PLAN ENLARGEMENT =3	18 JUN	
	C1000	SITE PLAN OVERVIEW	18 JUN	
	C1001	SITE PLAN ENLARGEMENT *1	18 JUN	
	C1002	SITE PLAN ENLARGEMENT *2	18 JUN	
	C1003	SITE PLAN ENLARGEMENT *3	18 JUN	
	C1004	OPEN SPACE PLAN	18 JUN	
	C1005	TREE CONSERVATION AREA PLAN	18 JUN	
	C1006	BLOCK PERIMETER PLAN	18 JUN	24
	C1007	EASEMENT PLAN	18 JUN	
	}C1008	ZONING AND PHASING PLAN	18 JUN	
	C1009	SIGHT DISTANCE TRIANGLE PLAN	18 JUN	
	}C1100	UTILITY PLAN OVERVIEW	18 JUN	24
	C1101	UTILITY PLAN ENLARGEMENT *1	18 JUN	24
	C1102	UTILITY PLAN ENLARGEMENT *2	18 JUN	24
	C1103	UTILITY PLAN ENLARGEMENT *3	18 JUN	
	C1200	GRADING & DRAINAGE PLAN OVERVIEW	18 JUN	24
	C1201	GRADING PLAN ENLARGEMENT *1	18 JUN	
	C1202	GRADING PLAN ENLARGEMENT *2	18 JUN	24
	C1203	GRADING PLAN ENLARGEMENT *3	18 JUN	24
	C1204	RETAINING WALL ENLARGEMENT #1	18 JUN	24
'	C1205	RETAINING WALL ENLARGEMENT *2	18 JUN	
	C1206	RETAINING WALL ENLARGEMENT *3	18 JUN	24
	C3101	FORESTVILLE RD EXISTING CONDITIONS, STRIPING, AND IMPROVEMENTS PLAN & PROFILE	18 JUN	24
	C3102	FORESTVILLE RD EXISTING CONDITIONS, STRIPING, AND IMPROVEMENTS PLAN & PROFILE FORESTVILLE RD EXISTING CONDITIONS. STRIPING.	18 JUN	24
	C3103	AND IMPROVEMENTS PLAN & PROFILE	18 JUN	
	C3201	TYPICAL SECTIONS DETAILED ROAD SECTIONS	18 JUN 18 JUN	
	C3301	DETAILED ROAD SECTIONS	18 JUN	
	C3302	DETAILED ROAD SECTIONS	18 JUN	
	C3304	DETAILED ROAD SECTIONS	18 JUN	
	C3305	DETAILED ROAD SECTIONS	18 JUN	
	C4201	SCM ENLARGEMENT •1	18 JUN	
	C4201	SCM ENLARGEMENT =1	18 JUN	
	L-1	OVERALL LANDSCAPE PLAN	19 APR	حنت
	L-2	DETAILED LANDSCAPE PLAN +1	19 APR	
	L-3	DETAILED LANDSCAPE PLAN •2	19 APR	24
	L-4	DETAILED LANDSCAPE PLAN +3	19 APR	24
	L-5	LANDSCAPE DETAILS	19 APR	24
	L-6	LANDSCAPE DETAILS	19 APR	24
	L-7	LANDSCAPE BUFFER SCHEDULE	19 APR	24
	L-8	LANDSCAPE BUFFER SCHEDULE	19 APR	24
	L-9	LANDSCAPE BUFFER SCHEDULE	19 APR	24
	L-10	LANDSCAPE BUFFER SCHEDULE	19 APR	24
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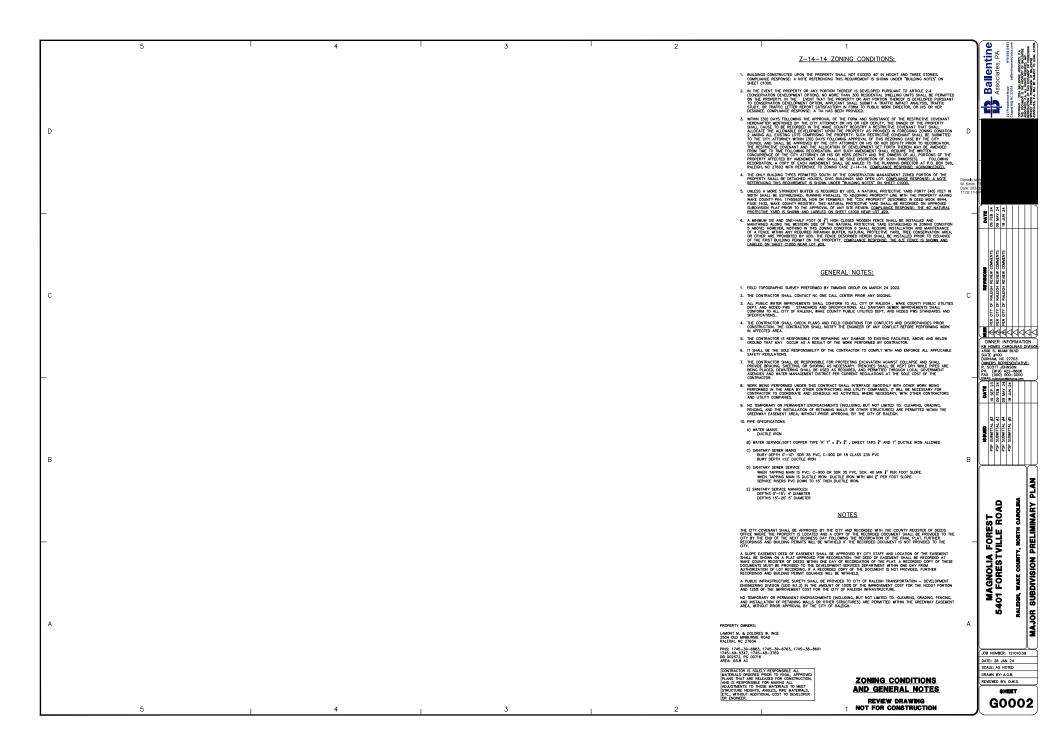
LANDSCAPE BUFFER SCHEDULE


22-0144A DUKE ENERGY SITE LIGHTING PLAN REVIEW DRAWING 06 APR 22 NOT FOR CONSTRUCTION


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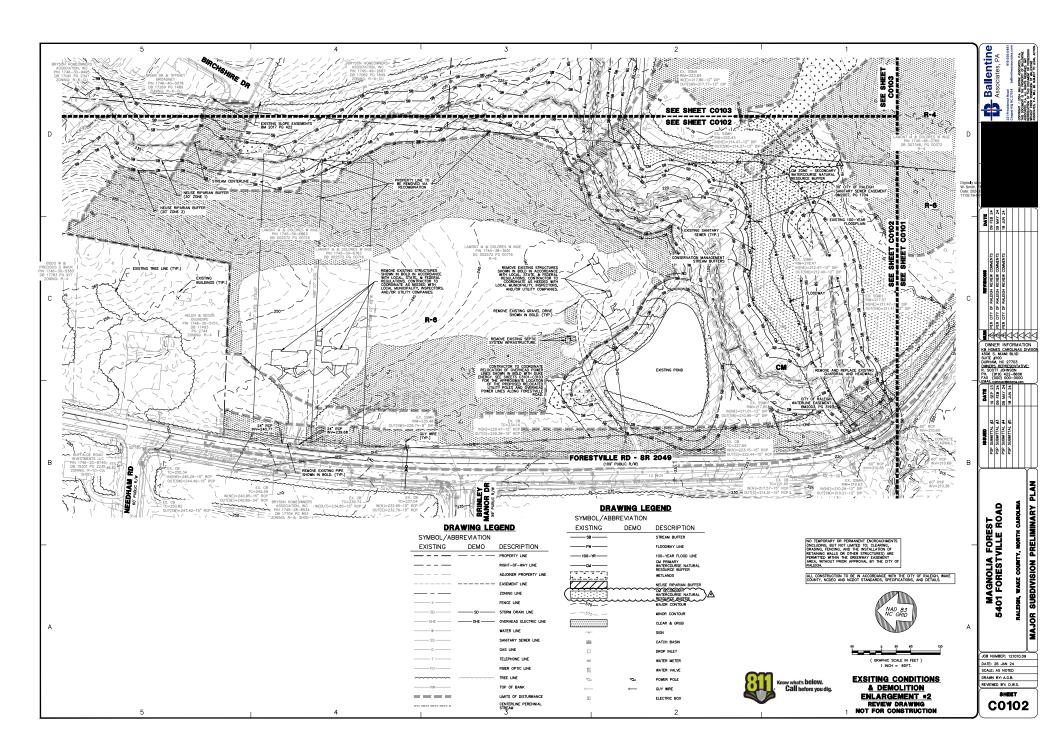
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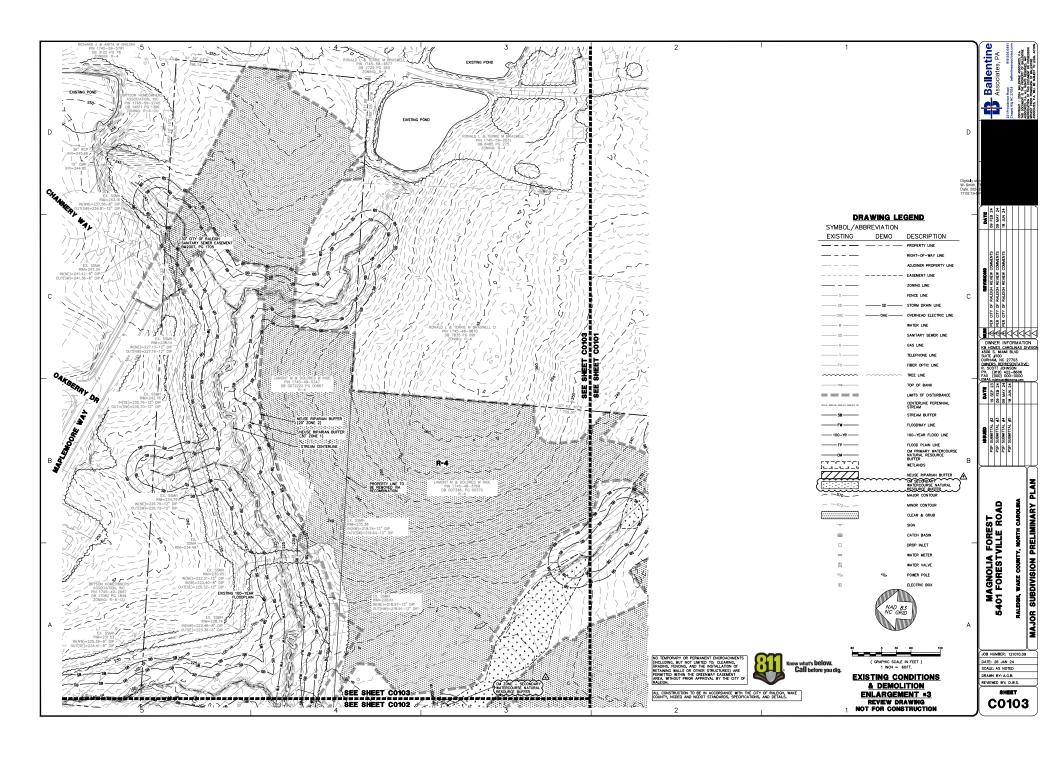
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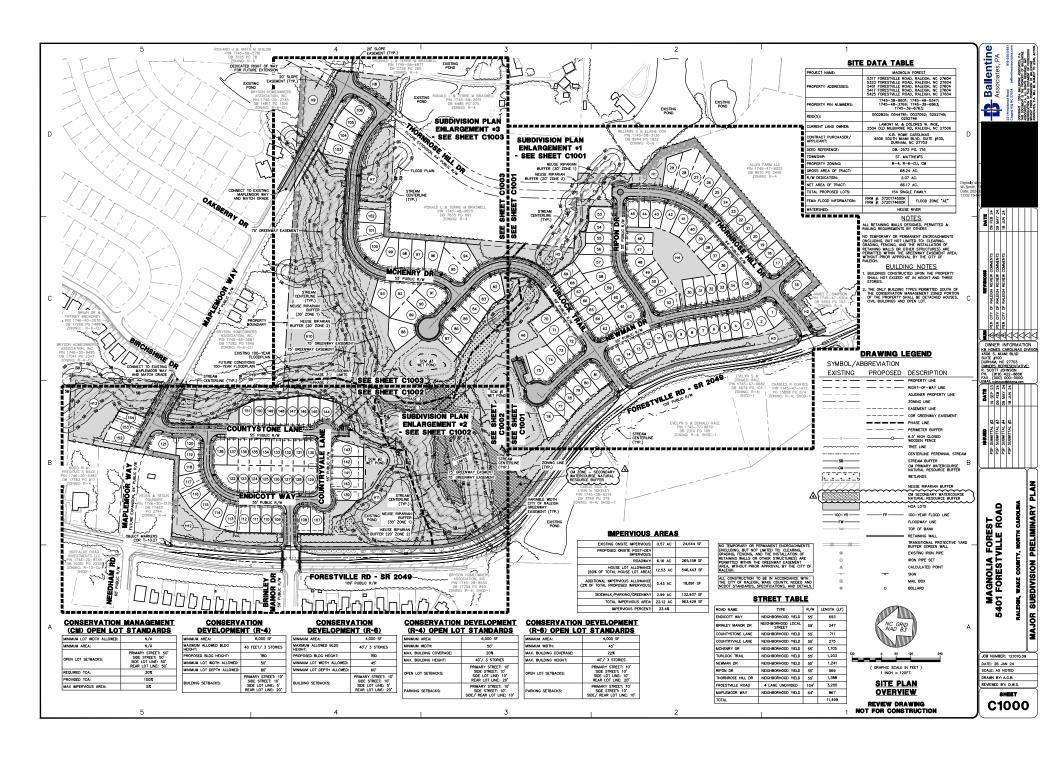











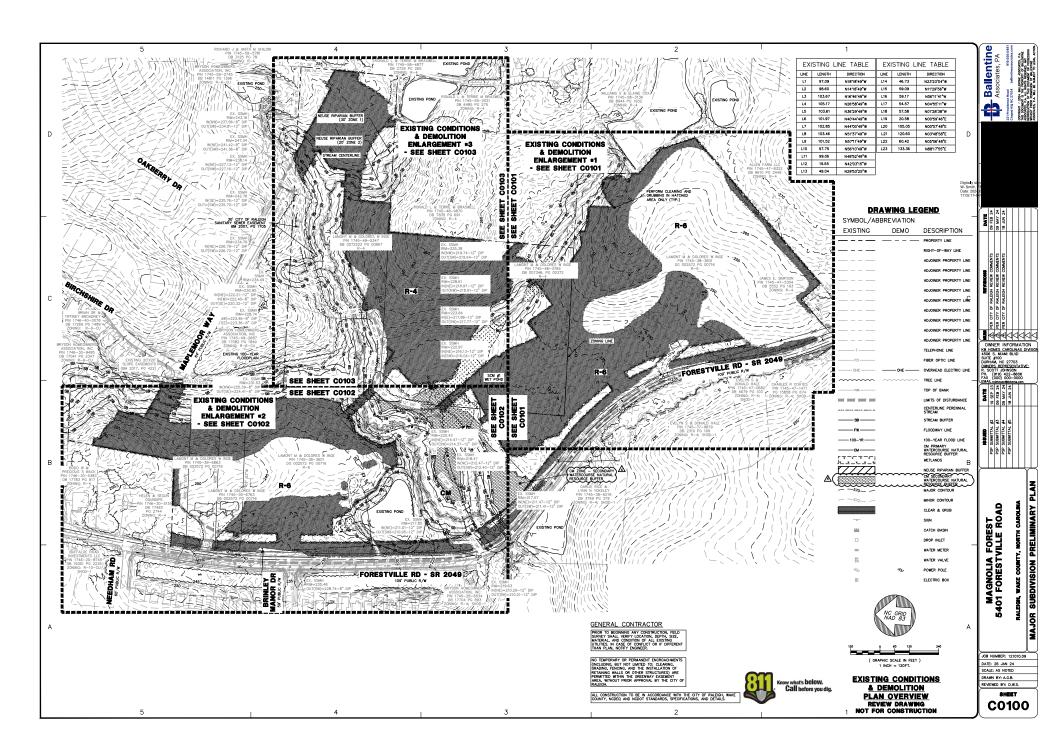


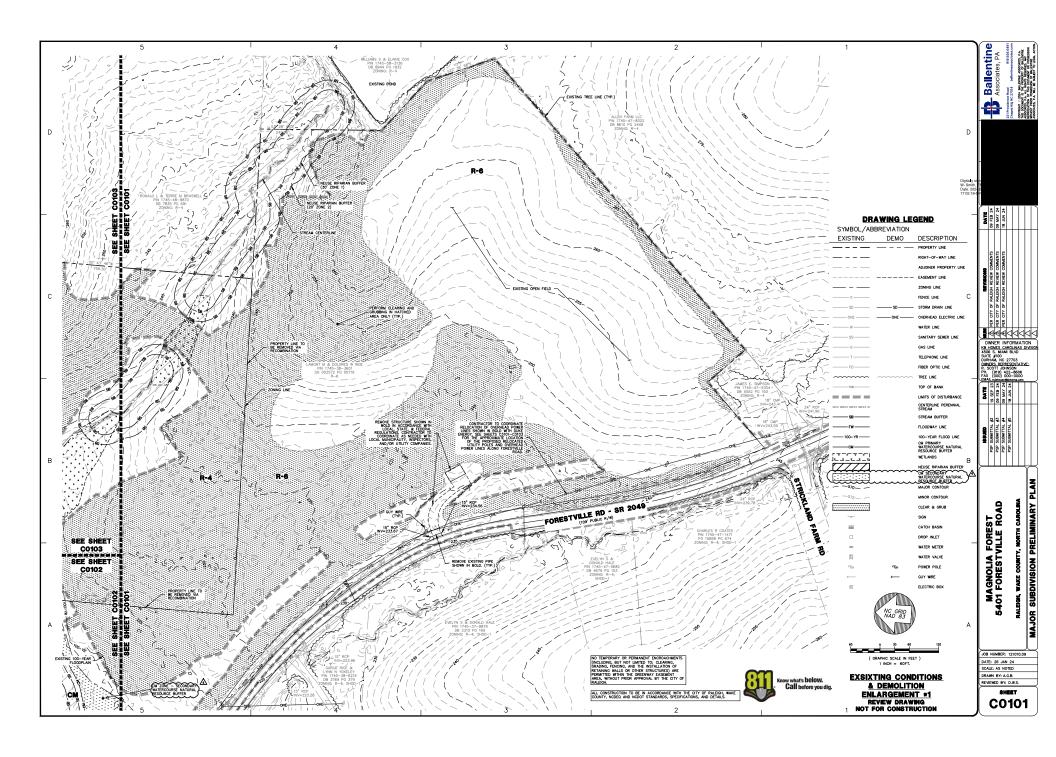


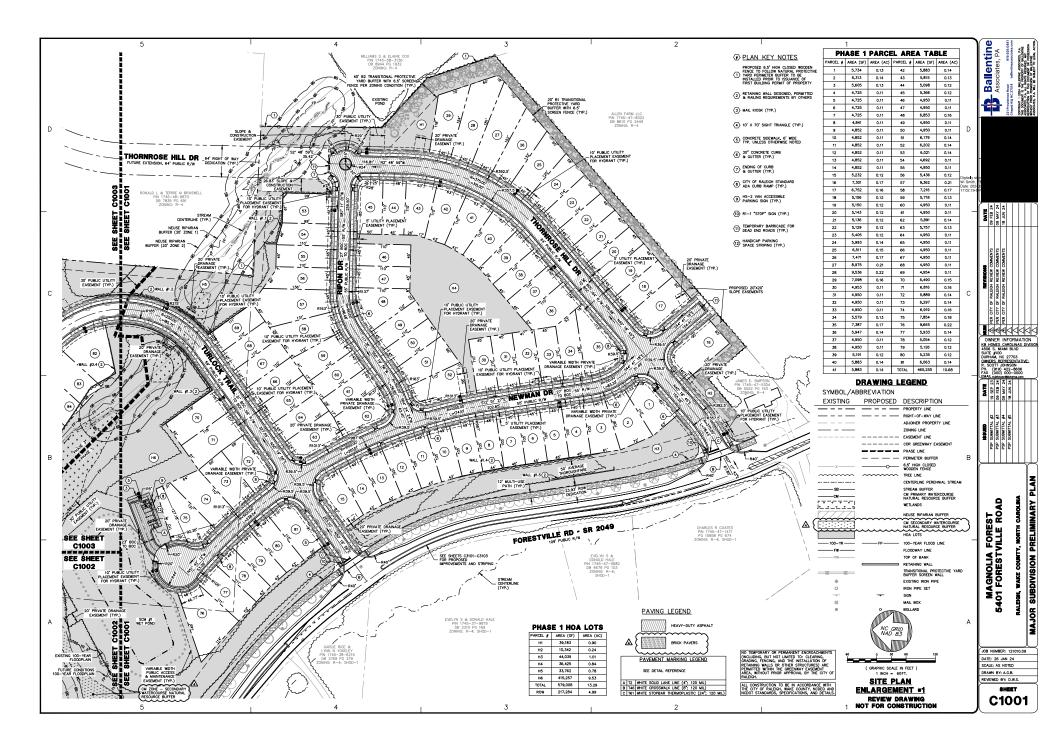


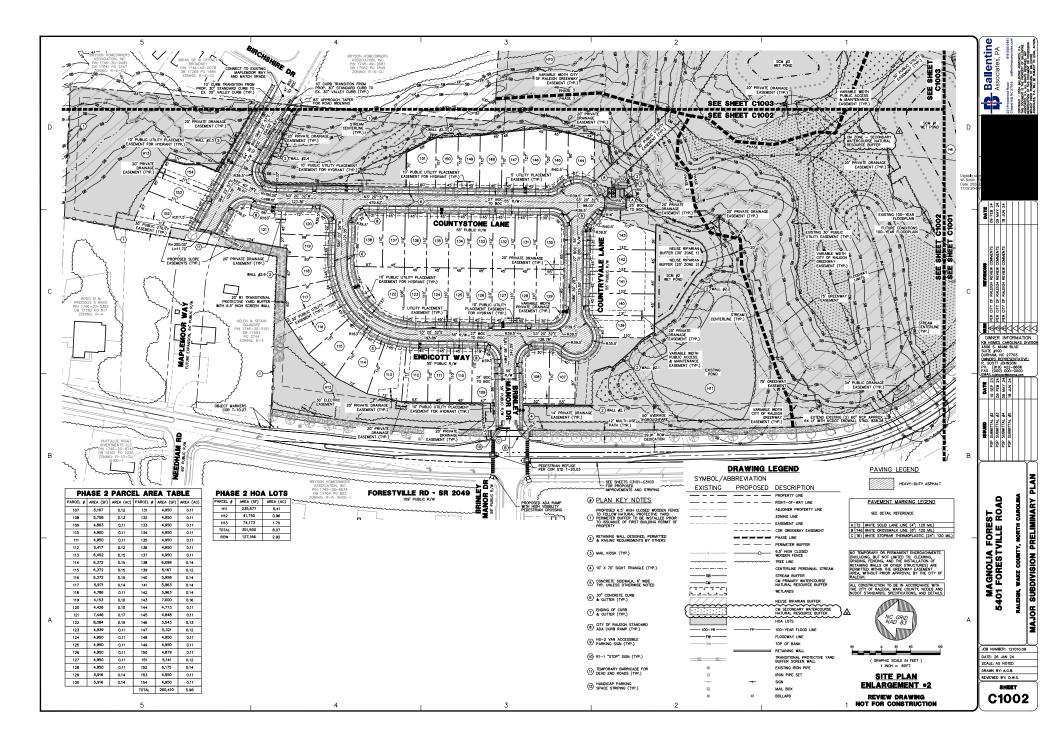


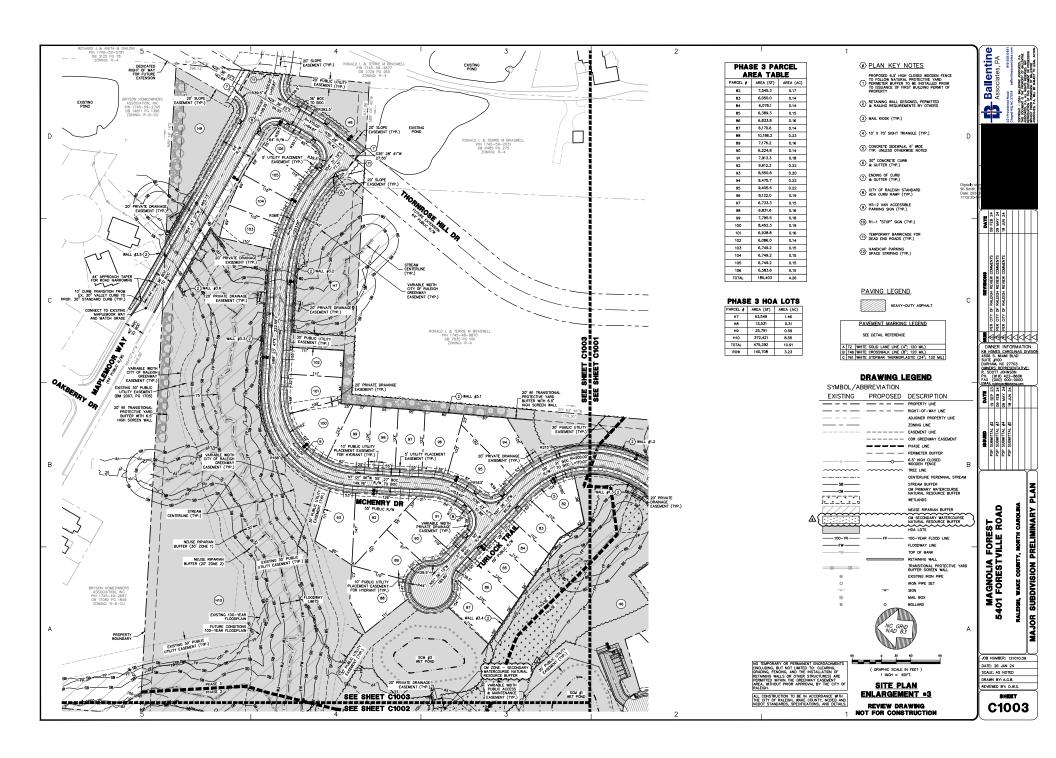


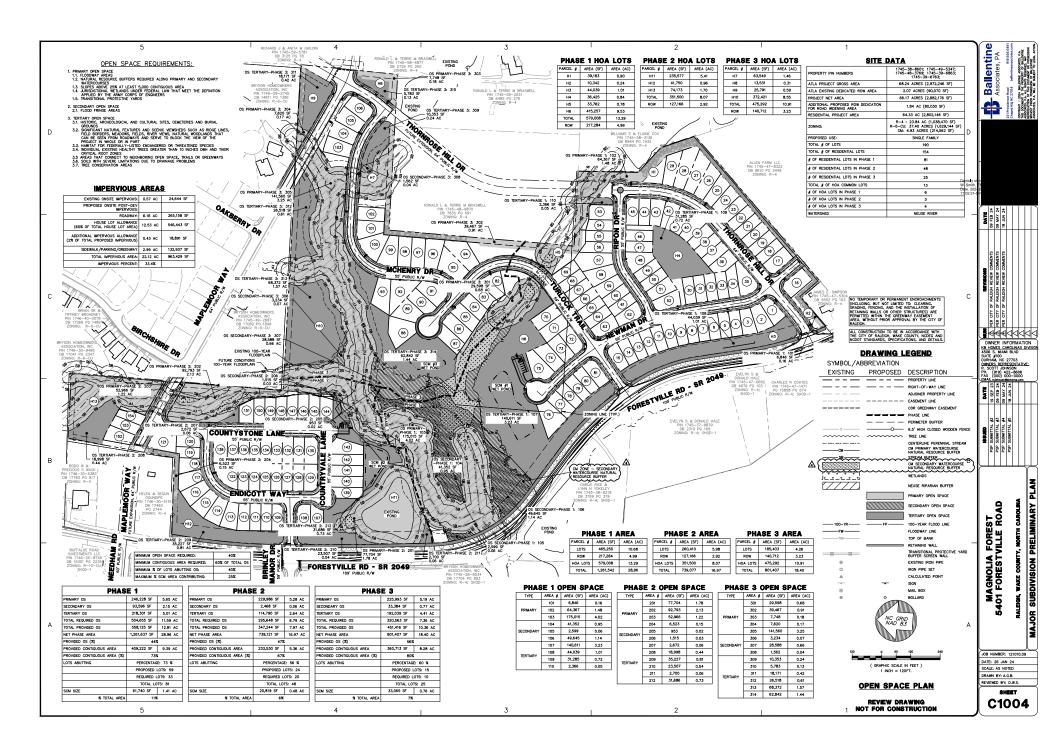


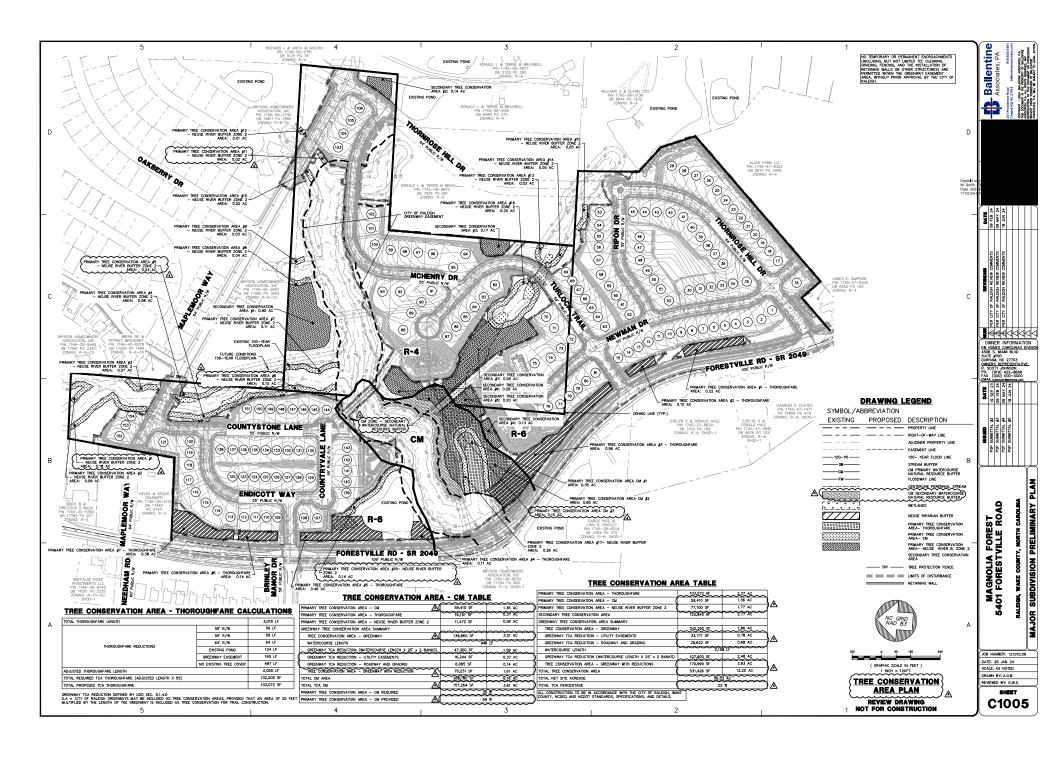


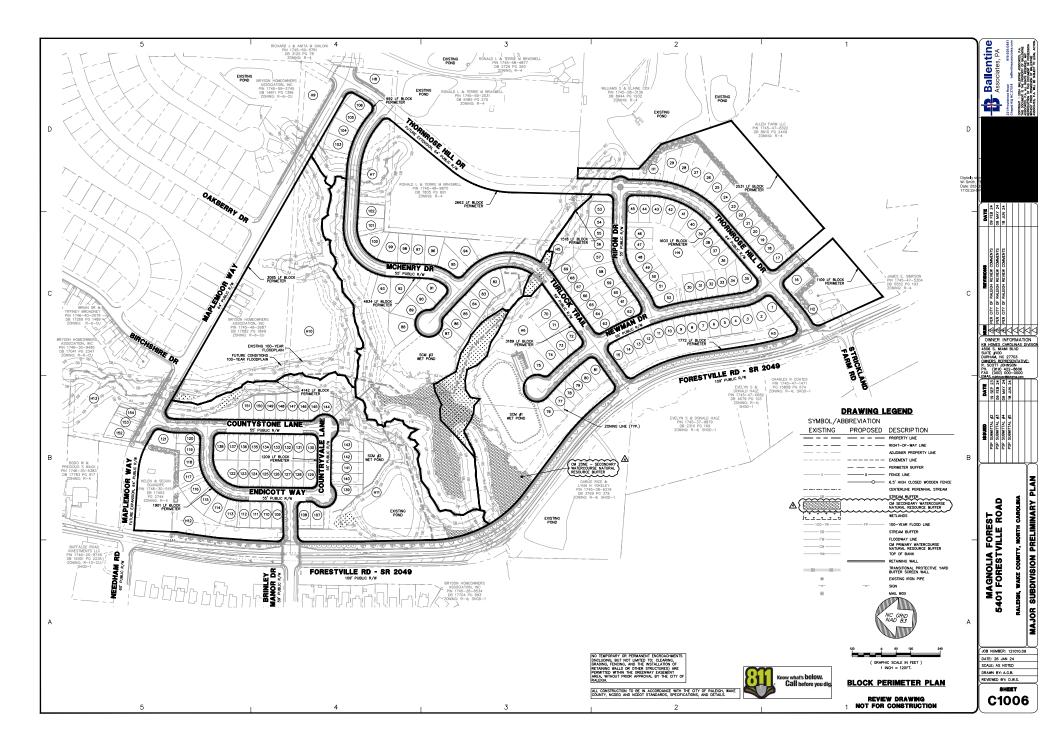


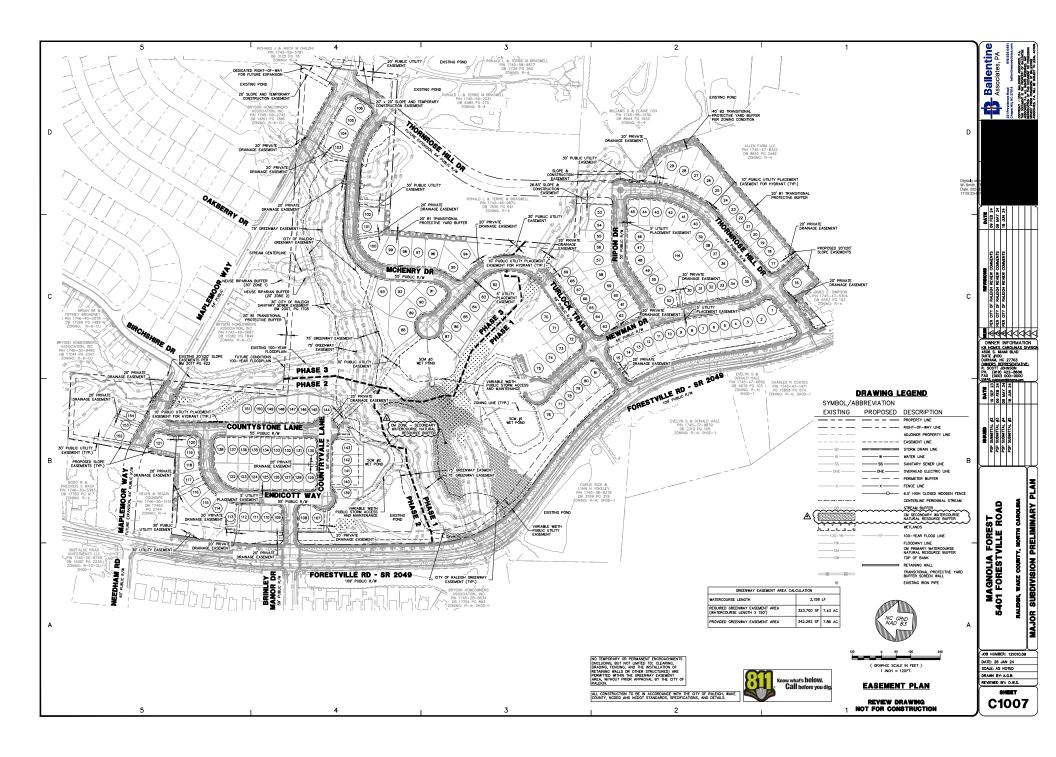


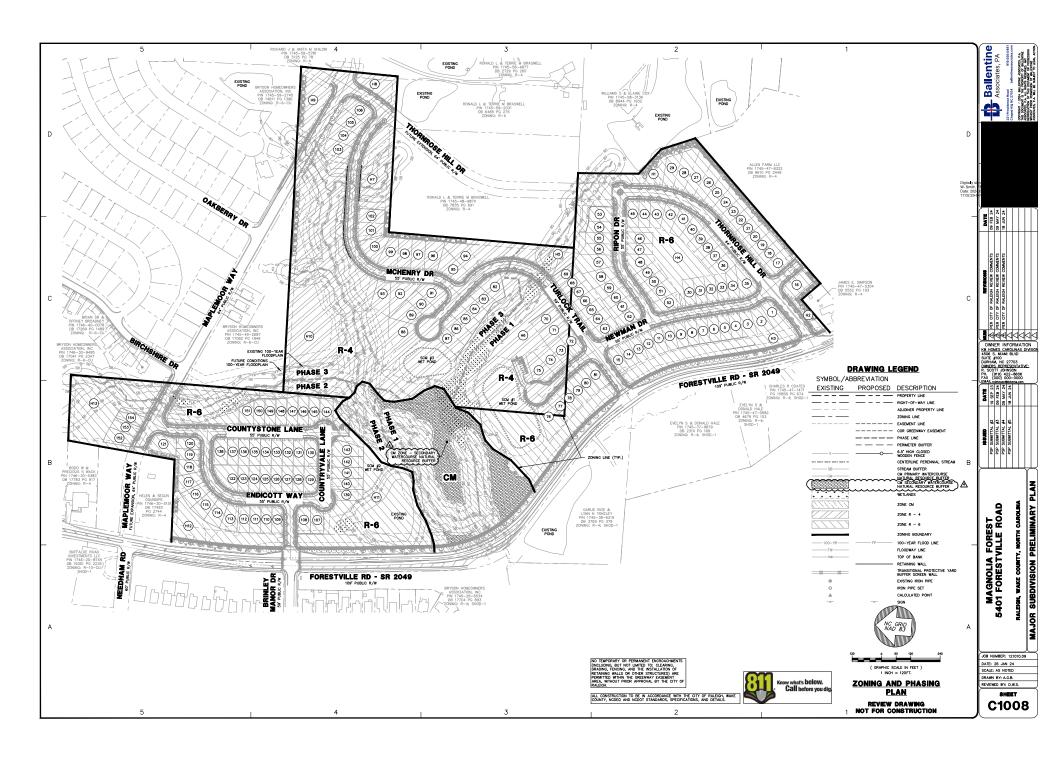


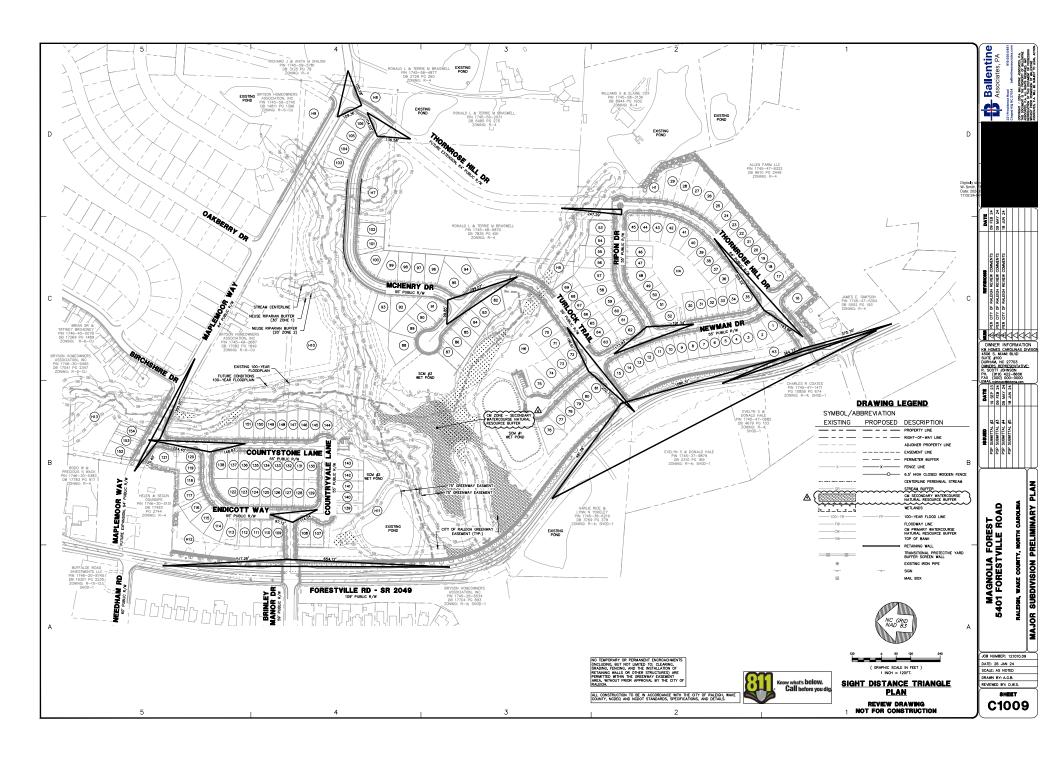


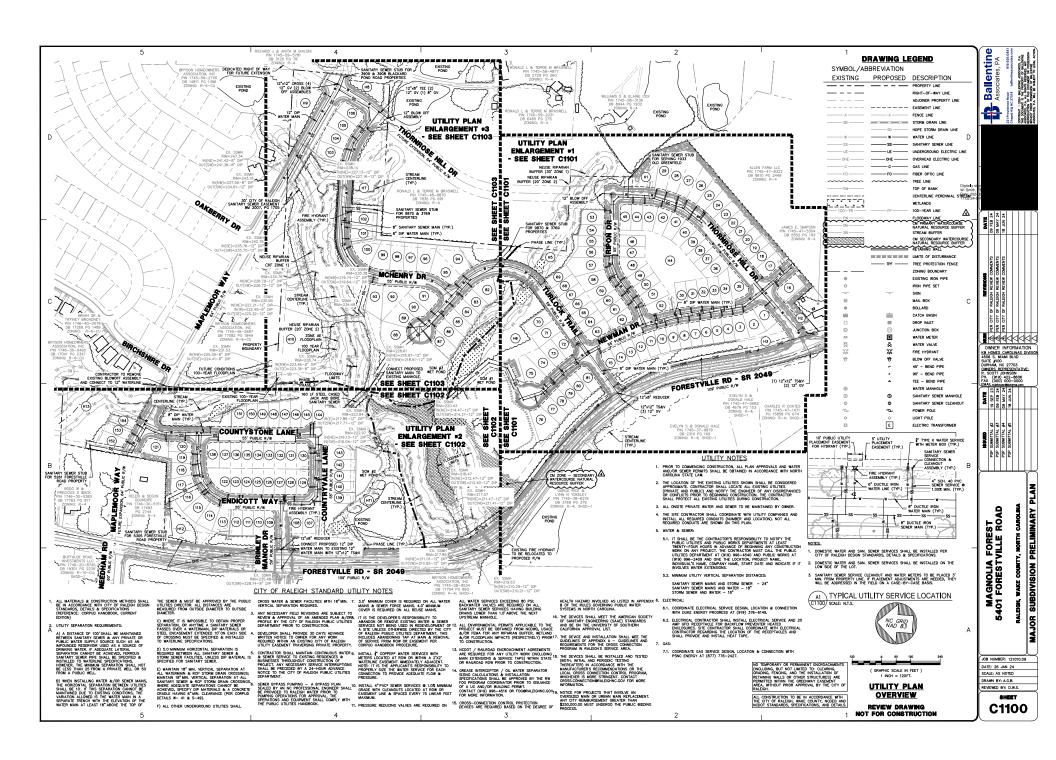


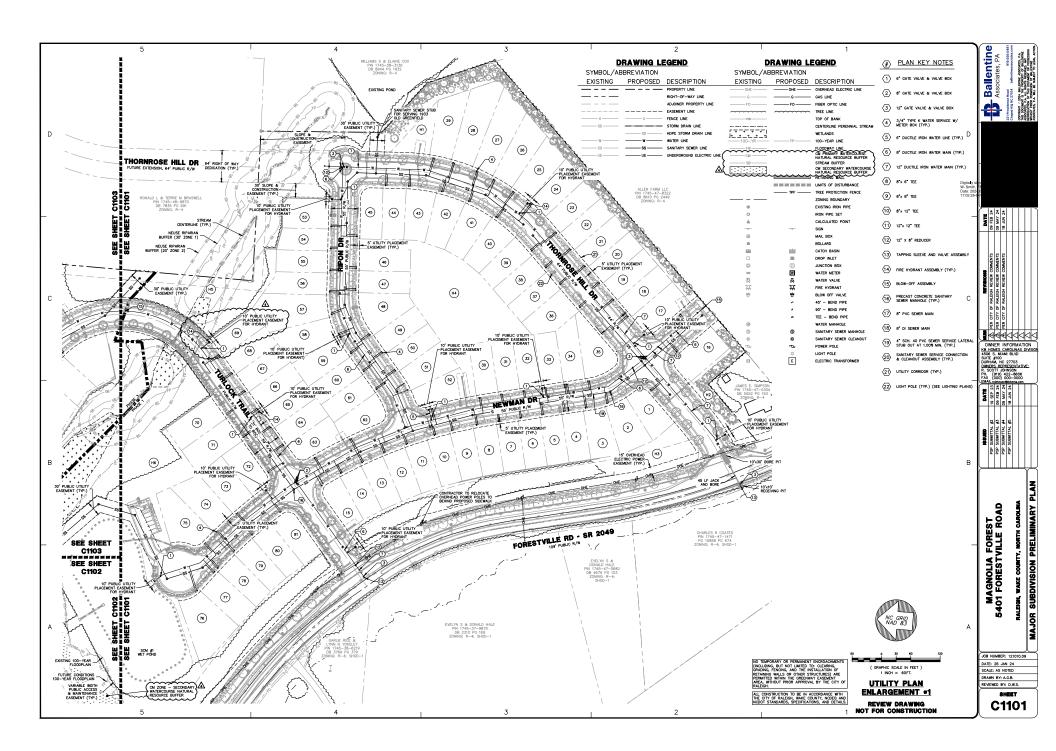


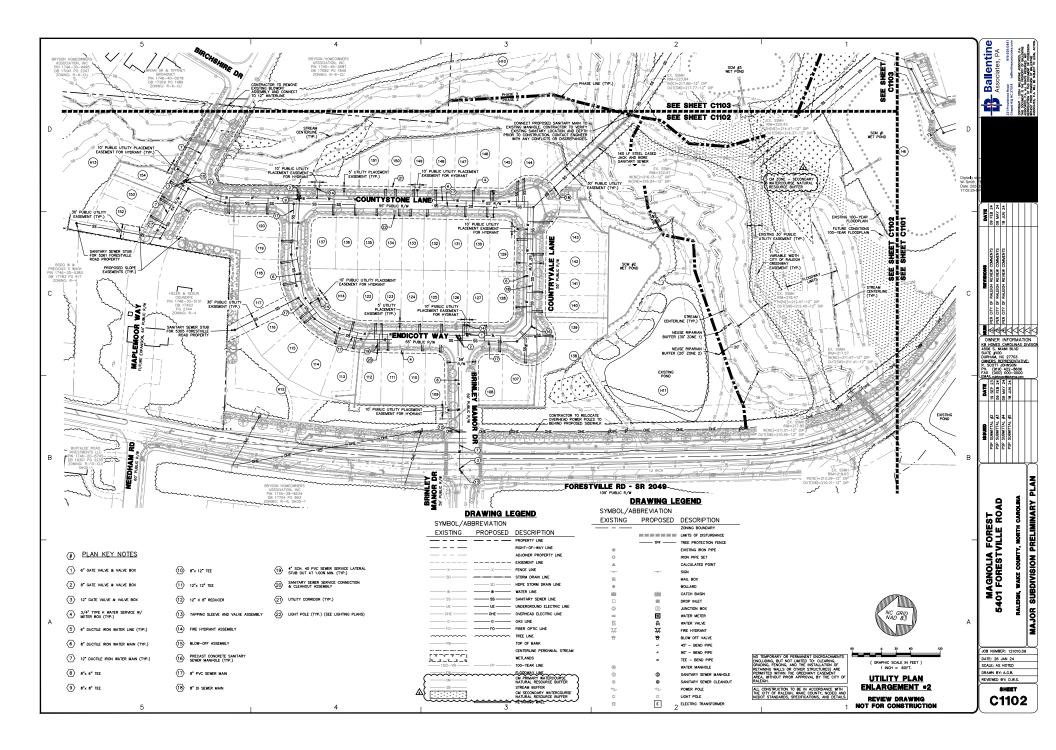


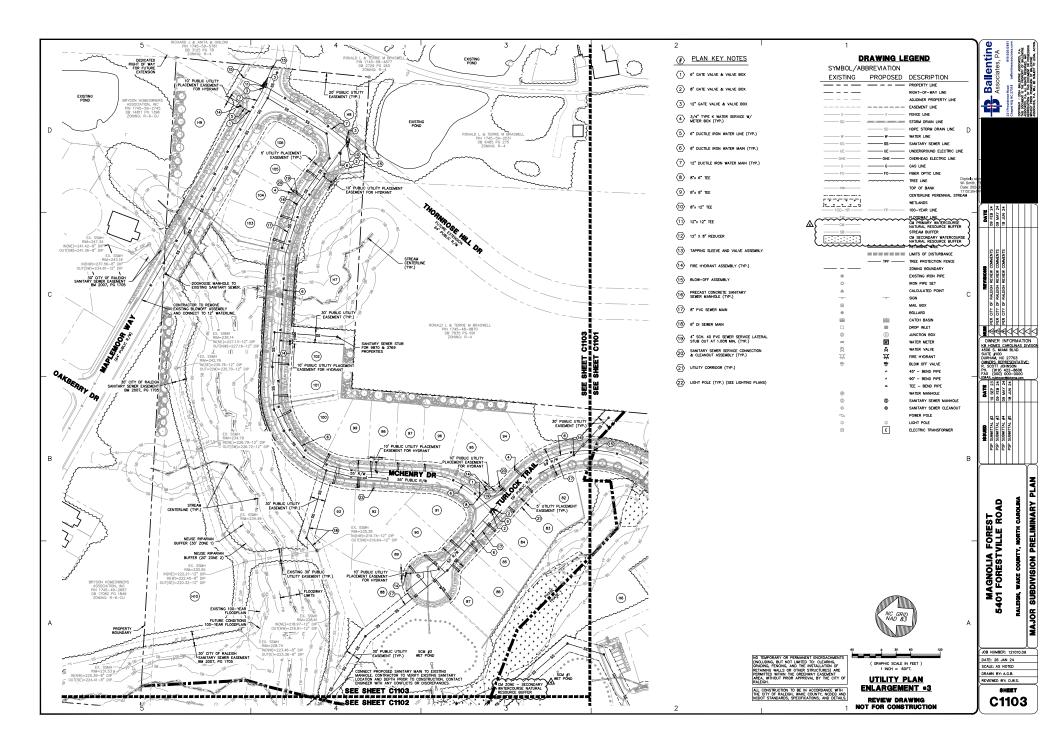


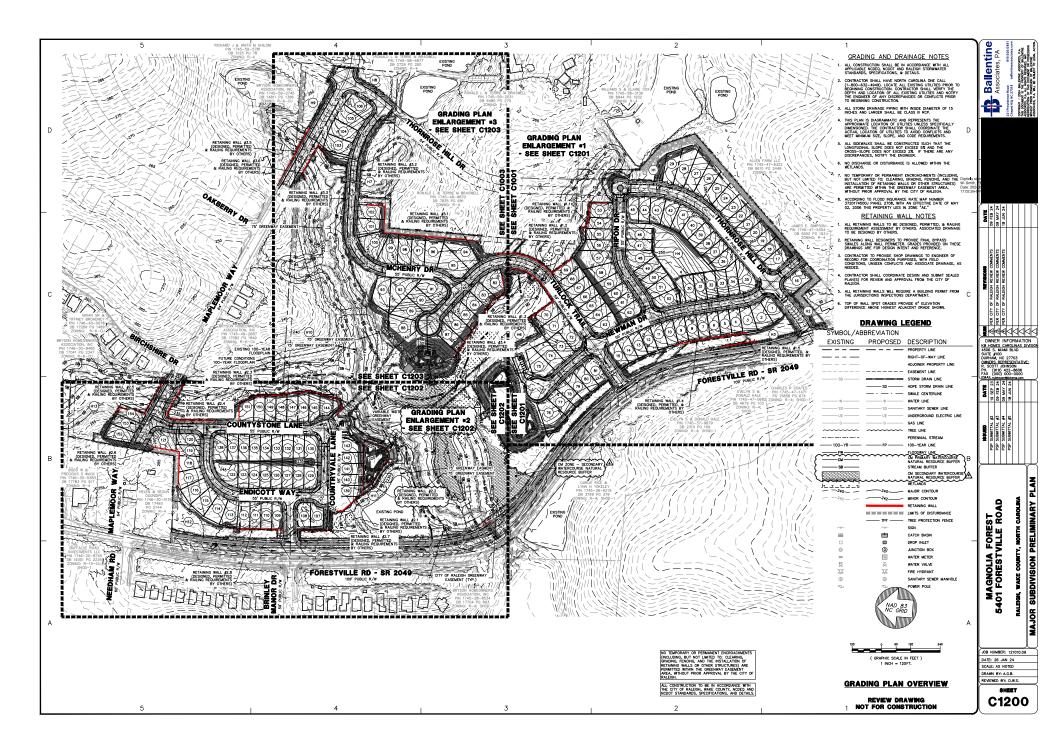


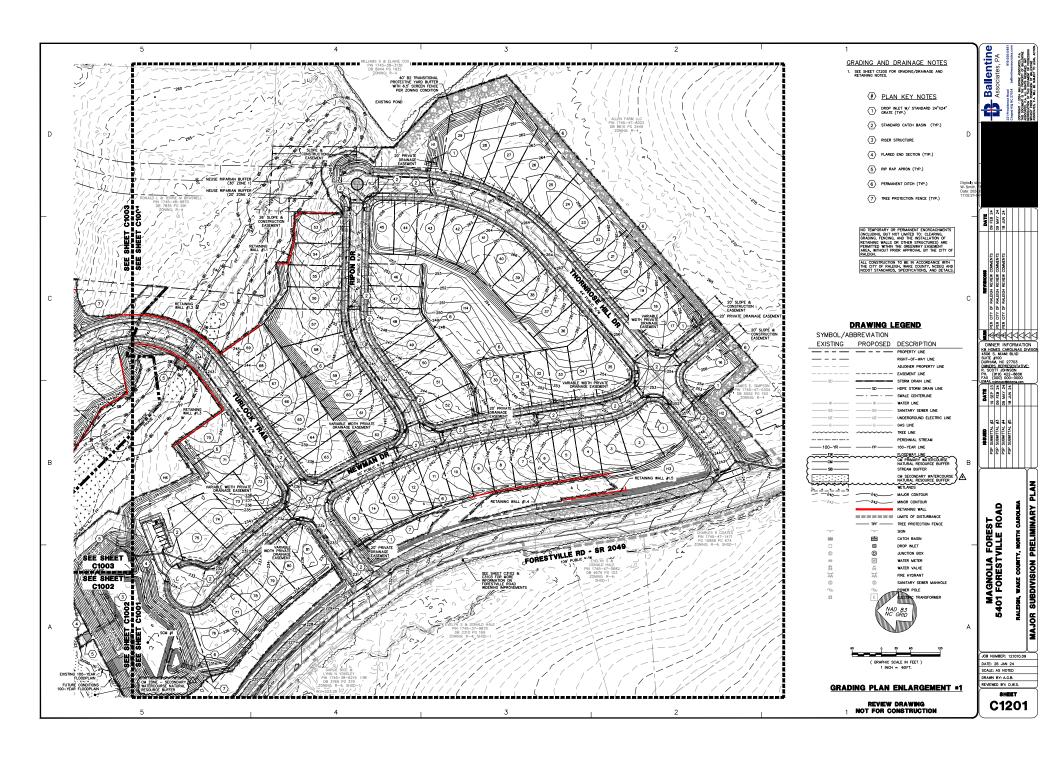


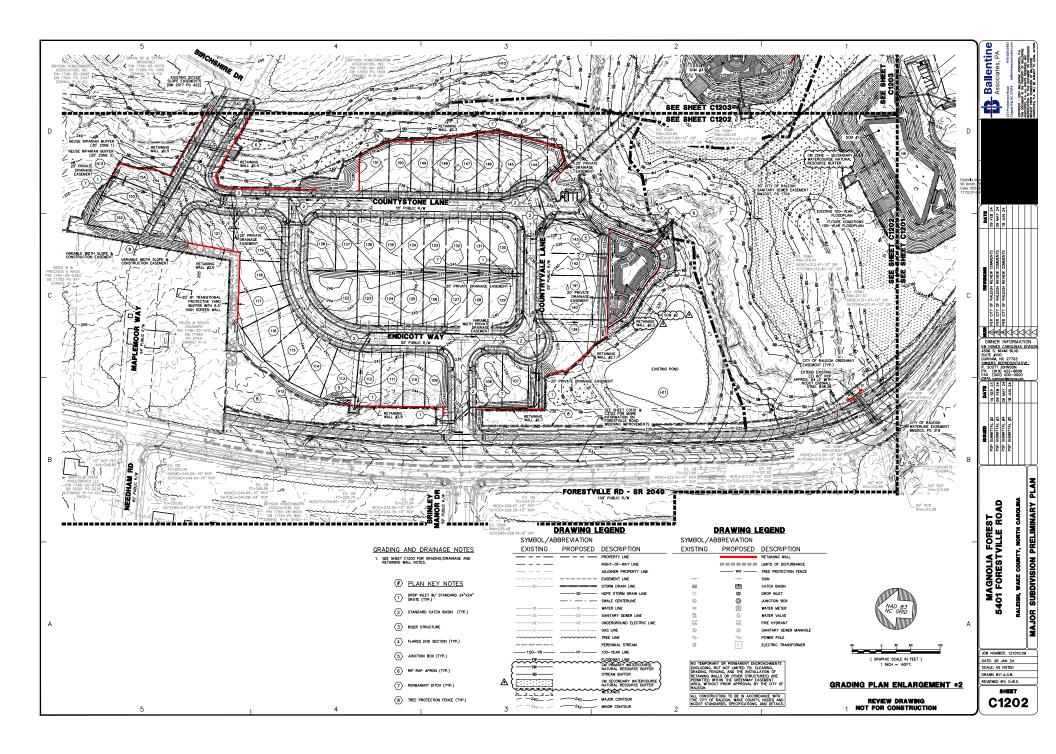


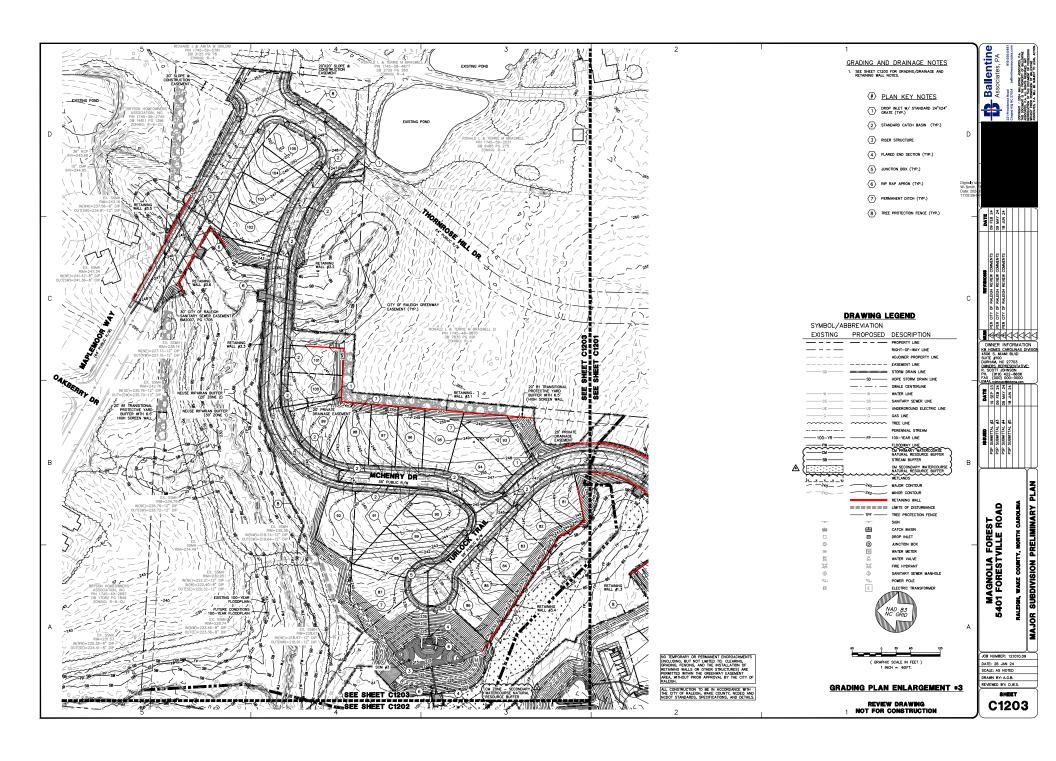


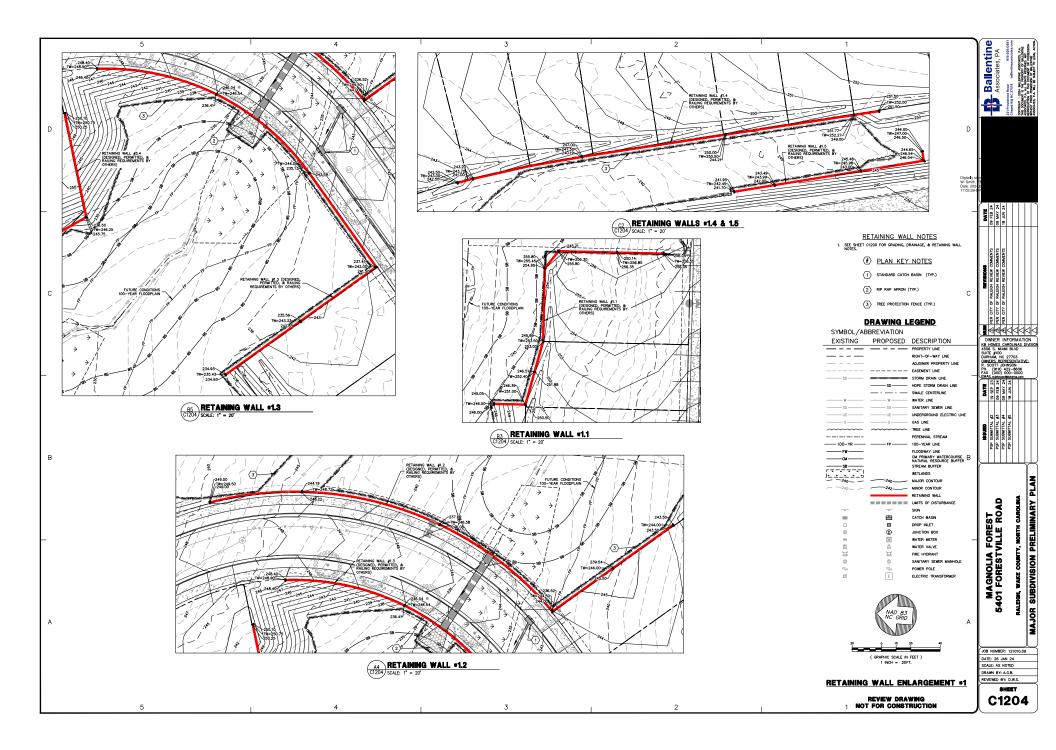


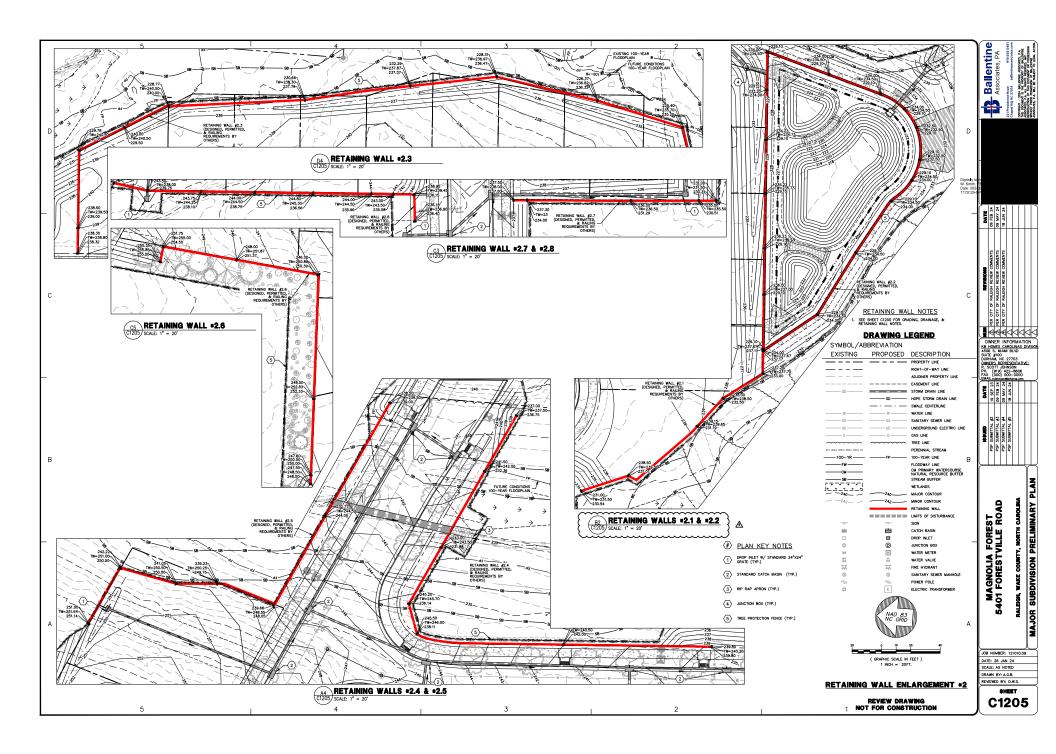


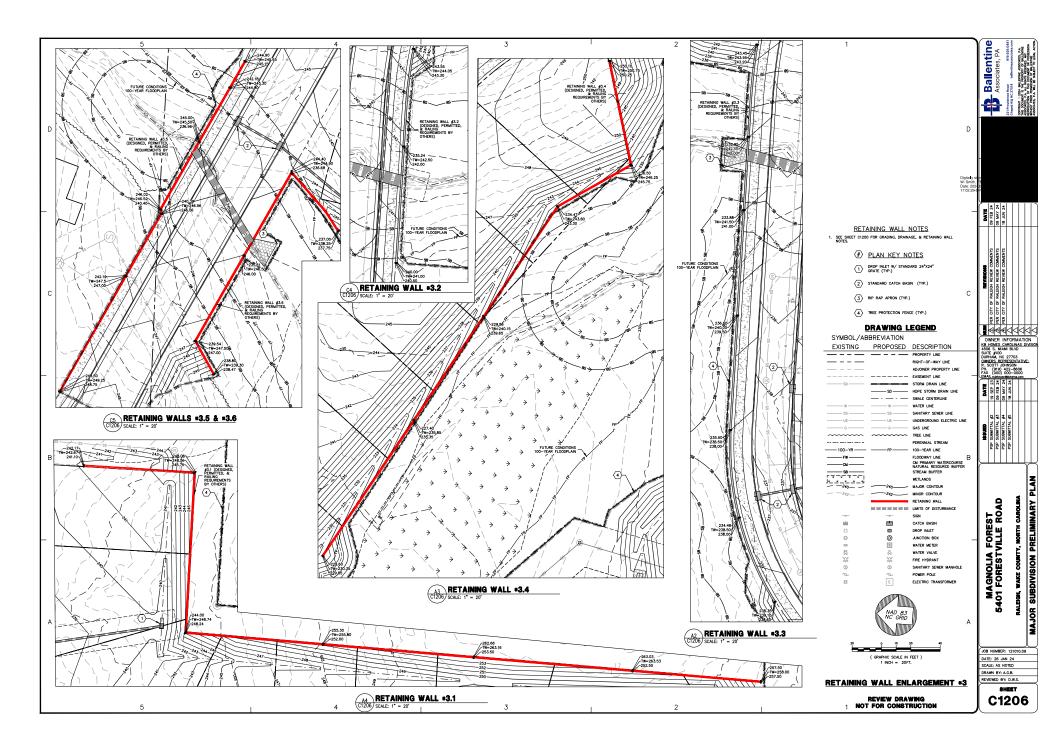


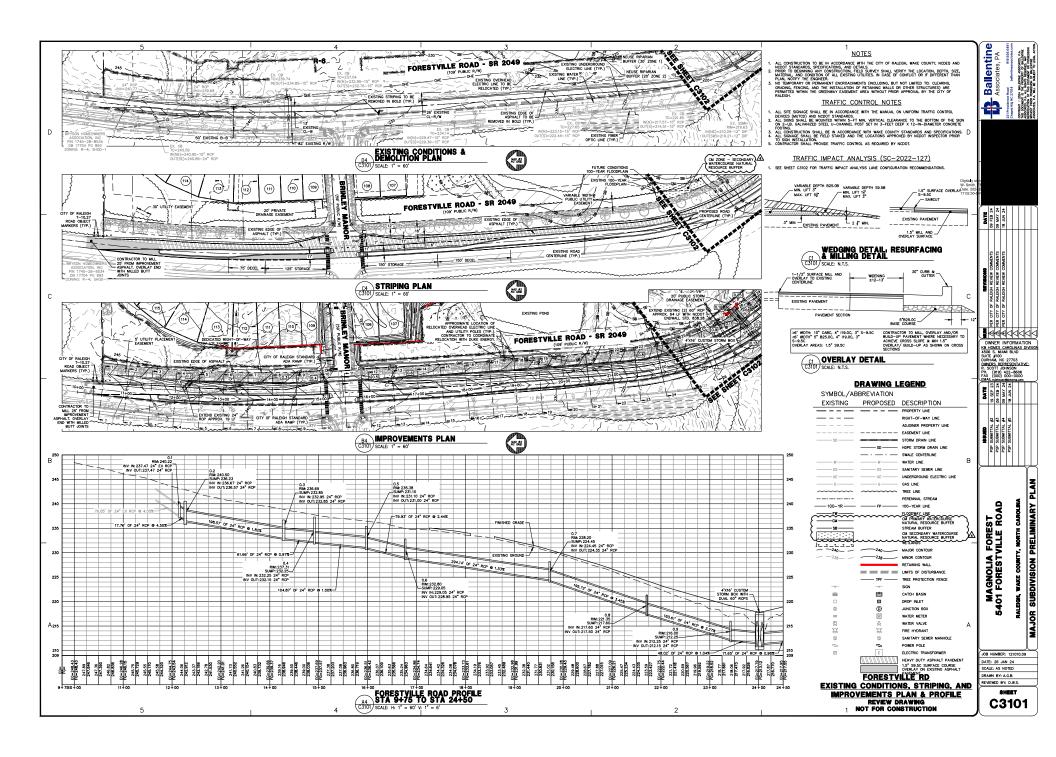


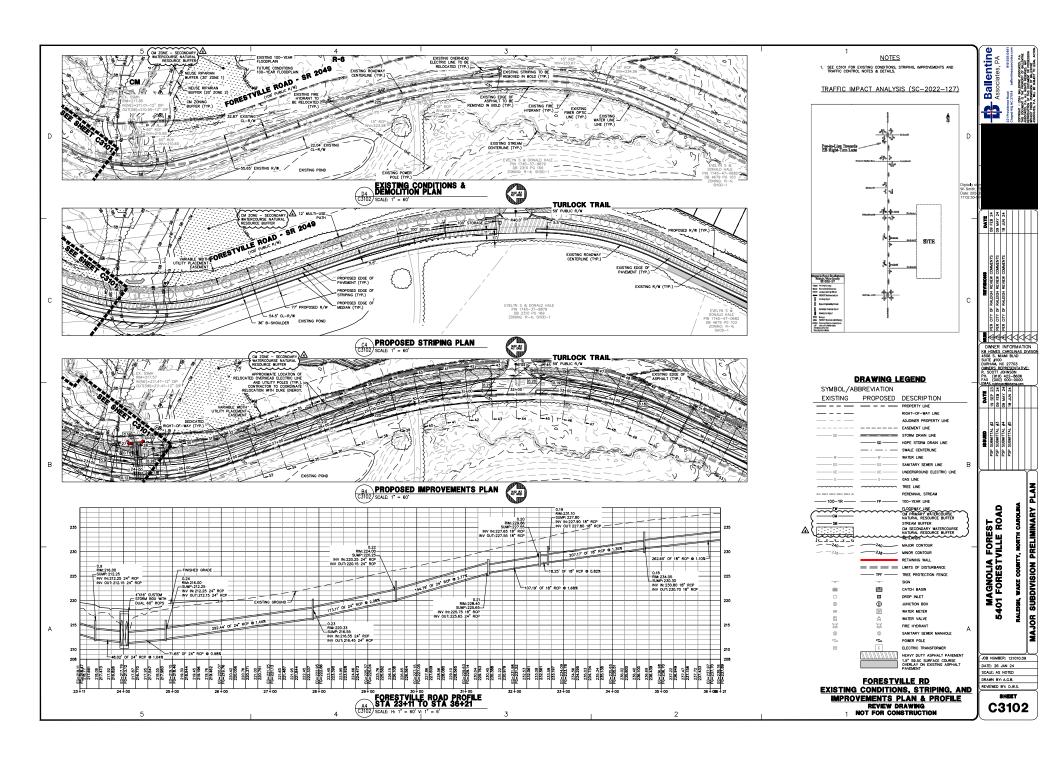


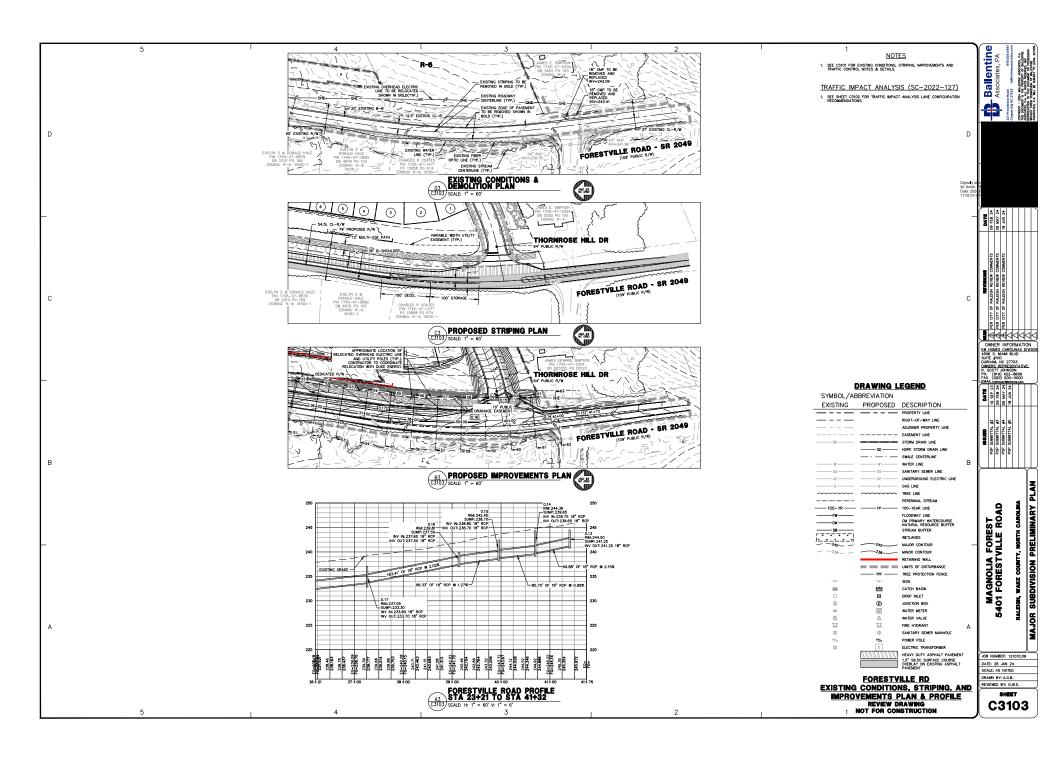


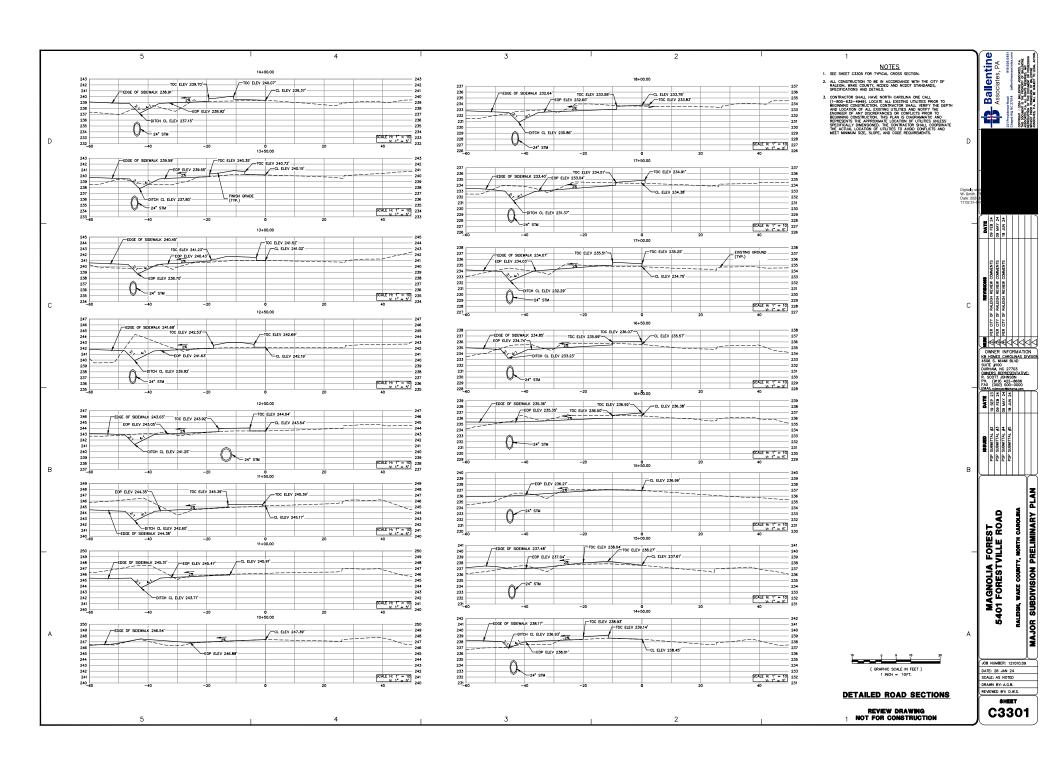


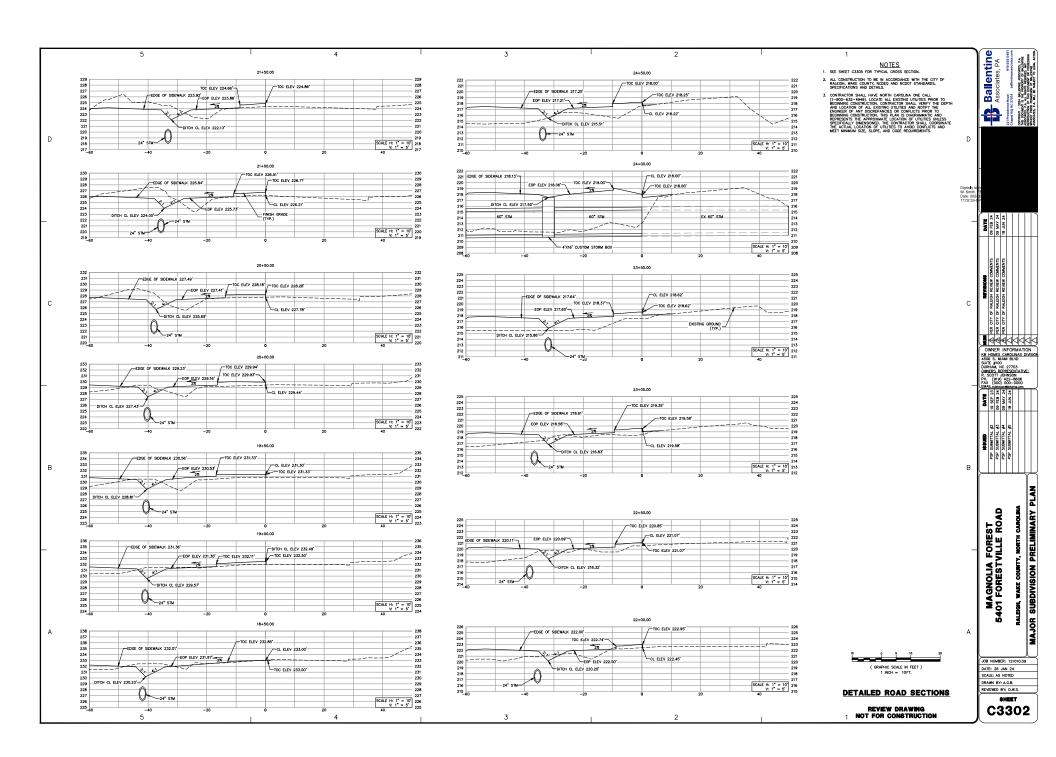


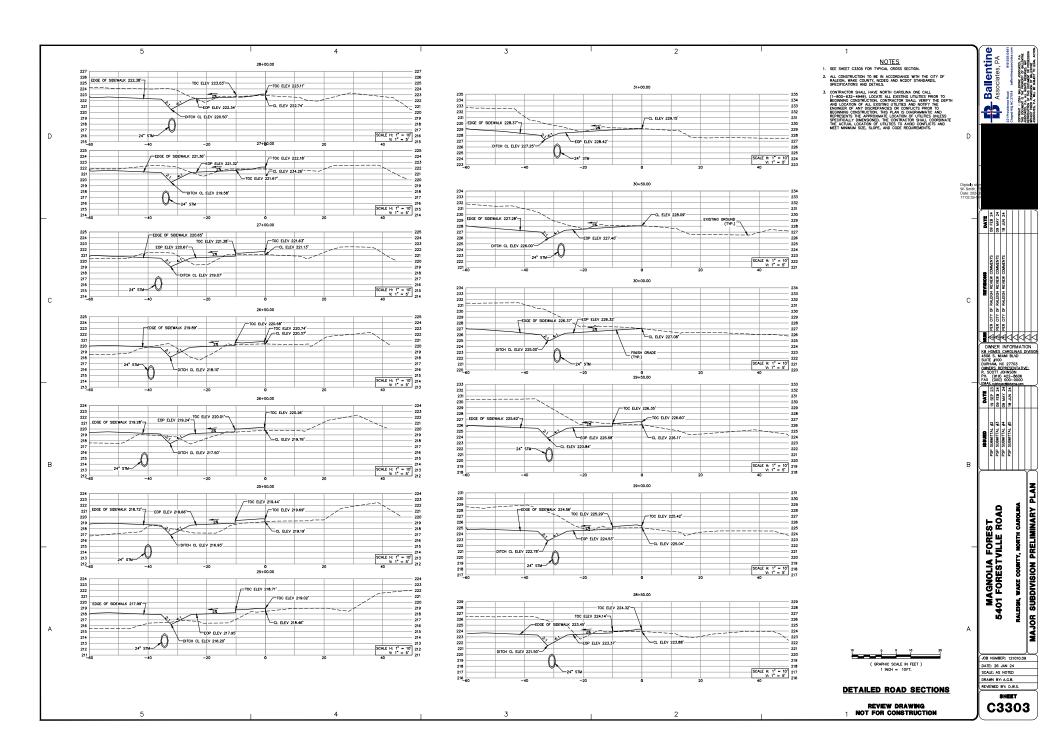


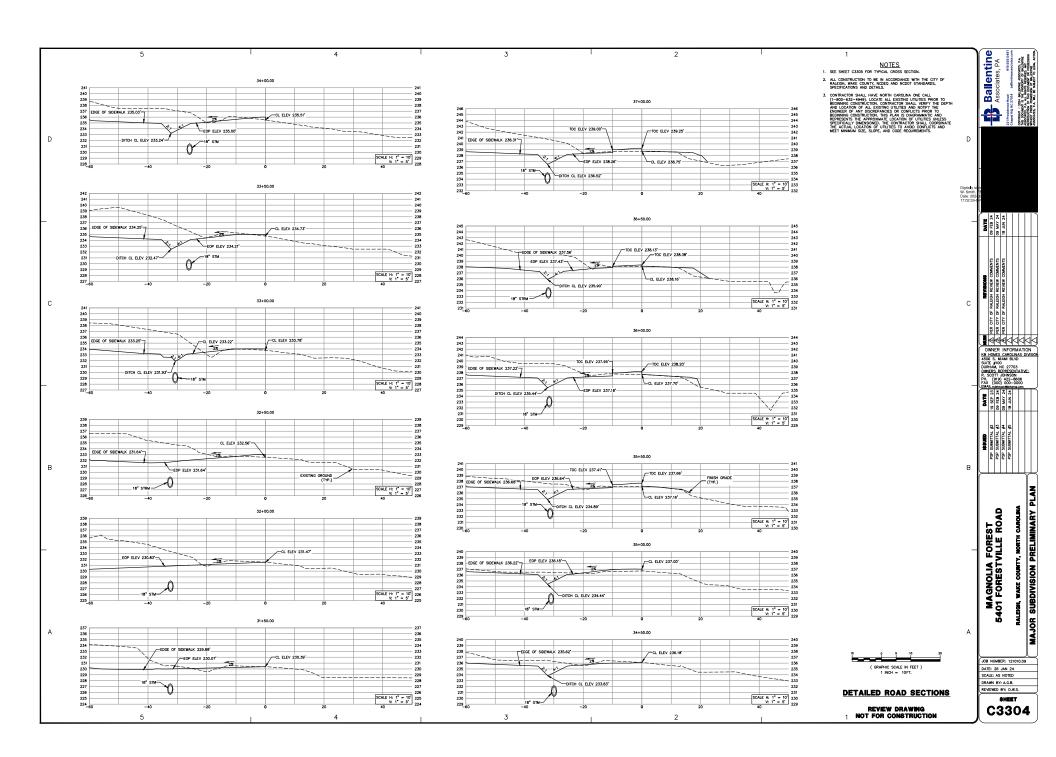

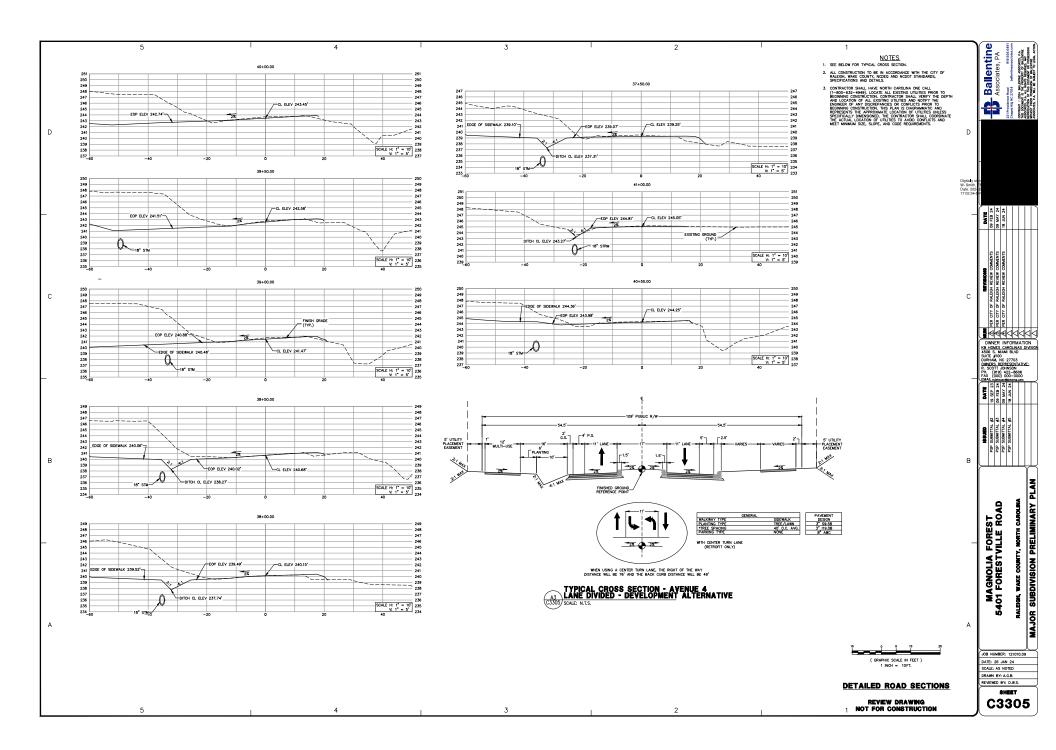

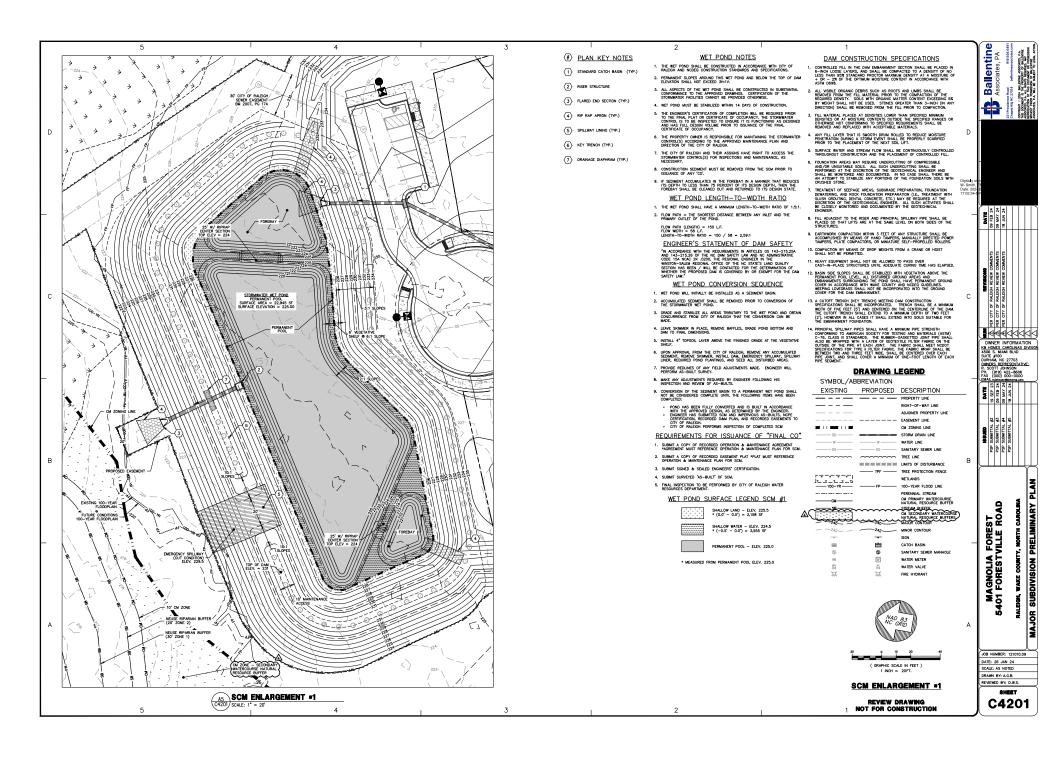

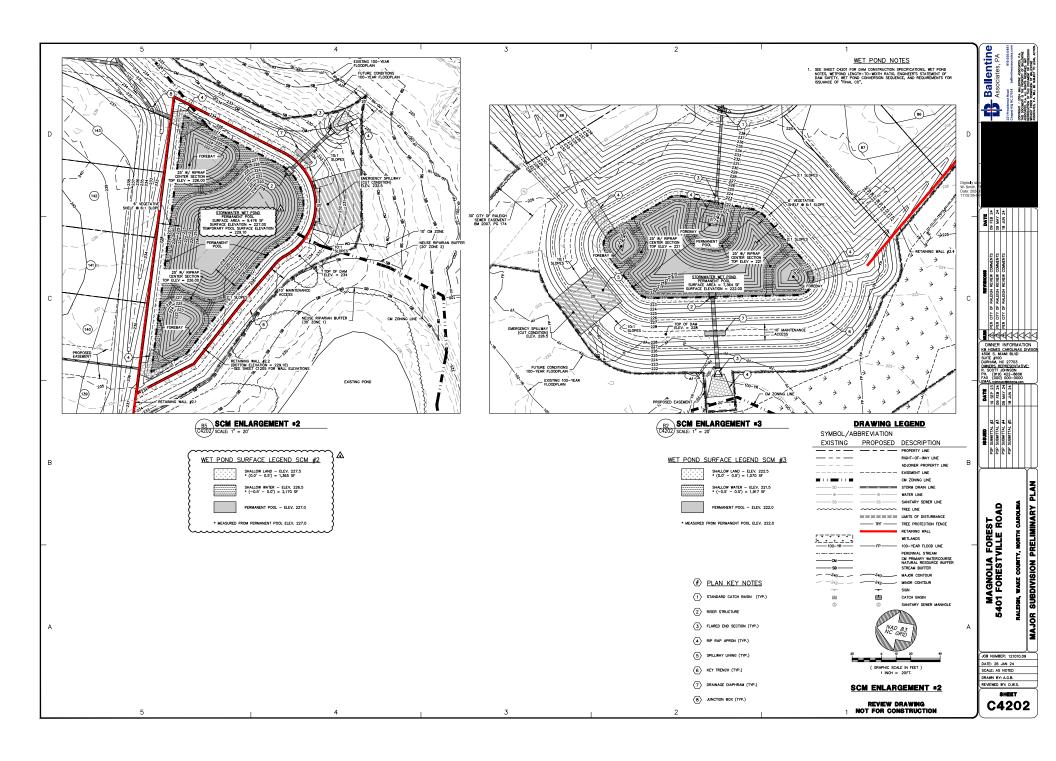

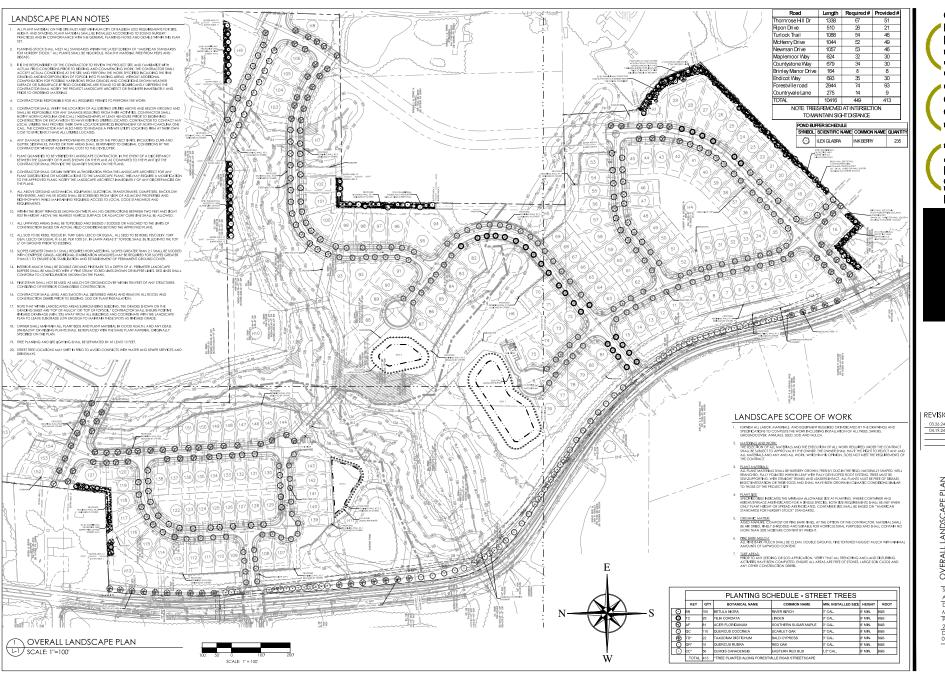



REVISIONS:


03.26.24 - CITY COMMENTS

OVERALL LANDSCAPE PLAN
MAGNOLIA FOREST
5001 FORESYNLE COAD
RALEGH, NC 27604

SCALE: AS NOTED DRAWN BY: MAK PROJECT #

24015 DATE: 02-02-2024 SHEET

L-1 OF XX

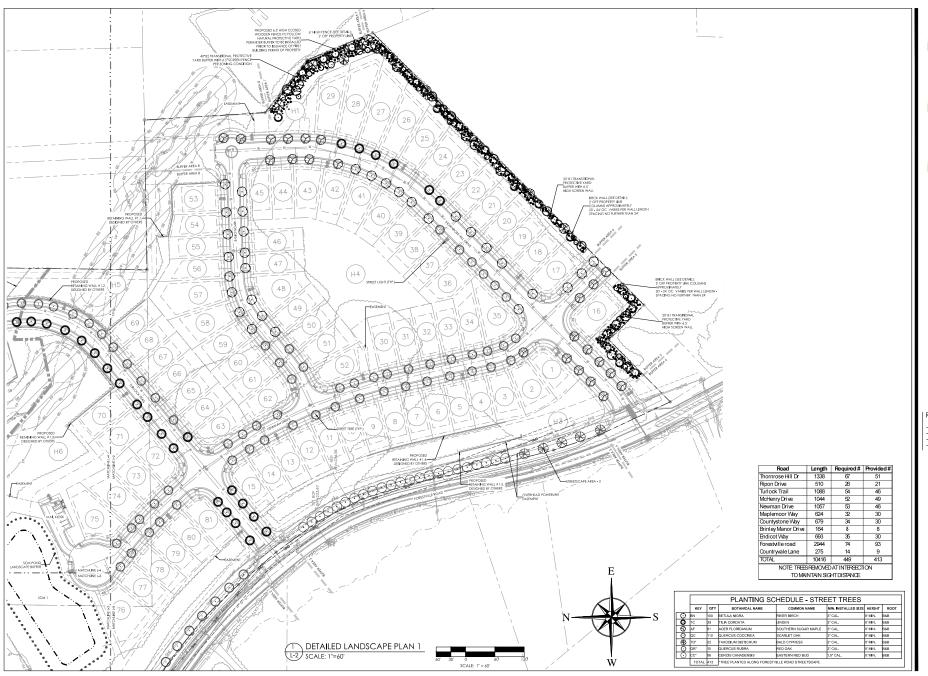




REV**I**SIONS:

03.26.24 - CITY COMMENTS 04.19.24 - BASE CHANGE

DETAILED LANDSCAPE PLAN 1
MAGNOLIA FOREST
5401 FORESYNLLE ROAD
RALEGH NC 27864

SCALE: AS NOTED DRAWN BY: MK PROJECT # 24015 DATE: 02-02-2024

SHEET L-2 OF XX

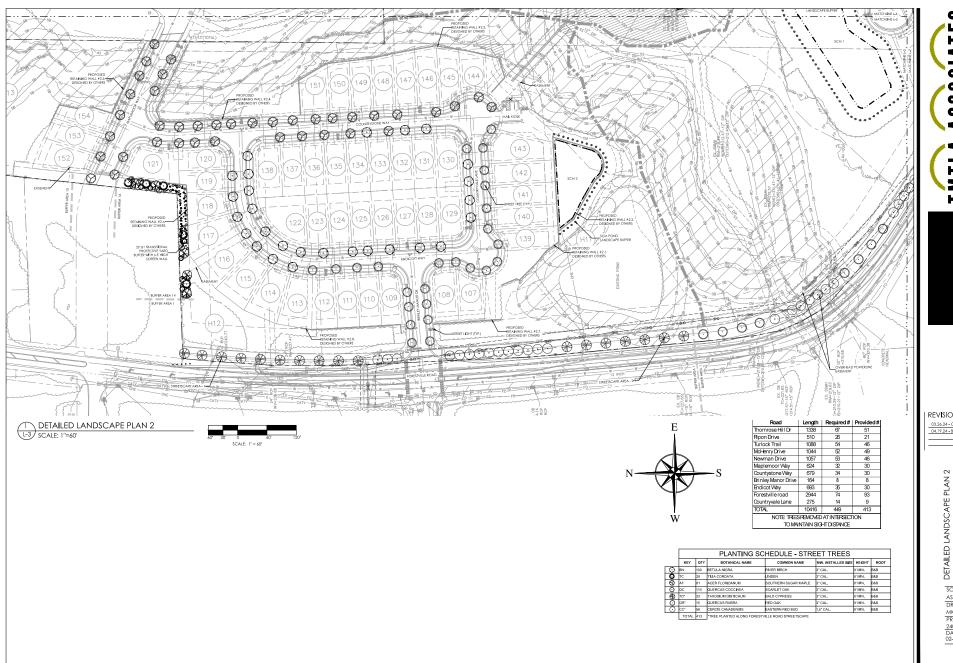



REVISIONS:


03.26.24 - CITY COMMENTS 04.19.24 - BASE CHANGE

DETAILED LANDSCAPE PLAN 2
MAGNOLIA FOREST
SOOI FORESYULLE ROAD
RALEGH NC 27804

SCALE: AS NOTED DRAWN BY: MK

PROJECT # 24015 DATE: 02-02-2024

SHEET L-3 OF XX

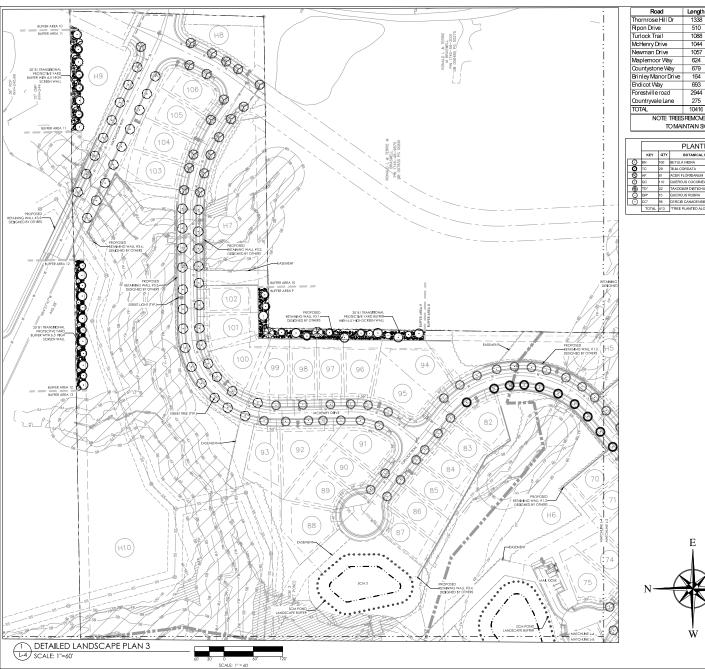

Road	Length	Required#	Provided#
Thornrose Hill Dr	1338	67	51
Ripon Drive	510	26	21
Turlock Trail	1088	54	46
McHenry Drive	1044	52	49
Newman Drive	1057	53	46
Maplemoor Way	624	32	30
Countystone Way	679	34	30
Brinley Manor Drive	164	8	8
Endicot Way	693	35	30
Forestville road	2944	74	93
Countryvale Lane	275	14	9
TOTAL	10416	449	413
NOTE TREES	REMOVED	AT INTERSECT	10N

TO MAINTAIN SIGHT DISTANCE

			PLANTING SC	HEDULE - STRE	ET TREES		
	KEY	QTY	BOTANICAL NAME	COMMON NAME	MIN. INSTALLED SIZE	HEIGHT	ROOT
0	BN	100	BETULA NIGRA	RIVER BIRCH	3° CAL.	8' MIN.	B&B
0	TC	29	TILIA CORDATA	LINDEN	3° CAL.	8' MIN.	888
0	AF	81	ACER FLORIDANUM	SOUTHERN SUGAR MAPLE	3" CAL.	8' MIN.	888
0	QC .	110	QUERCUS COCCINEA	SCARLET OAK	3" CAL.	8' MN.	888
49	TD*	22	TAXODIUM DISTICHUM	BALD CYPRESS	3" CAL.	8' MIN.	888
0	QR*	15	QUERCUS RUBRA	RED OAK	3° CAL.	8' MIN.	888
0	cc.	56	CERCIS CANADENSIS	EASTERN RED BUD	1.5" CAL.	8' MIN.	888
	TOTAL		ATREE DI ANTER AL ONO CORCOT	ILLE DOLD OFFICEROOLDE			•



ASSOCIATES

LANDSCAPE ARCHITECTURE & LAND PLANNING SOIL SOUTHPARA DRIVE, STEEDWINGHAM, NC 27733 P. (919), 484-48890 e. info@conda.com

03.26.24 - CITY COMMENTS


DETAILED LANDSCAPE PLAN 3
MAGNOLIA FOREST
SOOI FORESYNLLE ROAD
RALEIGH NC 27:604


SCALE: AS NOTED


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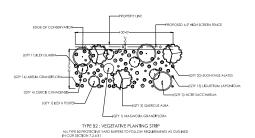
MK PROJECT # 24015 DATE: 02-02-2024


SHEET L-4 OF XX



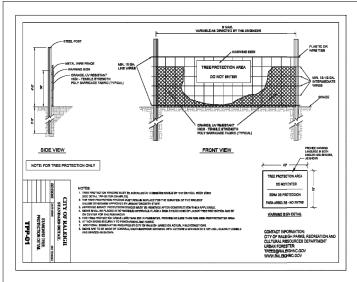

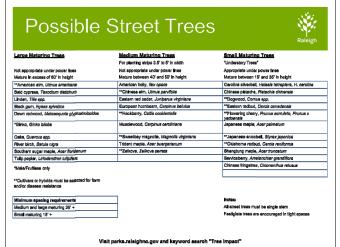

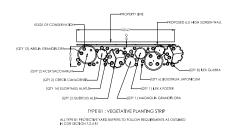

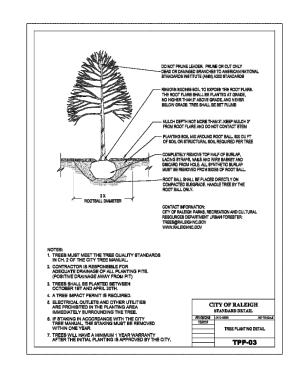

TMTLA ASSOCIATES

LANDSCAPE ARCHITECTURE & LAND PLANNING
SOIL SOUTHWARK PINE, STEEDMOGNAME, NC 27713
P. (191) 464-4880 e. nid@ Outlakeon

REV**I**SIONS:


03.26.24 - CITY COMMENTS

LANDSCAPE DETAILS
MAGNOLIA FOREST
540) FORESTVILE RALEIGH NC 27604


SCALE: AS NOTED DRAWN BY: MK PROJECT #


PROJECT # 24015 DATE: 02-02-2024 SHEET

> L-5 OF XX

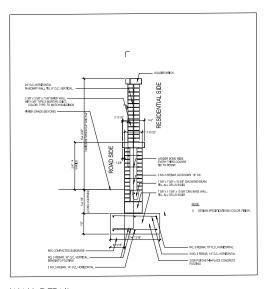

WALL DETAIL

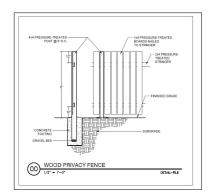

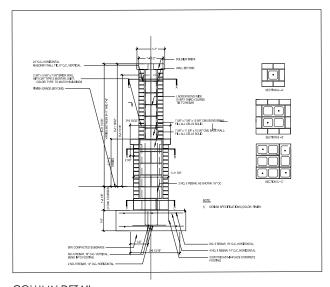

COLUMN DETAIL



REVISIONS:

03.26.24 - CITY COMMENTS

DETAILS IA FOREST

LANDSCAPE DETAILS
MAGNOLIA FOREST
SOOT FORESYLLE ROAD
RALECH NC 27804

AS NOTED

DRAWN BY:

MK

PROJECT #

PROJECT # 24015 DATE: 02-02-2024 SHEET

> L-6 OF XX

BUFFER AREA -1 625' LENGTH

PER SHEET 2.10 OPEN SPACE PLAN PER SHEET 2.11 TREE CONSERVATION AREA PLAN PER SHEET 4.0 AND 4.2 GRADING PLANS

EXISTING AND DESIGN CONDITIONS

- THIS AREA IS SECONDARY OPEN SPACE
- THIS ARE IS 50' WIDE AND UNDISTURBED EXCEPT FOR EXCEPT FOR ROAD SIDE GRADING, UTILITY LINE RELOCATION, AND MINOR ROAD IMPROVEMENT DRAINAGE

REQUIRED BUFFER PLANTING

NO BUFFER REQUIRED IN THAT THE EXISTING CONDITIONS WILL PRESERVE A 40' MINIMUM BUFFER ALONG THE ROAD FRONTAGE

- PROVIDED BUFFER PLANTING

 THIS OPEN SPACE PER OPEN SPACE, GRADING AND TREE CONSERVATION PLANS THIS AREA IS TO BE UNDISTURBED EXCEPT FOR MINOR ROAD SIDE GRADING THE AREA AND BUFFER REMAIN UNDISTURBED.
- NO BUFFER PLANTING IS TO BE INSTALLED
- EXISTING VEGETATED MEETS REQUIREMENTS

BUFFER AREA -2 340' LENGTH

PER SHEET 2.10 OPEN SPACE PLAN PER SHEET 2.11 TREE CONSERVATION AREA PLAN PER SHEET 4.0 AND 4.2 GRADING PLANS

EXISTING AND DESIGN CONDITIONS THIS AREA IS TERTIARY OPEN SPACE

- THIS ARE IS 50' WIDE AND UNDISTURBED EXCEPT FOR EXCEPT FOR ROAD SIDE GRADING AND UTILITY LINE RELOCATION

REQUIRED BUFFER PLANTING

NO BUFFER REQUIRED IN THAT THE EXISTING CONDITIONS WILL PRESERVE A 40' MINIMUM BUFFER ALONG THE ROAD FRONTAGE

PROVIDED BUFFER PLANTING

- THIS OPEN SPACE PER OPEN SPACE, GRADING AND TREE CONSERVATION PLANS
 THIS AREA IS TO BE UNDISTURBED EXCEPT FOR MINOR ROAD SIDE GRADING THE AREA AND BUFFER REMAIN UNDISTURBED.
- NO BUFFER PLANTING IS TO BE INSTALLED

EXISTING VEGETATED MEETS REQUIREMENTS

BUFFER AREA - 3

PER SHEET 2.10 OPEN SPACE PLAN PER SHEET 2.11 TREE CONSERVATION AREA PLAN PER SHEET 4.0 AND 4.2 GRADING PLANS

EXISTING AND DESIGN CONDITIONS THIS AREA IS TERTIARY OPEN SPACE

- THIS ARE IS 50' WIDE AND UNDISTURBED EXCEPT FOR EXCEPT FOR ROAD SIDE GRADING AND UTILITY LINE RELOCATION

REQUIRED BUFFER PLANTING

NO BUFFER REQUIRED IN THAT THE EXISTING CONDITIONS WILL PRESERVE A 40' MINIMUM BUFFER ALONG THE ROAD FRONTAGE

- PROVIDED BUFFER PLANTING

 THIS OPEN SPACE PER OPEN SPACE, GRADING AND TREE CONSERVATION PLANS THIS AREA IS TO BE UNDISTURBED EXCEPT FOR MINOR ROAD SIDE GRADING THE AREA AND BUFFER REMAIN UNDISTURBED.
- NO BUFFER PLANTING IS TO BE INSTALLED
- EXISTING VEGETATED MEETS REQUIREMENTS

FORESTVILLE STREET TREE PLANTING AREA 1

457' LENGTH

- EXISTING AND DESIGN CONDITIONS

 ROAD CROSS SECTION IS TO BE A DITCH SECTION WITH A 6' PLANTING ARE BETWEEN THE TOP OF BANK AND 10' MULTI USE PATH
- OVERHEAD LINES TO BE MOVED ON OUTSIDE OF MULTI-USE PATH

- REQUIRED STREET TREE PLANTING
 ONE UPPER STORY (SHADE) TREE TO BE PLANTED 40 FEET ON CENTER
- ONE UNDERSTORY TREE (WITHIN 15 FT OF OVERHEAD POWER LINE) TO BE PLANTED 20 FEET ON CENTER
- PROVISIONS MADE FOR SITE TRIANGLES
- TREE TO BE 3" CAL 10-12" HT MINIMUM
- 457' / 40' OC = 12 TREES

PROVIDED BUFFER PLANTING

TREES PLANTED AT 40 °OC, 20 °OC WITHIN 15 FT OF OVERHEAD POWER LINE
13 TREES PROVIDED.

FORESTVILLE STREET TREE PLANTING 1500' LENGTH

- EXISTING AND DESIGN CONDITIONS ROAD CROSS SECTION IS TO BE A DITCH SECTION WITH A 6' PLANTING ARE
- BETWEEN THE TOP OF BANK AND 10' MULTI USE PATH.

 OVERHEAD LINES TO BE MOVED OUTSIDE OF MUTI-USE PATH

- REQUIRED STREET TREE PLANTING

 ONE UPPER STORY (SHADE) TREE TO BE PLANTED 40 FEET ON CENTER
- ONE UNDERSTORY TREE (WITHIN 15 FT OF OVERHEAD POWER LINE) TO BE PLANTED 20 FEET ON CENTER
- PROVISIONS MADE FOR SITE TRIANGLES
- TREE TO BE 3" CAL 10-12" HT MINIMUM
- 1500' / 40' OC = 8 TREES

- PROVIDED BUFFER PLANTING

 TREES PLANTED AT 40' OC, 20' OC WITHIN 15 FT OF OVERHEAD POWER LINE

FORESTVILLE STREET TREE PLANTING

600' LENGTH

EXISTING AND DESIGN CONDITIONS

- ROAD CROSS SECTION IS TO BE A DITCH SECTION WITH A 6' PLANTING ARE BETWEEN THE TOP OF BANK AND 10' MULTI USE PATH.
- OVERHEAD LINES TO BE MOVED ON OUTSIDE OF MULTI-USE PATH

- REQUIRED STREET TREE PLANTING

 ONE UPPER STORY (SHADE) TREE TO BE PLANTED 50 FEET ON CENTER ONE UNDERSTORY TREE (WITHIN 15 FT OF OVERHEAD POWER LINE) TO BE PLANTED 20 FEET ON CENTER
- PROVISIONS MADE FOR SITE TRIANGLES
- TREE TO BE 3" CAL 10-12" HT MINIMUM
- 600' / 40' OC = 15 TREES

- PROVIDED BUFFER PLANTING

 TREES PLANTED AT 40' OC, 20' OC WITHIN 15 FT OF OVERHEAD POWER LINE
- ONE TREE ADDED ON SOUTH SIDE OF ENTRANCE

STREETSCAPE AREA 1

L	IKEES	•						
-	SYMB	QUANT	SCIENTIFIC NAME	COMMON NAME	CAL.	HEIGHT	SPREAD	NOTES
	8	10	TAXODIUM DISTICHUM	BLAD CYPRESS	3"	10'-12'	6'-8'	SINGLE LEADER - FULL
	\odot	3	CERCIS CANADENSIS	EASTERN RED BUD	1.5"	10'-12'	6'-8'	SINGLE LEADER - FULL

STREETSCARE AREA 3

TREES	3						
	QUANT	SCIENTIFIC NAME	COMMON NAME	CAL.	HEIGHT	SPREAD	NOTES
8	7	TAXODIUM DISTICHUM	BALD CYPRESS	3"	10'-12'	6'-8'	SINGLE LEADER - FULL
0	15	QUERCUS RUBRA	RED OAK	3"	10'-12'	6'-8'	SINGLE LEADER - FULL
\odot	30	CERCIS CANADENSIS	EASTERN RED BUD	1.5"	10'-12'	6'-8'	SINGLE LEADER - FULL

STREETSCAPE AREA - 3

TREES	3						
_	QUANT	SCIENTIFIC NAME	COMMON NAME	CAL.	HEIGHT	SPREAD	NOTES
8	5	TAXODIUM DISTICHUM	BALD CYPRESS	3"	10'-12'	6'-8'	SINGLE LEADER - FULL
\odot	23	CERCIS CANADENS I S	EASTERN RED BUD	1.5"	10'-12'	6'-8'	SINGLE LEADER - FULL

REVISIONS:

03.26.24 - CITY COMMEN

LANDSCAPE BUFFER SCHEDULE
MAGNOLIA FOREST
5401 FORESTMLE ROAD
RAEGH NG 27:064

SCALE: AS NOTED DRAWN BY:

PROJECT # 02-02-2024

> SHEET L-7 OF XX

BUFFER AREA - 4 50' LENGTH

PER SHEET 2.10 OPEN SPACE PLAN PER SHEET 2.11 TREE CONSERVATION AREA PLAN PER SHEET 4.0 AND 4.2 GRADING PLANS

EXISTING AND DESIGN CONDITIONS

THIS AREA IS PRIMARY OPEN SPACE

THIS ARE IS 50' WIDE AND UNDISTURBED EXCEPT FOR ROAD SIDE GRADING AND UTILITY LINE RELOCATION

REQUIRED BUFFER PLANTING

NO BUFFER REQUIRED IN THAT THE EXISTING CONDITIONS WILL PRESERVE A 40' MINIMUM BUFFER ALONG THE ROAD FRONTAGE

- PROVIDED BUFFER PLANTING

 THIS OPEN SPACE PER OPEN SPACE, GRADING AND TREE CONSERVATION PLANS THIS AREA IS TO BE UNDISTURBED EXCEPT FOR MINOR ROAD SIDE GRADING THE AREA AND BUFFER REMAIN UNDISTURBED.
- NO BUFFER PLANTING IS TO BE INSTALLED
- EXISTING VEGETATED MEETS REQUIREMENTS

BUFFER AREA - 5 233' LENGTH

PER SHEET 2.10 OPEN SPACE PLAN PER SHEET 2.11 TREE CONSERVATION AREA PLAN PER SHEET 4.0 AND 4.2 GRADING PLANS

- EXISTING AND DESIGN CONDITIONS
 THIS AREA IS PRIMARY OPEN SPACE
- THIS ARE IS 20' WIDE AND WILL DISTURBED DUE TO GRADING AND UTILITY INSTALLATION.

REQUIRED BUFFER PLANTING

TYPE B1 BUFFER REQUIRED

- PER 100'
 - 2 DECIDUOUS SHADE TREES AND 2 LARGE EVER GREEN TREES
- 2 DECIDUOUS UNDER STORY TREES AND 2 EVERGREEN UNDER STORY TREES
- TOTAL BUFFER LENGTH = 233 LF
- TOTAL SHADE TREES 233' = (2.33) X 2 = 5 SHADE TREES
 TOTAL EVERGREEN TREES = (2.33) X 2 = 5 EVERGREEN TREES
- TOTAL UNDER STORY TREES = (2.33) X 2 = 5 UNDER STORY TREES
- TOTAL UNDER STORY EVERGREEN TREES (2.33) X 2 = 5 UN/ST EV GR. TREES
- TOTAL EVERGREEN SHRUBS (2.33) X 40 = 94 SHRUBS

PROVIDED BUFFER PLANTING

- 233 LF

 TOTAL SHADE TREES 10 SHADE TREES
- TOTAL EVERGREEN TREES 10 EVERGREEN TREES
- TOTAL UNDER STORY TREES 10 UNDER STORY TREES TOTAL UNDER STORY EVERGREEN TREES -10 UN/ST EV.GR. TREES
- TOTAL EVERGREEN SHRUBS 98 SHRUBS

BUFFER AREA - 6

PER SHEET 2 10 OPEN SPACE PLAN PER SHEET 2.11 TREE CONSERVATION AREA PLAN PER SHEET 4.0 AND 4.2 GRADING PLANS

EXISTING AND DESIGN CONDITIONS

- THIS AREA IS PRIMARY OPEN SPACE
- THIS ARE IS 20' WIDE AND WILL DISTURBED DUE TO GRADING AND UTILITY INSTALLATION.

REQUIRED BUFFER PLANTING

TYPE B1 BUFFER REQUIRED

- PER 100'
- 2 DECIDUOUS SHADE TREES AND 2 LARGE EVER GREEN TREES
- 2 DECIDUOUS UNDER STORY TREES AND 2 EVERGREEN UNDER STORY TREES
- 40 EVERGREEN SHRUBS TOTAL BUFFER LENGTH = 620 LF

- TOTAL SHADE TREES 620' = (6,2) X 2 = 13 SHADE TREES TOTAL EVERGREEN TREES = (6.2) X 2 = 13 EVERGREEN TREES
- TOTAL UNDER STORY TREES = (6.2) X 2 = 13 UNDESTORY TREES TOTAL UNDER STORY EVERGREEN TREES (6.2) X 2 = 13 UN/ST EV.GR. TREES
- TOTAL EVERGREEN SHRUBS (6.2) X 40 = 248 SHRUBS

PROVIDED BUFFER PLANTING

620 LF • TO

- TOTAL SHADE TREES 14 SHADE TREES
- TOTAL EVERGREEN TREES 13 EVERGREEN TREES TOTAL UNDER STORY TREES 14 UNDESTORY TREES
- TOTAL UNDER STORY EVERGREEN TREES 13 UN/ST EV.GR. TREES TOTAL EVERGREEN SHRUBS - 248 SHRUBS

BUFFER AREA 5

BUFFE	IN AREA	5						
SHADI	TREES							
SYMB	QUANT	SCIENTIFIC NAME	COMMON NAME	CAL.	HEIGHT	SPREAD	NOTES	
0	4	ACER SACCARUM	SUGAR MAPLE	3"	10'-12'	6'-8'	SINGLE LEADER - FULL	DEC
0	1	QUERCUS RUBRA	RED OAK	3"	10'-12'	6'-8'	SINGLE LEADER - FULL	DE
C	4	PINUS TAEDA	LOBLOLLY PINE	3"	10'-12'	6'-8'	SINGLE LEADER - FULL	EVG
0	1	MAGNOLIA GRAND.	SOUTHERN MAG	3"	10'-12'	6'-8'	SINGLE LEADER - FULL	EVG
UNDE	RSTORY	TREES					•	
SYMB	QUANT	SCIENTIFIC NAME	COMMON NAME	CAL.	HEIGHT	SPREAD	NOTES	
0	3	LAGERSTOEMIA INDICA	CREPE MYRTLE	1,5"	6'-8'	4'-6'	3 STEM - FULL	DE
\odot	2	ACER PALMATUM	JAPANESE MAPLE	1.5"	6'-8'	4'-6'	3 STEM - FULL	DE
$\langle \hat{\cdot} \rangle$	2	PRUNUS CAROLINIANA	CHERRY LAUREL	1.5*	6'-8"	4'-6"	SINGLE LEADER - FULL	EV
0	3	THUGA CANADENSIS	HEMLOCK	1.5"	6'-8"	4'-6"	SINGLE LEADER - FULL	EVO
SHRU	BS							
SYMB	QUANT	SCIENTIFIC NAME	COMMON NAME	CAL.	HEIGHT	SPREAD	NOTES	
0	35	ABELIA GRANDIFLORA	GLOSSY ABELIA		18"-24"	18"-24"	FULL	EVG
0	17	AZALEA ENCORE	AZALEA - AUTUMN		18"-24"	18"-24"	FULL- COLOR VARIETIES	EVG
0	10	CHAMAECYPARIS OBTUSA	CHAMAECYPARIS		18"-24"	18"-24"	FULL	EVG
0	8	EUONYMUS FORTUNEI	EUONYMUS		18"-24"	18"-24"	FULL - LARGE VARIETY	EVG
0	8	LOROPETALUM CHINENSE	CHINESE FRINGE		18" -24"	18"-24" "	FULL LARGE VARIETY	EVG
8	20	VIBURNUM OBVATUM	VIBURNUM		18" -24"	18"-24"	FULL LARGE VARIETY	EVG

BUFFER AREA 6

SHADE	TREES							
SYMB	QUANT	SCIENTIFIC NAME	COMMON NAME	CAL.	HEIGHT	SPREAD	NOTES	
	5	ACER SACCARUM	SUGAR MAPLE	3"	10'-12'	6'-8'	SINGLE LEADER - FULL	DEC
8	3	PLATANUS OCCIDENTALIS	SYCAMORE	3"	10'-12'	6'-8'	SINGLE LEADER - FULL	DEC
0	6	QUERCUS RUBRA	RED OAK	3"	10'-12'	6'-8'	SINGLE LEADER - FULL	DEC
Ö	5	PINUS TAEDA	LOBLOLLY PINE	3*	10'-12'	6'-8'	SINGLE LEADER - FULL	EVGR
0	5	MAGNOLIA GRAND.	SOUTHERN MAG	3*	10'-12'	6'-8'	SINGLE LEADER - FULL	EVGR
UNDER	R STORY	TREES						
SYMB	QUANT	SCIENTIFIC NAME	COMMON NAME	CAL.	HEIGHT	SPREAD	NOTES	
0	6	LAGERSTOEMIA INDICA	CREPE MYRTLE	1.5*	6'-8'	4'-6'	3 STEM - FULL	DEC
\odot	5	ACER PALMATUM	JAPANESE MAPLE	1.5"	6'-8'	4'-6'	3 STEM - FULL	DEC
0	2	CERCIS CANADENSIS	REDBUD	1.5"	6'-8'	4'-6'	SINGLE LEADER - FULL	DEC
8	2	CORNUS FLORIDA	DOGWOOD	1.5"	6'-8'	4'-6'	SINGLE LEADER - FULL	DEC
53	7	ILEX X FOSTER	FOSTER HOLLY	1,5*	6'-8'	4'-6'	SINGLE LEADER - FULL	EVGR
0	3	MAGNOLIA GRANDIFLORA	LITTLE GEM	1.5*	6'-8"	4'-6"	SINGLE LEADER - FULL	EVGR
0	3	THUGA CANADENSIS	HEMLOCK	1.5"	6'-8"	4'-6"	SINGLE LEADER - FULL	EVGR
SHRUE	38							
SYMB	QUANT	SCIENTIFIC NAME	COMMON NAME	CAL.	HEIGHT	SPREAD	NOTES	
0	80	ABELIA GRANDIFLORA	GLOSSY ABELIA		18"-24"	18"-24"	FULL	EVGR
0	27	AZALEA ENCORE	AZALEA - AUTUMN		18"-24"	18"-24"	FULL- COLOR VARIETIES	EVGR
0	0	CHAMAECYPARIS OBTUSA	CHAMAECYPARIS		18"-24"	18"-24"	FULL	EVGR
0	20	EUONYMUS FORTUNEI	EUONYMUS		18"-24"	18"-24"	FULL - LARGE VARIETY	EVGR
0	0	ILEX CORNUTA - BURFO	BURFORD HOLLY		18"-24"	18"-24"	FULL	EVGR
•	11	LIGUSTRUM JAPONICUM	LIGUSTRUM		18" -24"	18"-24" "	FULL LARGE VARIETY	EVGR
0	29	LOROPETALUM CHINENSE	CHINESE FRINGE		18" -24"	18"-24" "	FULL LARGE VARIETY	EVGR
0	52	MYRICA CERIFERA	WAX MYRTLE		18" -24"	18"-24" '	FULL LARGE VARIETY	EVGR
8	30	VIBURNUM OBVATUM	VIBURNUM		18" -24"	18"-24" '	FULL LARGE VARIETY	EVGR



REVISIONS:

03.26.24 - CITY COM

LANDSCAPE BUFFER SCHEDULE
MAGNOLIA FOREST
SOOI FORESTVILE ROAD
RALEGH NC 27864

SCALE: AS NOTED DRAWN BY: PROJECT #

02-02-2024 SHEET L-8 OF XX BUFFER AREA - 7 340' LENGTH

PER SHEET 2.10 OPEN SPACE PLAN PER SHEET 2.11 TREE CONSERVATION AREA PLAN PER SHEET 4.0 AND 4.2 GRADING PLANS

- EXISTING AND DESIGN CONDITIONS

 THIS AREA IS PRIMARY OPEN SPACE
- THIS ARE IS 20' WIDE AND WILL DISTURBED DUE TO GRADING AND UTILITY INSTALLATION.

REQUIRED BUFFER PLANTING

- TYPE B1 BUFFER REQUIRED

- 2 DECIDUOUS SHADE TREES AND 2 LARGE EVER GREEN TREES
 2 DECIDUOUS UNDER STORY TREES AND 2 EVERGREEN UNDER STORY TREES
- 40 EVERGREEN SHRUBS

TOTAL BUFFER LENGTH = 340 LF

- TOTAL SHADE TREES 340' = (3.4) X 2 = 7 SHADE TREES
- TOTAL EVERGREEN TREES = (3.4) X 2 = 7 EVERGREEN TREES TOTAL UNDER STORY TREES = (3.4) X 2 = 7 UNDESTORY TREES
- TOTAL UNDER STORY EVERGREEN TREES (3.4) X 2 = 7 UN/ST EV.GR. TREES
- TOTAL EVERGREEN SHRUBS (3.4) X 40 = 136 SHRUBS

PROVIDED BUFFER PLANTING

- TOTAL SHADE TREES 7 SHADE TREES
 TOTAL EVERGREEN TREES 7 EVERGREEN TREES
 TOTAL EVERGREEN TREES 7 UNDER STORY TREES

 TOTAL EVERGREEN TREES 7 UNDER STORY TREES
 TOTAL EVERGREEN TREES 7 UNDER STORY TREES
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 TOTAL EVERGREEN TREES 7 UNDER STORY TREES 7 UNDER TOTAL UNDER STORY TREES - 7 UNDER STORY TREES
- TOTAL UNDER STORY EVERGREEN TREES 7 UN/ST EV.GR. TREES TOTAL EVERGREEN SHRUBS 140 SHRUBS

BUFFER AREA -8 755' LENGTH

PER SHEET 2.10 OPEN SPACE PLAN

PER SHEET 2.11 TREE CONSERVATION AREA PLAN

PER SHEET 4.0 AND 4.2 GRADING PLANS

- EXISTING AND DESIGN CONDITIONS
 THIS AREA IS PRIMARY, TERTIARY OPEN SPACE
- THIS AREA UNDISTURBED EXCEPT THE CONSTRUCTION OF A RETAINING WALL TO
- PROTECT THE WETLAND BUFFER

REQUIRED BUFFER PLANTING

NO BUFFER IS REQUIRED BECAUSE OF THE TREE CONSERVATION AREA.

PROVIDED BUFFER PLANTING NO PLANTING IS PROVIDED

BUFFER AREA - 9 430' LENGTH

PER SHEET 2.10 OPEN SPACE PLAN

PER SHEET 2.11 TREE CONSERVATION AREA PLAN

PER SHEET 4.0 AND 4.2 GRADING PLANS

EXISTING AND DESIGN CONDITIONS

- THIS AREA AN IS AND UN-DESIGNATED
- THIS ARE IS 20' WIDE AND WILL DISTURBED DUE TO GRADING AND UTILITY INSTALLATION.

- REQUIRED BUFFER PLANTING

 TYPE B1 BUFFER REQUIRED
- PER 100'
- 2 DECIDUOUS SHADE TREES AND 2 LARGE EVER GREEN TREES
- 2 DECIDUOUS UNDER STORY TREES AND 2 EVERGREEN UNDER STORY TREES
- 40 EVERGREEN SHRUBS
- TOTAL BUFFER LENGTH = 430 LF
- TOTAL SHADE TREES 430' = (4.3) X 2 = 9 SHADE TREES
- TOTAL EVERGREEN TREES = (4.3) X 2 = 9 EVERGREEN TREES
- TOTAL UNDER STORY TREES = (4.3) X 2 = 9 UNDER STORY TREES TOTAL UNDER STORY EVERGREEN TREES (4.3) X 2 = 7 UN/ST EV.GR. TREE
- TOTAL UNDER STORY EVERGREEN (4.3) X 40 = 172 SHRUBS

PROVIDED BUFFER PLANTING

- TOTAL SHADE TREES 9 SHADE TREES
- TOTAL EVERGREEN TREES 9 EVERGREEN TREES
- TOTAL UNDER STORY TREES 9 UNDER STORY TREES TOTAL UNDER STORY EVERGREEN TREES - 9 UN/ST EV.GR. TREES
- TOTAL EVERGREEN SHRUBS 172 SHRUBS

BUFFE	R AREA	- 7						
SHADE	TREES							
SYMB	QUANT	SCIENTIFIC NAME	COMMON NAME	CAL.	HEIGHT	SPREAD	NOTES	
0	3	ACER SACCARUM	SUGAR MAPLE	3*	10'-12'	6'-8'	SINGLE LEADER - FULL	DEC
8	4	QUERCUS ALBA	WHITE OAK	3"	10'-12'	6'-8'	SINGLE LEADER - FULL	DEC
0	3	ILEX x NELLIE STEVENS	NEL, STEV, HOLLY	3"	10'-12'	6'-8'	SINGLE LEADER - FULL	EVGR
Ö	4	PINUS TAEDA	LOBLOLLY PINE	3"	10'-12'	6'-8'	SINGLE LEADER - FULL	EVGR
UNDEF	RSTORY	TREES						
SYMB	QUANT	SCIENTIFIC NAME	COMMON NAME	CAL.	HEIGHT	SPREAD	NOTES	
0	4	LAGERSTOEMIA INDICA	CREPE MYRTLE	1.5"	6'-8'	4'-6'	3 STEM - FULL	DEC
8	3	CORNUS FLORIDA	DOGWOOD	1.5"	6'-8'	4'-6'	SINGLE LEADER - FULL	DEC
0	4	ILEX X FOSTER	FOSTER HOLLY	1.5"	6'-8'	4'-6'	SINGLE LEADER - FULL	EVGR
0	3	PRUNUS CAROLINIANA	CHERRY LAUREL	1.5"	6'-8"	4'-6"	SINGLE LEADER - FULL	EVGF
SHRU	BS							
SYMB	QUANT	SCIENTIFIC NAME	COMMON NAME	CAL.	HEIGHT	SPREAD	NOTES	
0	27	ABELIA GRANDIFLORA	GLOSSY ABELIA		18"-24"	18"-24"	FULL	EVGR
0	21	EUONYMUS FORTUNEI	EUONYMUS		18"-24"	18"-24"	FULL - LARGE VARIETY	EVGR
0	32	LOROPETALUM CHINENSE	CHINESE FRINGE		18" -24"	18"-24" "	FULL LARGE VARIETY	EVGR
0	35	MYRICA CERIFERA	WAX MYRTLE		18" -24"	18"-24" "	FULL LARGE VARIETY	EVGR

BUFFER AREA 9

SHADI	E TREES							
SYMB	QUANT	SCIENTIFIC NAME	COMMON NAME	CAL.	HEIGHT	SPREAD	NOTES	
(1)	3	PLATANUS OCCIDENTALIS	SYCAMORE	3"	10'-12'	6'-8'	SINGLE LEADER - FULL	DEC
0	6	QUERCUS RUBRA	RED OAK	3"	10'-12'	6'-8'	SINGLE LEADER - FULL	DEC
0	3	ILEX x NELLIE STEVENS	NEL, STEV, HOLLY	3"	10'-12'	6'-8'	SINGLE LEADER - FULL	EVGR
Ö	6	PINUS TAEDA	LOBLOLLY PINE	3"	10'-12'	6'-8'	SINGLE LEADER - FULL	EVGR
0	55	ABELIA GRANDIFLORA	GLOSSY ABELIA		18"-24"	18"-24"	FULL	EVGR
0	57	AZALEA ENCORE	AZALEA - AUTUMN		18"-24"	18"-24"	FULL- COLOR VARIETIES	EVGR
0	60	CHAMAECYPARIS OBTUSA	CHAMAECYPARIS		18"-24"	18"-24"	FULL	EVGR



REVISIONS:

03.26.24 - CITY COM

LANDSCAPE BUFFER SCHEDULE
MAGNOLIA FOREST
SOOI FORESTVILE ROAD
RALEGH NC 27864

SCALE: AS NOTED DRAWN BY: PROJECT #

02-02-2024 SHEET

L-9 OF XX BUFFER AREA - 10 919' LENGTH

PER SHEET 2.10 OPEN SPACE PLAN PER SHEET 2.11 TREE CONSERVATION AREA PLAN PER SHEET 4.0 AND 4.2 GRADING PLANS

EXISTING AND DESIGN CONDITIONS
 THIS AREA IS PRIMARY OPEN SPACE

THIS AREA UNDISTURBED EXCEPT THE CONSTRUCTION OF A RETAINING WALL TO PROTECT THE WETLAND BUFFER

REQUIRED BUFFER PLANTING

NO BUFFER IS REQUIRED BECAUSE OF THE TREE CONSERVATION AREA AND STREAM BUFFER.

PROVIDED BUFFER PLANTING

NO PLANTING IS PROVIDED

BUFFER AREA - 11 208' LENGTH

PER SHEET 2.10 OPEN SPACE PLAN PER SHEET 2.11 TREE CONSERVATION AREA PLAN PER SHEET 4.0 AND 4.2 GRADING PLANS

- EXISTING AND DESIGN CONDITIONS

 THIS AREA IS TERTIARY OPEN SPACE
- THIS ARE IS 20' WIDE AND WILL DISTURBED DUE TO GRADING AND UTILITY INSTALLATION.

REQUIRED BUFFER PLANTING

TYPE B1 BUFFER REQUIRED

- PER 100'
- ::
- 2 DECIDUOUS SHADE TREES AND 2 LARGE EVER GREEN TREES
 2 DECIDUOUS UNDER STORY TREES AND 2 EVERGREEN UNDER STORY TREES
- 40 EVERGREEN SHRUBS

- TOTAL BUFFER LENGTH = 208 LF

 TOTAL SHADE TREES = (2.08) X 2 = 4 SHADE TREES
- TOTAL EVERGREEN TREES = (2.08) X 2 = 4 EVERGREEN TREES
- TOTAL UNDER STORY TREES = (2.08) X 2 = 4 UNDER STORY TREES
- TOTAL UNDER STORY EVERGREEN TREES (2.08) X 2 = 4 UN/ST EV.GR. TREE
- TOTAL UNDER STORY EVERGREEN (2.08) X 40 = 83 SHRUBS

PROVIDED BUFFER PLANTING

- TOTAL SHADE TREES 4 SHADE TREES
- TOTAL EVERGREEN TREES 4 EVERGREEN TREES TOTAL UNDER STORY TREES - 4 UNDER STORY TREES
- TOTAL UNDER STORY EVERGREEN TREES 4 UN/ST EV. GR. TREES
- TOTAL EVERGREEN SHRUBS 83 SHRUBS

BUFFER AREA - 13 1901' LENGTH

PER SHEET 2.10 OPEN SPACE PLAN PER SHEET 2.11 TREE CONSERVATION AREA PLAN PER SHEET 4.0 AND 4.2 GRADING PLANS

EXISTING AND DESIGN CONDITIONS

THIS AREA IS PRIMARY, TERTIARY OPEN SPACE, AND PRIMARY, SECONDARY TCA THIS AREA UNDISTURBED EXCEPT THE CONSTRUCTION OF A RETAINING WALL TO PROTECT THE WETLAND BUFFER

REQUIRED BUFFER PLANTING

NO BUFFER IS REQUIRED BECAUSE OF THE TREE CONSERVATION AREA AND STREAM BUFFERS.

PROVIDED BUFFER PLANTING NO PLANTING IS PROVIDED

BUFFER AREA 11

BUFFE	ER AREA	11							
SHADE	E TREES								
SYMB	QUANT	SCIENTIFIC NAME	COMMON NAME	CAL.	HEIGHT	SPREAD	NOTES		
Ö	4	PINUS TAEDA	LOBLOLLY PINE	3"	10'-12'	6'-8'	SINGLE LEADER - FULL	EVGR	
0	4	MAGNOLIA GRAND.	SOUTHERN MAG	3"	10'-12'	6'-8'	SINGLE LEADER - FULL	EVGR	
UNDER STORY TREES									
SYMB	QUANT	SCIENTIFIC NAME	COMMON NAME	CAL.	HEIGHT	SPREAD	NOTES		
8	4	CORNUS FLORIDA	DOGWOOD	1.5*	6'-8'	4'-6'	SINGLE LEADER - FULL	DEC	
0	4	ILEX X FOSTER	FOSTER HOLLY	1.5"	6'-8'	4'-6'	SINGLE LEADER - FULL	EVGR	
SHRU	BS								
SYMB	QUANT	SCIENTIFIC NAME	COMMON NAME	CAL.	HEIGHT	SPREAD	NOTES		
0	25	ILEX CORNUTA - BURFO	BURFORD HOLLY		18"-24"	18"-24"	FULL	EVGR	
0	25	LIGUSTRUM JAPONICUM	LIGUSTRUM		18" -24"	18"-24"	FULL LARGE VARIETY	EVGR	
0	14	LOROPETALUM CHINENSE	CHINESE FRINGE		18" -24"	18"-24"	FULL LARGE VARIETY	EVGR	
0	19	MYRICA CERIFERA	WAX MYRTLE		18" -24"	18"-24"	FULL LARGE VARIETY	EVGR	

BUFFER AREA - 12 275' LENGTH

PER SHEET 2.10 OPEN SPACE PLAN PER SHEET 2.11 TREE CONSERVATION AREA PLAN PER SHEET 4.0 AND 4.2 GRADING PLANS

EXISTING AND DESIGN CONDITIONS

- THIS AREA AN IS AND UN-DESIGNATED
- THIS ARE IS 20' WIDE AND WILL DISTURBED DUE TO GRADING AND UTILITY INSTALLATION.

REQUIRED BUFFER PLANTING TYPE B1 BUFFER REQUIRED

- TYPE B1
 PER 100'
- 2 DECIDUOUS SHADE TREES AND 2 LARGE EVER GREEN TREES
- 2 DECIDUOUS UNDER STORY TREES AND 2 EVERGREEN UNDER STORY TREES
- 40 EVERGREEN SHRUBS

TOTAL BUFFER LENGTH = 275 LF

- TOTAL SHADE TREES = (2.75) X 2 = 6 SHADE TREES
- TOTAL EVERGREEN TREES = (2.75) X 2 = 6 EVERGREEN TREES
- TOTAL UNDER STORY TREES = (2.75) X 2 = 6 UNDER STORY TREES
 TOTAL UNDER STORY EVERGREEN TREES (2.75) X 2 = 6 UN/ST EV.GR. TREE
- TOTAL UNDER STORY EVERGREEN (2.75) X 40 = 110 SHRUBS

PROVIDED BUFFER PLANTING

430 LF

- TOTAL SHADE TREES 6 SHADE TREES
- TOTAL EVERGREEN TREES 6 EVERGREEN TREES TOTAL UNDER STORY TREES - 6 UNDER STORY TREES
- TOTAL UNDER STORY EVERGREEN TREES 6 UN/ST EV.GR. TREES
- TOTAL EVERGREEN SHRUBS 110 SHRUBS

BUFFER AREA 12

SHADE	TREES										
SYMB	QUANT	SCIENTIFIC NAME	COMMON NAME	CAL.	HEIGHT	SPREAD	NOTES				
0	6	QUERCUS RUBRA	RED OAK	3"	10'-12'	6'-8'	SINGLE LEADER - FULL	DEC			
0	6	ILEX x NELLIE STEVENS	NEL, STEV, HOLLY	3"	10'-12'	6'-8'	SINGLE LEADER - FULL	EVGR			
UNDER STORY TREES											
SYMB	QUANT	SCIENTIFIC NAME	COMMON NAME	CAL.	HEIGHT	SPREAD	NOTES				
0	6	PRUNUS CAROLINIANA	CHERRY LAUREL	1.5"	6'-8"	4'-6"	SINGLE LEADER - FULL	EVGR			
0	6	THUGA CANADENSIS	HEMLOCK	1.5"	6'-8"	4'-6"	SINGLE LEADER - FULL	EVGR			
SHRU	BS										
SYMB	QUANT	SCIENTIFIC NAME	COMMON NAME	CAL.	HEIGHT	SPREAD	NOTES				
0	45	ABELIA GRANDIFLORA	GLOSSY ABELIA		18"-24"	18"-24"	FULL	EVGR			
0	37	AZALEA ENCORE	AZALEA - AUTUMN		18"-24"	18"-24"	FULL- COLOR VARIETIES	EVGR			
0	28	EUONYMUS FORTUNEI	EUONYMUS		18"-24"	18"-24"	FULL - LARGE VARIETY	EVGR			



REVISIONS:

03.26.24 - CITY COMMENT

LANDSCAPE BUFFER SCHEDULE
MAGNOLIA FOREST
SOB FORESTMLE ROAD
RALEIGH NC 27864 SCALE:

AS NOTED DRAWN BY: PROJECT # 24015 02-02-2024

SHEET L-10 OF XX BUFFER AREA - 14 225' LENGTH

PER SHEET 2.10 OPEN SPACE PLAN PER SHEET 2.11 TREE CONSERVATION AREA PLAN PER SHEET 4.0 AND 4.2 GRADING PLANS

- EXISTING AND DESIGN CONDITIONS

 THIS AREA IS TERTIARY OPEN SPACE

 THIS AREA IS 20 WIDE AND WILL DISTURBED DUE TO GRADING AND UTILITY INSTALLATION.

- REQUIRED BUFFER PLANTING

 TYPE B1 BUFFER REQUIRED

 PER 100'

 2 DECIDIOUS SHADE TREES AND 2 LARGE EVER GREEN TREES

 2 DECIDIOUS UNDER STORY TREES AND 2 EVERGREEN UNDER STORY TREES
- 40 EVERGREEN SHRUBS
- TOTAL BUFFER LENGTH = 225 LF

 TOTAL SHADE TREES = (2.25) X 2 = 5 SHADE TREES
- TOTAL EVERGREEN TREES = (2.25) X 2 = 5 EVERGREEN TREES
- TOTAL UNDER STORY TREES = (2.25) X 2 = 5 UNDER STORY TREES

 TOTAL UNDER STORY EVERGREEN TREES (2.25) X 2 = 5 UNIST EV.GR. TREE

 TOTAL UNDER STORY EVERGREEN (2.25) X 40 = 90 SHRUBS

PROVIDED BUFFER PLANTING

- 225 LF
 TOTAL SHADE TREES 5 SHADE TREES
 TOTAL SHADE TREES 5 EVERGRE
- TOTAL EVERGREEN TREES 5 SHADE INCES
 TOTAL EVERGREEN TREES 5 EVERGREEN TREES
 TOTAL UNDER STORY TREES 5 UNDER STORY TREES
 TOTAL UNDER STORY EVERGREEN TREES 5 UN/ST EV.GR. TREES
- TOTAL EVERGREEN SHRUBS 90 SHRUBS

BUFFER AREA 14

BUFFE	K AKEA	14							
SHADE	TREES								
SYMB	QUANT	SCIENTIFIC NAME	COMMON NAME	CAL.	HEIGHT	SPREAD	NOTES		
8	5	QUERCUS ALBA	WHITE OAK	3"	10'-12'	6'-8'	SINGLE LEADER - FULL	DEC	
0	5	PINUS TAEDA	LOBLOLLY PINE	3"	10'-12'	6'-8'	SINGLE LEADER - FULL	EVGF	
UNDER STORY TREES									
SYMB	QUANT	SCIENTIFIC NAME	COMMON NAME	CAL.	HEIGHT	SPREAD	NOTES		
0	5	LAGERSTOEMIA INDICA	CREPE MYRTLE	1.5"	6'-8'	4'-6'	3 STEM - FULL	DEC	
0	5	MAGNOLIA GRANDIFLORA	LITTLE GEM	1.5"	6'-8"	4'-6"	SINGLE LEADER - FULL	EVGI	
SHRUBS									
SYMB	QUANT	SCIENTIFIC NAME	COMMON NAME	CAL.	HEIGHT	SPREAD	NOTES		
0	30	ILEX CORNUTA - BURFO	BURFORD HOLLY		18"-24"	18"-24"	FULL	EVGR	
0	30	LIGUSTRUM JAPONICUM	LIGUSTRUM		18" -24"	18"-24"	FULL LARGE VARIETY	EVGR	
90	30	VIBURNUM OBVATUM	VIBURNUM		18" -24"	18"-24"	FULL LARGE VARIETY	EVGR	



REVISIONS:


03.26.24 - CITY COMMEN

LANDSCAPE BUFFER SCHEDULE
MAGNOLIA FOREST
Sol FORESYNLLE ROAD
RALEGH NC 27:004

SCALE: AS NOTED DRAWN BY:

PROJECT # 24015 DATE: 02-02-2024 SHEET

> L-11 OF XX

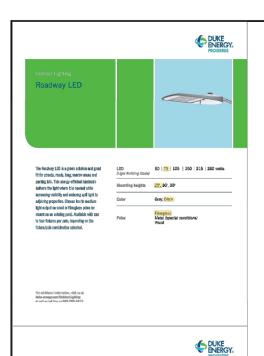



LED 105 IESNA Type II (forg oval) LED 150 IESNA Type III (medium ova LED 215 IESNA Type III (medium ova							
				Type II			
				light distribution pattern			
LED 280	IESNA Type III (med/um ove	a)	B3-U0-G4				
Color temperature Warre-up and res	s: 4,000K trike time: instant on (no warm	-up or nestri	in time)				
Poles availab	le:	recursing a	wigor	Coler			
Fibergless		28, 30, 3	10'	Gray			
Fiberglass		25, 80', 8	16	Black (sadd) throat coat)			
Wood		29, 80, 8	15'	Standard			
Metal (speciel conditions)*		20, 30, 3	16	Quay			
Features				Benefits			
Little or an Install	lation cost			Freez up capital for other projects			
Design services b	y lighting professionals include	ıd		Meets industry standards and lighting ordinances			
Maintenanoe incl	usled			aliminates high and unexpected repair bits			
Electricity Include	ed			Less expansive than makered service			
Wegrapity Include	d			Worsy-free			
One low manthly cost on your electric bill				Convenience and savings for you			
wire over manuality				Provides hassle-free installation and service			
Turnkey operation	1						



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Rev A	04/06/22	LED 70w Roadway	N)	
REV#	DATE	REVISION	BY	



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	Raleigh	, NC				
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Designed byD	EP LIGHTING	SOLUTION	DNS			
leviewed by	T. Ferguson	Senie	1" =	1501		
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be a select Man			66.4	. 1	DE 1	