Preliminary Subdivision Application







INSTRUCTIONS: This form is used when submitting a Preliminary Subdivision (UDO Section 10.2.5). Please check the appropriate review type and include the plan checklist document. Please email all documents and your preliminary subdivision plans to SiteReview@raleighnc.gov.

DEVELOPMENT OPTIONS (UDO Chapter 2)									
Х	X Conventional Subdivision			Compact Development			Conservation Development		
	Cottage	Court		Fla	g lot		Frequent Trans	it D	evelopment Option
NOTE: S	ubdivisions n	nay require City	Council app	oroval if l	ocated in a H	istor	ric Overlay District.		
			GEN	IERAL II	NFORMATIO	N			
Scoping/s	ketch plan c	ase number(s): I	N/A						
Development name (subject to approval): Modera Capital City									
Property Address(es): 7022 Capital Blvd									
Recorded Deed PIN(s): 1727838941									
Building	Building type(s):		Detached House		ed House		Townhouse	Х	Apartment
Genei	al Building	Mixed Use	Building	Civic E	Building		Open Lot		Tiny House
							OPER INFORMATION	NC	
Current P	roperty Owr	ner(s) Names: E	thel Limit	ed Partr	ership; Tho	mp	son, Northwood		
Company:	Ethel Limit	ed Partnership)		Title: N/A				
Address: 1517 Caswell Street Raleigh, NC 27608; 442 E Main St Clayton NC 27520									
Phone #:			Ema	Email:					
Applicant	Name (If dif	ferent from ow	ner. See "\	who can	apply" in ins	stru	ctions):		
Relationsh	Relationship to owner: Lessee or contract purchaser X Owner's authorized agent Easement holder					ent holder			
Company: McAdams				Address: 621 Hillsborough Street, Suite 500 Raleigh, NC 27603					
Phone #: 919.395.2272				Email: pike@mcadamsco.com					
NOTE: ple	ase attach _l	ourchase agree	ment or co	ontract, I	ease or ease	eme	nt when submitting	រ thi	is form.
Develope	Contact Na	mes: Lewis Ho	bbs						
Company: MCRT SFR Investments LLC					Title: VP of	De	velopment		
Address: 702 Oberlin Road, Suite 420									
Phone #: 919.589.1993			Emai	Email: Ihobbs@MCRTrust.com					
			1						

	MENT TYPE + SITE DA	TE TABLE – ZON	IING INFORMATION		
Gross site acreage: 33.51 AC.					
Zoning districts (if more than on CX-5-CU	e, provide acreage of ea	ach):			
Overlay district(s): SHOD-2	Inside City Limits?	X Yes X No	Historic District/Landmark: N/A X		
Conditional Use District (CUD) Case # Z- N/A	Board of Adjustment BOA- N/A	t Case #	Design Alternate Case # DA- N/A		
	STORMWATER	R INFORMATION			
Imperious Area on Parcel(s): Existing (sf) 0 Propose	ed total (sf) <u>288,126</u>	Impervious Area for Compliance (includes right-of-way): Existing (sf) 0 Proposed total (sf) 332,645			
	NUMBER OF LO	TS AND DENSIT	Υ		
# of Detached House Lots: N/A	# of Attached Ho	use Lots: N/A	# of Townhouse Lots: N/A		
# of Tiny House Lots: N/A	# of Open Lots: 2	# of Other Lots (Apartment, General, Mixed Use, Civic):			
Total # of Lots: 2	Total # Dwelling Units:				
Proposed density for each zoning	ng district (UDO 1.5.2.F):	: CX-5 (4.5 units	s/acre)		
landowner, a lessee or person ho	Stat. § 160D-403(a)), app lding an option or contrac	t to purchase or le	opment approvals may be made by the ase land, or an authorized agent of the		
easement. By submitting this application, the the persons authorized by state la undersigned also acknowledges t undersigned understands that demisrepresentations made in securior.	undersigned applicant active (N.C.G.S. 160D-403(a hat the information and size) approvals are sized the development appropriate the development appropriate appropriate the development appropriate ap	cknowledges that t)) to make this app tatements made in subject to revocation			
	ed in all respects in accor	rdance with the pla	ns and specifications submitted herewith,		
placed on hold at the request of the respond to comments or provide a	ne applicant for a period c additional information req is <u>discontinue</u> d and a nev	of six consecutive ruested by the City wapplication is rec	143-755(b1), if this permit application is months or more, or if the applicant fails to for a period of six consecutive months or juired to proceed and the development be new application.		
Signature:	61AE513BA543462		Date: 9/8/2023 3:40 P		
Printed Name:	Lewis Hobbs				
Signature:			Date:		
Printed Name:					

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DocuSign Envelope ID: 0D700E99-E6CE-4917-8355-258653F37138


By submitting this application, the undersigned applicant acknowledges that they are either the property owner or one of the persons authorized by state law (N.C.G.S. 160D-403(a)) to make this application, as specified in the application. The undersigned also acknowledges that the information and statements made in the application are correct and the undersigned understands that development approvals are subject to revocation for false statements or misrepresentations made in securing the development approval, pursuant to N.C. Gen. Stat. § 160D-403(f).

The undersigned indicates that the property owner(s) is aware of this application and that the proposed project described in this application will be maintained in all respects in accordance with the plans and specifications submitted herewith, and in accordance with the provisions and regulations of the City of Raleigh Unified Development Ordinance.

The undersigned hereby acknowledges that, pursuant to state law (N.C.G.S. 143-755(b1), if this permit application is placed on hold at the request of the applicant for a period of six consecutive months or more, or if the applicant fails to respond to comments or provide additional information requested by the City for a period of six consecutive months or more, then the application review is discontinued and a new application is required to proceed and the development regulations in effect at the time permit processing is resumed shall apply to the new application. 9/8/2023 | 3:40 PM EDT Printed Name: Signature:

Printed Name:

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VICINITY MAP

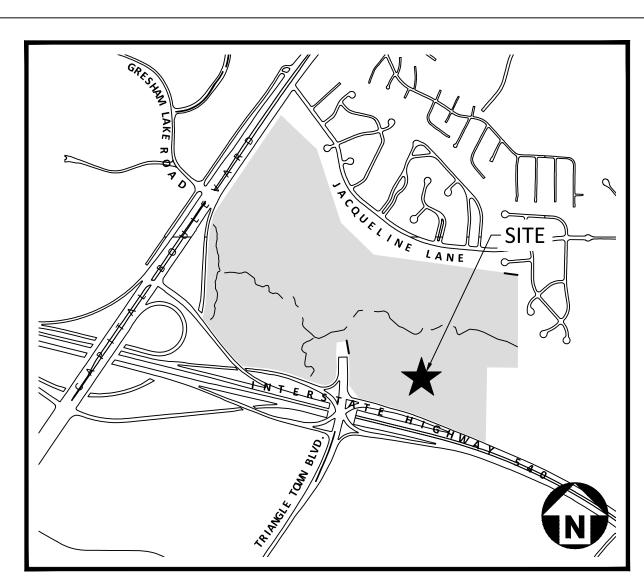N.T.S.

MODERA CAPITAL

7022 CAPITAL BOULEVARD RALEIGH, NORTH CAROLINA 27616

PRELIMINARY SUBDIVISION PLAN

CASE #: SUB-XXXX-2023 PROJECT NUMBER: MCR-23004 DATE: SEPTEMBER 8, 2023

SITE ADDRESS/PIN NUMBER	7022 CAPITAL BOULEVARD, RA	7022 CAPITAL BOULEVARD, RALEIGH, NORTH CAROLINA 27616 / PIN# 1727838941					
EXISTING ZONING:	CX-5-CU (COMMERCIAL MIXED	USE)					
EXISTING USE:	VACANT						
PROPOSED USE:	2 OPEN LOTS						
OVERLAY DISTRICT:	SHOD-2 OVERLAY DISTRICT						
BLOCK PERIMETER:	MAX ALLOWABLE: PROPOSED/EXISTING:						
WATER SUPPLY WATERSHED:	LOWER NEUSE RIVER						
FLOODPLAIN/FIRM PANEL:	N/A						
SITE AREA:	GROSS SITE AREA: RIGHT-OF-WAY DEDICATION: PROPOSED LOT 1 AREA: PROPOSED LOT 2 AREA: NET SITE AREA:		33.51 ACRES OR 1,459,699 SF 1.02 ACRES OR 44,519 SF. 19.95 ACRES OR 870,180 SF. 12.26 ACRES OR 533,853 SF. 32.49 ACRES OR 1,415,180 SF				
TREE CONSERVATION	REQUIRED: PROPOSED:		141,570 SF (10.00% NET SITE AREA) 266,152 SF (18.23% NET SITE AREA)				
IMPERVIOUS AREA	EXISTING: PROPOSED: FUTURE: DELTA:	0.00 AC. (0.0 2.92 AC. (12 4.72 AC. (20 +7.64 AC. (3	6,989 SF) 5,656 SF)				
BUILDING / PARKING SETBACKS	PRIMARY STREET: SIDE STREET: SIDE LOT LINE: REAR LOT LINE:	BUILDING SETBACK 10' 10' 5' 20'	PARKING SETBACK 10' 10' 0' 3'				
LOT DIMENSIONS	WIDTH: BUILDING COVERAGE:	LOT 1 ±500' 0%	LOT 2 ±400' 0%				

SITE DATA					
SITE ADDRESS:	7022 CAPITAL BOULEVARD, RALEIGH, NORTH CAROLINA				
PARCEL PIN NUMBER:	1727838941				
EXISTING ZONING:	CX-5-CU				
OVERLAY DISTRICT:	SHOD-2				
WATERSHED:	NEUSE RIVER BASIN				
FLOODPLAIN/FIRM PANEL:	MAP NUMBER 3720172700K/ PANEL 1727				
SITE AREA:	GROSS SITE AREA: 33.51 AC. (1,459,699 SF.); NET SITE AREA: 32.49 AC. (1,415,180 S				
PROPOSED DWELLING UNITS:	370 UNITS				
IMPERVIOUS AREA:	EXISTING IMPERVIOUS: 0.0 AC PROPOSED IMPERVIOUS: 7.66 AC (333,623 SF)				

	IMPERVIOUS AREA T	BLE		
BLOCK PERIMETER:		LOT 1	LOT 2	ROW
BLOCKS (UDO SEC. 8.3.2.A.1 vi).		1011	LOTZ	KOW
vi. THE CREATION (ON THE PROPERTY TO BE DEVELOPED) OR CONTINUATION (ON	ACREAGE	19.98 AC.	12.26 AC.	1.02 AC
AN ADJACENT PROPERTY) OF ANY NEW STREET OR STREET STUB WOULD BE OBSTRUCTED BY ANY OF THE FOLLOWING: a) EXISTING IMPROVEMENTS WHERE THE VALUE OF SUCH IMPROVEMENTS IS MORE THAN THE LAND VALUE OF THE PARCEL ON WHICH THE	IMPERVIOUS AREA	0.95 AC.	1.97 AC.	1.02 AC
IMPROVEMENTS ARE LOCATED; b) RAILROAD, OR CONTROLLED ACCESS HIGHWAY; c) WATERCOURSE THAT HAS ONE (1) SQUARE MILE OF DRAINAGE AREA OR MORE; OR	FUTURE IMPERVIOUS AREA	1.27 AC.	3.45 AC.	0.00 AC
d) PREVIOUSLY ESTABLISHED TREE CONSERVATION AREA, OPEN SPACE OR				

LOT DATA TABLE

RIGHT-OF-WAY OBSTRUCTION NOTES

- 1. STREET, LANE, AND SIDEWALK CLOSURES OR DETOURS: PRIOR TO ANY WORK THAT IMPACTS THE RIGHT-OF-WAY OR CLOSING OF ANY STREET, LANE, OR SIDEWALK, THE CONTRACTOR MUST APPLY FOR A PERMIT WITH RIGHT-OF-WAY SERVICES.
- 2. A PERMIT REQUEST WITH A TRAFFIC CONTROL AND/OR PEDESTRIAN PLAN SHALL BE SUBMITTED TO <u>rightofwayservices@raleighnc.gov</u> AT <u>www.raleighnc.gov</u> KEYWORD "RIGHT-OF-WAY SERVICES.
- 3. PRIOR TO THE START OF WORK, THE CLIENT SHALL SCHEDULE A PRE-CONSTRUCTION MEETING WITH THE ENGINEERING INSPECTIONS COORDINATOR TO REVIEW THE SPECIFIC COMPONENTS OF THE APPROVED PLAN, AND ENSURE ALL PERMITS ARE 4. THE CITY OF RALEIGH REQUIRES AN APPROVED RIGHT-OF-WAY OBSTRUCTION PERMIT FOR WORK ON ANY PUBLIC STREET OR
- SIDEWALK AND NCDOT ROAD WITHIN RALEIGH'S JURISDICTION. 5. ALL TRAFFIC CONTROL SIGNAGE AND PRACTICES SHALL ADHERE TO THE MANUAL ON UNIFORM TRAFFIC CONTROL. AND THE
- LATEST EDITION OF THE NCDOT "STANDARD SPECIFICATION FOR ROADWAY STRUCTURES". NCDOT "ROADWAY STANDARD DRAWING MANUAL", AND THE NCDOT SUPPLEMENT TO THE MUTCD.
- 6. ALL PUBLIC SIDEWALKS MUST BE ACCESSIBLE TO PEDESTRIANS WHO ARE VISUALLY IMPAIRED AND/OR PEOPLE WITH MOBILITY CONCERNS. EXISTING AND ALTERNATIVE PEDESTRIAN ROUTES DURING CONSTRUCTION SHALL BE REQUIRED TO BE COMPLIANT WITH THE PUBLIC RIGHTS OF WAY ACCESSIBILITY GUIDELINES (PROWAG), THE ADA STANDARDS FOR ACCESSIBLE DESIGN AND THE MANUAL ON UNIFORM TRAFFIC CONTROL DEVICES (MUTCD).
- 7. ALL PERMITS MUST BE AVAILABLE AND VISIBLE ON SITE DURING THE OPERATION.

ZONING CONDITIONS 2-7-22: 6700. 7022 CAPITAL BOULEVARD. ON THE NORTHEAST CORNER OF THE INTERSECTION OF CAPITAL BOULEVARD (US-1) AND I-540, CONSISTING OF WAKE COUNTY PINS 1727742742, AND 1727838941. APPROXIMATELY 121.47 ACRES REZONED TO COMMERCIAL MIXED USE-5 TORIES- CONDITIONAL USE W/SPECIAL HIGHWAY OVERLAY DISTRICT-2 (CX-5-CU W/SHOD-2). THE PORTION OF THE SUBJECT PROPERTY THAT IS NORTH OF PERRY CREEK, AND ONLY THAT PORTION, SHALL BE SUBJECT TO A. PERMITTED RESIDENTIAL USES SHALL BE LIMITED TO SINGLE-UNIT LIVING, TWO-UNIT LIVING, MULTI-UNIT LIVING AND ACCESSORY B. THE APARTMENT BUILDING TYPE SHALL BE PROHIBITED. :. THE MAXIMUM RESIDENTIAL BUILDING HEIGHT SHALL BE THREE (3) STORIES OR 50 FEET (50'). D. NON-RESIDENTIAL USES SHALL ONLY BE PERMITTED WITHIN 500 FEET OF THE CAPITAL BOULEVARD (U.S. 1) RIGHT-OF-WAY. THE FOLLOWING ADDITIONAL STANDARDS SHALL APPLY WITHIN THIS 500 FT ZONE: I. THE MAXIMUM BUILDING HEIGHT SHALL BE 4 STORIES OR 68 FEET. II. THE MAXIMUM GROUND STORY FLOOR PLATE AREA FOR ANY NON-RESIDENTIAL BUILDING TYPE SHALL BE 24,000 SQUARE FEET, EXCLUDING AREA USED FOR STRUCTURED PARKING. ESPONSE: THE SUBDIVISION IS TO THE SOUTH OF PERRY CREEK AND THUS DOES NOT APPLY TO THIS DEVELOPMENT. 2. NON-RESIDENTIAL USES FOR THE ENTIRE PROPERTY SHALL BE LIMITED TO A MAXIMUM OF 250,000 SQUARE FEET. RESPONSE: NO NON-RESIDENTIAL USES ARE PROPOSED WITH THIS SUBDIVISION. THE 100-YEAR FLOODPLAIN SHALL REMAIN UNDISTURBED FROM ADDED FILL EXCEPT FOR THE INSTALLATION OF STREETS, SIDEWALKS, UTILITIES, STORMWATER CONVEYANCES, GREENWAY TRAILS, FENCING, OR OTHER PUBLIC IMPROVEMENTS. RESPONSE: NO FILL IS PROPOSED WITHIN THE FLOODPLAIN EXCEPT FOR THE ABOVE ALLOWED IMPROVEMENTS. I. DEVELOPMENT OF 7022 CAPITAL BLVD (PARCEL NO. 1727838941: DEED BOOK 014631 / PAGE 01926) SHALL A INCLUDE A PUBLIC STREET CONNECTING TRIANGLE TOWN BOULEVARD TO THE NORTHERN PROPERTY LINE TO ALIGN WITH DRAPER ROAD AND A PUBLIC STREET CONNECTING TRIANGLE TOWN BOLL EVARD TO THE FASTERN PROPERTY LINE TO ALIGN WITH CREEKWATER DRIVE. THE APPROXIMATE LOCATIONS OF THE DRAPER ROAD AND CREEKWATER DRIVE CONNECTIONS ARE SHOWN IN THE ATTACHED EXHIBIT A. THESE STREET CONNECTIONS SHALL BE COMPLETED IN THE DEVELOPMENT PHASE IN WHICH THEY ARE LOCATED, THE FINAL LOCATIONS AND ALIGNMENT OF THE STREET CONNECTIONS SHALL BE DETERMINED AT THE SITE PLAN STAGE. RESPONSE: A PUBLIC STREET CONNECTING TRIANGLE TOWN BLVD WILL BE PROPOSED PENDING THE DEVELOPMENT OF THE REMAINING PARCELS WITHIN THE PROPERTY

5. A MINIMUM TEN FT (10') WIDE PEDESTRIAN AND BICYCLE MULTI-USE CROSSING OF PERRY CREEK SHALL BE PROVIDED ON 7022 CAPITAL BLVD (PARCEL NO. 1727838941; DEED BOOK 014631 /PAGE 01926). THIS PEDESTRIAN AND BICYCLE MULTI-USE CROSSING SHALL BE COMPLETED IN THE DEVELOPMENT PHASE IN WHICH IT IS LOCATED. THE FINAL LOCATION AND ALIGNMENT OF THE CROSSING SHALL BE DETERMINED AT THE SITE PLAN STAGE. RESPONSE: A 10' WIDE MULTI-USE PATH WILL BE PROPOSED PENDING THE DEVELOPMENT OF THE PARCEL TO THE NORTH OF PERRY 6. A LANDSCAPE BUFFER WITH A MINIMUM WIDTH OF FIFTY FT (50') MEASURED FROM THE PROPERTY LINE ABUTTING US-1 AND I-540 SHALL BE PROVIDED. THE LANDSCAPE BUFFER SHALL BE PLANTED ACCORDING TO THE PLANTING REQUIREMENTS FOR THE SHOD-1 PROTECTIVE YARD (UDO SECTION 5.3.1.F) UNLESS ESTABLISHED AS TREE CONSERVATION AREA IN ACCORDANCE WITH UDO ARTICLE 9.1. EXISTING VEGETATION AND THE PLANTINGS ALREADY REQUIRED BY THE SHOD-2 PROTECTIVE YARD, WHERE APPLICABLE, MAY BE CREDITED TOWARDS THE PLANTING REQUIREMENTS. THE LANDSCAPE BUFFER MAY INCLUDE GREENWAYS, OTHER PEDESTRIAN TRAILS, VEHICLE ACCESS, WALLS, BERMS, EASEMENTS INCLUDING SLOPE OR DRAINAGE EASEMENTS, UTILITIES, AND OTHER ENCROACHMENTS

AS PERMITTED BY THE UDO. NEW PLANTINGS SHALL ONLY BE REQUIRED WITHIN NORTH CAROLINA DEPARTMENT OF TRANSPORTATION

SLOPE OR DRAINAGE EASEMENTS IF PERMITTED BY THE NORTH CAROLINA DEPARTMENT OF TRANSPORTATION. RESPONSE: A 50' WIDE LANDSCAPE BUFFER IS PROPOSED WHERE TREE CONSERVATION IS NOT PROPOSED.

> TOTAL LIMITS OF DISTURBANCE = 16.50 AC. SOLID WASTE INSPECTION STATEMENT: THE DEVELOPER ACKNOWLEDGES THAT THEY HAVE REVIEWED AND ARE IN COMPLIANCE WITH THE REQUIREMENTS SET FORTH IN THE SOLID WASTE DESIGN MANUAL.

THE SOLID WASTE REMOVAL FOR THIS PROJECT WILL BE HANDLED BY PRIVATE SERVICES.

THE CITY OF RALEIGH SOLID WASTE SERVICES (SWS) WILL NOT SERVICE THIS DESIGN.

CROSS-ACCESS ROSS-ACCESS STANDARDS (UDO 8.3.4.D). TC-6-19, 8.3.4.D.5.b.iii "THE CREATION (ON THE PROPERTY TO BE DEVELOPED) OR CONTINUATION (ON AN ADJACENT PROPERTY) OF ANY CROSS ACCESS DRIVEWAY OR DRIVEWAY STUB WOULD BE OBSTRUCTED BY ANY OF THE FOLLOWING: ... iii. STEEP SLOPES IN EXCESS OF 25% WITHING 10 FEET OF THE PROPERTY LINE. PER TC-6-19, 8.3.4 D.5 b.iii- THE PROJECT SITE IS EXEMPT FROM CROSS-ACCESS (PIN: 1746324494) WHICH EXCEEDS 25% SLOPE WITHIN 10' OF THE PROPERTY LINE.

SHEET INDEX

OVERALL ROADWAY DEMOLITION PLAN

OVERALL SITE PLAN C3.00 OVERALL GRADING PLAN

SEWER OUTFALL CONNECTION

SITE DETAILS SITE DETAILS SITE DETAILS

SANITARY SEWER DETAILS

STORMWATER CONTROL MEASURE A DETAILS C9.02 STORMWATER CONTROL MEASURE B PLAN VIEW

STORMWATER CONTROL MEASURE C DETAILS

L5.00 LANDSCAPE PLAN

TREE CONSERVATION PLAN

PROJECT NOTES **OVERALL EXISTING CONDITIONS PLAN** OVERALL DEMOLITION PLAN

OVERALL UTILITY PLAN OFFSITE ROADWAY IMPROVEMENTS

C8.03 STORM DETAILS STORM DETAILS C8.05 WATER DETAILS

SANITARY SEWER DETAILS

STORMWATER CONTROL MEASURE B DETAILS

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ADAM PIKE, PE pike@mcadamsco.com PHONE: 919. 823. 4300

CONTACT

CLIENT

MILL CREEK RESIDENTIAL 702 OBERLIN RD, SUITE 420 RALEIGH, NC 27605 PHONE: 704. 833. 8415



PROJECT DIRECTORY



REVISIONS

PRELIMINARY SUBDIVISION PLAN FOR: MODERA CAPITAL CITY

RALEIGH, NORTH CAROLINA

PROJECT NUMBER: MCR-23004



CONTRACTOR SHALL NOTIFY "NC811" (811) OR (1-800-632-4949) AT LEAST 3 FULL BUSINESS DAYS PRIOR TO BEGINNING CONSTRUCTION OR EXCAVATION TO HAVE EXISTING UTILITIES LOCATED. CONTRACTOR SHALL CONTACT ANY LOCAL UTILITIES THAT PROVIDE THEIR OWN LOCATOR SERVICES INDEPENDENT OF "NC811". REPORT ANY DISCREPANCIES TO THE ENGINEER IMMEDIATELY.

APPROVAL BY THE CITY OF RALEIGH.

ALL CONSTRUCTION SHALL BE IN ACCORDANCE WITH

THE CURRENT CITY OF RALEIGH AND NCDOT

CONSTRUCTION STANDARDS

(WHERE APPLICABLE) ENGINEERING DESIGN AND

NO TEMPORARY OR PERMANENT ENCROACHMENTS (INCLUDING BUT NOT LIMITED TO CLEARING, GRADING,

FENCING, AND THE INSTALLATION OF RETAINING WALLS

OR OTHER STRUCTURES) ARE PERMITTED WITHIN THE

GREENWAY EASEMENT AREA WITHOUT PRIOR

SITE PLAN NOTES

- 1. NON-ALLEY LOADED DRIVEWAYS MAY INTERSECT A STREET NO CLOSER THAN 20 FEET FROM THE INTERSECTION OF TWO STREET RIGHT-OF-WAYS. THE MINIMUM CORNER CLEARANCE FROM CURBLINE OR EDGE OF PAVEMENT OF INTERSECTING STREETS SHALL BE AT LEAST 20 FEET FROM THE POINT OF TANGENCY OF THE RADIUS OF CURVATURE. OR 20 FEET FROM THE INTERSECTION OF RIGHT-OF-WAY LINES, WHICH EVER IS GREATER. THE RADIUS OF THE DRIVEWAY SHALL NOT ENCROACH ON THE MINIMUM CORNER CLEARANCE. REFER TO SECTION 6.5 OF THE LATEST VERSION OF THE RALEIGH STREET DESIGN MANUAL FOR ADDITIONAL
- 2. RIGHT-OF-WAY SHALL BE CLEARED AND GRUBBED WITHIN 50' OF ALL MINOR RESIDENTIAL, RESIDENTIAL, AND RESIDENTIAL COLLECTOR INTERSECTIONS. THE FULL LENGTH OF THE RIGHT-OF-WAY SHALL BE CLEARED AND GRADED ALONG ALL MAJOR, MINOR, & SENSITIVE AREA THOROUGHFARES.
- 3. WITHIN THE AREA DEFINED SIGHT TRIANGLES SHOWN ON THESE PLANS, THERE SHALL BE NO SIGHT OBSTRUCTING OR PARTLY OBSTRUCTING WALL, FENCE, SIGN, FOLIAGE BERMS, OR PARKED VEHICLES BETWEEN THE HEIGHTS OF 24 INCHES AND 8 FEET ABOVE THE CURB LINE ELEVATION OR THE NEAREST TRAVEL WAY IF NO CURB LINE EXISTS. REFER TO SECTION 6.12 OF THE LATEST VERSION OF THE RALEIGH STREET DESIGN MANUAL FOR ADDITIONAL DETAILS.
- 4. MULTIWAY STOP CONTROL WILL NOT BE USED AT ANY PUBLIC STREET INTERSECTION WITHOUT AN ENGINEERING STUDY TO PROVIDE DATA TO CITY OF RALEIGH TRANSPORTATION DIVISION THAT THE MULTIWAY STOP INSTALLATION WARRANTS CAN BE MET AND ORDINANCED BY CITY COUNCIL APPROVAL.
- 5. ALL CONSTRUCTION SHALL CONFORM TO THE LATEST CITY OF RALEIGH AND/OR NCDOT STANDARDS AND SPECIFICATIONS AS
- 6. ALL DIMENSIONS SHOWN ON SITE PLAN ARE MEASURED TO FACE OF CURB UNLESS OTHERWISE NOTED.

AND TO THE SATISFACTION OF THE OWNER, BY THE CONTRACTOR RESPONSIBLE FOR THE DAMAGE.

- 7. CONTRACTOR SHALL MAINTAIN AN "AS-BUILT" SET OF DRAWINGS TO RECORD THE EXACT LOCATION OF ALL PIPING PRIOR TO CONCEALMENT. DRAWINGS SHALL BE GIVEN TO THE ENGINEER UPON COMPLETION OF THE PROJECT WITH A COPY OF THE
- TRANSMITTAL LETTER TO THE OWNER. 8. EXISTING IMPROVEMENTS DAMAGED DURING CONSTRUCTION SHALL BE REPLACED/RESTORED TO THEIR ORIGINAL CONDITION
- 9. THE CONTRACTOR SHALL NOTE THAT THE DRAWINGS MAY NOT SHOW EVERY OFFSET, TRANSITION, FITTING, ETC. THAT MAY BE REQUIRED. THE CONTRACTOR SHALL INSTALL SUCH STANDARD APPURTENANCES AS REQUIRED TO CLOSELY FOLLOW THE GRADES
- AND ALIGNMENTS DEPICTED ON THE PLANS. 10. CONTRACTOR SHALL NOTIFY "NC811" (811) OR (1-800-632-4949) AT LEAST 3 FULL BUSINESS DAYS PRIOR TO BEGINNING CONSTRUCTION OR EXCAVATION TO HAVE EXISTING UTILITIES LOCATED. CONTRACTOR SHALL CONTACT ANY LOCAL UTILITIES
- 11. CONTRACTOR IS RESPONSIBLE FOR COORDINATING CONSTRUCTION ACTIVITIES WITH THE APPROPRIATE UTILITY COMPANIES FOR ANY REQUIRED RELOCATIONS (I.E. POWER POLES, TELEPHONE PEDESTALS, WATER METERS, ETC.).

THAT PROVIDE THEIR OWN LOCATOR SERVICES INDEPENDENT OF "NC811". REPORT ANY DISCREPANCIES TO THE ENGINEER

- 12. PRIOR TO BEGINNING CONSTRUCTION BEYOND EROSION CONTROL MEASURES, THE GENERAL CONTRACTOR SHALL SCHEDULE AND ATTEND A PRE-CONSTRUCTION CONFERENCE WITH THE CITY OF RALEIGH PUBLIC WORKS DEPARTMENT (919) 996-2409, AND A REPRESENTATIVE OF THE ENGINEER AND OWNER. THE PURPOSE OF THIS MEETING IS TO REVIEW THE SPECIFIC COMPONENTS OF THE PLAN AND OPERATION OF THE FACILITIES DURING CONSTRUCTION.
- 13. ALL DIMENSIONS AND GRADES SHOWN ON THE PLANS SHALL BE FIELD VERIFIED BY THE CONTRACTOR PRIOR TO CONSTRUCTION. CONTRACTOR SHALL NOTIFY THE ENGINEER IF ANY DISCREPANCIES EXIST PRIOR TO PROCEEDING WITH CONSTRUCTION, FOR NECESSARY PLAN OR GRADE CHANGES. NO EXTRA COMPENSATION SHALL BE PAID TO CONTRACTOR FOR ANY WORK DONE DUE TO DIMENSIONS OR GRADES SHOWN INCORRECTLY ON THESE PLANS IF SUCH NOTIFICATION HAS NOT BEEN GIVEN.
- 14. ACCESSIBLE RAMPS SHALL BE CONSTRUCTED IN ACCORDANCE WITH THE CITY OF RALEIGH UNIFIED DEVELOPMENT ORDINANCE (UDO) DETAILS.
- 15. ALL SIDEWALKS THAT CONNECT TO THE PUBLIC RIGHT-OF-WAY MUST BE ACCESSIBLE TO PERSONS WHO ARE BLIND. HAVE I OW VISION AND PEOPLE WITH MOBILITY DISABILITIES. PEDESTRIAN EXISTING ROUTES AND ALTERNATE PEDESTRIAN ROUTES DURING CONSTRUCTION WILL BE REQUIRED TO BE COMPLIANT WITH THE PUBLIC RIGHTS OF WAY ACCESSIBILITY GUIDELINES (PROWAG), 2010 ADA STANDARDS FOR ACCESSIBLE DESIGN AND THE MANUAL ON UNIFORM TRAFFIC CONTROL DEVICES (MUTCD).
- 16. TYPICAL PAVEMENT SECTION DETAILS ARE SHOWN WITHIN THIS SET AND INTENDED TO BE A MINIMUM PAVEMENT SECTION REQUIREMENT. THE CURRENT GEOTECHNICAL REPORT SHALL OVER-RIDE ALL TYPICAL PAVEMENT SECTIONS SHOWN, IF THE GEOTECHNICAL ENGINEER DEEMS A HEAVIER SECTION IS REQUIRED.
- 17. EQUIPMENT AND PRODUCTS OTHER THAN THOSE SPECIFIED MAY BE USED PROVIDED APPROVAL HAS BEEN OBTAINED FROM THE OWNER IN WRITING PRIOR TO ORDERING OR INSTALLATION. THE CONTRACTOR SHALL WAIVE ANY CLAIM FOR ADDITIONAL COST RELATED TO SUBSTITUTION OF ALTERNATE EQUIPMENT.
- 18. IF UNFORESEEN CONDITIONS DEVELOP DURING CONSTRUCTION, REFER TO THE LATEST VERSION OF THE RALEIGH STREET DESIGN MANUAL AND CONTACT PUBLIC WORKS STAFF FOR FURTHER GUIDANCE.
- 19. ALL SIGNAGE ASSOCIATED WITH THE PUBLIC STREET SYSTEM SHALL ADHERE TO MUTCD STANDARDS AND SPECIFICATIONS. 20. ANY TRANSIT STOP LOCATIONS SHOWN ARE PRELIMINARY ONLY. FINAL LOCATION SHALL BE DETERMINED ONCE THE CITY OF

RALEIGH TRANSIT ROUTE HAS BEEN FINALIZED. ALL TRANSIT STOPS SHALL HAVE A 10'x20'x6" (3000 PSI) CONCRETE PAD.

ADDITIONAL UTILITY NOTES

- 1. ALL WATER MAINS, SERVICES AND FIRE SERVICES GREATER THAN 2" DIAMETER ARE TO BE DUCTILE IRON PIPE. 2" & SMALLER DOMESTIC SERVICES MUST BE TYPE K SOFT COPPER (WITHOUT FITTINGS) TO THE WATER METER.
- 2. ALL SEWER MAINS SHALL BE EITHER PVC OR DUCTILE IRON PIPE AS SHOWN ON THE PLANS. ALL PIPE MATERIAL SHALL MEET CITY OF RALEIGH STANDARDS AND SPECIFICATIONS AS DEFINED IN THE LATEST ISSUE OF THE PUBLIC UTILITIES HANDBOOK AND/OR UNIFIED DEVELOPMENT ORDINANCE (UDO).
- 3. ALL FIRE HYDRANTS ALONG PUBLIC R/W LINES SHALL HAVE A 5'Wx5'L CITY OF RALEIGH WATERLINE EASEMENT ONTO ADJACENT
- 4. ALL SANITARY SEWER INTERCEPTOR LINES (12" AND LARGER), AS WELL AS MANHOLES AND FITTINGS ASSOCIATED WITH THE INTERCEPTOR LINE, SHALL BE INTERNALLY LINED WITH PROTECTO 401 OR APPROVED EQUAL TO PREVENT HYDROGEN SULFIDE CORROSION. SEE THE CURRENT CITY OF RALEIGH PUBLIC UTILITIES DEPARTMENT HANDBOOK FOR APPROVED COATINGS AND APPLICATION METHODS.
- 5. IN ACCORDANCE WITH GENERAL STATUTE 87-121(G), ALL UNDERGROUND UTILITIES INSTALLED AFTER OCTOBER 1, 2014 SHALL BE ELECTRONICALLY LOCATABLE. CONTRACTOR SHALL COORDINATE DIRECTLY WITH THE CITY OF RALEIGH PUBLIC UTILITIES DEPARTMENT FOR DETAILS AND SPECIFICATIONS FOR MEETING THESE REQUIREMENTS.
- 6. EXISTING UTILITIES SHOWN ARE BASED ON FIELD SURVEYS AND THE BEST AVAILABLE RECORD DRAWINGS. THE CONTRACTOR SHALL VERIFY CONDITIONS PRIOR TO BEGINNING CONSTRUCTION. ANY DISCREPANCIES BETWEEN ACTUAL FIELD CONDITIONS AND THE PLANS SHALL BE REPORTED TO THE ENGINEER IMMEDIATELY.
- 7. ALL WATER AND SEWER MAINS WITHIN PUBLIC EASEMENTS OR RIGHTS-OF-WAY TO BE OWNED, OPERATED, AND MAINTAINED BY

8. ALL WATER AND SEWER MAINS NOT WITHIN PUBLIC EASEMENTS OR RIGHTS-OF-WAY TO BE PRIVATELY OWNED, OPERATED, AND

- MAINTAINED BY THE PROPERTY OWNER.
- 9. CONTRACTOR SHALL NOTIFY "NC811" (811) OR (1-800-632-4949) AT LEAST 3 FULL BUSINESS DAYS PRIOR TO BEGINNING CONSTRUCTION OR EXCAVATION TO HAVE EXISTING UTILITIES LOCATED. CONTRACTOR SHALL CONTACT ANY LOCAL UTILITIES THAT PROVIDE THEIR OWN LOCATOR SERVICES INDEPENDENT OF "NC811". REPORT ANY DISCREPANCIES TO THE ENGINEER
- 10. ALL UTILITY SLEEVES SHALL BE SCHEDULE 40 PVC AND INSTALLED WITH 2' MINIMUM COVER. BOTH ENDS SHALL BE CAPPED AND

RETAINING WALL NOTES

- 1. THE RETAINING WALL ALIGNMENT SHOWN ON THESE PLANS DEPICTS THE LOCATION OF THE FRONT FACE OF THE RETAINING WALL AT THE BOTTOM OF THE WALL. THE CONTRACTOR IS RESPONSIBLE FOR ENSURING RETAINING WALLS ARE NOT LOCATED IN ANY STREAM BUFFERS, AND THEIR CONSTRUCTION DOES NOT ENCROACH INTO ANY ADJACENT PROPERTIES DUE TO ANY BATTER INCORPORATED IN THE DESIGN OF THE WALLS.
- 2. RETAINING WALLS ARE TO BE DESIGN-BUILD PROJECTS BY THE CONTRACTOR. IT SHALL BE THE CONTRACTOR'S RESPONSIBILITY TO OBTAIN FINAL CONSTRUCTION DRAWINGS FROM A REGISTERED ENGINEER AND GAIN ALL REQUIRED PERMITS NECESSARY FOR THE CONSTRUCTION OF THE RETAINING WALLS.
- 3. RETAINING WALLS SHALL BE ASSUMED TO BE BACKFILLED WITH OFF-SITE BORROW MATERIAL OR PROCESSED FILL, UNLESS THE CONTRACTOR CAN PROVIDE TO THE OWNER WITH CONFIRMATION FROM THE GEOTECHNICAL ENGINEER AND THE RETAINING WALL DESIGNER, THAT READILY AVAILABLE ON-SITE SOILS CAN BE USED.
- 4. THE TOP AND BOTTOM OF WALL ELEVATIONS SHOWN ON THESE PLANS IDENTIFY FINISHED GRADE ELEVATIONS ONLY. THE EXTENT THAT THE RETAINING WALL WILL BE EXTENDED BELOW GRADE TO THE FOOTING OR ABOVE GRADE TO THE TOP OF THE
- 5. ALL RETAINING WALLS OVER 30" HIGH SHALL HAVE A SAFETY FENCE (DESIGN BY OTHERS).
- 6. ANY PART OF ANY RETAINING WALL THAT EXTENDS INTO THE RIGHT-OF-WAY WILL REQUIRE AN ENCROACHMENT AGREEMENT. ENCROACHMENT AGREEMENTS FOR RETAINING WALLS SHALL BE APPROVED PRIOR TO CONSTRUCTION DRAWING APPROVAL
- 7. ANY TIEBACK SYSTEMS FOR THE RETAINING WALLS SHALL NOT BE ALLOWED WITHIN PUBLIC RIGHT-OF-WAY.

CAP BLOCK COURSE SHALL BE IDENTIFIED ON THE RETAINING WALL CONSTRUCTION DRAWINGS.

- 8. STORMWATER RUN-OFF SHALL BE DIRECTED AWAY FROM RETAINING WALLS. ANY RUN-OFF FLOWING TO AND OVER A RETAINING WALL SHALL BE KEPT TO AN ABSOLUTE MINIMUM AND BROUGHT TO THE ATTENTION OF THE WALL DESIGNER PRIOR
- 9. ALL WORK TO BE CONSTRUCTED IN STRICT COMPLIANCE WITH GEOTECHNICAL REPORT.

CITY OF RALEIGH PUBLIC UTILITIES STANDARD UTILITY NOTES (AS APPLICABLE)

SPECIFICATIONS (REFERENCE: CORPUD HANDBOOK, CURRENT EDITION).

- 1. ALL MATERIALS & CONSTRUCTION METHODS SHALL BE IN ACCORDANCE WITH CITY OF RALEIGH DESIGN STANDARDS, DETAILS &
- 2. UTILITY SEPARATION REQUIREMENTS:
- a) A DISTANCE OF 100' SHALL BE MAINTAINED BETWEEN SANITARY SEWER & ANY PRIVATE OR PUBLIC WATER SUPPLY SOURCE SUCH AS AN IMPOUNDED RESERVOIR USED AS A SOURCE OF DRINKING WATER. IF ADEQUATE LATERAL SEPARATION CANNOT BE ACHIEVED, FERROUS SANITARY SEWER PIPE SHALL BE SPECIFIED & INSTALLED TO WATERLINE SPECIFICATIONS. HOWEVER. THE MINIMUM SEPARATION SHALL NOT BE LESS THAN 25' FROM A PRIVATE WELL OR 50' FROM A PUBLIC WELL.
- b) WHEN INSTALLING WATER &/OR SEWER MAINS, THE HORIZONTAL SEPARATION BETWEEN UTILITIES SHALL BE 10'. IF THIS SEPARATION CANNOT BE MAINTAINED DUE TO EXISTING CONDITIONS, THE VARIATION ALLOWED IS THE WATER MAIN IN A SEPARATE TRENCH WITH THE ELEVATION OF THE WATER MAIN AT LEAST 18" ABOVE THE TOP OF THE SEWER & MUST BE APPROVED BY THE PUBLIC UTILITIES DIRECTOR. ALL DISTANCES ARE MEASURED FROM OUTSIDE DIAMETER TO OUTSIDE
- c) WHERE IT IS IMPOSSIBLE TO OBTAIN PROPER SEPARATION, OR ANYTIME A SANITARY SEWER PASSES OVER A WATERMAIN, DIP MATERIALS OR STEEL ENCASEMENT EXTENDED 10' ON EACH SIDE OF CROSSING MUST BE SPECIFIED & INSTALLED TO WATERLINE SPECIFICATIONS.
- d) 5.0' MINIMUM HORIZONTAL SEPARATION IS REQUIRED BETWEEN ALL SANITARY SEWER & STORM SEWER FACILITIES, UNLESS DIP MATERIAL IS SPECIFIED FOR SANITARY SEWER.
- e) MAINTAIN 18" MIN. VERTICAL SEPARATION AT ALL WATERMAIN & RCP STORM DRAIN CROSSINGS; MAINTAIN 18" MIN. VERTICAL SEPARATION AT ALL SANITARY SEWER & RCP STORM DRAIN CROSSINGS. WHERE ADEQUATE SEPARATIONS CANNOT BE ACHIEVED, SPECIFY DIP MATERIALS & A CONCRETE CRADLE HAVING 6" MIN. CLEARANCE (PER CORPUD DETAILS
- f) ALL OTHER UNDERGROUND UTILITIES SHALL CROSS WATER & SEWER FACILITIES WITH 18" MIN. VERTICAL SEPARATION
- 3. ANY NECESSARY FIELD REVISIONS ARE SUBJECT TO REVIEW & APPROVAL OF AN AMENDED PLAN &/OR PROFILE BY THE CITY OF RALEIGH PUBLIC UTILITIES DEPARTMENT PRIOR TO CONSTRUCTION.
- 4. CONTRACTOR SHALL MAINTAIN CONTINUOUS WATER & SEWER SERVICE TO EXISTING RESIDENCES & BUSINESSES THROUGHOUT CONSTRUCTION OF PROJECT. ANY NECESSARY SERVICE INTERRUPTIONS SHALL BE PRECEDED BY A 24 HOUR ADVANCE NOTICE TO THE CITY OF RALEIGH PUBLIC UTILITIES DEPARTMENT.
- 5. 3.0' MINIMUM COVER IS REQUIRED ON ALL WATER MAINS & SEWER FORCEMAINS. 4.0' MINIMUM COVER IS REQUIRED ON ALL REUSE MAINS.
- 6. IT IS THE DEVELOPER'S RESPONSIBILITY TO ABANDON OR REMOVE EXISTING WATER & SEWER SERVICES NOT BEING USED IN REDEVELOPMENT OF A SITE UNLESS OTHERWISE DIRECTED BY THE CITY OF RALEIGH PUBLIC UTILITIES DEPARTMENT. THIS INCLUDES ABANDONING TAP AT MAIN & REMOVAL OF SERVICE FROM ROW OR EASEMENT PER CORPUD HANDBOOK PROCEDURE.
- 7. INSTALL 3/4" COPPER* WATER SERVICES WITH METERS LOCATED AT ROW OR WITHIN A 2'X2' WATERLINE EASEMENT IMMEDIATELY ADJACENT. NOTE: IT IS THE APPLICANT'S RESPONSIBILITY TO PROPERLY SIZE THE WATER SERVICE FOR EACH CONNECTION TO PROVIDE ADEQUATE FLOW & PRESSURE.
- 8. INSTALL 4" PVC* SEWER SERVICES @ 1.0% MINIMUM GRADE WITH CLEANOUTS LOCATED AT ROW OR EASEMENT LINE & SPACED
- 24. PRESSURE REDUCING VALVES ARE REQUIRED ON ALL WATER SERVICES EXCEEDING 80 PSI. WHERE SANITARY SERVICES ARE SERVING A BUILDING INSTALLED ON A FLOOR WITH A FINISHED FLOOR ELEVATION BELOW THE ELEVATION OF THE MANHOLE COVER OF THE NEXT UPSTREAM MANHOLE IN THE PUBLIC SEWER, SUCH FIXTURES SHALL BE PROTECTED BY A BACKWATER VALVE INSTALLED IN THE SERVICE LINE. SANITARY SERVICES SERVING A BUILDING WITH A FINISHED FLOOR ELEVATION ABOVE THE ELEVATION OF THE MANHOLE COVER OF THE NEXT UPSTREAM MANHOLE IN THE PUBLIC SEWER SHALL NOT DISCHARGE THROUGH
- 25. ALL ENVIRONMENTAL PERMITS APPLICABLE TO THE PROJECT MUST BE OBTAINED FROM NCDWQ, USACE &/OR FEMA FOR ANY RIPARIAN BUFFER, WETLAND &/OR FLOODPLAIN IMPACTS (RESPECTIVELY) PRIOR TO CONSTRUCTION.
- 26. NCDOT / RAILROAD ENCROACHMENT AGREEMENTS ARE REQUIRED FOR ANY UTILITY WORK (INCLUDING MAIN EXTENSIONS & SERVICE TAPS) WITHIN STATE OR RAILROAD ROW PRIOR TO CONSTRUCTION.
- 27. GREASE INTERCEPTOR / OIL WATER SEPARATOR SIZING CALCULATIONS & INSTALLATION SPECIFICATIONS SHALL BE APPROVED BY THE CORPUD FOG PROGRAM COORDINATOR PRIOR TO ISSUANCE OF A BUILDING PERMIT. CONTACT STEPHEN CALVERLEY AT (919) 296-2334 OR STEPHEN.CALVERLEY@RALEIGHNC.GOV FOR MORE INFORMATION.
- 28. CROSS-CONNECTION CONTROL PROTECTION DEVICES ARE REQUIRED BASED ON DEGREE OF HEALTH HAZARD INVOLVED AS LISTED IN APPENDIX-B OF THE RULES GOVERNING PUBLIC WATER SYSTEMS IN NORTH CAROLINA. THESE GUIDELINES ARE THE MINIMUM REQUIREMENTS. THE DEVICES SHALL MEET AMERICAN SOCIETY OF SANITARY ENGINEERING (ASSE) STANDARDS OR BE ON THE UNIVERSITY OF SOUTHERN CALIFORNIA APPROVAL LIST. THE DEVICES SHALL BE INSTALLED AND TESTED (BOTH INITIAL AND PERIODIC TESTING THEREAFTER) IN ACCORDANCE WITH THE MANUFACTURER'S RECOMMENDATIONS OR THE LOCAL CROSS-CONNECTION CONTROL PROGRAM, WHICHEVER IS MORE STRINGENT. CONTACT JOANIE HARTLEY AT (919) 996-5923 OR JOANIE.HARTLEY@RALEIGHNC.GOV FOR MORE INFORMATION.

GRADING NOTES

- 1. ALL DIMENSIONS AND GRADES SHOWN ON THE PLANS SHALL BE FIELD VERIFIED BY THE CONTRACTOR PRIOR TO CONSTRUCTION. CONTRACTOR SHALL NOTIFY THE ENGINEER IF ANY DISCREPANCIES EXIST PRIOR TO PROCEEDING WITH CONSTRUCTION, FOR NECESSARY PLAN OR GRADE CHANGES. NO EXTRA COMPENSATION SHALL BE PAID TO THE CONTRACTOR FOR ANY WORK DONE DUE TO DIMENSIONS OR GRADES SHOWN INCORRECTLY ON THESE PLANS IF SUCH NOTIFICATION HAS NOT BEEN GIVEN.
- 2. OCCUPATIONAL SAFETY AND HEALTH ADMINISTRATION (OSHA) STANDARDS FOR EXCAVATIONS; FINAL RULE 29CFR PART 1926, SUBPART "P" APPLIES TO ALL EXCAVATIONS EXCEEDING FIVE (5) FEET IN DEPTH. EXCAVATION EXCEEDING TWENTY (20) FEET IN DEPTH REQUIRES THE DESIGN OF A TRENCH SAFETY SYSTEM BY A REGISTERED PROFESSIONAL ENGINEER, PROVIDED BY CONTRACTOR RESPONSIBLE FOR EXCAVATION.
- 3. ALL CONSTRUCTION SHALL BE IN ACCORDANCE WITH THE CITY OF RALEIGH AND/OR NCDOT STANDARDS AND SPECIFICATIONS AS
- 4. CONTRACTOR SHALL NOTIFY "NC811" (811) OR (1-800-632-4949) AT LEAST 3 FULL BUSINESS DAYS PRIOR TO BEGINNING CONSTRUCTION OR EXCAVATION TO HAVE EXISTING UTILITIES LOCATED. CONTRACTOR SHALL CONTACT ANY LOCAL UTILITIES THAT PROVIDE THEIR OWN LOCATOR SERVICES INDEPENDENT OF "NC811". REPORT ANY DISCREPANCIES TO THE ENGINEER
- 5. PRIOR TO BEGINNING CONSTRUCTION, THE GENERAL CONTRACTOR SHALL SCHEDULE AND ATTEND A PRE-CONSTRUCTION CONFERENCE WITH THE CITY OF RALEIGH STORMWATER AND EROSION CONTROL DEPARTMENT, THE ENGINEER AND A REPRESENTATIVE OF THE OWNER.
- 6. CONSTRUCTION, MAINTENANCE AND REMOVAL OF ALL EROSION CONTROL DEVICES ARE THE RESPONSIBILITY OF THE GENERAL CONTRACTOR. TIMING OF REMOVAL SHALL BE COORDINATED WITH THE EROSION CONTROL INSPECTOR.
- 7. EXISTING UTILITIES AND STRUCTURES SHOWN, BOTH UNDERGROUND AND ABOVE GROUND, ARE BASED ON A FIELD SURVEY AND THE BEST AVAILABLE RECORD DRAWINGS. THE CONTRACTOR SHALL VERIFY FIELD CONDITIONS PRIOR TO BEGINNING RELATED
- CONSTRUCTION. ANY DISCREPANCIES SHALL BE REPORTED TO THE ENGINEER IMMEDIATELY. 8. SOIL UNDER BUILDINGS, PAVED AREAS AND WITHIN SLOPES GREATER THAN 3:1 (H:V) SHALL BE APPROVED, PLACED AND
- 9. ALL WORK TO BE CONSTRUCTED IN STRICT COMPLIANCE W THE GEOTECHNICAL REPORT.

COMPACTED AS RECOMMENDED BY THE GEOTECHNICAL ENGINEER.




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REVISIONS

PLAN INFORMATION

PROJECT NO. MCR-23004

FILENAME MCR23004-N1 CHECKED BY ACP DRAWN BY

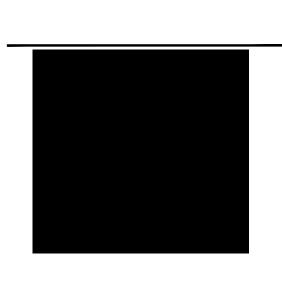PRELIMINARY DRAWING - NOT RELEASED FOR CONSTRUCTIO

PROJECT NOTES





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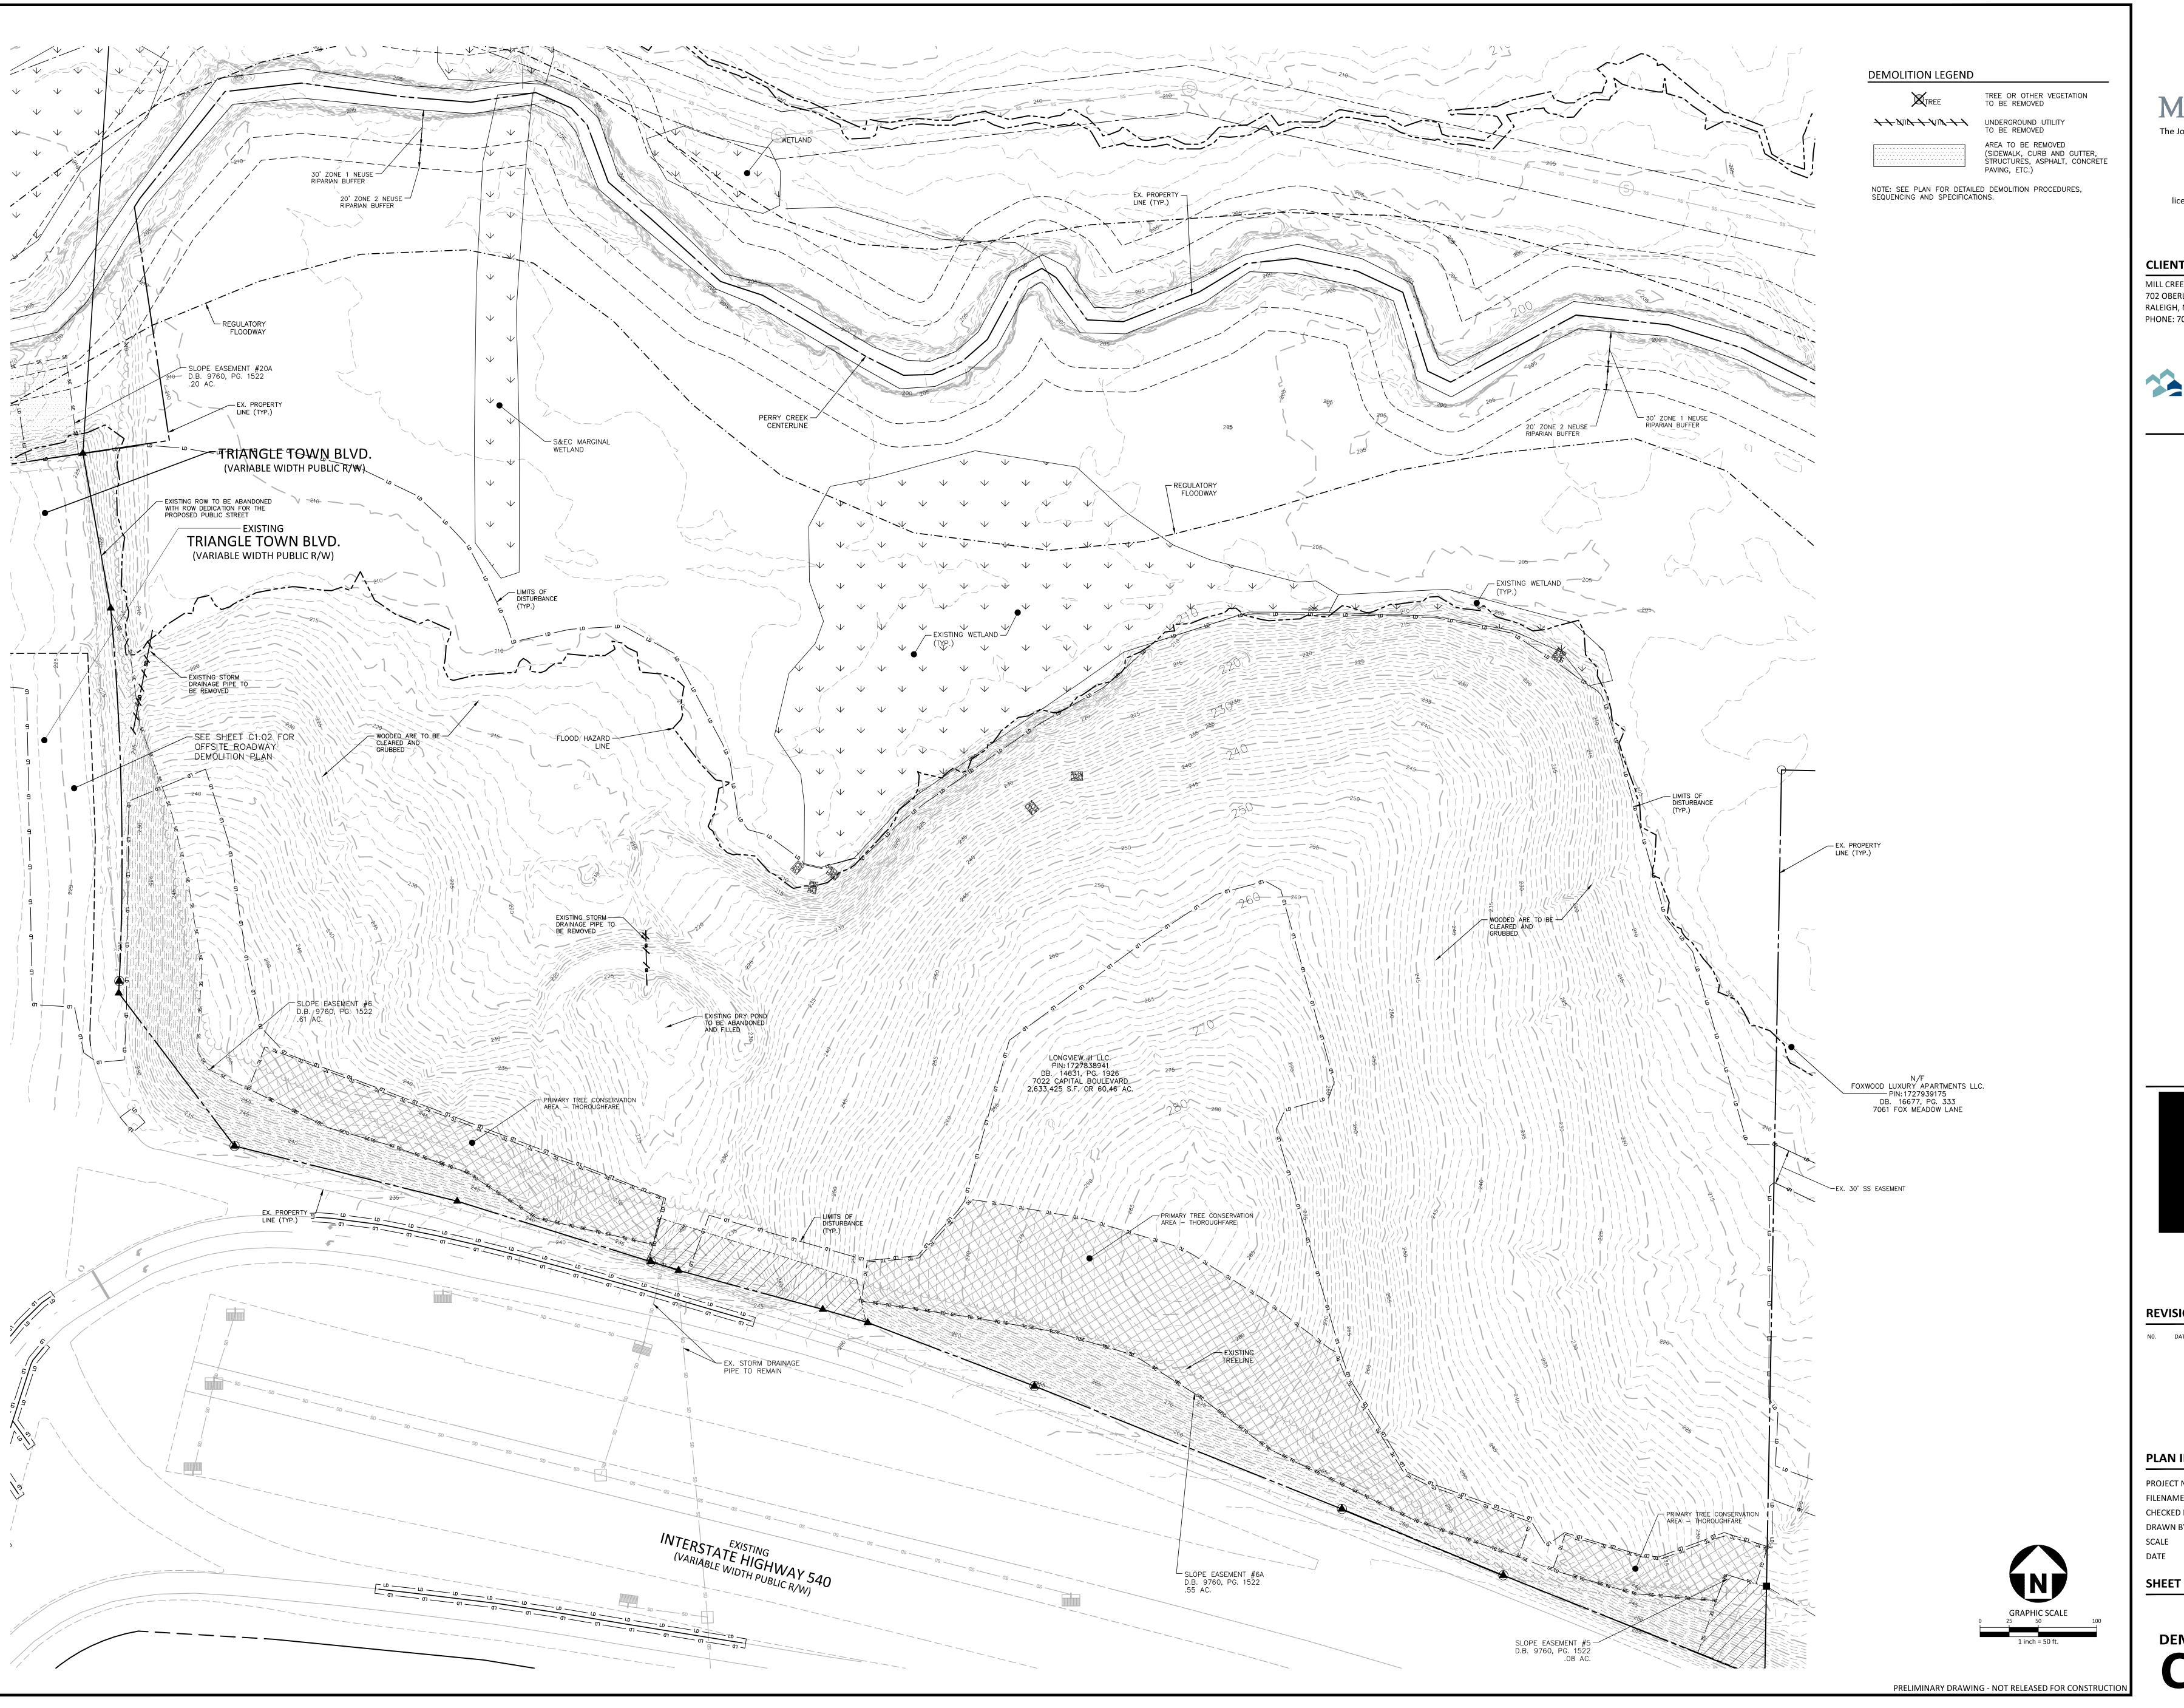
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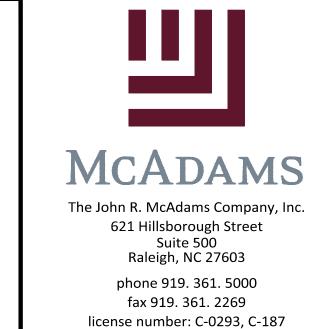
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SHEET

PRELIMINARY DRAWING - NOT RELEASED FOR CONSTRUCTION

OVERALL EXISTING CONDITIONS PLAN






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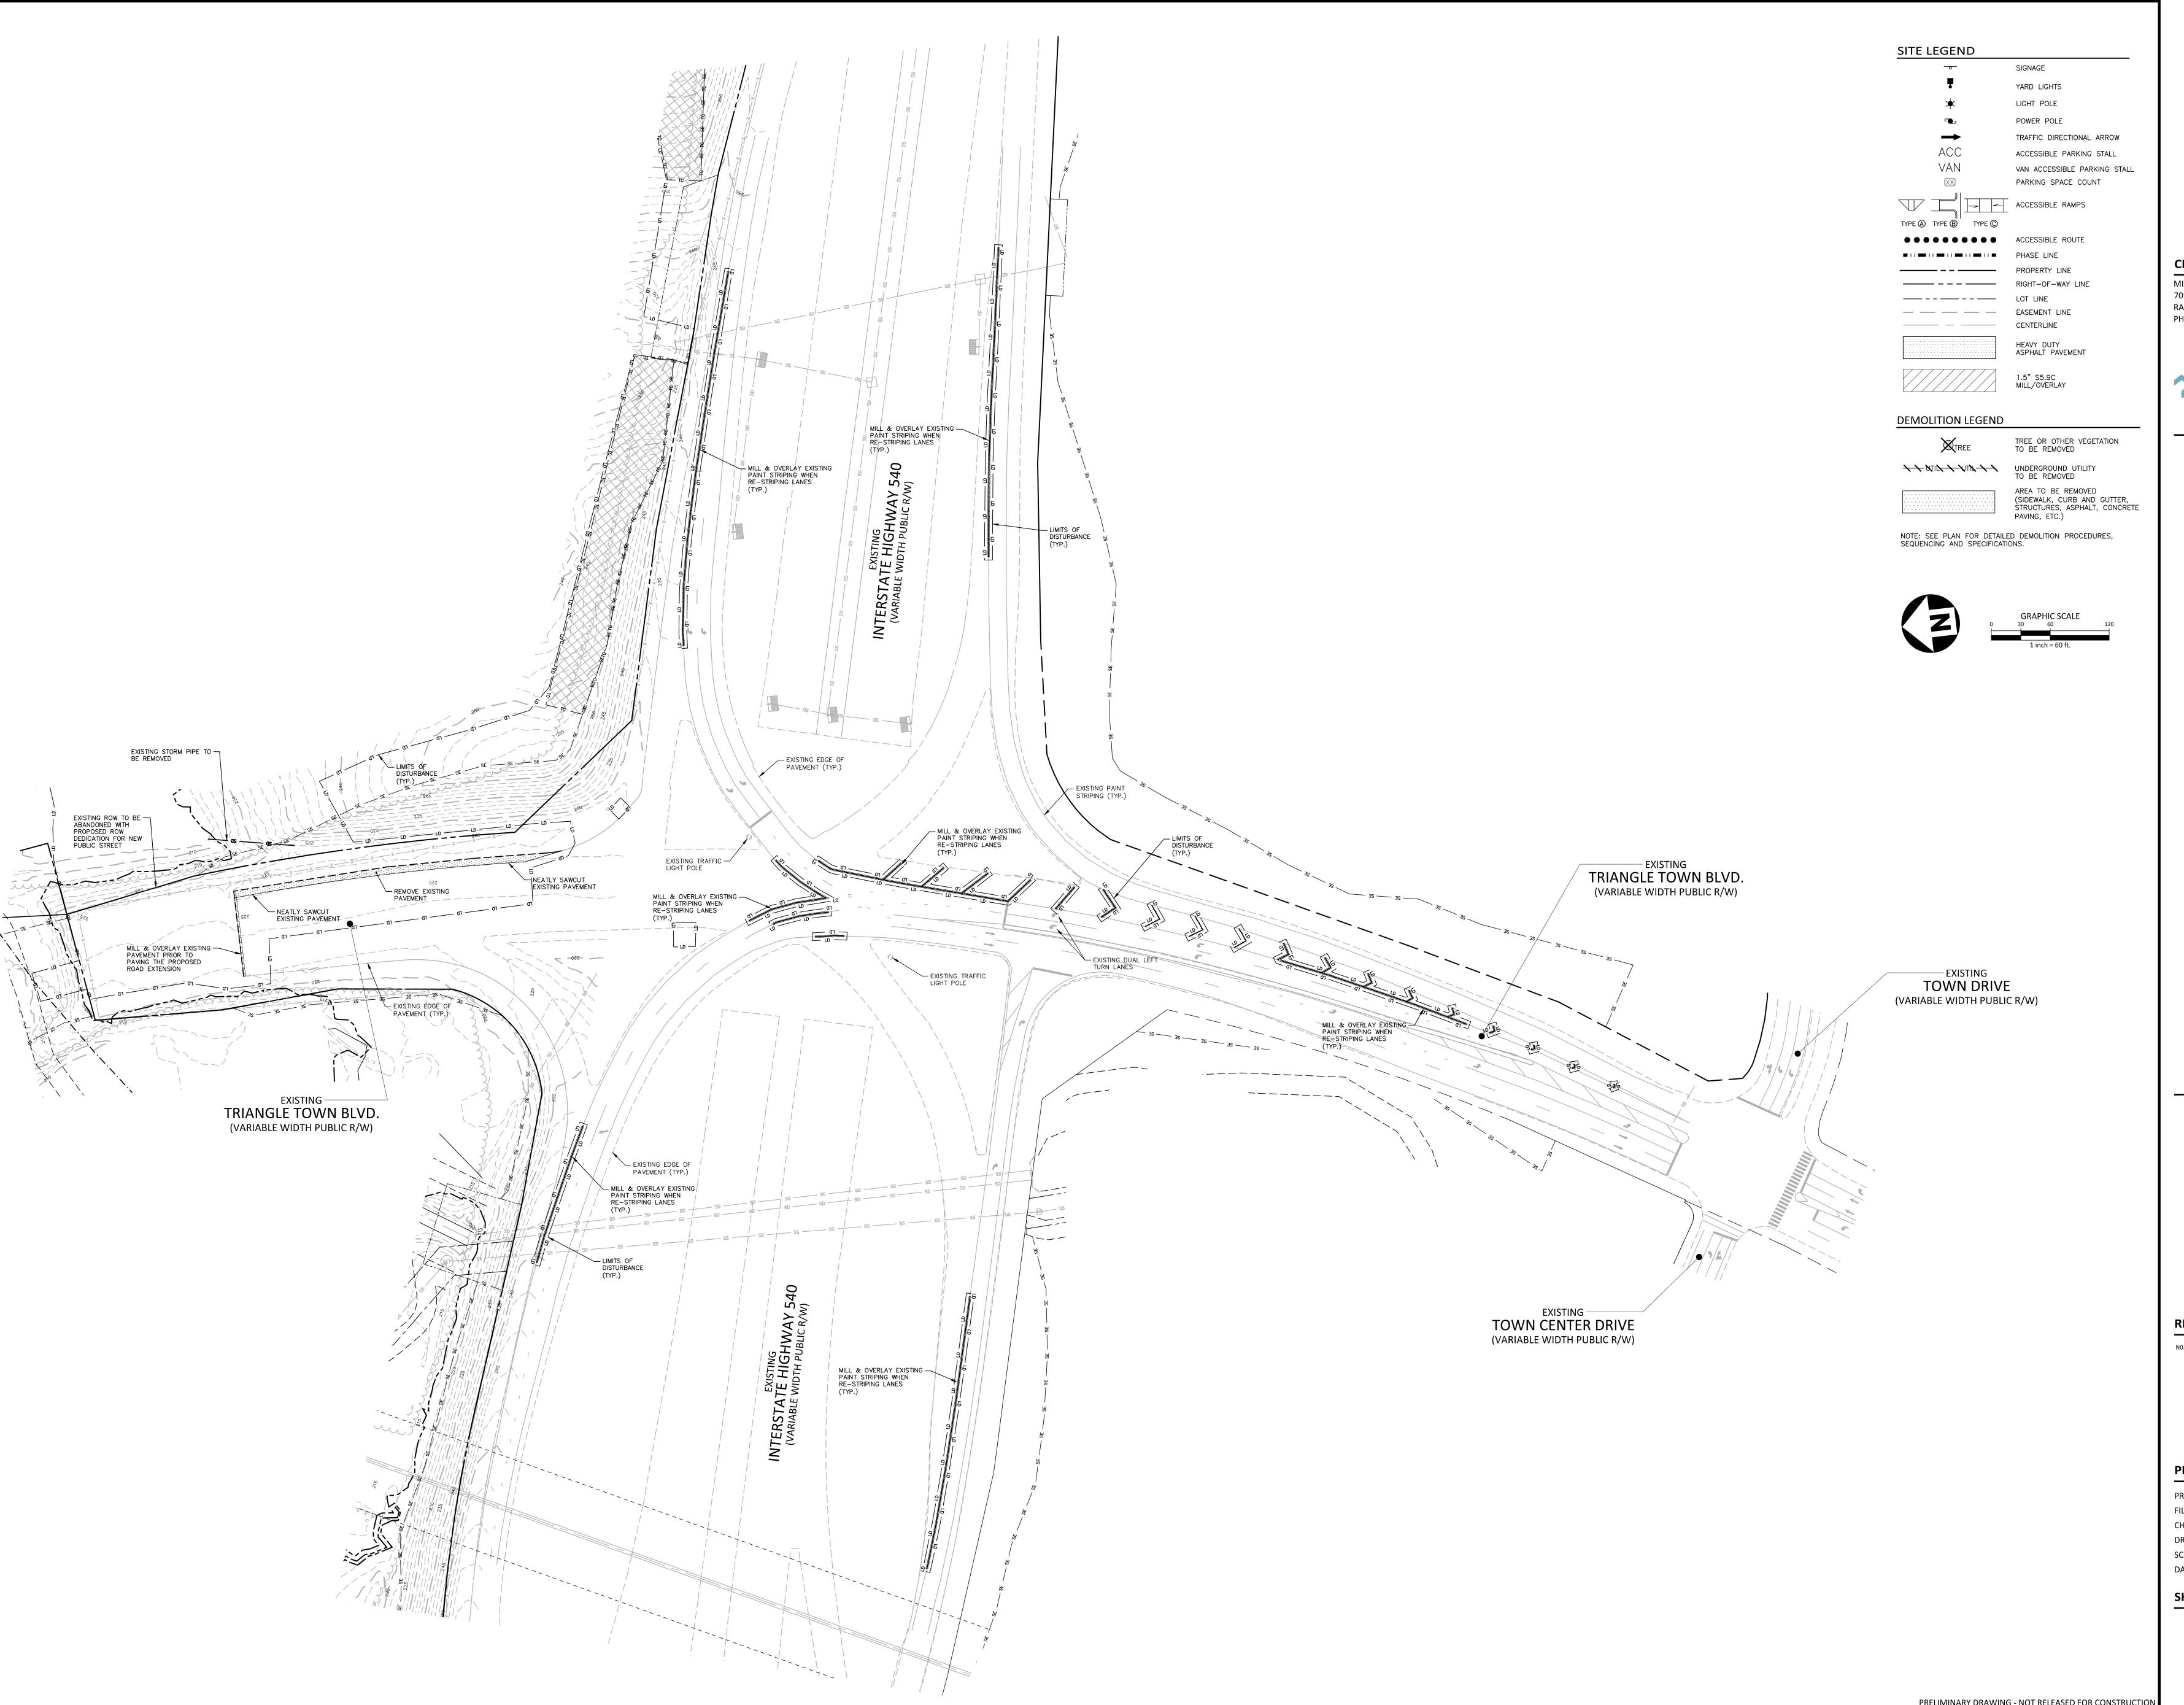
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PLAN INFORMATION

PROJECT NO. MCR-23004 FILENAME MCR23004-DM1 CHECKED BY ACP DRAWN BY SCALE

DATE

OVERALL DEMOLITION PLAN

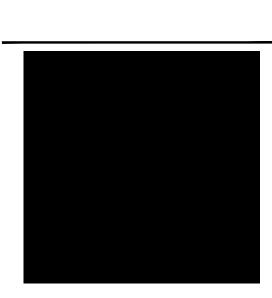




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NO. DATE


PLAN INFORMATION

PROJECT NO. MCR-23004 FILENAME MCR23004-DM2

CHECKED BY ACP

OFFSITE ROADWAY DEMOLITION PLAN

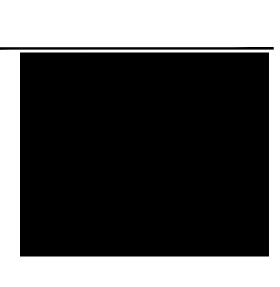PRELIMINARY DRAWING - NOT RELEASED FOR CONSTRUCTION

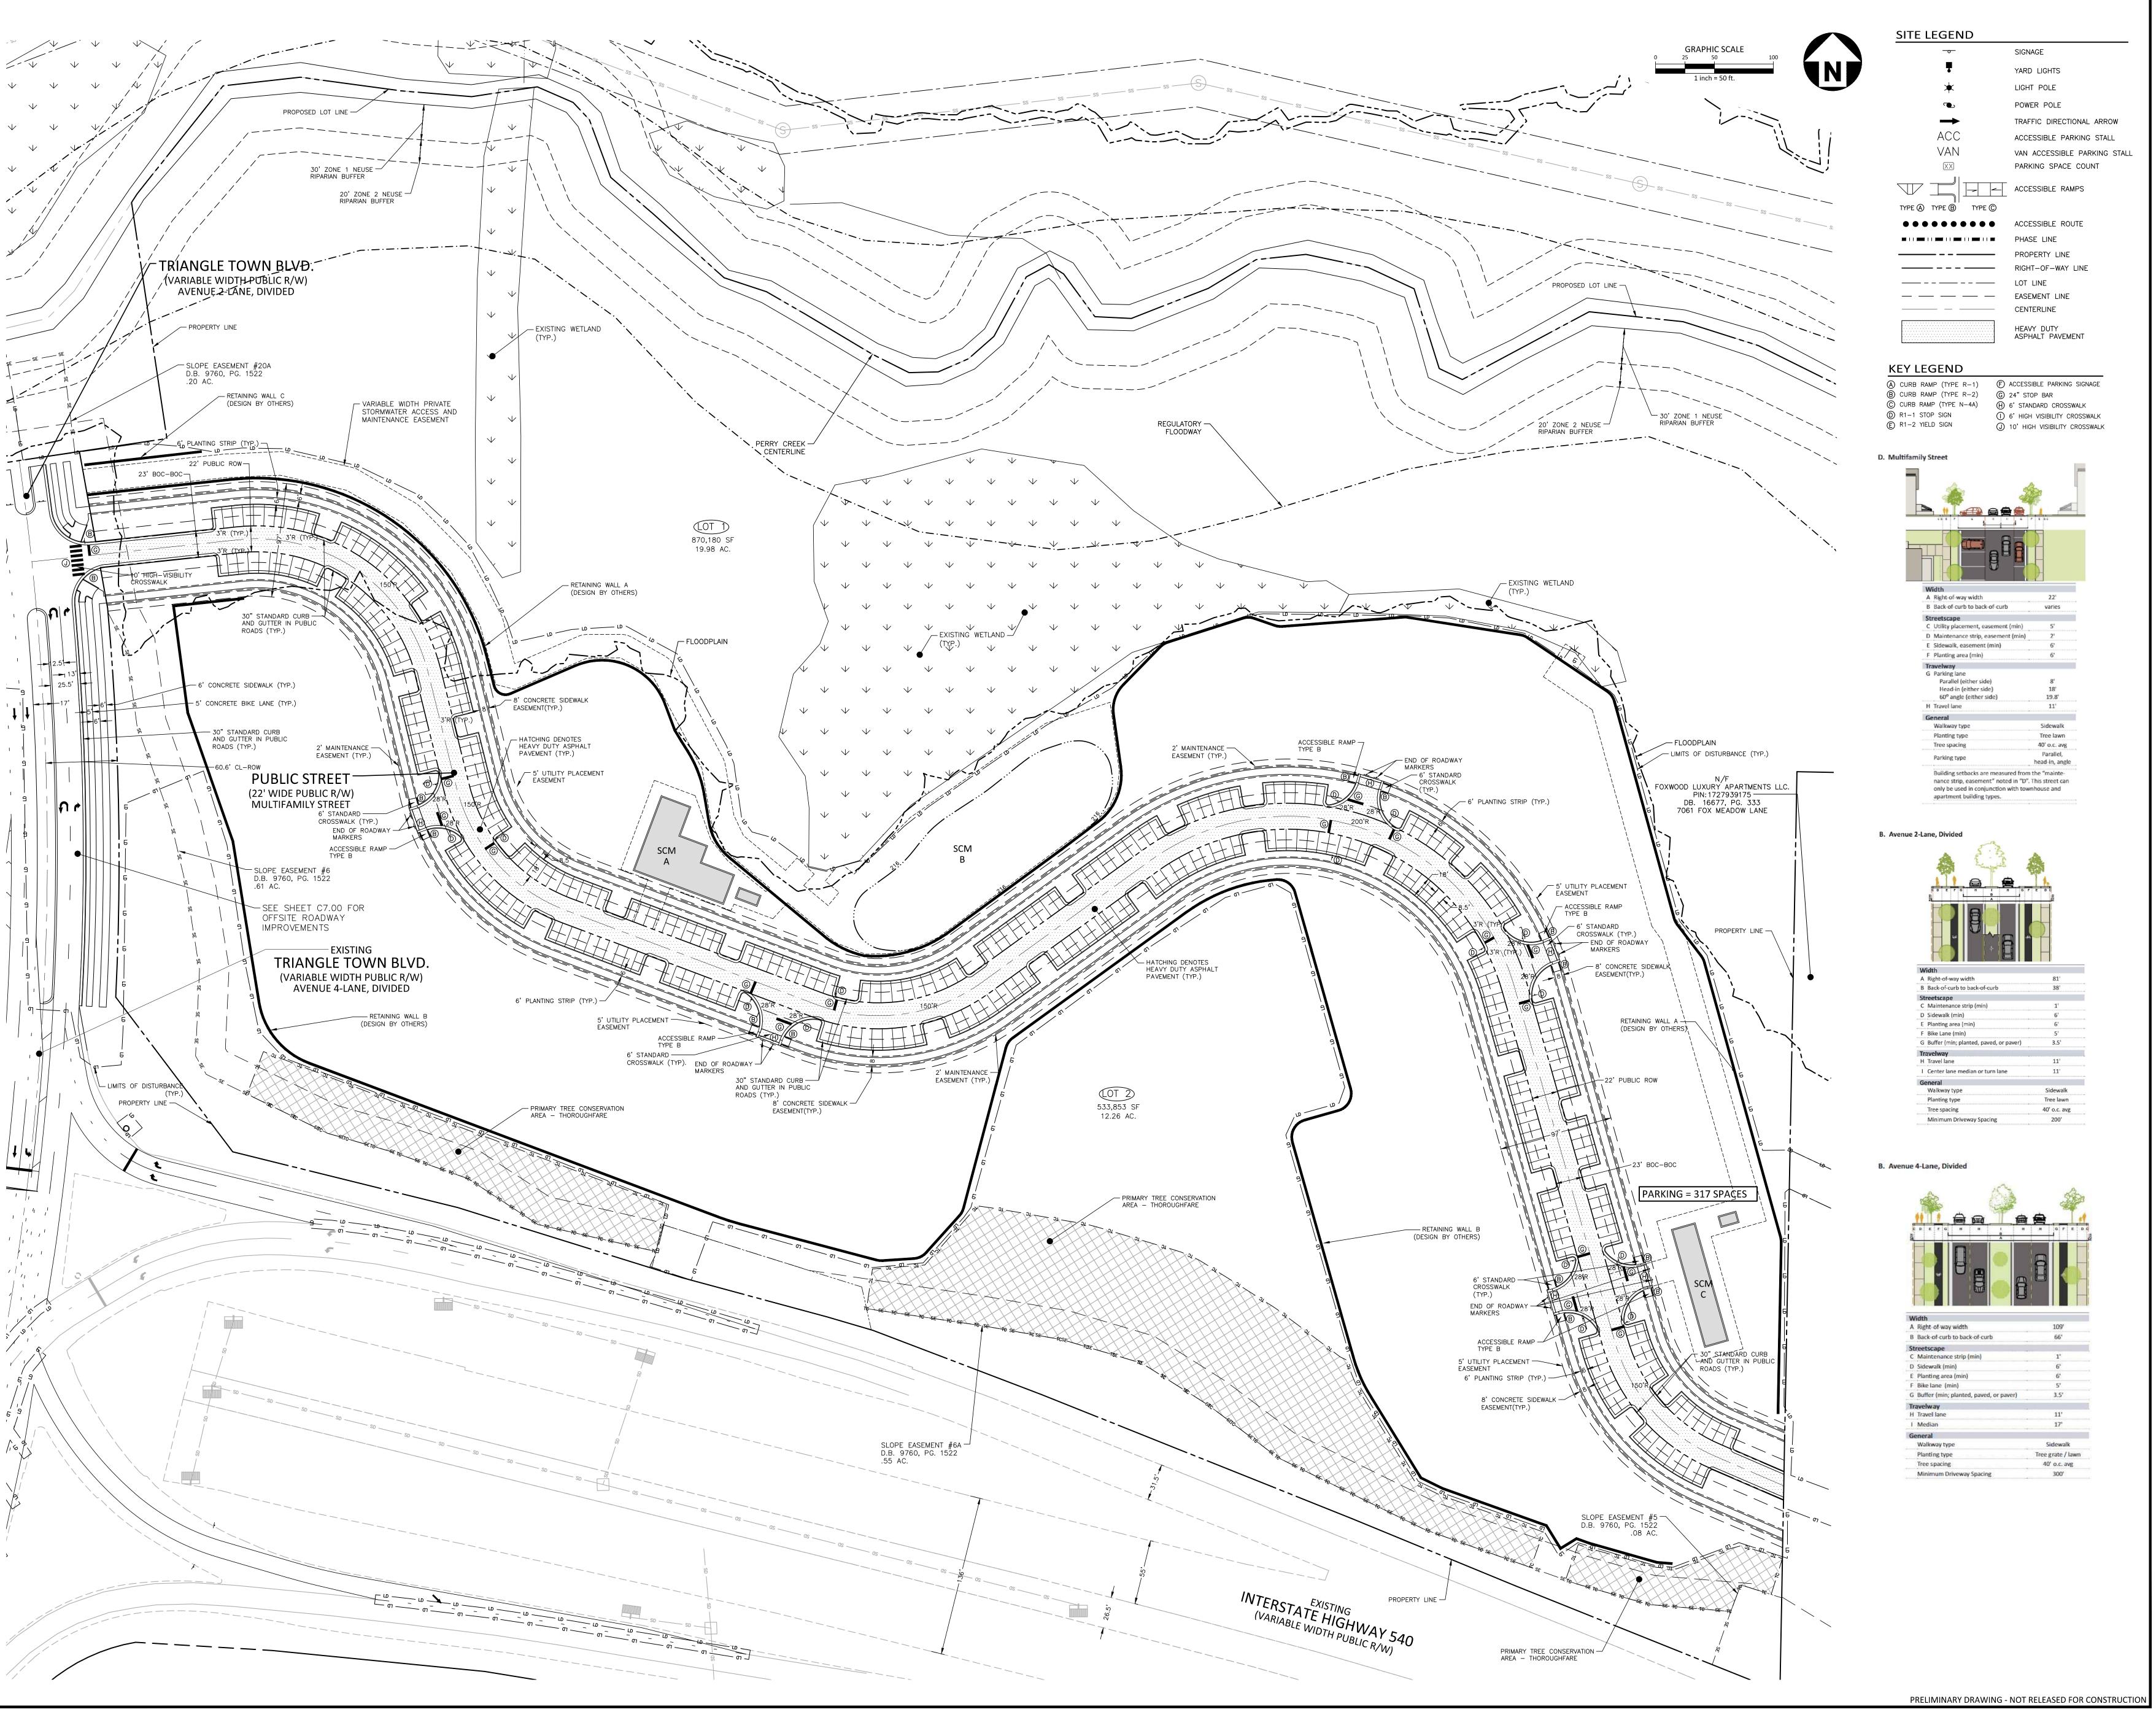




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Suite 500





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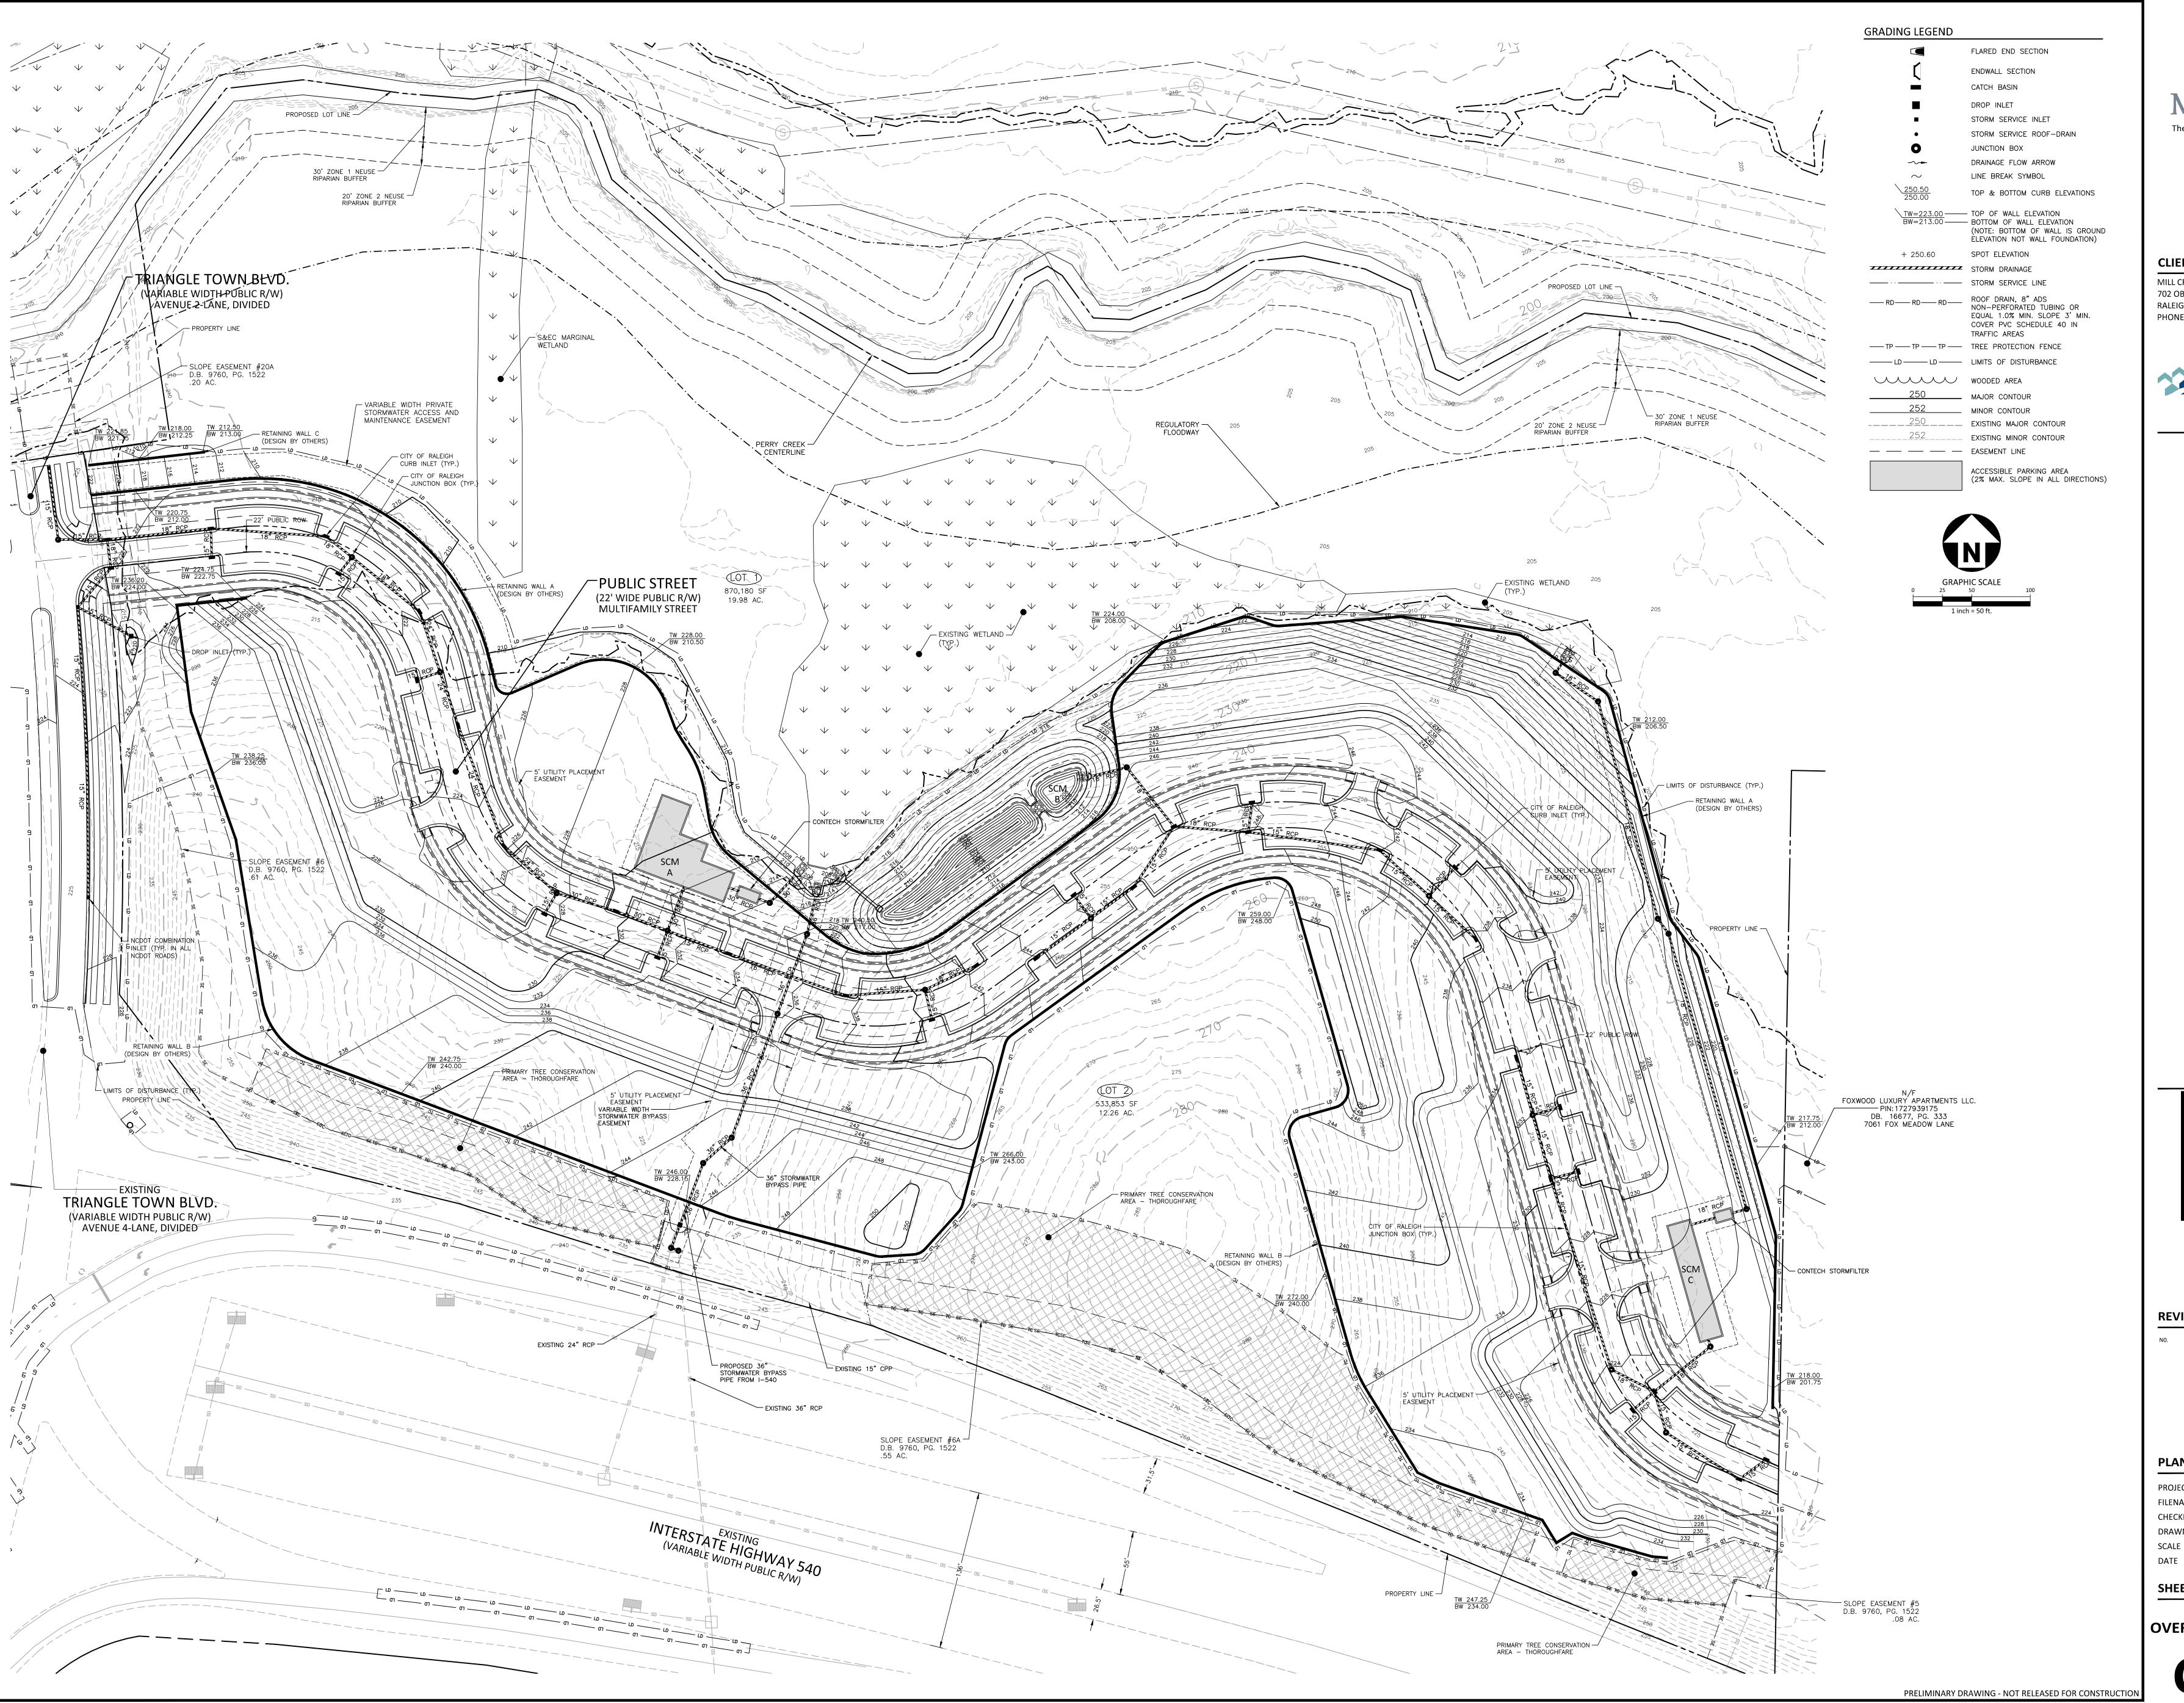
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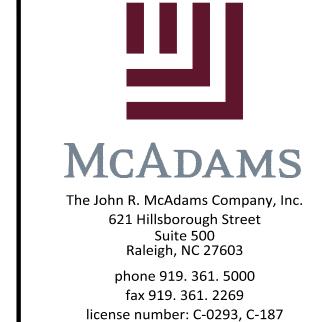
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PROJECT NO. MCR-23004 MCR23004-OAS1 FILENAME CHECKED BY ACP

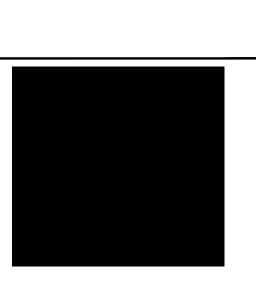DRAWN BY DATE

OVERALL SITE PLAN






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RELIMINARY SUBDIVISION PLAN
7022 CAPITAL BOULEVARD
RALEIGH, NORTH CAROLINA 27616



REVISIONS

NO. DATE

PLAN INFORMATION

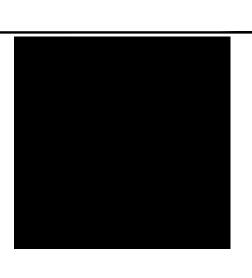
PROJECT NO. MCR-23004
FILENAME MCR23004-OAG1

CHECKED BY ACP
DRAWN BY HWM
SCALE 1" = 50'

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OVERALL GRADING PLAN

C3.00



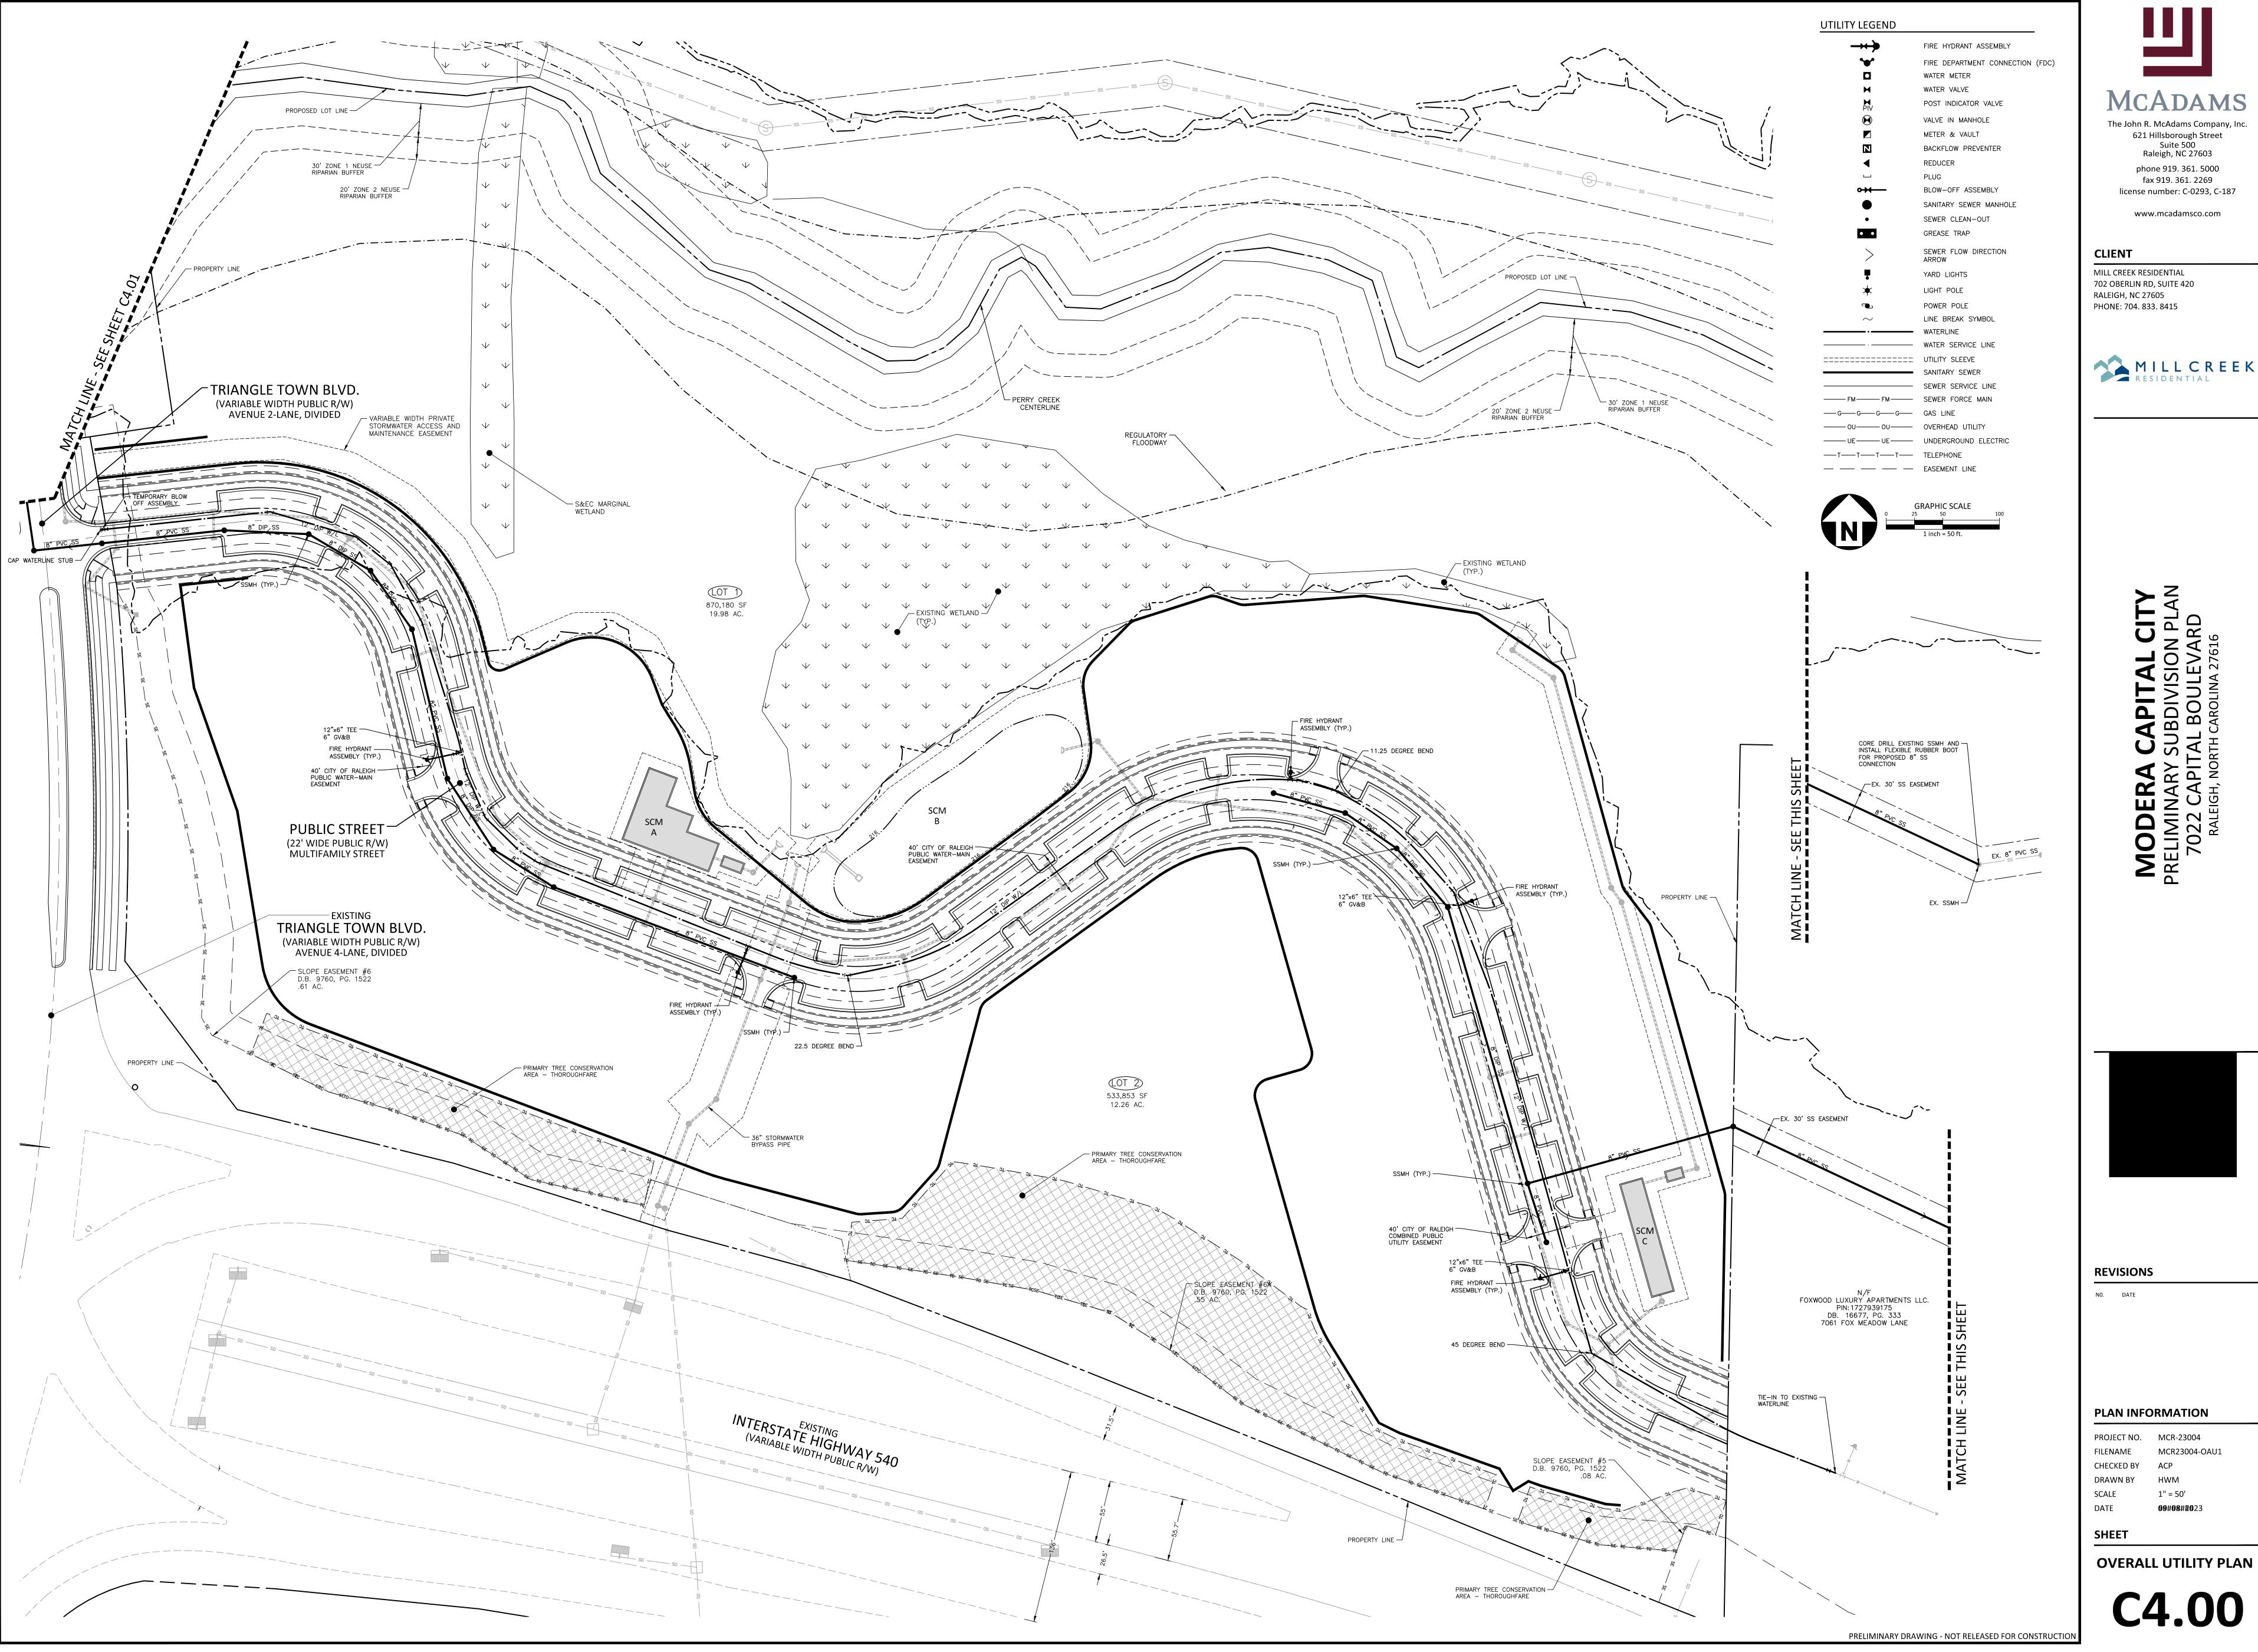

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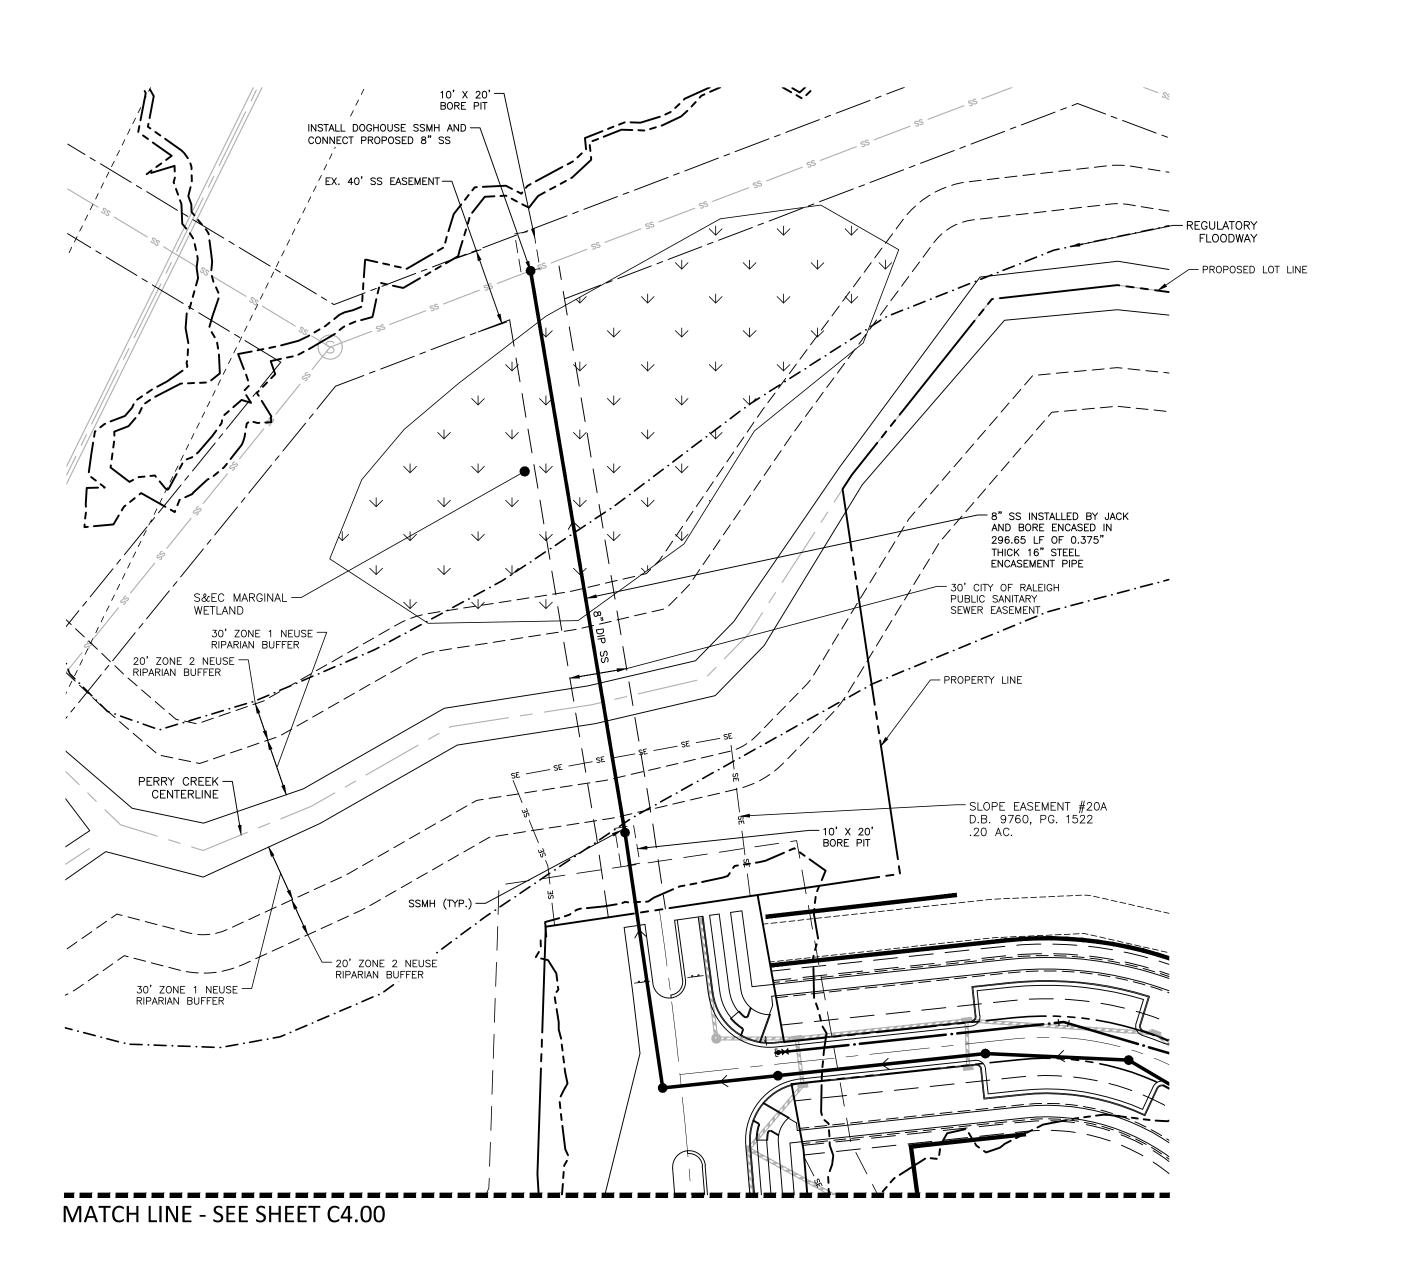
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PLAN INFORMATION

PROJECT NO. MCR-23004 FILENAME MCR23004-OAU1

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UTILITY LEGEND


FIRE HYDRANT ASSEMBLY FIRE DEPARTMENT CONNECTION (FDC) WATER METER WATER VALVE POST INDICATOR VALVE VALVE IN MANHOLE METER & VAULT BACKFLOW PREVENTER REDUCER PLUG BLOW-OFF ASSEMBLY SANITARY SEWER MANHOLE SEWER CLEAN-OUT GREASE TRAP

SEWER FLOW DIRECTION ARROW YARD LIGHTS LIGHT POLE POWER POLE LINE BREAK SYMBOL

----- WATERLINE

UTILITY SLEEVE SANITARY SEWER -----FM-FM-SEWER FORCE MAIN

-----OU-------OVERHEAD UTILITY ——— UE——— UNDERGROUND ELECTRIC —__T—_T—_T—_T TELEPHONE — — EASEMENT LINE

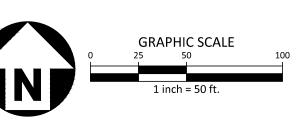

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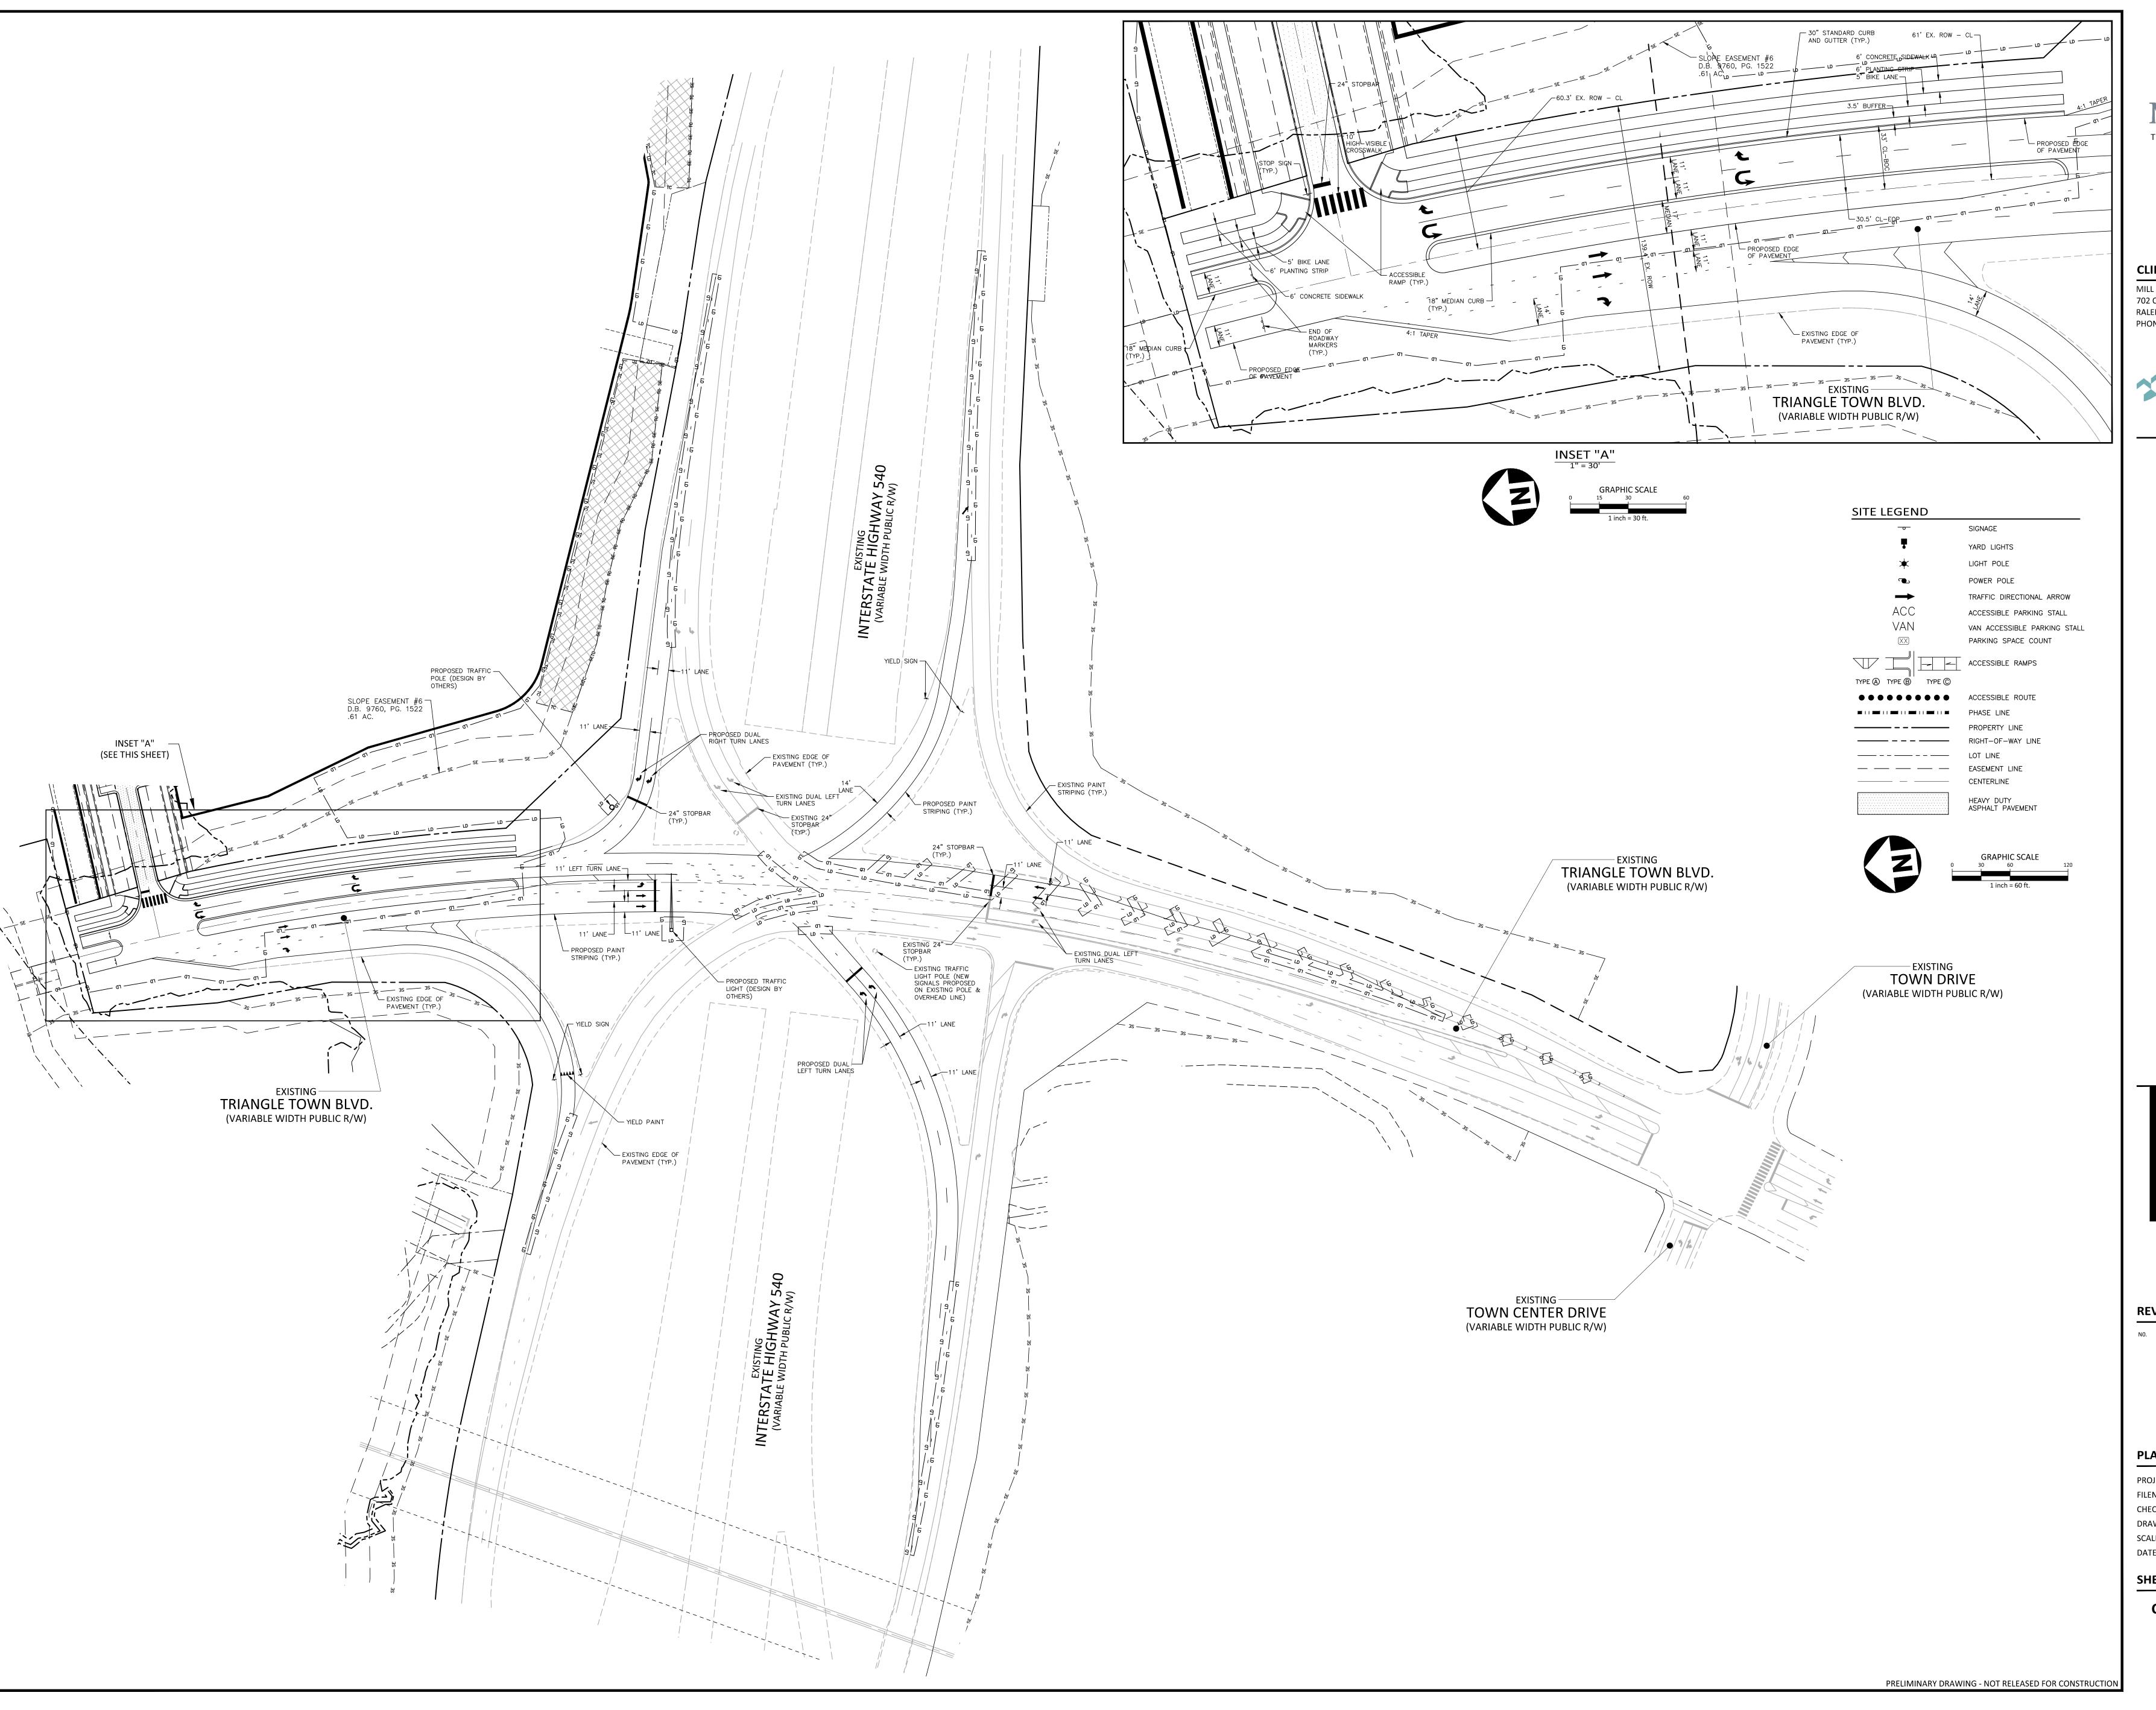


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PROJECT NO. MCR-23004 FILENAME MCR23004-OAU1 CHECKED BY ACP DRAWN BY HWM

SEWER OUTFALL CONNECTION



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IMINARY SUBDIVISION PLAN 022 CAPITAL BOULEVARD RALEIGH, NORTH CAROLINA 27616



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NO. DATE

PLAN INFORMATION

PROJECT NO. MCR-23004
FILENAME MCR23004-RW1

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DRAWN BY CAW


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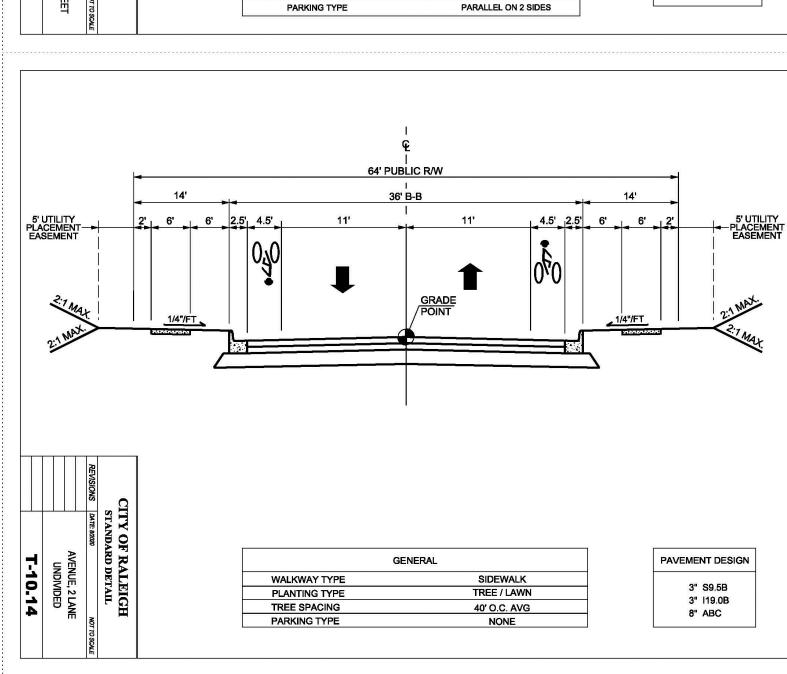
DATE 09. 08. 2

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OFFSITE ROADWAY IMPROVEMENTS

C7.00



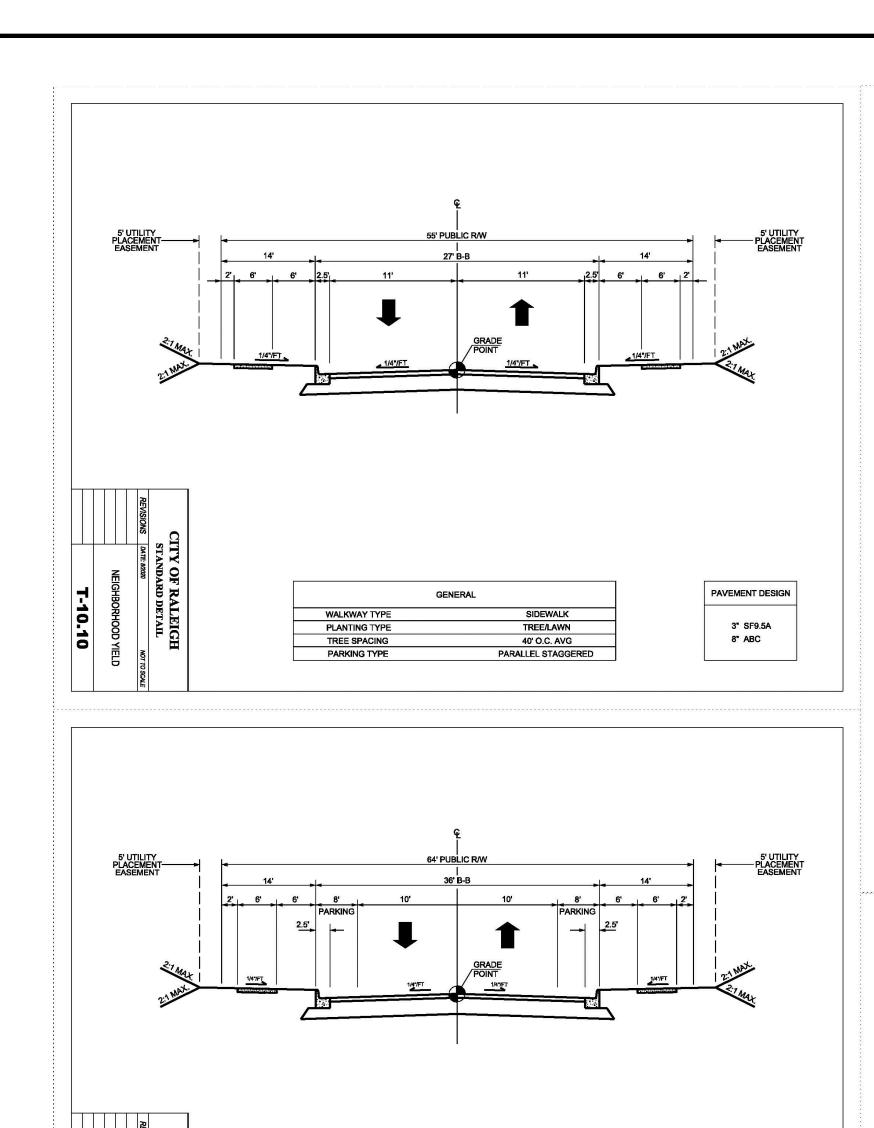

WALKWAY TYPE

PLANTING TYPE

TREE SPACING

SIDEWALK BOTH SIDES


TREE/LAWN


40' O.C. AVG


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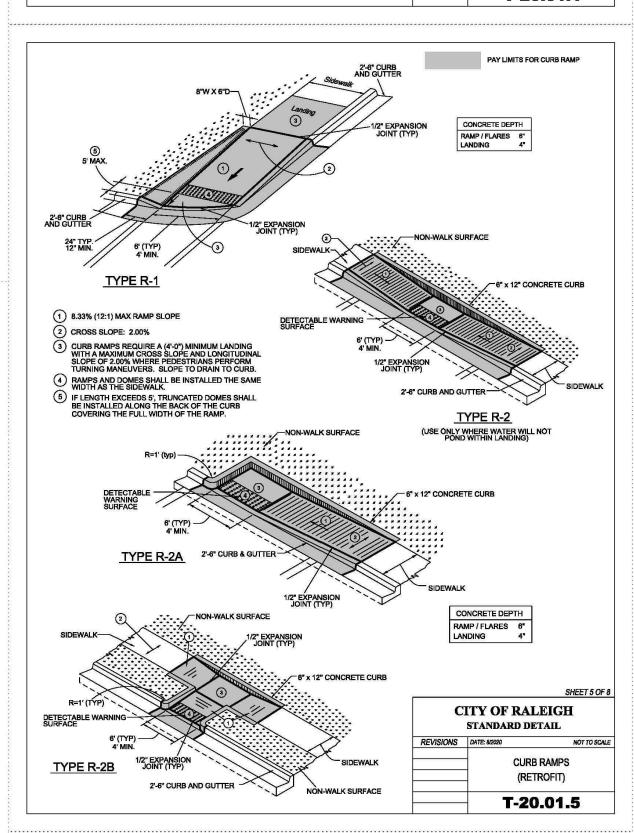
3" SF9.5A


8" ABC




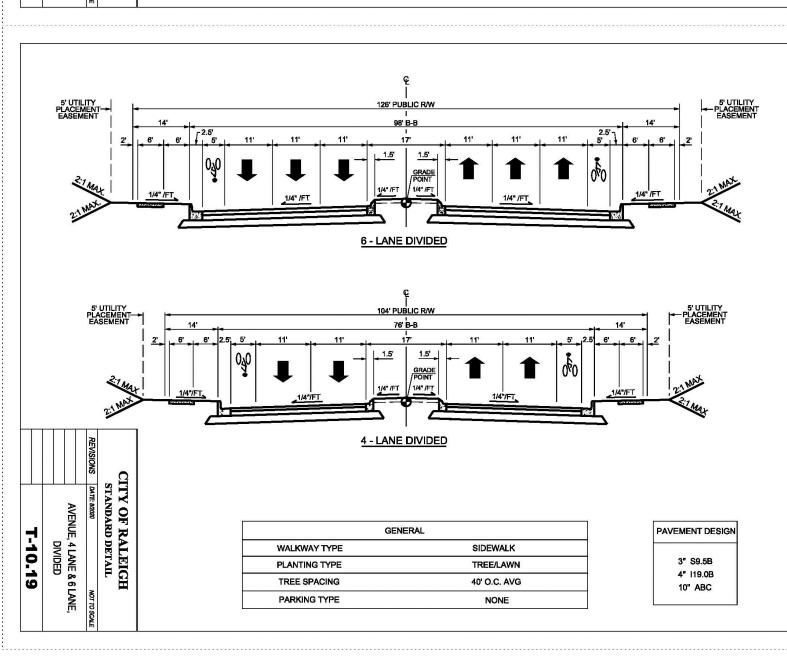


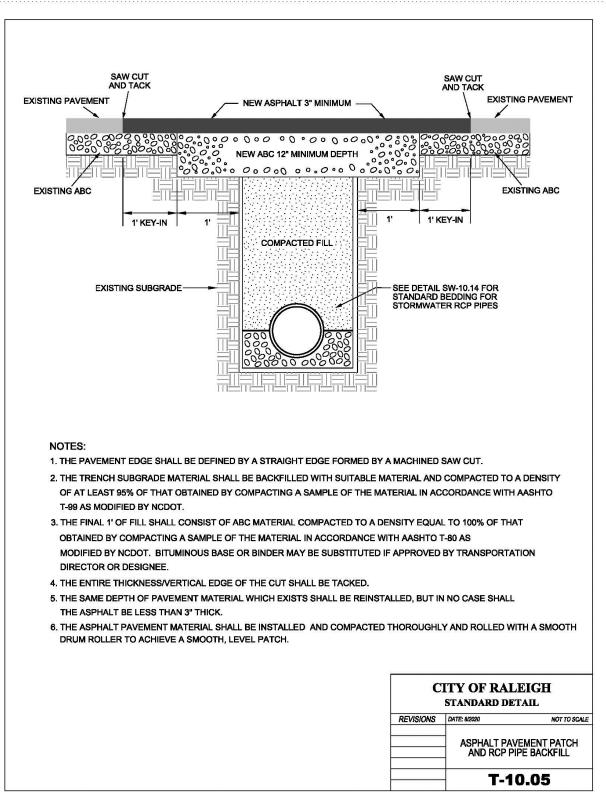


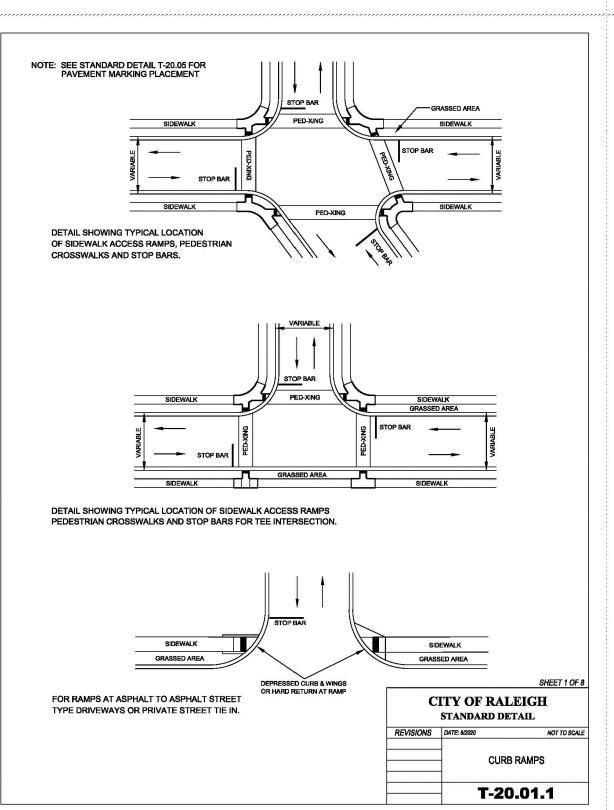


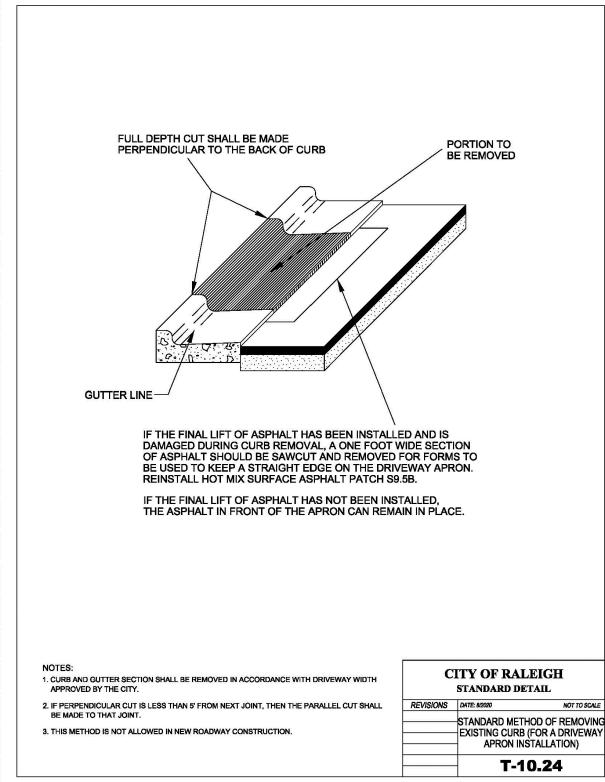

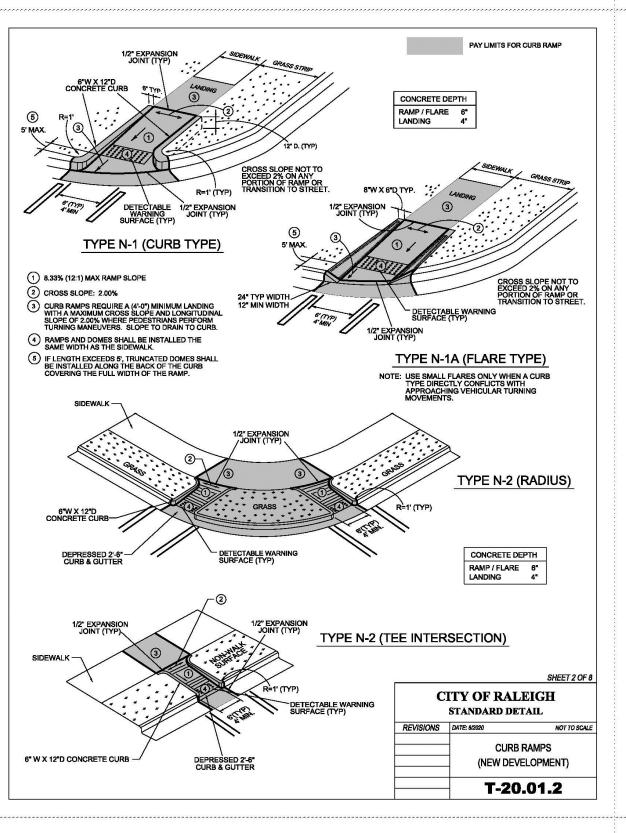

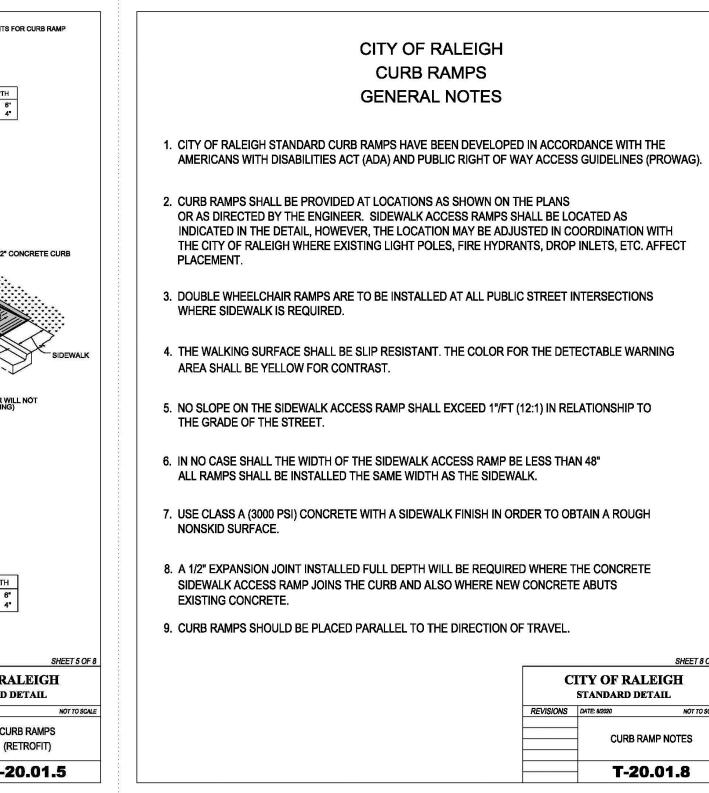

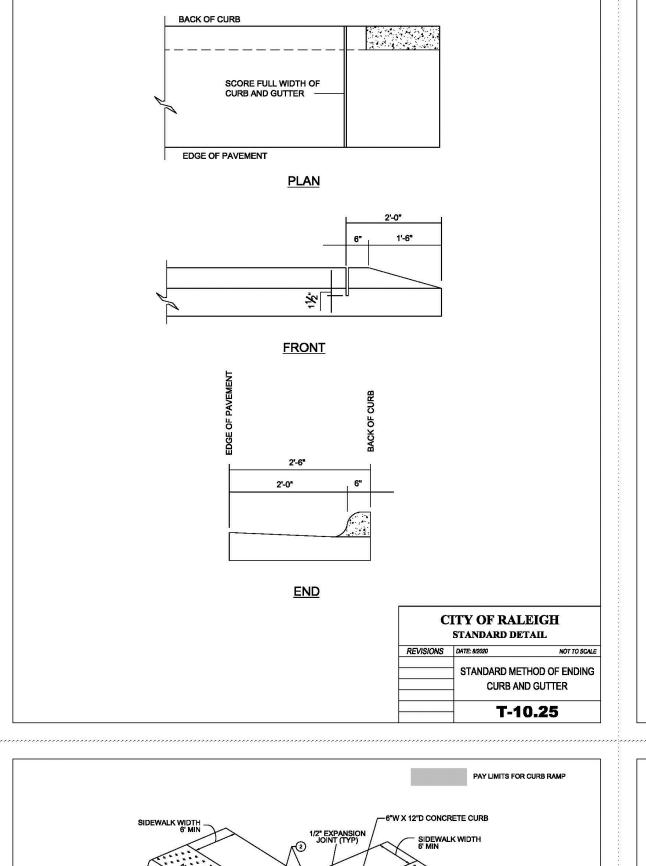

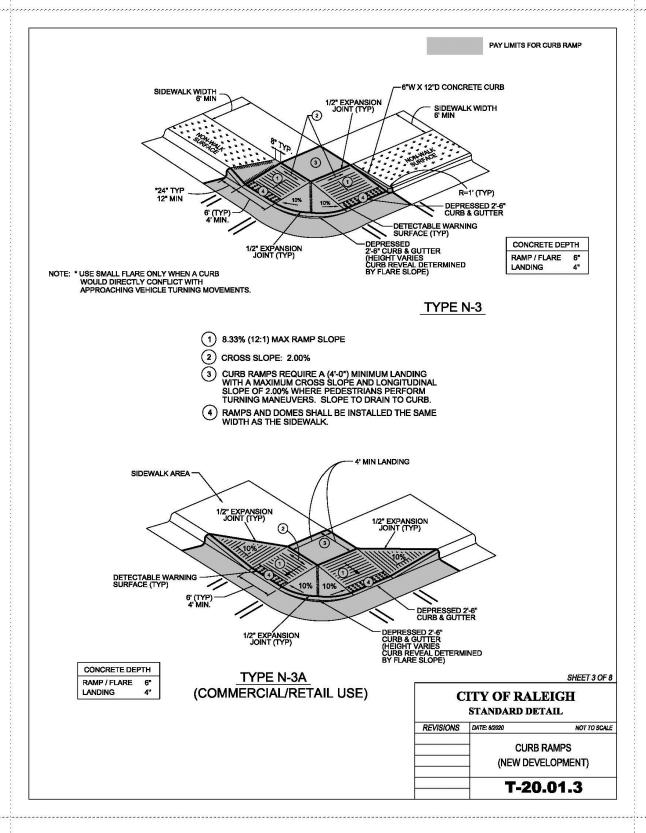

PARALLEL CURB RAMP


CITY OF RALEIGH


DETECTABLE WARNING

SURFACE PLACEMENT

T-20.04.1


CROSS SLOPE NOT TO EXCEED 2% ON ANY PORTION OF RAMP OR TRANSITION TO STREE

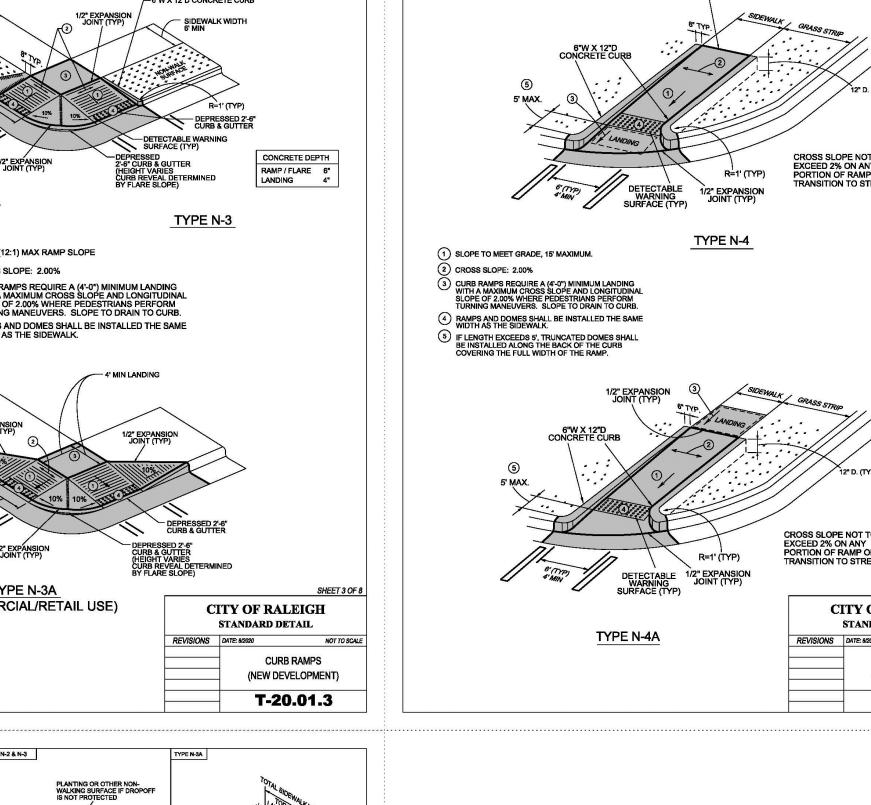

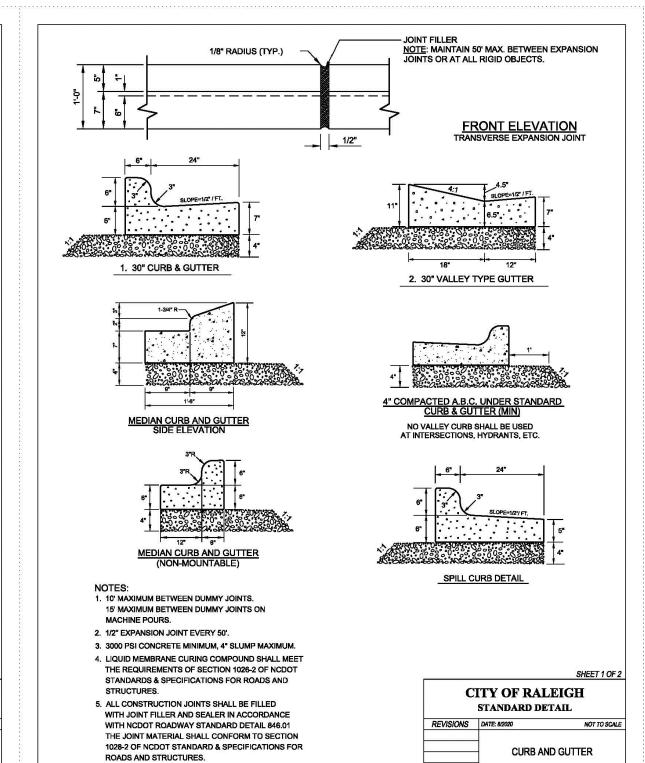

6. REFER TO NCDOT DETAIL 846.01 FOR CURB AND

GUTTER SUPERELEVATION RATES.

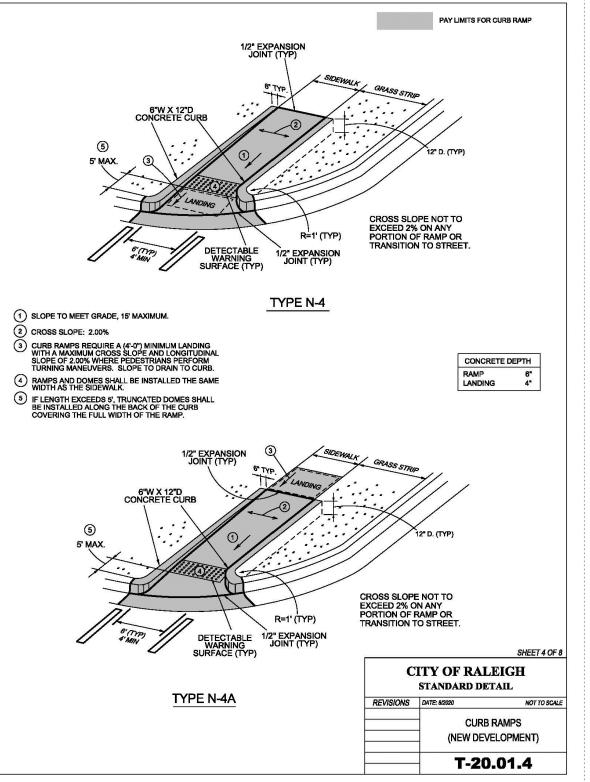

T-10.26.1




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phone 919. 361. 5000

fax 919. 361. 2269

license number: C-0293, C-187



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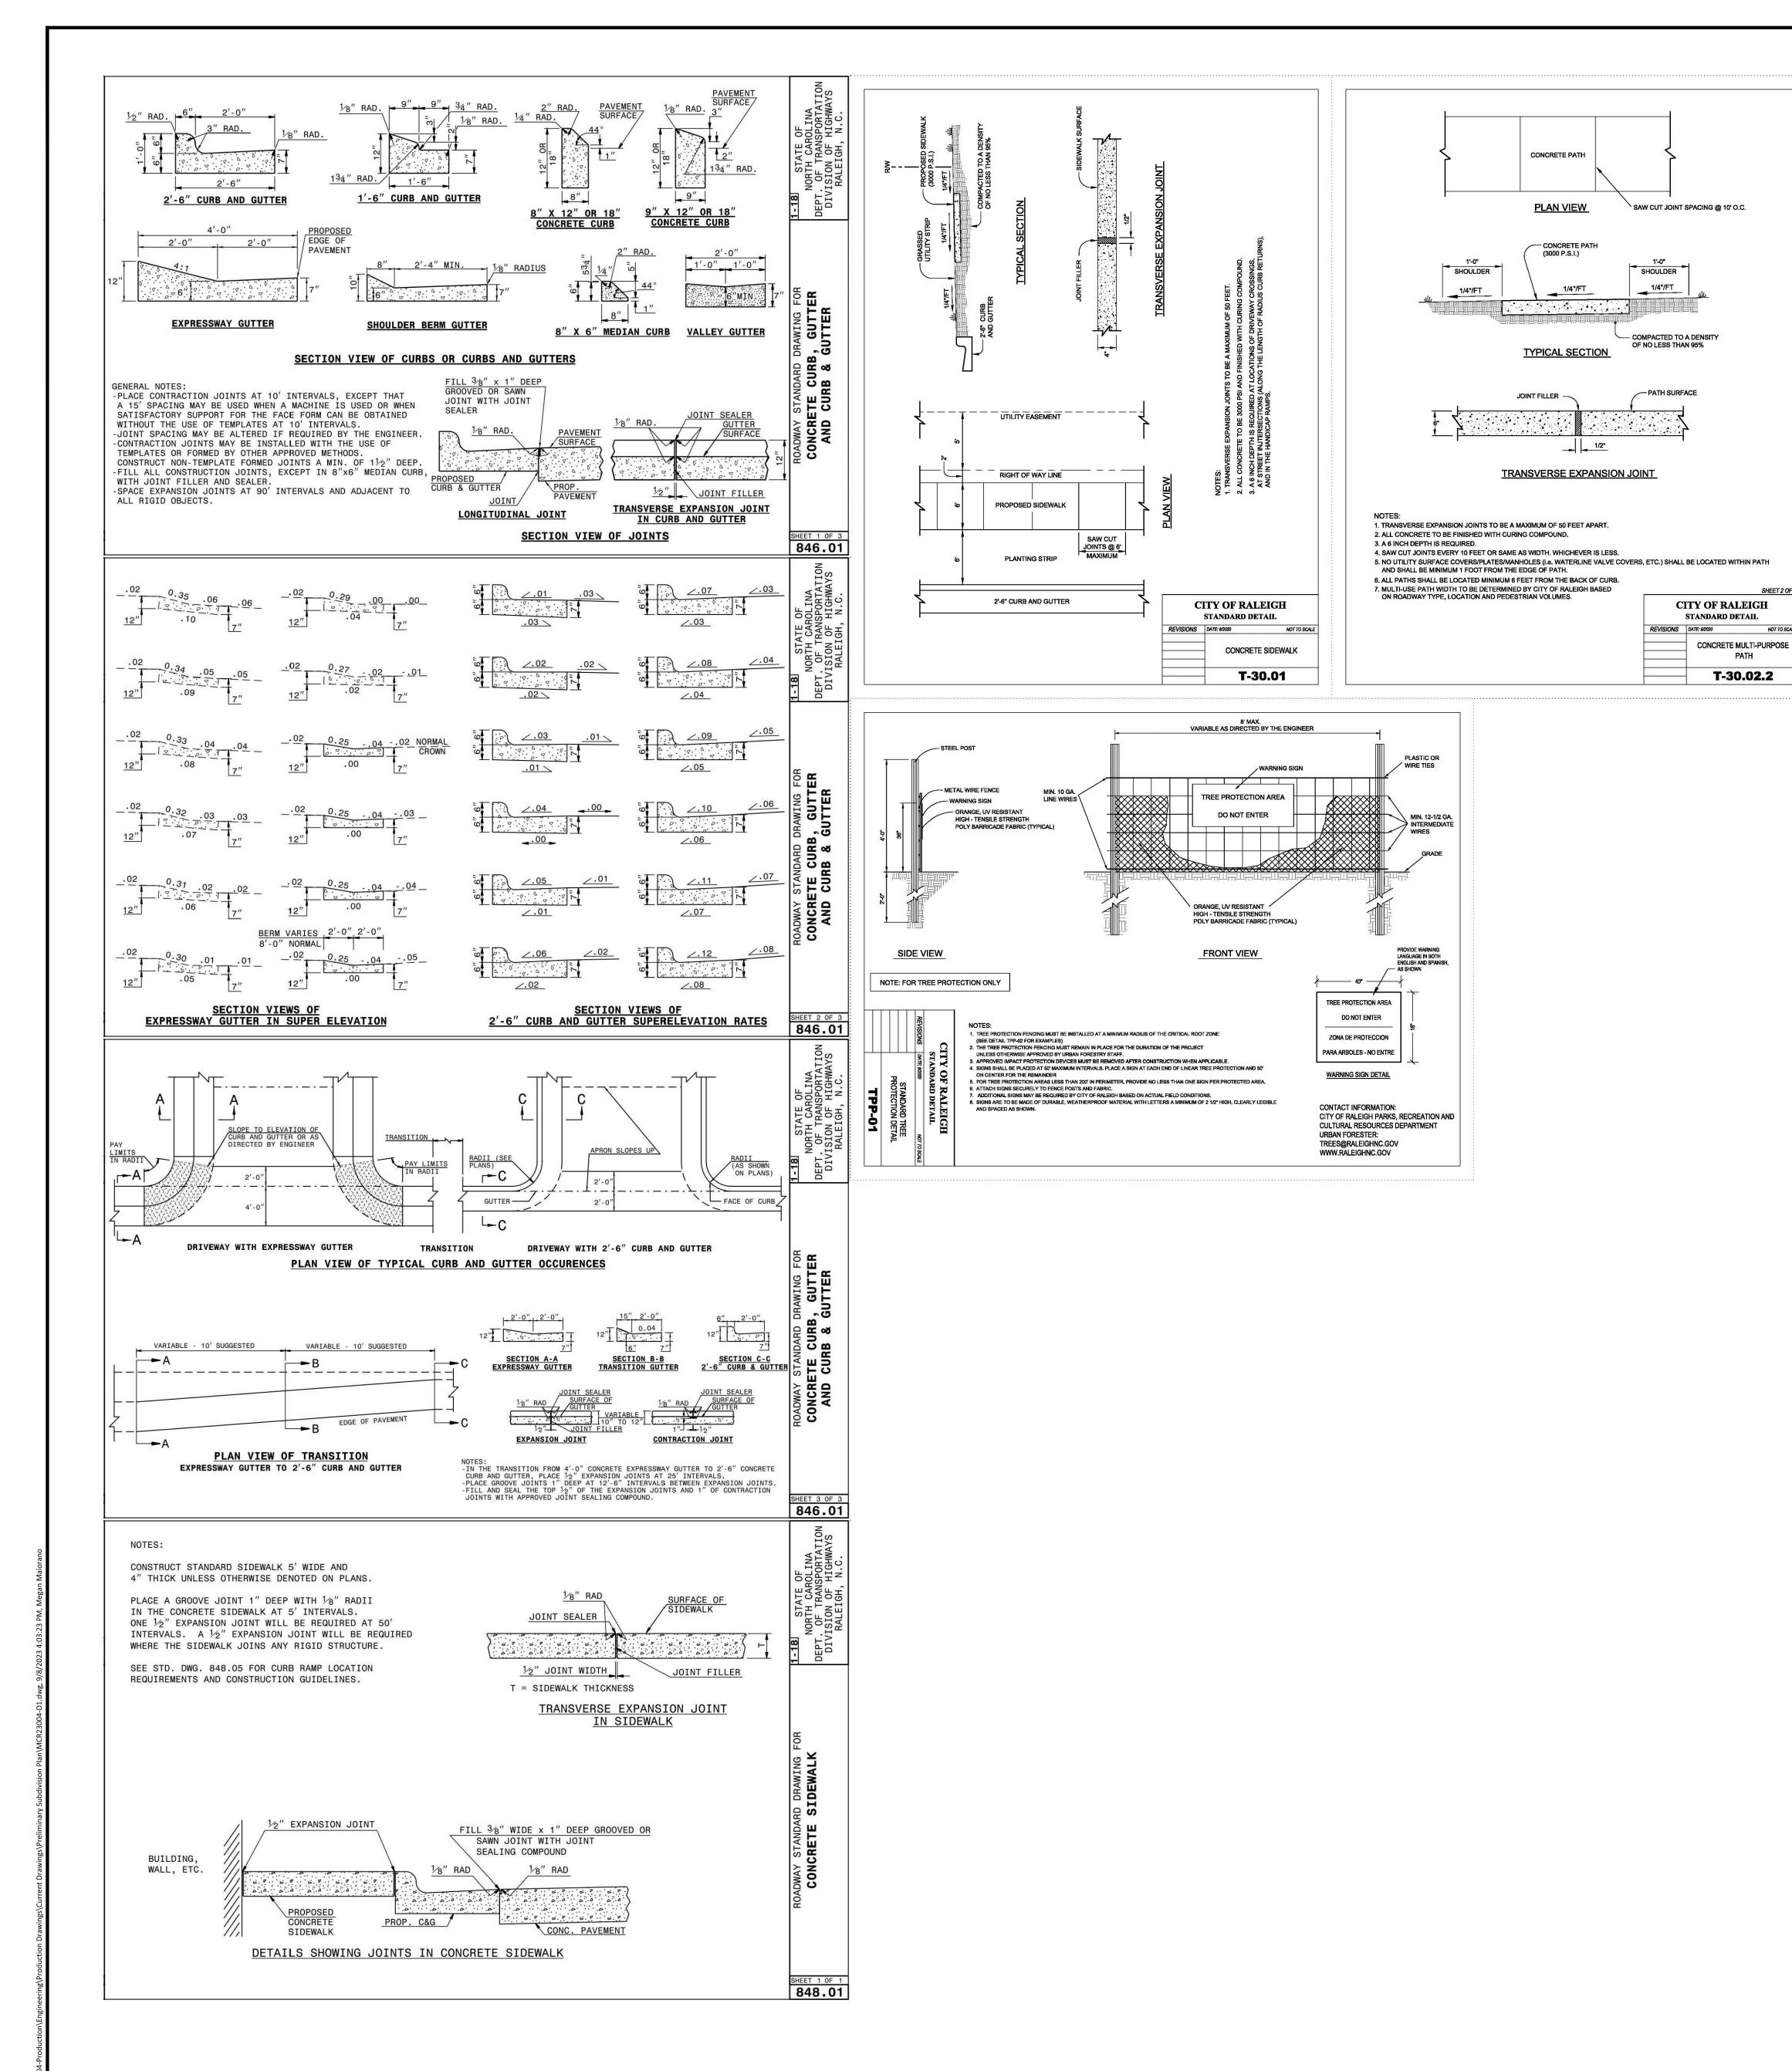
PLAN INFORMATION

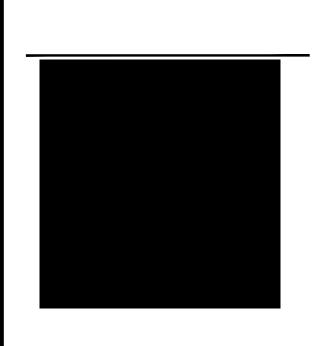PROJECT NO. MCR-23004 FILENAME CHECKED BY ACP

DATE

C8.00

SITE DETAILS



PATH




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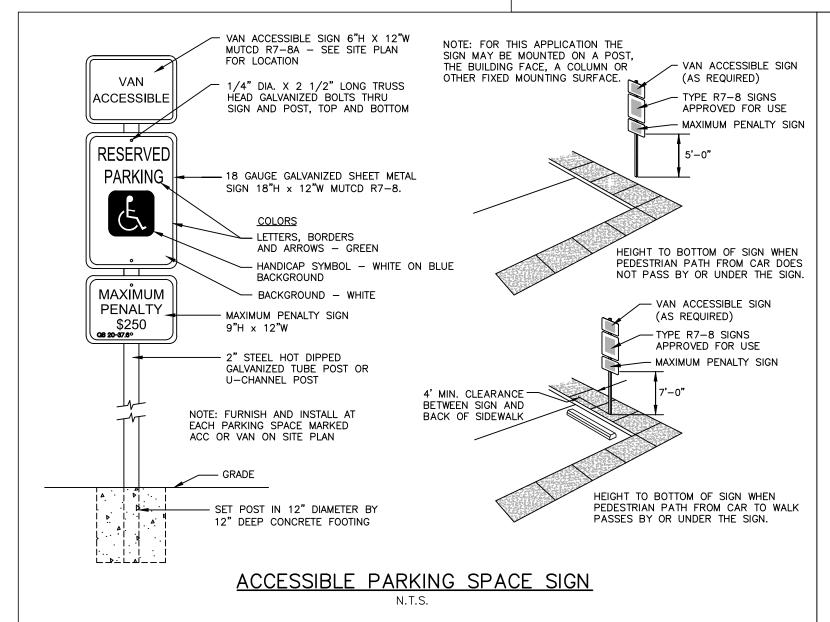
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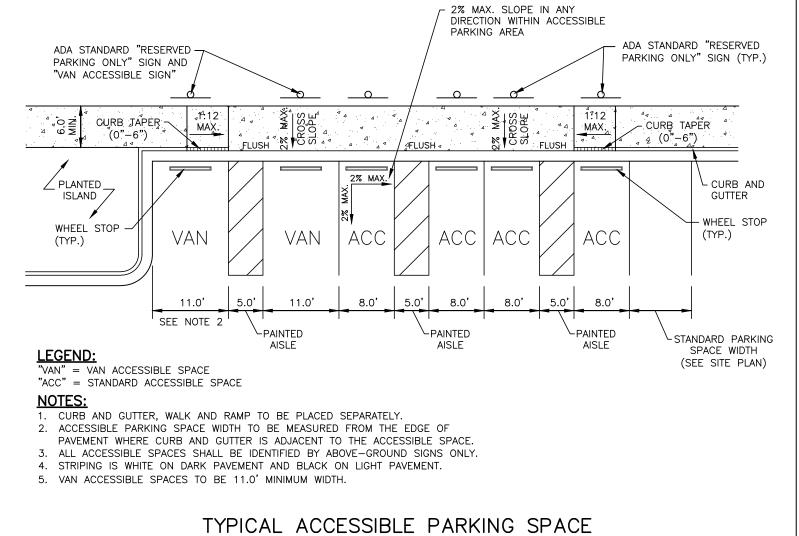
PROJECT NO. MCR-23004

FILENAME MCR23004-D1 CHECKED BY ACP


SITE DETAILS

C8.01

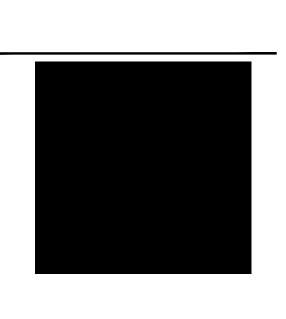



LAYOUT, RAMP AND SIGN LOCATIONS N.T.S.

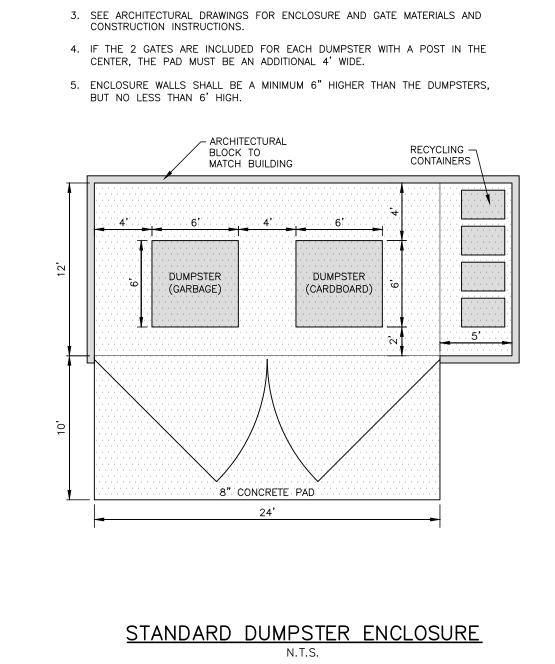


NOTES:

1. DUMPSTER PAD AND APPROACH PAD SHOULD BE 8" THICK CONCRETE

2. CURBS OR BUMPERS AT THE REAR OF EACH DUMPSTER ARE REQUIRED.

REINFORCED WITH REBAR PER GEOTECHNICAL ENGINEER'S RECOMMENDATION

N.T.S.

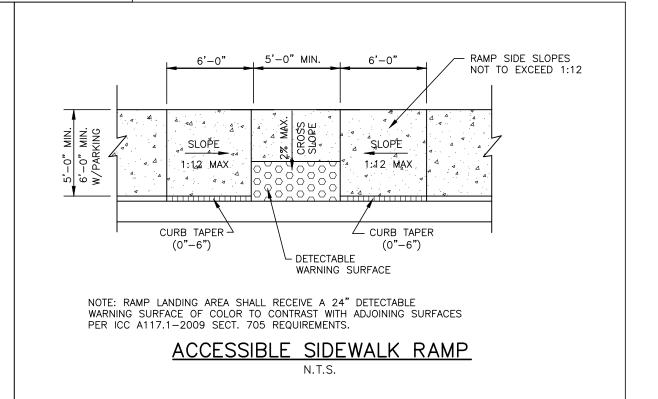

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REVISIONS

NO. DATE


PLAN INFORMATION

PROJECT NO. MCR-23004

FILENAME MCR23004-D1 CHECKED BY ACP DRAWN BY MEM

C8.02

SITE DETAILS

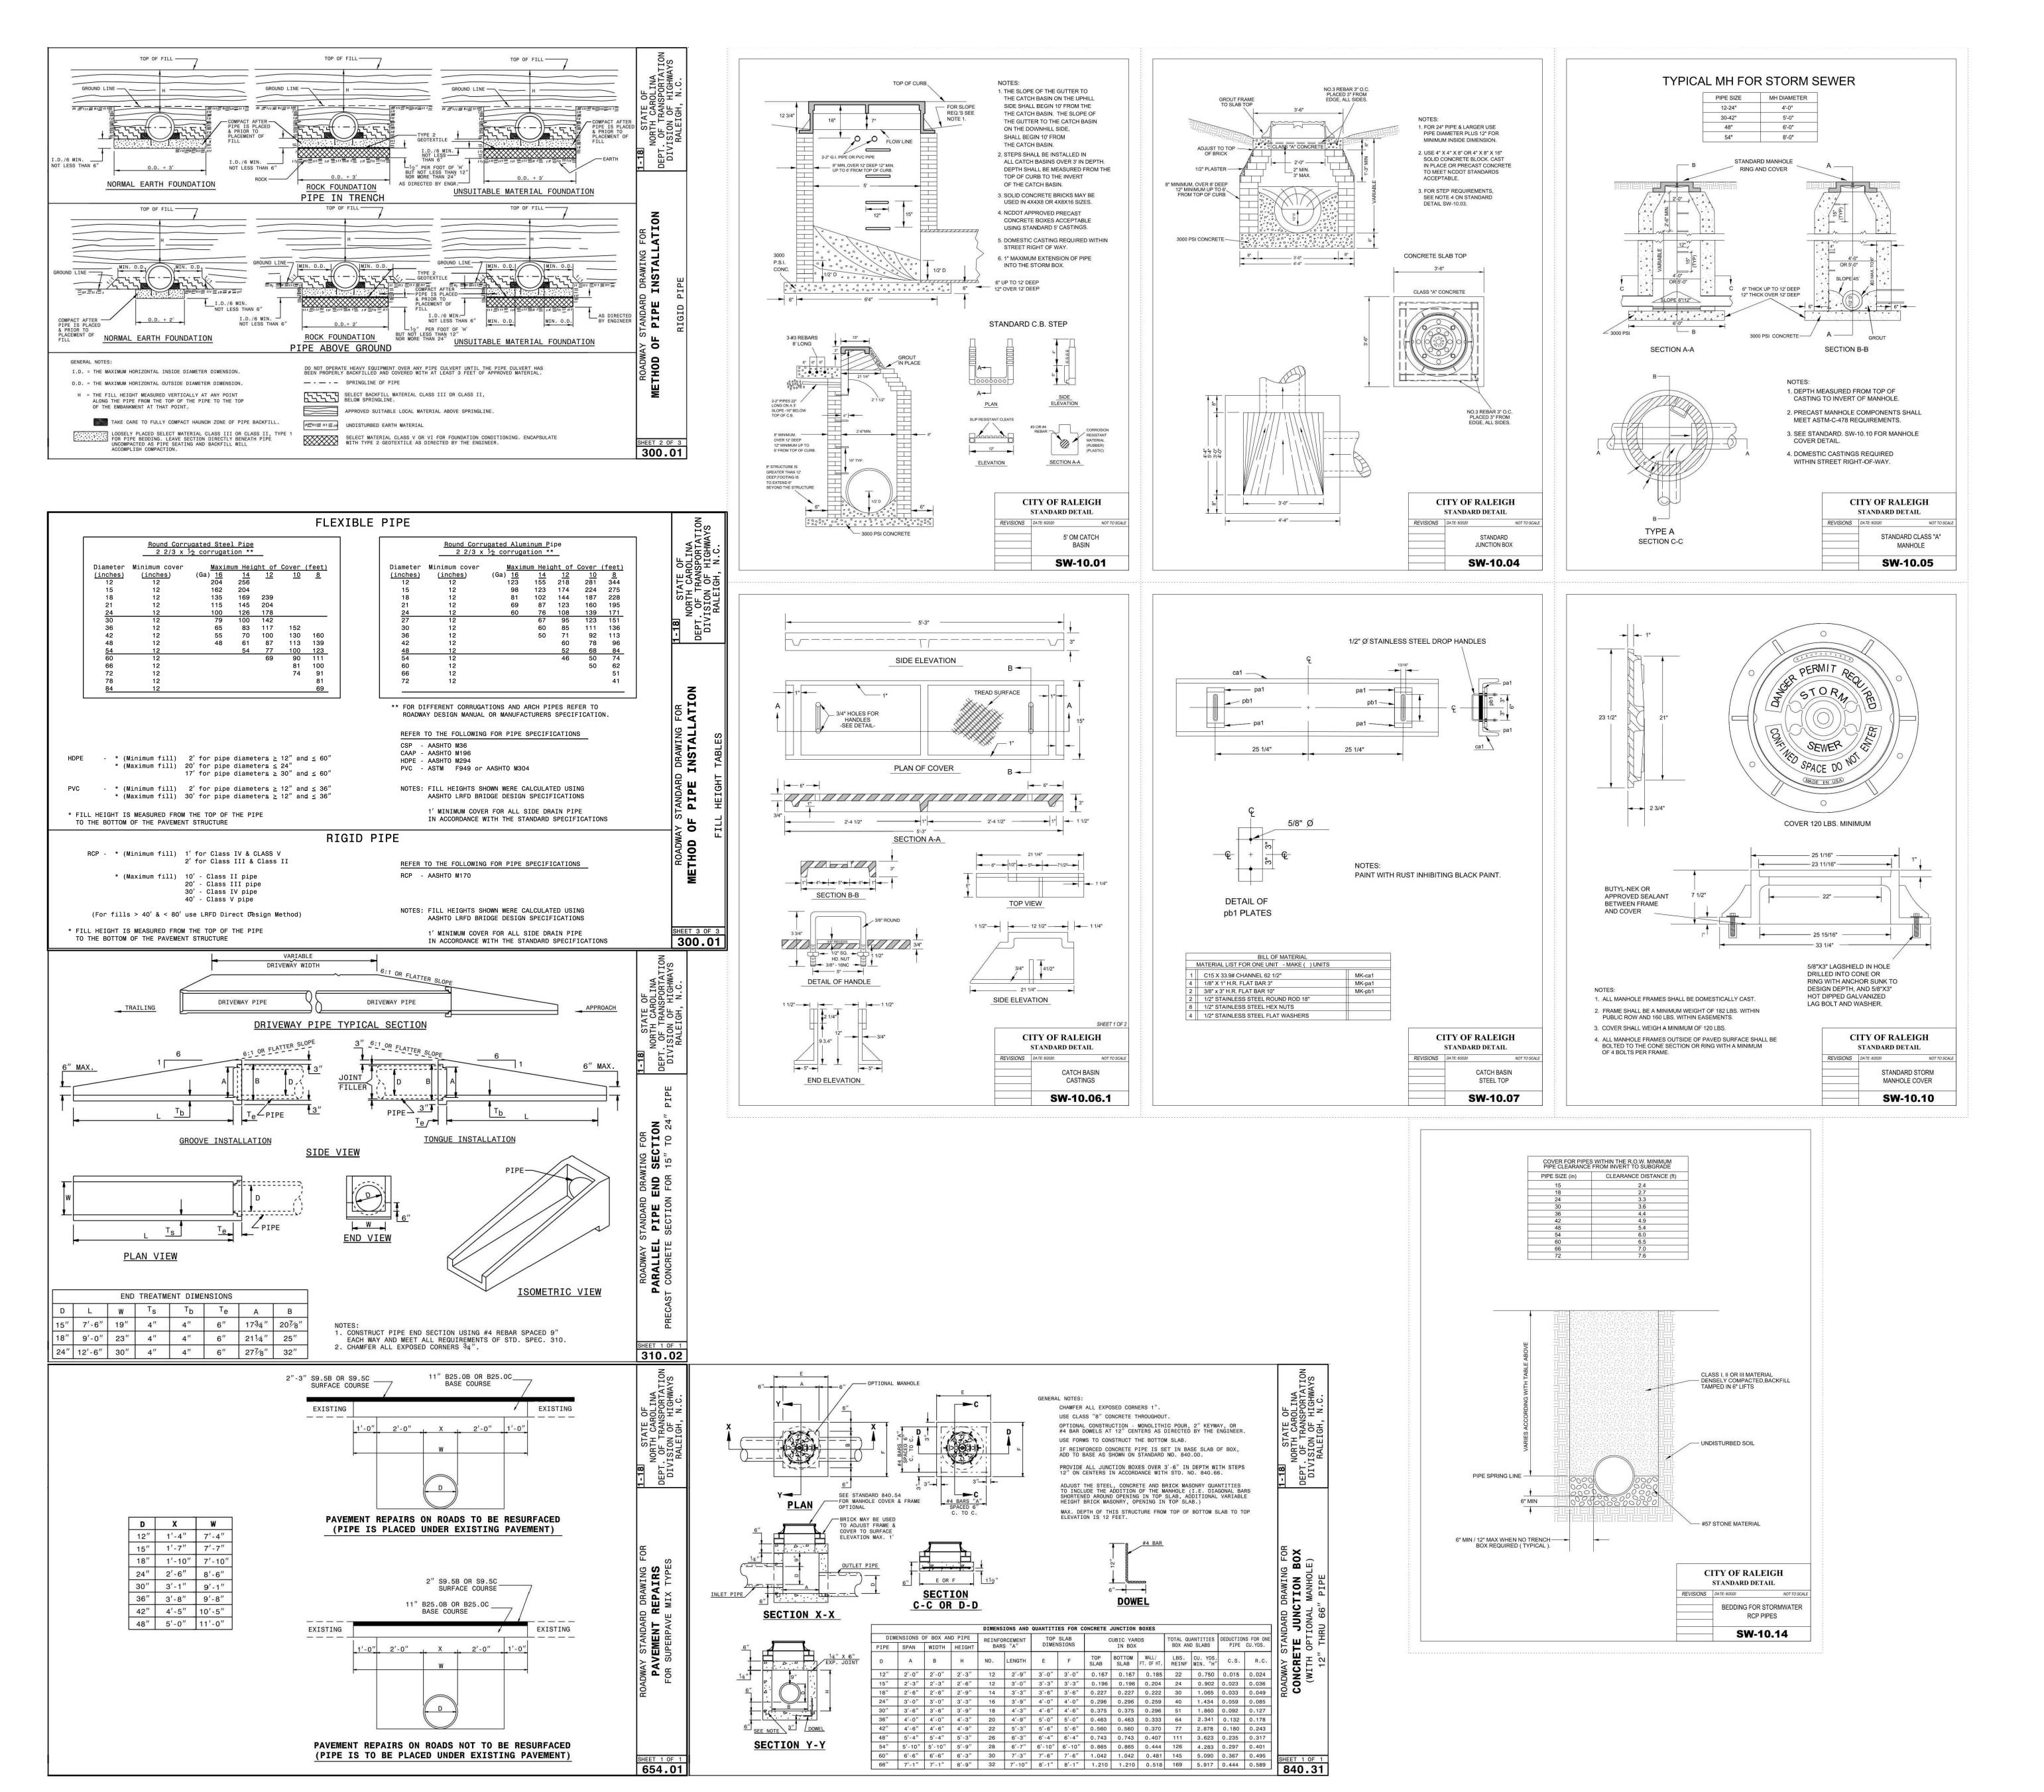



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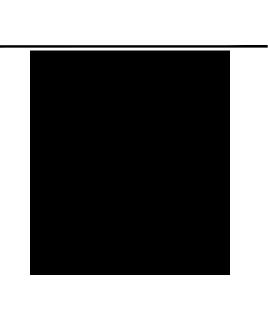
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PLAN INFORMATION

PROJECT NO. MCR-23004 FILENAME MCR23004-D1 CHECKED BY ACP DRAWN BY SCALE

DATE 09. 08. 2023

SHEET

STORM DETAILS

SECTION A-A




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REVISIONS

NO. DATE

PLAN INFORMATION


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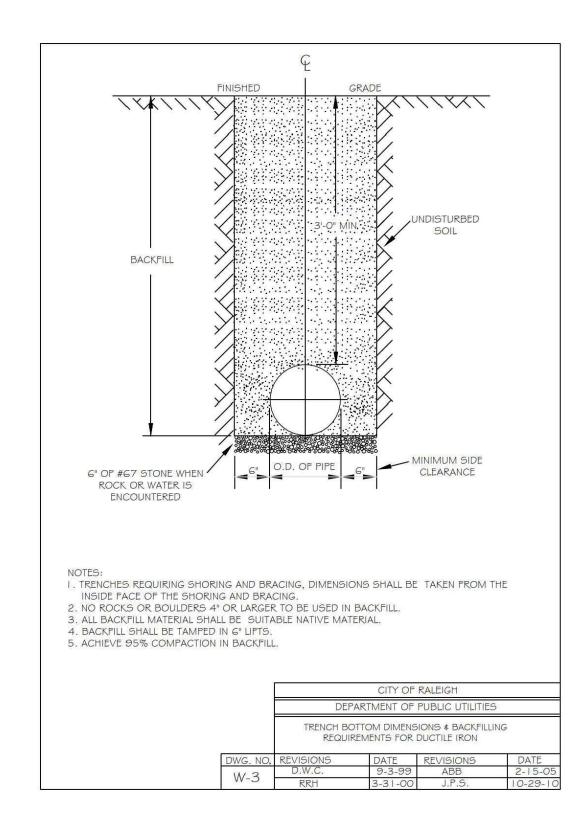
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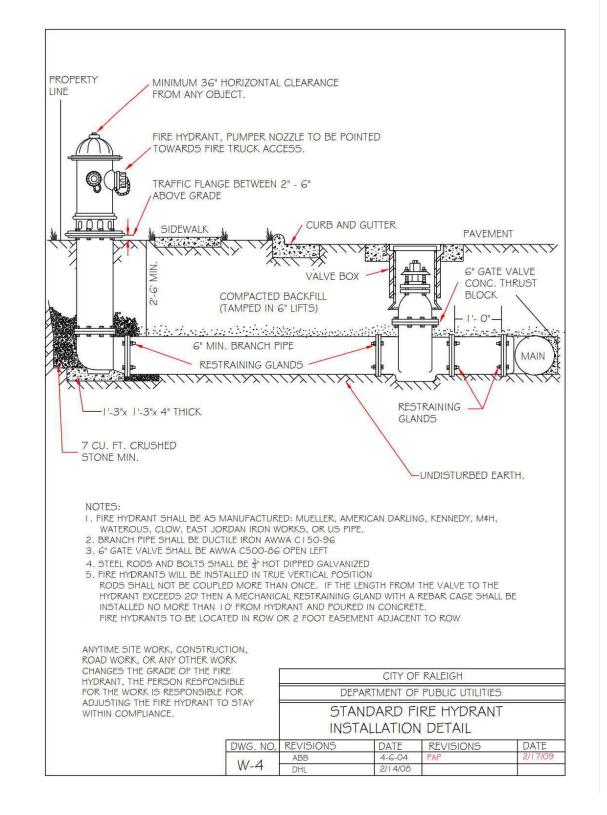
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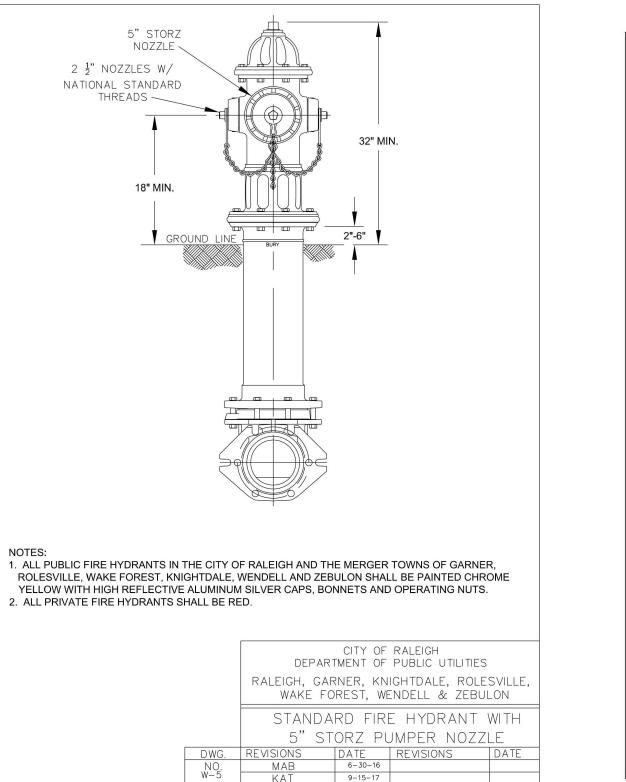
PRELIMINARY DRAWING - NOT RELEASED FOR CONSTRUCTION

STORM DETAILS

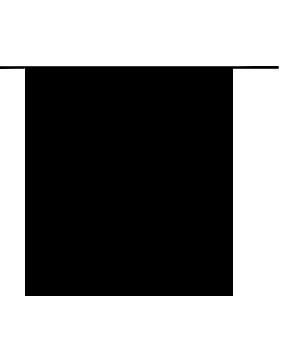








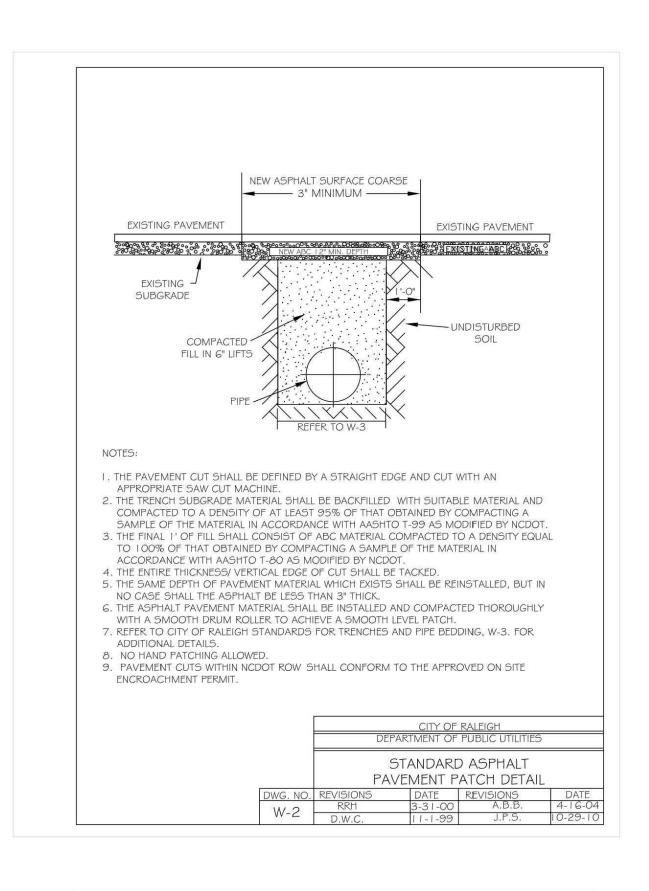



GATE / TAPPING VALVE

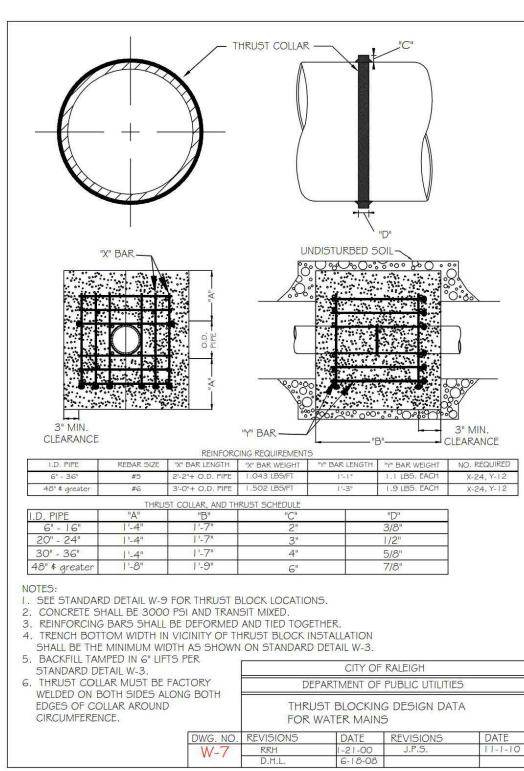


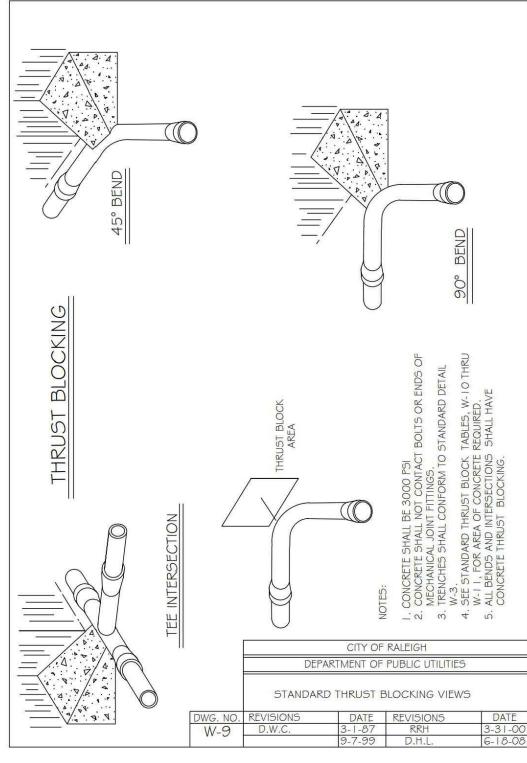


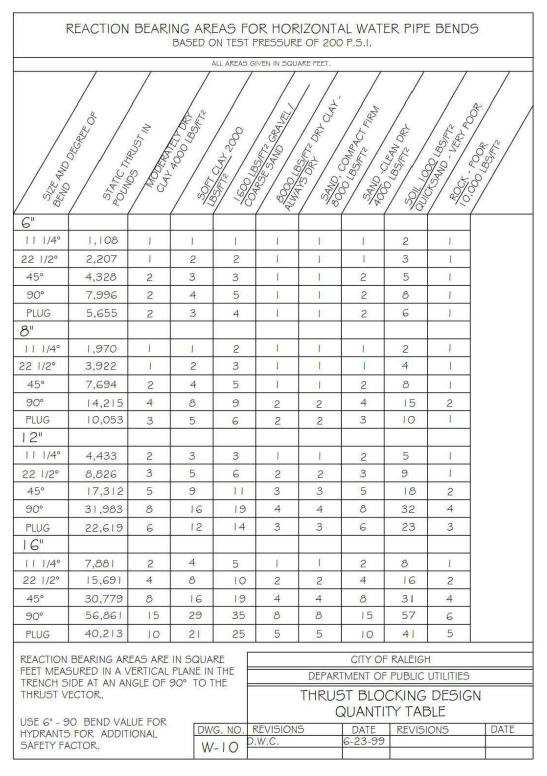


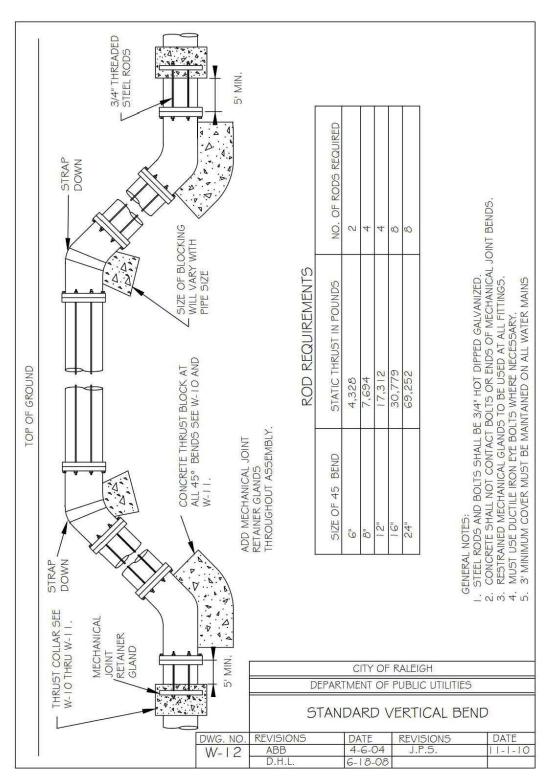


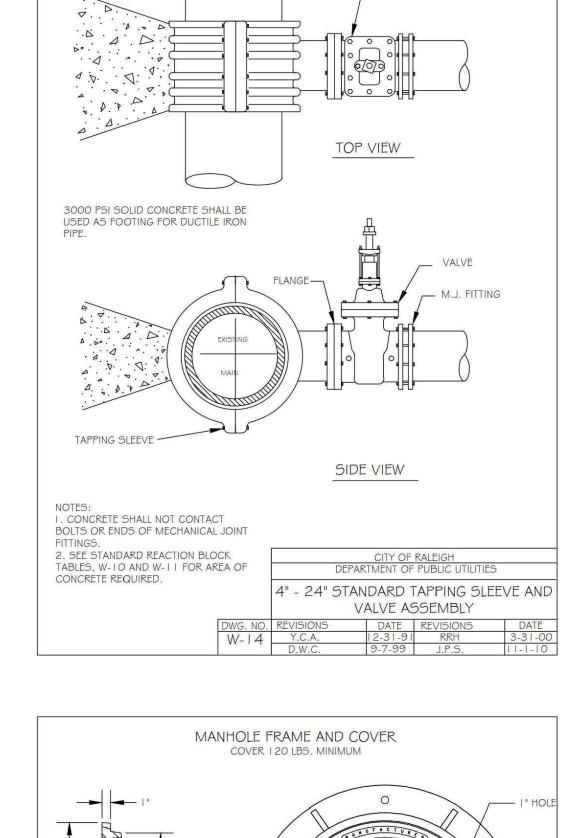


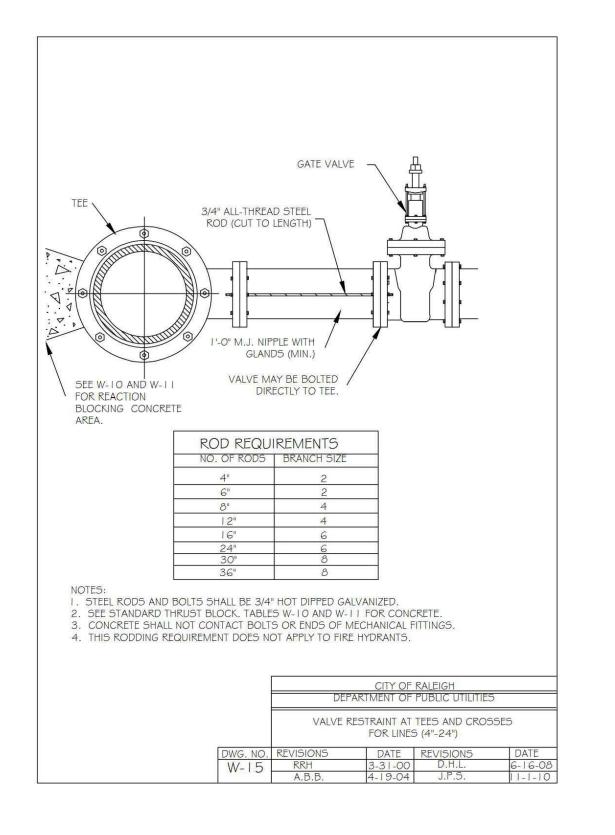


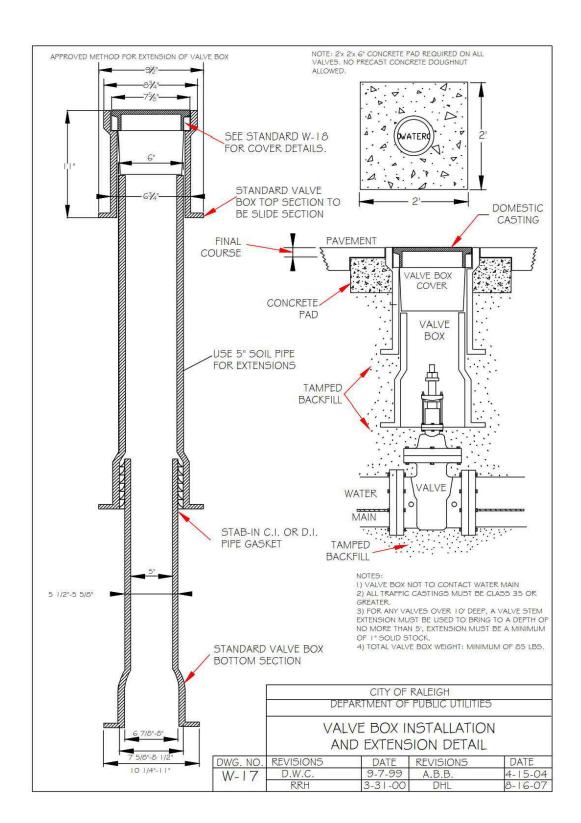

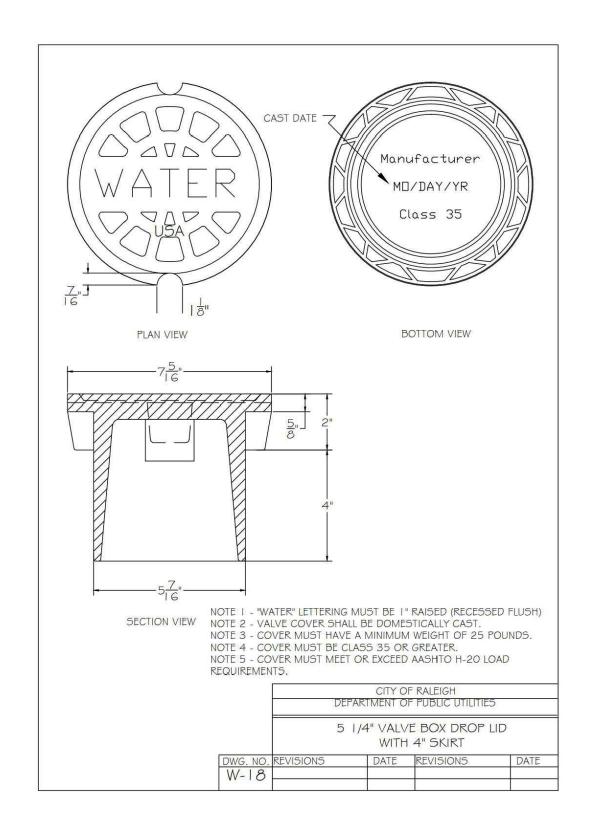

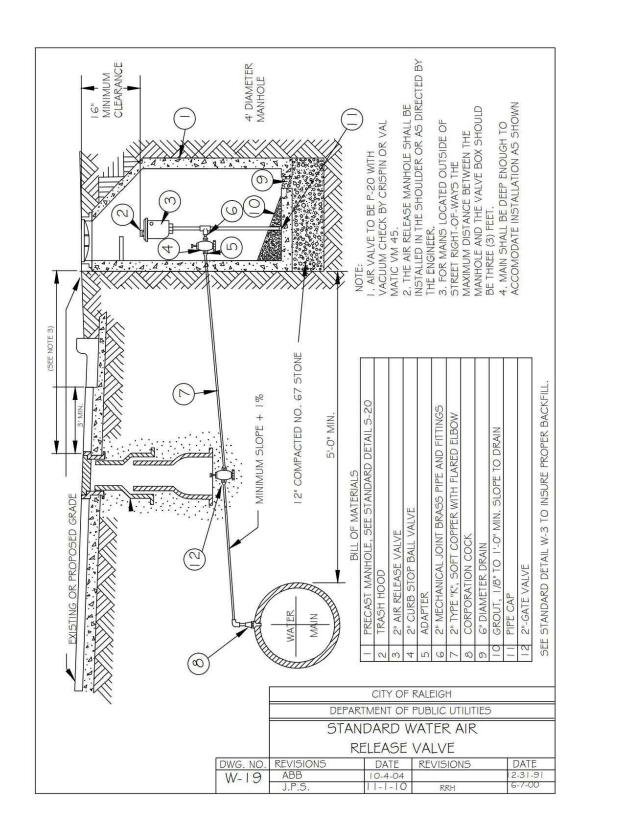

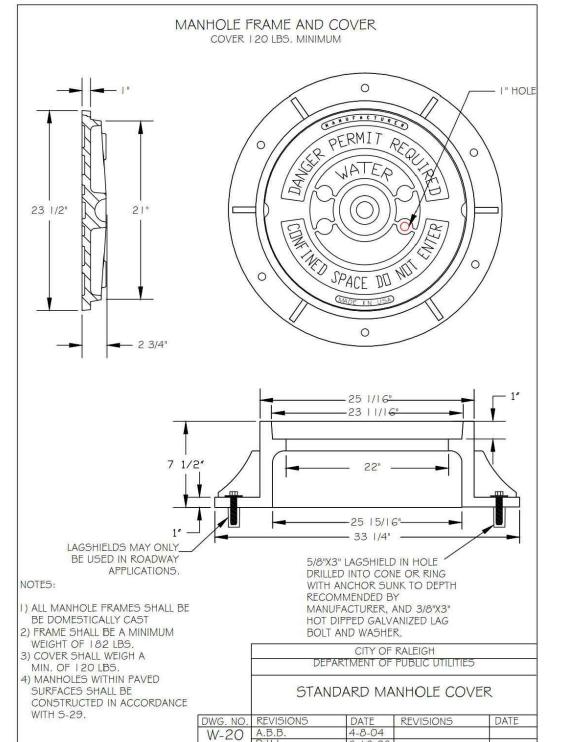

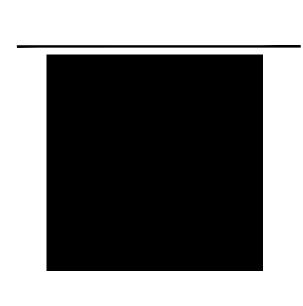

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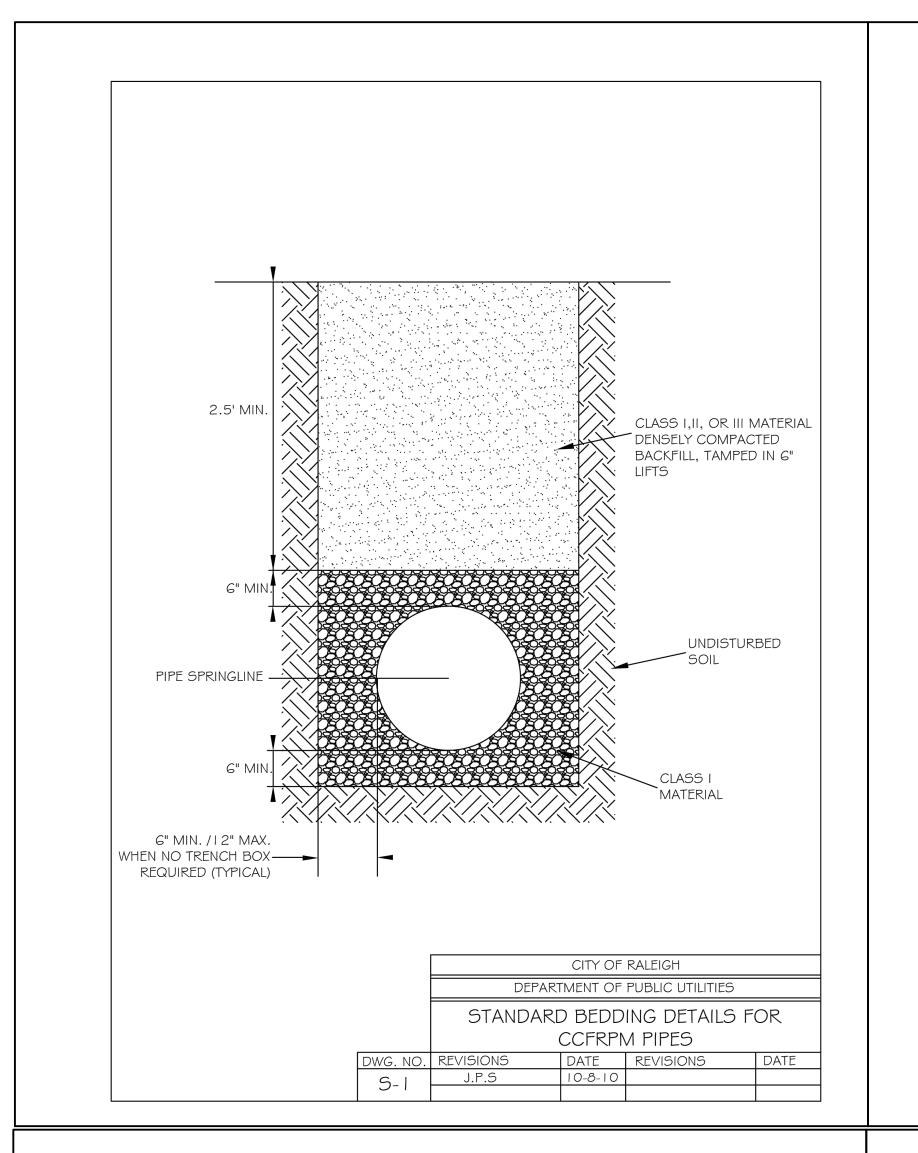
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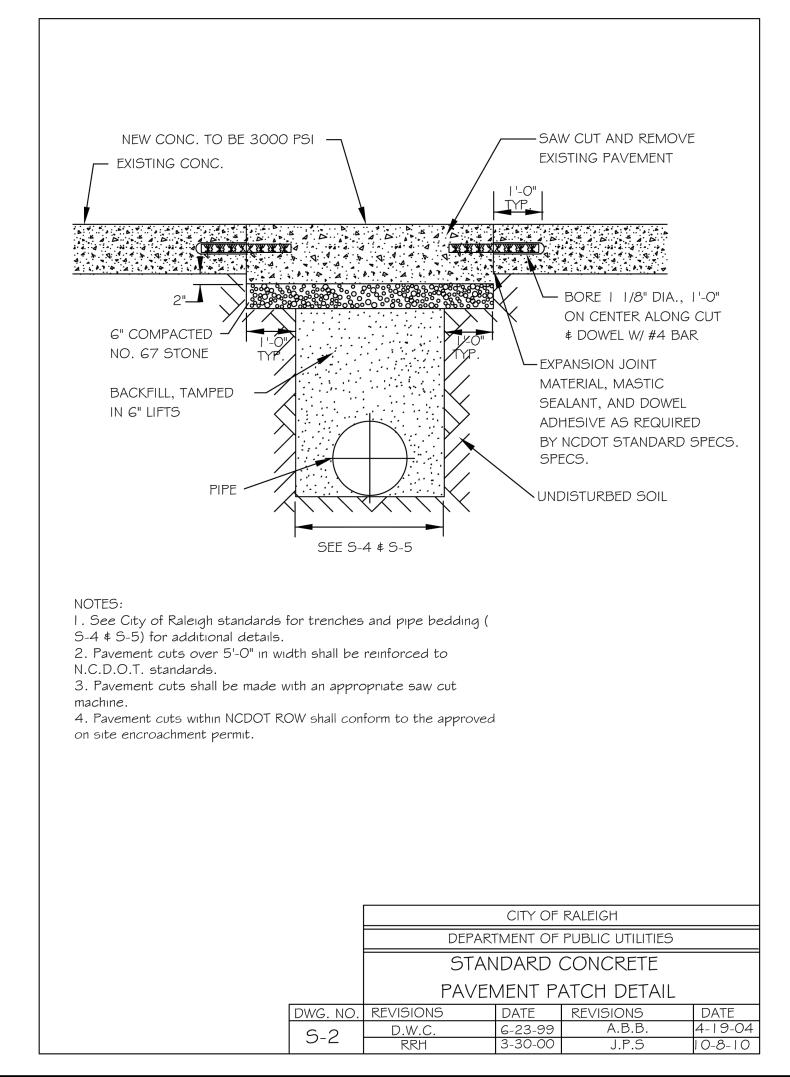
PROJECT NO. MCR-23004 FILENAME MCR23004-D1 CHECKED BY ACP DRAWN BY MEM SCALE


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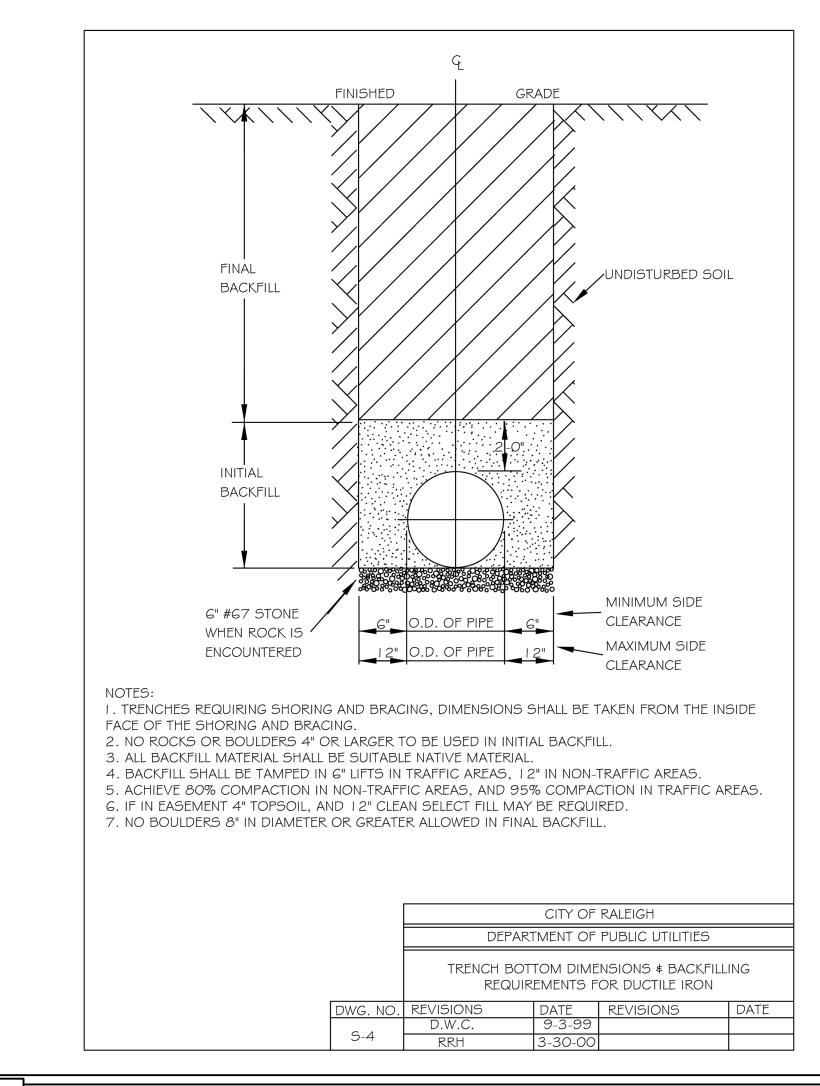
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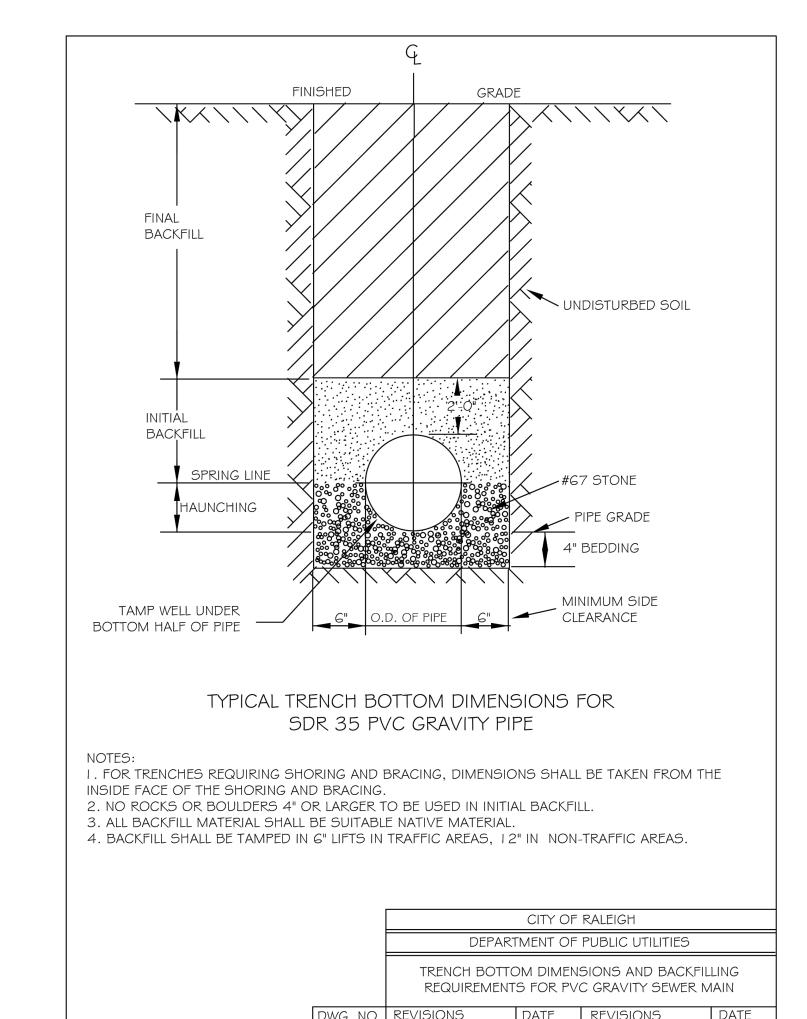
WATER DETAILS












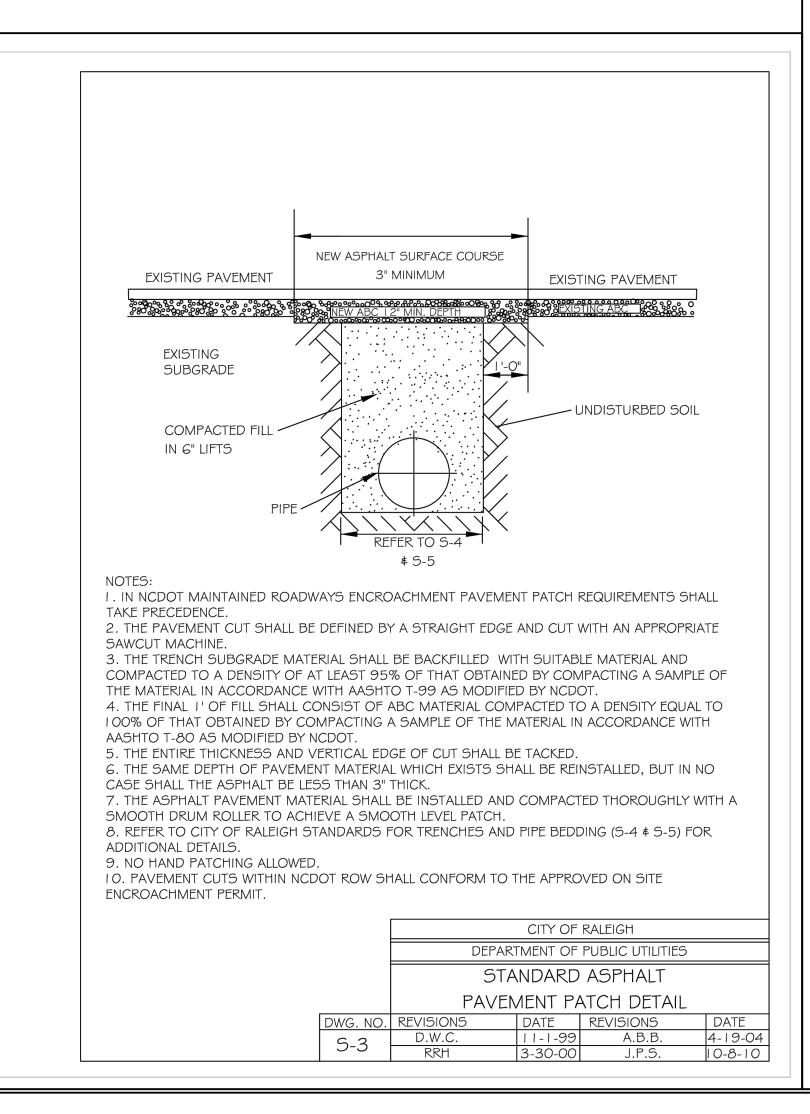

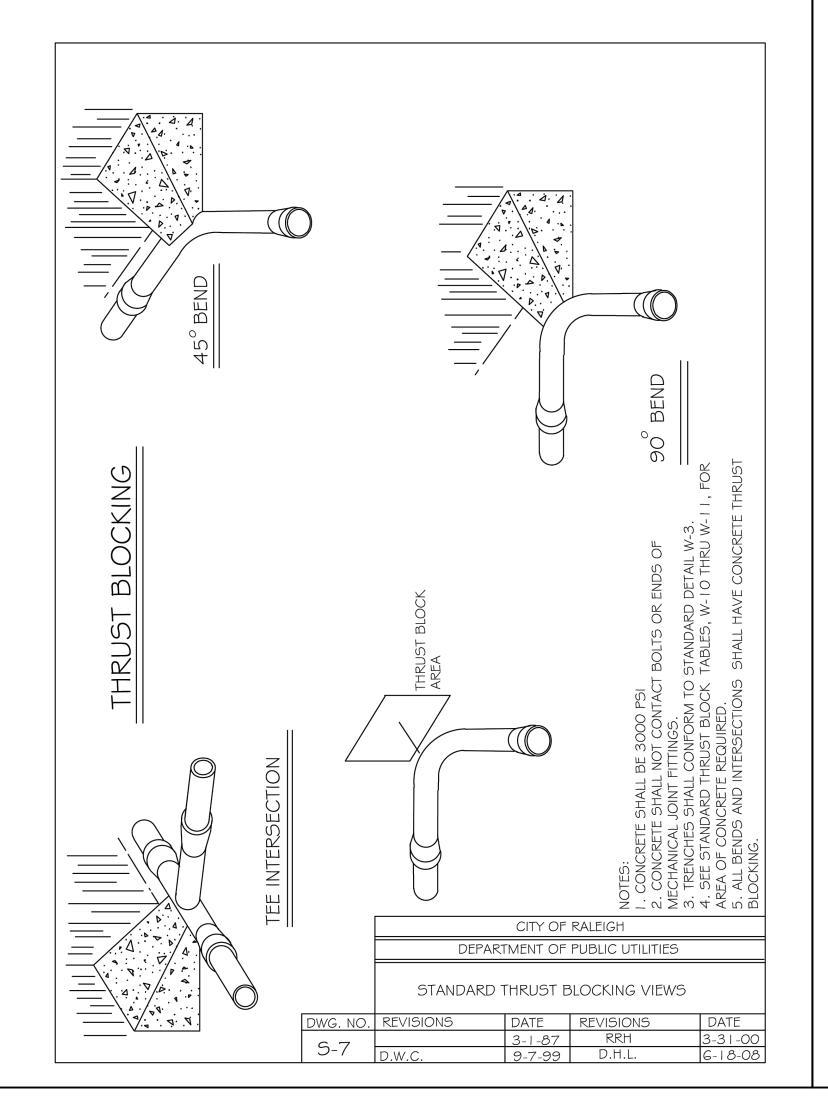

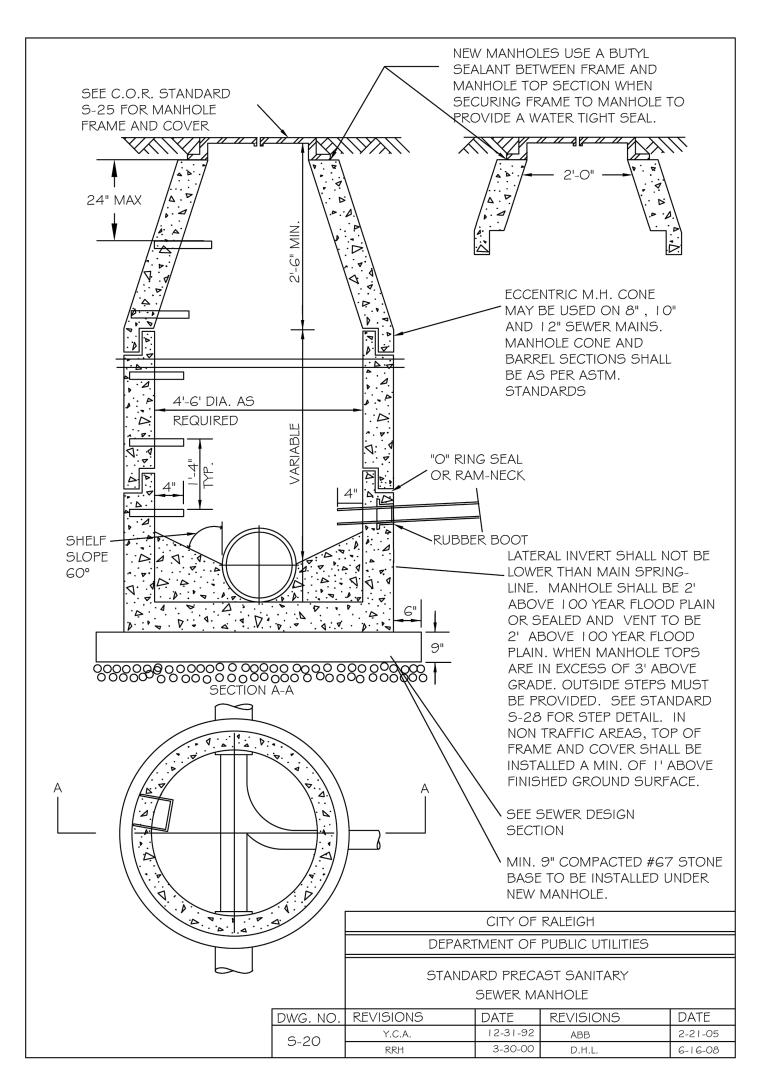

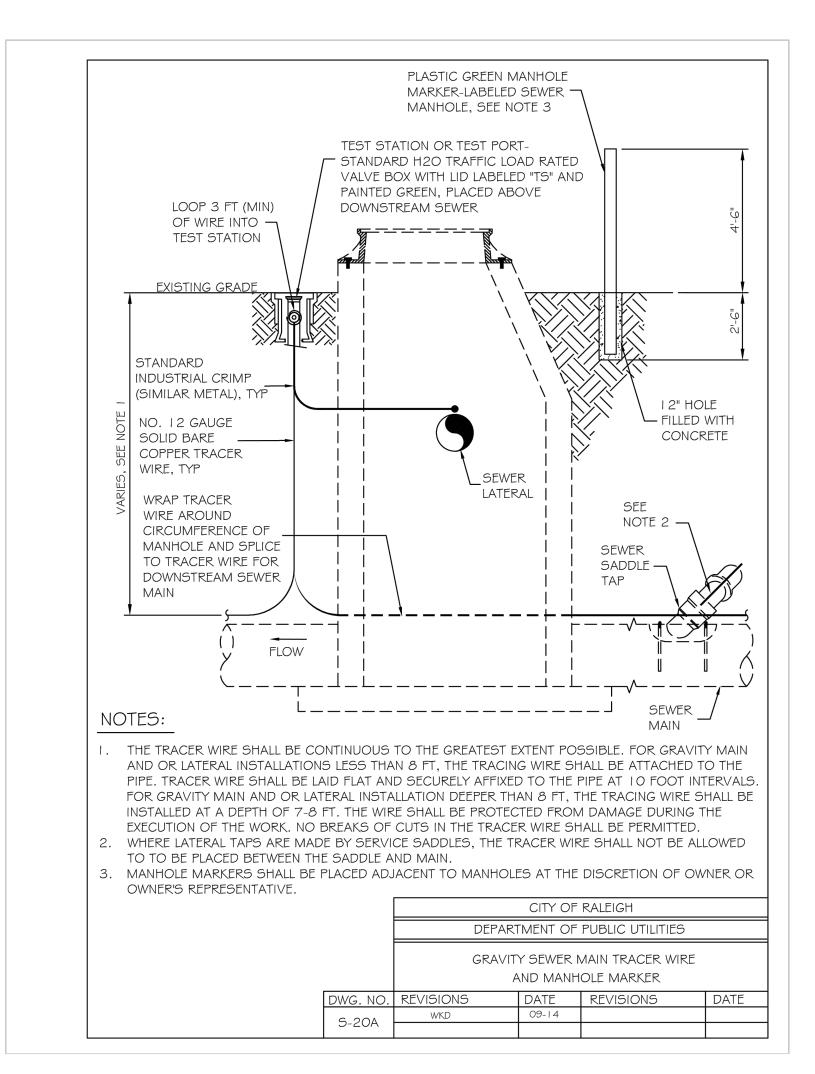



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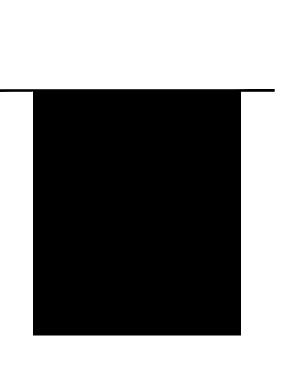
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REVISIONS

NO. DATE


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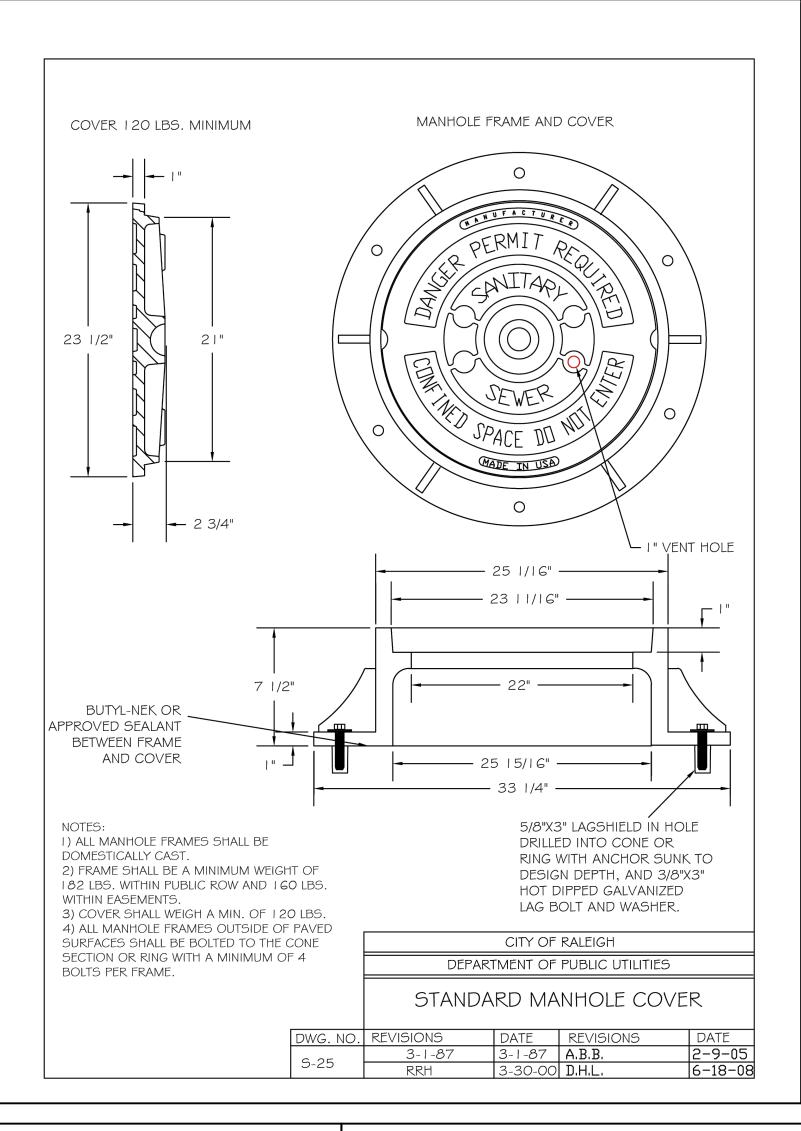
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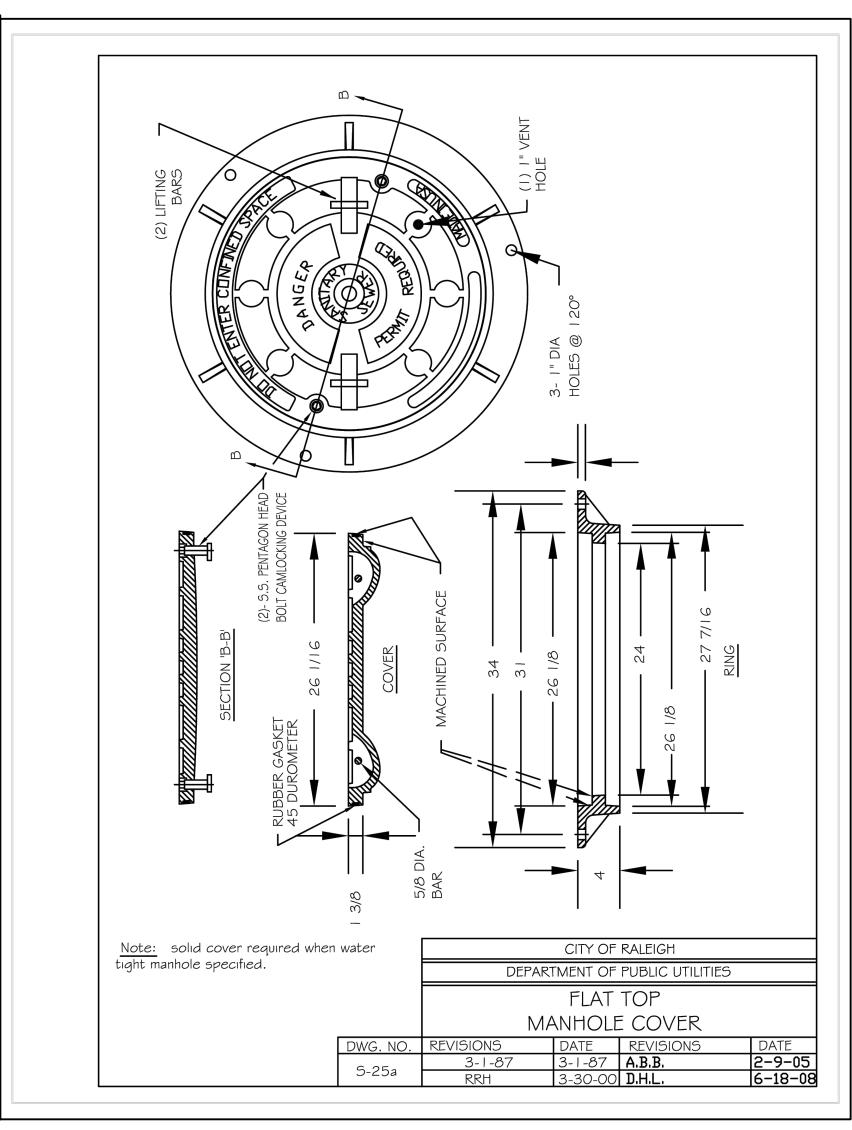
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CHECKED BY ACP
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SCALE N.T.S.
DATE 09. 08. 2023


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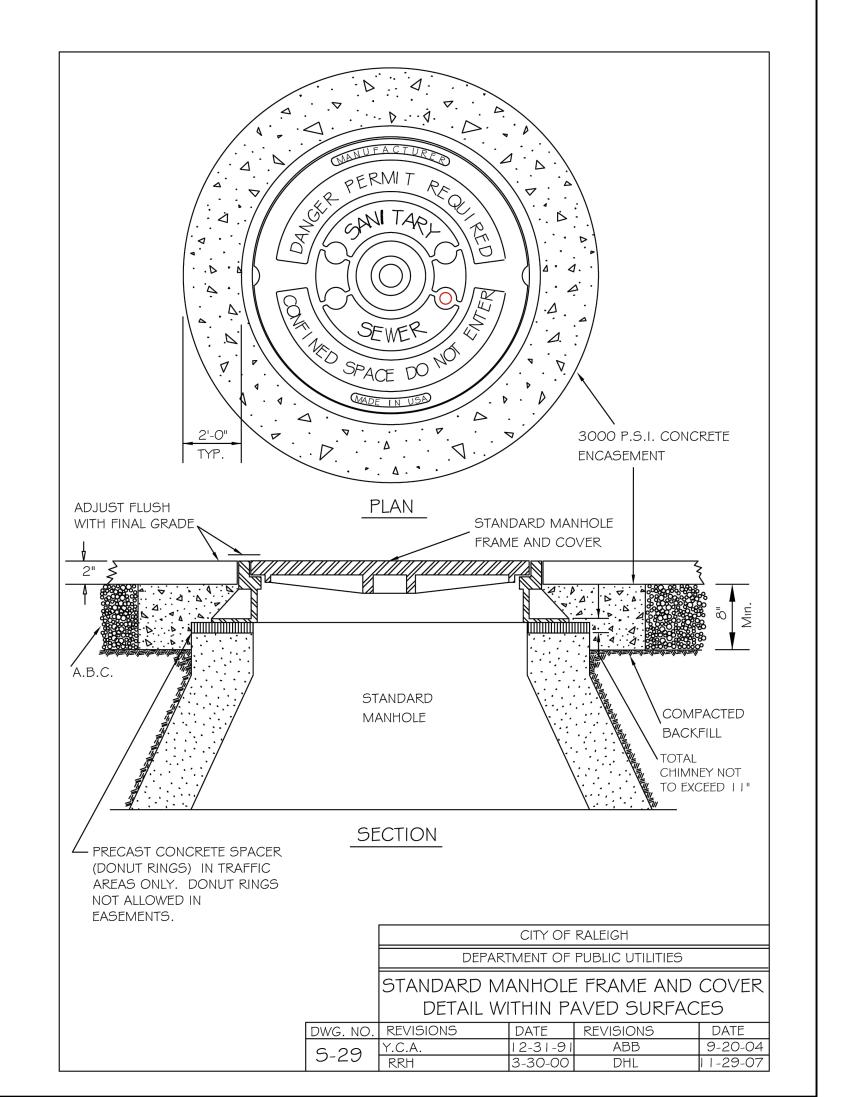
SANITARY SEWER DETAILS







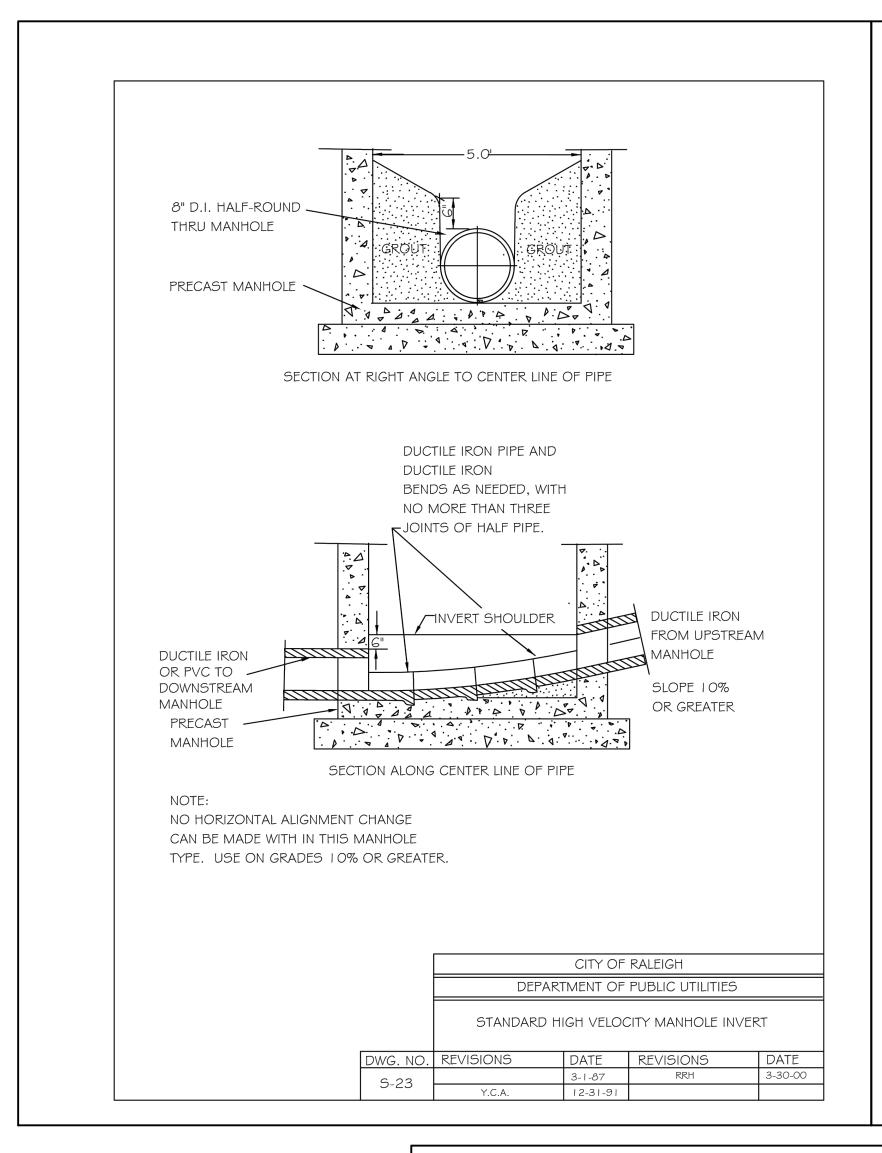

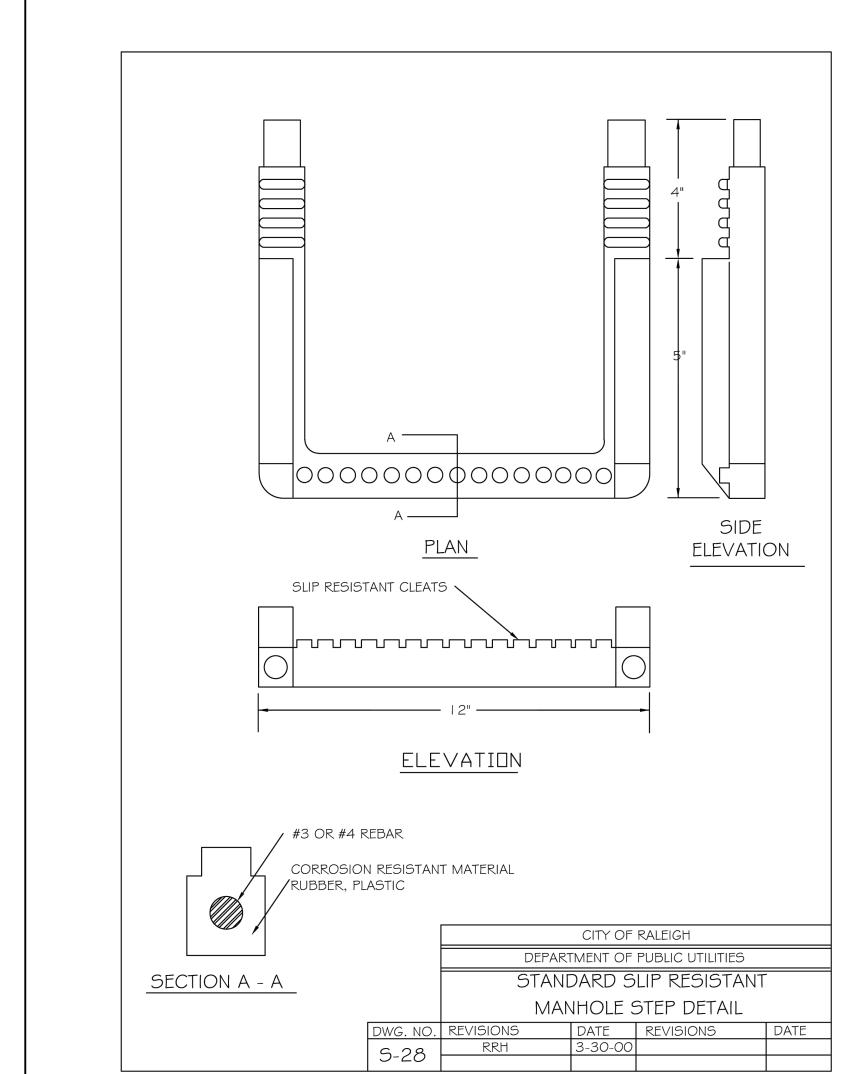



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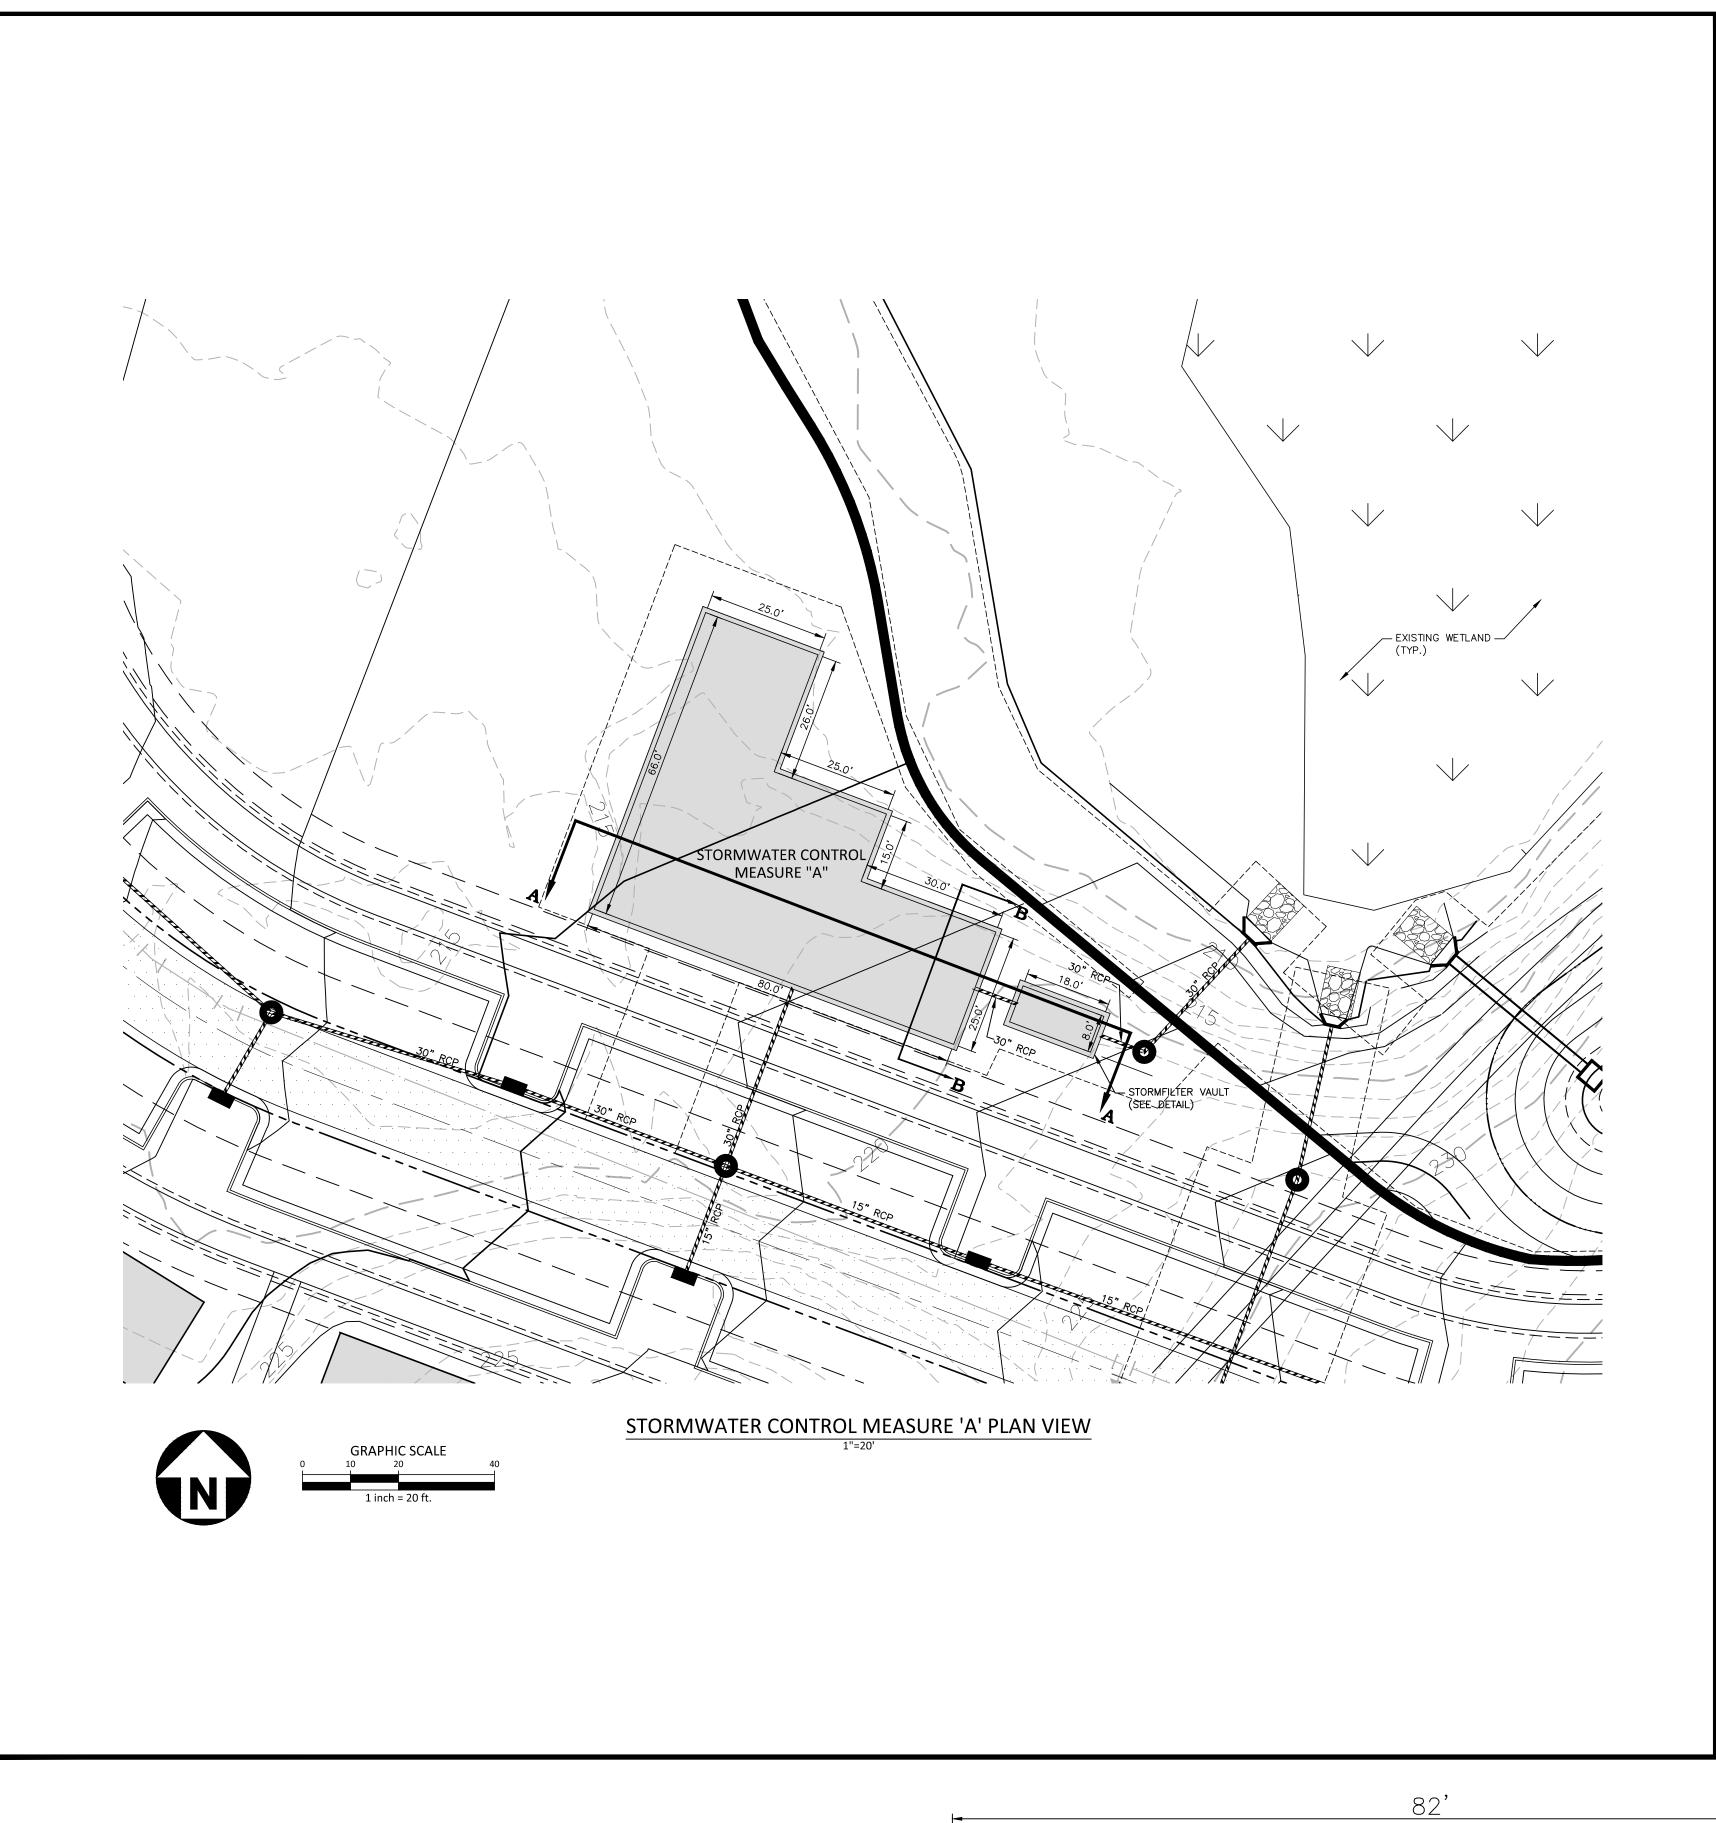
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PROJECT NO. MCR-23004 FILENAME MCR23004-D1 CHECKED BY ACP

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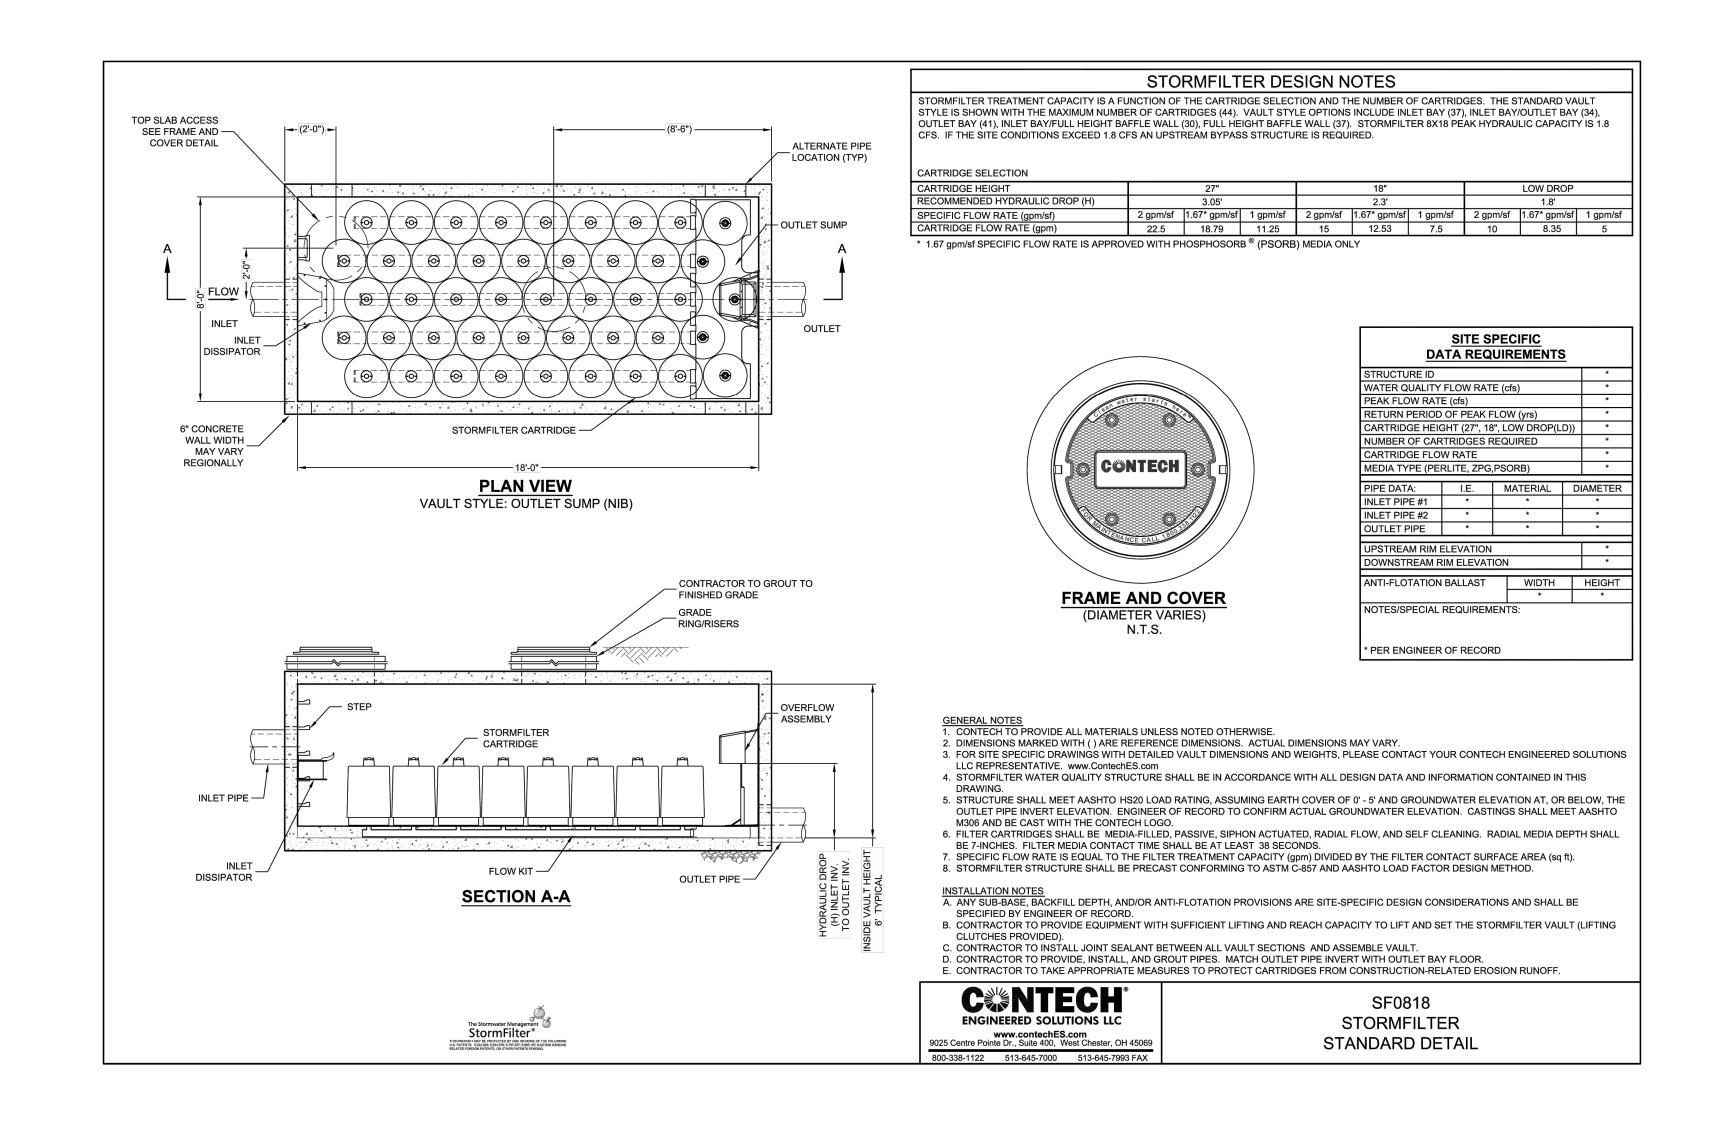
SANITARY SEWER DETAILS



— (34) 27" STORMFILTER

CARTRIDGE (PHOSPHOSORB)


─ INVERT OUT = 216.85'




INSIDE TOP EL. = 229.00'

100-YR STORM EL. = 227.26'

25-YR STORM EL. =226.46'

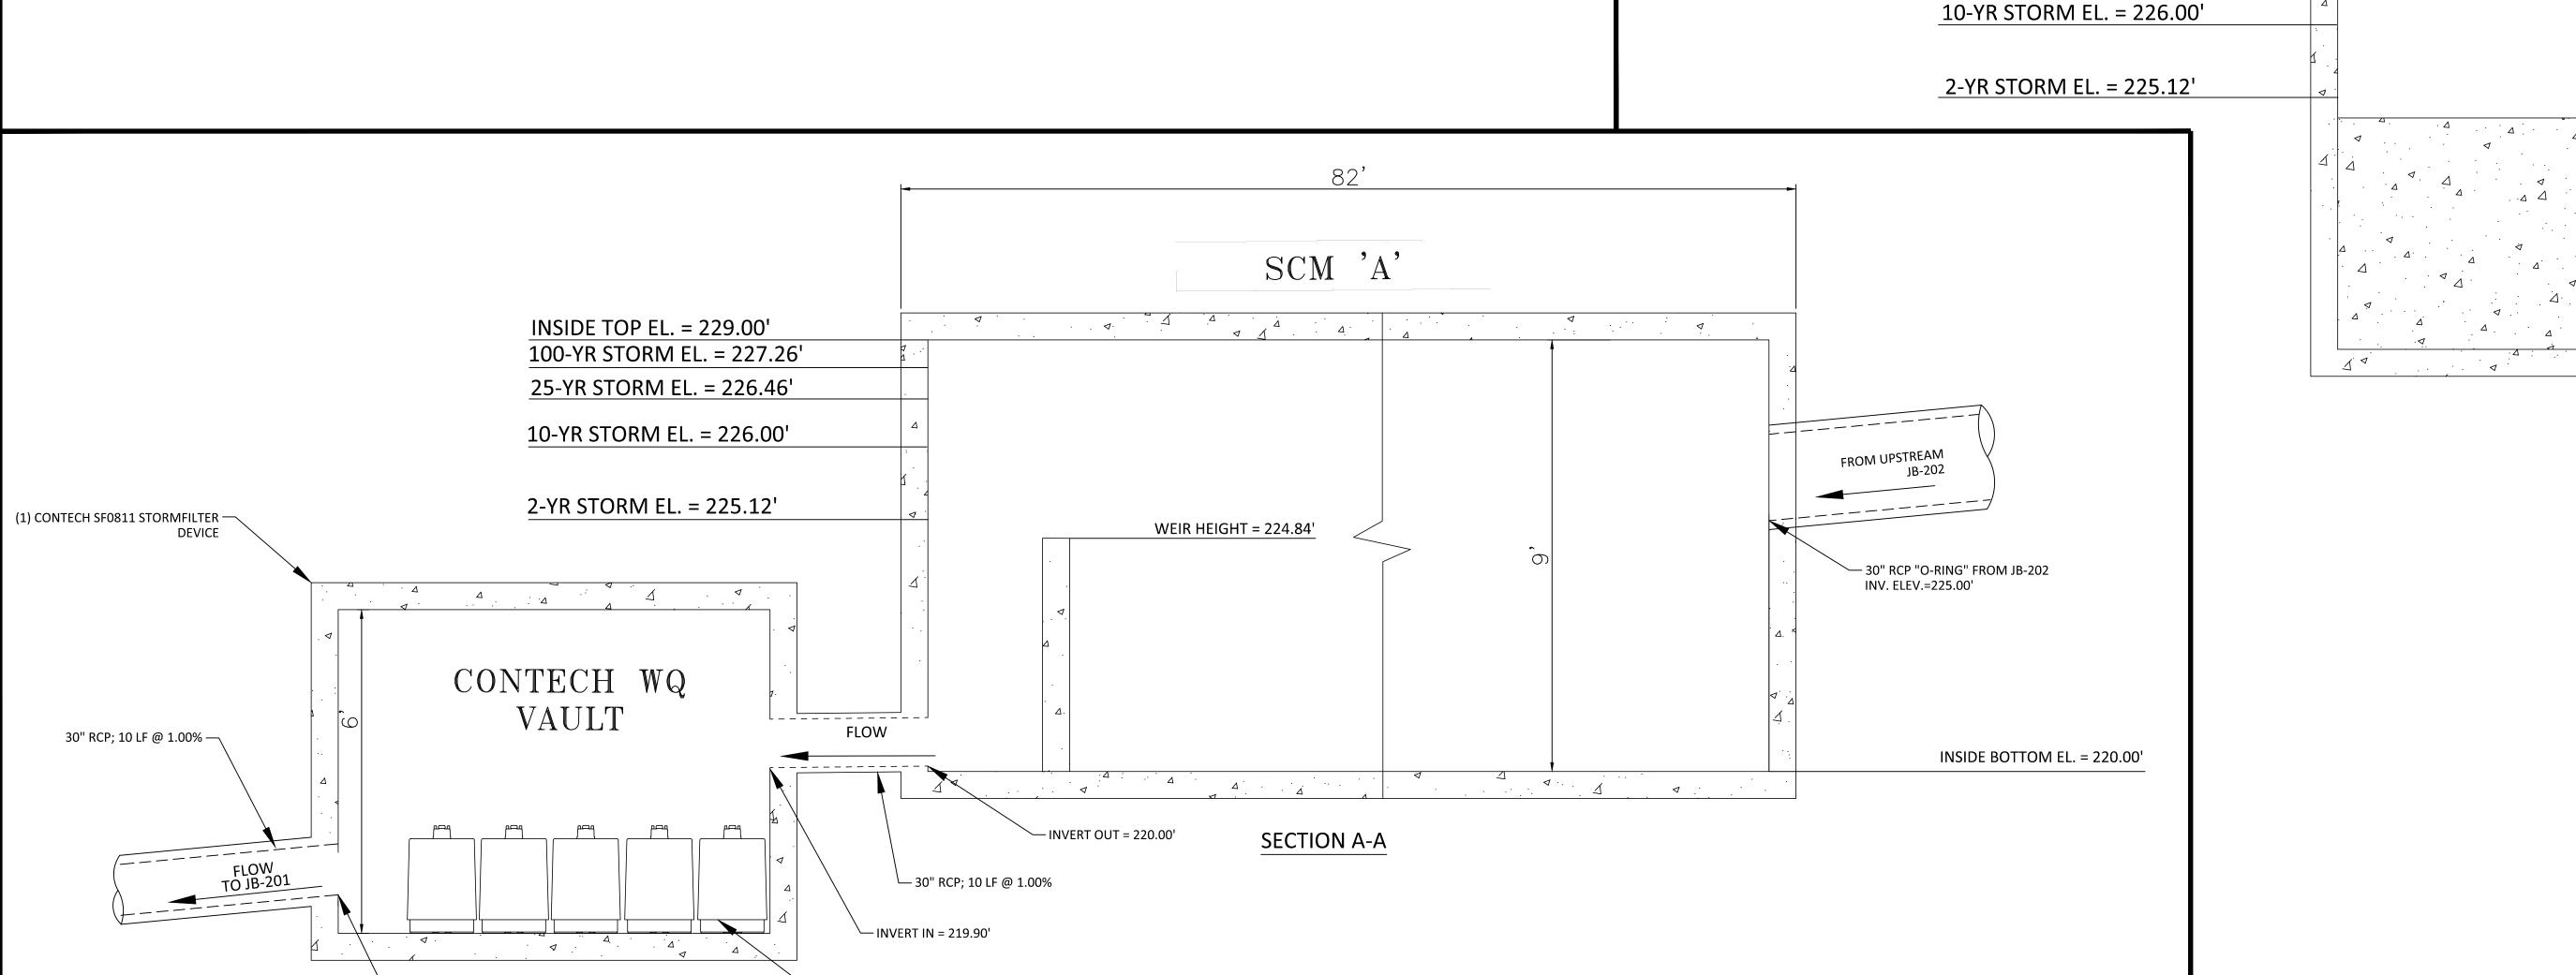

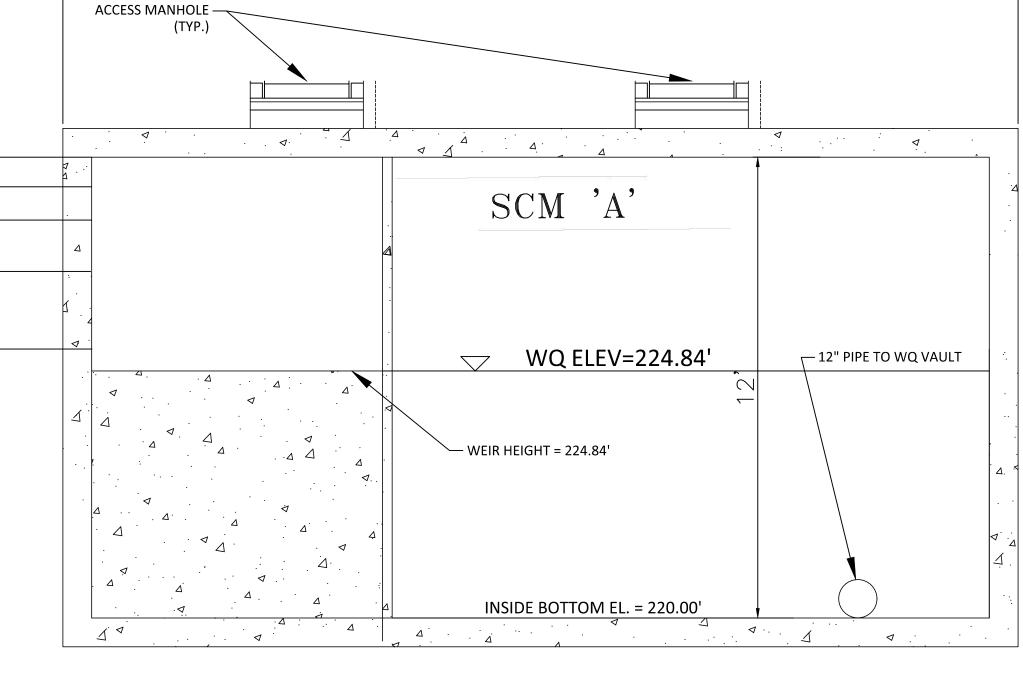

SECTION B-B N.T.S.

REVISIONS

PLAN INFORMATION

PROJECT NO. MCR-23004 FILENAME MCR23004-SWA CHECKED BY DRAWN BY

09. 08. 2023 DATE

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STORMWATER CONTROL **MEASURE A DETAILS**

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STORMWATER CONTROL MEASURE 'A' CONSTRUCTION SPECIFICATIONS

PRIOR TO CONSTRUCTION, ANY DISCREPANCIES IN THE PLANS AND NOTES SHALL BE BROUGHT TO THE DESIGN ENGINEER'S ATTENTION

- 2. THE PROJECT WILL MEET ALL OF THE REQUIREMENTS RELATIVE TO BEST MANAGEMENT PRACTICES AND ENGINEERED STORMWATER
- CONTROL STRUCTURES AS OUTLINED IN THE CITY OF RALEIGH LAND DISTURBANCE ORDINANCE.
- 3. THE FINAL CERTIFICATION FOR THIS FACILITY WILL INCLUDE A CERTIFICATION BY THE ON-SITE GEOTECHNICAL ENGINEER THAT THE PROJECT WAS CONSTRUCTED PER THE APPROVED PLANS. IT IS THE RESPONSIBILITY OF THE CONTRACTOR TO COORDINATE WITH THE ON-SITE GEOTECHNICAL ENGINEER FOR OBSERVATION AND TESTING SUCH THAT THE ON-SITE GEOTECHNICAL ENGINEER CAN CERTIFY THE 3. CONSTRUCTION OF THE DAM EMBANKMENT AND SPILLWAY. THIS CERTIFICATION MUST ADDRESS THE TESTING FOR MATERIALS AND COMPACTION OF THE DAM EMBANKMENT AND SPILLWAY.
- 4. ALL CONSTRUCTION ACTIVITY RELATED TO THE PROPOSED STORMWATER CONTROL MEASURE SHALL BE PER THE DETAILS AND SPECIFICATIONS SHOWN IN THESE DRAWINGS. SOILS, COMPACTION, AND OTHER MISCELLANEOUS DETAILS AND SPECIFICATIONS MAY BE MODIFIED PER THE RECOMMENDATIONS OF THE ON-SITE GEOTECHNICAL ENGINEER. HOWEVER, PRIOR TO IMPLEMENTATION, THE DESIGN ENGINEER SHALL BE NOTIFIED OF ANY DEVIATION FROM THESE DESIGN DRAWINGS, INCLUDING SHOP DRAWINGS FOR ANY PROPOSED
- 5. DURING THE INITIAL STAGES OF CONSTRUCTION. THE STORMWATER CONTROL MEASURE MAY BE USED AS A SEDIMENT BASIN FOR EROSION CONTROL PURPOSES. IF SO, THE CONTRACTOR SHALL FOLLOW THE GENERAL CONSTRUCTION SEQUENCE BELOW: A. THE CONTRACTOR SHALL CONSTRUCT THE ENTIRE FACILITY (PERMANENT OUTLET STRUCTURE, DAM, ETC.) WITH THE EXCEPTION OF THE INTERIOR FINE GRADING FOR THE FACILITY. THE INTERIOR FINE GRADING WILL BE CONSTRUCTED ONCE THE EROSION CONTROL
- PHASE IS COMPLETE. 3. THE TEMPORARY DRAW DOWN RISER (OR SKIMMER) SHALL BE CONNECTED TO THE PERMANENT 6"Ø DIP DRAIN PIPE. ONCE THE UPSTREAM DRAINAGE AREA IS STABILIZED AND THE EROSION CONTROL INSPECTOR APPROVES THE REMOVAL OF THE SEDIMENT BASIN, THE CONTRACTOR SHALL REMOVE THE TEMPORARY DRAW DOWN RISER (OR SKIMMER) AND CLEAN OUT THE BASIN. ALL SEDIMENT, TRASH, ETC. SHALL BE DISPOSED OF PROPERLY (I.E. - PLACED IN A LANDFILL) AND NOT STOCKPILED IN AN AREA WHERE WATER QUALITY COULD BE ADVERSELY AFFECTED.
- D. ONCE THE BASIN IS CLEANED OUT, AND ALL EROSION CONTROL DEVICES REMOVED, THE CONTRACTOR SHALL CONSTRUCT THE INTERIOR GRADING SHOWN ON THIS SHEET ONCE THE GRADING IS COMPLETE, THE CONTRACTOR SHALL REQUEST AN ON-SITE INSPECTION AND AN AS-BUILT SURVEY PRIOR TO INSTALLATION OF THE STORMWATER CONTROL MEASURE PLANTS. IF THE CONTRACTOR PLANTS THE PROPOSED VEGETATION PRIOR
- TO AN AS-BUILT SURVEY (AND SUBSEQUENT APPROVAL), ANY CHANGES TO THE GRADING / RE-PLANTING OF PLANTS WILL BE AT THE CONTRACTOR'S EXPENSE F. ONCE THE ENGINEER HAS APPROVED THE AS-BUILT GRADING, THE CONTRACTOR SHALL PLANT THE PROPOSED STORMWATER
- CONTROL MEASURE PLANTS SHOWN ON THE LANDSCAPE PLAN FOR THE FACILITY. AFTER COMPLETION OF THE PLANTING, THE LANDSCAPE CONTRACTOR SHALL PROVIDE A LETTER TO THE ENGINEER CERTIFYING THAT THE PLANTS HAVE BEEN INSTALLED PER THE APPROVED STORMWATER CONTROL MEASURE PLANTING PLAN. 6. ALL OSHA REQUIREMENTS FOR EXCAVATIONS (SHORING, DEPTH, ETC.) ARE THE RESPONSIBILITY OF THE CONTRACTOR. IF REQUIRED, THE CONTRACTOR SHALL PROVIDE AN EXCAVATION PLAN TO BE SEALED BY A NC P.E. IT IS THE RESPONSIBILITY OF THE CONTRACTOR TO
- DETERMINE IF AN EXCAVATION PLAN IS REQUIRED. THE JOHN R. MCADAMS COMPANY ASSUMES NO RESPONSIBILITY FOR ANY EXCAVATION DESIGN RELATED TO SAFETY OR OSHA REQUIREMENTS. 7. ON-SITE GEOTECHNICAL ENGINEER TO DETERMINE IF IN-SITU SOILS ENCOUNTERED WOULD MAINTAIN A STORMWATER CONTROL MEASURE PERMANENT POOL AT DESIGN ELEVATION. IF HIGHLY PERMEABLE SOILS ARE ENCOUNTERED THAT WOULD NOT MAINTAIN
- THE PERMANENT POOL ELEVATION AS DESIGNED. A CLAY LINER MAY BE REQUIRED TO MAINTAIN A PERMANENT POOL OF WATER IN THE STORMWATER CONTROL MEASURE. FINAL DETERMINATION IF A CLAY LINER IS NEEDED SHALL BE THE RESPONSIBILITY OF THE ON-SITE GEOTECHNICAL ENGINEER. UPON DETERMINATION OF HIGHLY PERMEABLE SOIL CONDITIONS, ON-SITE GEOTECHNICAL ENGINEER WILL INFORM THE DESIGN ENGINEER AND RECOMMEND LINER SPECIFICATIONS. 8. IT IS ANTICIPATED THAT DEWATERING WILL BE NECESSARY IN THE EXCAVATION AREAS (E.G. - EMBANKMENT SUB GRADE, INTERIOR
- PORTIONS OF THE STORMWATER CONTROL MEASURE, KEY TRENCH, ETC.). THEREFORE, THE CONTRACTOR SHALL FURNISH, INSTALL, OPERATE, AND MAINTAIN ANY PUMPING EQUIPMENT, ETC. NEEDED FOR REMOVAL OF WATER FROM VARIOUS PARTS OF THE STORMWATER CONTROL MEASURE SITE. DURING PLACEMENT OF FILL WITHIN THESE AREAS, THE CONTRACTOR SHALL KEEP THE WATER LEVEL BELOW THE BOTTOM OF THE EXCAVATION / CONSTRUCTION AREAS. THE MANNER IN WHICH THE WATER IS REMOVED SHALL BE SUCH THAT THE EXCAVATION BOTTOM AND SIDE SLOPES ARE STABLE, WITH NO SEDIMENT DISCHARGED FROM THE SITE (I.E. PUMPED WATER MAY NEED TO BE DIRECTED TO AN APPROVED EROSION CONTROL DEVICE SUCH AS A DIRT BAG (ACF ENVIRONMENTAL), OR ENGINEER APPROVED EQUIVALENT, PRIOR TO DISCHARGE).
- 9. THE RETAINING WALL ALIGNMENT SHOWN ON THESE PLANS DEPICTS THE LOCATION OF THE FRONT FACE OF THE
- 10. THE RETAINING WALL IS TO BE A DESIGN-BUILD PROJECT(S) BY THE CONTRACTOR. IT SHALL BE THE CONTRACTOR'S RESPONSIBILITY TO OBTAIN FINAL CONSTRUCTION DRAWINGS FROM A REGISTERED PROFESSIONAL ENGINEER AND GAIN ALL REQUIRED PERMITS NECESSARY FOR THE CONSTRUCTION OF THE RETAINING WALL.
- 11. THE RETAINING WALL SHALL BE ASSUMED TO BE BACKFILLED WITH OFF-SITE BORROW MATERIAL OR PROCESSED FILL UNLESS CONTRACTOR CAN PROVIDE OWNER WITH CONFIRMATION FROM THE GEOTECHNICAL ENGINEER AND THE RETAINING WALL DESIGNER THAT READILY AVAILABLE ON-SITE SOILS CAN BE USED.
- 12. THE TOP AND BOTTOM OF WALL ELEVATIONS SHOWN ON THESE PLANS IDENTIFY FINISHED GRADE ELEVATIONS ONLY. THE EXTENT THAT THE RETAINING WALL WILL BE EXTENDED BELOW GRADE TO THE FOOTING SHALL BE IDENTIFIED ON THE RETAINING WALL
- 13. THE ON-SITE GEOTECHNICAL ENGINEER SHOULD BE GIVEN AN OPPORTUNITY TO REVIEW ALL RETAINING WALL PLANS AND DESIGNS RELEVANT TO GEOTECHNICAL CONSIDERATIONS PRIOR TO FINAL DESIGN OF THE WALLS.
- 14. THE GRADES SHOWN ON THIS PLAN ARE FINISHED GRADES. IF THE EXISTING SOIL LAYER AFTER CONSTRUCTION / COMPACTION IS NOT DETERMINED SUITABLE BY A LANDSCAPE PROFESSIONAL FOR THE WET POND PLANTINGS, THEN THE CONTRACTOR SHALL AMEND THE PLANTING AREA OF THE WET POND AS DIRECTED BY A LANDSCAPE PROFESSIONAL.
- 15. PRIOR TO TOPSOIL INSTALLATION, THE CONTRACTOR SHALL SCARIFY THE TOP 2"-3" OF THE BERM SECTION TO PROMOTE BONDING OF THE TOPSOIL WITH THE COMPACTED FILL. THE TOPSOIL DEPTH SHALL RANGE FROM 3"-4" ON THE DAM EMBANKMENT AND WET POND. PLEASE NOTE THE TOPSOIL SHALL BE AMENDED, AS DIRECTED BY A LANDSCAPE PROFESSIONAL, PRIOR TO INSTALLATION ON THE
- 16. THE CONTRACTOR SHALL REFER TO THE LANDSCAPE PLAN FOR THE PERMANENT PLANTING PLAN/SCHEDULE FOR THIS FACILITY. CONTRACTOR SHALL COORDINATE WITH A LANDSCAPE PROFESSIONAL REGARDING SCHEDULING FOR PLANT INSTALLATION. PLEASE NOTE THAT NO TREES/SHRUBS OF ANY TYPE MAY BE PLANTED ON THE PROPOSED DAM EMBANKMENT (FILL AREAS).

OUTLET STRUCTURE MATERIAL SPECIFICATIONS

- l. THE 24"Ø RCP OUTLET BARREL SHALL BE CLASS III RCP, MODIFIED BELL AND SPIGOT, MEETING THE REQUIREMENTS OF ASTM C76-LATEST. THE PIPES SHALL HAVE CONFINED O-RING RUBBER GASKET JOINTS MEETING ASTM C-443-LATEST. THE PIPE JOINTS SHALL BE TYPE R-4.
- 2. THE STRUCTURAL DESIGN FOR THE 4' X 4' (INTERNAL DIMENSIONS) RISER BOX WITH EXTENDED BASE SHALL BE BY OTHERS. PRIOR TO ORDERING THE STRUCTURES, THE CONTRACTOR SHALL PROVIDE, TO THE DESIGN ENGINEER FOR REVIEW, SHOP DRAWINGS AND SUPPORTING STRUCTURAL CALCULATIONS SEALED BY A P.E. REGISTERED IN NORTH CAROLINA DEMONSTRATING THE PERTINENT VERTICAL 2. LOADS ARE SUPPORTED BY THE CONCRETE RISER STRUCTURE.
- THE RISER BOX. STEPS SHALL BE IN ACCORDANCE WITH NCDOT STD. 840.66. PLEASE REFER TO SHEET C9.05 FOR LOCATION OF THE RISER STEPS. NOTE THE STEPS SHALL LINE UP WITH THE ACCESS HATCH OF THE TRASH RACK.
- 4. THE CONCRETE ANTI-FLOTATION BLOCK SHALL BE CAST-IN-PLACE. STEEL REINFORCEMENT AND CONNECTION TO THE RISER SHALL BE PROVIDED IN ACCORDANCE WITH THE DETAIL ON SHEET C9.05. THE CONTRACTOR SHALL ENSURE THE WEIGHT OF THE ENTIRE RISER STRUCTURE IS GREATER THAN OR EQUAL TO XX,XXX LBS. IN LIEU OF CAST-IN-PLACE, THE CONTRACTOR MAY OPT FOR A PRECAST ANTI-FLOTATION BLOCK. SHOP DRAWINGS FOR THE PRECAST BLOCK SHALL BE SUBMITTED TO THE ENGINEER FOR REVIEW. THE PRECAST ANTI-FLOTATION BLOCK SHALL HAVE A SHIPPING WEIGHT OF XX,XXX LBS.

3. THE RISER BOX OUTLET STRUCTURE SHALL BE PROVIDED WITH STEPS 16" ON CENTER. STEPS SHALL BE PROVIDED ON THE INNER WALL OF

- 5. THE RISER BOX JOINTS SHALL BE SEALED USING BUTYL RUBBER SEALANT CONFORMING TO ASTM-C990-LATEST. IF NECESSARY, THE CONTRACTOR SHALL INCORPORATE A WATERSTOP INTO THE RISER BOX JOINT TO ENSURE A WATERTIGHT CONNECTION. THE CONTRACTOR SHALL PARGE JOINTS ON BOTH THE INSIDE AND OUTSIDE WITH NON-SHRINK GROUT AND INSTALL GALVANIZED STEEL STRAPS PER DETAIL ON SHEET C9.05.
- 6. PRIOR TO ORDERING, THE CONTRACTOR SHALL SUBMIT TRASH RACK SHOP DRAWINGS TO THE ENGINEER FOR REVIEW. CONTRACTOR SHALL ENSURE THAT AN ACCESS HATCH IS PROVIDED WITHIN THE TRASH RACK (SEE DETAIL FOR LOCATION) THAT WILL ALLOW FOR FUTURE MAINTENANCE ACCESS. CONTRACTOR SHALL ALSO PROVIDE A CHAIN AND LOCK FOR SECURING THE ACCESS HATCH. NOTE THE ACCESS HATCH SHALL LINE UP WITH THE ACCESS STEPS AFTER INSTALLATION.
- 7. ALL POURED CONCRETE SHALL MEET THE FOLLOWING SPECIFICATIONS UNLESS OTHERWISE NOTED:
- -MINIMUM 3000 PSI (28 DAY) -SLUMP = 3" - 5"
- -ENTRAINED AIR = 5% 7%
- PLEASE NOTE NO CONCRETE SHALL BE POURED WHEN THE AMBIENT AIR TEMPERATURES ARE EXPECTED TO BE ABOVE 85°F OR BELOW 40°F. CAST-IN-PLACE CONCRETE SHALL BE "WET CURED" AFTER FINISHING FOR A MINIMUM OF 48 HOURS.
- ON-SITE GEOTECHNICAL ENGINEER TO ENSURE AND CERTIFY ALL POURED CONCRETE MEETS THE ABOVE SPECIFICATIONS.
- 8. GEOTEXTILE FABRIC FOR THE 24"Ø RCP OUTLET BARREL JOINTS SHALL BE MIRAFI 180N OR ENGINEER APPROVED EQUAL (NON-WOVEN
- 9. STORMWATER CONTROL MEASURE EMERGENCY DRAW DOWN IS VIA AN 6"Ø PLUG VALVE. THE VALVE SHALL BE A M&H STYLE 1820 ECCENTRIC VALVE OR APPROVED EQUAL. THIS VALVE IS IN ACCORDANCE WITH AWWA C-517, AND SHALL BE OPERABLE FROM TOP OF OUTLET STRUCTURE VIA A HAND WHEEL (SEE DETAIL SHEET C9.05). THE CONTRACTOR SHALL PROVIDE A REMOVABLE VALVE WRENCH WITH A HAND WHEEL ON TOP FOR OPERATION OF THE 6"Ø PLUG VALVE.

CONSTRUCTION SEQUENCE

- PRIOR TO CONSTRUCTION, THE OWNER SHALL OBTAIN A LAND DISTURBING (GRADING) PERMIT AND AN "APPROVAL TO CONSTRUCT" FROM THE CITY OF RALEIGH AND ALL OTHER NECESSARY PERMITS FROM APPLICABLE AGENCIES (E.G. 404 / 401 PERMITS)
- 2. INSTALL ALL SEDIMENT AND EROSION CONTROL MEASURES PER THE APPROVED SEDIMENT AND EROSION CONTROL PLAN. THE CONTRACTOR SHALL MAINTAIN ALL APPROVED SEDIMENT AND EROSION CONTROL MEASURES THROUGHOUT THE ENTIRE PROJECT, AS REQUIRED. THE CONTRACTOR SHALL RECEIVE APPROVAL FROM THE EROSION CONTROL INSPECTOR, AS REQUIRED BY GOVERNING
- CLEAR AND GRUB AREA WITHIN THE LIMITS OF THE PROPOSED DAM CONSTRUCTION. ALL TREES AND THEIR ENTIRE ROOT SYSTEMS MUST BE REMOVED FROM THE DAM FOOTPRINT AREA AND BACKFILLED WITH SUITABLE SOIL MATERIAL. THE BACKFILLED AREAS SHALL BE COMPACTED TO THE SAME STANDARDS AS THE DAM EMBANKMENT. THE REMAINING AREA OF THE EMBANKMENT SHALL BE STRIPPED TO A SUITABLE DEPTH AS DIRECTED BY THE ON-SITE GEOTECHNICAL ENGINEER. ANY RESIDUAL SOILS TO BE LEFT IN PLACE MUST BE WELL SCARIFIED TO PROMOTE BONDING OF THE NEW EMBANKMENT FILL NO EMBANKMENT MATERIAL SHALL BE PLACED FOR THE DAM OR KEY TRENCH UNTIL APPROVAL OF THE DAM SUBGRADE IS OBTAINED FROM THE ON-SITE GEOTECHNICAL ENGINEER.
- EXCAVATE FOR THE NEW KEY TRENCH ALONG THE CENTERLINE OF THE PROPOSED DAM EMBANKMENT. THE TRENCH SHALL EXTEND A MINIMUM OF 5 FT BELOW EXISTING GRADE OR 2 FT BELOW THE RCP OUTLET BARRELS AND SHALL HAVE A MINIMUM BOTTOM WIDTH OF 5 FFFT. THE KEY TRENCH SIDESLOPES SHALL BE A MINIMUM OF 1:1 (H:V). WHEN EXCAVATING THE KEY TRENCH, IF ANY DEBRIS IS ENCOUNTERED TO AN EXTENT THAT SUCH DEBRIS MAY EXIST IN OTHER INSITU PORTIONS OF THE DAM EMBANKMENT, IT SHOULD ALSO BE REMOVED. THE KEY TRENCH SHALL BE COMPACTED TO THE SAME SPECIFICATION LISTED IN ITEM 4 OF THE SECTION TITLED "BERM AND SOIL COMPACTION SPECIFICATIONS." DEPENDING UPON ON-SITE SOIL CONDITIONS ENCOUNTERED DURING EXCAVATION, THE ON-SITE GEOTECHNICAL ENGINEER MAY VARY THE DEPTH AND DIMENSIONS OF THE KEY TRENCH AS DEEMED NECESSARY. THE ON-SITE GEOTECHNICAL ENGINEER SHALL RETAIN DOCUMENTATION OF ANY VARIATION FOR FUTURE AS-BUILT SUBMITTALS TO THE CITY OF
- 5. BEGIN PLACEMENT OF BACKFILL WITHIN THE KEY TRENCH. THE KEY TRENCH SHALL BE COMPACTED TO THE SPECIFICATIONS LISTED ITEM 4 OF THE SECTION TITLED "BERM AND SOIL COMPACTION SPECIFICATIONS." THE KEY TRENCH SHALL BE TESTED PER THE SPECIFICATIONS
- 6. PRIOR TO INSTALLATION, SUBGRADE CONDITIONS ALONG THE SPILLWAY PIPES SHOULD BE EVALUATED BY THE ON-SITE GEOTECHNICAL ENGINEER TO ASSESS WHETHER SUITABLE BEARING CONDITIONS EXIST AT THE SUBGRADE LEVEL. SHOULD SOFT OR OTHERWISE UNSUITABLE CONDITIONS BE ENCOUNTERED ALONG THE PIPE ALIGNMENTS. THESE MATERIALS SHOULD BE UNDERCUT AS DIRECTED BY THE GEOTECHNICAL ENGINEER. THE UNDERCUT MATERIALS SHALL BE REPLACED WITH ADEQUATELY COMPACTED STRUCTURAL FILL, LEAN CONCRETE OR FLOWABLE FILL AS DIRECTED BY THE ON-SITE GEOTECHNICAL ENGINEER.
- 7. IN ORDER TO HELP PROTECT THE SOIL SUBGRADE FROM DETERIORATION (DUE TO EXPOSURE, RAINFALL, SEEPAGE, AND RUNOFF) BEFORE THE CRADLE CAN BE POURED, IT IS STRONGLY RECOMMENDED THAT A 3" TO 4" THICK CONCRETE MUD MAT BE POURED OVER THE SUBGRADE ONCE IT IS APPROVED BY THE ON-SITE GEOTECHNICAL ENGINEER. THE MUD MAT WILL ALSO PROVIDE BEARING FOR THE BLOCKS THAT TEMPORARILY SUPPORT THE SPILLWAY PIPE UNTIL THE CRADLE CAN BE POURED. THE METHOD OF BLOCK SUPPORT FOR THE PIPE PROPOSED BY THE CONTRACTOR SHOULD BE SUBMITTED TO THE JOHN R. McADAMS COMPANY FOR REVIEW.
- 8. BEGIN CONSTRUCTION OF THE NEW EMBANKMENT. FILL MATERIALS SHALL BE PLACED IN MAXIMUM 8" THICK LIFTS PRIOR TO COMPACTION, UNLESS DIRECTED OTHERWISE BY THE ON-SITE GEOTECHNICAL ENGINEER. FILL LIFTS SHALL BE CONTINUOUS OVER THE ENTIRE LENGTH OF FILL. IF IT IS NECESSARY, THE EMBANKMENT FILL MATERIAL WILL BE OVERBUILT IN HORIZONTAL LIFTS AND CUT BACK
- TO FINAL GRADE IN ORDER TO ACHIEVE PROPER COMPACTION. 9. AS CONSTRUCTION OF THE EMBANKMENT MOVES FORWARD, IT WILL BE NECESSARY TO INSTALL THE CONCRETE CRADLE. SEE NOTE ON
- A. IF THE PROPOSED STRUCTURAL FILL MATERIAL IS UTILIZED AS THE FORMWORK FOR THE CONCRETE CRADLE, THEN THE STRUCTURAL FILL SHOULD BE INSTALLED AND COMPACTED UP TO THE TOP OF CONCRETE CRADLE ELEVATION. ONCE THE STRUCTURAL FILL REACHES THE NEXT DOWNSTREAM JUNCTION BOX OR HEADWALL AND IS COMPACTED TO THE ELEVATION OF THE TOP OF THE CONCRETE CRADLE. EXCAVATE THE CONCRETE CRADLE TRENCH PER THE PROVIDED DETAILS AND CONSTRUCT THE CONCRETE CRADLE

CRADLE DETAIL (SHEET C9.06). THIS MAY BE CONSTRUCTED USING ONE OF THE FOLLOWING METHODS:

AS PER THE PROVIDED CONCRETE CRADLE DETAIL.

THE DETAILS SHOWN ON SHEET C9.06.

B. IF THE PROPOSED STRUCTURAL FILL IS NOT UTILIZED AS THE FORMWORK FOR THE CONCRETE CRADLE, THEN PRIOR TO CONSTRUCTING THE STRUCTURAL FILL EMBANKMENT, THE FORMWORK FOR THE CONCRETE CRADLE SHOULD BE INSTALLED ON

EXISTING GROUND AND/OR THE MUD MAT. THE CONCRETE CRADLE SHALL BE CONSTRUCTED PER THE PROVIDED DETAILS

- 10. AS AN ALTERNATE TO A CONCRETE CRADLE UNDER THE BARREL PIPE (SEE SHEET C9.06), THE CONTRACTOR MAY CHOOSE TO ELIMINATE THE CONCRETE CRADLE AND USE COMPACTED BACKFILL IF THE ON-SITE GEOTECHNICAL ENGINEER WILL PROVIDE A NC PE SEALED LETTER CERTIFYING THAT THE COMPACTION UNDER, AROUND, AND ABOVE THE BARREL MEETS THE SPECIFICATIONS OF THE EMBANKMENT COMPACTION REQUIREMENTS AND MOISTURE CONTENT. THIS CERTIFICATION LETTER MUST BE SUBMITTED TO THE DESIGN ENGINEER PRIOR TO BACKFILL. THIS SEPARATE CERTIFICATION MUST BE SPECIFIC TO THE BARREL PIPE FOR THE FACILITY. AND MUST CLEARLY STATE THAT ALL SOIL MATERIAL LUNDER, AROUND, AND ABOVE THE BARREL PIPE MEETS THE BERM AND SOIL COMPACTION SPECIFICATIONS ON THIS SHEET. THIS CERTIFICATION IS TO INCLUDE REFERENCE TO BOTH MATERIAL AND COMPACTION, AND MUST STATE THAT ALL MATERIALS UNDER, AROUND, AND ABOVE THE BARREL HAVE BEEN COMPACTED PER THE BERM MATERIAL SPECIFICATIONS (AT LEAST 95% OF MAXIMUM DRY DENSITY USING ASTM D698 STANDARD PROCTOR) WITH NO VOID SPACES PRESENT. THE CONTRACTORS INTENT TO UTILIZE THIS ALTERNATIVE MUST BE STATED PRIOR TO CONSTRUCTION TAKING PLACE. THIS CONTRACTORS CERTIFICATION MUST BE
- 11. INSTALL RISER / BARREL ASSEMBLY, ALONG WITH THE EMERGENCY DRAIN SYSTEM. INSTALL RCP OUTLET BARREL SPILLWAY FILTER FROM

PRESENTED TO THE DESIGN ENGINEER BEFORE AN AS-BUILT CERTIFICATION CAN BE ISSUED FOR THIS FACILITY.

- 12. CONSTRUCT EMBANKMENT PER SPECIFICATIONS LISTED IN THE SECTION TITLED "BERM AND SOIL COMPACTION SPECIFICATIONS" AND REQUIREMENTS OF THE ON-SITE GEOTECHNICAL ENGINEER. ALL CHARACTERISTICS OF THE EMBANKMENT FILL MATERIAL SHALL MEET THE STANDARDS SET FORTH IN "BERM AND SOIL COMPACTION SPECIFICATIONS". INCLUDING COMPACTION AND MOISTURE REQUIREMENTS. IF NECESSARY TO ACHIEVE PROPER COMPACTION, THE EMBANKMENT FILL MATERIAL WILL BE OVERBUILT IN HORIZONTAL LIFTS AND CUT BACK TO PROPER FINAL GRADE. ANY HAND COMPACTION ACTIVITIES AROUND SPILLWAY OR DRAIN STRUCTURES SHALL BE CONDUCTED IN 4-INCH LOOSE LIFTS AND BE TO THE SAME COMPACTION AND MOISTURE REQUIREMENTS AS THE ENTIRE EMBANKMENT. ALL COMPACTION AND MOISTURE TESTING SHALL BE CARRIED OUT AS DIRECTED BY THE ON-SITE GEOTECHNICAL ENGINEER AND AS LISTED IN THE SECTION TITLED "BERM AND SOIL COMPACTION SPECIFICATIONS".
- 13. UPON COMPLETION OF DAM EMBANKMENT, PROMPTLY STABILIZE AND SEED DAM EMBANKMENT PER SEEDING SCHEDULE. PERMANENT GROUND COVER SHALL BE ESTABLISHED PER THE PERMANENT SEEDING SCHEDULE FOUND ON SHEET C9.07.
- 14. SCHEDULE A FINAL AS-BUILT INSPECTION AND AS-BUILT SURVEY WITH THE ENGINEER AND SURVEYOR. AN AS-BUILT INSPECTION AND SURVEY SHALL BE SCHEDULED BEFORE IMPOUNDING WATER IN THE FACILITY AND A MINIMUM OF 60 DAYS PRIOR TO THE ANTICIPATED DATE OF CERTIFICATION APPROVAL. ANY COMMENTS OR DEFICIENCIES IN THE SCM CONSTRUCTION MUST BE CORRECTED TO THE SATISFACTION OF THE ENGINEER AND OWNER BEFORE CERTIFICATION SHALL BE GRANTED.

BERM AND SOIL COMPACTION SPECIFICATIONS


- PRIOR TO CONSTRUCTION, THE ON-SITE GEOTECHNICAL ENGINEER SHALL IDENTIFY BORROW / FILL AREAS AND VERIFY THEIR SUITABILITY FOR USE WITHIN THE DAM EMBANKMENT. ALSO, THE ON-SITE GEOTECHNICAL ENGINEER SHALL PERFORM STANDARD PROCTORS ON THE PROPOSED BORROW MATERIAL TO ENSURE THAT OPTIMUM MOISTURE CONTENT AND COMPACTION CAN BE ACHIEVED / CONTROLLED
- ALL FILL MATERIALS TO BE USED FOR THE DAM EMBANKMENT SHALL BE TAKEN FROM BORROW AREAS APPROVED BY THE ON-SITE GEOTECHNICAL ENGINEER. THE FILL MATERIAL SHALL BE FREE FROM ROOTS, STUMPS, WOOD, STONES GREATER THAN 6", AND FROZEN OR OTHER OBJECTIONABLE MATERIAL. THE FOLLOWING SOIL TYPES ARE SUITABLE FOR USE AS FILL WITHIN THE DAM EMBANKMENT AND KEY TRENCH: ML AND CL. ALL FILL MATERIALS SHALL BE APPROVED BY THE ONSITE GEOTECHNICAL ENGINEER FOR THE INTENDED USE.

3. FILL PLACEMENT FOR THE EMBANKMENT SHALL NOT EXCEED A MAXIMUM 8" LIFT (UNCOMPACTED). EACH LIFT SHALL BE CONTINUOUS

- FOR THE ENTIRE LENGTH OF EMBANKMENT. BEFORE PLACEMENT OF FILL FOR THE BERM SECTION, ALL UNSUITABLE MATERIAL SHALL BE REMOVED AND THE SURFACE PROPERLY PREPARED FOR FILL PLACEMENT. FILL MATERIAL ADJACENT TO ALL SPILLWAY AND DRAINAGE STRUCTURES SHALL BE PLACED IN 4-INCH (UNCOMPACTED) LIFTS AND HAND-COMPACTED TO THE SAME COMPACTION AND MOISTURE REQUIREMENTS AS THE ENTIRE EMBANKMENT.
- 4. ALL FILL SOILS USED IN THE EMBANKMENT CONSTRUCTION SHALL BE COMPACTED TO AT LEAST 95% OF THE STANDARD PROCTOR MAXIMUM DRY DENSITY (ASTM D-698). THE FILL SOILS SHALL BE COMPACTED AT A MOISTURE CONTENT WITHIN -1 TO +3 PERCENT OF ITS OPTIMILM MOISTURE CONTENT. COMPACTION TESTS SHALL BE PERFORMED BY THE ON-SITE GEOTECHNICAL ENGINEER DURING CONSTRUCTION TO VERIFY THAT THE PROPER COMPACTION LEVEL HAS BEEN REACHED. THE FILL SHOULD BE COMPACTED USING A SHEEPSFOOT TYPE COMPACTOR. IN ORDER TO PREVENT DAMAGE TO THE PIPE, NO COMPACTION EQUIPMENT SHALL CROSS ANY PIPE UNTIL MINIMUM COVER IS ESTABLISHED ALONG THE PIPE.
- THE DESIGN ENGINEER SHALL BE PROVIDED WITH REPORTS AND CERTIFICATION, BY THE ON-SITE GEOTECHNICAL ENGINEER, THAT THE GEOTECHNICAL ASPECTS OF THE FACILITY HAVE BEEN CONSTRUCTED PER PLAN. THIS CERTIFICATION MUST ADDRESS THE TESTING FOR MATERIALS AND COMPACTION OF THE DAM EMBANKMENT AND SPILLWAY. THESE REPORTS AND CERTIFICATION WILL BE NEEDED DURING THE AS-RUILT CERTIFICATION PROCESS FOR THIS STORMWATER CONTROL MEASURE, THEREFORE, IT SHALL BE THE CONTRACTOR'S RESPONSIBILITY TO COORDINATE TESTING AND OBSERVATION WITH THE ON-SITE GEOTECHNICAL ENGINEER.
- 6. TESTING OF THE NEW FILL MATERIALS SHALL BE PERFORMED TO VERIFY THAT THE RECOMMENDED LEVEL OF COMPACTION IS ACHIEVED DURING CONSTRUCTION. THEREFORE, ONE DENSITY TEST SHALL BE PERFORMED FOR EVERY 2,500 SQUARE FEET OF AREA FOR EVERY LIFT OF FILL OR AS RECOMMENDED BY THE ON-SITE GEOTECHNICAL ENGINEER.
- 7. TESTING WILL BE REQUIRED ALONG THE RCP OUTLET BARRELS AT A FREQUENCY OF ONE TEST PER 25 LF OF PIPE PER VERTICAL FOOT OF FILL OR AS DIRECTED BY THE ON-SITE GEOTECHNICAL ENGINEER.

STATEMENT OF RESPONSIBILITY

1. ALL REQUIRED MAINTENANCE AND INSPECTIONS OF THE STORMWATER CONTROL MEASURE SHALL BE THE RESPONSIBILITY OF THE OWNER, PER THE EXECUTED OPERATION AND MAINTENANCE AGREEMENT FOR THIS FACILITY.

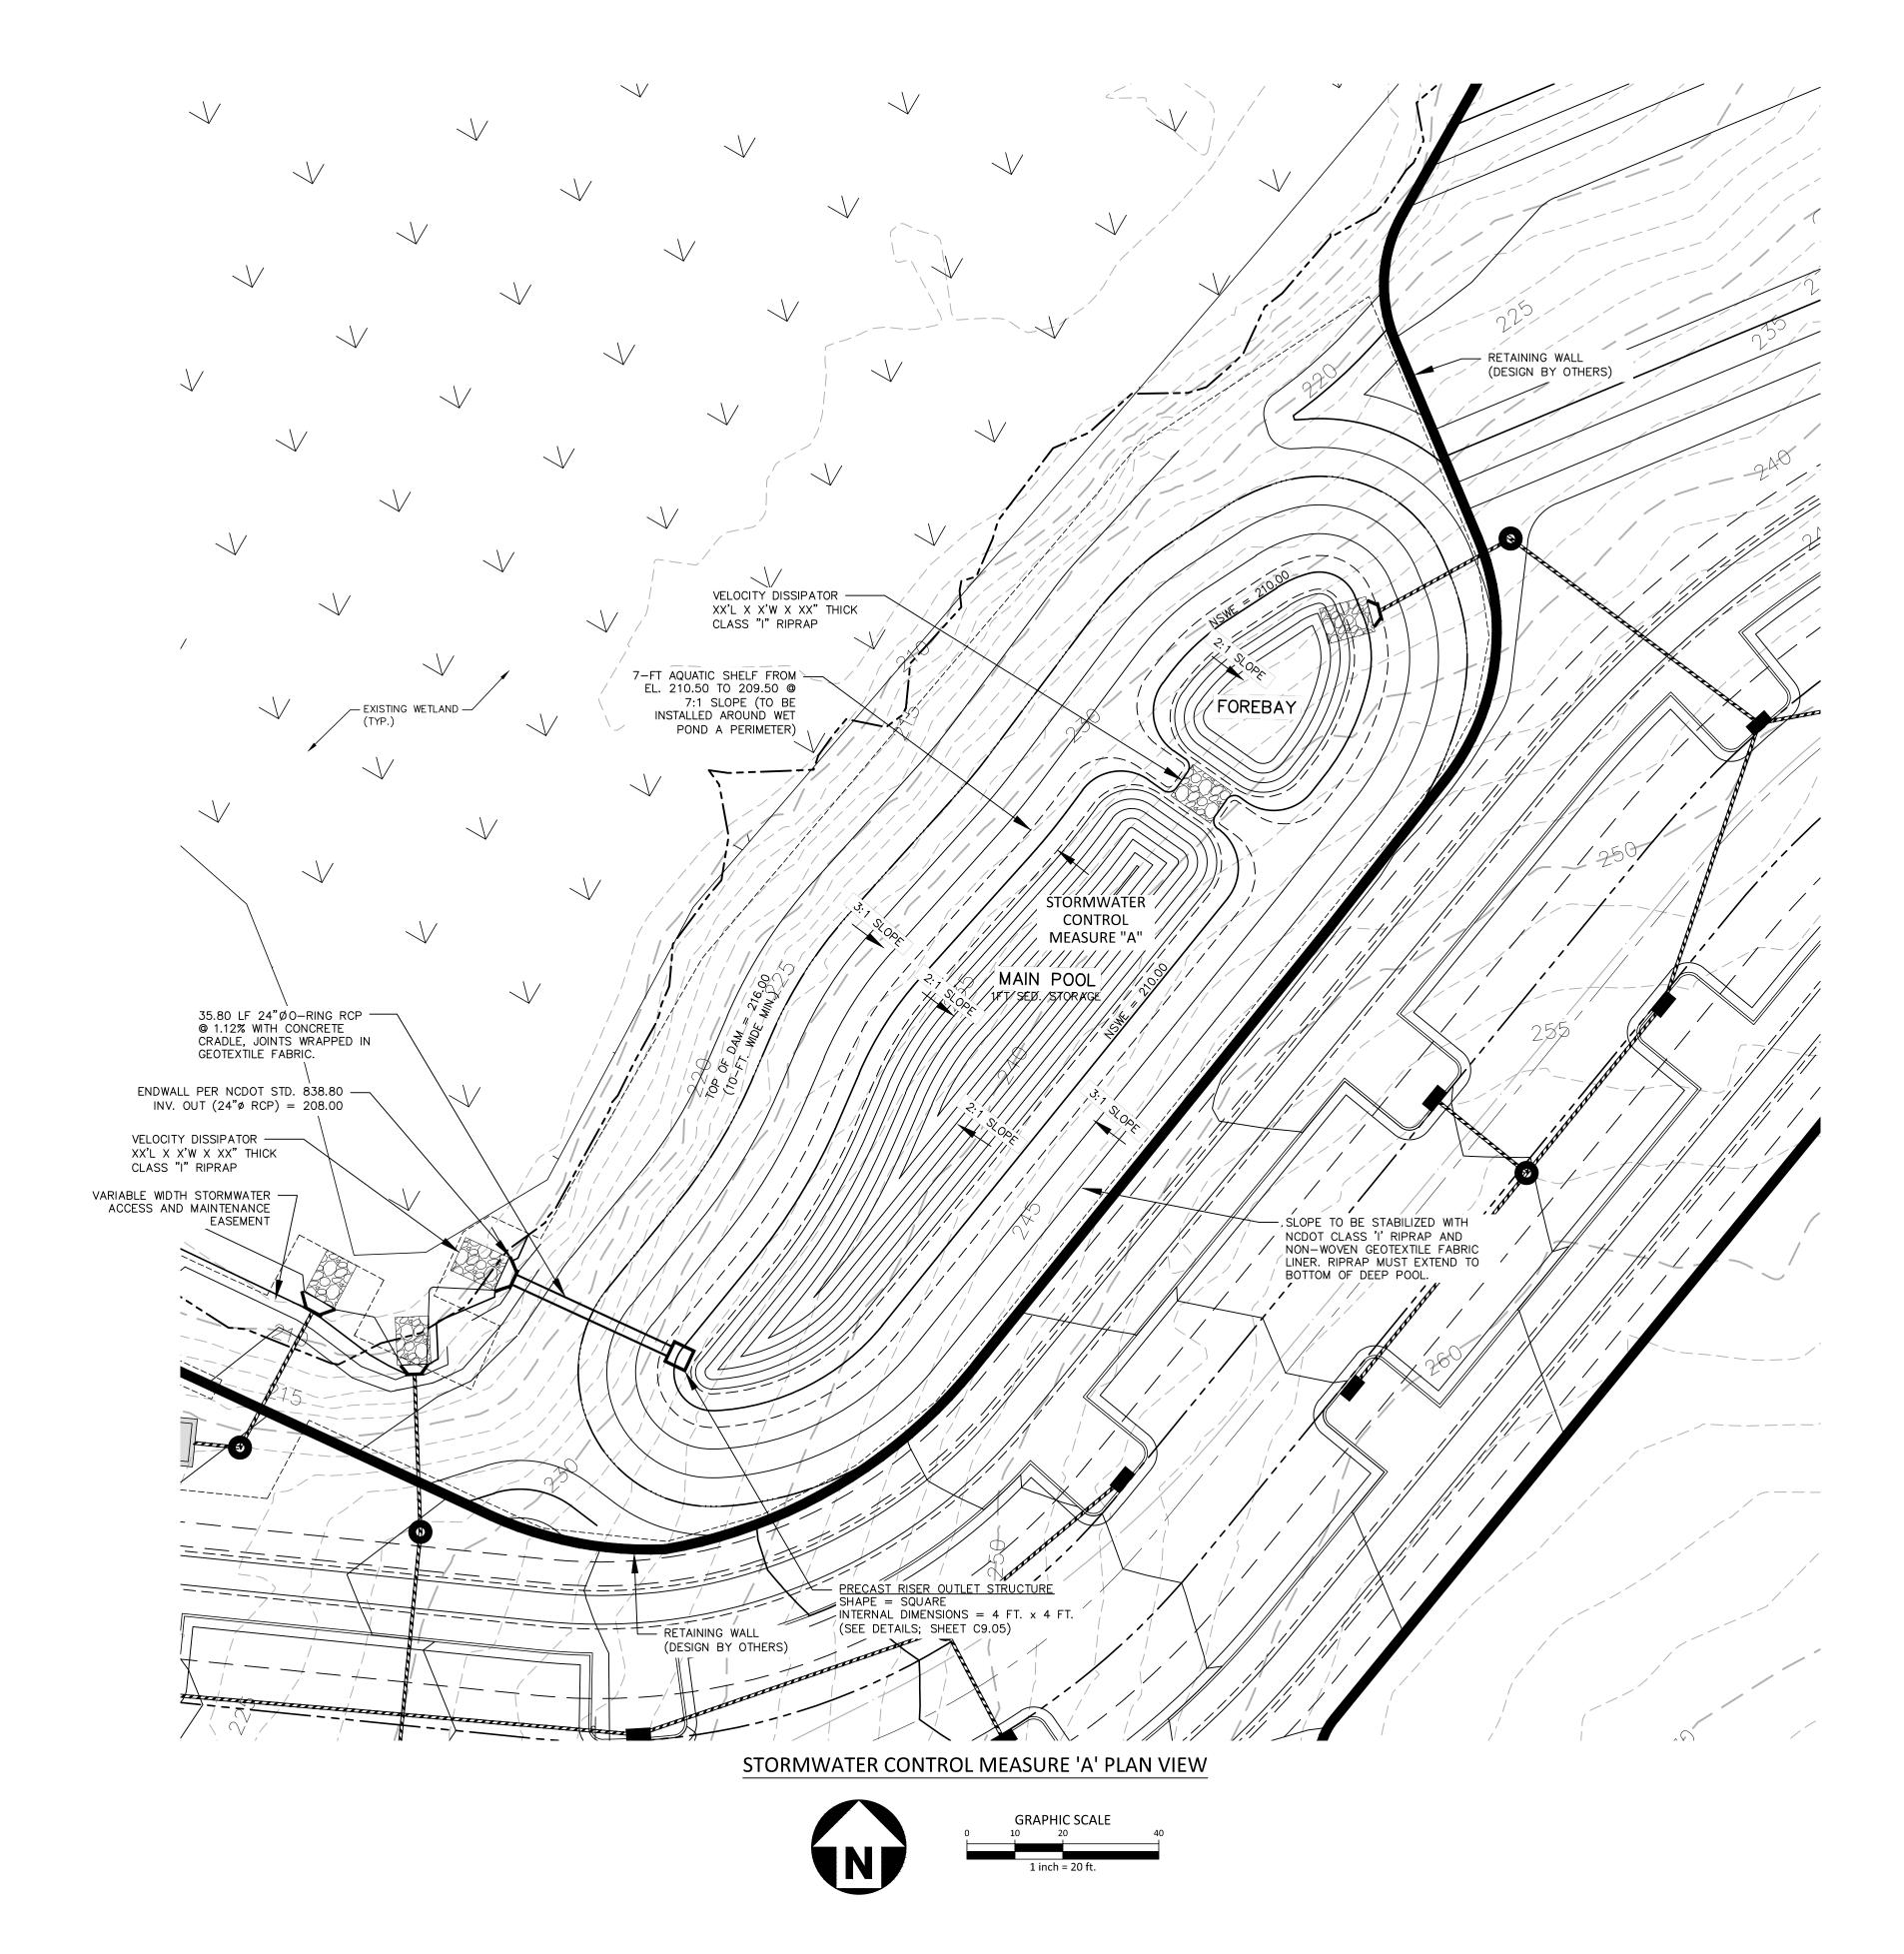



Raleigh, NC 27603

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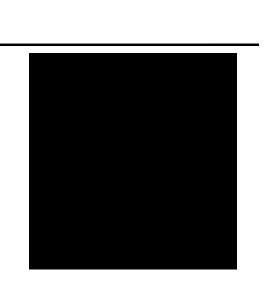
CLIENT MILL CREEK RESIDENTIAL 702 OBERLIN RD, SUITE 420

RALEIGH, NC 27605

PHONE: 704. 833. 8415







REVISIONS

PLAN INFORMATION


PROJECT NO. MCR-23004

SHEET

PRELIMINARY DRAWING - NOT RELEASED FOR CONSTRUCTIO

09. 08. 2023

STORMWATER CONTROL MEASURE B PLAN VIEW

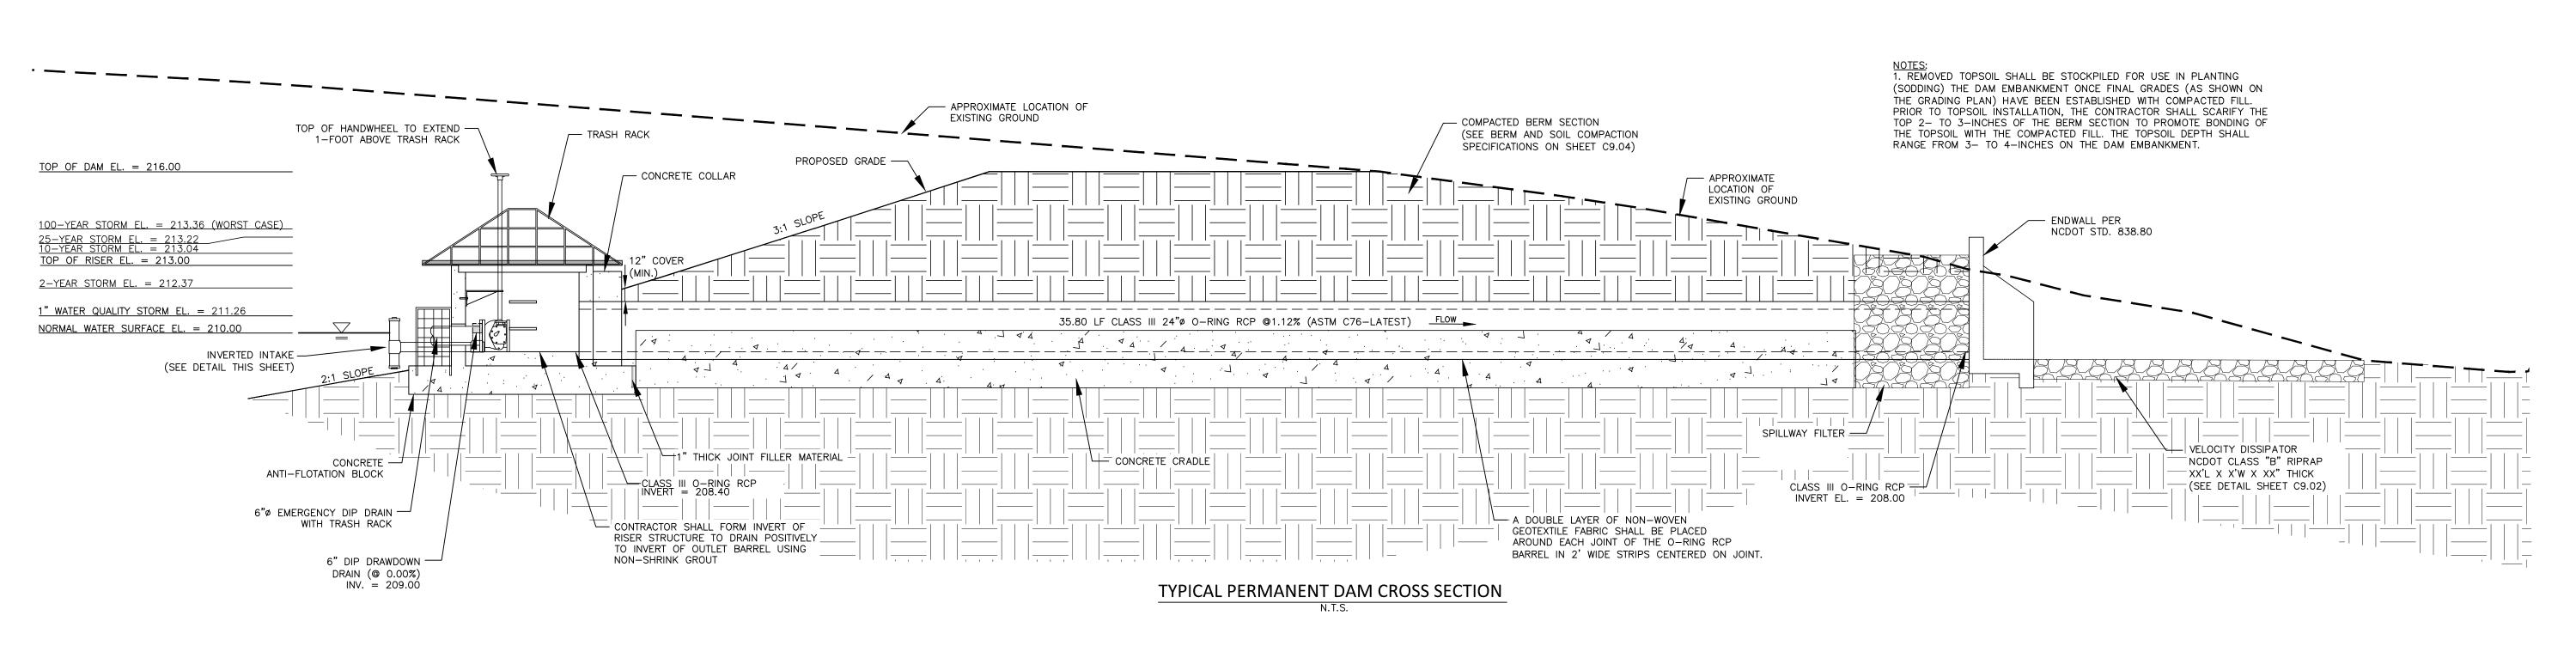

THE PIPE PENETRATION

USING A RUBBER BOOT AND STAINLESS STEEL

6" PLUG VALVE. THE VALVE

ENGINEER-APPROVED
EQUIVALENT. THIS VALVE

SHALL BE IN ACCORDANCE

TOP OF OUTLET STRUCTURE

(CENTER TO CENTER)

BE IN ACCORDANCE WITH AWWA C-517, AND SHALL BE OPERABLE FROM TOP OF OUTLET

STRUCTURE VIA A HANDWHEEL.

WITH AWWA C-517, AND

VIA A HANDWHEEL.

#6 REBAR — A A A P. PERIMETER

CONTRACTOR SHALL SEAL THE
PIPE PENETRATION USING A
RUBBER BOOT AND STANSOF

RUBBER BOOT AND STAINLESS EQUIVALENT. THIS VALVE SHALL

HARDWARE


SHALL BE A M&H STYLE 1820 ECCENTRIC VALVE OR


(CENTER TO CENTER)


4"x4" % WELDED WIRE FABRIC —


STEEL HARDWARE

(EACH SIDE & TOP OF CAGE)

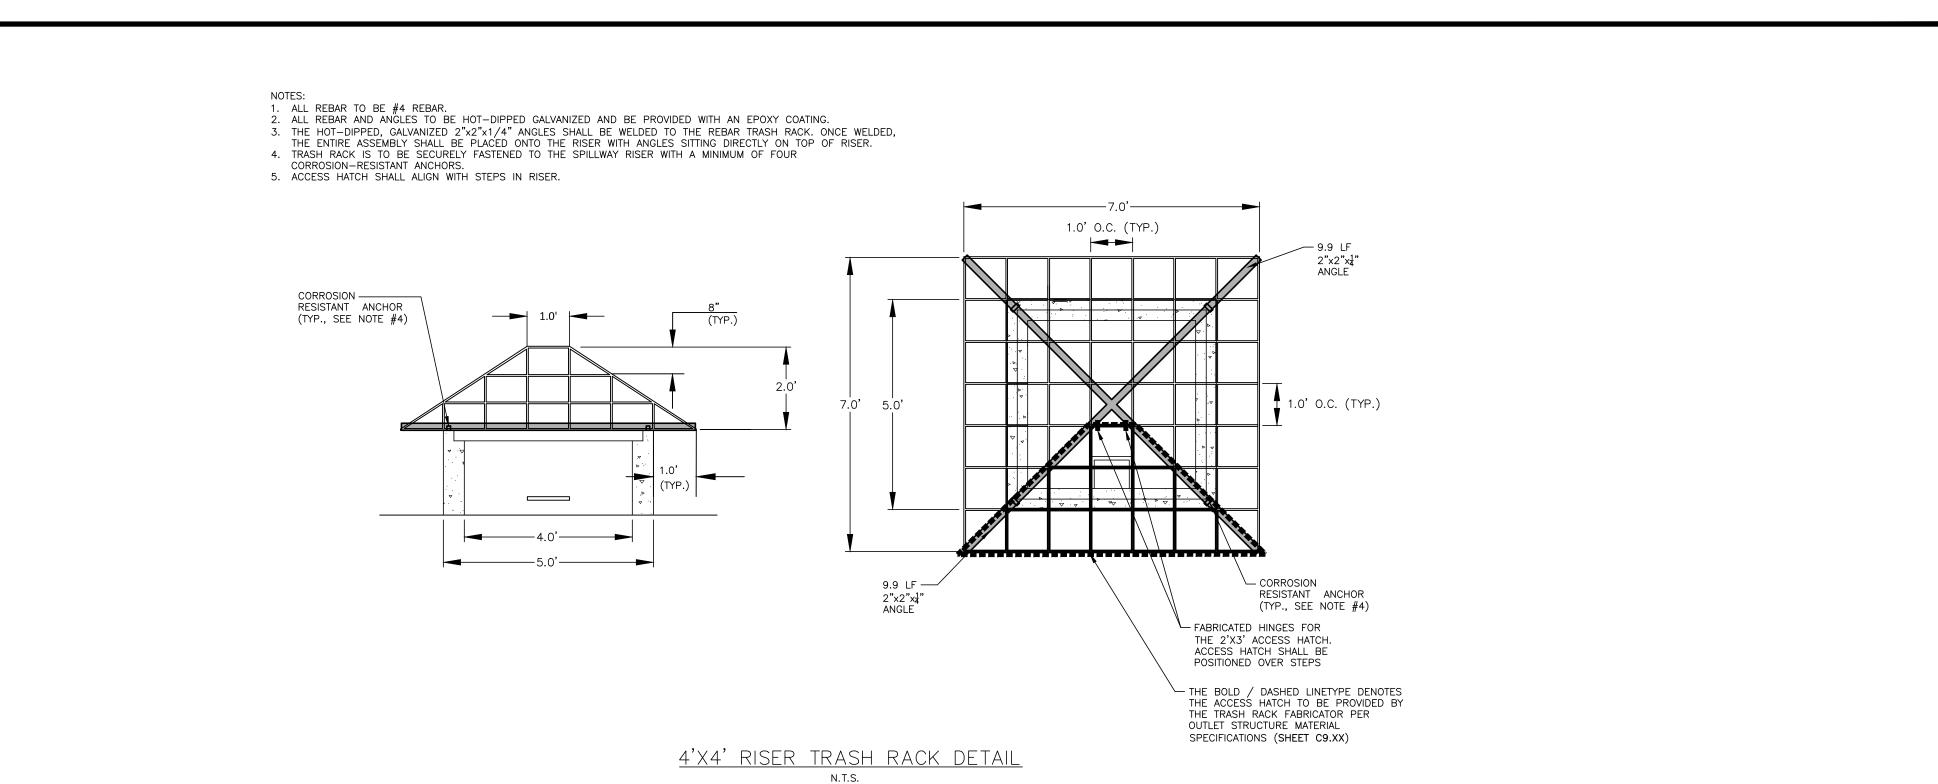

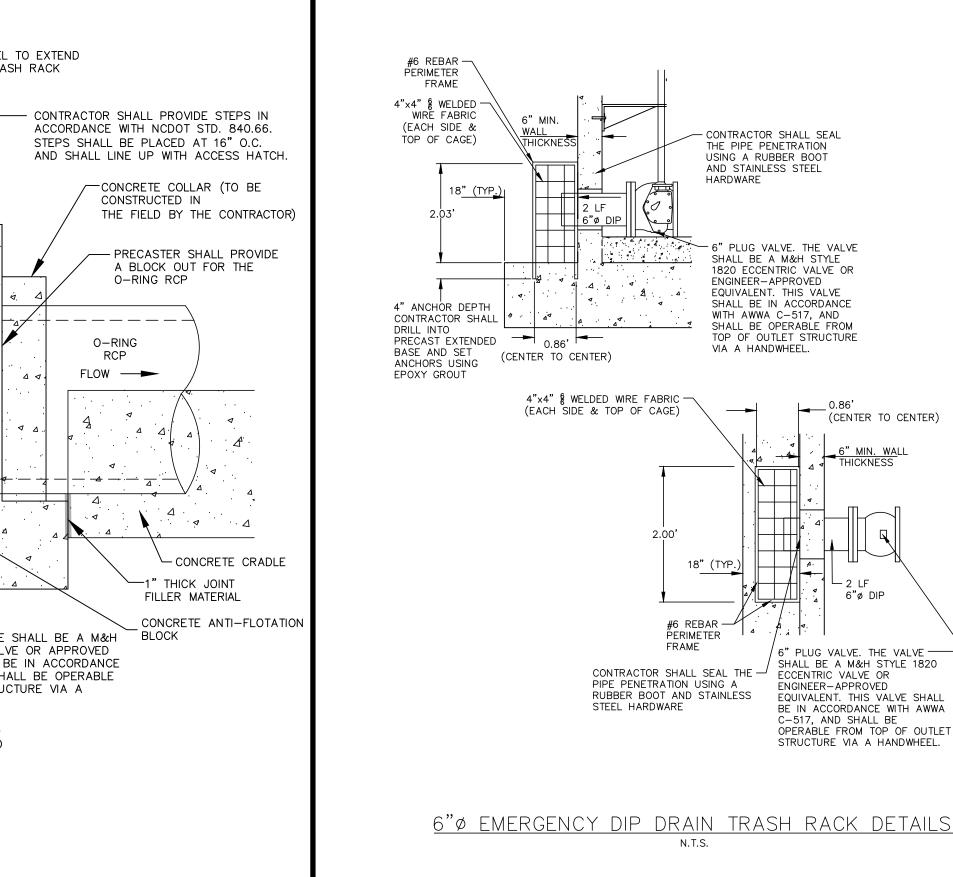

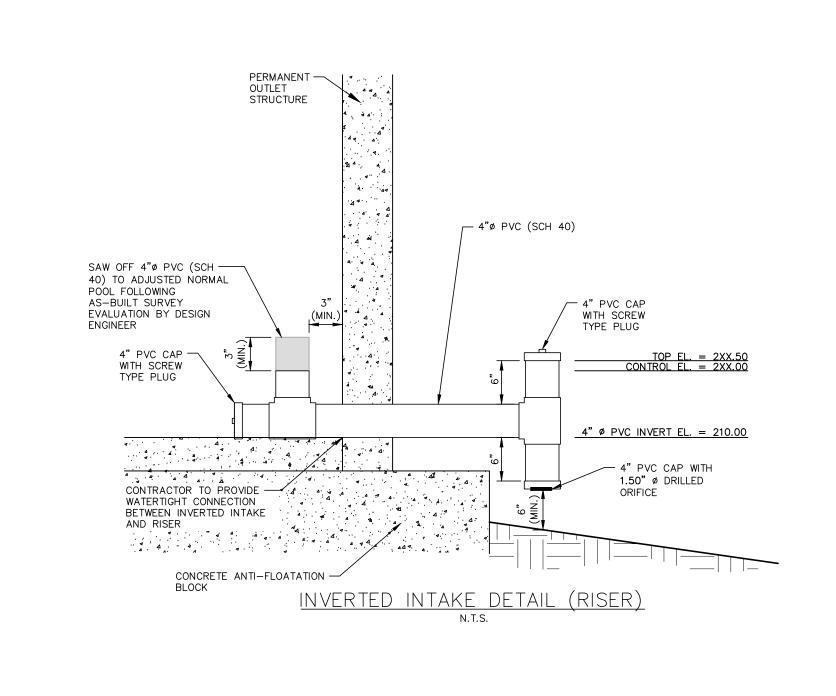

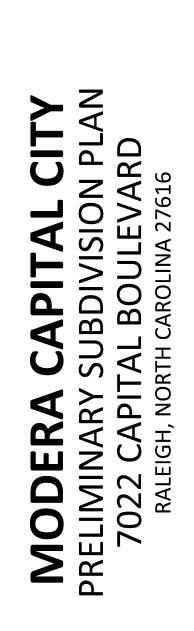

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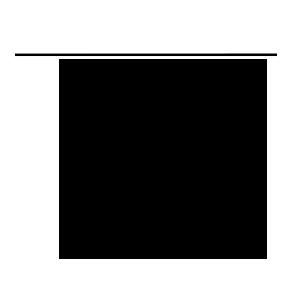
CLIENT

MILL CREEK RESIDENTIAL

RALEIGH, NC 27605

PHONE: 704. 833. 8415

702 OBERLIN RD, SUITE 420



REVISIONS

NO. DATE

PLAN INFORMATION

PROJECT NO. MCR-23004 FILENAME MCR23004-SWB

CHECKED BY ACP DRAWN BY SCALE N.T.S. DATE 09. 08. 2023

SHEET

PRELIMINARY DRAWING - NOT RELEASED FOR CONSTRUCTION

STORMWATER CONTROL **MEASURE B DETAILS**

- PRECASTER SHALL PROVIDE A BLOCK OUT FOR THE

1" THICK JOINT FILLER MATERIAL

CONCRETE COLLAR (TO BE CONSTRUCTED IN

-1" THICK JOINT FILLER MATERIAL

CONTRACTOR SHALL PROVIDE STEPS IN ACCORDANCE WITH NCDOT STD. 840.66. STEPS SHALL BE PLACED AT 16" O.C. AND SHALL LINE UP WITH

ACCESS HATCH.

TOP OF RISER EL. = 213.00

INVERT EL. = 208.40

THE FIELD BY THE CONTRACTOR)

TOP OF HANDWHEEL TO EXTEND 1-FOOT ABOVE TRASH RACK

· 4 4 .

O-RING RCP FLOW —

8" DIP DRAIN — W/ TRASH RACK

8" PLUG VALVE. THE VALVE SHALL -BE A M&H STYLE 1820 ECCENTRIC

8"ø DIP DRAIN -

W/ TRASH RACK

ANTI-FLOTATION

BY CONTRACTOR

CONCRETE SUPPORT BLOCK TO


BE CONSTRUCTED IN THE FIELD

24"ø O-RING

VALVE OR APPROVED EQUAL. THIS

VALVE SHALL BE IN ACCORDANCE WITH AWWA C-517, AND SHALL BE OPERABLE FROM TOP OF OUTLET STRUCTURE VIA A HANDWHEEL.

CONCRETE CRADLE

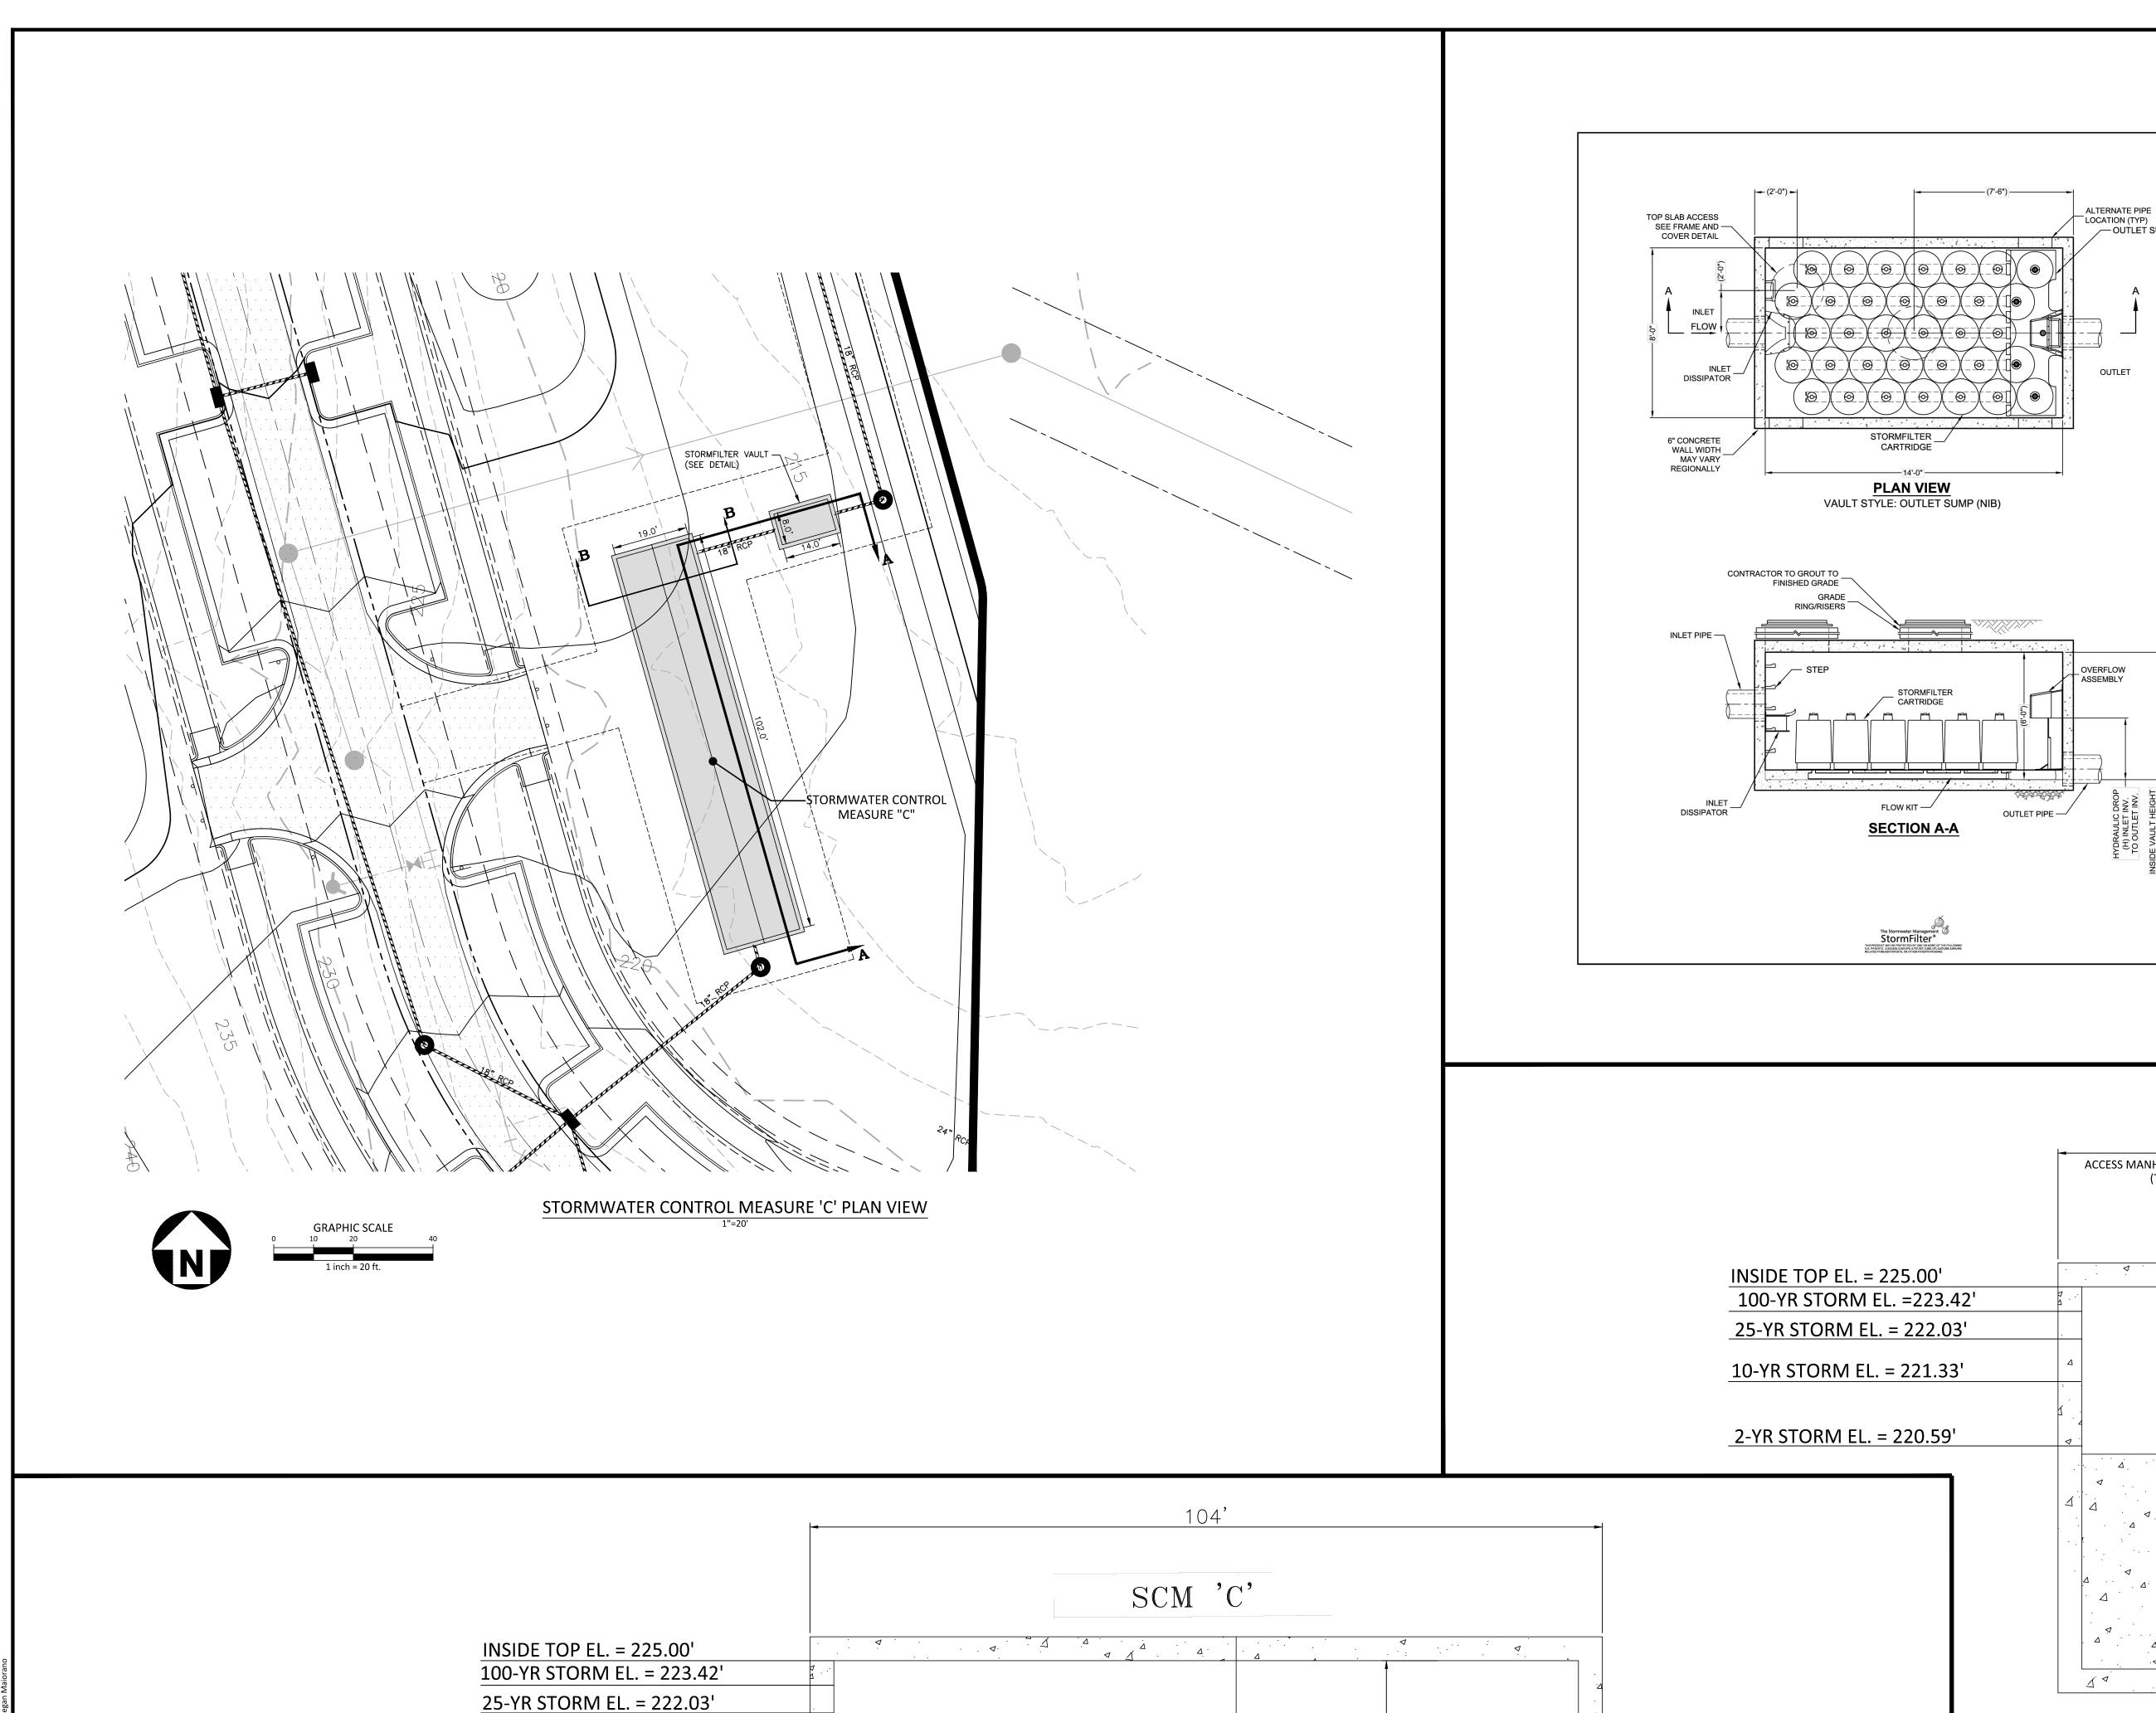

WEIR HEIGHT = 220.45'

Δ· · · Δ

SECTION A-A

N.T.S.

— INVERT OUT = 216.00'

└─ 18" RCP; 20 LF @ 1.00%

`— INVERT IN = 215.80'

— (34) 27" STORMFILTER

(PHOSPHOSORB)

CARTRIDGE

10-YR STORM EL. = 221.33'

2-YR STORM EL. = 220.59'

CONTECH WQ


VAULT


─ INVERT OUT = 212.75'

(1) CONTECH SF0811 STORMFILTER — DEVICE

18" RCP; 12 LF @ 1.00% —

FLOW TO JB-405

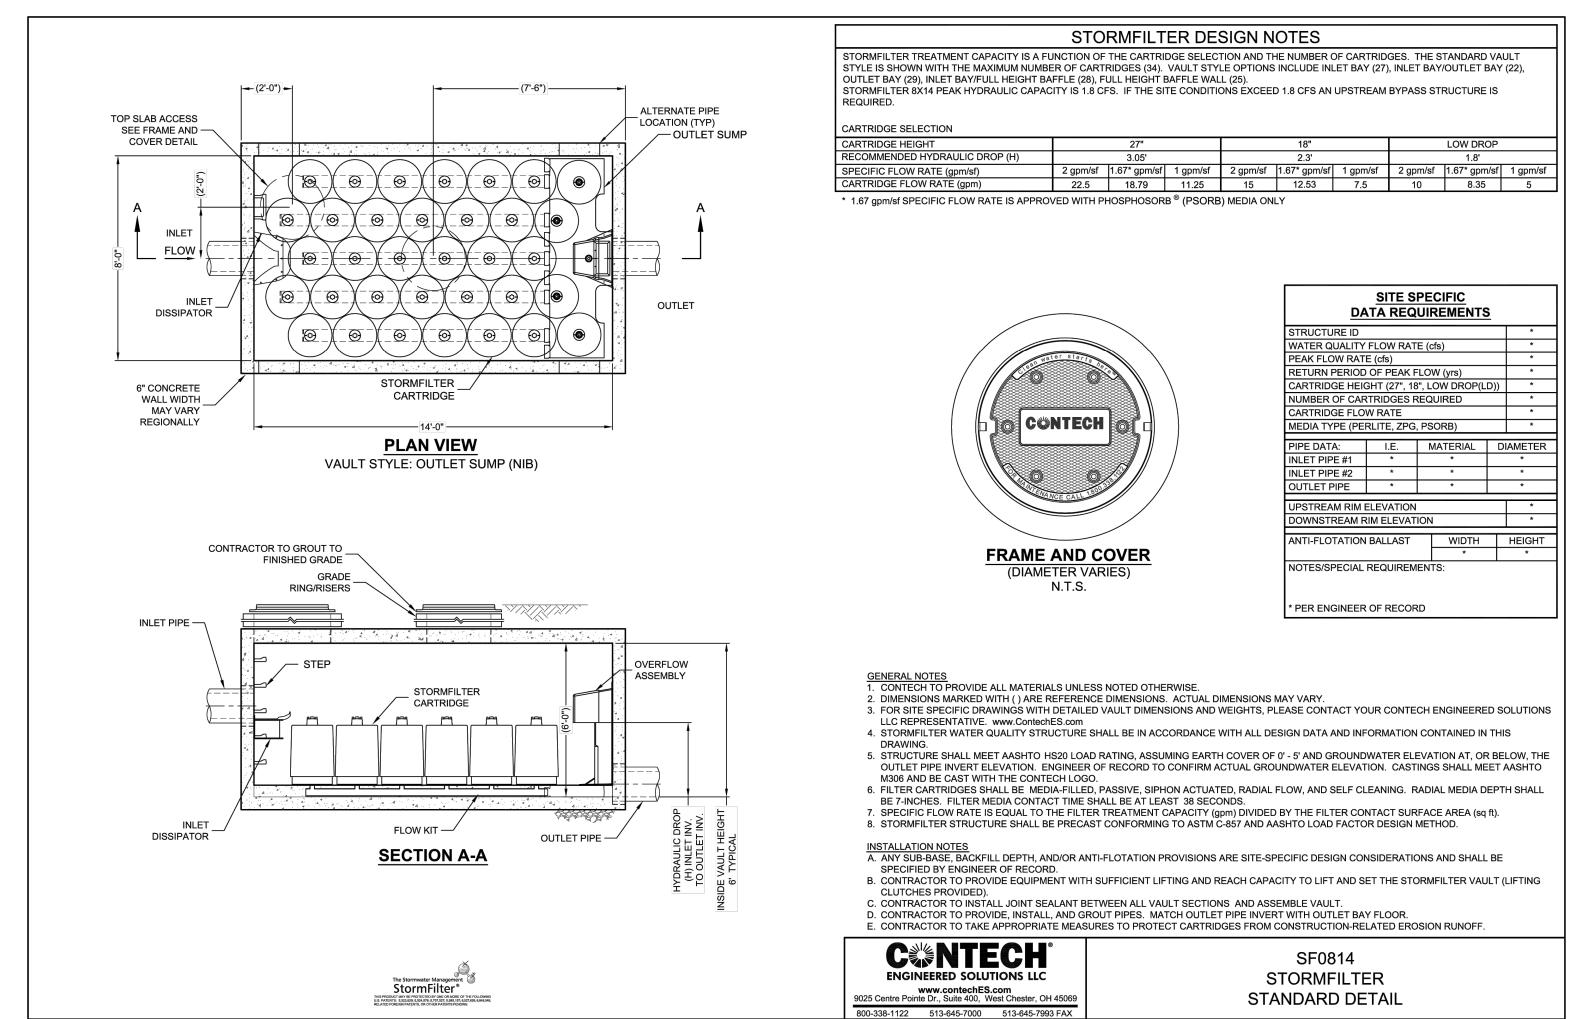

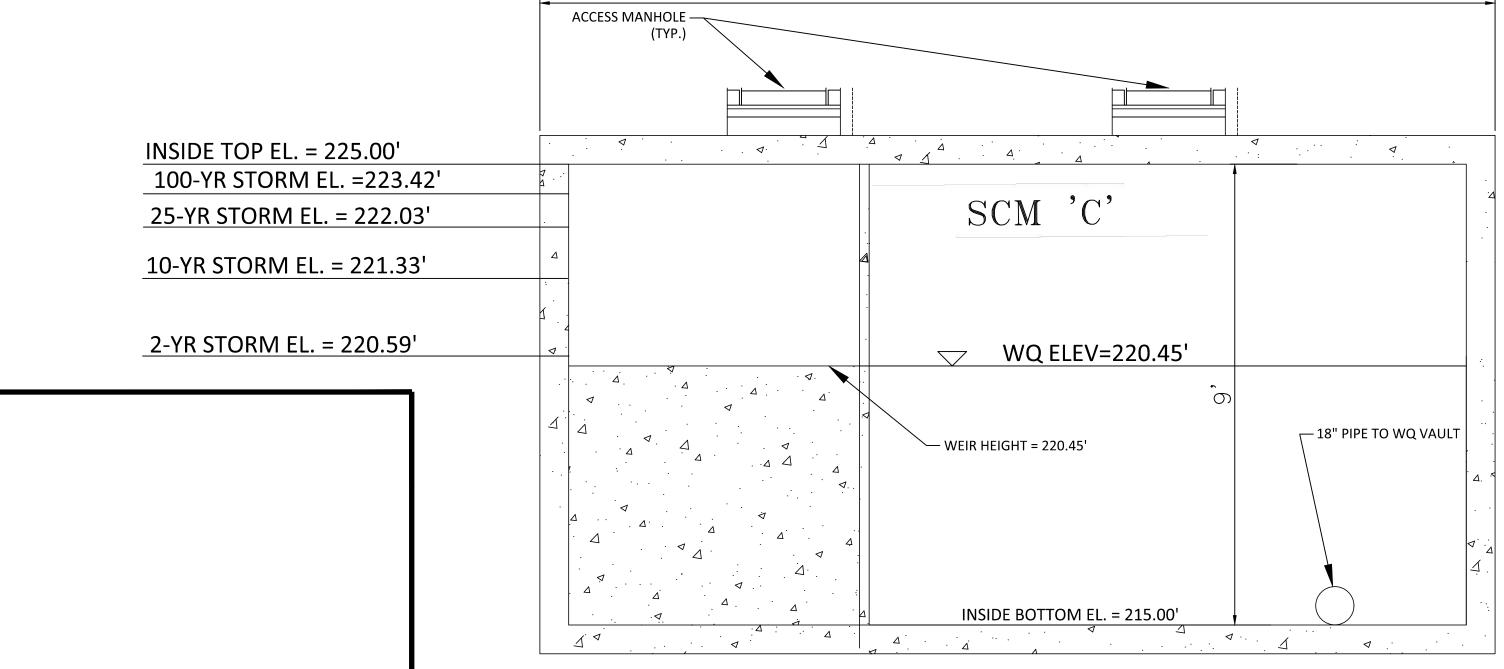

FROM UPSTREAM

─ 18" RCP "O-RING" FROM JB-204

INSIDE BOTTOM EL. = 216.00'

INV. ELEV.=383.45'

SECTION B-B N.T.S.

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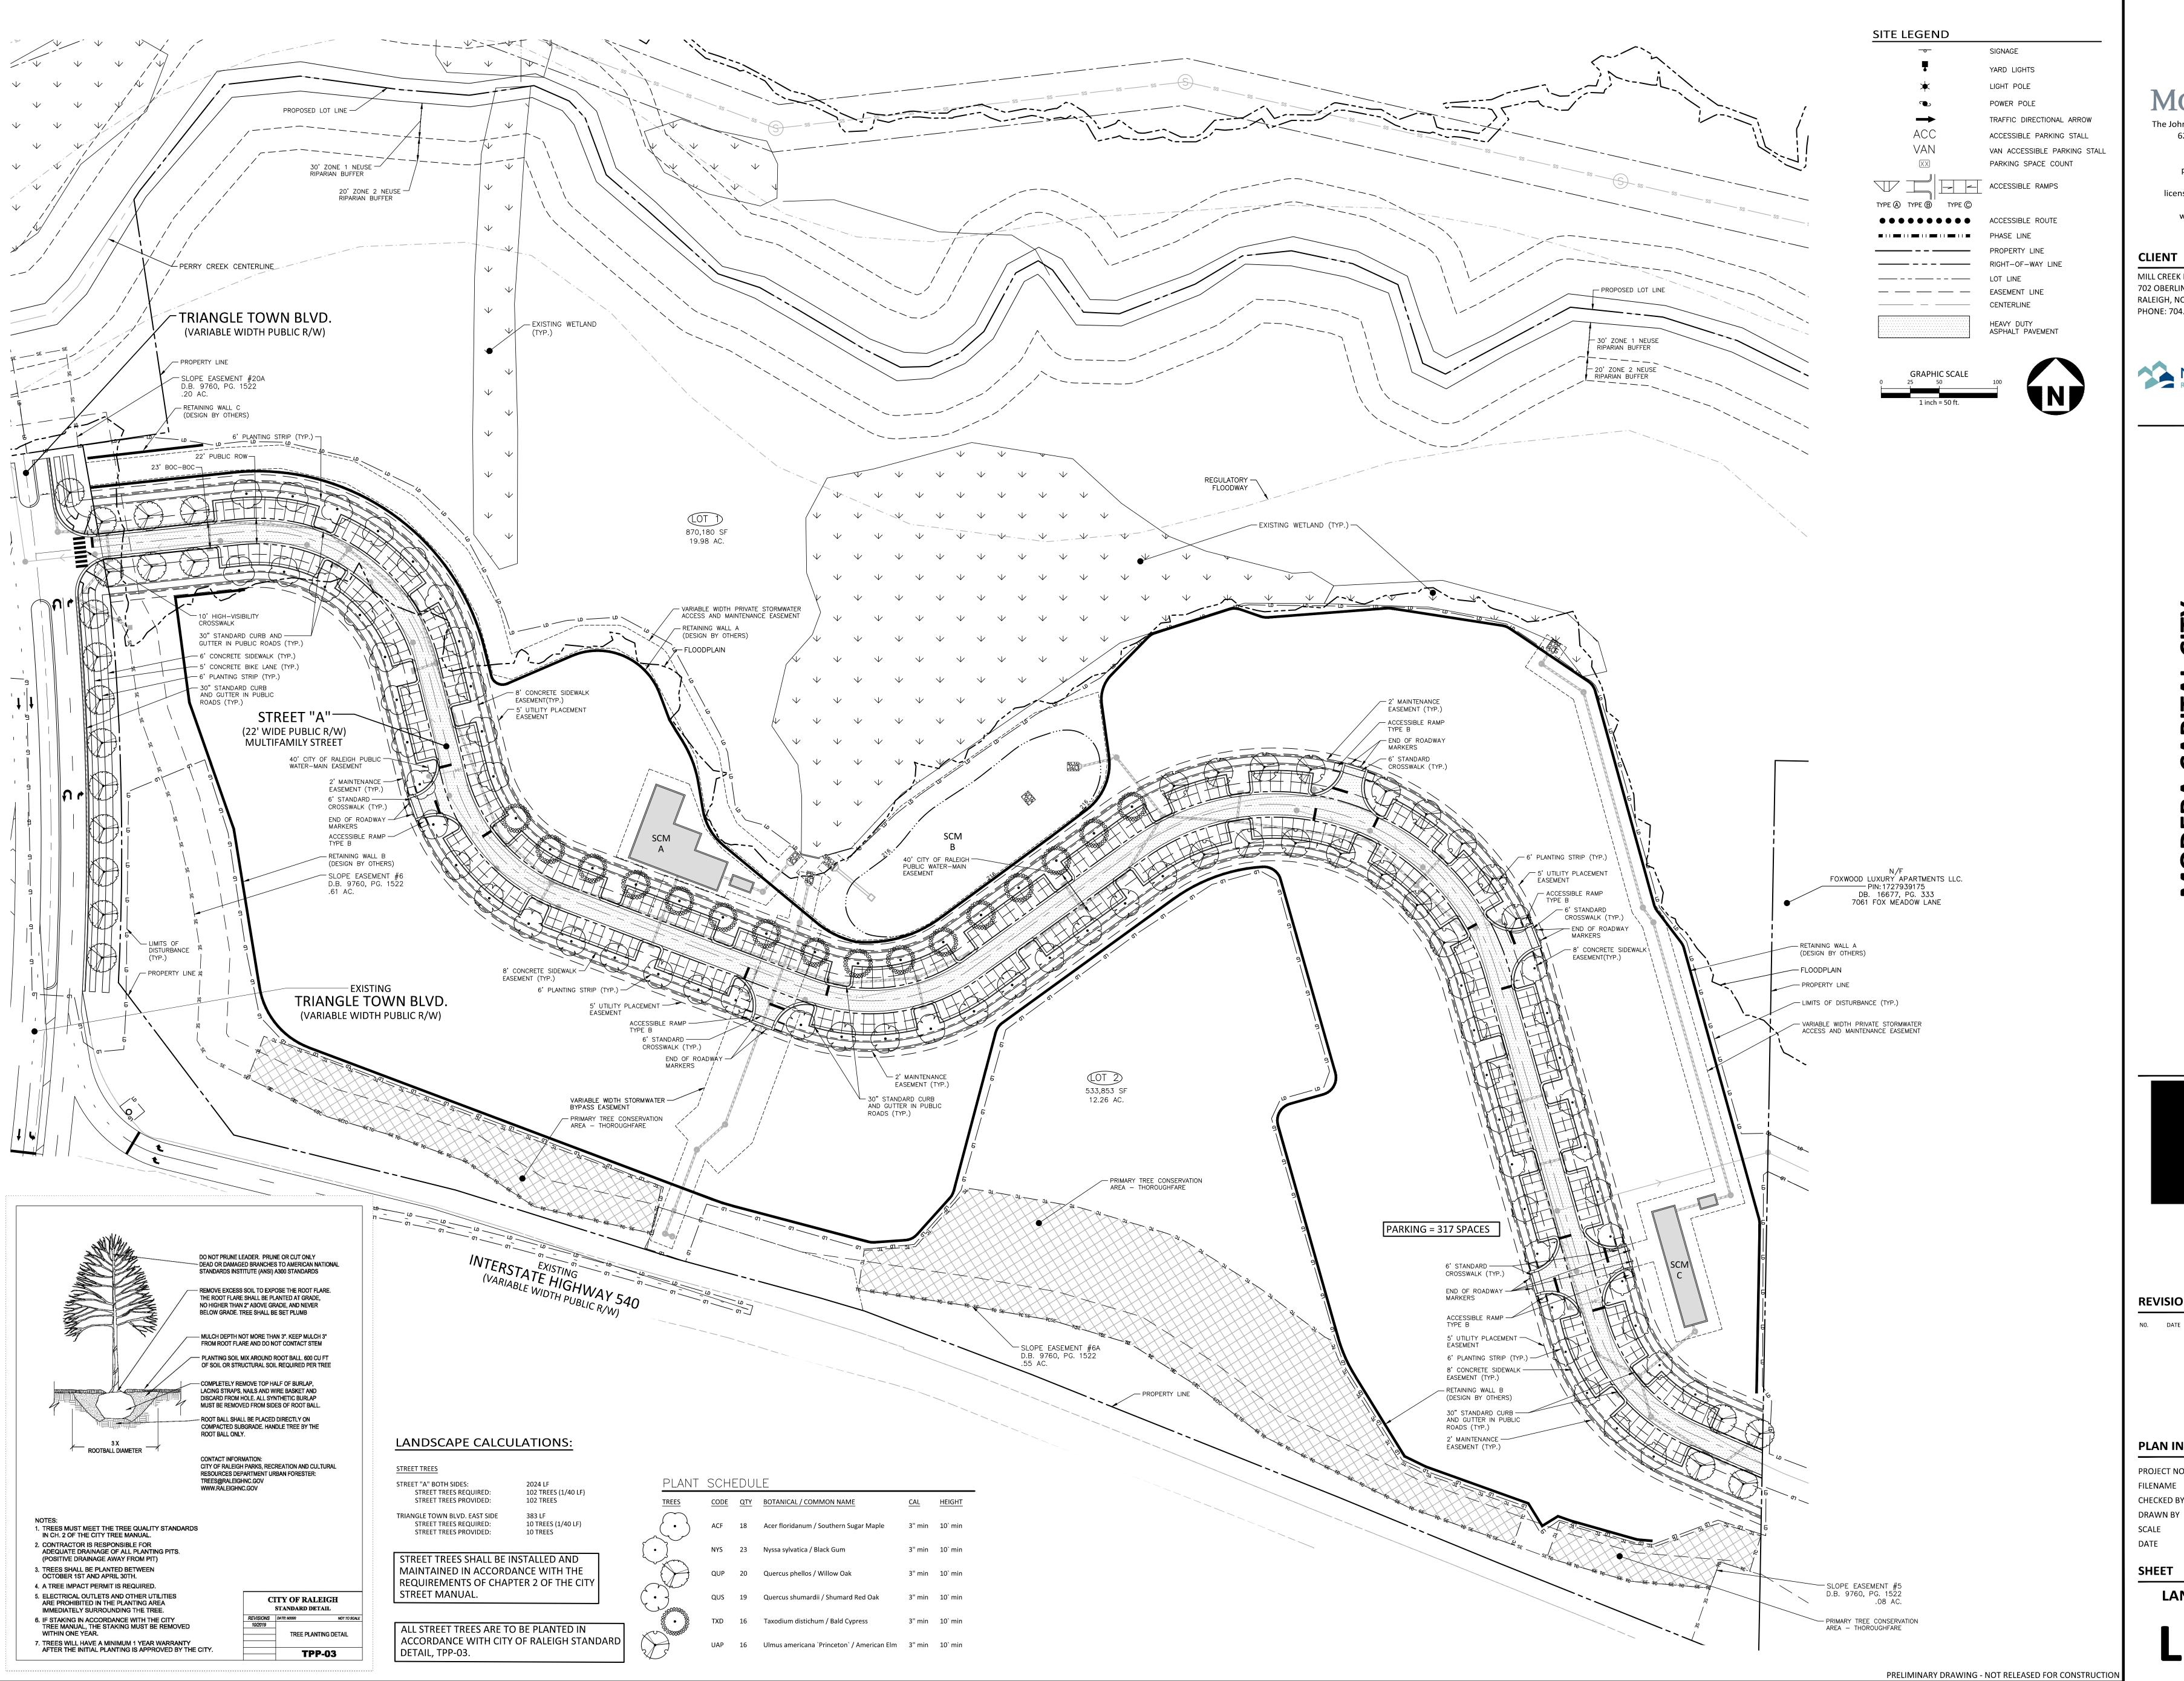
PLAN INFORMATION

PROJECT NO. MCR-23004 MCR23004-SWC FILENAME

CHECKED BY DRAWN BY 09. 08. 2023 DATE

PRELIMINARY DRAWING - NOT RELEASED FOR CONSTRUCTION

SHEET STORMWATER CONTROL **MEASURE C DETAILS**





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NO. DATE


PLAN INFORMATION

PROJECT NO. MCR-23004 FILENAME MCR23004-LS1 CHECKED BY JGY DRAWN BY MCG

1" = 50' 09. 08. 2023

SHEET

LANDSCAPE PLAN

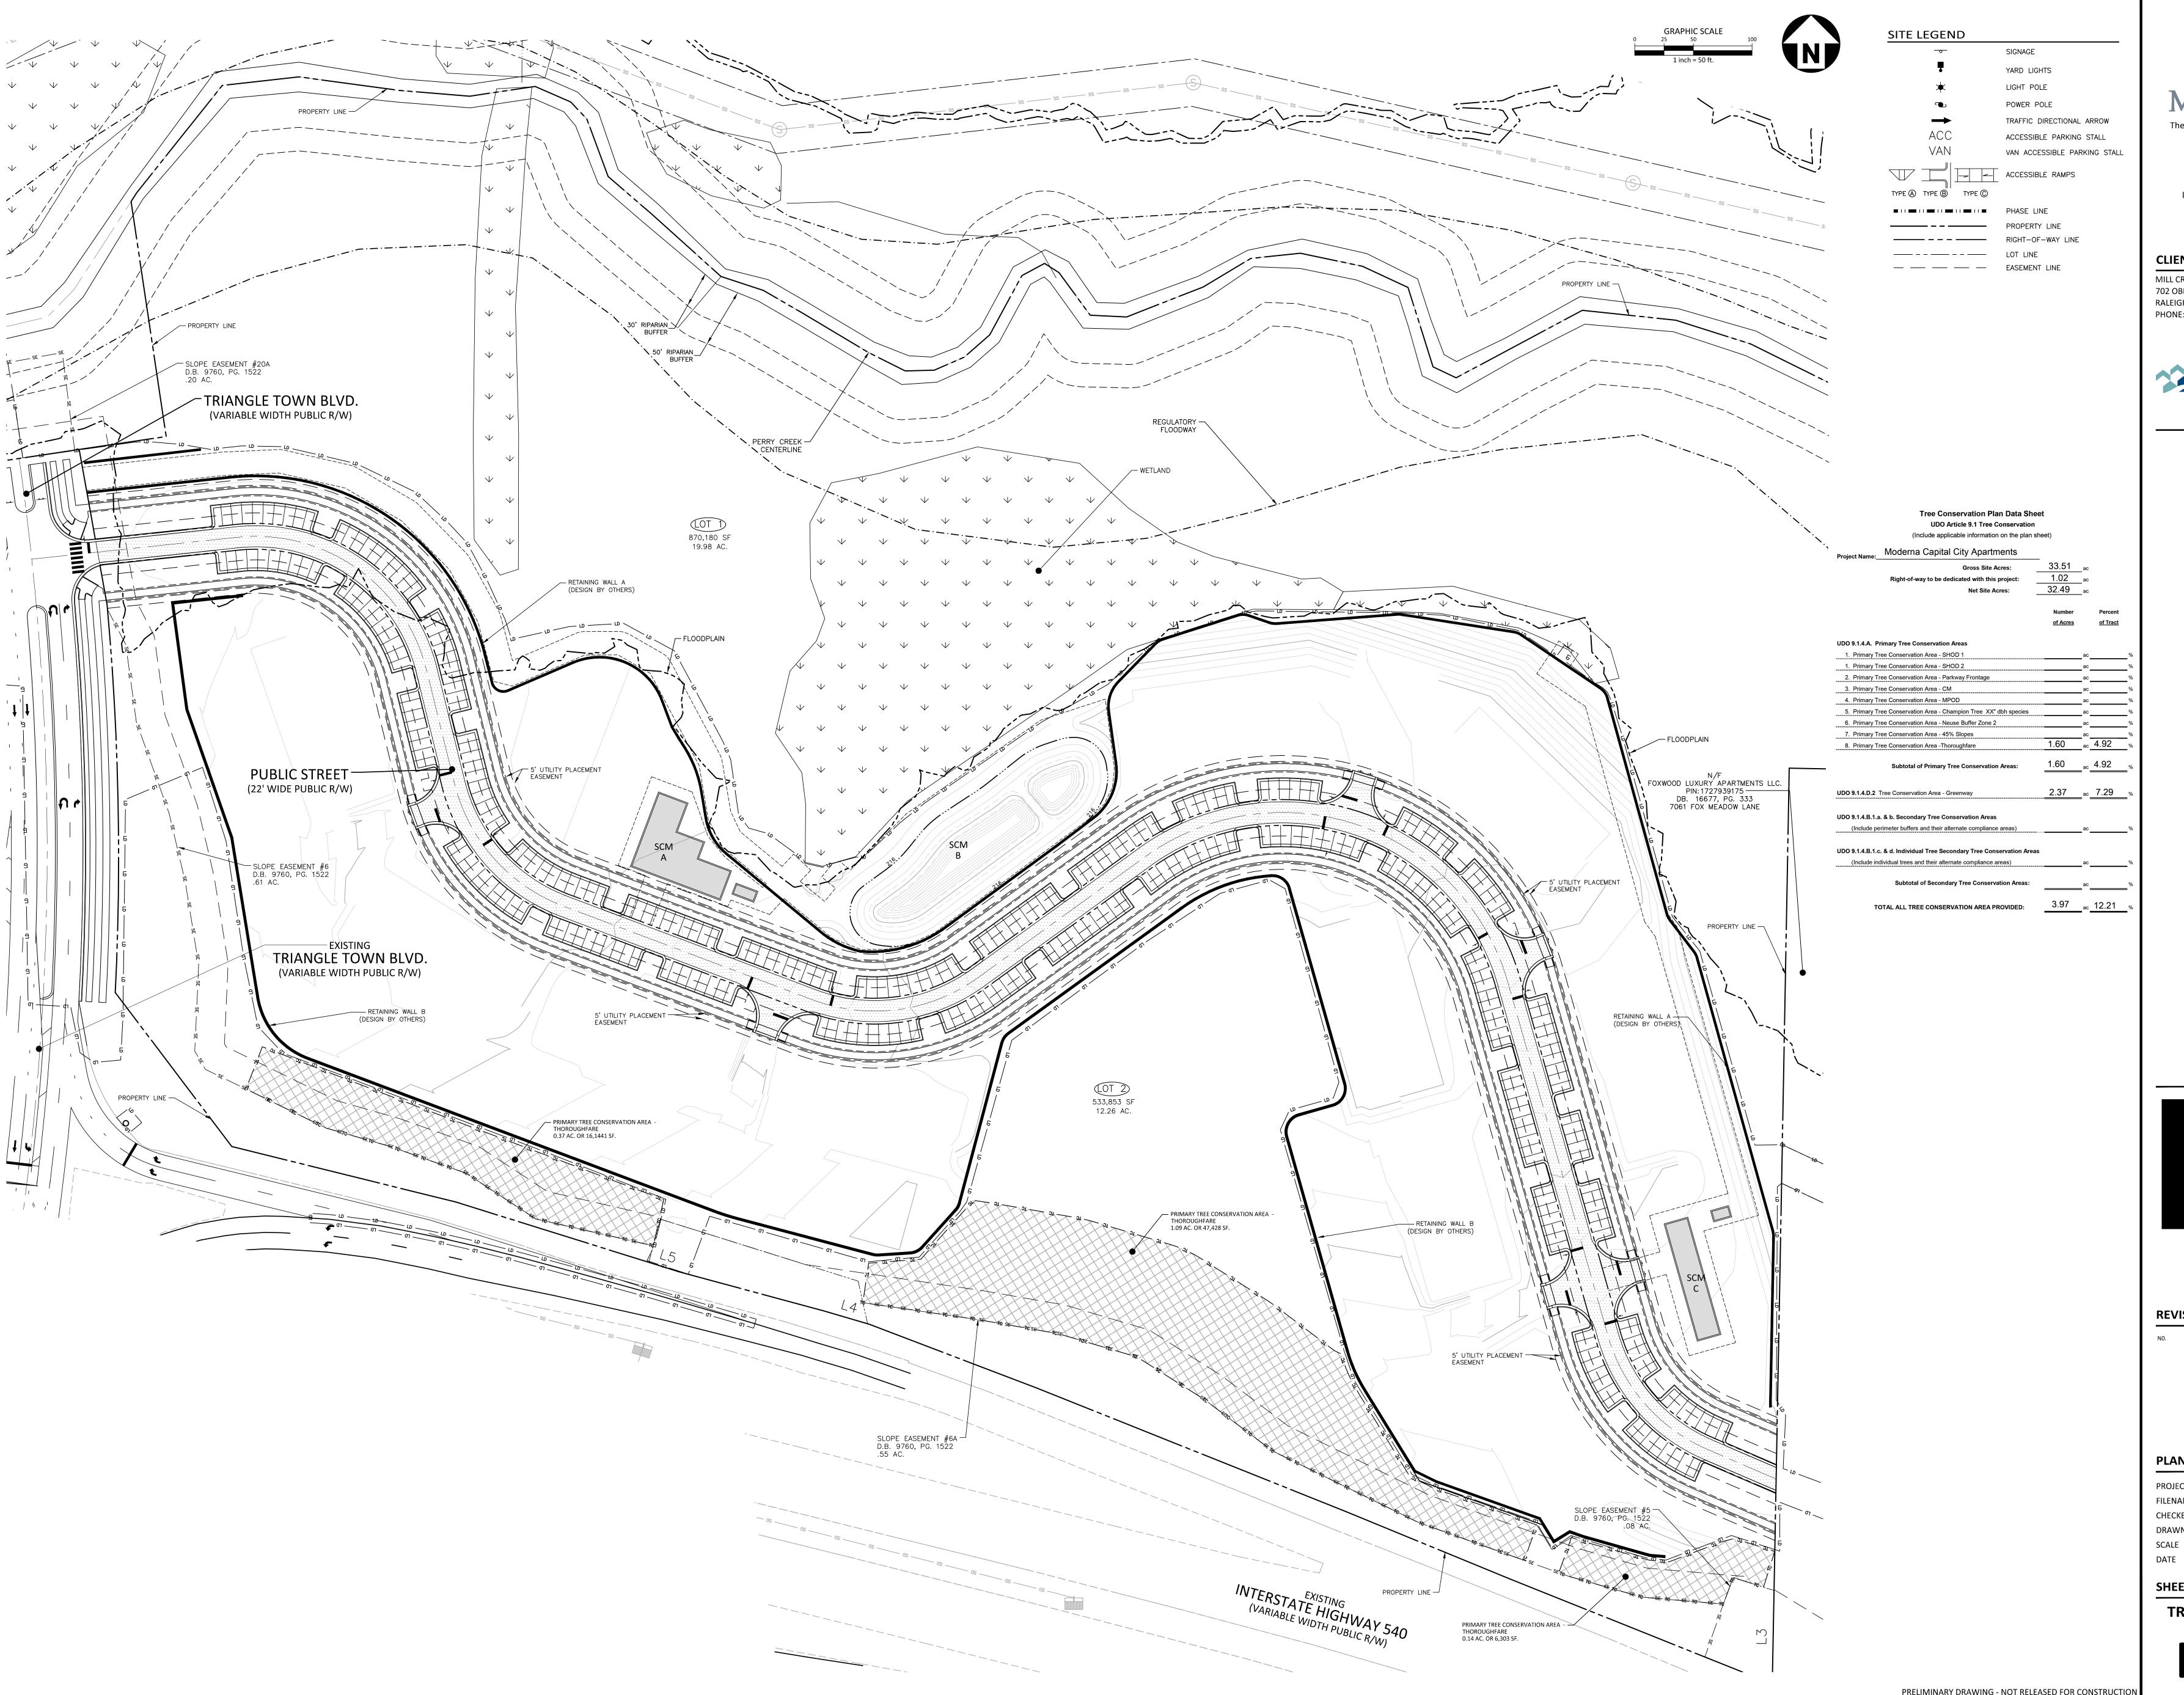



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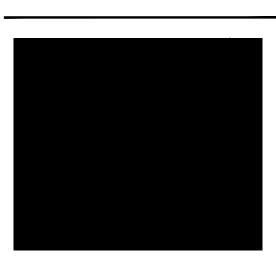
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CLIENT MILL CREEK RESIDENTIAL

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REVISIONS

NO. DATE

PLAN INFORMATION

PROJECT NO. MCR-23004 FILENAME MCR23004-TC1

CHECKED BY ACP DRAWN BY

TREE CONSERVATION PLAN