Preliminary Subdivision Application

Site Review

Planning and Development Customer Service Center • One Exchange Plaza, Suite 400 | Raleigh, NC 27601 | 919-996-2500



INSTRUCTIONS: This form is used when submitting a Preliminary Subdivision (UDO Section 10.2.5). Please check the appropriate review type and include the plan checklist document. Please email all documents and your preliminary subdivision plans to <u>SiteReview@raleighnc.gov</u>.

	DEVELOPMI	ENT OPTION	S (UDO Cha	apter 2)		
Conventional Subdiv	ional Subdivision Compact De			Co	onservation Development	
Cottage Court	Cottage Court			Frequent Transit Development Option		
NOTE: Subdivisions may requir	re City Council app	roval if locate	d in a Histor	ric Overlay Di	istrict.	
	GEN	IERAL INFO	RMATION			
Scoping/sketch plan case numb	per(s):					
Development name (subject to	approval):					
Property Address(es):						
Recorded Deed PIN(s):						
Building type(s): Deta	ached House	Attached H	louse	Townhouse	Apartment	
General Building Mixe	ed Use Building	Civic Build	ing	Open Lot	Tiny House	
CURRENT	PROPERTY OWN	IER/APPLIC	ANT/DEVEL	OPER INFO	RMATION	
Current Property Owner(s) Na	mes:					
Company:		Title	:			
Address:						
Phone #:	Emai	I:				
Applicant Name (If different fro	om owner. See "w	ho can appl	y" in instrue	ctions):		
Relationship to owner:	see or contract pur	chaser C)wner's auth	orized agent	Easement holder	
Company:	Addro	ess:				
Phone #:	Phone #: Email:					
NOTE: please attach purchase agreement or contract, lease or easement when submitting this form.						
Developer Contact Names:						
Company:	Company: Title:					

DEVELOPMENT TYPE + SITE DATE TABLE – ZONING INFORMATION

Gross site acreage:

Zoning districts (if more than one, provide acreage of each):

Overlay district(s):	Inside City Limits?	Yes	No	Historic District/Landmark:	N/A
Conditional Use District (CUD) Case # Z-	Board of Adjustment BOA-	Board of Adjustment Case #		Design Alternate Case # DA-	

STORMWATER INFORMATION						
Imperious Area on Parcel(s):		Impervious Area for Compliance (includes right-of-way):				
Existing (sf)Proposed total (sf)		_ Existing (sf)Proposed total (sf)				
NUMBER OF LOTS AND DENSITY						
# of Detached House Lots:	# of Attached Ho	ouse Lots: # of Townhouse Lots:				
# of Tiny House Lots:	# of Open Lots:	# of Other Lots (Apartment, General, Mixed Use, Civic):				
Total # of Lots: Total # Dwelling Units:						
# of bedroom units (if known): 1br 2br 3br 4br						
Proposed density for each zoning district (UDO 1.5.2.F):						

APPLICANT SIGNATURE BLOCK

Pursuant to state law (N.C. Gen. Stat. § 160D-403(a)), applications for development approvals may be made by the landowner, a lessee or person holding an option or contract to purchase or lease land, or an authorized agent of the landowner. An easement holder may also apply for development approval for such development as is authorized by the easement.


Acting as an authorized agent requires written permission from the property owner for the purposes of making this development approval and/or permit application. Written permission from the property owner to act as an authorized agent must be made available to the City of Raleigh upon request.

By submitting this application, the undersigned applicant acknowledges that they are either the property owner or one of the persons authorized by state law (N.C.G.S. 160D-403(a)) to make this application, as specified in the application. The undersigned also acknowledges that the information and statements made in the application are correct and the undersigned understands that development approvals are subject to revocation for false statements or misrepresentations made in securing the development approval, pursuant to N.C. Gen. Stat. § 160D-403(f).

The undersigned indicates that the property owner(s) is aware of this application and that the proposed project described in this application will be maintained in all respects in accordance with the plans and specifications submitted herewith, and in accordance with the provisions and regulations of the City of Raleigh Unified Development Ordinance.

The undersigned hereby acknowledges that, pursuant to state law (N.C.G.S. 143-755(b1), if this permit application is placed on hold at the request of the applicant for a period of six consecutive months or more, or if the applicant fails to respond to comments or provide additional information requested by the City for a period of six consecutive months or more, then the application review is discontinued, and a new application is required to proceed and the development regulations in effect at the time permit processing is resumed shall apply to the new application.

Signature:	Date:
Printed Name:	
Signature:	Date:
Printed Name:	

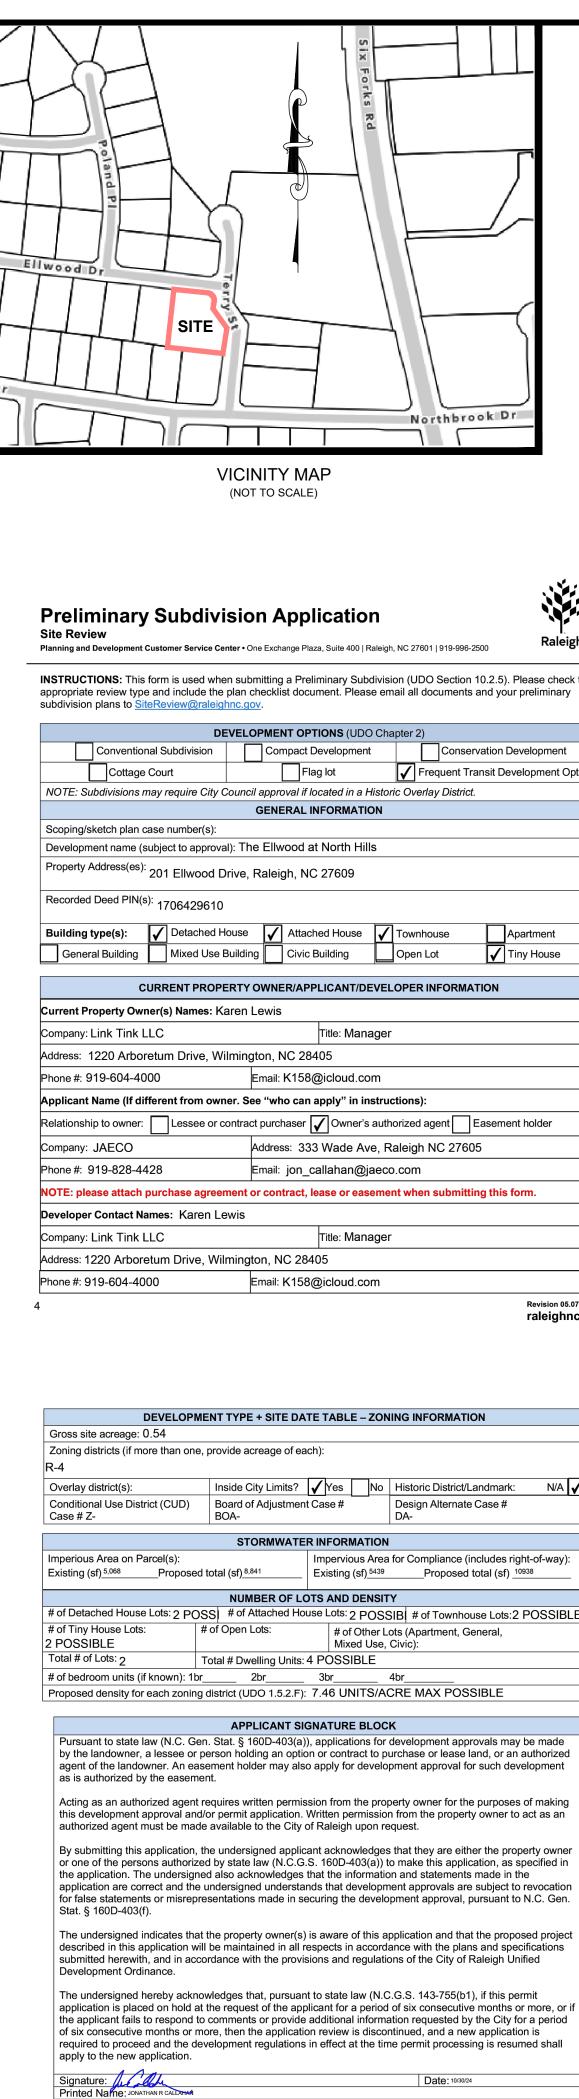

THE ELLWOOD AT NORTH HILLS 2 LOT SUBDIVISION OF GRANDFATHERED LOT IN FREQUENT TRANSIT DEVELOPMENT OPTION SUB-XXXX-2024 RALEIGH, NORTH CAROLINA ABBREVIATIONS APPLICABLE TO ENTIRE PLAN SET REQUIRED/ALLOWE THE FREQUENT TRANSIT DEVELOPMENT OPTION AC ACRE

ninar	v Sub	divisi	on Ap	olicat	ion					
ew	-		One Exchange			h, NC 276	601 919-9	996-2500		`] ! Raleigh
e review ty		ide the plan	bmitting a P checklist do gov.							
		DEVEL	OPMENT C		UDO Ch	apter 2)			
Conventi	onal Subdivi	ision	Compa	ct Developr	ment		Cor	nservation	Develo	pment
Cottag	e Court	`		Flag lot			requen	t Transit D	evelopr	nent Optic
ubdivisions	may require	e City Coun	cil approval	if located ir	n a Histo	ric Ove	rlay Dis	trict.		
			GENERA	LINFORM	ATION					
•	case numb	()	<u> </u>							
			he Ellwood							
Address(es	^{9):} 201 Ellw	ood Drive	, Raleigh,	NC 27609	9					
I Deed PIN	^{(s):} 170642	29610								
type(s):	✓ Deta	ched House	Att	ached Hou	se 🗸	Town	house		Apartm	ent
ral Building	Mixe	d Use Buildi	ing Civ	ic Building		Open	Lot	\checkmark	Tiny He	ouse
	CURRENT	PROPERTY	Y OWNER/A	PPLICAN	T/DEVE	LOPER		MATION		
roperty Ov	vner(s) Nan	nes: Karen	ı Lewis							
Link Tink	LLC			Title: N	lanage	r				
1220 Arb	oretum Dri	ve, Wilmin	igton, NC 2	28405						
919-604-4			Email: K15		d.com					
Name (If c	lifferent fro	om owner. S	⊥ See "who ca			ctions):			
ip to owne			act purchase		ner's aut	,		Easem	ent holo	der
JAECO			Address: 3				° L			
	1400						INC 2	7005		
919-828-4			Email: jon		•					
		-	t or contrac	t, lease or	easeme	ent whe	en subn	nitting this	; torm.	
	Names: Ka	Iren Lewis								
Link Tink					lanage	r				
		ve, Wilming	gton, NC 2							
19-604-4	000		Email: K15	58@icloud	d.com					
										rision 05.07.2
									. a	
	DEVELOP	MENT TYP	E + SITE D	ATE TABL	E – ZON	IING IN	FORMA	ATION		
te acreage:	0.54									
istricts (if n	nore than or	ne, provide a	acreage of e	ach):						
district(s):		Inside	City Limits?	🖌 Yes	No	Histor	ic Distri	ct/Landma	rk:	N/A 🖌
nal Use Dis <u>7</u> -	strict (CUD)	Board BOA-	of Adjustme	nt Case #		Desig DA-	n Altern	ate Case #	1	

	022, 11001
CONC	CONCRETE
COR	CITY OF RALEIGH
СР	COMPUTED POINT
DB	DEED BOOK
DI	DROP INLET
DIP	DUCTILE IRON PIPE
DTL	DETAIL
ECM	EX CONC MONUMENT
EIP	EX IRON PIPE
EIR	EX IRON ROD
ELEC	ELECTRIC
ELEV	ELEVATION
EOP	EDGE OF PAVEMENT
ESMT	EASEMENT
EX	EXISTING
FDC	FIRE DEPARTMENT CONNECTION
	FEDERAL EMERGENCY
FEMA	MANAGEMENT AGENCY
FH	FIRE HYDRANT
FM	FORCE MAIN
FP	FLOODPLAIN
GIS	GEOGRAPHIC INFORMATION
	SYSTEM
GM	GAS METER
GP	GALVANIZED PIPE
GW	GUY ANCHOR
HB	HOT BOX
HDPE	HIGH DENSITY POLYETHYLENE
IPS	IRON PIPE SET
LF	LINEAR FEET
LP	LIGHT POLE
LOC	LOCATION
MAGS	MAG NAIL SET
МН	MANHOLE
N/F	NOW OR FORMERLY
NCDOT	NORTH CAROLINA DEPARTMENT OF TRANSPORTATION
PG	PAGE
_	
PP	POWER POLE
PROP	
PVC	
RCP	REINFORCED CONC PIPE
ROW	RIGHT-OF-WAY
R/W	
RSDM	RALEIGH STREET DESIGN MANUAL
SF	SQUARE FEET
SS	SANITARY SEWER
STBK	SETBACK
STD	STANDARD
SWM	STORMWATER MANAGEMENT
TBD	TO BE DETERMINED
TBR	TO BE REMOVED
TBRL	
TF	ELECTRIC TRANSFORMER
TP	TELEPHONE PEDESTAL
TYP	TYPICAL
UNK	UNKNOWN
wv	WATER VALVE
WLE	WATER LINE ESMT

WATER METER

YARD INLE

WM

YI

Date:

APPROX

B-B

BM

СВ

CIP

CL

со

APPROXIMATE

BACK-TO-BACK

BOOK OF MAPS

CATCH BASIN

CAST IRON PIPE

CENTERLINE

CLEANOUT

Printed Name

OCTOBER 2024


SITE DATA					
SITE ADDRESS:	201 ELLWOOD DRIVE; RAL	EIGH, NC 27609			
WAKE COUNTY PIN#:	1706429610				
ZONING:	R-4				
OVERLAY DISTRICT:	N/A				
EXISTING AREA:	23,622 SF (0.54 AC)	23,622 SF (0.54 AC)			
AREA TO BE DEDICATED:	296 SF (0.007 AC)				
NET SITE AREA: 23,326 SF (0.54 AC)					
EXISTING USE:	SINGLE FAMILY HOME				
PROPOSED USE: DETACHED, ATTACHED, TINY HOUSE, OR TOWNHOUSE					
	REQUIRED	PROVIDED			
VEHICLE PARKING:	NO MAXIMUM	N/A			
BICYCLE PARKING:	0	0			

sewer, and/or reuse, as approved in these plans, is responsible for contacting the PUBLIC WORKS DEPARTMENT at (919) 996-2409. and the PUBLIC UTILITIES DEPARTMENT at (919)996-4540 at least twenty four hours prior to beginning any of their construction. FAILURE to notify both City Departments in advance of beginning construction, will result in the issuance of monetary fines, and require reinstallation of any water or sewer facilities not inspected as a result of this notification failure. FAILURE to call for Inspection, Install a Downstream Plug, have Permitted Plans on the jobsite, or any other Violation of CITY OF RALEIGH STANDARDS will result in a Fine and Possible Exclusion from future work in the CITY OF RALEIGH.

DEVELOPERS HAVE REVIEWED AND ARE IN COMPLIANCE WITH THE REQUIREMENTS SET FORTH IN THE SOLID WASTE DESIGN MANUAL

8.3.5.D.5.A.

SHEET INDEX					
CE-0	COVER SHEET				
CE-1	EXISTING CONDITIONS PLAN				
CE-2	DEMOLITION PLAN				
CE-3	SUBDIVISION/LANDSCAPE PLAN				
CE-4	UTILITY PLAN				
CE-5	GRADING / STORMWATER PLAN				
CE-6	FIRE DEPARTMENT PLAN				

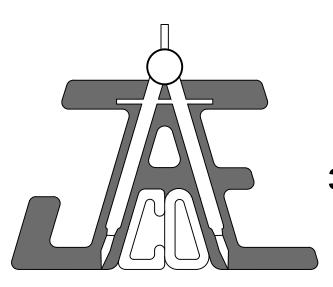

OWNER/DEVELOPER:

LINK TINK, LLC

KAREN LEWIS 2019 FAIRVIEW ROAD Raleigh, N.C. 27608 919-604-4000 k158@icloud.com.com

CIVIL ENGINEER:

JAECO

Consulting Engineers NC License F-0289 333 Wade Ave., Raleigh, N.C. 27605 Phone: (919) 828-4428 Fax: (919) 828-4711 E-mail: info@jaeco.com

ATTENTION CONTRACTORS:

The Construction Contractor responsible for the extension of water,

SOLID WASTE INSPECTIONS STATEMENT

PROPOSED RECYCLING & SOLID WASTE CONTAINERS TO BE STORED AT THE DWELLINGS AND COLLECTED ALONG ELLWOOD DRIVE AND TERRY STREET BY CITY OF RALEIGH. OWNERS WILL BE RESPONSIBLE FOR LABELING THEIR ASSIGNED CONTAINERS.

SITE WILL BE EXEMPT FROM BLOCK PERIMETER REQUIREMENTS PER UDO 8.3.2.2.b. MINIMUM SITE AREA.

SITE WILL BE EXEMPT FROM CROSS ACCESS REQUIREMENTS PER UDO

HORIZONTAL DATUM: NAD83 VERTICAL DATUM: NAVD88

ALL CONSTRUCTION SHALL BE IN

ACCORDANCE WITH CITY OF RALEIGH STANDARDS AND SPECIFICATIONS.

FREQUENT TRANSIT D	EVELOPMENT (UDO 2.7)	
REQUIRED/ALLOWED	PROVIDED/PROPOSED	

ALLOWS FOR ADDITIONAL HOUSING IN LOCATIONS NEAR CURRENT AND PLANNED FREQUENT TRANSIT SERVICE. A FREQUENT TRANSIT AREA REFERS TO AREAS SLATED FOR A BUS OR OTHER TRANSIT SERVICE TRANSIT OR WITHIN A QUARTER-MILE OF OTHER WHERE THE TIME BETWEEN VEHICLES WILL BE 15 MINUTES OR LESS DURING PEAK SERVICE PERIODS AND MUST BE MAPPED IN THE CITY'S COMPREHENSIVE PLAN AS SUCH. WHERE A REGULATION IN THIS SECTION WHOLLY LOCATED WITHIN A QUARTER-MILE OF THE CONFLICTS WITH A REGULATION OF A NEIGHBORHOOD FREQUENT TRANSIT ROUTE RUNNING IN POOLE ROAD CONSERVATION OVERLAY DISTRICT (NCOD). THE NCOD 🛛 AND MARTIN LUTHER KING JR BLVD, AS EVIDENCE BY **REGULATION SHALL CONTROL.**

TRANSIT AREAS" ARE DEFINED AS "AREAS WITHIN A HALF MILE OF CORRIDORS PROPOSED FOR BUS RAPID FREQUENT TRANSIT ROUTES. DEFINED AS TRANSI WITH SCHEDULE WAITS OF 15 MINUTES OR LESS DURING PEAK HOURS" THE SUBJECT PROPERTY IS COMPREHENSIVE MAP UD-1:URBAN FORM, ASN AS SUCH IS ELIGIBLE FOR THE FREQUENT TRANSIT DEVELOPMENT OPTION.

PER THE CITY OF RALEIGH 2030 COMPREHENSIVE PLAN

UPDATE (OCTOBER 2023) SECTION 11 "EREQUENT

WHERE IN CONFLICT, THE KING CHARLES NCOD REGULATION CONTROL FOR THE SUBJECT

DEVELOPMENT REQUIRED/ALLOWED PROVIDED/PROPOSED

		FROVIDED/FROFOSED		
A. Building Types				
A1 Applicable Building Types	Tiny House, Detached House, Attached House, Townhouse, Apartment	Tiny House, Detached House Attached House, Townhouse		
B. Lot Dimensions		1		
B1 Area(min)	6,500 SF	9,334 SF		
B2 Width (min)	65'	65'		
B3 Depth(min)	100'	100'		
B4 Density(max)	N/A	-		
B5 Outdoor Amenity Area(min) for Townhouse (3+ units) and Apartment	10%	10%		
C. Lot Area Required per Unit ¹	1	I		
C1 Single-unit living(min)	6,500 SF	9,334 SF		
C2 Two-unit living(min)	2,500 SF	4,667 SF		
C3 Multi-unit living(min)	2,000 SF	N/A		
D. Principal Building Setbacks				
D1 From primary street (min)	10'	55.9' FROM CL (INFILL)		
D2 From side street (min)	10'	10'		
D3 From side lot line (min) ²	5'	5'		
D4 From rear lot line (min) ³	25'	25'		
D5 From alley (min) ⁴	4' or 20'	N/A		
D6 Residential infill rules may apply (see Sec. 2.2.7.) ⁵	yes	yes		
E. Height				
E1 Detached/Attached Principal Building(max)	40'/3 stories	-		
E2 Townhouse/Apartment Principal Building(max)	45'/3 stories	45'/3 stories		
E3 Tiny House(max)	26'/2 stories	-		
E4 Accessory structure(max)	26'	-		
E5 Residential Infill rules may apply (see Sec.2.2.7)	No	N/A		
F. Parking Setbacks ⁶				
F1 From Primary Street(min)	10'	N/A		
F2 From Side Street(min)	10'	N/A		
F3 From Side Lot Line(min)	0'	N/A		
F4 From Rear Lot Line(min)	3'	N/A		
F5 From Alley(min)	4' or 20' min	N/A		
F6 Residential Infill rules may apply (see Sec.2.2.7)	No	N/A		
G. Additional Requirements				
G1 ADU Regulations G1 ADU Regulations G1 ADU Regulations There shall be no more than one ADU on the same lot as principal building unless it is located in a frequent transit a only one ADU can be attached or internal to the principal building. In the case of a townhome development only one ADU is permitted per principle dwelling. See Sec.2.6.3 for additional regulations				
G2	This development option canno Compact or Conservation Deve			
G3	Lots utilizing this option shall have at least a portion of each lot within the mapped Frequent Transit Area in 20 order to take advantage of any regulations listed herein.			
G4 ⁷	A development site utilizing this option in a residential zoning district shall contain no more than twelve (12) residential units; however, a development site may contain additional residential units provided a number of units equal to at least twenty percent (20%) of the residential units over twelve (12) established within the development site shall be affordable for households earning sixty percent (60%) of the Area Median Income or less for a period of no less than 30 years from the date of issuance of a certificate of occupancy.			

See Sec. 1.5.4.D "Building Setbacks" for specific building elements requirements. ¹For Townhouse buildings, this standard shall apply to site area and not lot area.

²For Townhouse buildings, C3 shall only apply to the side site boundary. ³For Townhouse buildings, C4 shall only apply to the rear site boundary. A permanently recorded open lot or common area lot of

at least 20 feet in width may be used to satisfy Sec.2.5.1.C.4. ⁴Garages (or a portion thereof) must either be located 4 feet from the travel lane of an alley or rear access drive or be a minimum of 20 feet from the alley or rear access drive. Where parking spaces are located between the garage and the alley or rear access drive, the garage must be located at least 20 feet from the travel lane of an alley or rear access drive.

⁵The property owner may elect to either adhere to the primary street setback range set forth in Section 2.2.7 if applicable, or follow only the applicable zoning district's minimum primary streetsetback regulation ⁶Parking setbacks shall not apply to driveways serving individual dwelling units or shared between two dwelling units.

⁷The rent and income limits will follow the Affordable Housing Standards determined annually by the City of Raleigh Housing & Neighborhoods Department. An Affordable Housing Deed Restriction in a form approved by the City shall be filed and recorded in the property's chain of title by the property owner in the Wake County Register of Deeds prior to the project receiving a certificate of occupancy. The property owner of development approved under this section shall provide an annual report to the City to demonstrate compliance with the requirements of this section. The report shall utilize a form prescribed by the City and shall be submitted in accordance with a schedule set by the City. Affordable units used to meet the requirements of this section shall be constructed concurrently with the project's market rate units.

<u>SITE DATA</u> LOT 9

OWNER	LINK TINK LLC
SITE ADDRESS	201 ELLWOOD DRIVE RALEIGH, NC 27609
PIN	1706429610
REFERENCES:	DB 19261, PG 2608 BM 1963, PG 223
AREA	23,622 S.F. (0.5423 AC.)


ZONING

NOTES:

1. ALL DISTANCES ARE HORIZONTAL GROUND.

R-4

- 2. ALL DIMENSIONS ARE IN FEET.
- 3. AREA COMPUTED USING COORDINATE METHOD FROM MEASURED FIELD DATA.
- 4. BASIS OF BEARINGS IS NORTH CAROLINA GRID NORTH, NAD83(2011). THE SITE WAS LOCALIZED UTILIZING REAL-TIME KINEMATIC (RTK) GLOBAL POSITIONING SYSTEM (GPS) SOLUTIONS REFERENCING THE CONTINUOUSLY OPERATING REFERENCE STATION (CORS) NETWORK BASE STATION NCRD, RALEIGH, NC.
- 5. THIS SURVEY WAS PREPARED WITHOUT THE BENEFIT OF A TITLE REPORT AND MAY BE SUBJECT TO ANY MATTERS THAT A FULL TITLE SEARCH WOULD DISCLOSE.
- 6. ALL REFERENCE ARE MADE TO THE WAKE COUNTY REGISTRY.
- 7. HORIZONTAL DATUM IS NAD 83(2011) AND VERTICAL DATUM IS NAVD 88

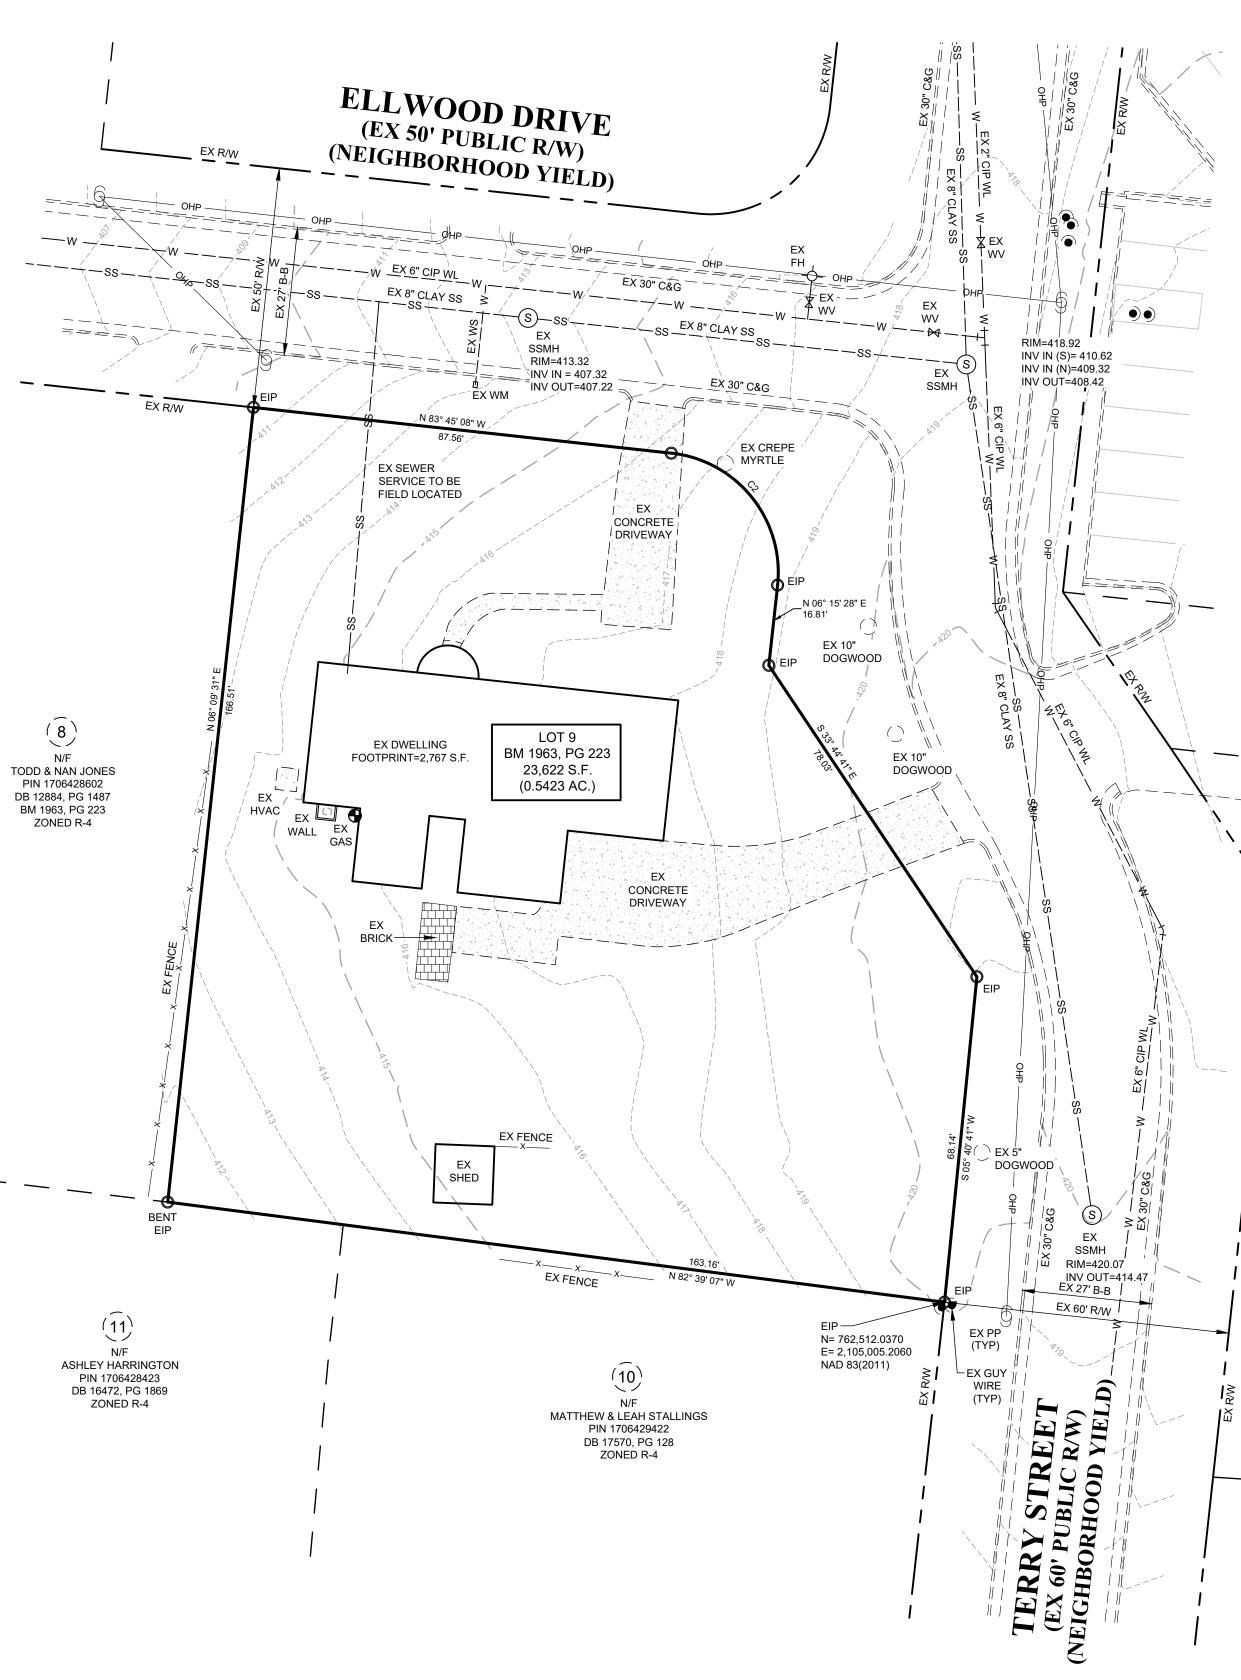


CURVE TABLE						
CURVE LENGTH RADIUS CHORD CHORD BEARING						
C2	39.19'	25.00'	35.30'	N38° 50' 54"W		

EXISTING IMPERVIOUS AREA

EXISTING ON-SITE	5,227 S.F 0.12 AC.
EXISTING OFF-SITE	
TOTAL	5,598 S.F 0.13 AC.

	JOHN A. EDWARDS & COMPANY JOHN A. EDWARDS & COMPANY Gonsulting Engineers and Land Surveyors NC License F-0289 333 Wade Ave., Raleigh, N.C. 27605 Phone: (919) 828-4428 Fax: (919) 828-4428 Fax: (919) 828-4711 E-mail: info@jaeco.com
	Project THE ELLWOOD AT NORTH HILLS 201 ELLWOOD DRIVE RALEIGH, NC 27609
	^{Client} LINK TINK, LLC 2019 FAIRVIEW ROAD RALEIGH, NC 27608
	LEGEND AC ACREAGE BO BLOWOFF BO CORRUGATED METAL PIPE CO SEWER CLEANOUT CONC. CONCRETE RCP BO DUCTULE IRON DUCTULE IRON RPDA DO DORON PLATE PEP EXISTING IRON PIPE ELEVATION SS CONSCIENCIENTING IRON PIPE SS ELEVATION SS CONCRETE SS ELEVATION SS EDC FIRE DEPARTMENT TC CONCRETE SS ME EX. FLARED PLOOR TRE CONSERVATION AREA CONCRETE ME EX. STORM GATCHA BASIN ME EX. STORM CATCH BASIN TC ME EX. STORM CATCH BASIN TC EX. STORM CATCH BASIN TYP EX. STORM CATCH BASIN NEW STER SCIONLA EX. STORM CATCH BASIN NEW STER SCIONLA </th
	EXISTING CONDITIONS PLAN Revisions Number Description Date
GRAPHIC SCALE	
20 0 10 20 40 80 (IN FEET) 1 inch = 20 ft.	Drawing Scale 1" = 20' Drawn By ZCS / BF CE-1 Checked By JRC of Date Issued X/X/XX of

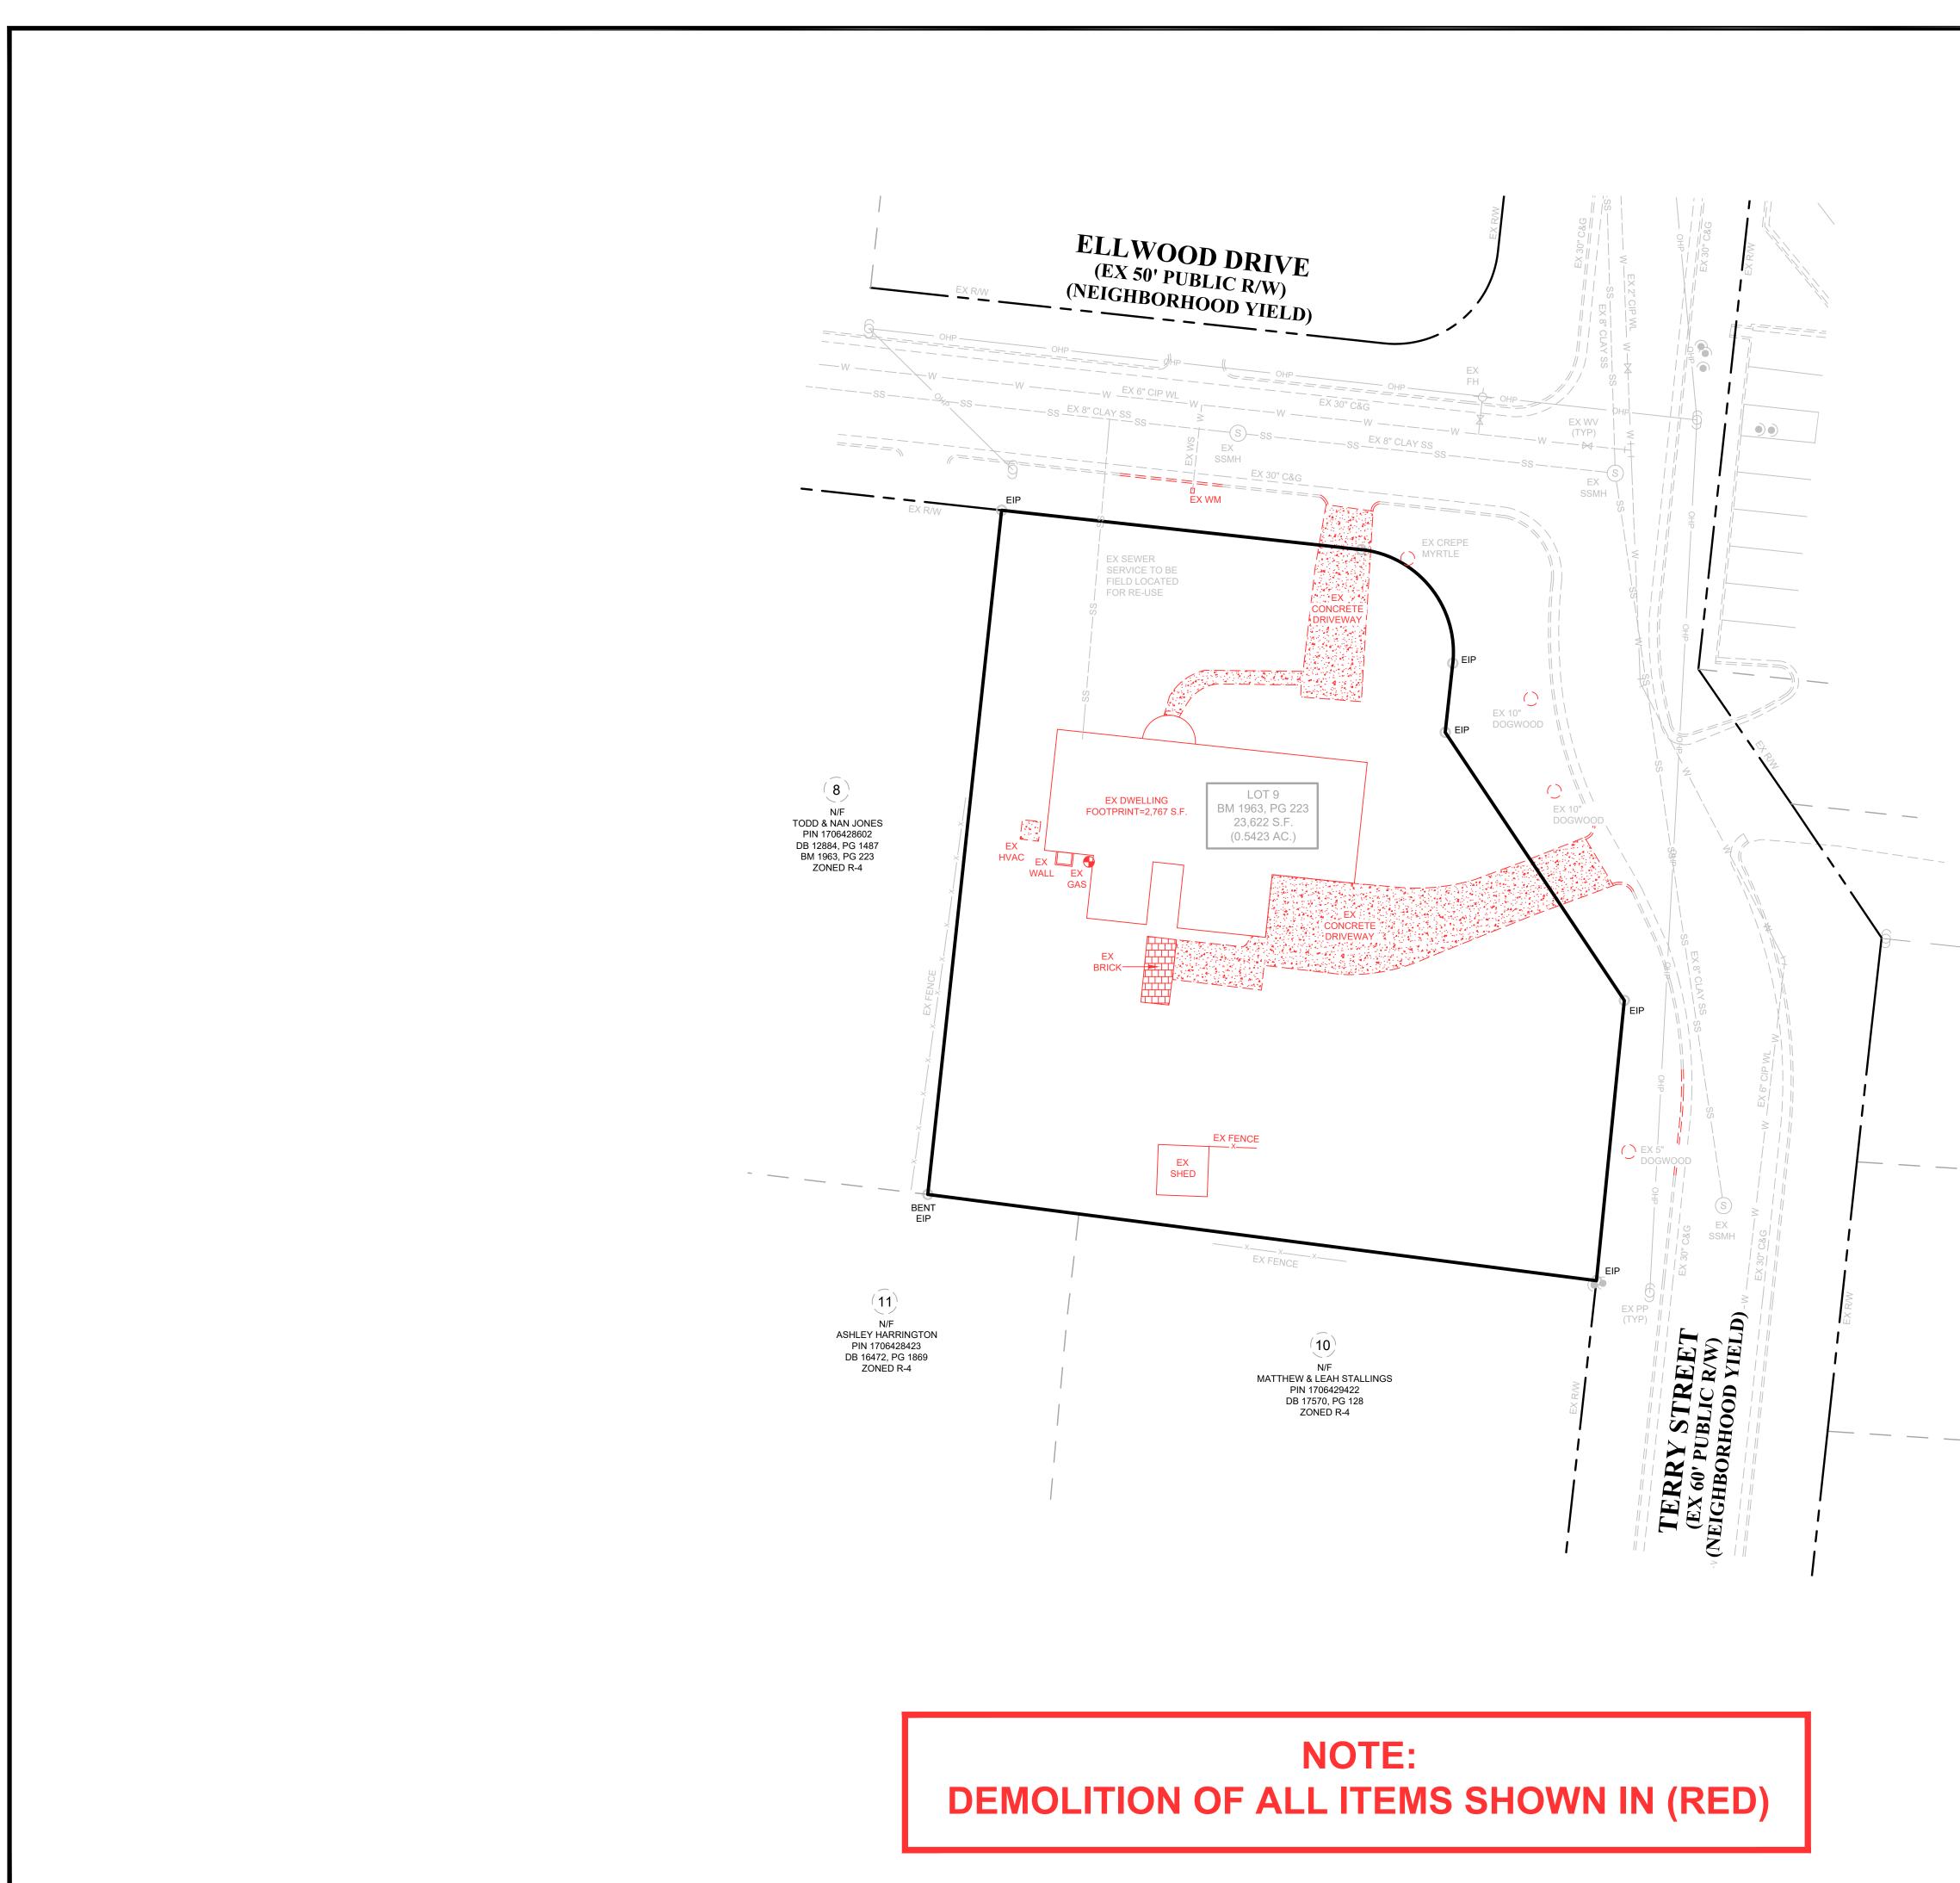

INC GRU		Internet of the second state of the second sta
		LINK TINK, LLC 2019 FAIRVIEW ROAD RALEIGH, NC 27608
		LEGEND AC. ACREAGE BM BOOK OF MAPS BO BLOWOFF BW BOTTOM OF WALL BW BOTTOM OF WALL CAG CURB AND GUTTER BW DOTTOM OF WALL CAG CURB AND GUTTER CMP CORCURATED METAL PIPE PE CONC. CORCURATED METAL PIPE CORCURATED METAL PIPE CORCURATED METAL PIPE CONCC. CONCRETE CONC. CONCORCETE DI DUCTILE IRON DI DUCTILE IRON RPD REDUCED PRESSURE ZONE DI DROP INLET RWW RIGHT-OF-WAY ELEV. ELEVATION SP SPACES CONCECTION SP FES FLARED END SECTION FE FIRE HYDRANT FL FIRE HYDRANT
The sev <u>con</u> and	TTENTION CONTRACTORS: Construction Contractor responsible for the extension of water, ver, and/or reuse, as approved in these plans, is responsible for tacting the PUBLIC WORKS DEPARTMENT at (919) 996-2409. The PUBLIC UTILITIES DEPARTMENT at (919)996-4540 at least nty four hours prior to beginning any of their construction.	W EASEMENT LINE W EXISTING WATER LINE EXISTING SANITARY SEWER EXISTING STORM DRAINAGE W NEW SANITARY SEWER NEW SANITARY SEWER NEW STORM DRAINAGE 270 EXISTING CONTOUR LINE 270 NEW CONTOUR LINE 0HP EXISTING OVERHEAD POWER SWALE SWALE
FA con reir of t FA Per RA	LURE to notify both City Departments in advance of beginning struction, will result in the issuance of monetary fines, and require stallation of any water or sewer facilities not inspected as a result his notification failure. LURE to call for Inspection, Install a Downstream Plug, have mitted Plans on the jobsite, or any other Violation of CITY OF LEIGH STANDARDS will result in a <u>Fine and Possible Exclusion</u> from re work in the CITY OF RALEIGH.	DEMOLITION PLAN Revisions Number Description Date
	GRAPHIC SCALE 10 20 40 80 (IN FEET) 1 inch = 20 ft.	Drawing Scale 1" = 20' Drawn By BF Checked By JRC Date Issued X/X/XX

GENERAL NOTES


- 1. CONTRACTOR TO FIELD VERIFY LOCATION & ELEVATION OF ALL EXISTING UTILITIES PRIOR TO CONSTRUCTION. EXISTING UTILITIES SHOWN HEREON WERE OBTAINED VIA 811 ("MISS UTILITY") MARKOUT. EXISTING UTILITIES SHOULD BE ASSUMED TO BE APPROXIMATE AND POTENTIALLY INCOMPLETE.
- 2. UTILITY CONSTRUCTION SHALL BE IN ACCORDANCE WITH CITY OF RALEIGH AND / OR NCDOT STANDARDS AND SPECIFICATIONS UNLESS OTHERWISE NOTED.
- 3. FIRE HYDRANTS SHALL BE EQUIPPED WITH NST THREADS AND WITH A 5 INCH STORZ CONNECTION.
- 4. UNLESS OTHERWISE NOTED, ACCESS ROUTE FOR EMERGENCY VEHICLES SHALL PROVIDE AN INSIDE TURNING RADIUS OF 28' MINIMUM
- 5. CITY OF RALEIGH RECORDS INDICATE EXISTING WATER & SEWER SERVICE TO EXISTING HOUSE. EX SERVICE CONNECTIONS SHALL BE REMOVED IN ACCORDANCE WITH RALEIGH PUBLIC UTILITIES HANDBOOK SEWER CONSTRUCTION STANDARD #31 AND WATER CONSTRUCTION STANDARD #31. FIELD LOCATED SERVICES TO BE PROVIDED DURING SPR REVIEW.
- 6. EXISTING WATER AND SEWER SIZES AND MATERIALS PER SCOPE-0130-2022

CONSTRUCTION NOTES:

- 1. ALL CONSTRUCTION SHALL BE IN ACCORDANCE WITH CITY OF RALEIGH AND/OR NCDOT STANDARDS.
- 2. THE CONTRACTOR SHALL CONDUCT THE WORK IN A SAFE MANNER AND WITH A MINIMUM AMOUNT OF INCONVENIENCE TO TRAFFIC.
- 3. THE CONTRACTOR SHALL BE RESPONSIBLE FOR ALL TRAFFIC CONTROL AND SHALL ADHERE TO THE PROVISIONS OF THE MUTCD (MOST CURRENT EDITION).
- 4. PRIOR TO START OF WORK, A PRE-CONSTRUCTION MEETING MUST BE SET UP WITH THE CONTRACTOR AND CITY OF RALEIGH TRANSPORTATION FIELD SERVICES STAFF. CONTACT ENGINEERING INSPECTIONS AT (919) 996-2409 TO SET UP THE MEETING.
- 5. THE CONTRACTOR SHALL OBTAIN A RIGHT-OF-WAY OBSTRUCTION PERMIT FOR ANY WORK WHICH REQUIRES THE TEMPORARY CLOSURE OF A STREET, TRAVEL LANE, PARKING SPACE OR SIDEWALK FROM RIGHT-OF-WAY SERVICES AT LEAST 48 HOURS IN ADVANCE. ANY TEMPORARY STREET CLOSURE MUST BE SUBMITTED 2 WEEKS PRIOR. SEE "RIGHT-OF-WAY CLOSURES" ON WWW.RALEIGHNC.GOV AND SEND THE RIGHT-OF WAY OBSTRUCTION PERMIT TO RIGHTOFWAYSERVICES@RALEIGHNC.GOV.
- 6. PRIOR TO CONSTRUCTION BEGINNING, ALL SIGNAGE AND TRAFFIC CONTROL SHALL BE IN PLACE.
- 7. THE CONTRACTOR SHALL REPAIR ANY DAMAGED INFRASTRUCTURE IN THE RIGHT-OF-WAY AND RESTORE IT TO PREVIOUS OR BETTER CONDITION.
- 8. THE CONTRACTOR SHALL REPAIR ANY DAMAGES TO ADJACENT PROPERTIES AND RESTORE IT TO PREVIOUS OR BETTER CONDITION.

TPP-03

9. ALL SIDEWALKS MUST BE ACCESSIBLE TO PERSONS WHO ARE VISUALLY IMPAIRED AND PEOPLE WITH MOBILITY DISABILITIES. PEDESTRIAN EXISTING ROUTES AND ALTERNATE PEDESTRIAN ROUTES DURING CONSTRUCTION WILL BE REQUIRED TO BE COMPLIANT WITH THE PUBLIC RIGHTS OF WAY ACCESSIBILITY GUIDELINES (PROWAG), 2010 ADA STANDARDS FOR ACCESSIBLE DESIGN AND THE MANUAL ON UNIFORM TRAFFIC CONTROL DEVICES (MUTCD).

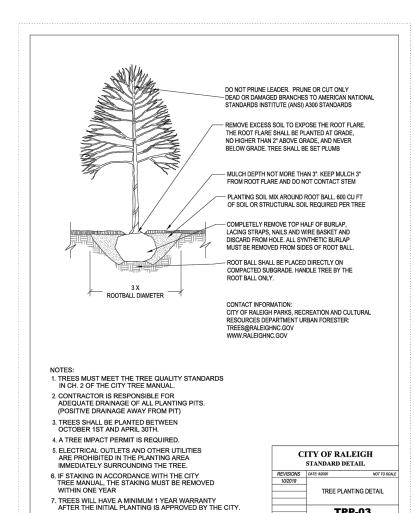

PROPOSED STREET TREE CALCULATION	

ELLWOOD DRIVE ELIGIBLE FRONTAGE = 111'

REQUIRED TREES = 111 LF / 40' OC = 3 SHADE TREES REQUIRED PROVIDED SHADE TREES = 3


TERRY STREET POWER LINE OVERHEAD ELIGIBLE FRONTAGE = 77' REQUIRED TREES = 77 LF / 20' OC = 4 UNDERSTORY TREES REQUIRED NO POWER LINE OVERHEAD ELIGIBLE FRONTAGE = 103'

REQUIRED TREES = 103 LF / 40' OC = 3 SHADE TREES REQUIRED PROVIDED TREES = 4 UNDERSTORY AND 3 SHADE TREES

PLANT LIST


KEY	QUAN.	BOTANICAL NAME	COMMON NAME	CAL.	HT.	MATURE HT.	MATURE SP.
TREE	ES						
QI	6	Quercus lyrata	Highbeam Overcup Oak	3"	10'	40-50'	35-40'
Нс	4	Halesia Carolina	Carolina Silverbell	1.5"	6'	20-25'	15-20'

ALL STREET TREES ARE TO BE PLANTED IN ACCORDANCE WITH CITY OF RALEIGH STANDARD DETAIL, TPP-03.

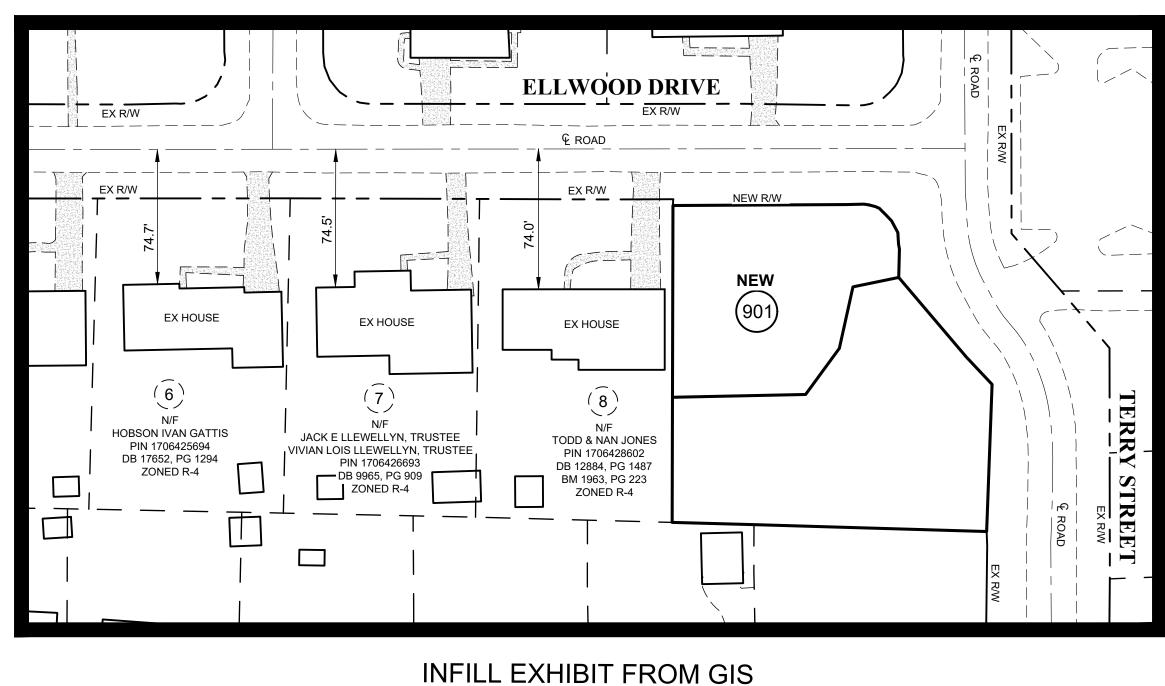

SCALE: 1" = 50'

MEDIAN SETBACK FROM COMPARATIVE SAMPLE IS 74.5' FROM EXISTING CL PER 2.2.7.C.3. SINXCE SUBJECT PROPERTY R/W IS DIFFERENT FROM THE COMPARATIVE SAMPLE. PER 2.2.7.C.1.b. THE SETBACK MAY BE WITHIN 25% OF THE MEDIAN FOR LOTS WIDER THAN 80'. MIN SETBACK FROM CL ON NEW LOT 901 IS 55.9' AND MAX IS 93.1' FINAL INFILL SETBACK TO BE MEASURED AT TIME OF BUILDING PERMIT.

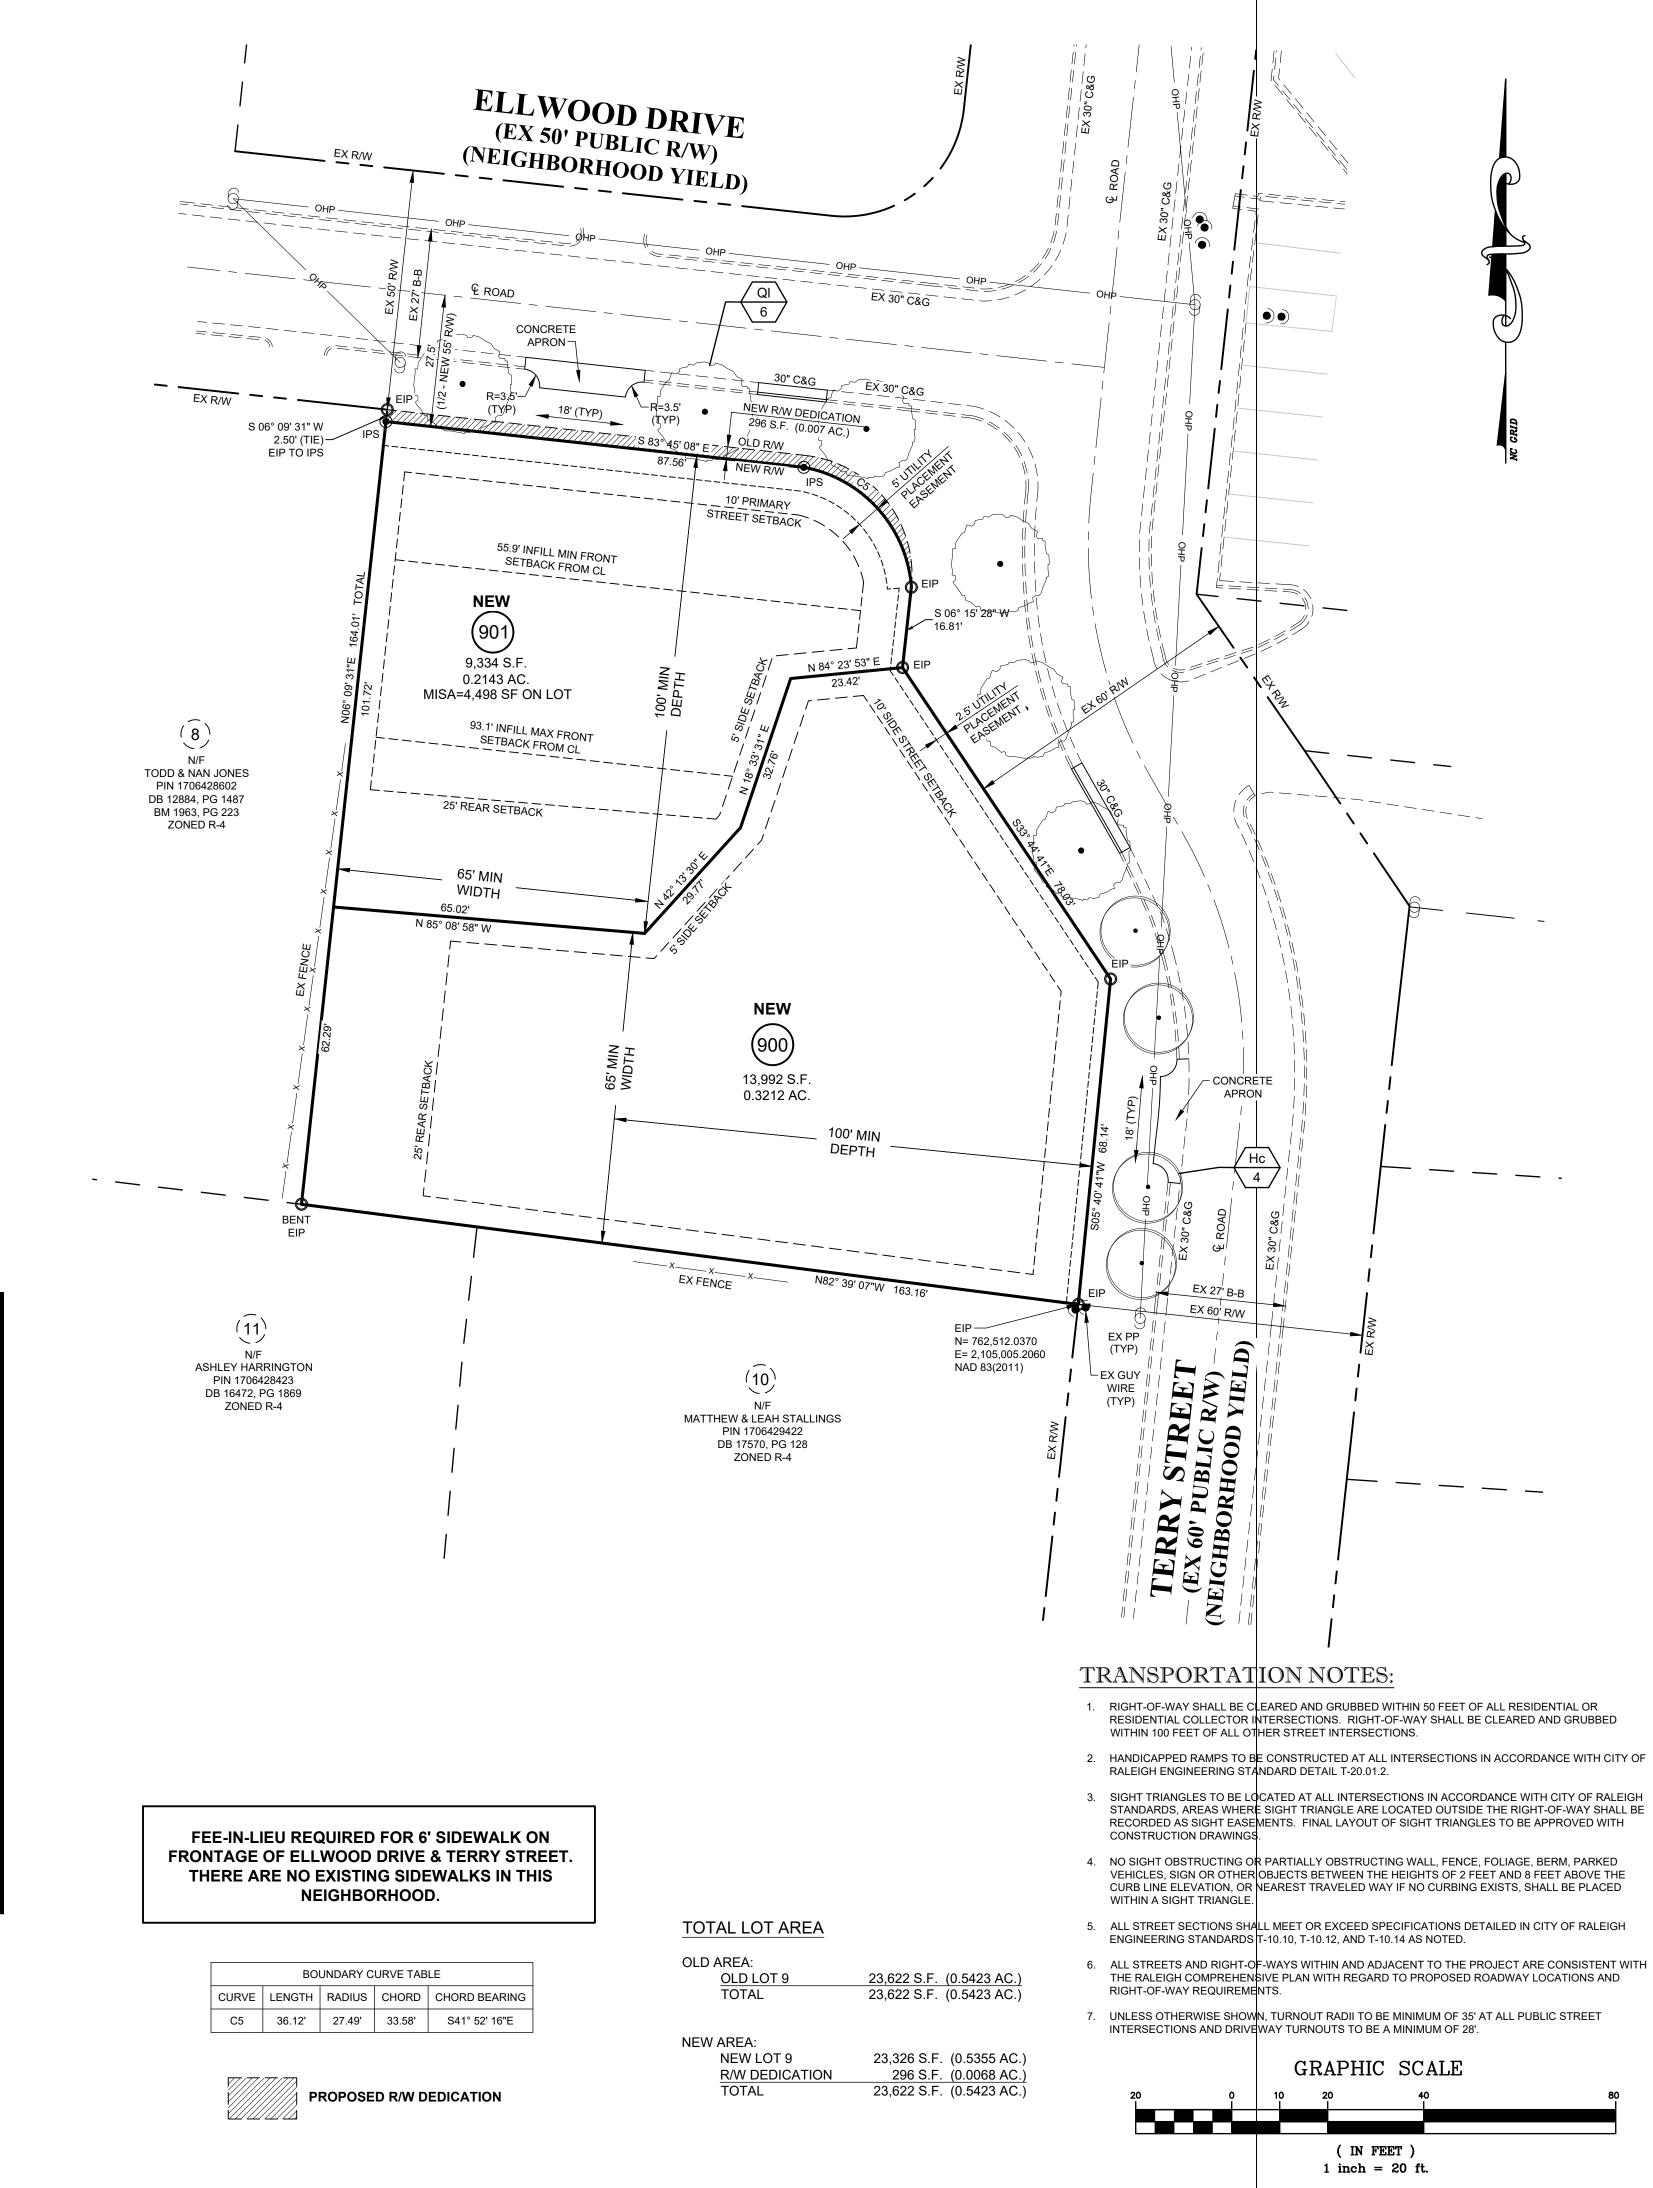

BB 20' BB Single stem

ROOT

- 2. HANDICAPPED RAMPS TO BE CONSTRUCTED AT ALL INTERSECTIONS IN ACCORDANCE WITH CITY OF
- 3. SIGHT TRIANGLES TO BE LOCATED AT ALL INTERSECTIONS IN ACCORDANCE WITH CITY OF RALEIGH STANDARDS, AREAS WHERE SIGHT TRIANGLE ARE LOCATED OUTSIDE THE RIGHT-OF-WAY SHALL BE RECORDED AS SIGHT EASEMENTS. FINAL LAYOUT OF SIGHT TRIANGLES TO BE APPROVED WITH
- CURB LINE ELEVATION, OR NEAREST TRAVELED WAY IF NO CURBING EXISTS, SHALL BE PLACED
- THE RALEIGH COMPREHENSIVE PLAN WITH REGARD TO PROPOSED ROADWAY LOCATIONS AND

A Consulting Engineers and Land Surveyors NC License F-0289 33 Wade Ave., Raleigh, N.C. 2 Phone: (919) 828-4428 Fax: (919) 828-4428 Eax: (919) 828-4428 Fax: (919) 828-4428 Fax: (919) 828-4428	
Project THE ELLWOC AT NORTH HIL 201 ELLWOOD DRIV RALEIGH, NC 27609	LS E
Client	
LINK TINK, LLC 2019 FAIRVIEW ROAE RALEIGH, NC 27608)
LEGEND AC. ACREAGE BM BOOK OF MAPS BO BLOWOFF BW BOTTOM OF WALL Cag CURB AND GUTTER CMP CORRUGATED METAL PIPE PRIVATE DRAIN CONC. CONCRETE CONC. CONCRETE DED BOOK RPDA DECD BOOK RPDA DECD BOOK RPDA DECD BOOK RPDA DECD FORMERNT SS SOUTHLE IRON RPDA REDUCED PRES DETECTOR ASS DI DROP INLET RW RIGHT-OR-WAY EVENEDE PAREMENT SS SOUARE FEET SS EVENEDE PARTMENT SS FDC FIRE DEPARTMENT FES FLARED END SECTION FEF FINSHED FLOOR FINSHED FLOOR TV FL FIRE LINE MEX MALEYARANT FL FIRE HYDRANT FL FIRE HYDRANT FL FIRE HYDRANT <	AGE EASEMENT ORIDE PIPE ONCRETE PIPE SURE EMBLY SURE ZONE ER (ATION AREA PIPE L E DLE ALVE EDUCER RANT IETER IANHOLE CLEANOUT ATCH BASIN ROP INLET END SECTION INE INE R LINE ARY SEWER M DRAINAGE E SEWER AINAGE OUR LINE L
Drawing Title SITE PLAN	
Revisions	
Number Description	Date
Drawing Scale 1" = 20' Drawn By BF Checked By JRC	E-3

Date Issued X/X/XX

GENERAL NOTES


- 1. CONTRACTOR TO FIELD VERIFY LOCATION & ELEVATION OF ALL EXISTING UTILITIES PRIOR TO CONSTRUCTION. EXISTING UTILITIES SHOWN HEREON WERE OBTAINED VIA 811 ("MISS UTILITY") MARKOUT. EXISTING UTILITIES SHOULD BE ASSUMED TO BE APPROXIMATE AND POTENTIALLY INCOMPLETE.
- 2. UTILITY CONSTRUCTION SHALL BE IN ACCORDANCE WITH CITY OF RALEIGH AND / OR NCDOT STANDARDS AND SPECIFICATIONS UNLESS OTHERWISE NOTED.
- 3. FIRE HYDRANTS SHALL BE EQUIPPED WITH NST THREADS AND WITH A 5 INCH STORZ CONNECTION.
- 4. UNLESS OTHERWISE NOTED, ACCESS ROUTE FOR EMERGENCY VEHICLES SHALL PROVIDE AN INSIDE TURNING RADIUS OF 28' MINIMUM
- 5. CITY OF RALEIGH RECORDS INDICATE EXISTING WATER & SEWER SERVICE TO EXISTING HOUSE. EX SERVICE CONNECTIONS SHALL BE REMOVED IN ACCORDANCE WITH RALEIGH PUBLIC UTILITIES HANDBOOK SEWER CONSTRUCTION STANDARD #31 AND WATER CONSTRUCTION STANDARD #31. FIELD LOCATED SERVICES TO BE PROVIDED DURING SPR REVIEW.
- 6. EXISTING WATER AND SEWER SIZES AND MATERIALS PER SCOPE-0130-2022

CONSTRUCTION NOTES:

- 1. ALL CONSTRUCTION SHALL BE IN ACCORDANCE WITH CITY OF RALEIGH AND/OR NCDOT STANDARDS.
- 2. THE CONTRACTOR SHALL CONDUCT THE WORK IN A SAFE MANNER AND WITH A MINIMUM AMOUNT OF INCONVENIENCE TO TRAFFIC.
- 3. THE CONTRACTOR SHALL BE RESPONSIBLE FOR ALL TRAFFIC CONTROL AND SHALL ADHERE TO THE PROVISIONS OF THE MUTCD (MOST CURRENT EDITION).
- 4. PRIOR TO START OF WORK, A PRE-CONSTRUCTION MEETING MUST BE SET UP WITH THE CONTRACTOR AND CITY OF RALEIGH TRANSPORTATION FIELD SERVICES STAFF. CONTACT ENGINEERING INSPECTIONS AT (919) 996-2409 TO SET UP THE MEETING.
- 5. THE CONTRACTOR SHALL OBTAIN A RIGHT-OF-WAY OBSTRUCTION PERMIT FOR ANY WORK WHICH REQUIRES THE TEMPORARY CLOSURE OF A STREET, TRAVEL LANE, PARKING SPACE OR SIDEWALK FROM RIGHT-OF-WAY SERVICES AT LEAST 48 HOURS IN ADVANCE. ANY TEMPORARY STREET CLOSURE MUST BE SUBMITTED 2 WEEKS PRIOR. SEE "RIGHT-OF-WAY CLOSURES" ON WWW.RALEIGHNC.GOV AND SEND THE RIGHT-OF WAY OBSTRUCTION PERMIT TO RIGHTOFWAYSERVICES@RALEIGHNC.GOV.
- 6. PRIOR TO CONSTRUCTION BEGINNING, ALL SIGNAGE AND TRAFFIC CONTROL SHALL BE IN PLACE.
- 7. THE CONTRACTOR SHALL REPAIR ANY DAMAGED INFRASTRUCTURE IN THE RIGHT-OF-WAY AND RESTORE IT TO PREVIOUS OR BETTER CONDITION.
- 8. THE CONTRACTOR SHALL REPAIR ANY DAMAGES TO ADJACENT PROPERTIES AND RESTORE IT TO PREVIOUS OR BETTER CONDITION.

TPP-03

9. ALL SIDEWALKS MUST BE ACCESSIBLE TO PERSONS WHO ARE VISUALLY IMPAIRED AND PEOPLE WITH MOBILITY DISABILITIES. PEDESTRIAN EXISTING ROUTES AND ALTERNATE PEDESTRIAN ROUTES DURING CONSTRUCTION WILL BE REQUIRED TO BE COMPLIANT WITH THE PUBLIC RIGHTS OF WAY ACCESSIBILITY GUIDELINES (PROWAG), 2010 ADA STANDARDS FOR ACCESSIBLE DESIGN AND THE MANUAL ON UNIFORM TRAFFIC CONTROL DEVICES (MUTCD).

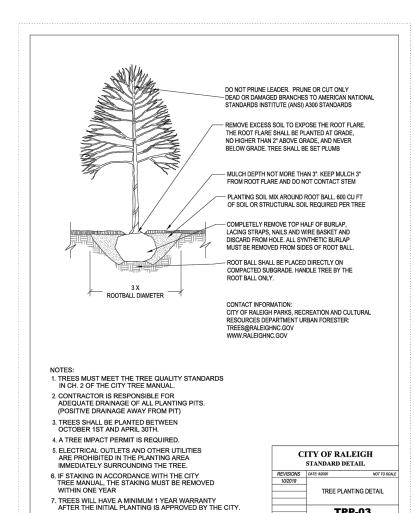

PROPOSED STREET TREE CALCULATION	
	-

ELLWOOD DRIVE ELIGIBLE FRONTAGE = 111'


REQUIRED TREES = 111 LF / 40' OC = 3 SHADE TREES REQUIRED PROVIDED SHADE TREES = 3 TERRY STREET

POWER LINE OVERHEAD ELIGIBLE FRONTAGE = 77' REQUIRED TREES = 77 LF / 20' OC = 4 UNDERSTORY TREES REQUIRED NO POWER LINE OVERHEAD ELIGIBLE FRONTAGE = 103' REQUIRED TREES = 103 LF / 40' OC = 3 SHADE TREES REQUIRED PROVIDED TREES = 4 UNDERSTORY AND 3 SHADE TREES

PLANT LIST


KEY	QUAN.	— BOTANICAL NAME	COMMON NAME	CAL.	нт	MATURE HT.	MATURE SP.
	QUAN.			UAL.			01.
TREE	ES						
QI	6	Quercus lyrata	Highbeam Overcup Oak	3"	10'	40-50'	35-40'
Hc	4	Halesia Carolina	Carolina Silverbell	1.5"	6'	20-25'	15-20'
NOTE: ALL STREET TREES ARE TO BE PLANTED IN ACCORDANCE							

ALL STREET TREES ARE TO BE PLANTED IN ACCORDANCE WITH CITY OF RALEIGH STANDARD DETAIL, TPP-03.

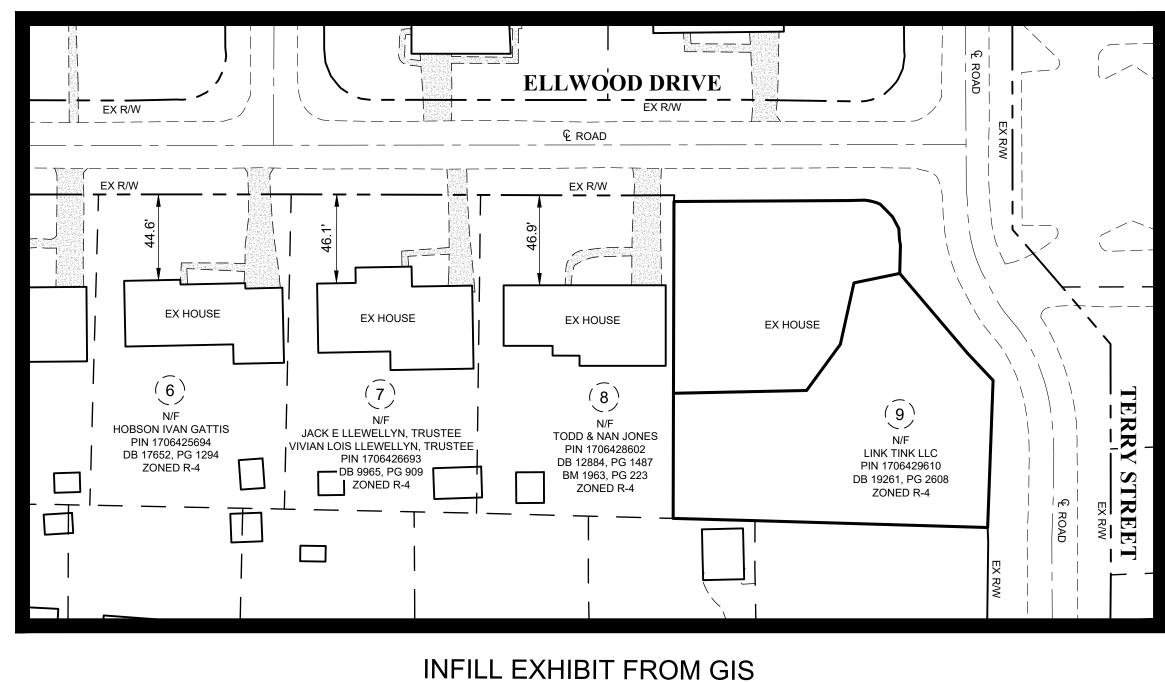

SCALE: 1" = 50'

MEDIAN SETBACK FROM COMPARATIVE SAMPLE IS 46.1' FROM EXISTING R/W. PER 2.2.7.C.1.b. THE SETBACK MAY BE WITHIN 25% OF THE MEDIAN FOR LOTS WIDER THAN 80'. MIN SETBACK FROM NEW R/W IS 32.1' AND MAX IS 55.1'

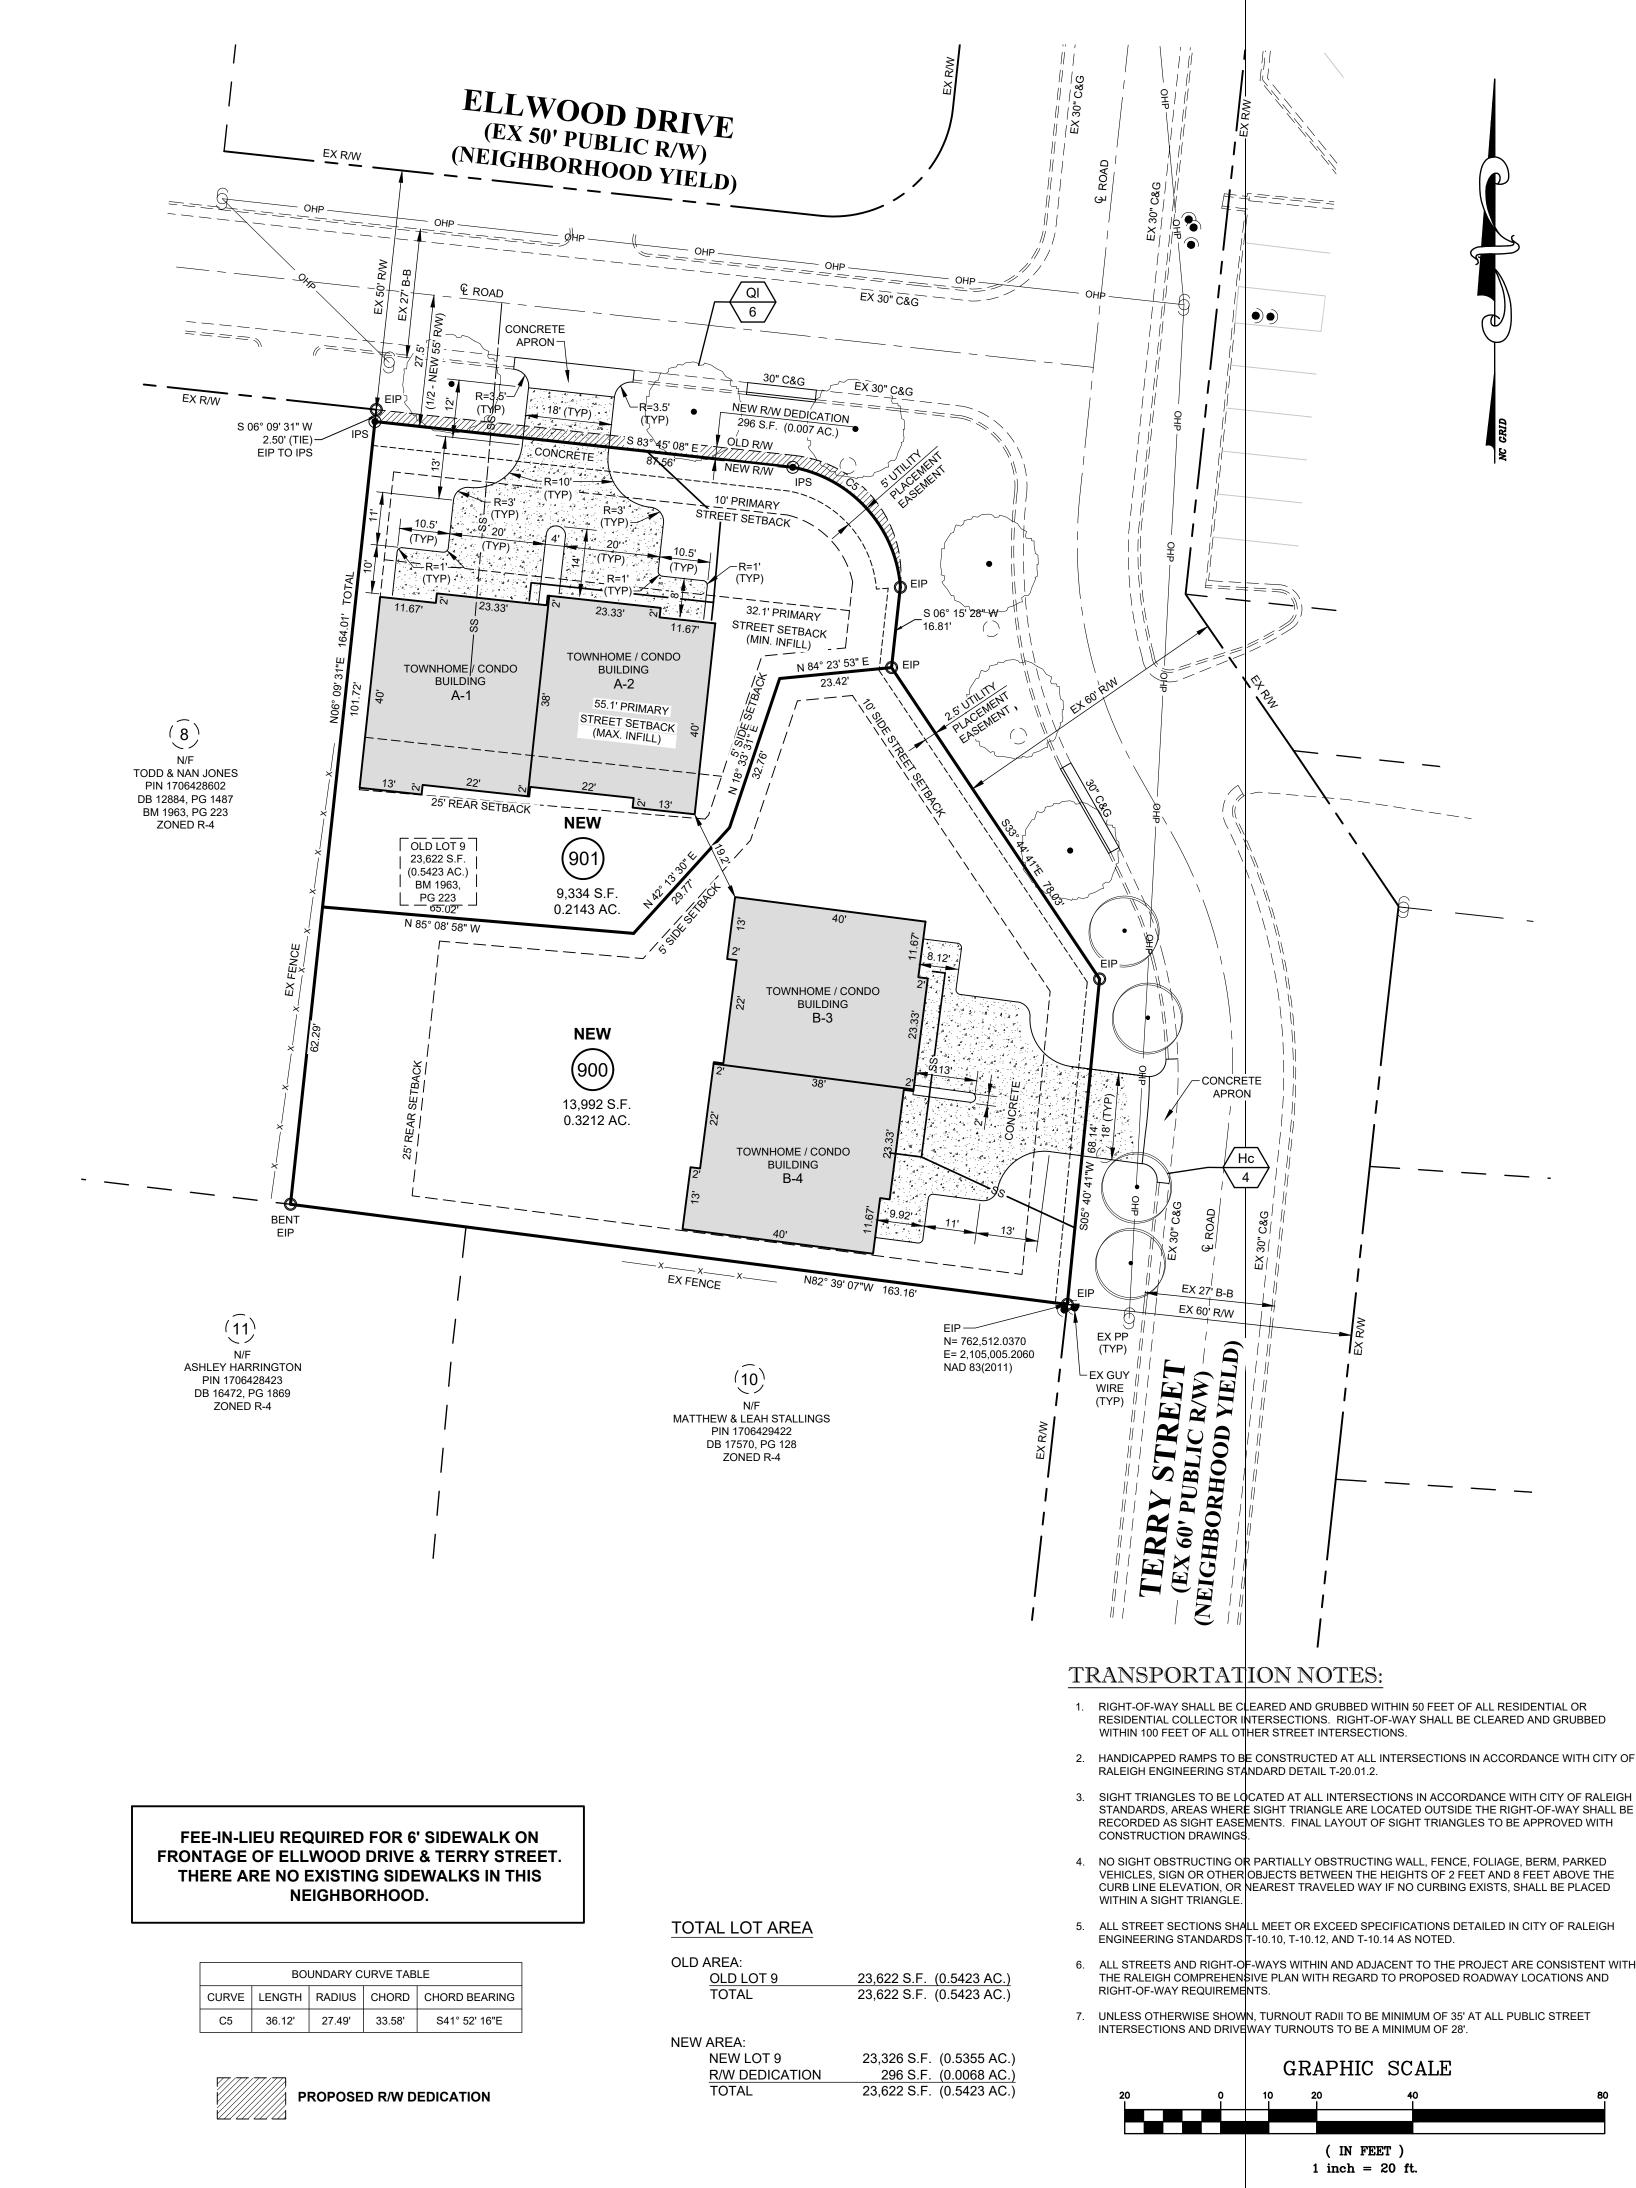

ROOT BB 20' BB Single stem

- 2. HANDICAPPED RAMPS TO BE CONSTRUCTED AT ALL INTERSECTIONS IN ACCORDANCE WITH CITY OF
- STANDARDS, AREAS WHERE SIGHT TRIANGLE ARE LOCATED OUTSIDE THE RIGHT-OF-WAY SHALL BE RECORDED AS SIGHT EASEMENTS. FINAL LAYOUT OF SIGHT TRIANGLES TO BE APPROVED WITH
- CURB LINE ELEVATION, OR NEAREST TRAVELED WAY IF NO CURBING EXISTS, SHALL BE PLACED
- 6. ALL STREETS AND RIGHT-OF-WAYS WITHIN AND ADJACENT TO THE PROJECT ARE CONSISTENT WITH THE RALEIGH COMPREHENSIVE PLAN WITH REGARD TO PROPOSED ROADWAY LOCATIONS AND

_	
JOHN A. EDWARD JOHN A. EDWARD Consulting E and Land Su NC License 333 Wade Ave., Rale Phone: (919) & Fax: (919) & E-mail: info@j	ngineers irveyors F-0289 igh, N.C. 27605 828-4428 28-4711 aeco.com
Seals	
Project THE ELL AT NORTI 201 ELLWOO RALEIGH, N	H HILLS
Client	
LINK TINK 2019 FAIRVIE RALEIGH, NO	W ROAD
✓ EX. WATER VALVE → EX. FIRE HYDRANT □ EX. SEWER MANHOLE ○ EX. SEWER CLEANOUT □ EX. STORM CATCH BASIN □ EX. STORM DROP INLET ↓ EX. FLARED END SECTION ↓ EX. IIGHT POLE ● EX. IRON PIPE □ EX. IRON PIPE □ EX. SSS	NEW SEWER MANHOLE NEW SEWER CLEANOUT NEW STORM CATCH BASIN NEW STORM DROP INLET NEW FLARED END SECTION IRON PIPE SET PROPERTY LINE RIGHT-OF-WAY LINE LOT LINE EASEMENT LINE EXISTING WATER LINE EXISTING SANITARY SEWER EXISTING STORM DRAINAGE NEW WATER LINE NEW SANITARY SEWER NEW SANITARY SEWER NEW STORM DRAINAGE EXISTING CONTOUR LINE NEW CONTOUR LINE EXISTING OVERHEAD POWER
	SWALE
Drawing Title	LAN
Revisions Number Description	Date
Drawing Scale 1" = 20'	
Drawn By BF Checked By JRC	— CE-3

Date Issued X/X/XX

GENERAL NOTES


- 1. CONTRACTOR TO FIELD VERIFY LOCATION & ELEVATION OF ALL EXISTING UTILITIES PRIOR TO CONSTRUCTION. EXISTING UTILITIES SHOWN HEREON WERE OBTAINED VIA 811 ("MISS UTILITY") MARKOUT. EXISTING UTILITIES SHOULD BE ASSUMED TO BE APPROXIMATE AND POTENTIALLY INCOMPLETE.
- 2. UTILITY CONSTRUCTION SHALL BE IN ACCORDANCE WITH CITY OF RALEIGH AND / OR NCDOT STANDARDS AND SPECIFICATIONS UNLESS OTHERWISE NOTED.
- 3. FIRE HYDRANTS SHALL BE EQUIPPED WITH NST THREADS AND WITH A 5 INCH STORZ CONNECTION.
- 4. UNLESS OTHERWISE NOTED, ACCESS ROUTE FOR EMERGENCY VEHICLES SHALL PROVIDE AN INSIDE TURNING RADIUS OF 28' MINIMUM
- 5. CITY OF RALEIGH RECORDS INDICATE EXISTING WATER & SEWER SERVICE TO EXISTING HOUSE. EX SERVICE CONNECTIONS SHALL BE REMOVED IN ACCORDANCE WITH RALEIGH PUBLIC UTILITIES HANDBOOK SEWER CONSTRUCTION STANDARD #31 AND WATER CONSTRUCTION STANDARD #31. FIELD LOCATED SERVICES TO BE PROVIDED DURING SPR REVIEW.
- 6. EXISTING WATER AND SEWER SIZES AND MATERIALS PER SCOPE-0130-2022

STANDARD UTILITY NOTES:

- 1. All materials & construction methods shall be in accordance with City of Raleigh design standards, details & specifications (reference: CORPUD Handbook, current edition). 2. Utility separation requirements:
- a) A distance of 100' shall be maintained between sanitary sewer & any private or public water supply source such as an impounded reservoir used as a source of drinking water. If adequate lateral separation cannot be achieved, ferrous sanitary sewer pipe shall be specified & installed to waterline specifications. However, the minimum separation shall not be less than 25' from a private well or
- 50' from a public well. b) When installing water &/or sewer mains, the horizontal separation between utilities shall be 10'. If this separation cannot be maintained due to existing conditions, the variation allowed is the water main in a separate trench with the elevation of the water main at least 18" above the top of the sewer & must be approved by the Public Utilities Director. All distances are measured from outside diameter to outside diameter.
- c) Where it is impossible to obtain proper separation, or anytime a sanitary sewer passes over a watermain, DIP materials or steel encasement extended 10' on each side of crossing must be specified & installed to waterline specifications. d) 5.0' minimum horizontal separation is required between all sanitary sewer & storm sewer facilities, unless
- DIP material is specified for sanitary sewer. e) Maintain 18" min. vertical separation at all watermain & RCP storm drain crossings; maintain 18" min.
- vertical separation at all sanitary sewer & RCP storm drain crossings. Where adequate separations cannot be achieved, specify DIP materials & a concrete cradle having 6" min. clearance (per CORPUD details W- 41 & S-49). f) All other underground utilities shall cross water & sewer facilities with 18" min. vertical separation required.
- 3. Any necessary field revisions are subject to review & approval of an amended plan &/or profile by the *City of Raleigh Public Utilities Department prior to construction.* 4. Developer shall provide 30 days advance written notice to owner for any work required within an existing
- City of Raleigh Utility Easement traversing private property. 5. Contractor shall maintain continuous water & sewer service to existing residences & businesses throughout construction of project. Any necessary service interruptions shall be preceded by a 24-hour advance notice to
- the City of Raleigh Public Utilities Department. 6. SEWER BYPASS PUMPING – A bypass plan sealed by an NC Professional Engineer shall be provided to Raleigh Water prior to pumping operations for approval. The operations and equipment shall comply with the Public Utilities Handbook.
- 7. 3.0' minimum cover is required on all water mains & sewer force mains. 4.0' minimum cover is required on all reuse mains. 8. It is the developer's responsibility to abandon or remove existing water & sewer services not being used
- in redevelopment of a site unless otherwise directed by the City of Raleigh Public Utilities Department. This includes abandoning tap at main & removal of service from ROW or easement per CORPUD Handbook procedure. 9. Install ¾" copper* water services with meters located at ROW or within a 2'x2' Waterline Easement
- immediately adjacent. NOTE: it is the applicant's responsibility to properly size the water service for each connection to provide adequate flow & pressure. 10. Install 4" PVC* sewer services @ 1.0% minimum grade with cleanouts located at ROW or easement line & spaced every 75 linear feet maximum.
- 11. Pressure reducing valves are required on all water services exceeding 80 psi; backwater valves are required on all sanitary sewer services having building drains lower than 1.0' above the next upstream manhole. 12. All environmental permits applicable to the project must be obtained from NCDWQ, USACE &/or FEMA for
- any riparian buffer, wetland &/or floodplain impacts (respectively) prior to construction. 13. NCDOT / Railroad Encroachment Agreements are required for any utility work (including main extensions & service taps) within state or railroad ROW prior to construction.
- 14. Grease Interceptor / Oil Water Separator sizing calculations & installation specifications shall be approved by the RW FOG Program Coordinator prior to issuance of a UC and/or Building Permit. Contact (919) 996-4516 or fog@raleighnc.gov for more information.
- 15. Cross-connection control protection devices are required based on the degree of health hazard involved as listed in Appendix B of the Rules Governing Public Water Systems in North Carolina. 16. The devices shall meet the American Society of Sanifary Engineering (SAAE) standards and be on the
- University of Southern California approval list. 17. The device and installation shall mee the guidelines of Appendix A – Guidelines and Requirements for the
- Cross Connection Program in Raleigh's Service Area. 18. The devices shall be installed and tested (both, initial and periodic testing thereafter) in accordance with
- the manufacturer's recommendations or the local cross connection control program, whichever is more stringent. Contact Cross.connection@raleighnc.gov for more information. 19. NOTICE for projects that involve an oversized main or urban main replacement. Any City reimbursement
- greater than \$250,000.00 must undergo the public bidding process.

====^

(11)N/F ASHLEY HARRINGTON PIN 1706428423 DB 16472, PG 1869 ZONED R-4

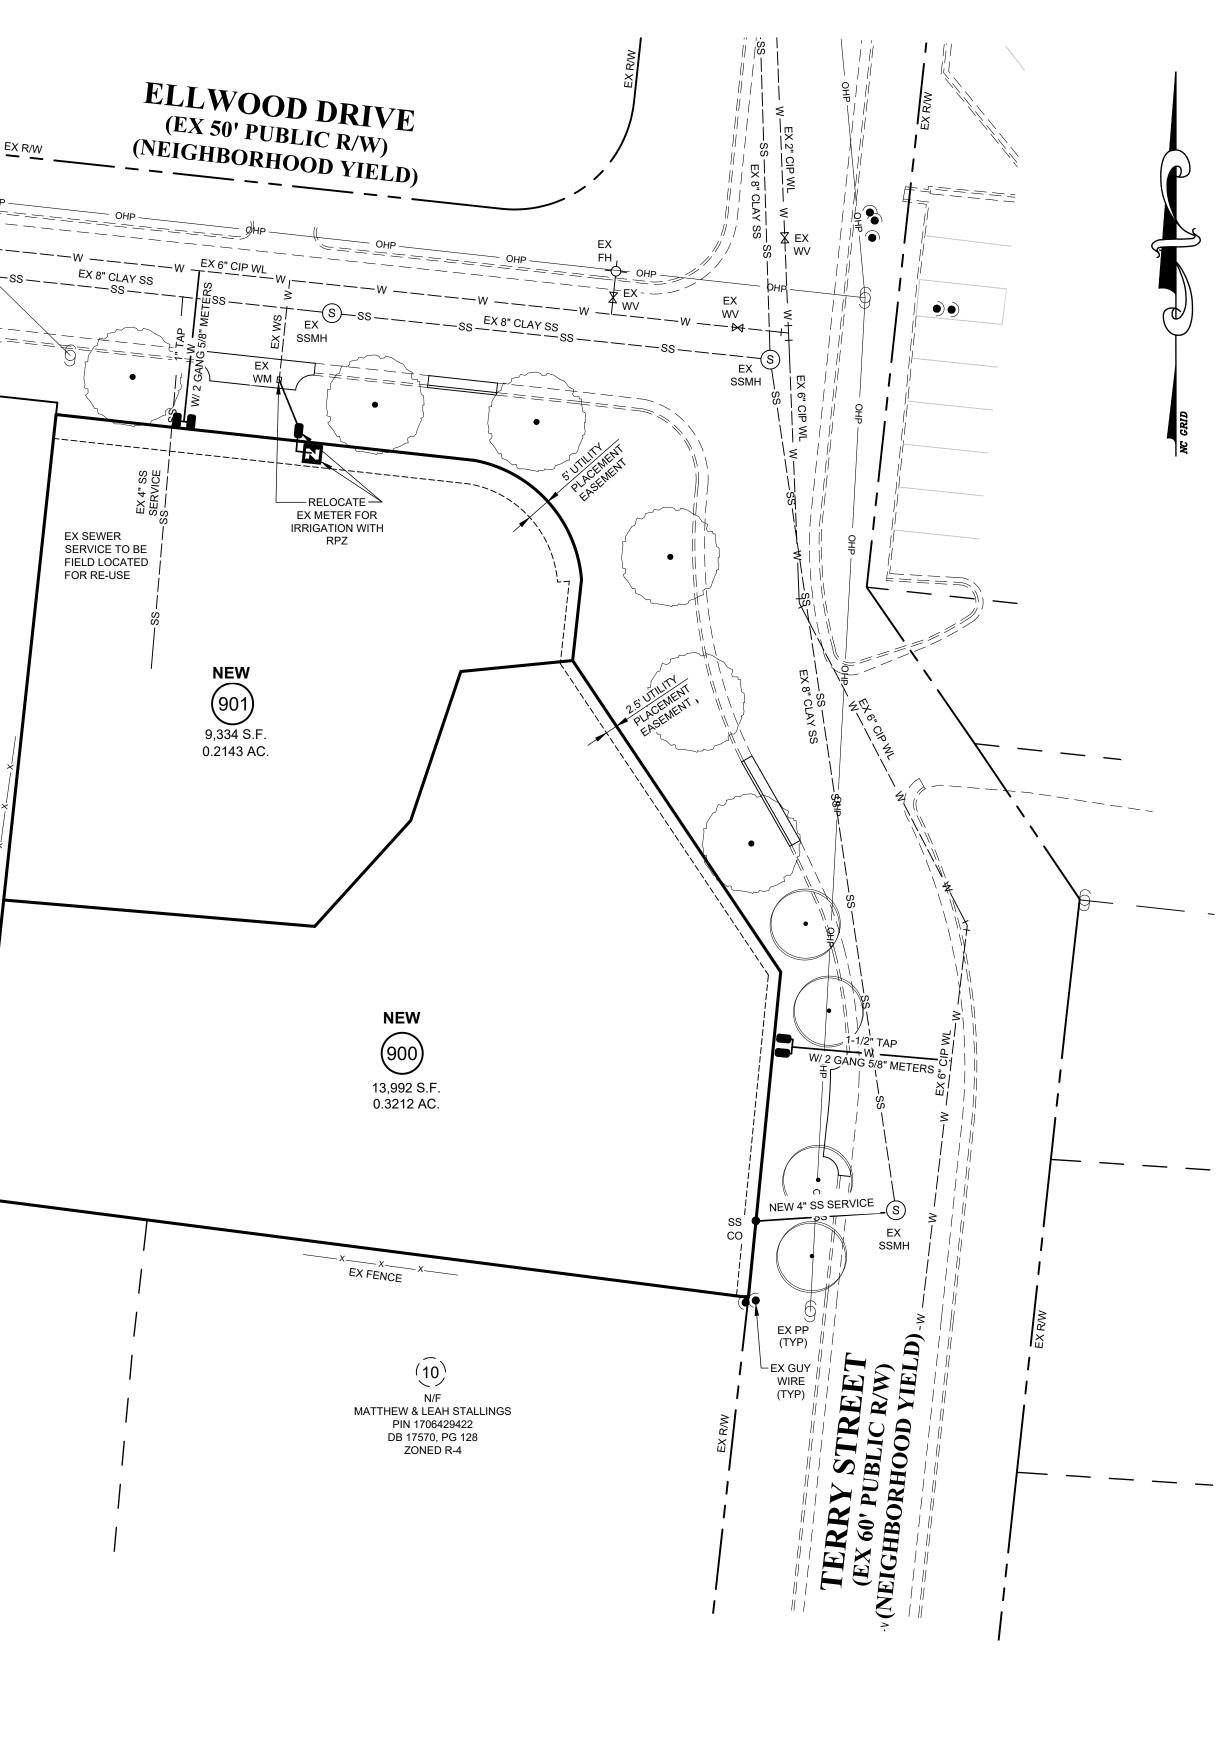

<u>NOTE</u> ALL WATER METERS, CLEAN-OUTS & FIRE HYDRANTS LOCATED OUTSIDE OF THE PUBLIC RIGHT-OF-WAY TO BE LOCATED IN A 5' x 5' UTILITY EASEMENT.

			JOHN A. EDWARDS 8 Gonsulting Engin and Land Surve NC License F-0 333 Wade Ave., Raleigh, Phone: (919) 828-4 E-mail: info@jaec www.jaeco.co	neers yors 289 N.C. 27605 -4428 -711 o.com
			Project THE ELLW AT NORTH 201 ELLWOOD RALEIGH, NC 2	HILLS DRIVE
			^{Client} LINK TINK, LI 2019 FAIRVIEW RALEIGH, NC 2	ROAD
	ENTION CONTRACTORS:		BM BOOK OF MAPS INV. INVE. BO BLOWOFF IPS IRON BW BOTTOM OF WALL JB JUN C&G CURB AND GUTTER MH MAN. CB CATCH BASIN MIN. MIN. CMP CORRUGATED METAL PDE PRIV. CO SEWER CLEANOUT PG PAG CONC. CONCRETE RCP REIN DB DEED BOOK RPDA RED DI DROP INLET RW RIGH DI. DUCTILE IRON RPZ RED DI DROP INLET RW RIGH ELEV. ELEVATION SP SPA EOP EDGE OF PAVEMENT SS SAN ESMT. EASEMENT TC TOP FL FIRE DEPARTMENT TCA TRE FLEVATION TC TOP TER FES FLARED END SECTION TSP TRA FFE FINISHED FLOOR TW TOP EX EXENTION <	N PIPE SET CTION BOX HIOLE MUM V OR FORMERLY VATE DRAINAGE EASEMENT E YVINYL CHLORIDE PIPE JFORCED CONCRETE PIPE UCED PRESSURE ECTOR ASSEMBLY UCED PRESSURE ZONE TT-OF-WAY HARE FET CES ITARY SEWER EXALK OF CURB E CONSERVATION AREA RA COTTA PIPE FFIC SIGNAL OF WALL ICAL TER LINE TER SERVICE TER VALVE D INLET POWER POLE W WATER REDUCER W WATER REDUCER W WATER METER W SEWER MANHOLE W
sewer, <u>contact</u> and the <u>twenty</u> FAILUF constru reinstal	nstruction Contractor responsible for the extension of water, and/or reuse, as approved in these plans, is responsible for ing the PUBLIC WORKS DEPARTMENT at (919) 996-2409. PUBLIC UTILITIES DEPARTMENT at (919)996-4540 at least four hours prior to beginning any of their construction. The to notify both City Departments in advance of beginning ction, will result in the issuance of monetary fines, and require lation of any water or sewer facilities not inspected as a result		Drawing Title UTILITY PL	_AN
FAILUF Permitt RALEIO	btification failure. E to call for Inspection, Install a Downstream Plug, have ed Plans on the jobsite, or any other Violation of CITY OF H STANDARDS will result in a <u>Fine and Possible Exclusion</u> from work in the CITY OF RALEIGH.		Revisions Number Description	Date
	GRAPHIC SCALE	80	Drawing Scale 1" = 20' Drawn By BF	
	(IN FEET) 1 inch = 20 ft.		Checked By JRC Date Issued X/X/XX	- CE-4 - ^{of}

IMPERVIOUS AREAS WITHINI THE PUBLIC R/W AND INCLUDED INT EH FLOOD STUDY ARE SUMMARIZED IN THE IMPERVIOUS AREA SUMMARY TABLE.

NEW LOT 901 IS SUBJECT TO A MAXIMUM IMPERVIOUS SURFACE AREA (MISA) OF 4,580 SF ON THE LOT. A FLOOD STUDY IS PROVIDED IN ACCORDANCE

AREA FOR THE 6' PUBLIC SIDEWALK AND DRIVEWAY LOCATED IN THE PUBLIC

WITH 9.2.2.A.4.b.ii. THE FLOOD STUDY INCLUDES IMPERVIOUS SURFACE

STORMWATER MANAGEMENT PLAN

IN ACCORDANCE WITH 9.2.2.A.2.b.i. THIS IS A SUBDIVISION OF A

SURFACE COVERAGE OUTLINED PER ZONING IN 9.2.2.A.4.a.

R/W WHICH IS IN ADDITION TO THE MISA SHOWN ON THE LOT.

DRIVEWAY CONNECTION IN THE PUBLIC R/W.

GRANDFATHERED LOT ONE ACRE OR LESS TO BE USED FOR SINGLE UNIT LIVING, OR ANY ATTACHED HOUSE, TINY HOUSE OR TWO UNIT TOWNHOUSE

DEVELOPMENT USED FOR 2 UNIT LIVING AND THEREFORE REMAINS GRANDFATHERED SUBJECT TO MAXIMUM PERCENTAGE OF IMPERVIOUS

NEW LOT 900 IS SUBJECT TO A MAXIMUM 38% IMPERVIOUS SURFACE COVERAGE AREA WHICH INCLUDES A 6' PUBLIC SIDEWALK AND THE

IMPERVIOUS AREA SUMMARY

EXISTING ON SITE..... (EXISTING GRANDFATHERED LOT EXISTING IN R/W (TO E PROPOSED MAX ON N PROPOSED IN R/W LO PROPOSED MAX ON N PROPOSED IN R/W LO

(11) N/F

PIN 1706428423

ZONED R-4

 $(\widehat{8})$


N/F

TODD & NAN JONES

PIN 1706428602 DB 12884, PG 1487 BM 1963, PG 223 ZONED R-4


-

_

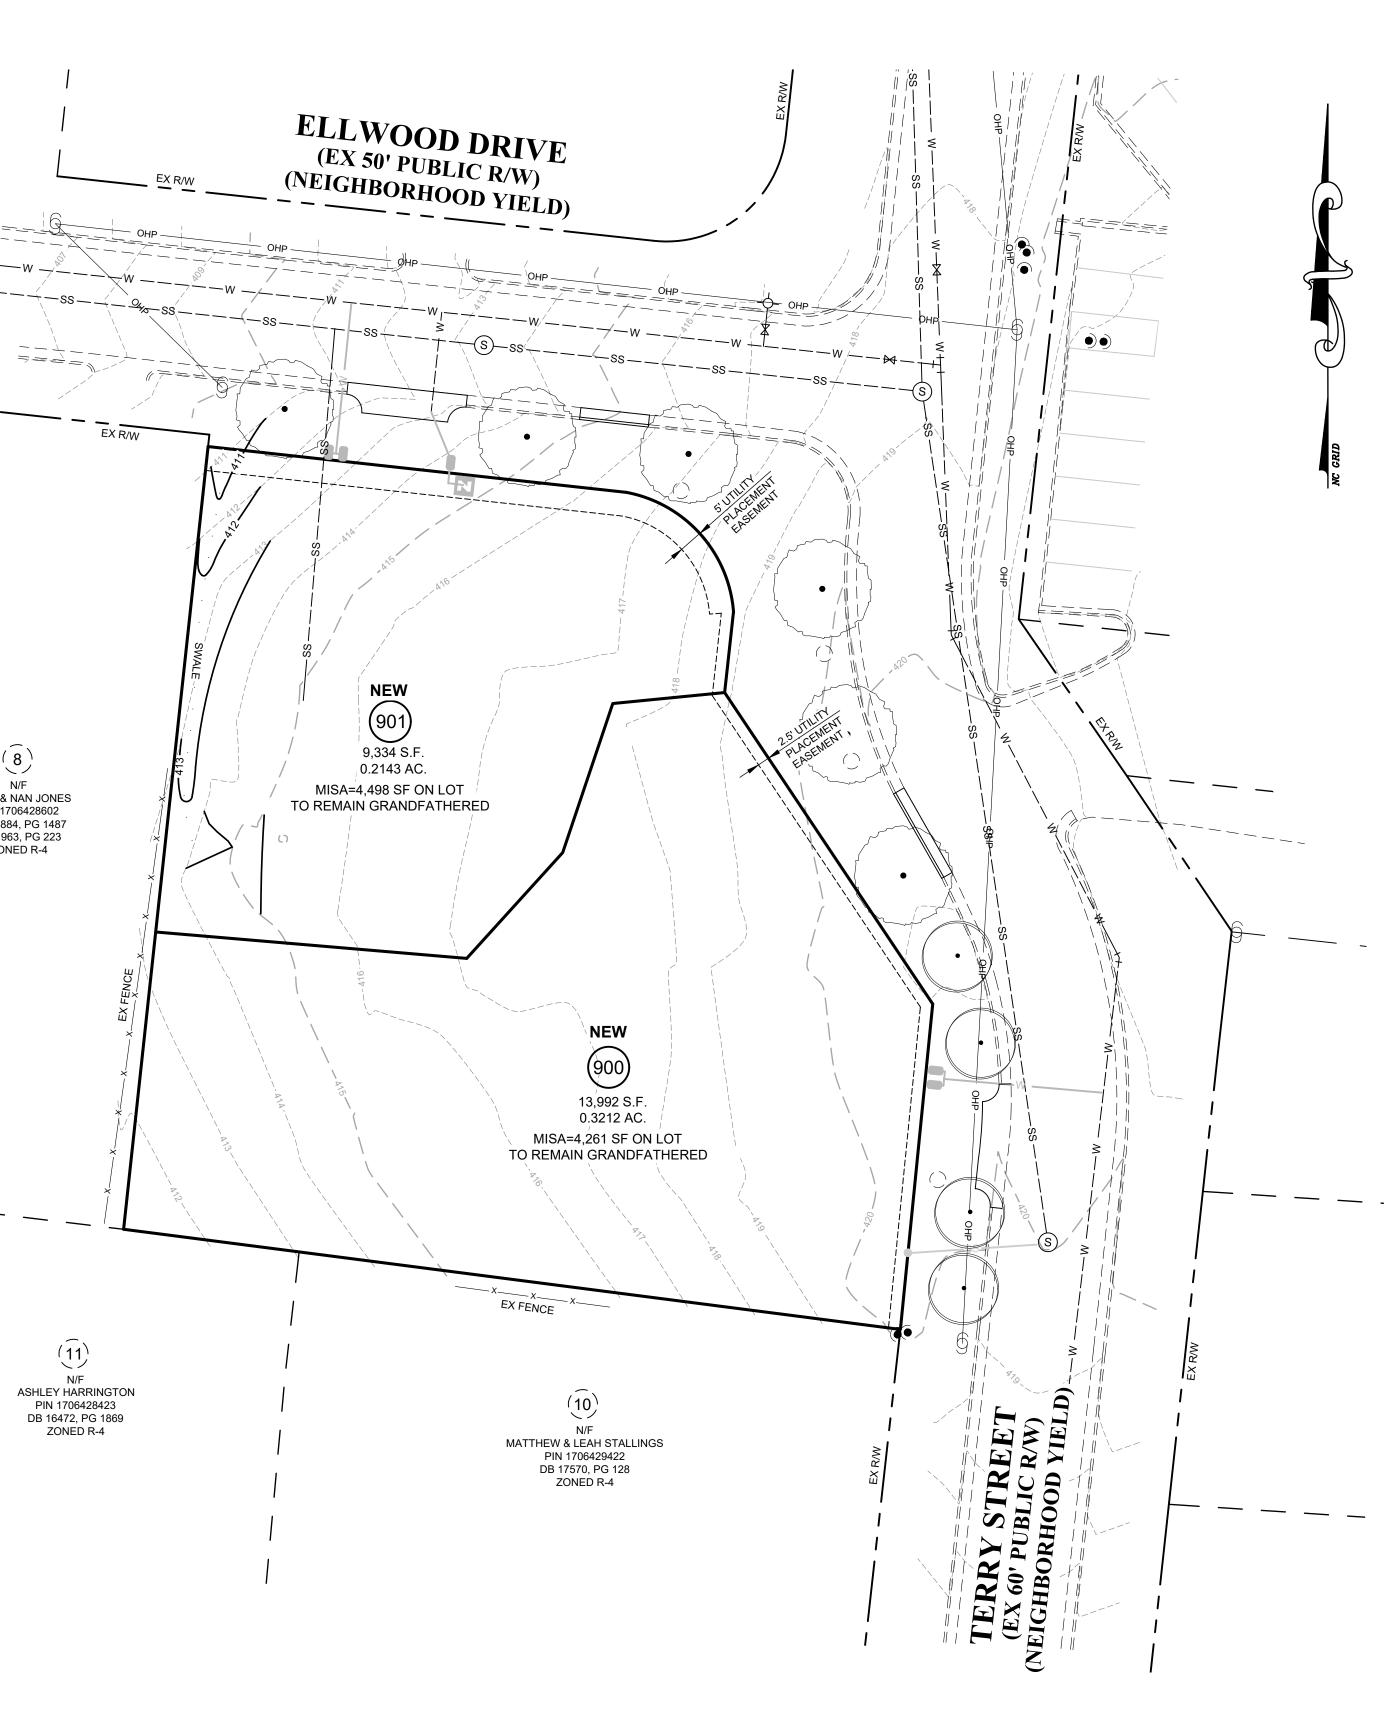

~~	5,068 S.F 0.12 AC.
ot) EXISTING BACK OF CURB)	. 371 S.F 0.0085 AC.
NEW LOT 900 (38% LESS R/W IMPROVEMENTS TO BACK OF CURB)	4,261 S.F 0.0978 AC.
OT 900 (TO EXISTING BACK OF CURB)	1,056 S.F 0.0242 AC.
NEW LOT 901	4,498 S.F 0.1051 AC.
OT 901 (TO EXISTING BACK OF CURB)	1,122 S.F 0.0258 AC.

			Projed Projed Projed Projed
			^{Client} LINK TINK, LLC 2019 FAIRVIEW ROAD RALEIGH, NC 27608
The Cons sewer, ar <u>contactine</u> and the P	INTION CONTRACTORS: Intuition Contractor responsible for the extension of water, d/or reuse, as approved in these plans, is responsible for the PUBLIC WORKS DEPARTIMENT at (919) 996-2409. UBLIC UTILITIES DEPARTIMENT AT		LEGEND AC. ACREAGE BM BOOK OF MAPS BW BOOK OF WALL BW BOTTOM OF WALL BW BOTTOM OF WALL BW BOTTOM OF WALL CG CURB AND GUTTER BW CORCATCH BASIN CMP CORCATCH BASIN CMP CORCATCH BASIN CMP CORCATCH BASIN CONC CORCATED METAL PIE PREINFORCE DONG RETE CONC CORCORCETE DI DUCTILE IRON DI DUCTILE IRON DI DUCTILE IRON PIC PREINFORCE DONGRETE 20NE DI DORDP INLET SENSTING IRON PIPE S.F. SENT. EASEMENT SSMIT EASEMENT SW SIGUARE FEET SW SOUARE FEET SW SENT. EASEMENT EX. EXTING IRON PIPE S.F. SOUARE FEET SW SOUARE FEET SW SOUARE FEET SW SOUARE FEET <t< th=""></t<>
FAILURE construct reinstallat of this no FAILURE Permitted RALEIGH	to notify both City Departments in advance of beginning on, will result in the issuance of monetary fines, and require on of any water or sewer facilities not inspected as a result tification failure. to call for Inspection, Install a Downstream Plug, have Plans on the jobsite, or any other Violation of CITY OF STANDARDS will result in a <u>Fine and Possible Exclusion</u> from k in the CITY OF RALEIGH.		GRADING / STORMWATER PLAN Revisions Number Description Date
	GRAPHIC SCALE		
	(IN FEET) 1 inch = 20 ft.	80	Drawing Scale 1" = 20' Drawn By BF Checked By JRC Date Issued X/X/XX

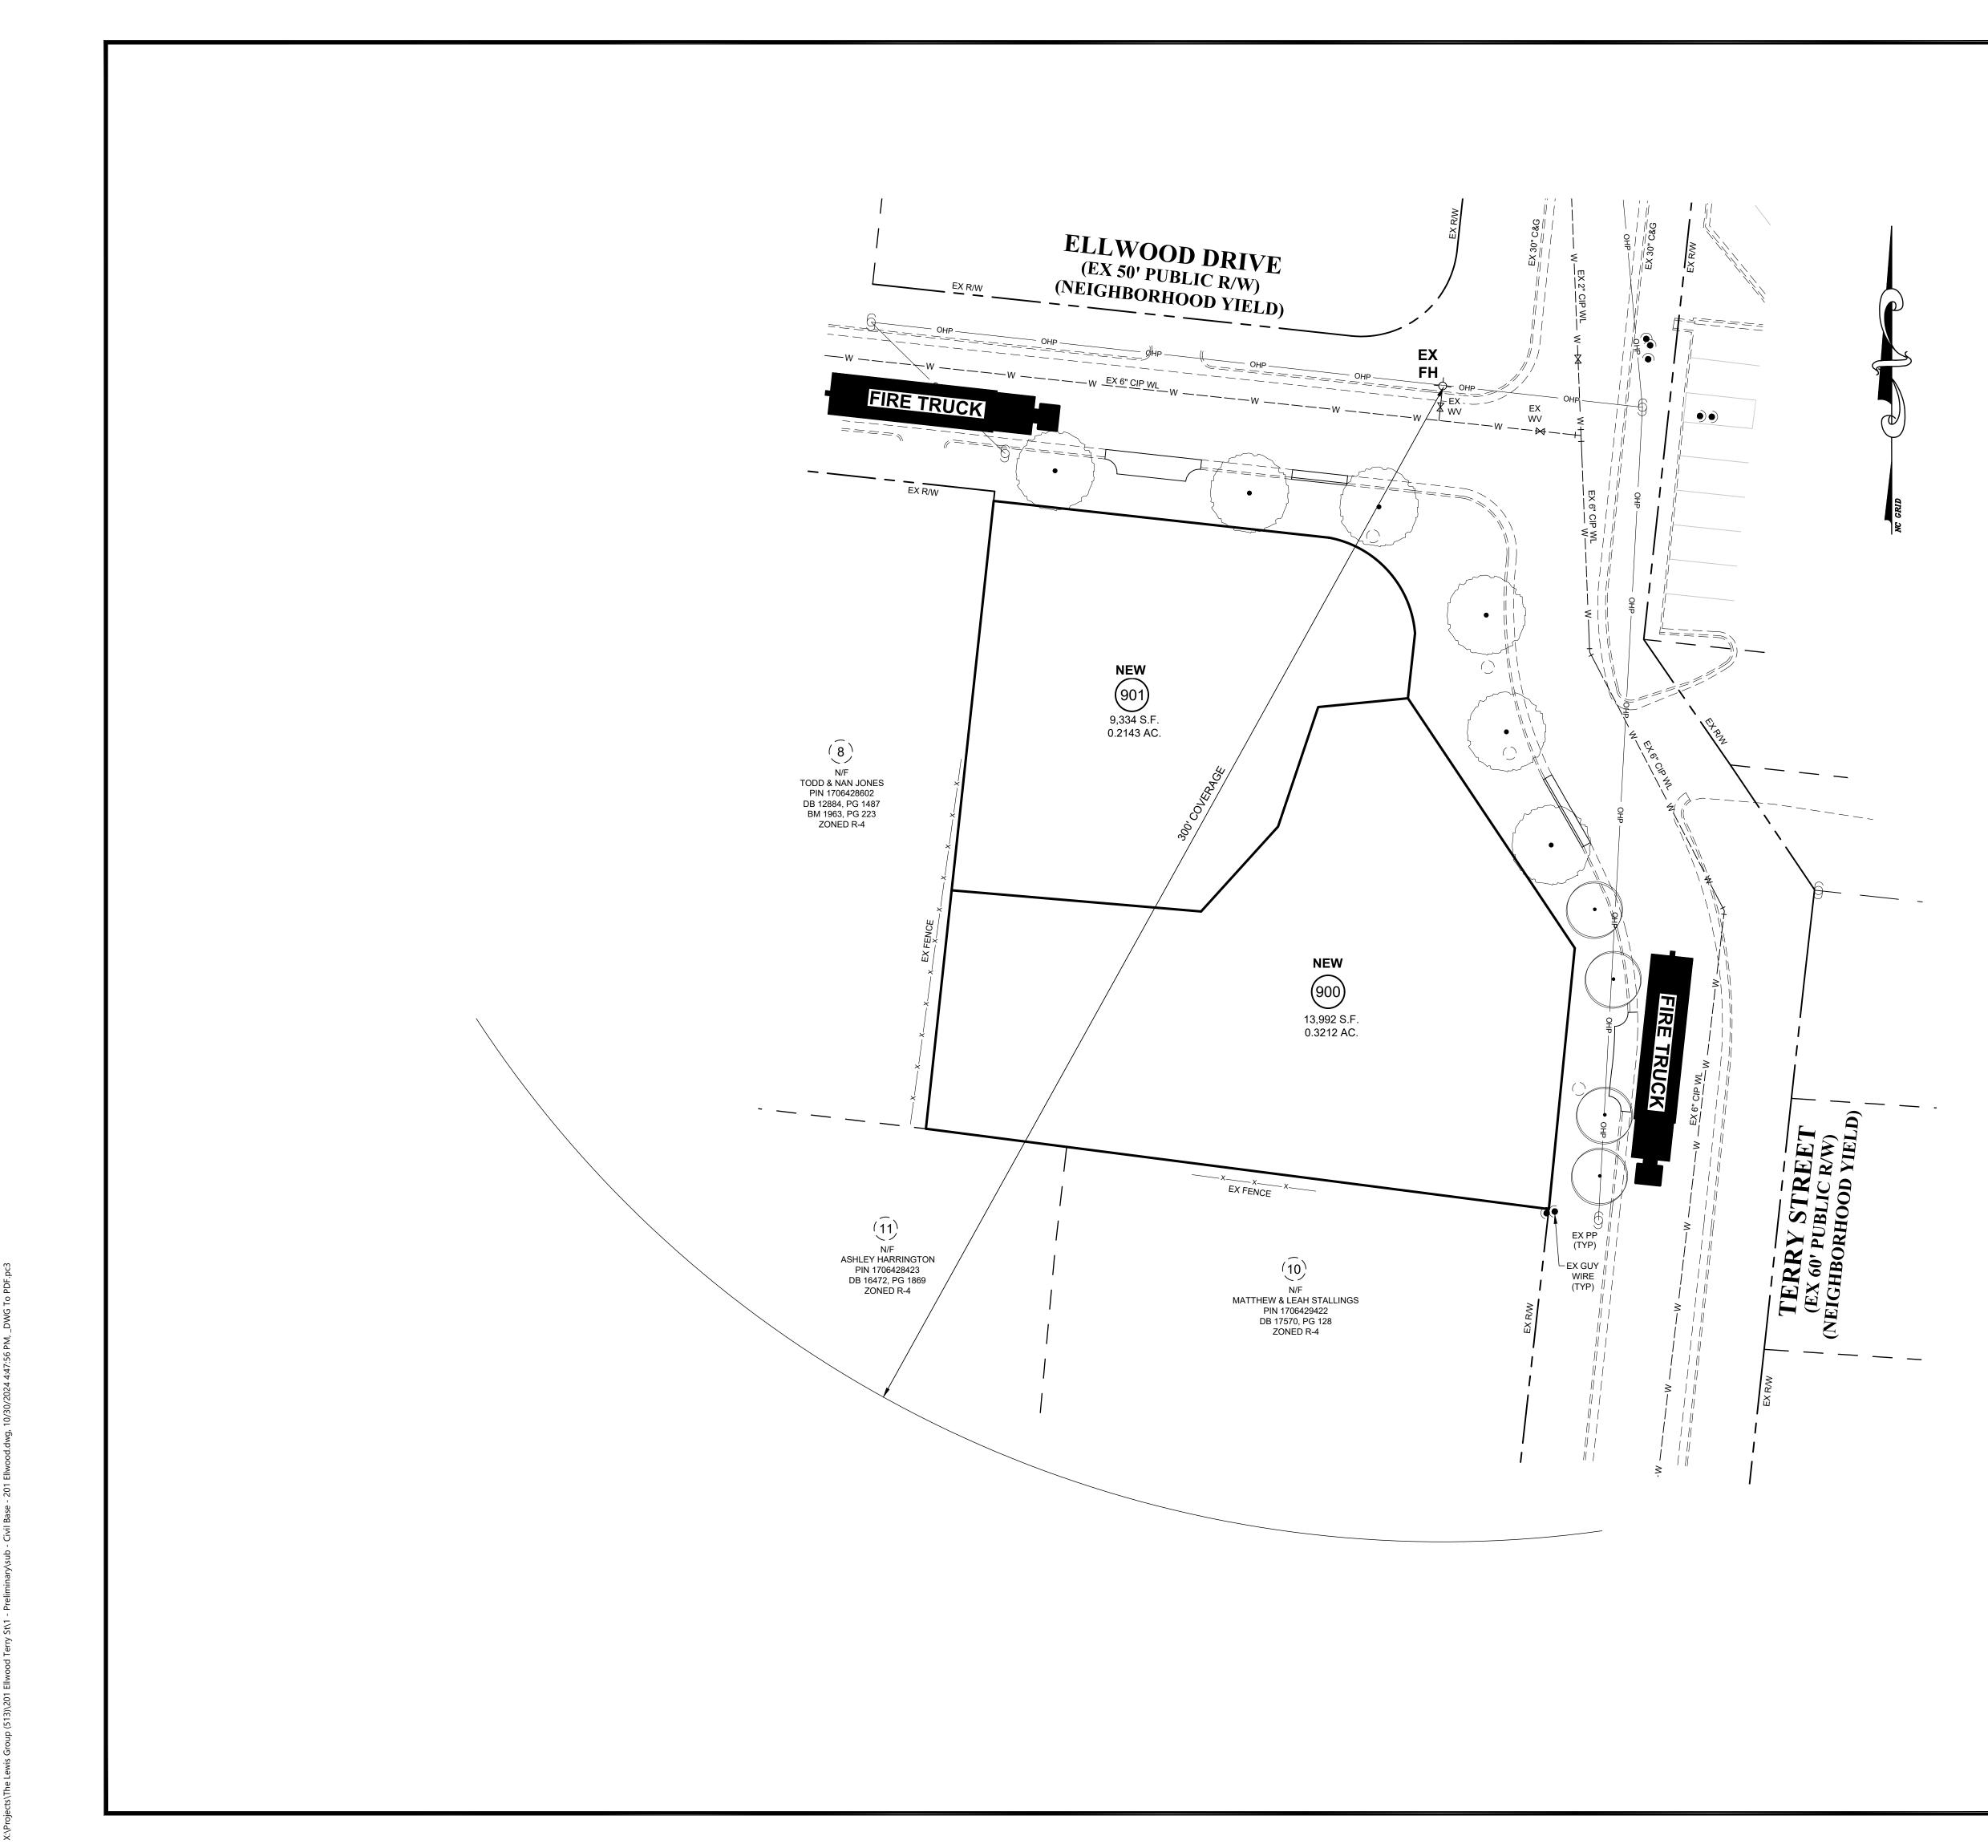

		Consulting Engineers and Land Surveyors NC License F-0289 333 Wade Ave., Raleigh, N.C. 27605 Phone: (919) 828-4428 Fax: (919) 828-4711 E-mail: info@jaeco.com
CRAPHIC SCALE		Project THE ELLWOOD DRIVE
		LINK TINK, LLC 2019 FAIRVIEW ROAD RALEIGH, NC 27608
GRAPHIC SCALE		AC. ACREAGE HW HEADWALL BM BOOK OF MAPS INV. INVERT B0 BLOWOFF JB JUNCTION BOX CAG CURB AND GUTTER MIN MANHOLE BM CORCUCATED METAL JP PORP PIE PROP PRIVATE DRAINAGE EASEMENT PDE PORCORCRETE PVC DCVA DOUBLE CHECK VALVE PAGE DL DUCTILE IRON RP2 REDUCED PRESSURE ZONE REDUCED PRESSURE ZONE DI DROP INLET RW REP EXISTING IRON PIPE SS SAMITARY SEWER SSURE ZONE PIP EXISTING IRON PIPE SS EVENTION SP SPACES SOLARE FEET SW SIDEWALK EX. EASEMENT SW SIDEWALK TOP OF CURB FDC FIRE DEPARTMENT TCA CONCRETE WW SIDEWALK FL FIRE HYDRANT TCP FL FIRE HYDRANT TCP FL FIRE HYDRAN
GRAPHIC SCALE O 10 20 40 80 Drawing Scale 1" = 20' Drawn By BF CE-6		FIRE DEPARTMENT PLAN Revisions
20 0 10 20 40 80 Image: Second s		
	10 20 40 80	Drawn By BF