

Case File / Name: SUB-S-9-2019 GARNER ROAD TOWNHOMES City of Raleigh
Development Services Department
One Exchange Plaza
Raleigh, NC 27602
(919) 996-2492
currentplanning@raleighnc.gov
www.raleighnc.gov

LOCATION: The site is located at 2908 Garner Road and the PIN is 1702944574.

REQUEST: Development of a 1.13 acre tract zoned Residential Mixed Use (RX-3-CU) into 13

townhome lots with 1 common lot. There are corresponding zoning conditions

under Z-18-2018.

One variance has been approved by the Board of Adjustment under case A-81-19

for this project.

The variance request entailed a 5' rear yard setback variance from Unified Development Ordinance Section 3.2.3C and a 3' variance form the rear setback

encroachment allowed under section 1.5.4.D.1.i.

DESIGN

ADJUSTMENT(S)/

ALTERNATES, ETC: SPR-0273-2019: DSLC - Site Permitting Review/Major [Signature Set]

RCMP-0125-2020: DSLC - Recorded Maps/Subdivision

SUR-0725-2021: DSENG - Surety/Infrastructure

FINDINGS: City Administration finds that this request, with the below conditions of

approval being met, conforms to the Unified Development Ordinance. This approval is based on a preliminary plan dated September 30, 2019 by

Crumpler Consulting Services.

CONDITIONS OF APPROVAL and NEXT STEPS:

This document must be applied to the second sheet of all future submittals except for final plats. This is a preliminary plan and as such no permits have been issued with this approval. To obtain permits and/or completion of the project, the following steps are required:

☑ <u>SITE PERMITTING REVIEW</u> - For land disturbance of 12,000 square feet or greater, public or private infrastructure, shared stormwater devices, etc. Site Permitting Review may be submitted upon receipt of this signed approval document.

The following items are required prior to approval of Site Permitting Review plans:

General

1. That the final site and landscape plans be revised to show all required shade trees to meet the height and spread size requirements as defined for shade trees in the UDO and to show that all required interior parking lot landscape islands meet the minimum size and dimensional requirements of UDO Section 7.1.7 D2.

Stormwater

- 2. A surety equal to of the cost of clearing, grubbing and reseeding a site, shall be paid to the City (UDO 9.4.4).
- 3. A nitrogen offset payment must be made to a qualifying mitigation bank (UDO 9.2.2.B).
- 4. A stormwater control plan with a stormwater operations and maintenance manual and budget shall be approved (UDO 9.2).



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☑ **LEGAL DOCUMENTS** - Email to legaldocumentreview@raleighnc.gov. Legal documents must be approved, executed, and recorded prior to or in conjunction with the recorded plat on which the associated easements are shown. Copies of recorded documents must be returned to the City within one business day of recording to avoid withholding of further permit issuance.

| Ø | Cross Access Agreements Required | Ø | Utility Placement Easement Required |
|---|--|---|-------------------------------------|
| Ø | Stormwater Maintenance Covenant Required | | |

☑ <u>RECORDED MAP(S)</u> - Submit plat to record new property lines, easements, tree conservation areas, etc.). Plats may be submitted for review when the Site Permitting Review plans, if required, have been deemed ready for mylar signature.

The following items must be approved prior to recording the plat:

General

1. The City Code Covenant is no longer required based on UDO text change TC-19-20.

Engineering

- 2. A cross access agreement for the shared driveway and sidewalk among the proposed lots and to the adjacent parcel identified by PIN 1702-94-5298 as shown on the preliminary plan shall be approved by the Development Services Department for recording in the Wake County Registry, and a copy of the recorded cross access easement shall be returned to the Development Services Department within one day of plat recordation. If a recorded copy of the document is not provided within this time, further recordings and building permit issuance will be withheld.
- 3. A fee-in-lieu for 1' of sidewalk along Rush Street and Garner Road is paid to the City of Raleigh (UDO 8.1.10).
- 4. A 5' utility placement easement and associated deed of easement shall be approved by the City and the location of the easement shall be shown on the map approved for recordation. The deed of easement shall be recorded at Wake County Register of Deeds within one day of recordation of the recorded plat. A recorded copy of these documents must be provided to the Development Services Department within one day from authorization of lot recordation. If recorded copies of the documents are not provided, further recordings and building permit issuance will be withheld.
- 5. The required right of way for proposed and/or existing streets shall be dedicated to the City of Raleigh and shown on the map approved for recordation.
- 6. A public infrastructure surety is provided to the City of Raleigh Development Services Development Engineering program (UDO 8.1.3).

Stormwater



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- 7. The City form document entitled Declaration of Maintenance Covenant and Grant of Protection Easement for Stormwater Control Facilities shall be approved by the City and recorded with the county register of deeds office (UDO 9.2.2.G).
- 8. A payment equal to twenty-four percent (24%) of the estimated cost of constructing all stormwater control facilities shown on the development plans shall be paid by the developer to the City stormwater facility replacement fund (UDO 9.2.2.G.3).
- 9. All stormwater control measures and means of transporting stormwater runoff to and from any nitrogen and stormwater runoff control measures shall be shown on all plats for recording as private drainage easements (UDO 9.2).

☑ <u>BUILDING PERMITS</u> - For buildings and structures shown on the approved plans. Commercial building permit plans must include the signed, approved Site Permitting Review plans attached, if applicable. Permit sets may be reviewed prior to the recordation of required plats, but cannot be approved.

The following items must be approved prior to the issuance of building permits:

Urban Forestry

1. A tree impact permit must be obtained for the approved streetscape tree installation in the right of way. This development proposes street trees along Rush Street and Garner Road.

The following are required prior to issuance of building occupancy permit:

Stormwater

- 1. As-built impervious survey is accepted by the Engineering Services Department (UDO 9.2).
- 2. As-built drawings and associated forms for all Stormwater devices are accepted by the Engineering Services Department (UDO 9.2.2.D.3).

EXPIRATION DATES: If significant construction has not taken place on a project after preliminary subdivision approval, that approval may "sunset" and be declared void, requiring re-approval before permits may be issued. To avoid allowing this preliminary approval to "sunset", the following must take place by the following dates:

3-Year Sunset Date: July 6, 2023

Record at least ½ of the land area approved.

5-Year Sunset Date: July 6, 2025

Record entire subdivision.





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I hereby certify this administrative decision.

Signed: Alusia Bailey Taylor Date: 10/09/2019

Development Services Dir/Designee
Staff Coordinator: Daniel Stegall



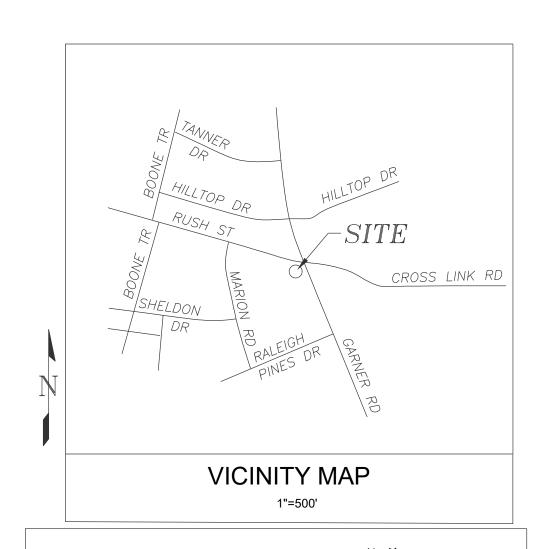
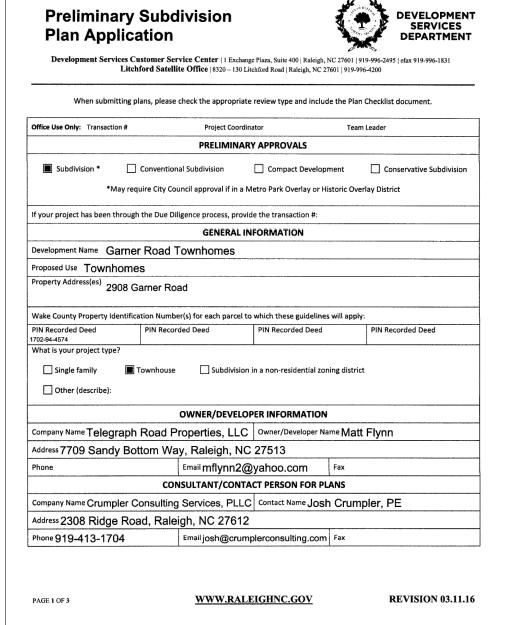
| DEVELOPMENT TYPE | E AND SITE DAT | E TABLE (Applicable to | all developm | ents) | | | |
|---|------------------------|--|--|---------------------------------------|--|--|--|
| | ZONING | INFORMATION | | 700 | | | |
| Zoning District(s) RX-3-CU | | | | | | | |
| If more than one district, provide the acreag | e of each: | | | | | | |
| Overlay District? Yes 🔳 No | | | | | | | |
| Inside City Limits? Yes No | | | | | | | |
| CUD (Conditional Use District) Case # Z- 18- | 2018 | | | | | | |
| COA (Certificate of Appropriateness) Case # | | | | | | | |
| BOA (Board of Adjustment) Case # A- | | | | | | | |
| | STORMWAT | ER INFORMATION | | | | | |
| Existing Impervious Surface () | acres/sf | Flood Hazard Area | Yes | ■ No | | | |
| Proposed Impervious Surface 26,149 | acres/sf | Neuse River Buffer | Yes | ■ No | | | |
| | | Wetlands | Yes | ■ No | | | |
| If in a Flood Hazard Area, provide the followi | ng: | | | | | | |
| Alluvial Soils Flood | FEMA Map | FEMA Map Panel # | | | | | |
| | NUMBER OF | LOTS AND DENSITY | | | | | |
| Total # of Townhouse Lots: Detached 1 | Attached 13 | Attached 13 | | | | | |
| Total # of Single Family Lots () | Total # of All Lots 14 | Total # of All Lots 14 | | | | | |
| Overall Unit(s)/Acre Densities Per Zoning Dis | tricts 13.37 | | | | | | |
| Total # of Open Space and/or Common Area | Lots 1 lot at 4, | 766sf | | · · · · · · · · · · · · · · · · · · · | | | |
| SIGNAT | JRE BLOCK (Ap | plicable to all develop | nents) | | | | |
| In filing this plan as the property owner(s), !/ successors and assigns jointly and severally t subdivision plan as approved by the City. | | | | | | | |
| I hereby designate Josh Crumpler administrative comments, to resubmit plans | | my agent regarding this app to represent me in any publ | | | | | |
| I/we have read, acknowledge, and affirm tha development use. | t this project is cor | nforming to all application re | equirements app | licable with the proposed | | | |
| 111 | Manage | r 4/23 | 15 | | | | |
| | | Date | | | | | |
| Signature | | | | | | | |

PRELIMINARY SUBDIVISION PLANS FOR

GARNER ROAD TOWNHOMES

2908 GARNER ROAD RALEIGH, NORTH CAROLINA

CITY OF RALEIGH FILE: SUB-S-9-19
CITY OF RALEIGH FILE: S-9-19
CITY OF RALEIGH TRANSACTION #: 586702

PREPARED FOR:
TELEGRAPH ROAD PROPERTIES, LLC
7709 SANDY BOTTOM WAY
RALEIGH, NORTH CAROLINA 27513

PREPARED BY:

CRUMPLER

Consulting Services, PLLC

Project Contact: Joshua Crumpler, PE 2308 Ridge Road Raleigh, North Carolina 27612 Ph. 919-413-1704 P-1533 BOARD OF ADJUSTMENT-APPROVED VARIANCE DECISION (A-81-19-99/9/19)

DECISION: APPROVED AS REQUESTED.

WHEREAS TELEGRAPH ROAD PROPERTIES, LLC, PROPERTY OWNER, REQUESTS A 5' REAR YARD SETBACK VARIANCE FROM SECTION 3.2.3.C OF THE UNIFIED DEVELOPMENT ORDINANCE AND A 3' VARIANCE FROM THE REAR SETBACK ENCROACHMENTS ALLOWED UNDER SECTION 1.5.4.D.1.i IN ORDER TO CONSTRUCT A 13-UNIT TOWNHOUSE DEVELOPMENT THAT RESULTS IN A 15' REAR YARD SETBACK FOR FOUR OF THE PROPOSED TOWNHOMES AND A REAR YARD SETBACK RANGING FROM 9'-10' FOR FOUR OF THE ASSOCIATED PATIOS ALL ON A 1.13-ACRE PROPERTY ZONED RESIDENTIAL MIXED-USE-3 CONDITIONAL USE LOCATED AT 2908 GARNER ROAD.

REZONING NOTES

ORDINANCE 909 ZC 773

EFFECTIVE 1/8/19
Z-18-18 - GARNER ROAD AND RUSH STREET, APPROXIMATELY 1.13 ACRES LOCATED AT THE SOUTHWEST INTERSECTION OF GARNER ROAD AND RUSH STREET AT 2908 GARNER ROAD, BEING WAKE COUNTY PIN 1702944574, ARE REZONED TO RESIDENTIAL MIXED USE-3 STORIES-CONDITIONAL USE (RX-3-CU

CONDITIONS DATED: NOVEMBER 16, 2018

- 1. THE FOLLOWING PRINCIPAL USES LISTED IN ALLOWED PRINCIPAL USE TABLE (UDO SECTION 6.1.4) SHALL BE PROHIBITED: BOARDINGHOUSE; DORMITORY, FRATERNITY, SORORITY; EMERGENCY SHELTER TYPE B. (THE SITE IS IN COMPLIANCE AS THE USE WILL BE TOWNHOMES)
- NOT EXCEED 16 DWELLING UNITS.

 (THE SITE IS IN COMPLIANCE AS THE TOTAL NUMBER OF UNITS WILL

 DE 12 TOWNWOMES)
- 3. VINYL SIDING SHALL BE PROHIBITED AS AN EXTERIOR BUILDING SIDING MATERIAL, BUT THIS SHALL NOT APPLY TO SOFFETS, EAVES, WINDOWS AND OTHER ARCHITECTURAL ACCENTS.

 (THE SITE WILL BE IN COMPLIANCE AS THE BUILDING MATERIAL

NOTE

- TOPOGRAPHIC AND BOUNDARY SURVEY PROVIDED BY TURNING POINT SURVEYING, PLLC, DATED 12/05/17.
- 2. THE RECORDED PARCEL IS LOCATED IN BM 1996, PG 748 WITH A DEED LOCATED IN DB 15207, PG 999, AND A PIN OF 0786.07-59-4717.
- 3. PROPERTY IS LOCATED IN ZONES X (AREA DETERMINED TO BE OUTSIDE THE 0.2% ANNUAL CHANCE AND FUTURE 1% ANNUAL CHANCE FLOODPLAIN) BASED ON THE FEMA MAP NUMBER 3720078600J DATED MA
- 4. NO ONSITE STREAMS OR WETLANDS HAVE BEEN IDENTIFIED WITHIN THE PROJECT OR PARCEL AS SHOWN.
- 5. THIS DRAWING IS NOT FOR RECORDATION.

PROPOSED WILL NOT BE VINYL SIDING)

6. SOLID WASTE TO BE HANDLED USING ROLLOUT TRASHCANS. ROLLOUT TRASHCANS TO BE STORED ON REAR PATIOS. SOLID WASTE COLLECTION AREA MUST ADHERE TO SCREENING REQUIREMENTS OF UDO SEC. 7.2.5.C AND BE LOCATED TO THE SIDE OR REAR OF BUILDINGS AND MUST BE SCREENED FROM VIEW FROM ADJACENT PROPERTY OR PUBLIC STREET

SITE EXEMPTION NOTES:

-THE SITE WILL BE CONFORMING TO THE EXEMPTION OF TREE CONSERVATION REQUIREMENTS THROUGH THE CITY OF RALEIGH'S UNIFIED DEVELOPMENT CODE SECTION 9.1.2 FOR PARCELS LESS THAN 2 ACRES IN SIZE.

| | SHEET | DESCRIPTION | | | | |
|--|-------|--------------------------------|--|--|--|--|
| | C-1 | COVER | | | | |
| | C-2 | EXISTING SURVEY | | | | |
| | C-3 | SITE PLAN | | | | |
| | C-4 | UTILITY PLAN | | | | |
| | C-5 | GRADING PLAN | | | | |
| | C-6 | LANDSCAPING PLAN | | | | |
| | C-7 | OUTDOOR AMENITY PLAN | | | | |
| | C-8 | TOWNHOME LOT AND EASEMENT PLAN | | | | |
| | D-1 | DETAILS | | | | |
| | D-2 | DETAILS | | | | |
| | D-3 | DETAILS | | | | |
| | D-4 | DETAILS | | | | |
| ALL CONSTRUCTION TO BE IN ACCORDANCE WITH ALL CITY OF RALEIGH STANDARDS AND SPECIFICATIONS. CALL 48 HOURS BEFORE YOU DIG | | | | | | |
| | | | | | | |

NORTH CAROLINA
ONE-CALL CENTER
1-800-632-4949

RUMPLER onsulting Services, PLLC 2308 Ridge Road

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ISSUED FOR PERMITTING

1 CITY OF RALEIGH COMMENTS 04/24/19
2 CITY OF RALEIGH COMMENTS 09/26/19
3 CITY OF RALEIGH COMMENTS 09/26/19
4 CITY OF RALEIGH COMMENTS 09/30/19

COVER SHEET

ER ROAD TOWNHOMES

2908 GARNER ROAD


PROJECT NO.: 18005


DRAWN BY: JAC
CHECKED BY: JAC

DATE: 02/01/19

SCALE: NO SCALE

C-1

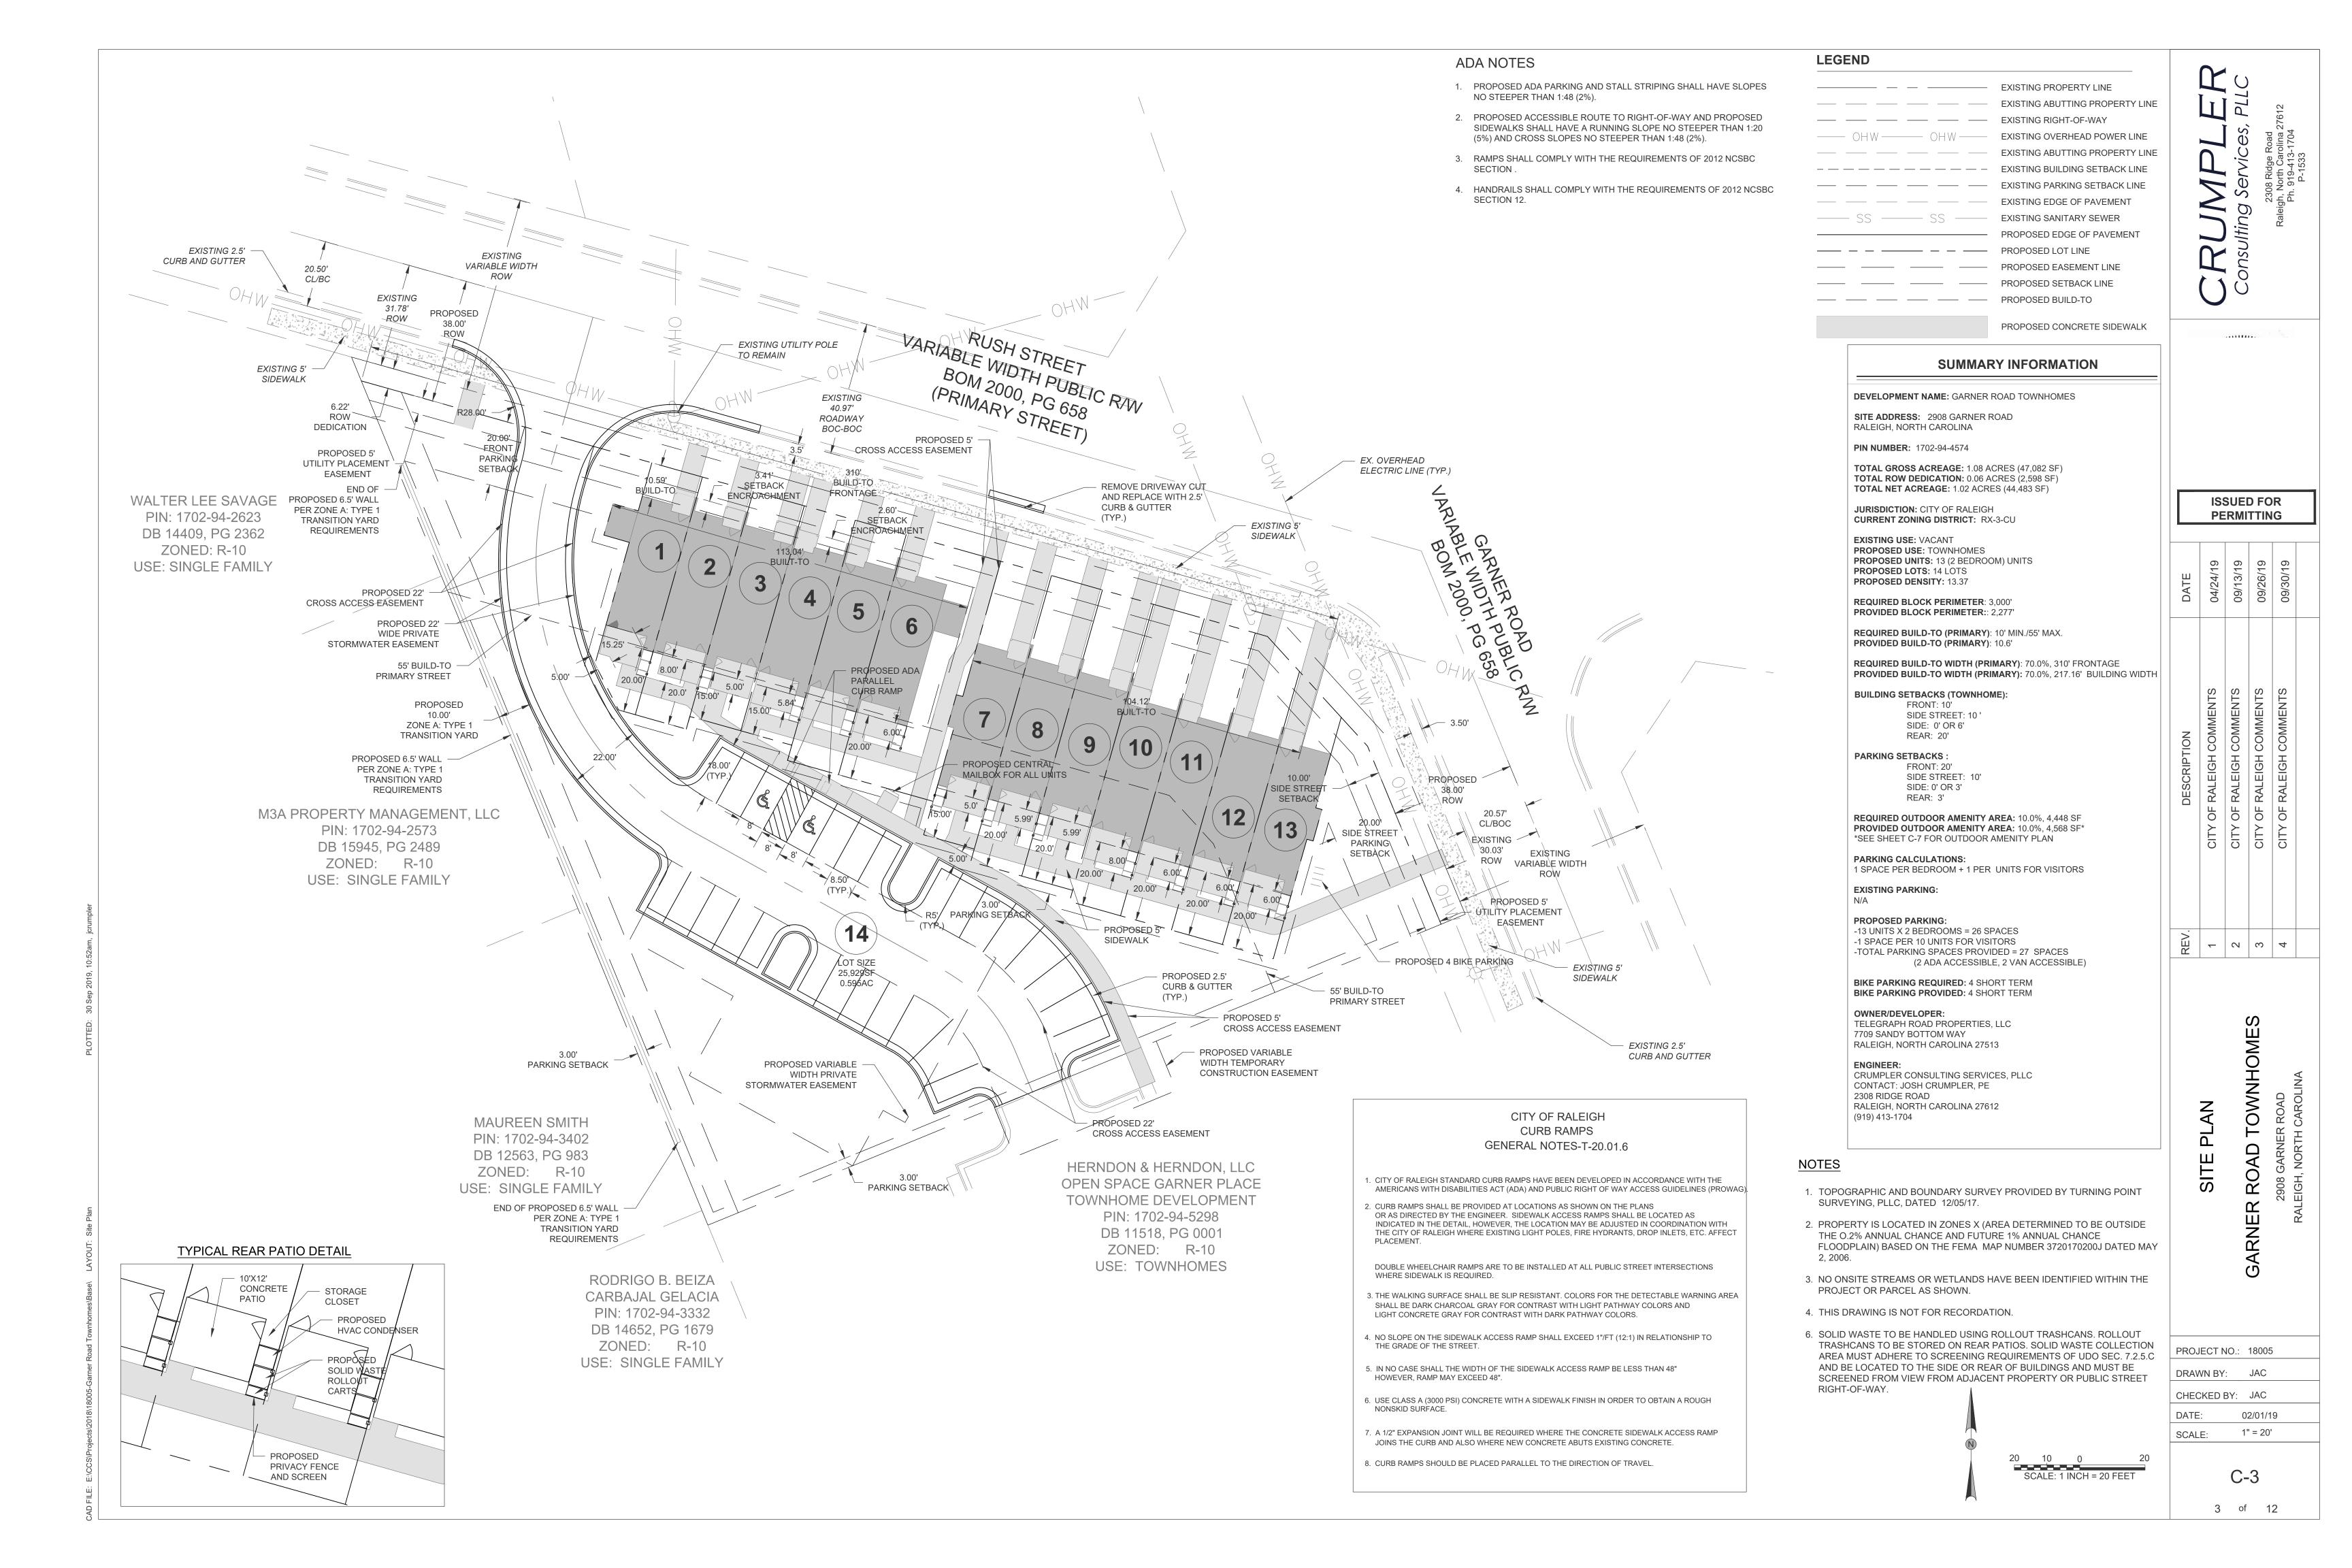

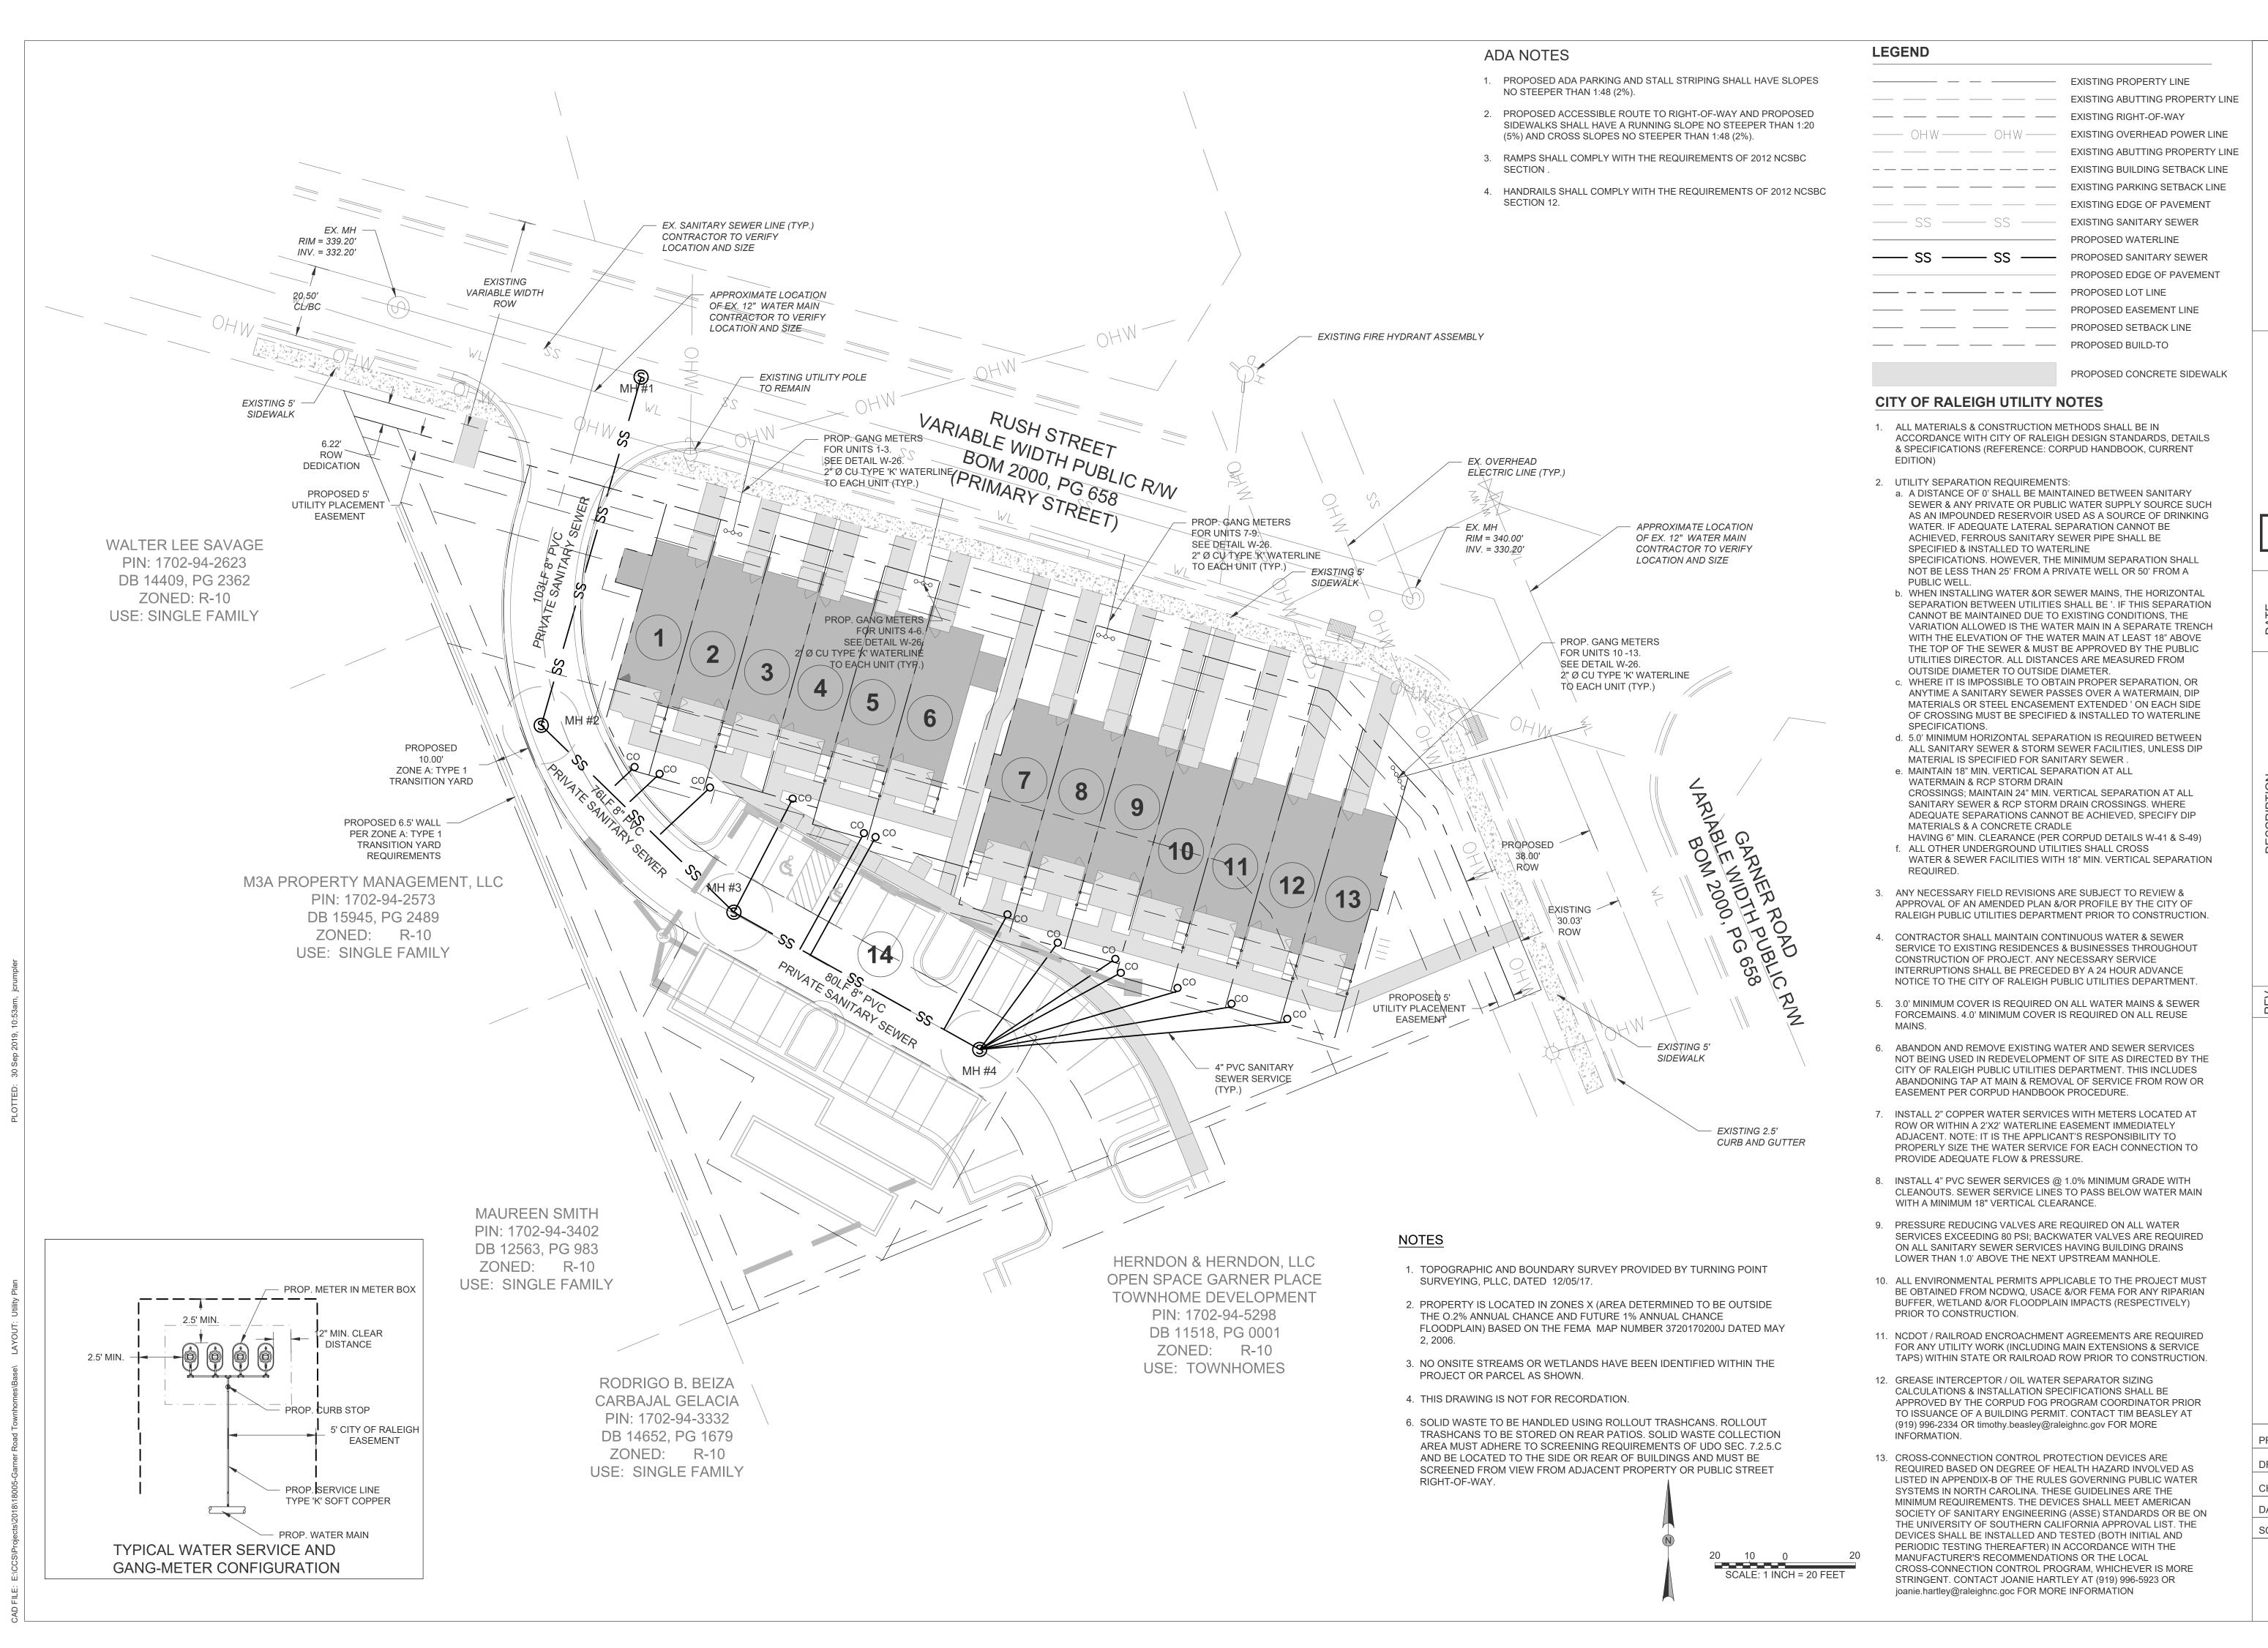

Ifing Services, PLLC
2308 Ridge Road
Raleigh, North Carolina 27612
Ph. 919-413-1704

.....

ISSUED FOR PERMITTING

1 CITY OF RALEIGH COMMENTS 04/24/19
2 CITY OF RALEIGH COMMENTS 09/13/19
3 CITY OF RALEIGH COMMENTS 09/26/19
4 CITY OF RALEIGH COMMENTS 09/30/19

ARNER ROAD TOWNHOI

PROJECT NO.: 18005


DRAWN BY: JAC

CHECKED BY: JAC

DATE: 02/01/19

SCALE: 02/01/19

C-4

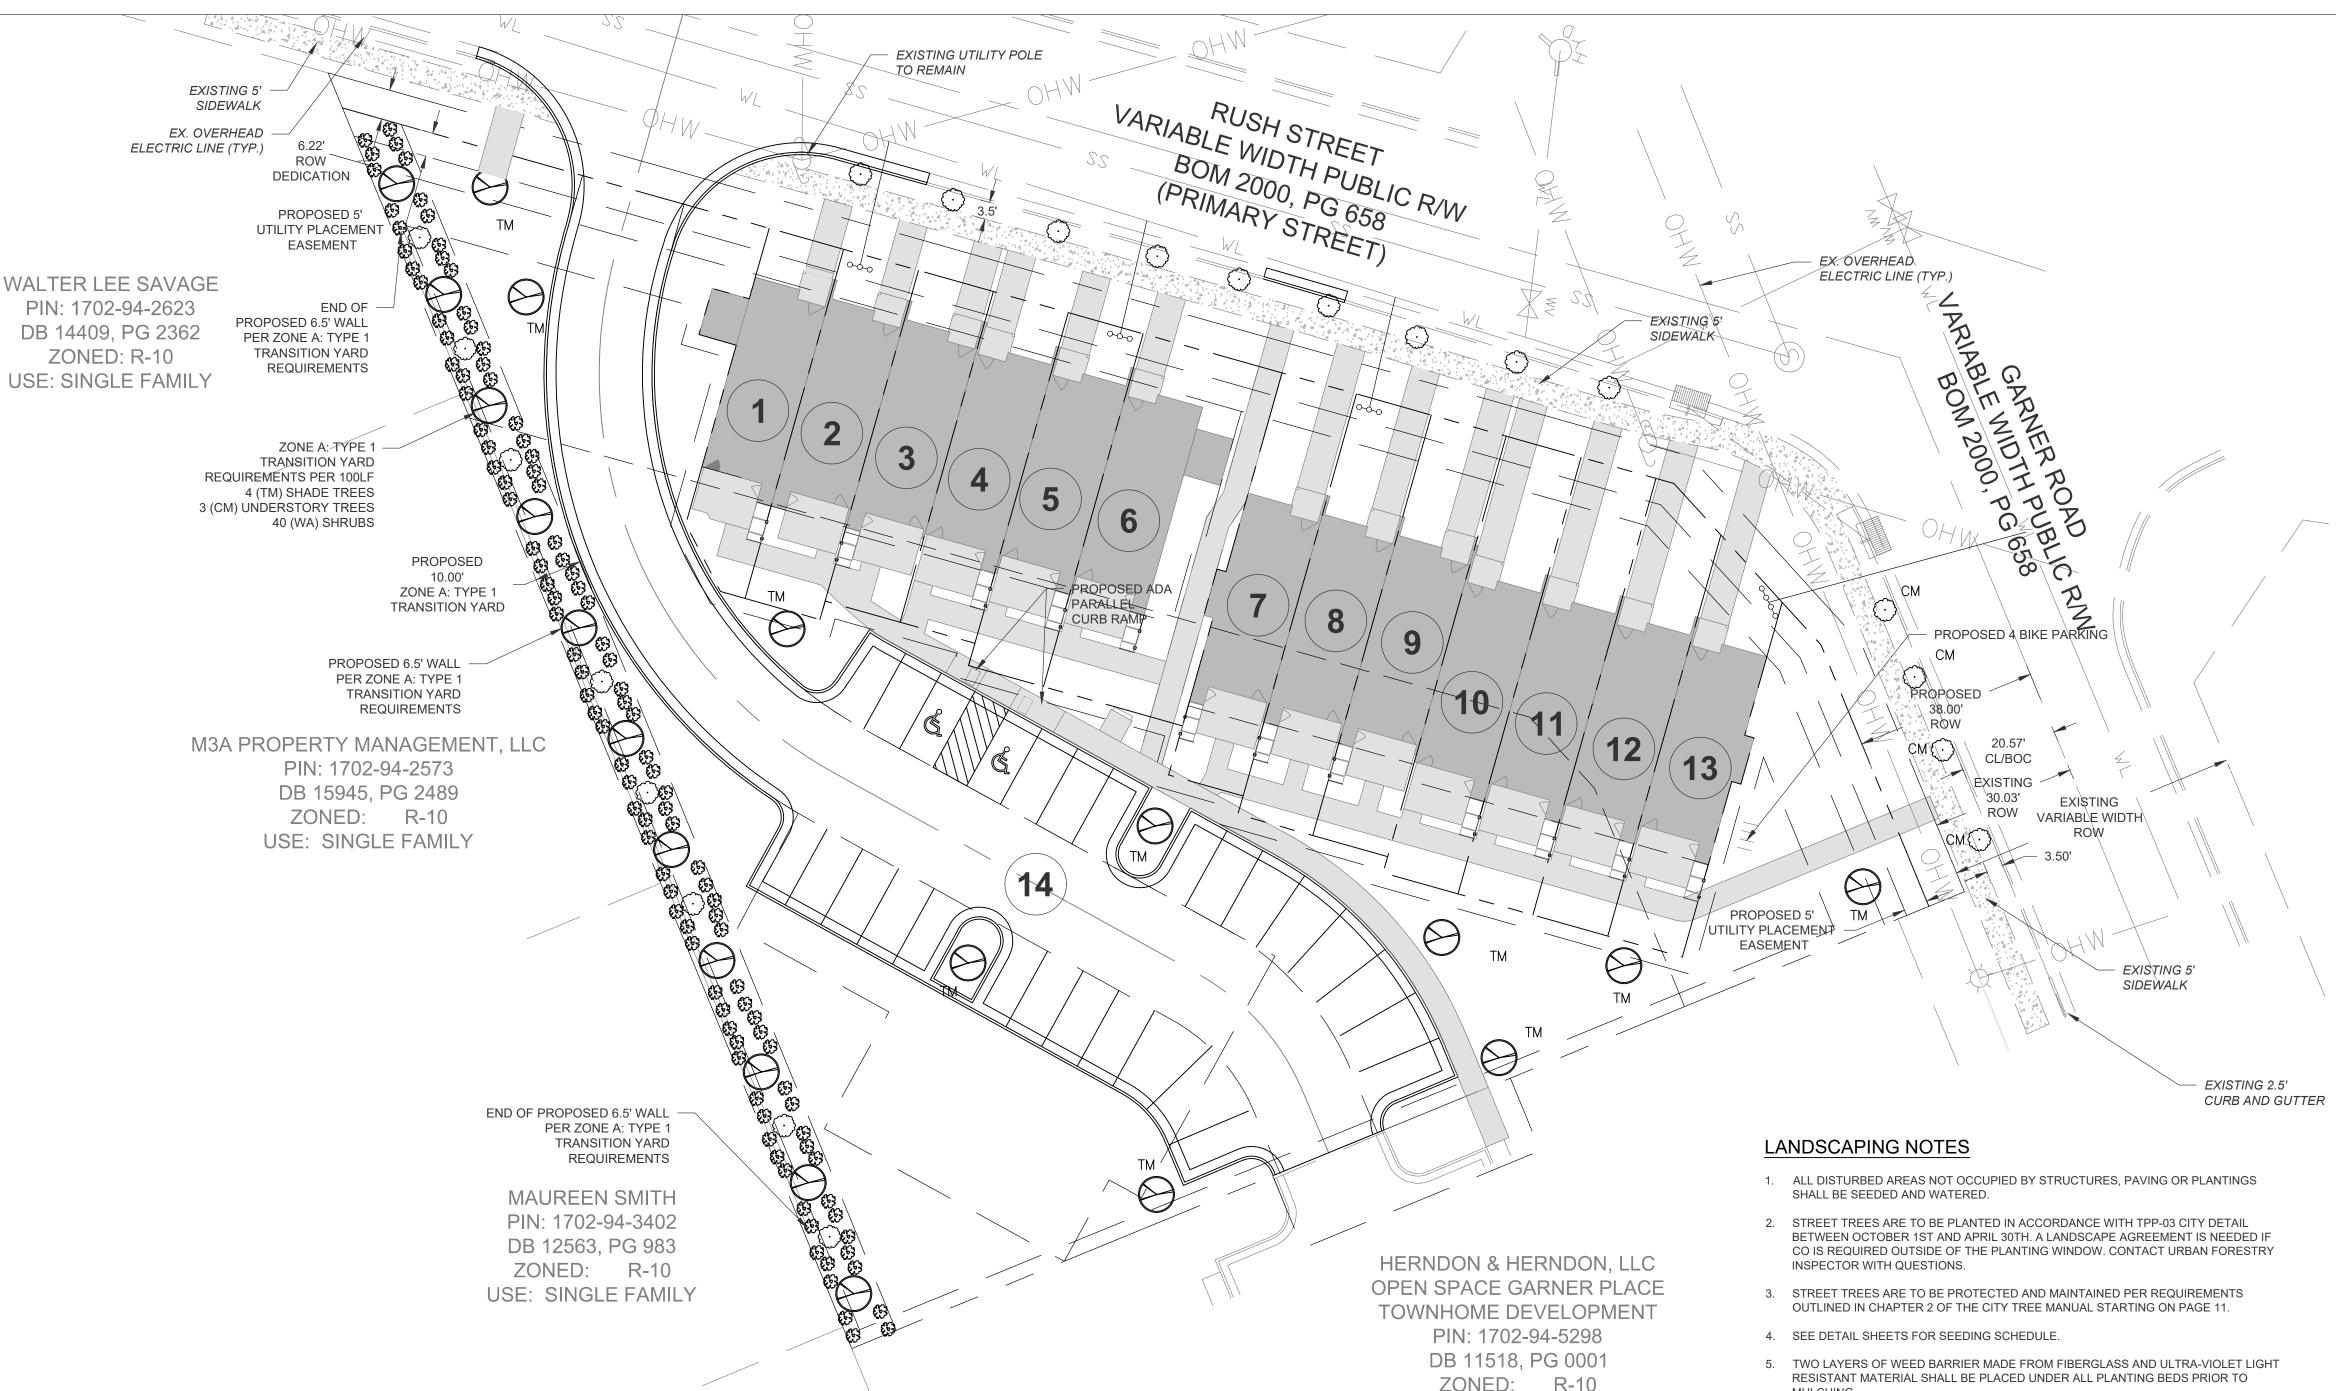

RODRIGO B. BEIZA

CARBAJAL GELACIA

PIN: 1702-94-3332

DB 14652, PG 1679

ZONED: R-10

USE: SINGLE FAMILY

18"

HEIGHT | SPREAD | ROOT | CALIPER |

B&B

5 GAL.

COMMON NAME

TRIDENT MAPLE

SINGLE STEM

CREPE MYRTLE

"COMANCHE"

WILD AZALEA

KEY QUA.

TM 21

20

CM

BOTANICAL NAME

SHADE TREES

ACER BUERGERIANUM

UNDERSTORY TREES

LAGERSTROEMIA SPP., L HYBRIDS

SHRUBS

WA 110 RHODODENDRON PERICLYMENOIDES

TREE CONSERVATION AND LANDSCAPING NOTES:

-THE SITE WILL BE CONFORMING TO THE EXEMPTION OF TREE CONSERVATION REQUIREMENTS THROUGH THE CITY OF RALEIGH'S UNIFIED DEVELOPMENT CODE SECTION 9.1.2 FOR PARCELS LESS THAN 2 ACRES IN SIZE.

USE: TOWNHOMES

-TREE IMPACT PERMIT IS REQUIRED PRIOR TO ISSUANCE OF BUILDING PERMIT TO PLANT TREES IN THE PUBLIC RIGHT OF WAY IF REQUIRED.

LANDSCAPING REQUIREMENTS

REQUIREMENT: 1 UNDERSTORY TREE PER 20LF=82LF/20LF=4 TREES PROVIDED: 4 TREES DUE TO OVERHEAD POWER LINE AND INTERSECTION

RUSH STREET REQUIREMENT: 1 UNDERSTORY TREE PER 20LF=294LF/40LF=15 TREES PROVIDED: 8 DUE TO OVERHEAD POWER LINE, STORM SEWER, AND ENTRANCE

PARKING LOT LANDSCAPING REQUIREMENT: 1 SHADE TREE PER ISLAND AND 1 PER 2,000 SF OF PARKING AREA PROVIDED: 6 SHADE TREES FOR 6 ISLANDS

11,001SF OF PARKING/2,000SF=5 SHADE TREES

PARKING LOT LANDSCAPING REQUIREMENT: 4 SHADE TREES, 3 UNDERSTORY TREES, AND 40 SHRUBS PER 100LF PROVIDED: 271.55LF/100LF=2.7 11 SHADE TREES 8 UNDERSTORY TREES

110 SHRUBS

- RESISTANT MATERIAL SHALL BE PLACED UNDER ALL PLANTING BEDS PRIOR TO
- 6. ALL TREE PLANTINGS SHALL BE MULCHED WITH 3" CLEAN, BARK MULCH.
- 7. A MINIMUM OF FOUR INDIVIDUAL SOIL SAMPLES SHALL BE TAKEN THROUGHOUT THE SITE FOR OVERALL SOIL ANALYSIS.
- 8. MINIMUM TOPSOIL DEPTH SHALL BE 4" IN LAWN AREAS AND 12" IN LANDSCAPED AREAS. CONTRACTOR TO UTILIZE ALL ONSITE TOPSOIL. CONTRACTOR SHALL SUPPLY ADDITIONAL TOPSOIL AT NO ADDITIONAL COST TO OWNER IF EXISTING
- TOPSOIL IS NOT SUFFICIENT TO MEET THE NEEDS OF THIS PROJECT. 9. ALL PLANTING AREAS TO RECEIVE 1 CY OF SOIL CONDITIONER FOR EACH 75 SF OF PLANT BED AREA. ACCEPTABLE SOIL CONDITIONERS SHALL BE PULVERIZED PINE BARK, PEAT MOSS OR SHREDDED/COMPOSTED LEAVES.
- 10. CONTRACTOR TO FIELD VERIFY LOCATION OF EXISTING UTILITIES BEFORE BEGINNING OF GRADING AND LANDSCAPE INSTALLATION.
- 11. CONTRACTOR TO VERIFY QUANTITIES OF PLANTINGS AS SHOWN. PLANTINGS INDICATED ON PLANS SHALL PREVAIL OVER QUANTITIES INDICATED IN PLANT LIST IF DISCREPANCIES ARISE.
- 12. ALL PLANTS ARE TO BE THOROUGHLY "WATERED IN" THE SAME DAY AS PLANTED. 13. TREES DESIGNATED B&B SHALL BE PROPERLY DUG WITH FIRM, NATURAL BALLS OF
- SOIL WITH BALL SIZE NOT LESS THAN DIAMETER AND DEPTH RECOMMENDED BY ANSI Z60.1 FOR TYPE AND SIZE OF TREE, RETAINING AS MANY FIBROUS ROOTS AS POSSIBLE. BALLS SHALL BE FIRMLY WRAPPED WITH BIODEGRADABLE BURLAP AND SECURED WITH NAILS AS RECOMMENDED BY ANSI Z60.1.
- 14. REMOVE BURLAP FROM TOP HALF OF ROOT BALL BEFORE BACKFILLING AROUND BALL IS COMPLETED.
- 15. ALL TREES, WHEN PLANTED, SHALL HAVE THE SAME RELATIONSHIP TO FINISHED GRADE AS TO THE GRADING PLAN.PLANTING HOLES SHALL BE NO DEEPER THAN THE ROOT FLARE OF THE TREE OR PLANT WHICH SHALL BE INSTALLED AT GRADE, A MAXIMUM OF 2 INCHES ABOVE GRADE, AND NEVER BELOW GRADE.
- 16. LANDSCAPING SHOWN MEETS CITY OF RALEIGH REQUIREMENTS.
- 17. ALL ADDITIONAL LANDSCAPING SHALL BE PER OWNER.
- 18. ALL LANDSCAPING SHALL BE GUARANTEED FOR ONE (1) YEAR AFTER FINAL ACCEPTANCE. ANY PLANTINGS NEEDING REPLACEMENT WILL BE GUARANTEED FROM THE TIME OF REPLACEMENT IF AFTER FINAL ACCEPTANCE.
- 19. UTILITY SERVICE AREAS LOCATED OUTSIDE OF THE PUBLIC RIGHT-OF-WAY THAT EXCEED 42 INCHES IN HEIGHT AND 42 INCHES IN ANY OTHER DIMENSION MUST BE SCREENED FROM THE PUBLIC RIGHT-OF-WAY AS REQUIRED BY UDO SEC. 7.2.5.E.
- 20. MECHANICAL EQUIPMENT MUST ADHERE TO THE SCREENING REQUIREMENTS OF UDO SEC. 7.2.5.D.1 THROUGH 7.2.5.D.4.

LEGEND

EXISTING PROPERTY LINE ---- ---- EXISTING ABUTTING PROPERTY LINE EXISTING RIGHT-OF-WAY EXISTING OVERHEAD POWER LINE —— OHW——— OHW—— EXISTING ABUTTING PROPERTY LINE EXISTING BUILDING SETBACK LINE EXISTING PARKING SETBACK LINE EXISTING EDGE OF PAVEMENT EXISTING SANITARY SEWER — PROPOSED LOT LINE PROPOSED EASEMENT LINE PROPOSED SETBACK LINE ---- PROPOSED BUILD-TO PROPOSED CONCRETE SIDEWALK

PLANTING REQUIREMENTS

A. PROVIDE A STRUCTURAL PLANTING SOIL USING THE TWO COMPONENTS LISTED BELOW THAT

- MEET ASTM STANDARDS AS FOLLOWS: 1. 3/4" EXPANDED SLATE 80%
- 2. SANDY CLAY LOAM 20%

IN ADDITION TO THE NATURAL SETTLING PROCESS.

- 3. PERCENTAGES OF SAND AND CLAY MAY VARY TO MEET TEST REQUIREMENTS. B. COMPACTION: WHEN CALCULATING THE VOLUME NECESSARY FOR THE PROJECT, ADD CALCULATED VOLUME TO ALLOW FOR COMPACTION APPROXIMATELY 18% TO THE
- 1.2 STRUCTURAL SOIL COMPONENTS:
- A. SIZE 3/4" ROTARY KILN EXPANDED SLATE 1. ONLY NON-HAZARDOUS FUELS SUCH AS COAL OR NATURAL GAS MAY BE USED TO PROCESS

WHICH OCCURS DURING INSTALLATION DUE TO DRIVING SMALL EQUIPMENT OVER THE PRODUCT,

- 2. UNIT DRY WEIGHT LOOSE: 48 LB./C.F. TO 55 LB./C.F. (ASTM C29)(SATURATED SURFACE
- LOOSE: 55 LBS./C.F. TO 60 LBS./C.F.) 3. SPECIFIC GRAVITY: 1.45 TO 1.60, DRY BULK (ASTM C127)
- 4. GRADATION: 3/4" #4 SIZE

SIEVE SIZE % PASSING

- 5. TEST FOR DEGRADATION LOSS USING LOS ANGELES ABRASION TESTING IN ACCORDANCE WITH ASTM C-131 MODIFIED METHOD FM 1-T096. NO MORE THAN 28% OF THE WEIGHT OF THE AGGREGATE MUST BE LOST TO DEGRADATION.
- B. SANDY CLAY LOAM: SANDY CLAY LOAM IS FOR MIXING WITH STRUCTURAL SOIL ONLY AND NOT TO BE CONFUSED WITH "PLANTING SOIL"
- 40 65% SAND
- 15 25% SILT 20 - 35% CLAY
- 2 5 % ORGANIC MATTER


3.0 PREPARATION:

- 1. STRUCTURAL SOIL IS SHOWN IN A PUBLIC RIGHT-OF-WAY OR EASEMENT. OBTAIN APPROVALS FROM PROPER AUTHORITIES BEFORE AND AFTER PLACING STRUCTURAL SOIL 2. ACHIEVE 90% OF MAXIMUM DRY DENSITY FOR THE SUBGRADE. (ASTM D698)
- B. PREPARING SUBGRADE:
- THE SUBGRADE SHALL BE PREPARED ACCORDING TO THE FOLLOWING PROCEDURE REMOVE ALL ORGANIC MATTER, DEBRIS, LOOSE MATERIAL AND LARGE ROCKS.
- 2. DIG OUT SOFT AND MUCKY SPOTS AND REPLACE WITH SUITABLE MATERIAL. 3. LOOSEN HARD SPOTS; UNIFORMLY COMPACT SUBGRADE TO 95% OF ITS MAXIMUM DRY
- C. PERFORATED UNDERDRAIN SYSTEM (IF USED): 1. INSTALL UNDER DRAIN SYSTEM, WITH SOCK OR SOIL SEPARATOR FABRIC, ACCORDING TO DRAWINGS AND CONNECTED TO STORM DRAIN.

3.3 INSTALLATION OF STRUCTURAL SOIL MIX: A. GENERAL

- 1. INSTALL THE SOIL DRAINS ENSURING THE STRUCTURAL SOIL IS PROPERLY COMPACTED UNDER AND AROUND EACH PIPE.
- 2. CONSIDER USING ROOT BARRIERS IF IT IS DESIRED TO AVOID ROOT PENETRATION INTO ADJACENT UTILITIES.
- B. PLACING AND COMPACTING STRUCTURAL SOIL:
- 1. PLACE STRUCTURAL SOIL MIX IN HORIZONTAL LIFTS NOT EXCEEDING 12 INCHES DEPTH. COMPACT USING A VIBRATORY PLATE COMPACTING MACHINE. PERFORM A MINIMUM OF TWO PASSES, OF NOT LESS THAN SECONDS PER PASS, BEFORE MOVING THE VIBRATORY PLATE TO THE NEXT ADJACENT LOCATION. ADDITIONAL PASSES MAY BE REQUIRED SHOULD THE FIELD ENGINEER DETERMINE ADDITIONAL COMPACTION IS NECESSARY TO INSURE STABILITY OF THE LAYER. CONTINUE PLACING AND COMPACTING 12 INCH LIFTS UNTIL THE SPECIFIED DEPTH IS REACHED.
- 2. FOR LARGE SPACES, A VIBRATORY STEEL ROLLER WEIGHING NO MORE THAN 12 TONS STATIC WEIGHT CAN BE USED. HORIZONTAL LIFTS SHOULD NOT EXCEED 12 INCHES COMPACTED. THE MINIMUM NUMBER OF PASSES IS TWO AND MAXIMUM NUMBER IS FOUR. ADDITIONAL PASSES MAY BE REQUIRED SHOULD THE FIELD ENGINEER DETERMINE ADDITIONAL COMPACTION IS NECESSARY TO INSURE STABILITY OF THE LAYER.

- 1. TOPOGRAPHIC AND BOUNDARY SURVEY PROVIDED BY TURNING POINT SURVEYING, PLLC, DATED 12/05/17.
- 2. PROPERTY IS LOCATED IN ZONES X (AREA DETERMINED TO BE OUTSIDE THE O.2% ANNUAL CHANCE AND FUTURE 1% ANNUAL CHANCE FLOODPLAIN) BASED ON THE FEMA MAP NUMBER 3720170200J DATED MAY 2. 2006.
- 3. NO ONSITE STREAMS OR WETLANDS HAVE BEEN IDENTIFIED WITHIN THE PROJECT OR PARCEL AS SHOWN.
- 4. THIS DRAWING IS NOT FOR RECORDATION.

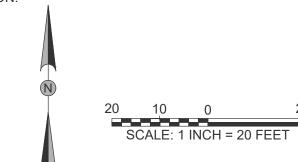


ISSUED FOR PERMITTING

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ANDS Ш

PROJECT NO.: 18005 DRAWN BY: JAC CHECKED BY: JAC

1" = 20' SCALE:

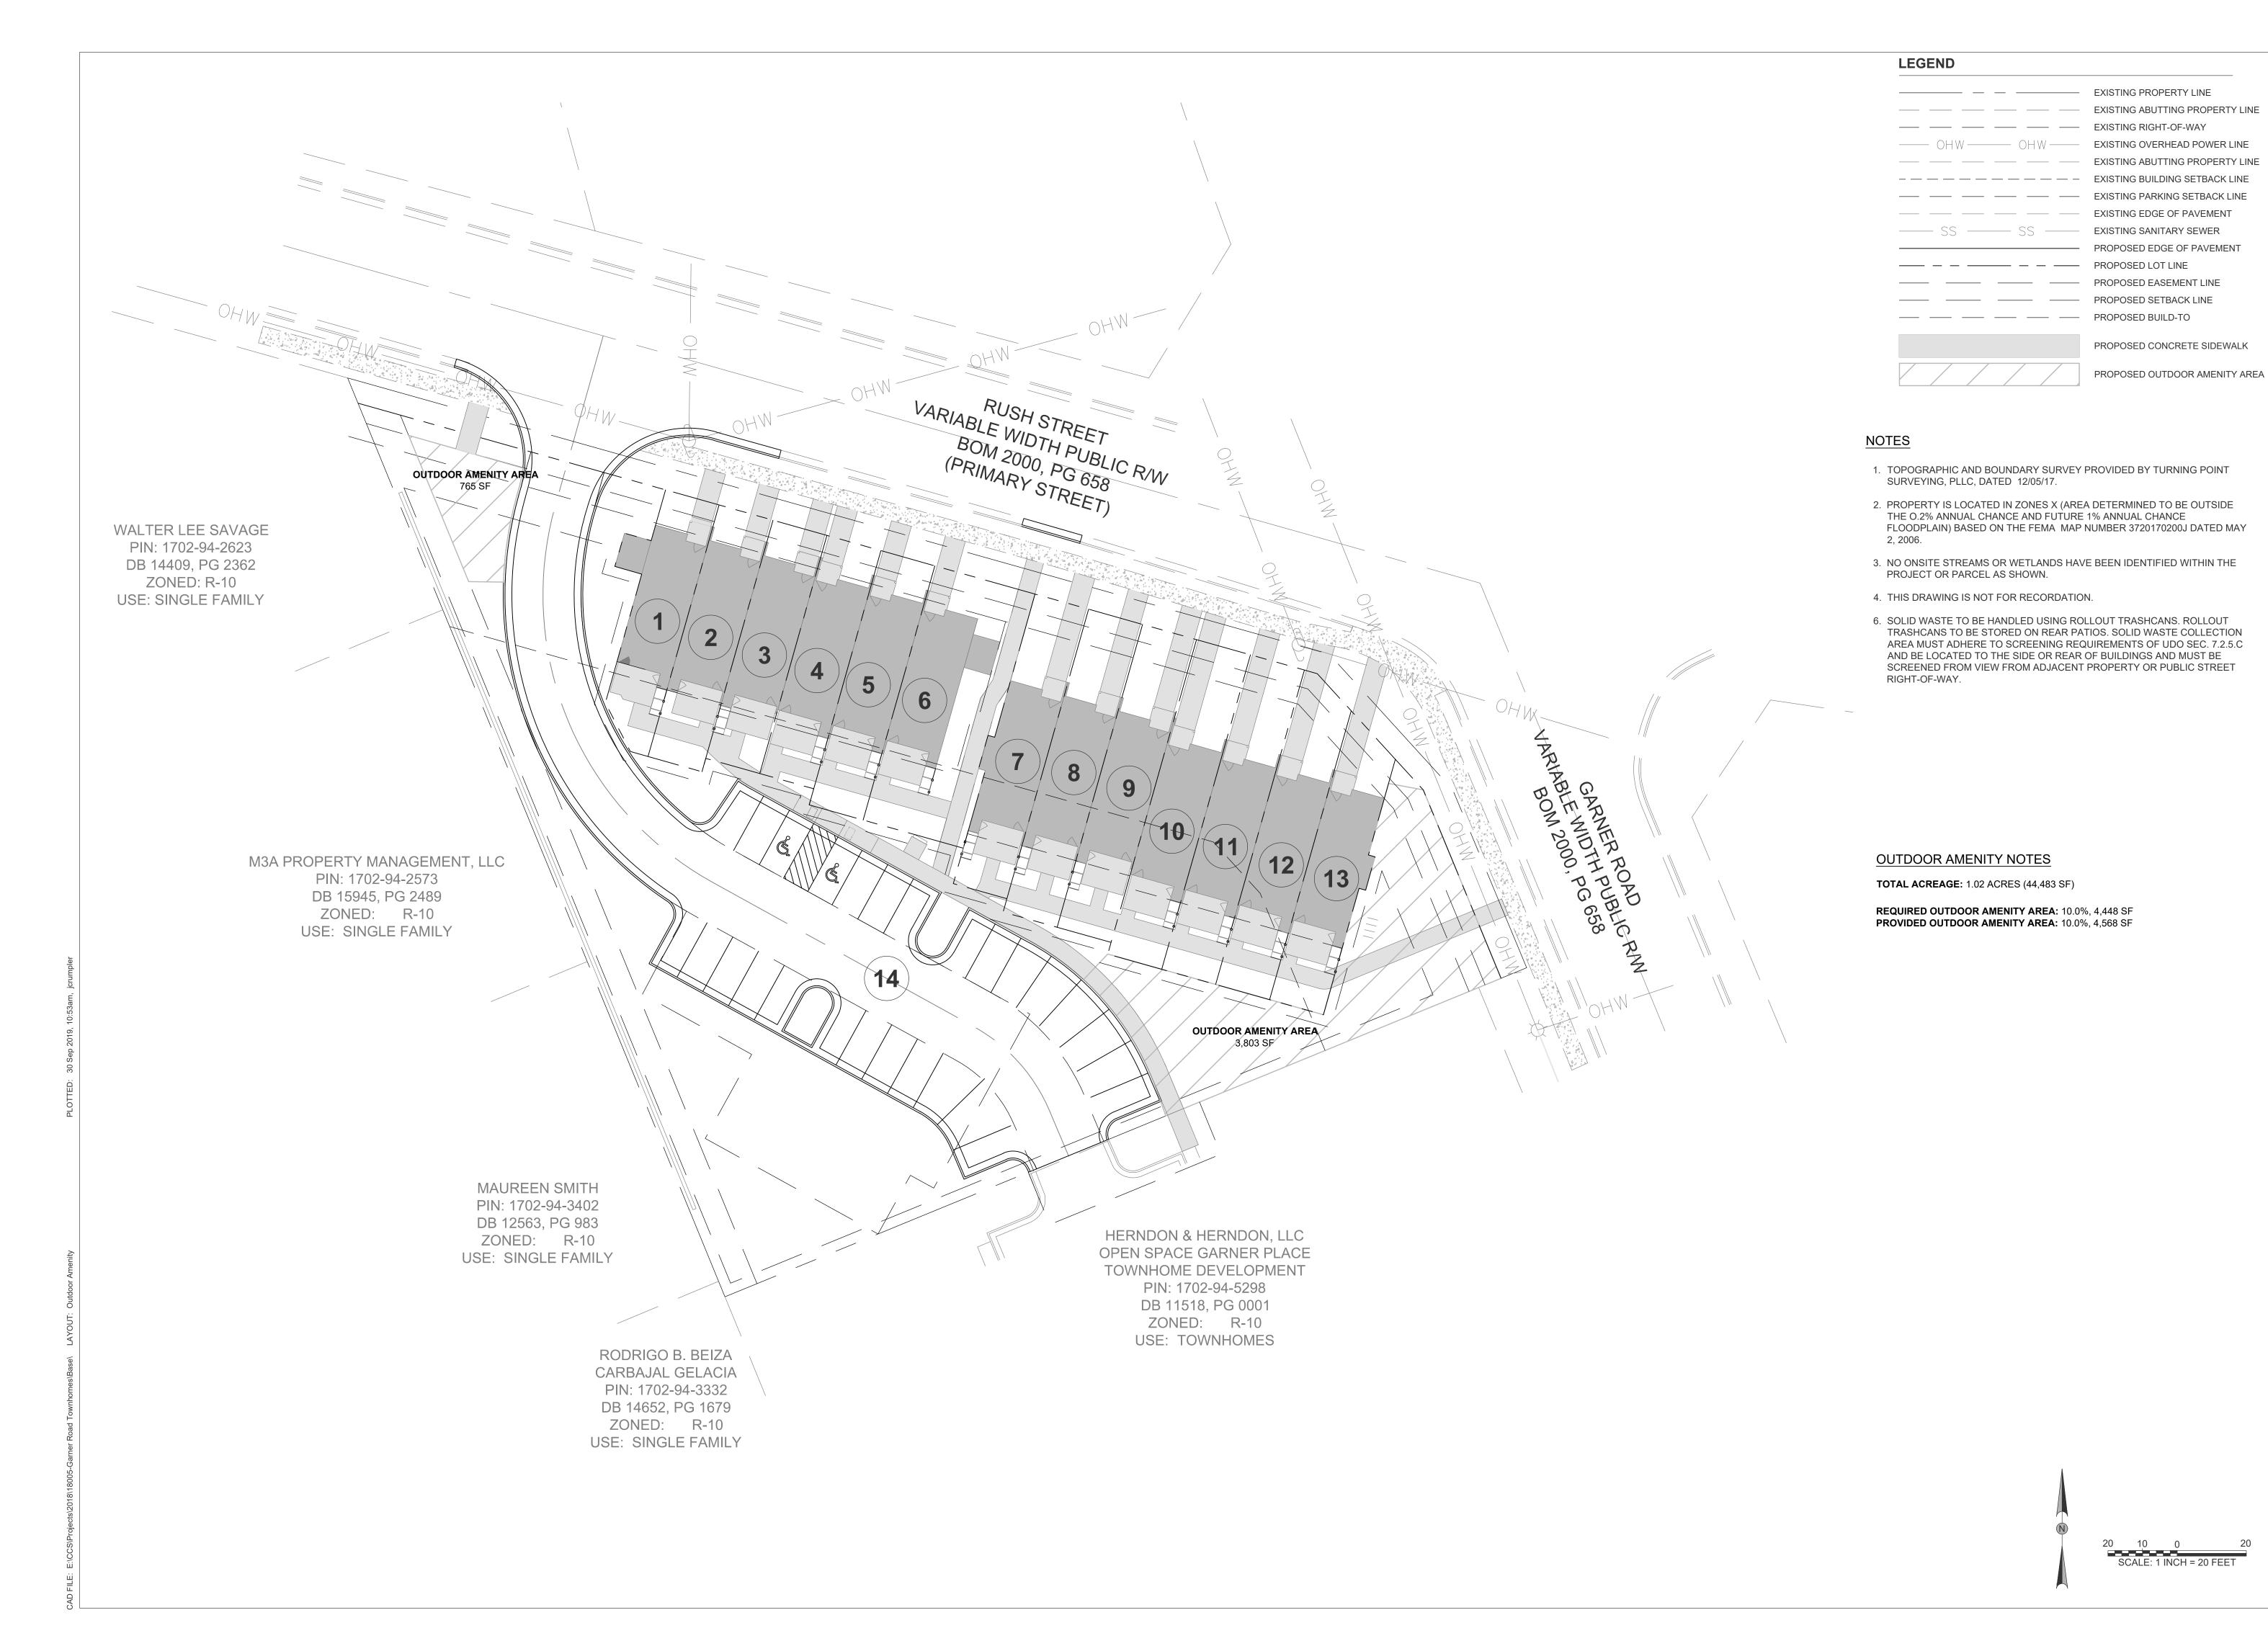

IMPLER

g Services, PLLC

2308 Ridge Road
leigh, North Carolina 27612
Ph. 940-413-1704

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CITY OF RALEIGH COMMENTS

O9/26/19

CITY OF RALEIGH COMMENTS

O9/30/19

OUTDOOR AMENITY PLAN
GARNER ROAD TOWNHOMES

7 2 8 4 A

PROJECT NO.: 18005

DRAWN BY: JAC


CHECKED BY: JAC

DATE: 02/01/19

DATE: 02/01/19

SCALE: 1" = 20'

C-7

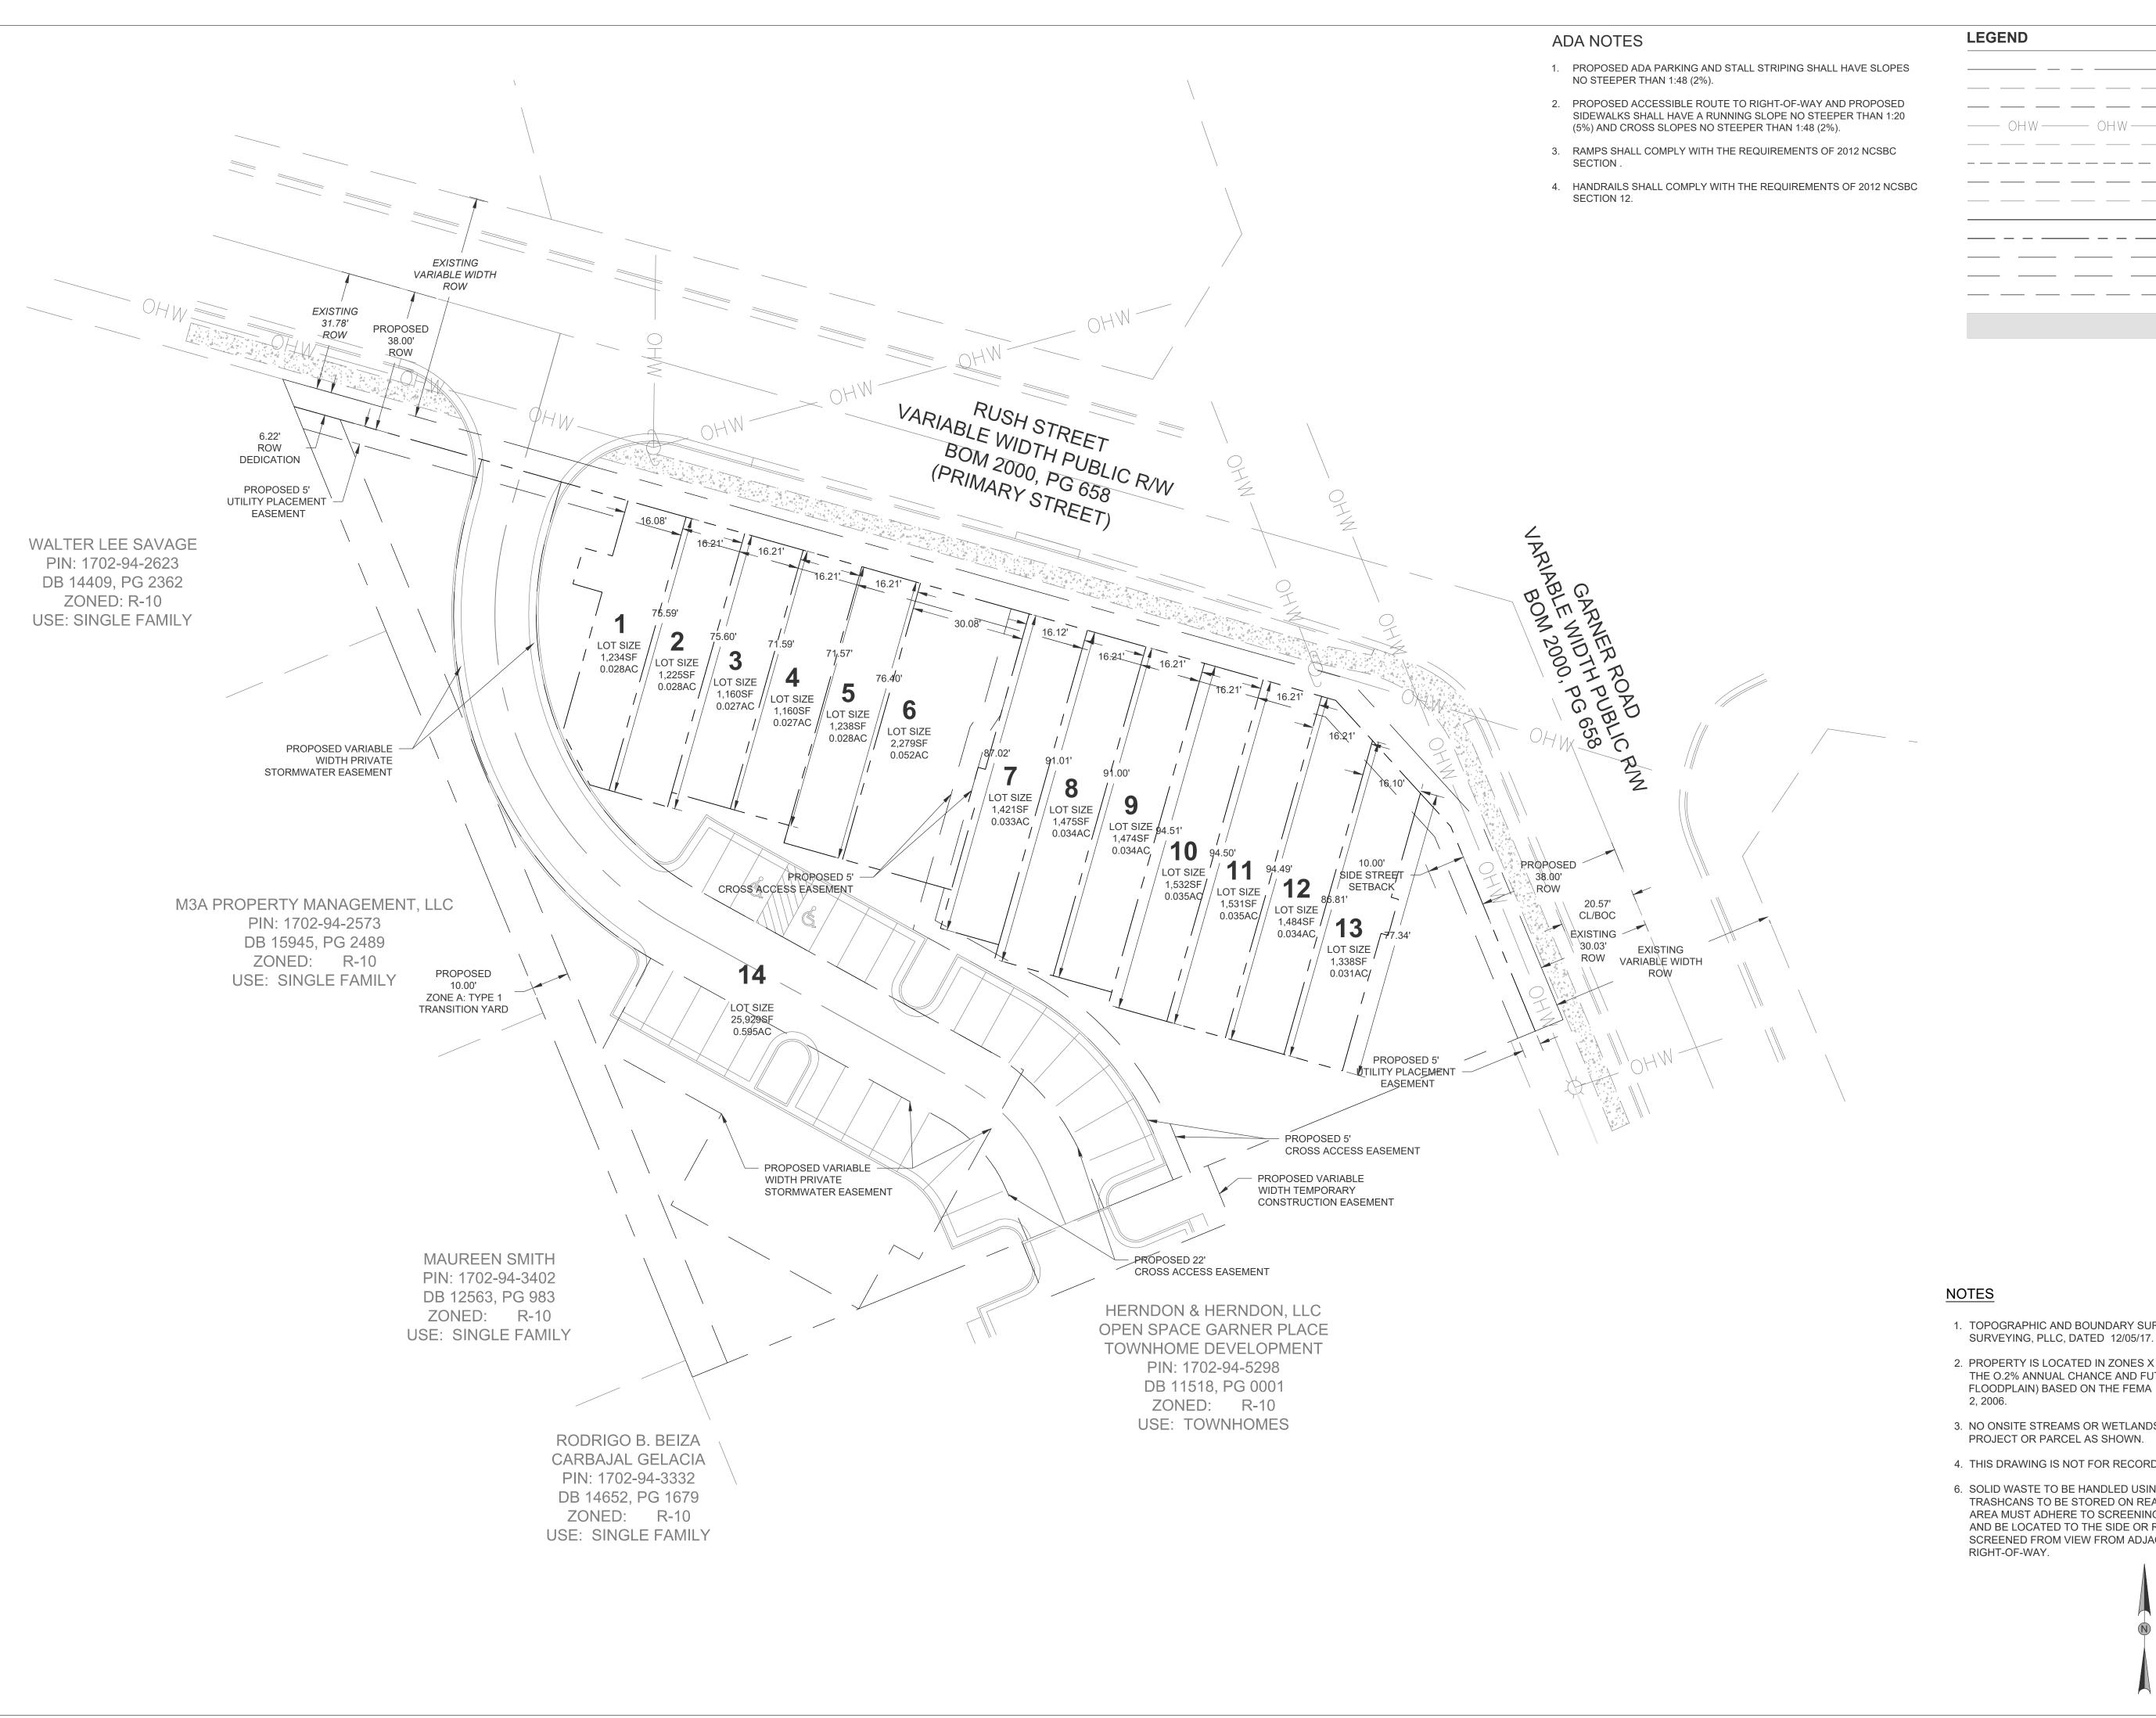

EXISTING ABUTTING PROPERTY LINE EXISTING RIGHT-OF-WAY

EXISTING OVERHEAD POWER LINE EXISTING BUILDING SETBACK LINE EXISTING PARKING SETBACK LINE EXISTING EDGE OF PAVEMENT PROPOSED EDGE OF PAVEMENT — — PROPOSED LOT LINE PROPOSED EASEMENT LINE

PROPOSED CONCRETE SIDEWALK

PROPOSED SETBACK LINE

PROPOSED BUILD-TO


ISSUED FOR PERMITTING

| 5 | 5 | 5 | 5

LOT ARNER

1. TOPOGRAPHIC AND BOUNDARY SURVEY PROVIDED BY TURNING POINT

- 2. PROPERTY IS LOCATED IN ZONES X (AREA DETERMINED TO BE OUTSIDE THE O.2% ANNUAL CHANCE AND FUTURE 1% ANNUAL CHANCE FLOODPLAIN) BASED ON THE FEMA MAP NUMBER 3720170200J DATED MAY
- 3. NO ONSITE STREAMS OR WETLANDS HAVE BEEN IDENTIFIED WITHIN THE PROJECT OR PARCEL AS SHOWN.
- 4. THIS DRAWING IS NOT FOR RECORDATION.
- 6. SOLID WASTE TO BE HANDLED USING ROLLOUT TRASHCANS. ROLLOUT TRASHCANS TO BE STORED ON REAR PATIOS. SOLID WASTE COLLECTION AREA MUST ADHERE TO SCREENING REQUIREMENTS OF UDO SEC. 7.2.5.C AND BE LOCATED TO THE SIDE OR REAR OF BUILDINGS AND MUST BE SCREENED FROM VIEW FROM ADJACENT PROPERTY OR PUBLIC STREET

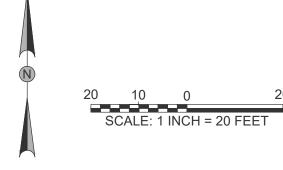

PROJECT NO.: 18005 DRAWN BY: JAC

CHECKED BY: JAC 02/01/19

SCALE: 1" = 20'

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