

## RALEIGH, WAKE COUNTY NORTH CAROLINA

# CRABTREE CREEK GREENWAY LASSITER MILL

TYPE OF WORK: GRADING, PAVING, STRUCTURE, DRAINAGÉ, & EROSION CONTROL

CITY OF RALEIGH #: SPR-0081-2025 TIP# BL-0027 WBS# 49611.3.1 FEDERAL AID# 0520129

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CHEET NO

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### Public Improvement Quantities

PHASE NUMBER(S)	PHASE 1	PHASE 2	PHASE 3
NUMBER OF LOTS(S)			
LOT NUMBER(S) BY PHASE			
NUMBER OF UNITS			
LIVABLE BUILDINGS			
OPEN SPACE?			
NUMBER OF OPEN SPACE LOTS			
PUBLIC WATER (LF)			
PRIVATE WATER* (LF)			
PUBLIC SEWER (LF)			
PUBLIC FORCE MAIN (LF)			
PRIVATE SEWER** (LF)			
PUBLIC STREET (LF) - FULL			
PUBLIC STREET (LF) - PARTIAL			
PUBLIC SIDEWALK (LF) - FULL			
PUBLIC SIDEWALK (LF) - PARTIAL			
MULTI-USE PATH*** (LF)	2,165 LF		
PUBLIC STORMDRAIN (LF)			
STREET SIGNS (LF)			
WATER SERVICE STUBS	1		
SEWER SERVICE STUBS			
AVERAGE DAILY FLOW PER PHASE****			

oject Flow. Sased on 75gpd per bedroom for residential (Apartments, single Family dwelling,

RETAINING WALL SUMMARY					
Wall ID	Low Point Elevation	High Point Elevation	Sheet#		
RW1	217.5	231	5		
RW3	202	207.9	9		

	FENCE SUMMARY							
Fence Type	Plan Sheet	Length	Detail Sheet	Detail No.				
Safety Rail	4	85'	2B-3	01				
Safety Rail	5	273'	2B-3	01				
Safety Rail	9	134'	2B-3	01				
White Vinyl Fence	9	135'	2B-3	02				

### TRAFFIC CONTROL AND PEDESTRIAN PLAN (TCPED) NOTES:

- PRIOR TO ANY WORK THAT IMPACTS THE RIGHT-OF-WAY, CLOSING OR DETOURING OF ANY STREET, LANE, OR SIDEWALK, THE CONTRACTOR WILLIAM STREET, LANE, OR SIDEWALK, THE CONTRACTOR WILLIAM STREET, LANE, OR SIDEWALK, THE CONTRACTOR WILLIAM STREET, LANE, OR SIDEWALK, THE CONTRACTOR STREET, LANE, DISTORDING THE STREET OF STREET, LANE, DISTORDING THE STREET WITHIN RAREGYS TO THE STREET WORK THE CONTRACTOR STREET WITHIN RAREGYS TO THE STREET WORK THE CONTRACTOR STREET WITHIN RAREGYS TO THE STREET WORK THE CONTRACTOR WITHIN THE RECEIVERING INSPECTIONS PROFESSION STREET WITHIN THE RECEIVER WITHIN THE STREET WITHIN THE RECEIVER WITHIN THE STREET WITHIN THE RECEIVER WITHIN THE STREET WITHIN THE PROFESSION OF WITHIN THE WITHIN THE STREET WITHIN THE PROFESSION OF WITHIN THE WITHIN THE
- UNIFORM TRAFFIC CONTROL DEVICES (MUTCD).
  ALL PERMITS MUST BE AVAILABLE AND VISIBLE ON SITE DURING THE
  OPERATION

#### **Project Data Sheet**

This form must be completed and applied to the cover shee of drawings submitted with a Non-Residential building permit associated with a Site Permit Review, or permits for in apartment, office, and/or commercial uses.

				GENERAL IN	ORM	ATION			
Development Name: Crabtree Creek Greenway					Proposed Use: Greenway and Multi-use Path				
Property Addre	99(69	:Lassiter M	ill Ro	d, Hertford St, Crab	otree	Creek			
Approval Site	Dian .	ne Rodellivision i	nasa i						
Wake County	Prope	erty Identification	on Nu	imber(s) (PIN) for eac	th par	cel to which these guid	lelines	s will apply:	
PIN#:N/A		PIN#: N/A		PIN	PIN#: N/A		PIN #: N/A		
What is the project type?		Apartment		Bank		Congregate care		Hospital	
		Hotel/Motel		Industrial building		Mixed residential		Non-residential cond-	
		Office		Religious institution		Residential condo		Retail	
		School		Shopping center		Single-family residential		Teleconmunication tower	
		Townhouse		Civic use: Park, community center, museum or government facility		<b>V</b>	Other		

Grading, Paving, Drainage, Pavement Marking, Signing, Erosion Control, & Stream Resto

FOR APARTMENTS, C	ONDOS, AND TOWNH	OMES ONLY			
Total number of townhouse lots:	Number attached:	Number detached:			
2. Total number of apartment or condominium usits:					
3. Total number of Congregate Care or Life Cary Dw	elling units:				
4. Overall total number of dwelling units (from 13 ab	ove):				
<ol> <li>Number of bedroom units: 1BR: 28</li> </ol>	R: 3BR:	4BR or more:			
6. Overall unit(s) per acre densities per zoning ristric	t(s):				
DEVELOPMENT TYPE AND STE I	DATA TABLE (applicat	le to all developments)			
Zoning Information		Building Information			
Zoning district(s): R-4	Proposed use of	Proposed use of building(s):			
If more than one district, provide acreage of each:	Proposed sq. ft. o	Proposed sq. ft. of building(s) gross:			
Overlay district(s):	Existing sq. ft. of	Existing sq. ft. of building(s) gross:			
Total site acreage: 3.12 ac	Total sq. ft. gross	Total sq. ft. gross (existing and proposed):			
Off street parking: Required: Provider:	Proposed height	Proposed height of building(s):			
COA (Certificate of Appropriateness) case #:	FAR (floor area n	FAR (floor area ratio) %:			
BOA (Board of Adjustment) case # A -	Building lot cover	Building lot coverage %:			
CUD (Conditional Use District) case # Z -	Inside City Limits	7 Yes No			
			REVISION 11.16.		

THE WORK INCLUDED IN THIS SPR-0081-2025 WAS MODELED IN **LOCAL FLOOD STUDY FS 799.** 



621 Hillsborough Street Suite 500 Raleigh, NC 27603

PROJECT LENGTH

LENGTH OF CONCRETE = 0.19 MILES

LENGTH OF BOARDWALK = 0.09 MILES TOTAL LENGTH OF PROJECT = 0.41 MILES

LENGTH OF ASPHALT = 0.13 MILES

phone 919. 361. 5000 fax 919. 361. 2269 license number: C-0293, C-187

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METHOD OF GRADING: CLEARING ON THIS PROJECT SHALL BE TO LIMITS ESTABLISHED USING METHOD II.

PARKS, RECREATION, AND CULTURAL RESOURCES
RALEIGH MUNICIPAL BUILDING 222 W. HARGETT STREET SUITE 600 RALEIGH, NC 27601

**DESIGN DATA** 

DESIGN SPEED = 10 MPH

LEAN ANGLE = 20 DEGREES FUNC. CLASSIFICATION = TRANSPORTATION

REVISIONS

GRAPHIC SCALE

HORIZONTAL

BEGIN PROJECT L1 12+80.00

-STREAMBANK STABILIZATION

-BOARDWALK 1

RETAINING WALL 1



RETAINING WALL 3-

END PROJECT L4 56+05.83-

**GRAPHIC SCALES** 

PROFILE (HORIZONTAL)

HYDRAULICS ENGINEER

GRAPHIC SCALE

PROFILE (VERTICAL)

## CRABTREE CREEK GREENWAY BL-0027 LASSITER MILL

LASSITER MILL ROAD TO HERTFORD STREET

PLAN INFORMATION PROJECT NO. RAL-18000

FILENAME RAL18000\_CS.dwg CHECKED BY AH DRAWN BY GDB SCALE NTS DATE 08/28/2025 CITY FILE NO. SPR-0081-2025

### STATE OF NORTH CAROLINA, DIVISION OF HIGHWAYS

# CONVENTIONAL PLAN SHEET SYMBOLS Note: Not to Scale \*S.U.E. = Subsurface Utility Engineering **BOUNDARIES AND PROPERTY:**

BOUNDARIES AND PROPERTY:	RAILROADS: Note: Not to Sca	ale *S.	U.E. = Subsurface Utility Engineering		WATER:	
State Line					Water Manhole —————	<b>©</b>
County Line		CSX TRANSPORTATION	Hedge —	-0.0.0.0.0.0.0	Water Meter	. 0
Township Line	RR Signal Milepost	MILEPOST 35	Woods Line		Water Valve	⊗
City Line	Switch —	SWITCH	Orchard —	0000	Water Hydrant	•
Reservation Line	RR Abandoned		Vineyard —	Vineyard	U/G Water Line LOS B (S.U.E*)	
Property Line — — — —	RR Dismantled		EXISTING STRUCTURES:		, ,	
Existing Iron Pin			MAJOR:		U/G Water Line LOS D (S.U.E*)	
Computed Property Corner — — — — — — — — — — — — — — — — — — —	RIGHT OF WAY & PROJECT CON	VTROL:	Bridge, Tunnel or Box Culvert	CONC	Above Ground Water Line	A/G Woter
Property Monument	Secondary Horiz and Vert Control Point	$\Diamond$	Bridge Wing Wall, Head Wall and End Wall -	CONC WW (	Above Ground Water Line	
Parcel/Sequence Number — (23)	Primary Horiz Control Point —	0	MINOR:		TV:	· [C]
Existing Fence Line ————————————————————————————————————	Primary Horiz and Vert Control Point ———	0	Head and End Wall	CONC HM	TV Pedestal	· × ×
Proposed Woven Wire Fence	Exist Permanent Easment Pin and Cap ———	$\Diamond$	Pipe Culvert		TV Tower —	· •
Proposed Chain Link Fence	New Permanent Easement Pin and Cap —		Footbridge	<b></b>	U/G TV Cable Hand Hole	
Proposed Barbed Wire Fence	Vertical Benchmark ————	$\boxtimes$	Drainage Box: Catch Basin, DI or JB	СВ	G 77 CUDIO 200 B (0.0.2.)	tv —
Existing Wetland Boundary	Existing Right of Way Marker —	$\triangle$	Paved Ditch Gutter		do 17 cable LOS C (5.0.L.)	
Proposed Wetland Boundary	Existing Right of Way Line		Storm Sewer Manhole —	(S)	GO IV Cubie LOS D (S.O.L.)	тү
	New Right of Way Line	<del></del>	Storm Sewer	s	U/G Fiber Optic Cable LOS B (S.U.E.*)	
Existing Endangered Animal Boundary ————————————————————————————————————	New Right of Way Line with Pin and Cap—	<u> </u>	Y MANY TOWNS		U/G Fiber Optic Cable LOS C (S.U.E.*)	
Existing Endangered Plant Boundary	,	<del></del>	UTILITIES:		U/G Fiber Optic Cable LOS D (S.U.E.*)	
Existing Historic Property Boundary	New Right of Way Line with  Concrete or Granite RW Marker	<del></del>	POWER:		GAS:	
Known Contamination Area: Soil ————————————————————————————————————	New Control of Access Line with	• •	Existing Power Pole ——————	•	Gas Valve	. ♦
Potential Contamination Area: Soil ————————————————————————————————————	Concrete C/A Marker	<del></del>	Proposed Power Pole	Ģ	Gas Meter ———————————————————————————————————	φ
Known Contamination Area: Water ————————————————————————————————————	Existing Control of Access	<del>(§)</del>	Existing Joint Use Pole	<u>+</u>	U/G Gas Line LOS B (S.U.E.*)	
Potential Contamination Area: Water ————————————————————————————————————	New Control of Access	<del></del>	Proposed Joint Use Pole	- <b>ò</b> -	U/G Gas Line LOS C (S.U.E.*)	
Contaminated Site: Known or Potential — 💥 🏋	Existing Easement Line	——E——	Power Manhole —	®	U/G Gas Line LOS D (S.U.E.*)	
BUILDINGS AND OTHER CULTURE:	New Temporary Construction Easement -	Е	Power Line Tower —	$\boxtimes$	Above Ground Gas Line	A/G Gos
Gas Pump Vent or U/G Tank Cap — O	New Temporary Drainage Easement	TDE	Power Transformer —	<b>Ø</b>		
Sign ————	New Permanent Drainage Easement —	PDF	U/G Power Cable Hand Hole —		SANITARY SEWER:	
Well	New Permanent Drainage / Utility Easement	—— DUE——	H-Frame Pole	••	Sanitary Sewer Manhole	●
Small Mine - 🔆	New Permanent Utility Easement	DOE-	U/G Power Line LOS B (S.U.E.*)		Sanitary Sewer Cleanout	•
Foundation —	New Temporary Utility Easement	TUE	U/G Power Line LOS C (S.U.E.*)		U/G Sanitary Sewer Line ————————————————————————————————————	
Area Outline	New Aerial Utility Easement	ALIF	U/G Power Line LOS D (S.U.E.*)		Above Ground Sanitary Sewer —	
Cemetery	Now Period Climy Edderhein	AOE-	TELEPHONE:		SS Forced Main Line LOS B (S.U.E.*) ———	rss
Building —	ROADS AND RELATED FEATURE	ç.			SS Forced Main Line LOS C (S.U.E.*) ———	
School —	Existing Edge of Pavement		Existing Telephone Pole		SS Forced Main Line LOS D (S.U.E.*)	F\$S
Church —	Existing Curb		Proposed Telephone Pole ————	-0-		
Dam —	•	c_	Telephone Manhole	⊕	MISCELLANEOUS:	
HYDROLOGY:	. roposou oropo oranos ou	<u>F</u>	Telephone Pedestal —————		Utility Pole ————————————————————————————————————	•
Stream or Body of Water —		(R)	Telephone Cell Tower	,Ā,	Utility Pole with Base —	
Hydro, Pool or Reservoir	Proposed Curb Ramp	CR)	U/G Telephone Cable Hand Hole	H <sub>H</sub>	Utility Located Object —————	⊙
Jurisdictional Stream	Existing Metal Godfardii		U/G Telephone Cable LOS B (S.U.E.*)		Utility Traffic Signal Box —————	S
Buffer Zone 1 Bz 1	Troposed Godrardii		U/G Telephone Cable LOS C (S.U.E.*)		Utility Unknown U/G Line LOS B (S.U.E.*)	
Buffer Zone 2	Existing Cable Colderali		U/G Telephone Cable LOS D (S.U.E.*)		U/G Tank; Wcter, Gas, Oil ——————	
Flow Arrow	Troposed Cable Colderali		U/G Telephone Conduit LOS B (S.U.E.*) —		Underground Storage Tank, Approx. Loc. ——	(UST)
Disappearing Stream —	Equality Symbol —————	$\oplus$	U/G Telephone Conduit LOS C (S.U.E.*)—		A/G Tank; Water, Gas, Oil —	
Spring	Pavement Removal ————	$\bowtie$	U/G Telephone Conduit LOS D (S.U.E.*)—		Geoenvironmental Boring —————	
Wetland *	VEGETATION:		U/G Fiber Optics Cable LOS B (S.U.E.*)		U/G Test Hole LOS A (S.U.E.*)	•
Proposed Lateral, Tail, Head Ditch	Single Tree	G:	U/G Fiber Optics Cable LOS C (S.U.E.*)		Abandoned According to Utility Records —	AATUR
False Sump	Single Shrub	0	U/G Fiber Optics Cable LOS D (S.U.E.*)		End of Information —	E.O.I.
			opines casio 200 5 (5.0.E. )			100% DRAWING - RELEASED FOR CONSTRUCT



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CRABTREE CREEK GREENWAY


LASSITER MILL

LASSITER MILL ROAD TO HERTFORD STREET

PLAN INFORMATION PROJECT NO. RAL-18000 FILENAME RAL18000-N.dwg CHECKED BY -DRAWN BY GDB

SCALE 1" = 50' / 1"=10'
DATE 08/28/2025
CITY FILE NO. SPR-0081-2025

**1B** 

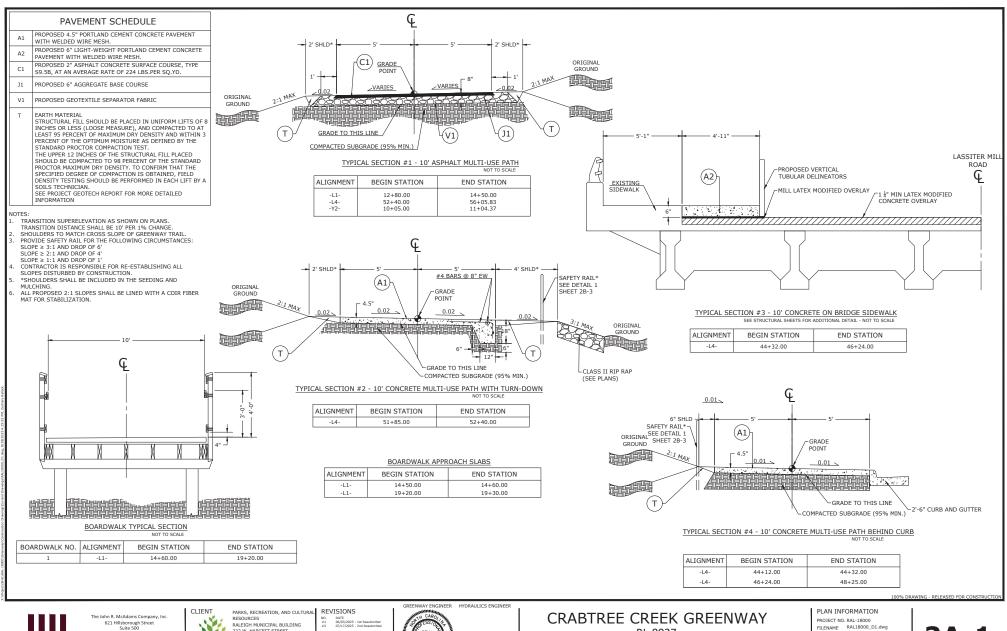



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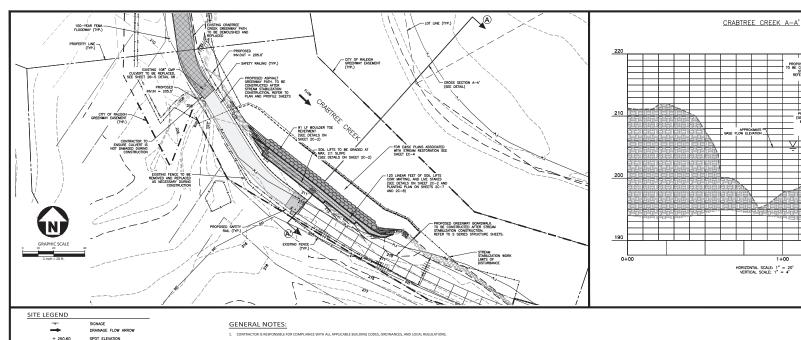



BL-0027 LASSITER MILL LASSITER MILL ROAD TO HERTFORD STREET

CHECKED BY --DRAWN BY GDB SCALE 1" = 20' / 1"=4' DATE 08/28/2025

CITY FILE NO. SPR-0081-2025

2A-1



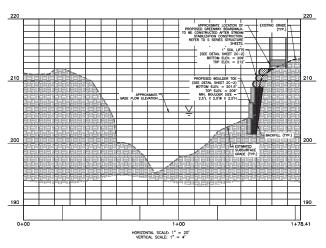

- PROPERTY LINE \_\_ \_\_ \_ \_ LOT LINE \_\_\_x\_\_\_ EXISTING FENCE \_\_\_TP\_\_\_TP\_\_\_\_TP\_\_\_\_\_TREE\_PROTECTION\_FENCE

LD ---- LIMITS OF DISTURBANCE MAJOR CONTOUR 252 \_\_\_\_ MINOR CONTOUR 250 EXISTING MAJOR CONTOUR

..... EXISTING MINOR CONTOUR \_\_\_ \_\_ \_ \_ EASEMENT LINE STORM DRAINAGE - STORM SERVICE LINE

BOULDER TOE REVETMENT







PROPOSED GREENWAY BOARDWALK

- PROJECT LOCATED WITHIN FEMA SPECIAL FLOOD HAZARD AREA STREAM NAME: CRABITREE CREEK MAP #: 372017500X EFFECTIVE DATE: 07/19/2022 FLOOD ZONES: CLOODWAY, AE, ZONE X
- 3. ALL CONSTRUCTION SHALL CONFORM TO OR EXCEED REGULATIONS OF THE AMERICANS WITH DISABilities ACT AND OTHER APPLICABLE STANDARDS AND GOLDENING A INTURBINIS
- ALL CONSTRUCTION SHALL BE PERFORMED IN ACCORDANCE WITH THE CONTRACT DOCUMENTS AND ALL APPLICABLE LOCAL, STATE, AND FEDERAL AGENCIES AND REGULATIONS.
- ACCOMPANIES MALE PRINTED THE PRINCE FROM CONTINUE FOR ARMAL AND ARROCATED ACTIVITY TRANSPECTORSTRUCTURE. COCCURATIONAL SAF MEATH COMMISSION (DOUGH STORMAGE FOR EXCLUSIVE FOR MILE IZ SCHEME TO SAFETY THE PRINCE TO ALL EXCLUSIVE FOR FEET OF EXCLUSIVE EXCLUSIVE OF SAFETY STORMAGE FOR EXCLUSIVE FOR THE PRINCE FOR SAFETY SYSTEM BY A REGISTERED PROF INCOME, PROVIDED BY CONTINUES RESPONSIBLE FOR EXCLUSIVE.
- 8. CONTRACTOR SHALL MAINTAIN AN "AS BUILT" SET OF DRAWINGS TO RECORD THE EXACT LOCATION OF STREAM STABILIZATION STRUCTURES. DRAWINGS SHALL BE GIVEN TO THE DESIGN ENGINEER UPON COMPLETION OF THE PROJECT.
- 9. EXISTING IMPROVEMENTS SLATED TO REMAIN THAT ARE DAMAGED DURING CONSTRUCTION SHALL BE REPLACED/RESTORED TO THEIR ORIGINAL CONDITION OR TO THE SATISFACTION OF THE OWNER'S REPRESENTATIVE BY THE CONTRACTOR RESPONSIBLE FOR THE DAMAGE.

- 12. EXISTING UTILITIES SHOWN ARE BASED ON FIELD SURVEYS AND THE BEST AVAILABLE RECORD DRAWINGS. THE CONTRACTOR SHALL VERIFY CONDITIONS PRIOR TO BEGINNING CONSTRUCTION. ANY DISCREPANCIES BETWEEN ACTUAL FIELD CONDITIONS AND THE PLANS SHALL BE REPORTED TO THE OWNER'S REPRESENTATIVE
- 14 CONSTRUCTION OPERATIONS SHALL BE CARRIED OUT IN SUCH A MANNER THAT FROSION AND WATER POLITION IS MINIMIZED.
- 15. ALL DISTLIBRED AREAS TO BE SEEDED PER SEEDING SCHEDULE ON SHEET 2C.8.
- 16. PHASE 1 EROSION AND SEDIMENTATION CONTROL PLANS ASSOCIATED WITH THE STREAM RESTORATION CAN BE FOUND ON SHEET EC-4
- 17. PHASE 2 EROSION AND SEDIMENTATION CONTROL PLANS ASSOCIATED WITH GREENWAY CONSTRUCTION CAN BE FOUND ON SHEETS EC-5 THRU EC-12



ALL CONSTRUCTION SHALL BE IN ACCORDANCE WITH THE CURRENT CITY OF RALEIGH ENGINEERING DESIGN AND CONSTRUCTION STANDARDS

CONTRACTOR SHALL NOTIFY "NC811" (811) OR (1-800-632-4949) AT LEAST 3 FULL BUSINESS DAYS PRIOR TO BEGINNING CONSTRUCTION OR EXCAVATION TO HAVE EXISTING UTILITIES LOCATED. THEIR OWN LOCATOR SERVICES INDEPENDENT OF "NC811". REPORT ANY DISCREPANCIES TO THE ENGINEER IMMEDIATELY.

100% DRAWING - DELEASED FOR CONSTR



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phone 919. 361. 5000 fax 919. 361. 2269 license number: C-0293, C-187

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CLIENT Raleigh CONTACT:
LEXT YATES, PROJECT MANAGER

PARKS, RECREATION, AND CULTURAL RESOURCES
RALEIGH MUNICIPAL BUILDING 222 W. HARGETT STREET SUITE 600 RALEIGH, NC 27601 919-996-3762

REVISIONS

STREAM ENGINEER

CRABTREE CREEK GREENWAY BL-0027 LASSITER MILL


LASSITER MILL ROAD TO HERTFORD STREET

PLAN INFORMATION

PROJECT NO. RAL-18000 RAL18000-SW.dwg FILENAME CHECKED BY RAS

DRAWN BY KEG DATE 08/28/2025 CITY FILE NO. SPR-0081-2025 GRADING PLAN

2C-1

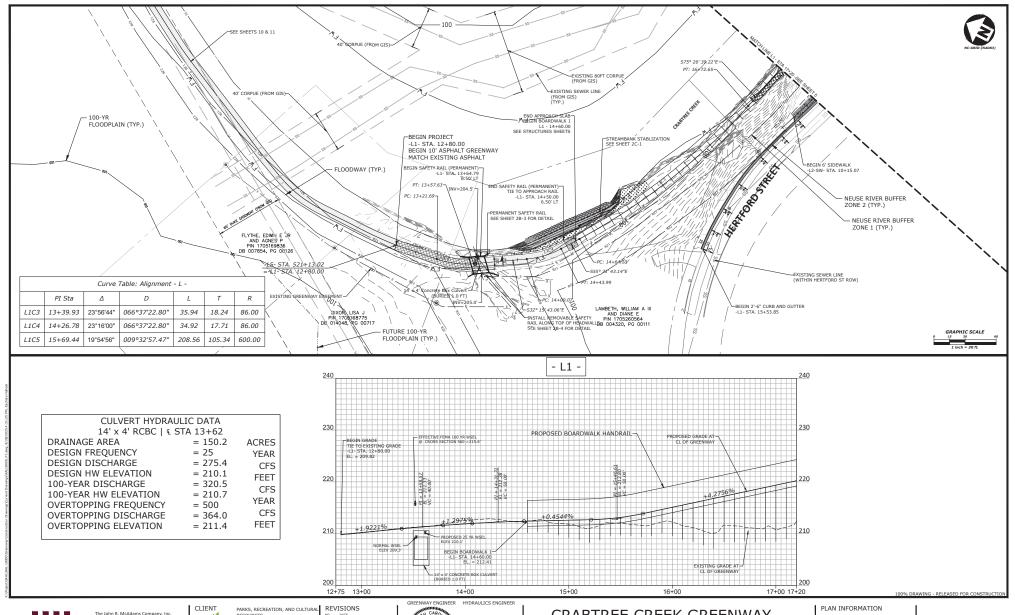



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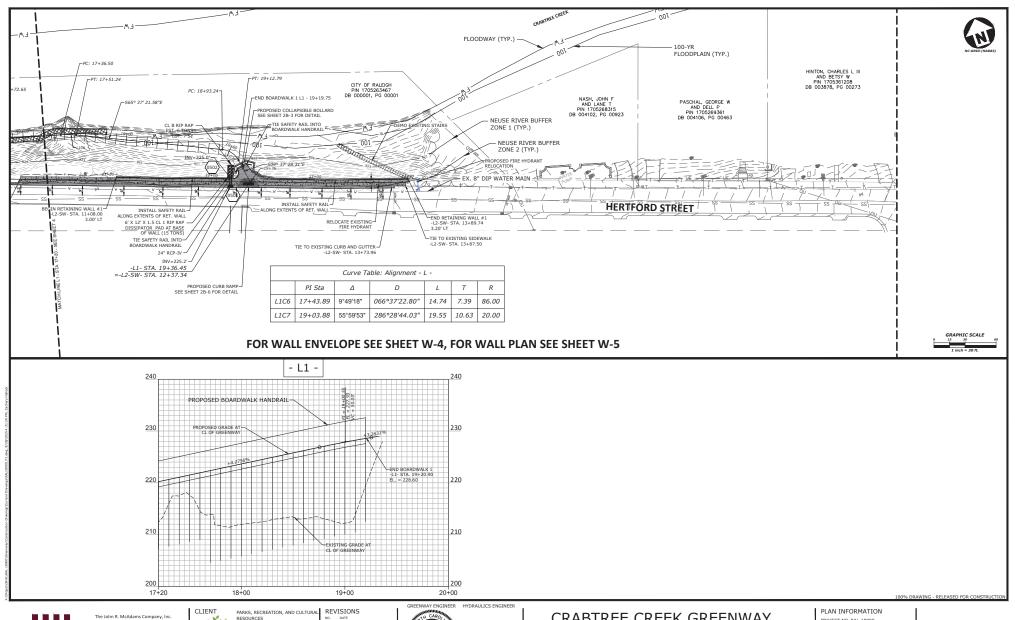




CRABTREE CREEK GREENWAY BL-0027 LASSITER MILL LASSITER MILL ROAD TO HERTFORD STREET

PROJECT NO. RAL-18000 FILENAME RAL18000\_P1.dwg CHECKED BY AH DRAWN BY GDB SCALE 1" = 30' / 1"=6' DATE 08/28/2025

CITY FILE NO. SPR-0081-2025





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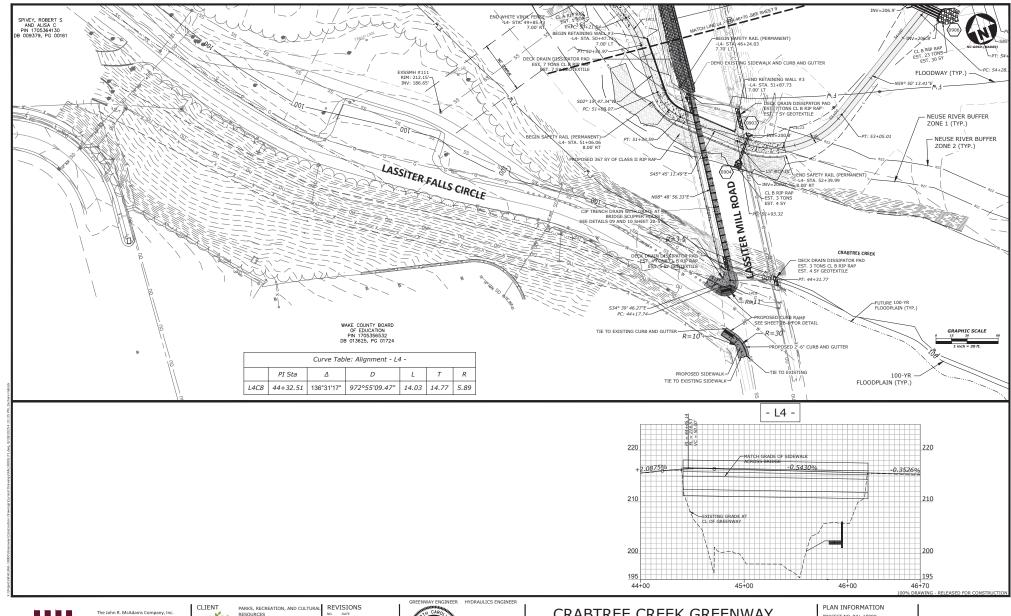


CRABTREE CREEK GREENWAY BL-0027 LASSITER MILL LASSITER MILL ROAD TO HERTFORD STREET

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5





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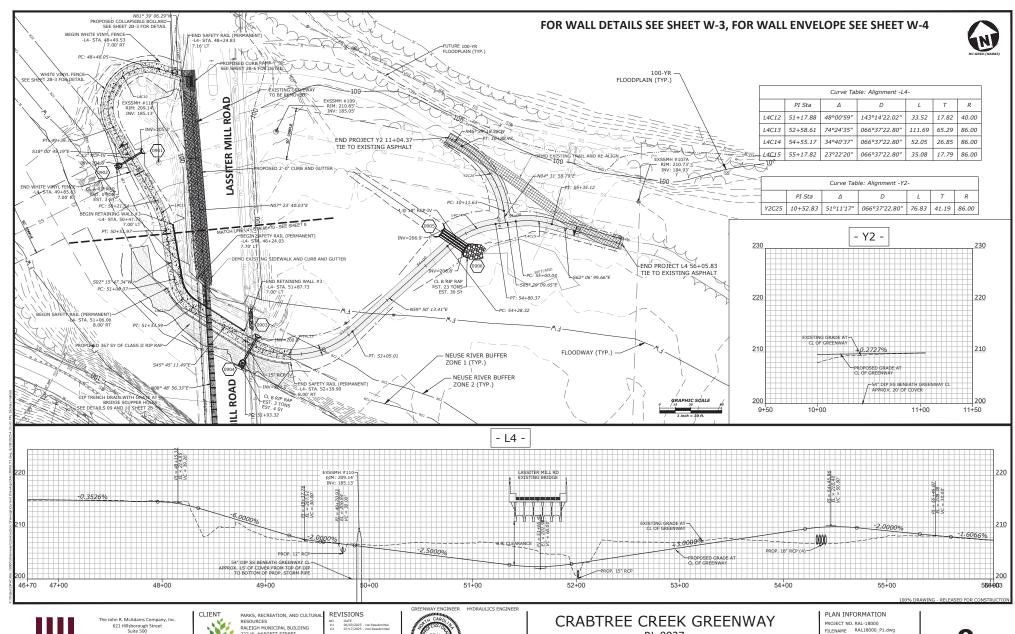
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PROJECT NO. RAL-18000 FILENAME RAL18000\_P1.dwg CHECKED BY AH DRAWN BY GDB

SCALE 1" = 30' / 1"=6'

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8





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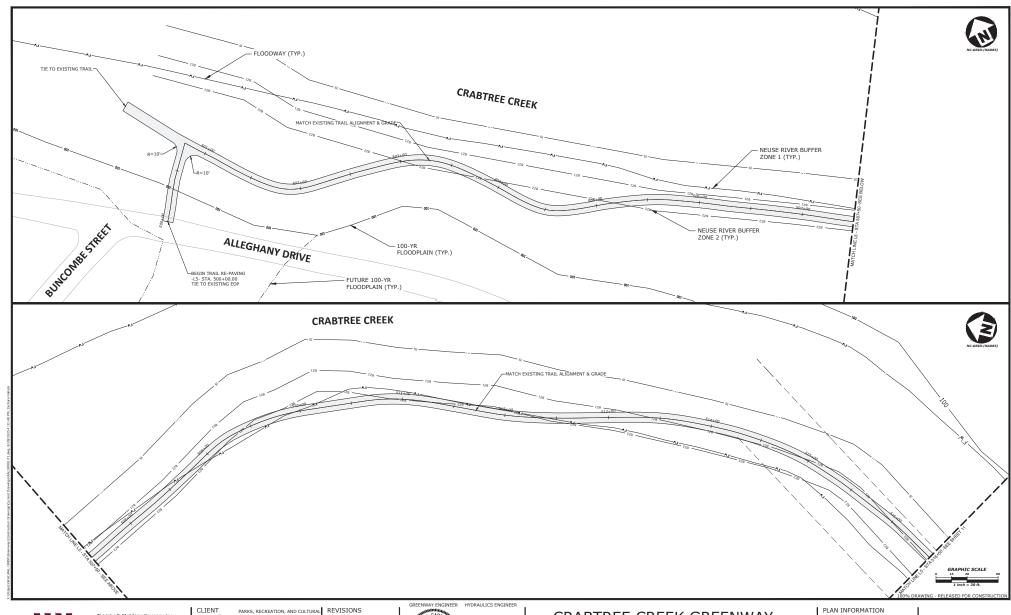


222 W. HARGETT STREET SUITE 600 RALEIGH, NC 27601



BL-0027 LASSITER MILL

CHECKED BY AH DRAWN BY GDB SCALE 1" = 30' / 1"=6' DATE 08/28/2025 LASSITER MILL ROAD TO HERTFORD STREET CITY FILE NO. SPR-0081-2025





The John R. McAdams Company, Inc. 621 Hillsborough Street Suite 500 Raleigh, NC 27603

phone 919. 361. 5000 fax 919. 361. 2269 license number: C-0293, C-187

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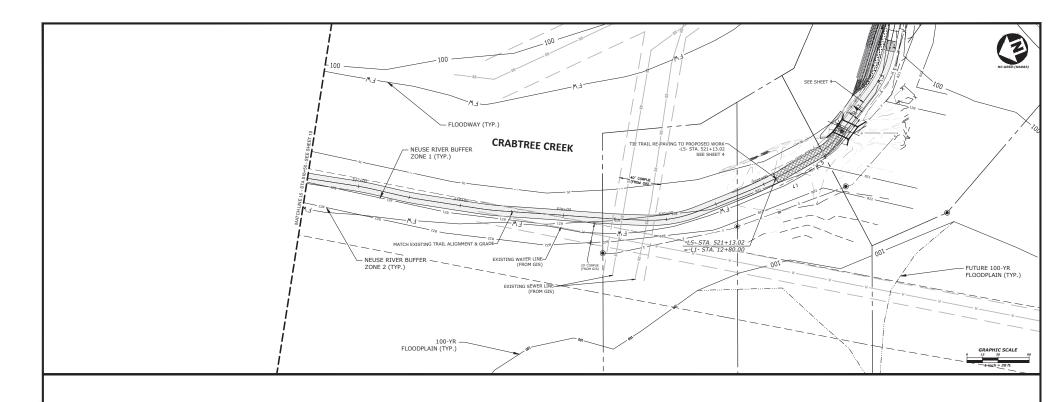


CLIENT PARKS, RECREATION, AND CULTURES OF RESOURCES RALEIGH MUNICIPAL BUILDING 222 W. HARGETT STREET SUITE 600 RALEIGH, NC 27501 919-96-3762 CONTACT: LEXI YATES, PROJECT MANAGER

CRABTREE CREEK GREENWAY BL-0027 LASSITER MILL LASSITER MILL ROAD TO HERTFORD STREET

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**MCADAMS** 

The John R. McAdams Company, Inc. 621 Hillsborough Street Suite 500 Raleigh, NC 27603

phone 919. 361. 5000 fax 919. 361. 2269 license number: C-0293, C-187

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SUITE 600
RALEIGH, NC 275601
919-96-3762
CONTACT:
LEXI YATES, PROJECT MANAGER



GREENWAY ENGINEER HYDRAULICS ENGINEER

BL-0027 LASSITER MILL LASSITER MILL ROAD TO HERTFORD STREET

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SCALE 1" = 30' / 1"=6'
DATE 08/28/2025
CITY FILE NO. SPR-0081-2025

PLAN INFORMATION